

CONSTRUCTION DRAWINGS FOR ORANGE COUNTY CLASS III LANDFILL LANDFILL GAS MANAGEMENT SYSTEM HEADER EXPANSION CELL 2 - 2019

DRAWING TITLE	DRAWING NO.
GENERAL	
COVER SHEET	G1
SYMBOLS AND LEGEND.....	G2
AERIAL PHOTOGRAPH (2016)	G3
CIVIL	
SITE PLAN.....	C1
HEADER PROFILES - NORTH.....	C2
HEADER PROFILES - SOUTH (1 OF 2).....	C3
HEADER PROFILES - SOUTH (2 OF 2).....	C4
HEADER PROFILES - WEST.....	C5
DETAILS (1 OF 4).....	C6
DETAILS (2 OF 4).....	C7
DETAILS (3 OF 4).....	C8
DETAILS (4 OF 4).....	C9


MAY 2019



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REGIONAL MAP



UTILITIES SOLID WASTE DIVISION ORANGE COUNTY, FLORIDA

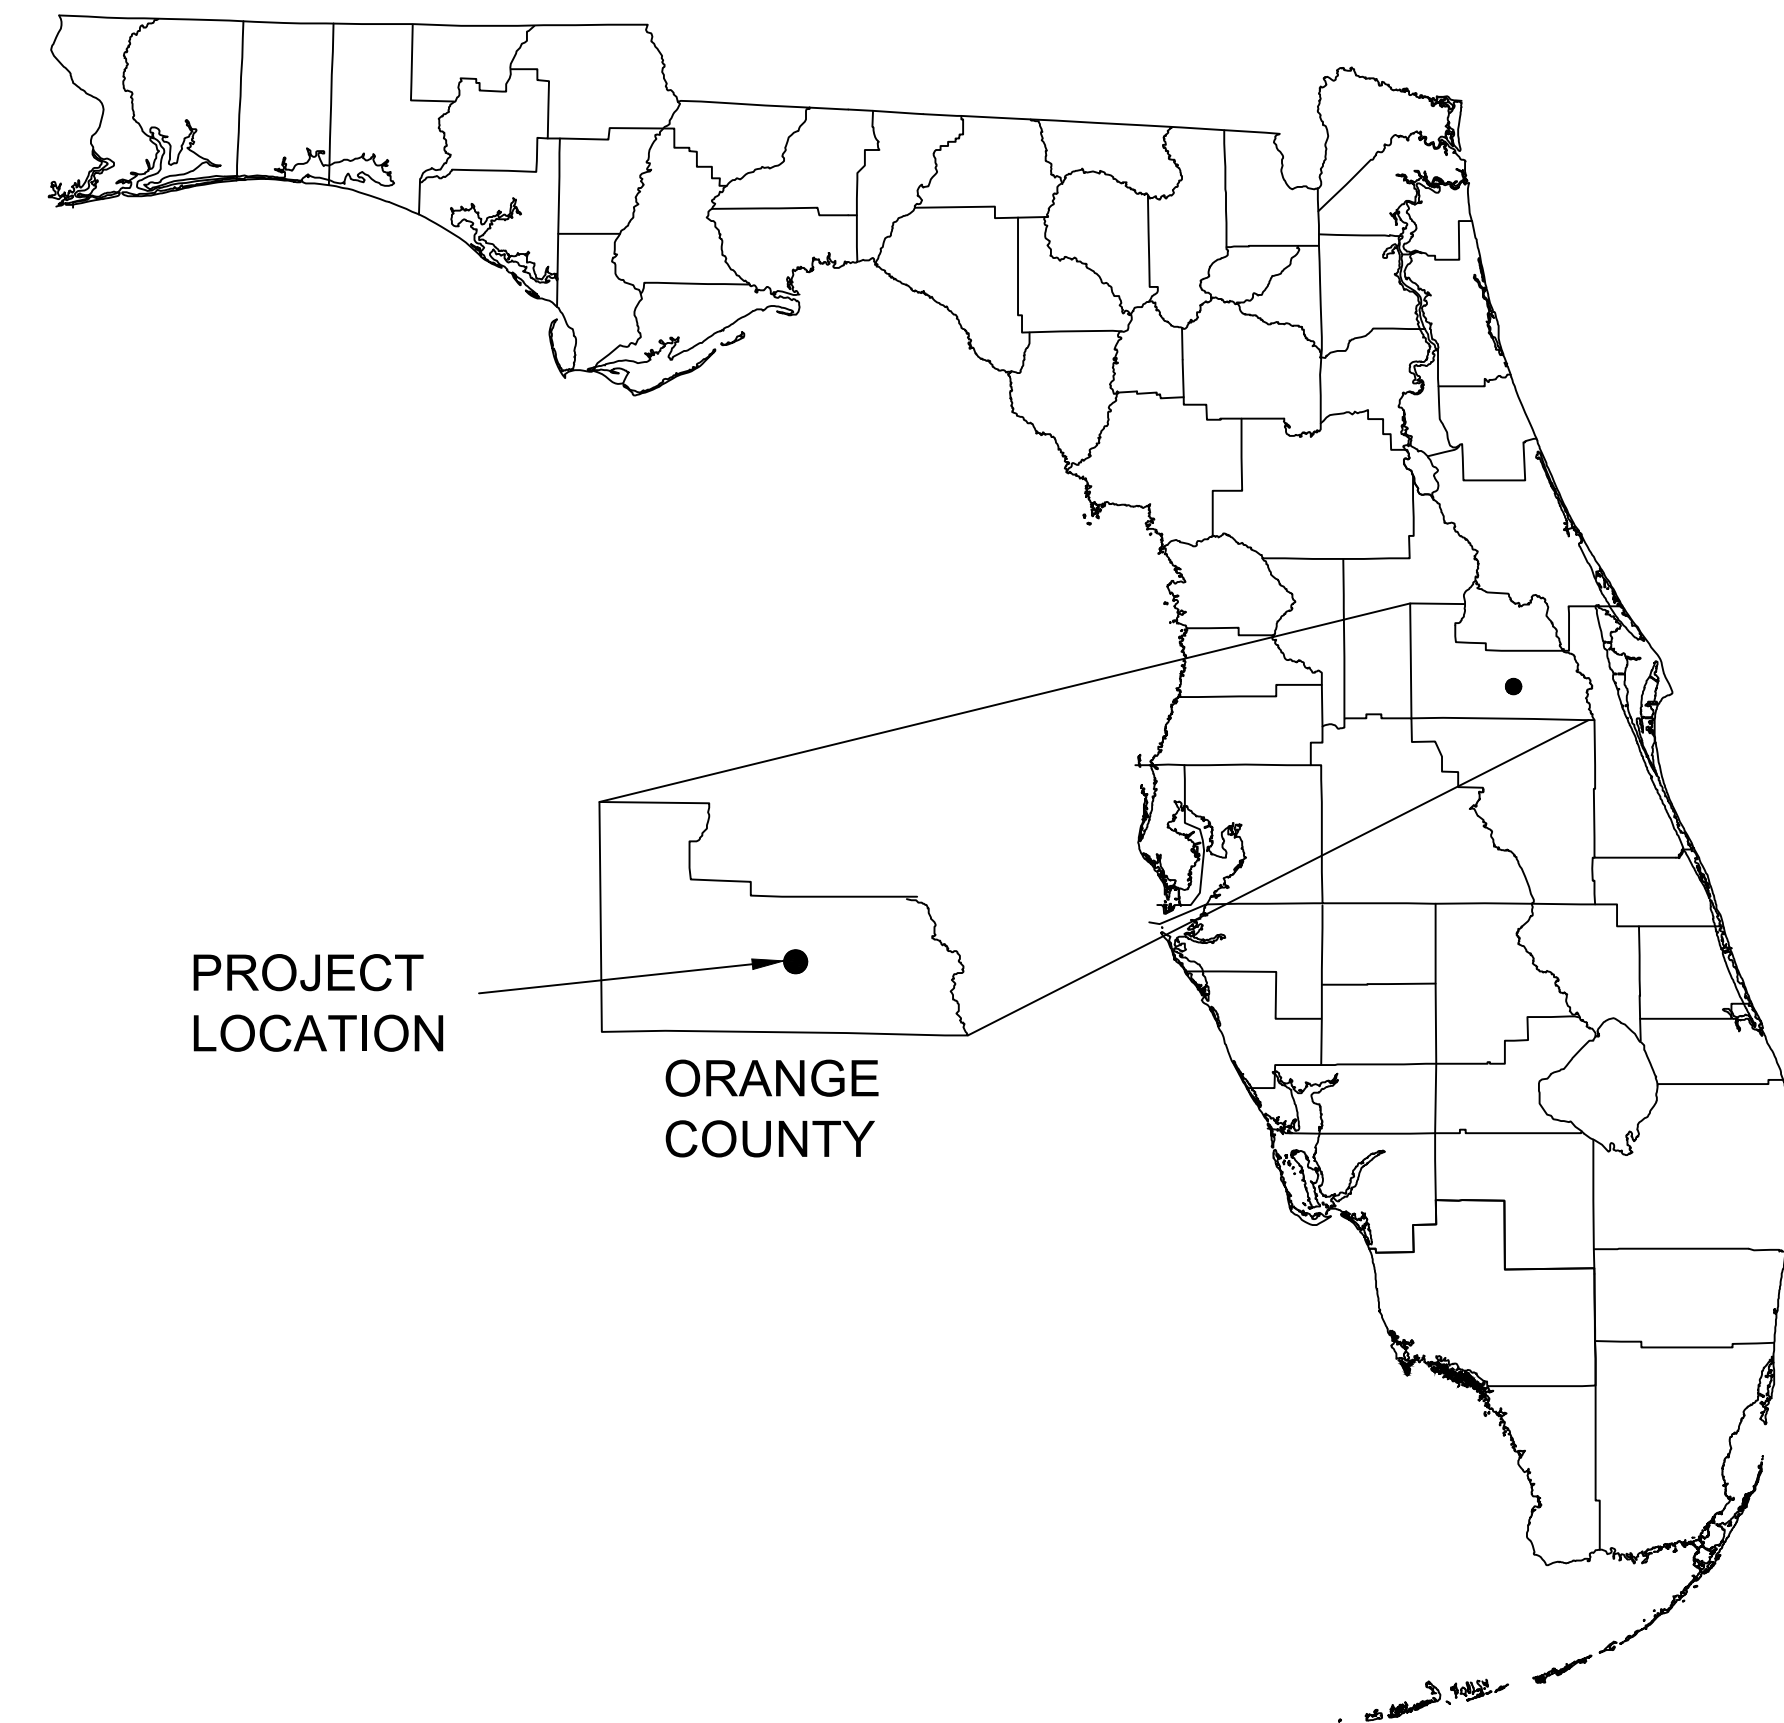CIP # 4410-038-1106-0003
SEQ # 66786



531 Versailles Drive, Suite 202
Maitland, Florida 32751
PH: (407) 475-9163 - FAX: (407) 475-9169
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VICINITY MAP

Signature: _____ Date: _____ Robert E. Mackey, P.E. Florida Registration # 40176	
REMARKS	
REV. NO. DATE DRAWN BY CHKD BY	
COVER SHEET LFG HEADER EXPANSION CLASS III LANDFILL ORANGE COUNTY, FLORIDA	
531 Versailles Drive, Suite 202 Maitland, Florida 32751 (407) 475-9163 FAX 475-9169 Certification of Authorization # 7831	
DRAWING NO. G1	

LEGEND

EXISTING		PROPOSED	
SYMBOL	DESCRIPTION	SYMBOL	DESCRIPTION
	LIMEROCK ROAD		SILT FENCE
	PAVED ROAD		LEACHATE COLLECTION LATERAL
	UNPAVED ROAD		CONTOUR
	CONTOUR		BENTONITE GROUT
	GENERAL BACKFILL SOILS		INVERT ELEVATION OF LATERAL
	STRUCTURE		FDOT NO. 57 STONE
	TREE		COMPACTED SUBGRADE
	PROPERTY BOUNDARY		GENERAL BACKFILL SOILS
	EDGE OF WATER		DITCH
	LEACHATE FORCEMAIN		PROTECTIVE SOIL
	DITCH		DRAINAGE SAND
	LINER CONTAINMENT BERM		GEOMEMBRANE LINER
	MANHOLE		COMPOSITE DRAINAGE NET (CDN)
	CLEANOUT		GEOSYNTHETIC CLAY LINER
	WASTE		GEOTEXTILE
	UTILITY POLE		STORMWATER CONTROL FLAP
	GROUNDWATER MONITORING WELL		ROAD
	GAS MONITORING PROBE		CLEANOUT
	PUMP STATION		STAKING POINT
	WASTE LIMIT		TOE OF SLOPE
	TOE DRAIN		TOP OF BERM
	CULVERT		CELL BOTTOM
	CONCRETE		LINER CONTAINMENT BERM
	PRIMARY LEACHATE COLLECTION HEADER		SOIL BERM
	SECONDARY LEACHATE COLLECTION HEADER		LIMITS OF CONSTRUCTION
			SPOT ELEVATION
			UTILITY POLE
			SILT FABRIC
			GFFR
			LINER LIMIT
			GROUNDWATER MONITORING WELL
			TOE DRAIN

PROPOSED	
SYMBOL	DESCRIPTION
	GATE VALVE
	CULVERT
	PRIMARY LEACHATE COLLECTION HEADER
	SECONDARY LEACHATE COLLECTION HEADER
	LEACHATE FORCEMAIN
	PLUG VALVE
	GAS MONITORING PROBE
	CELL BOUNDARY LINES
	PUMP STATION
	CONDENSATE SUMP
	STUB-OUT WITH BLIND FLANGE
	HDPE AIRLINE
	HEADER PIPE HIGH POINT
OTHER ITEMS	
SYMBOL	DESCRIPTION
	DETAIL CALLOUT DETAIL 1 PRESENTED ON DRAWING 3 WAS REFERENCED FOR THE FIRST TIME ON DRAWING 2
	CROSS SECTION CALLOUT SECTION 1 PRESENTED ON DRAWING 3 WAS REFERENCED FOR THE FIRST TIME ON DRAWING 2
	NOT IN CONTRACT

GENERAL NOTES:

1. PATTERN AND LINE SCALES MAY BE SLIGHTLY DIFFERENT ON INDIVIDUAL DRAWINGS.
2. ALL ELEVATIONS HAVE BEEN REFERENCED TO THE NATIONAL GEODETIC VERTICAL DATUM OF 1929 (NGVD 29). NORTHING-EASTING COORDINATES SET IN FLORIDA STATE PLANE: EAST ZONE.
3. THIS IS A GENERAL LEGEND. ALL PATTERNS AND SYMBOLS SHOWN ON THIS SHEET MAY NOT BE USED IN THE DRAWING SET.
4. FOR CONTRACTOR'S ACCESS AND MATERIAL HAULING, THE CONTRACTOR MAY USE MAIN ACCESS, SECONDARY ACCESS, AND LIMEROCK ROADS, AS SHOWN ON THE SITE AERIAL (DRAWING G-3).
5. DURING CONSTRUCTION, THE CONTRACTOR'S MATERIAL HAULING TRUCKS AND OTHER VEHICULAR TRAFFIC SHALL OBEY ON-SITE SPEED LIMITS AND TRAFFIC SIGNS, NOT STOP OR PARK ALONG THE MAIN ENTRANCE ROAD, AND NOT INTERFERE WITH SOLID WASTE OPERATION AND/OR CONSTRUCTION TRAFFIC INCLUDING SOLID WASTE DELIVERY AND OPERATION VEHICLES TO AND FROM THE CLASS III LANDFILL OPERATION.
6. CONTRACTOR MAY BYPASS SCALES WHEN BRINGING CONSTRUCTION MATERIALS ON SITE. HOWEVER, THE CONTRACTOR MUST HAVE A REPRESENTATIVE ON-SITE AT ALL TIMES TO RECEIVE DELIVERIES. COUNTY STAFF SHALL NOT ACCEPT OR TAKE RESPONSIBILITY FOR CONTRACTOR DELIVERIES.
7. NO USABLE DIRT OR BORROW MAY BE REMOVED FROM SITE. ALL CONTRACTOR -GENERATED CONSTRUCTION WASTE SHALL BE DISPOSED PROPERLY ON-SITE AT A LOCATION APPROVED BY THE OWNER. CONTRACTOR SHALL NOT BE CHARGED A TIPPING FEE.
8. ANY EXCAVATED WASTE SHALL BE TRANSPORTED TO THE ON SITE CLASS I LANDFILL FOR DISPOSAL.
9. SOLID WASTE IN LANDFILLS DECOMPOSES, MOVES, SETTLES AND COMPACTS WITH TIME. THE ELEVATIONS SHOWN FROM THE MOST RECENT TOPOGRAPHIC AERIAL SURVEY MAY NOT REPRESENT ACTUAL SITE CONDITIONS AT THE TIME OF CONSTRUCTION.
10. THE GENERAL LOCATION OF CONTRACTOR'S STAGING AREA IS SHOWN ON THE SITE AERIAL (DRAWING G-3). THE OWNER AND CONTRACTOR WILL COORDINATE ON FINAL BOUNDARIES OF CONTRACTOR'S STAGING AREA AT THE PRE-CONSTRUCTION MEETING. THE STAGING AREA SHALL BE RESTORED PRIOR TO SUBSTANTIAL COMPLETION OF THE PROJECT. THE RESTORATION SHALL INCLUDE CLEANING OF ALL STORMWATER INLETS, PIPES AND DITCHES AND RESTORATION OF ALL AFFECTED ROADWAYS AND VEGETATION.
11. DAMAGE TO THE EXISTING LFG CONTROL SYSTEM, EXISTING STORMWATER SYSTEM OR ANY OTHER SITE FEATURES SHALL BE REPAIRED AS QUICKLY AS POSSIBLE AT NO COST TO, AND TO THE SATISFACTION OF, THE OWNER.


MINIMUM ALLOWABLE BEND RADIUS FOR HDPE PIPE INSTALLED IN AN OPEN CUT TRENCH (SAFETY FACTOR OF 2:1)

NOMINAL OUTSIDE DIAMETER, IN	2	4	6	8	10	12	14	16	18	24	36	48
ACTUAL OUTSIDE DIAMETER, IN	2.38	4.5	6.625	8.625	10.75	12.75	14	16	18	24	36	48
SDR	9 11 17	9 11 17	9 11 17	9 11 17	9 11 17	9 11 17	9 11 17	9 11 17	9 11 17	9 11 17	9 11 17	17
^{1,2} MINIMUM ALLOWABLE BEND RADIUS, FT	8 10 11 15 19 20	22 28 30	29 36 39 36	45 48 43	53 57 47	58 63 53 67 72	60 75 81	80 100 108	120 150 162	216		

¹THE MINIMUM ALLOWABLE HDPE BEND RATIOS USED IN THIS TABLE ARE BASED ON INFORMATION PROVIDED IN "POLYETHYLENE PIPING SYSTEMS FIELD MANUAL FOR MUNICIPAL WATER APPLICATIONS", PLASTIC PIPING INSTITUTE, 2009.

²THE MINIMUM ALLOWABLE BEND RADIUS IS DETERMINED UTILIZING THE FOLLOWING EQUATION: MINIMUM RADIUS OF CURVATURE = R_b * PIPE O.D. NOTE THAT S2Li ADDED A FACTOR OF SAFETY OF 2:1 TO THE MINIMUM ALLOWABLE BEND RADIUS VALUES PROVIDED IN THE FIELD MANUAL.

³THE MINIMUM BEND RADIUS IS 100 X PIPE OUTSIDE DIAMETER (O.D.) WHEN A FITTING OR FLANGE IS PRESENT IN THE BEND. THIS BEND RADIUS SHALL BE MAINTAINED FOR A DISTANCE OF 5 X PIPE O.D. IN EACH DIRECTION FROM THE FITTING OR FLANGE.

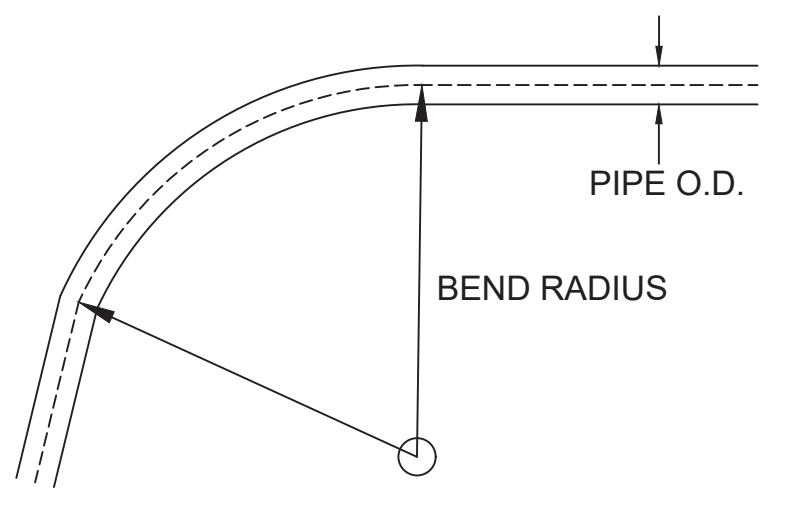

Date _____
Signature _____
Robert E. Mackey, P.E.
Florida Registration # 40176

REV. No	DATE	DRAWN BY	CHECK BY	REMARKS



SYMBOLS AND LEGEND
LFG HEADER EXPANSION
CLASS III LANDFILL
ORANGE COUNTY, FLORIDA

531 Versailles Drive, Suite 202
Maitland, Florida 32751
(407) 475-9163 FAX 475-9169
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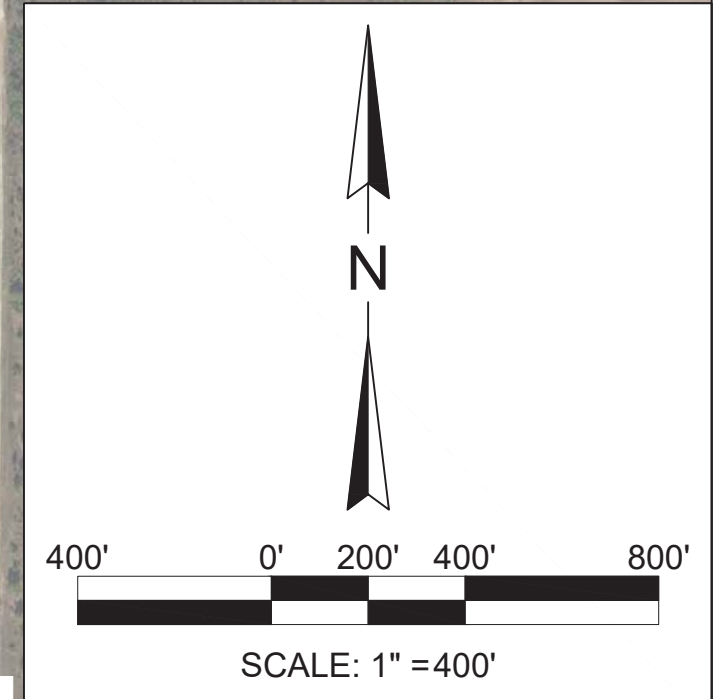
S2Li

DRAWING NO.
G2

A B C D E F



NOTE: AERIALS TAKEN FROM FDOT APLUS DATABASE. FLIGHT DATE 2016.



Signature
 Robert E. Maskey, P.E.
 Florida Registration # 40176

REV. No.	DATE	DRAWN BY	CHECK BY	REMARKS






AERIAL PHOTOGRAPH (2016)
 LFG HEADER EXPANSION
 CLASS III LANDFILL
 ORANGE COUNTY, FLORIDA

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DRAWING NO.
G3

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- NOTES:
- REFER TO DRAWING G2 FOR SYMBOL IDENTIFICATION.
 - HEADER PIPE TO BE 12" DIAMETER EXCEPT WHERE OTHERWISE NOTED.
 - ALL ABOVE GROUND STRUCTURES INCLUDING VALVES, STUB-OUTS, BLOW-OFFS, AND PUMP STATIONS TO HAVE BOLLARDS PLACED ACCORDING TO DETAIL 4 ON DRAWING C5.
 - FORCEMAIN AND AIRLINE CROSSOVERS TO BE CONSTRUCTED AT EACH PUMP STATION.
 - MITERED END SECTIONS TO BE CONSTRUCTED IN ACCORDANCE WITH FDOT INDEX NO. 272.
 - EXISTING 4" HEADER PIPE LOCATED ON THE NORTH SIDE OF THE LANDFILL TO BE CUT AND CAPPED AS NECESSARY FOR NEW HEADER PIPE PLACEMENT.

Date _____
 Signature _____
 Robert E. Mackey, P.E.
 Florida Registration # 40176

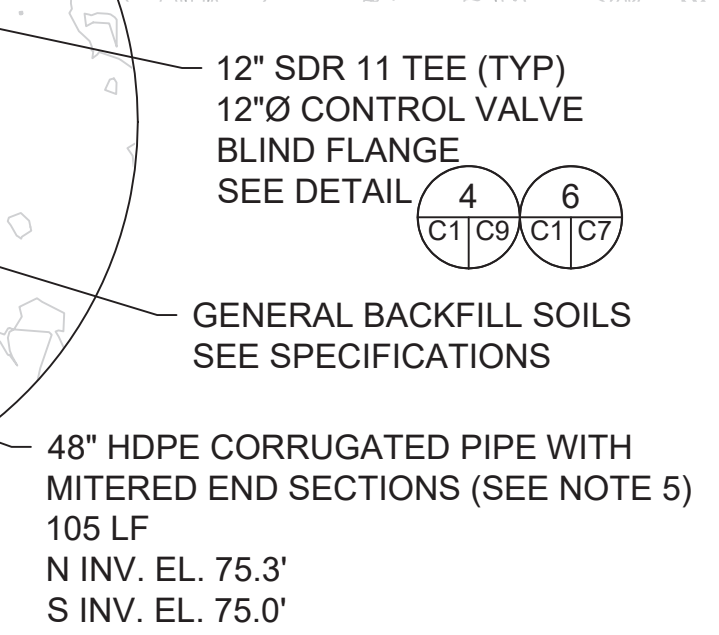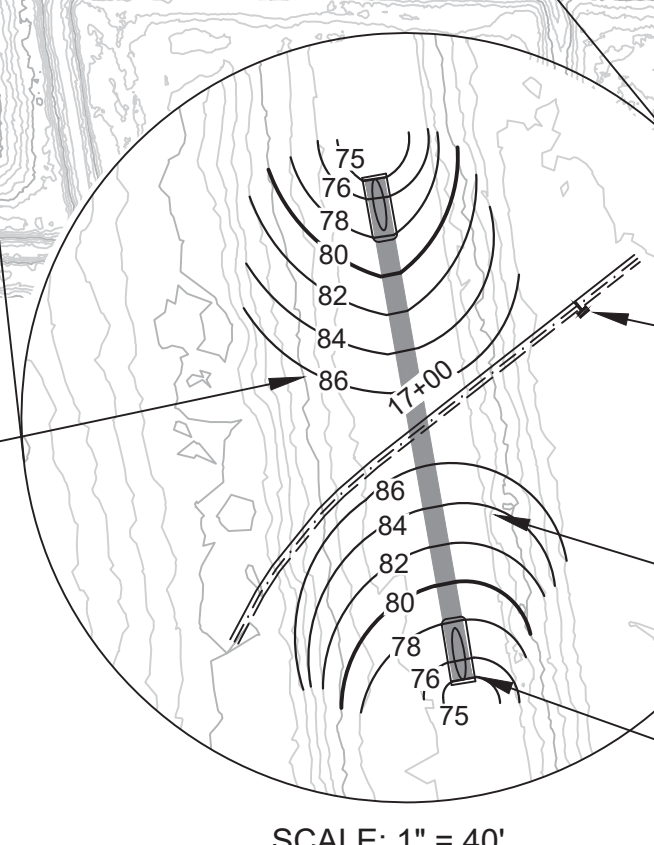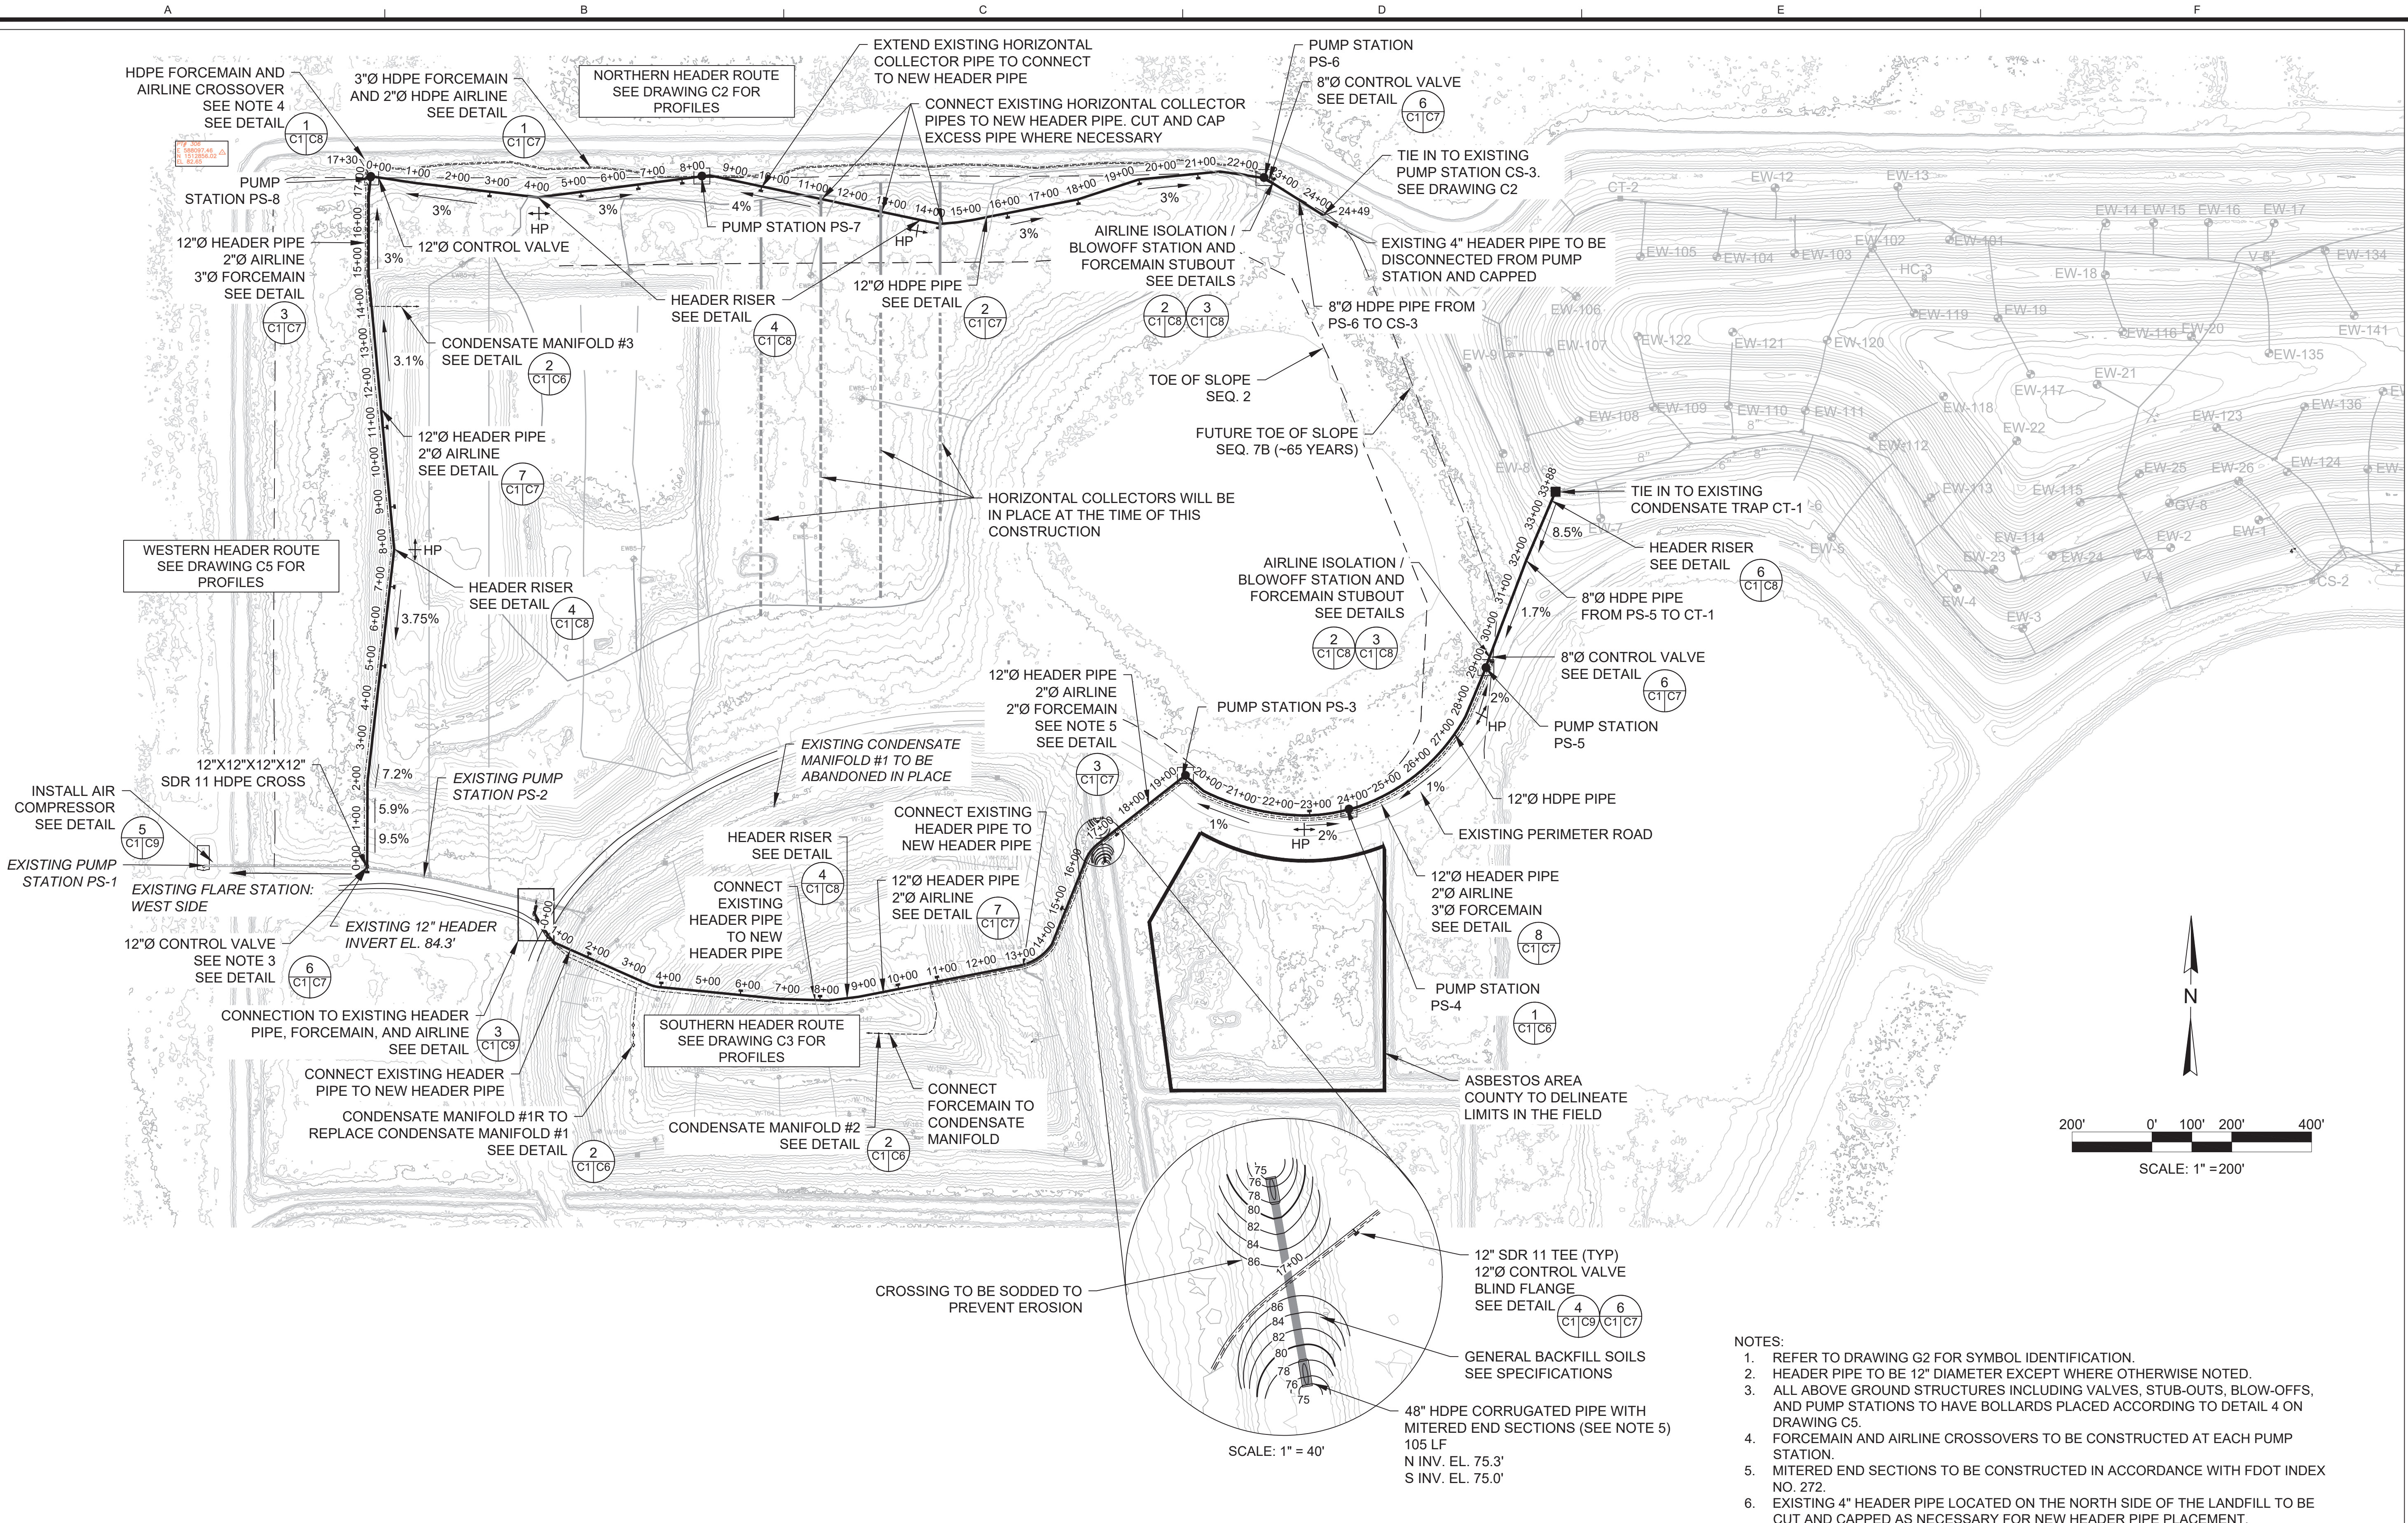REV	DATE	DRAWN	CHKD	BY	REMARKS





SITE PLAN
LFG HEADER EXPANSION
ORANGE COUNTY CLASS III LANDFILL
ORANGE COUNTY, FLORIDA

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DRAWING NO.
C1

I:\File-Server\Data\Working Files\Orange County\17-237 Class III LFG Expansion\Production Drawings\C1-C4-Header Design 4-25-16.dwg Apr 26, 2016 - 3:24 PM

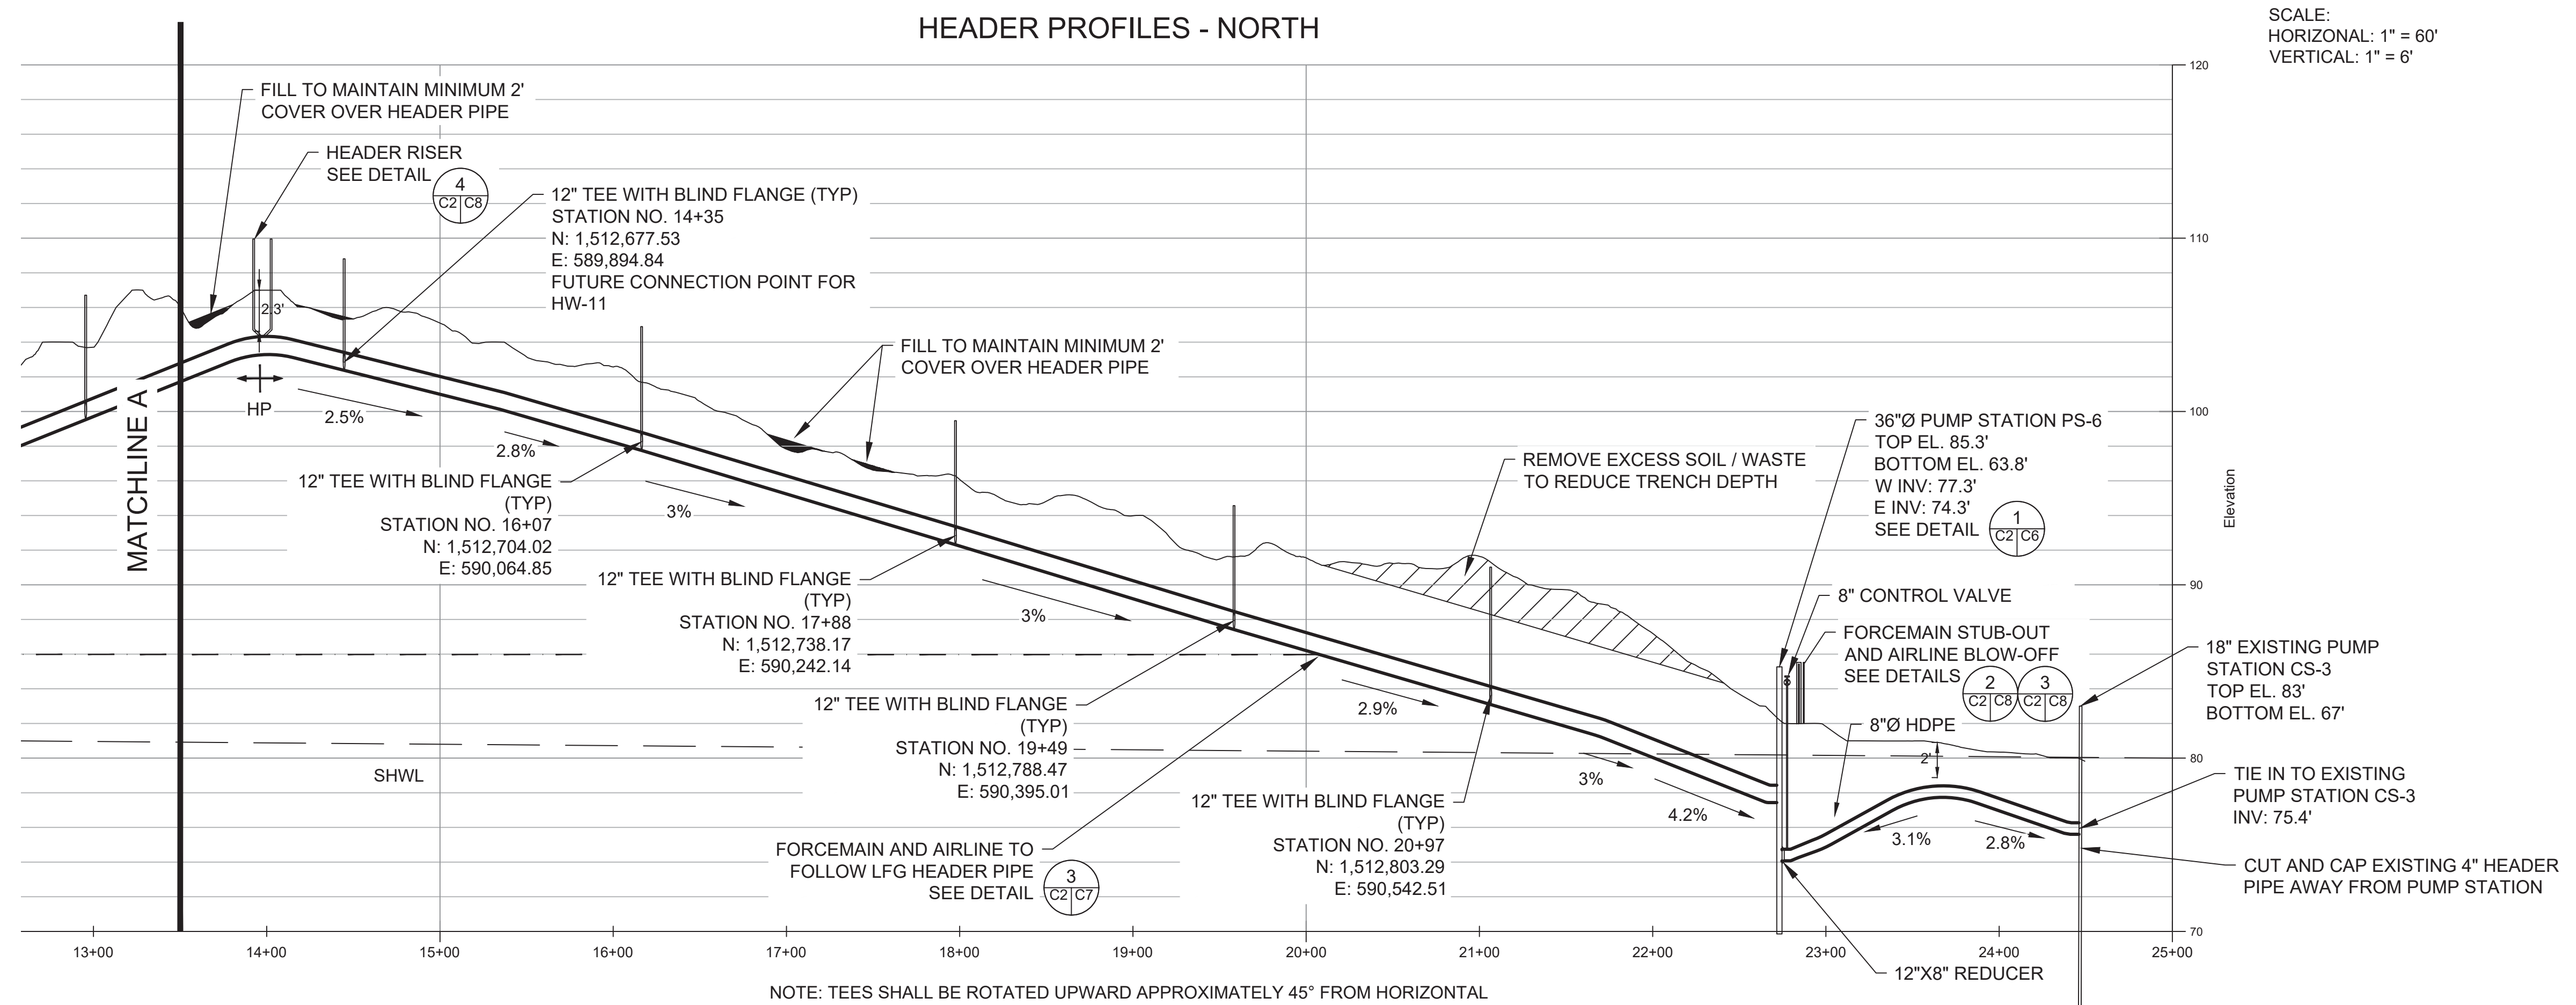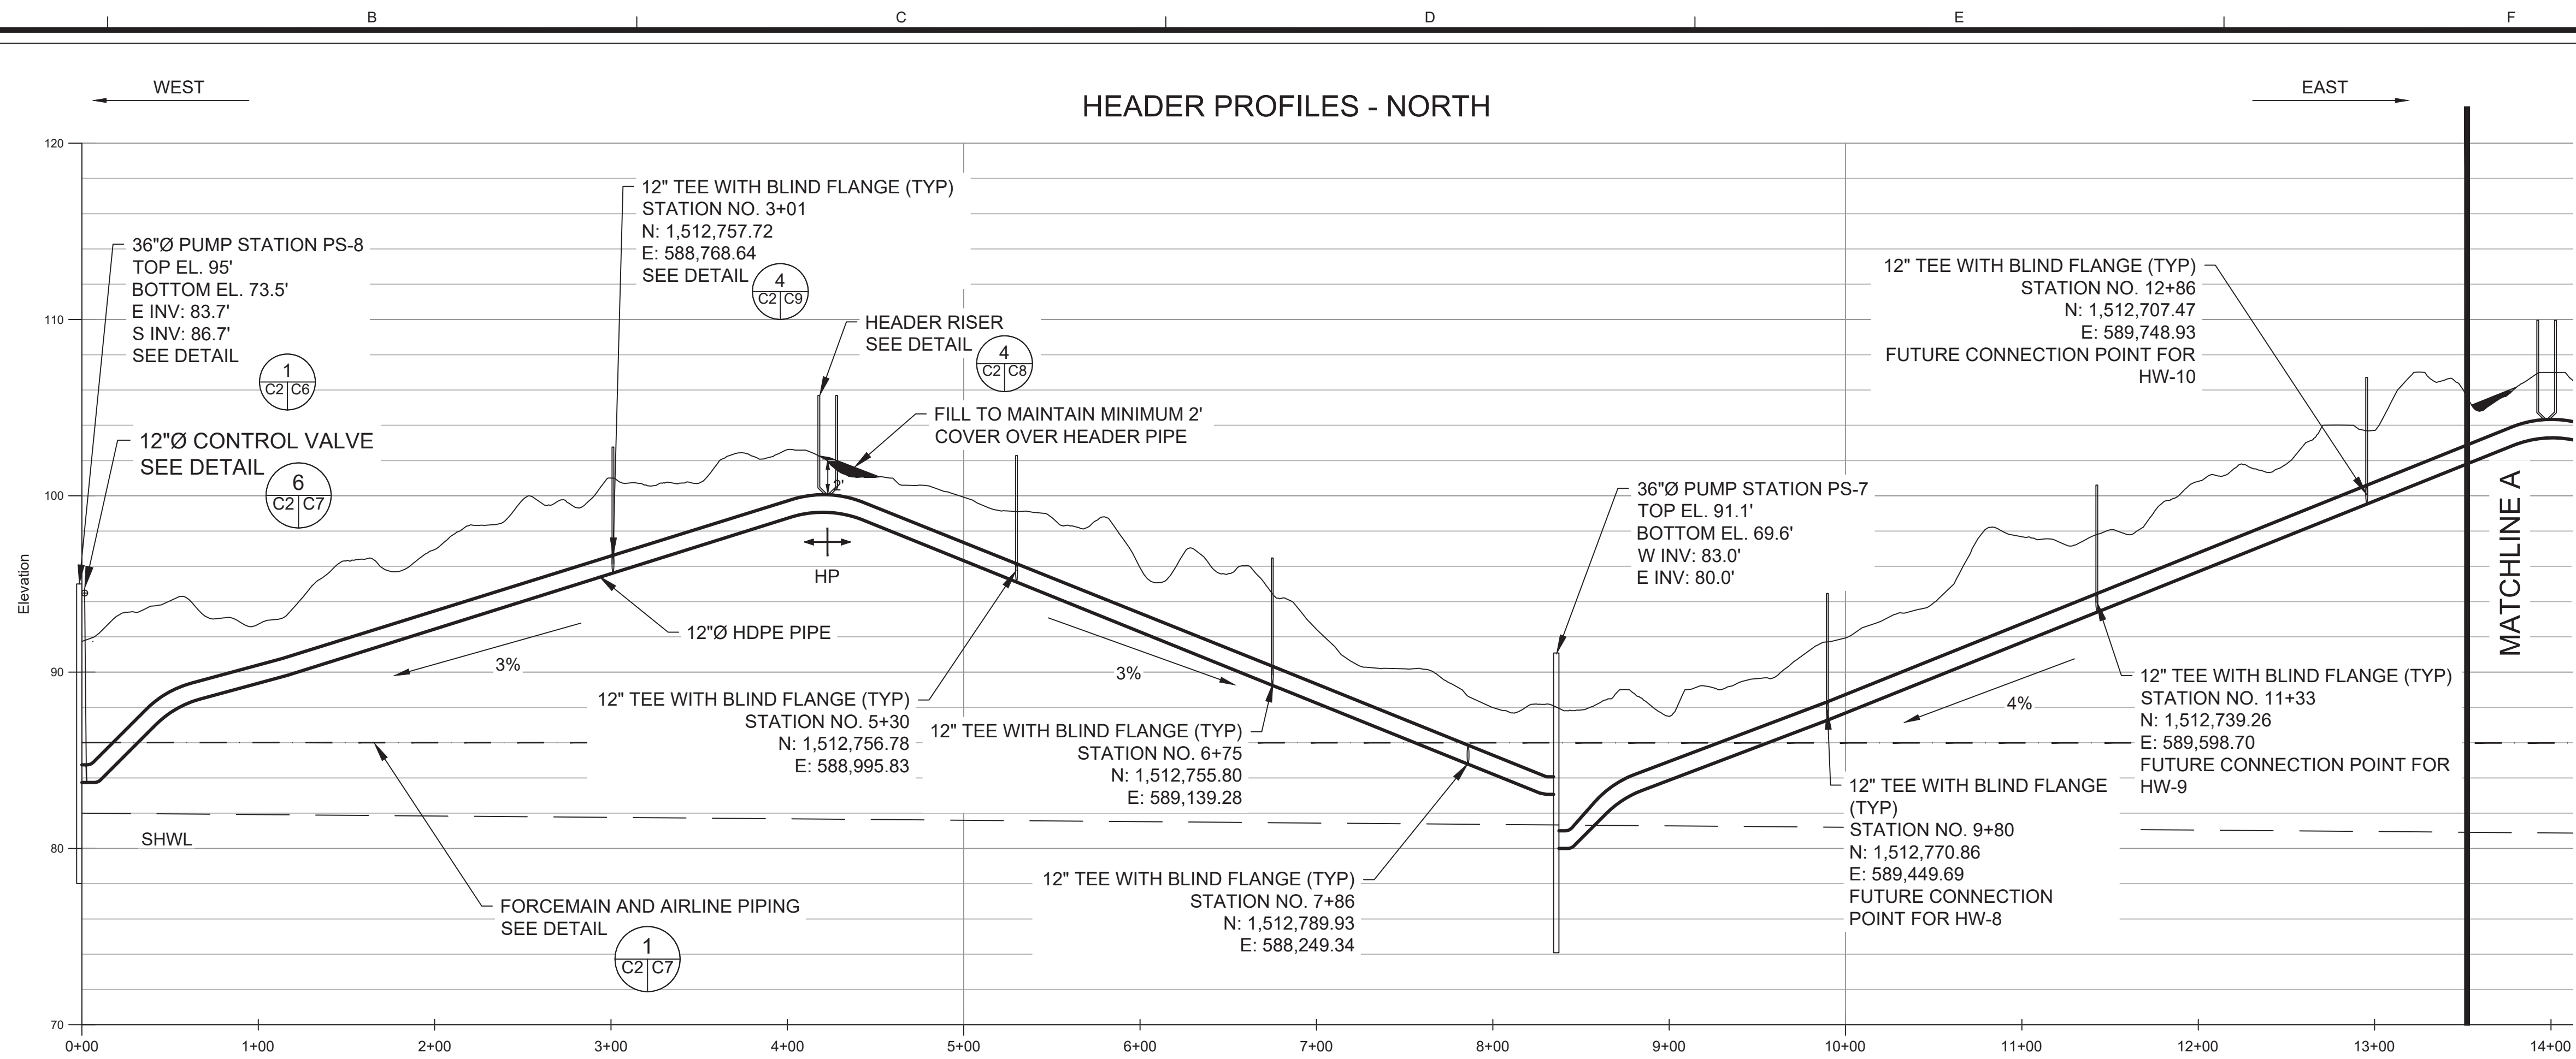

SCALE:
HORIZONTAL: 1" = 60'
VERTICAL: 1" = 6'

NOTE: VERTICAL SCALE IS EXAGGERATED BY A FACTOR OF 10. DUE TO THE EXAGGERATED SCALE IT MAY APPEAR THAT ANGLED FITTINGS WILL BE REQUIRED IN AREAS IN WHICH THEY ARE NOT.

NOTE: TEES SHALL BE ROTATED UPWARD APPROXIMATELY 45° FROM HORIZONTAL

Signature: Robert E. Mackey, P.E.
Florida Registration # 40176

REV. No.	DATE	DRAWN BY	CHKD BY	REMARKS



HEADER PROFILES - NORTH
LFG HEADER EXPANSION
ORANGE COUNTY CLASS III LANDFILL
ORANGE COUNTY, FLORIDA


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DRAWING NO.
C2

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HEADER PROFILES - SOUTH



SCALE:
HORIZONTAL: 1" = 100'
VERTICAL: 1" = 10'

NOTE: VERTICAL SCALE IS EXAGGERATED BY A FACTOR OF 10. DUE TO THE EXAGGERATED SCALE IT MAY APPEAR THAT ANGLED FITTINGS WILL BE REQUIRED IN AREAS IN WHICH THEY ARE NOT.

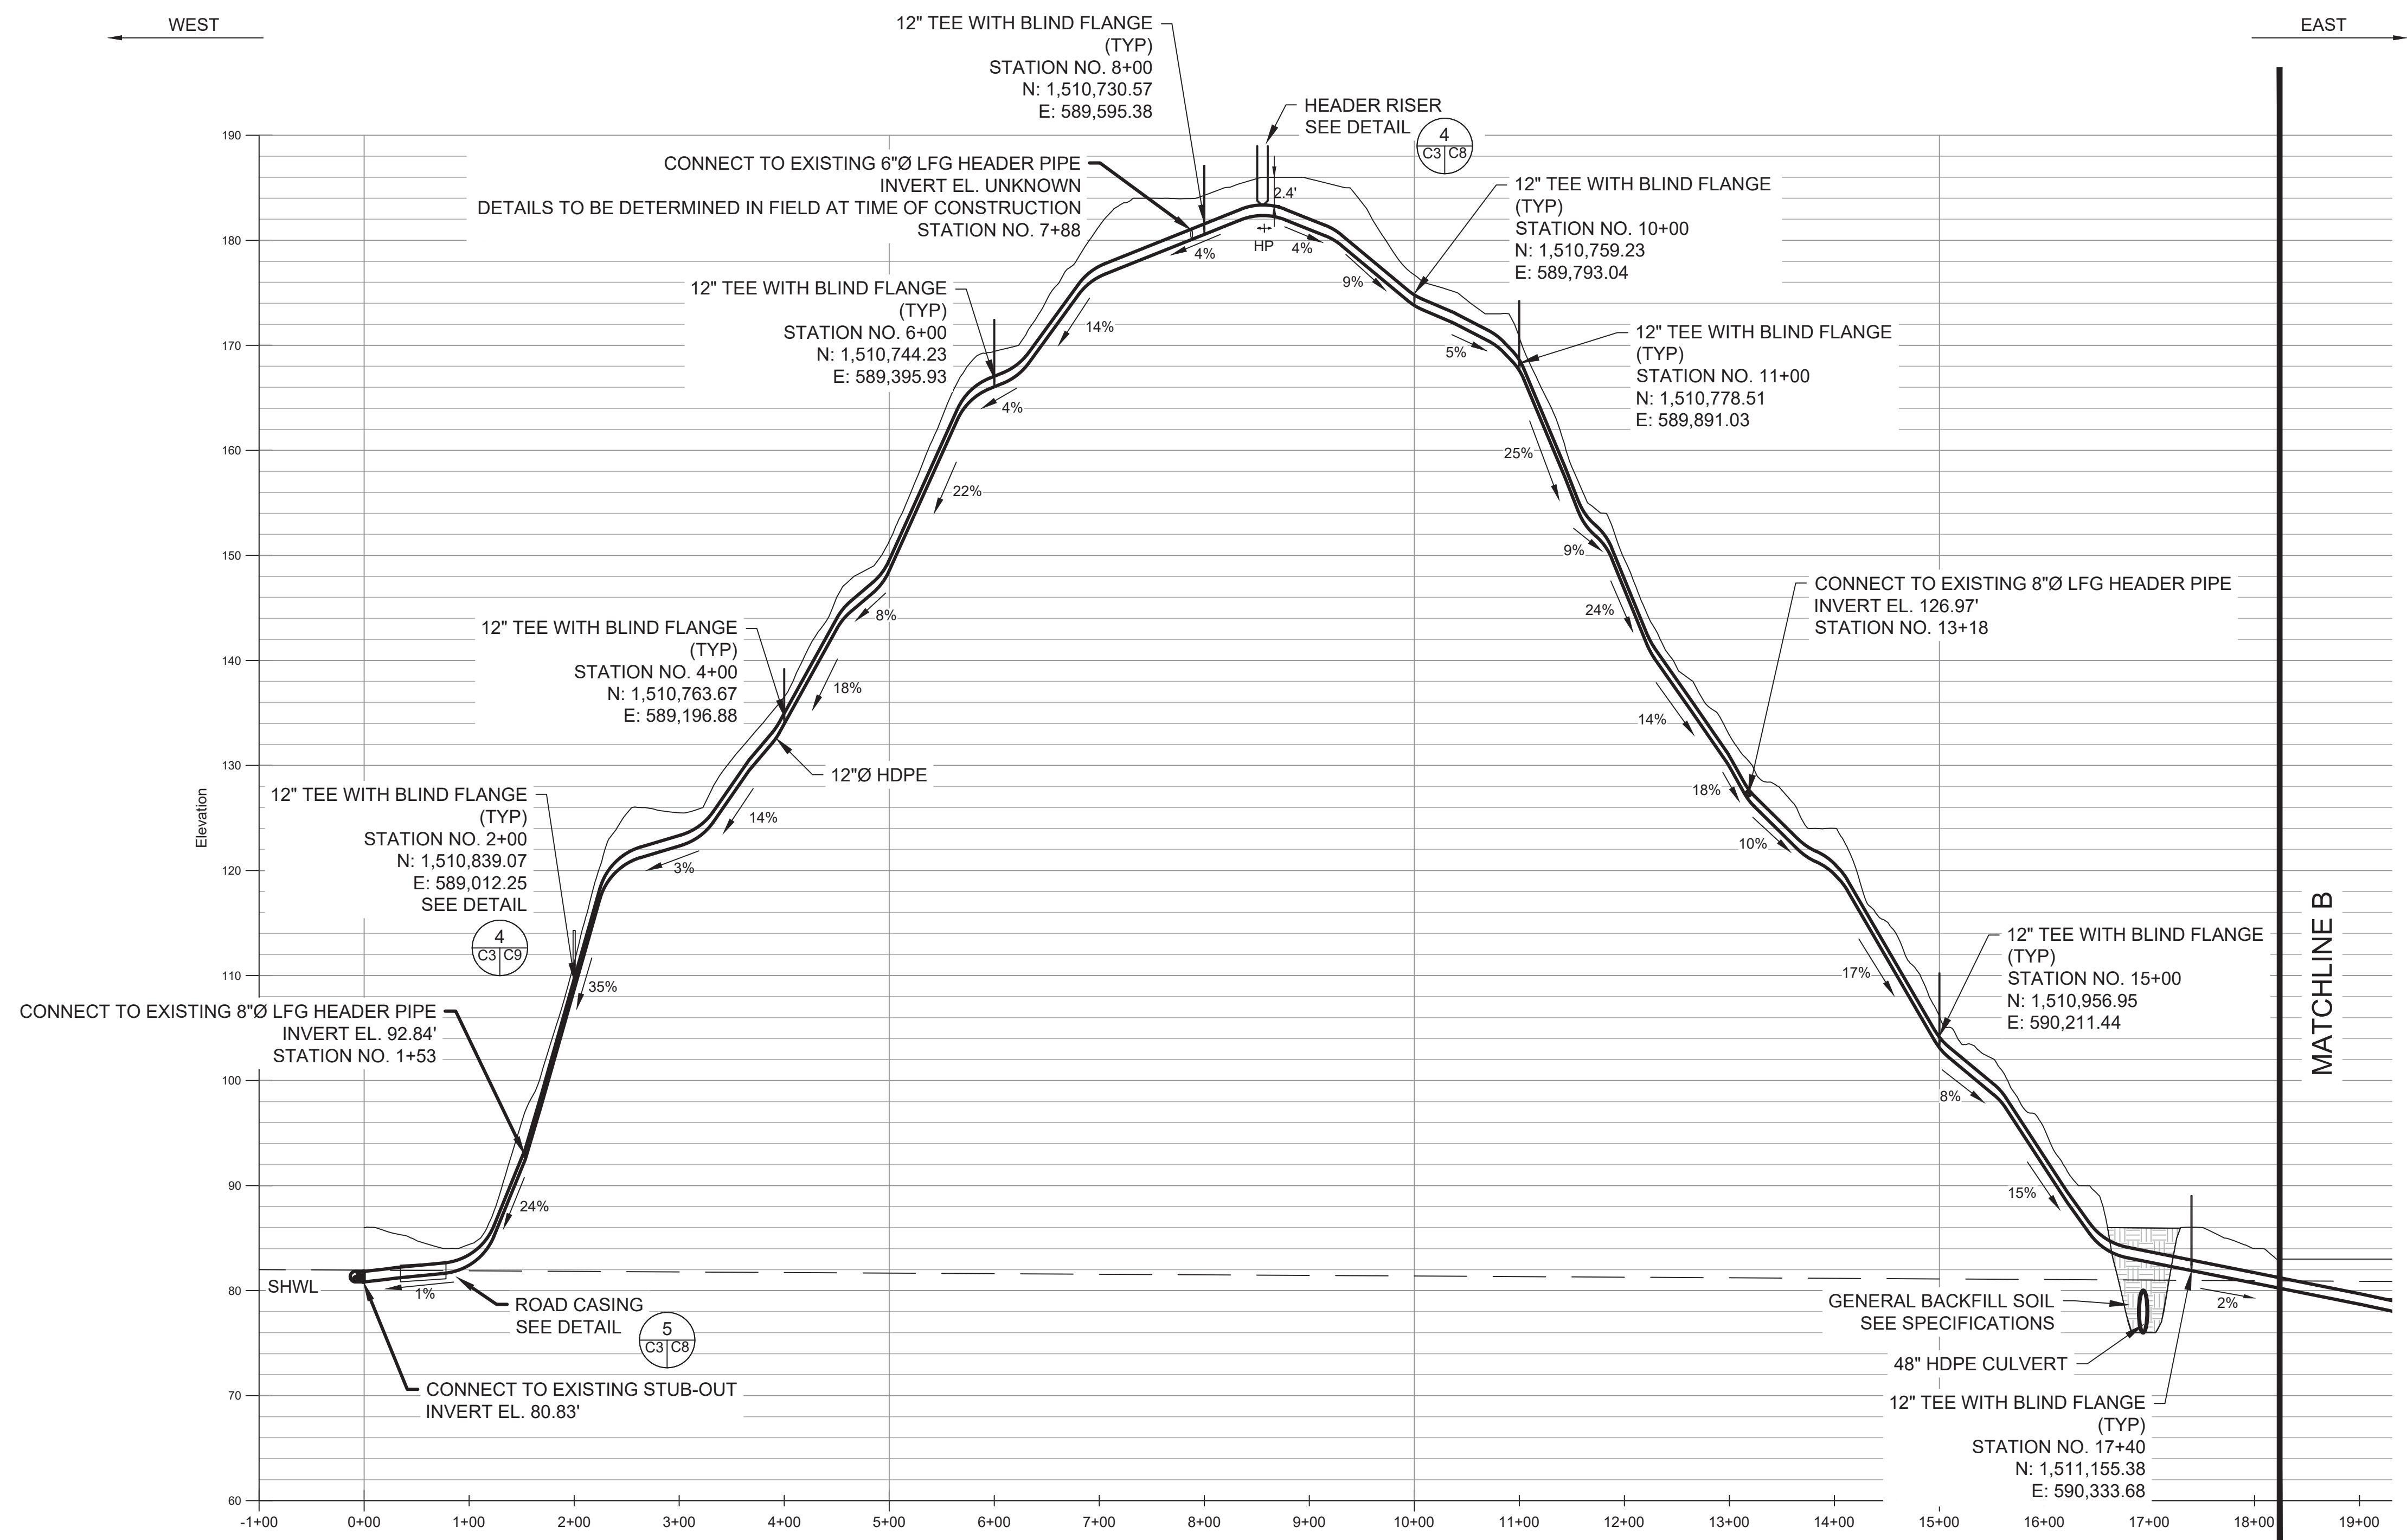Signature: Robert E. Maskey, P.E.
Florida Registration # 40176
Date: _____

REV. No.	DATE	DRAWN BY	CHECK BY	REMARKS



HEADER PROFILES - SOUTH (1 OF 2)
LFG HEADER EXPANSION
ORANGE COUNTY CLASS III LANDFILL
ORANGE COUNTY, FLORIDA

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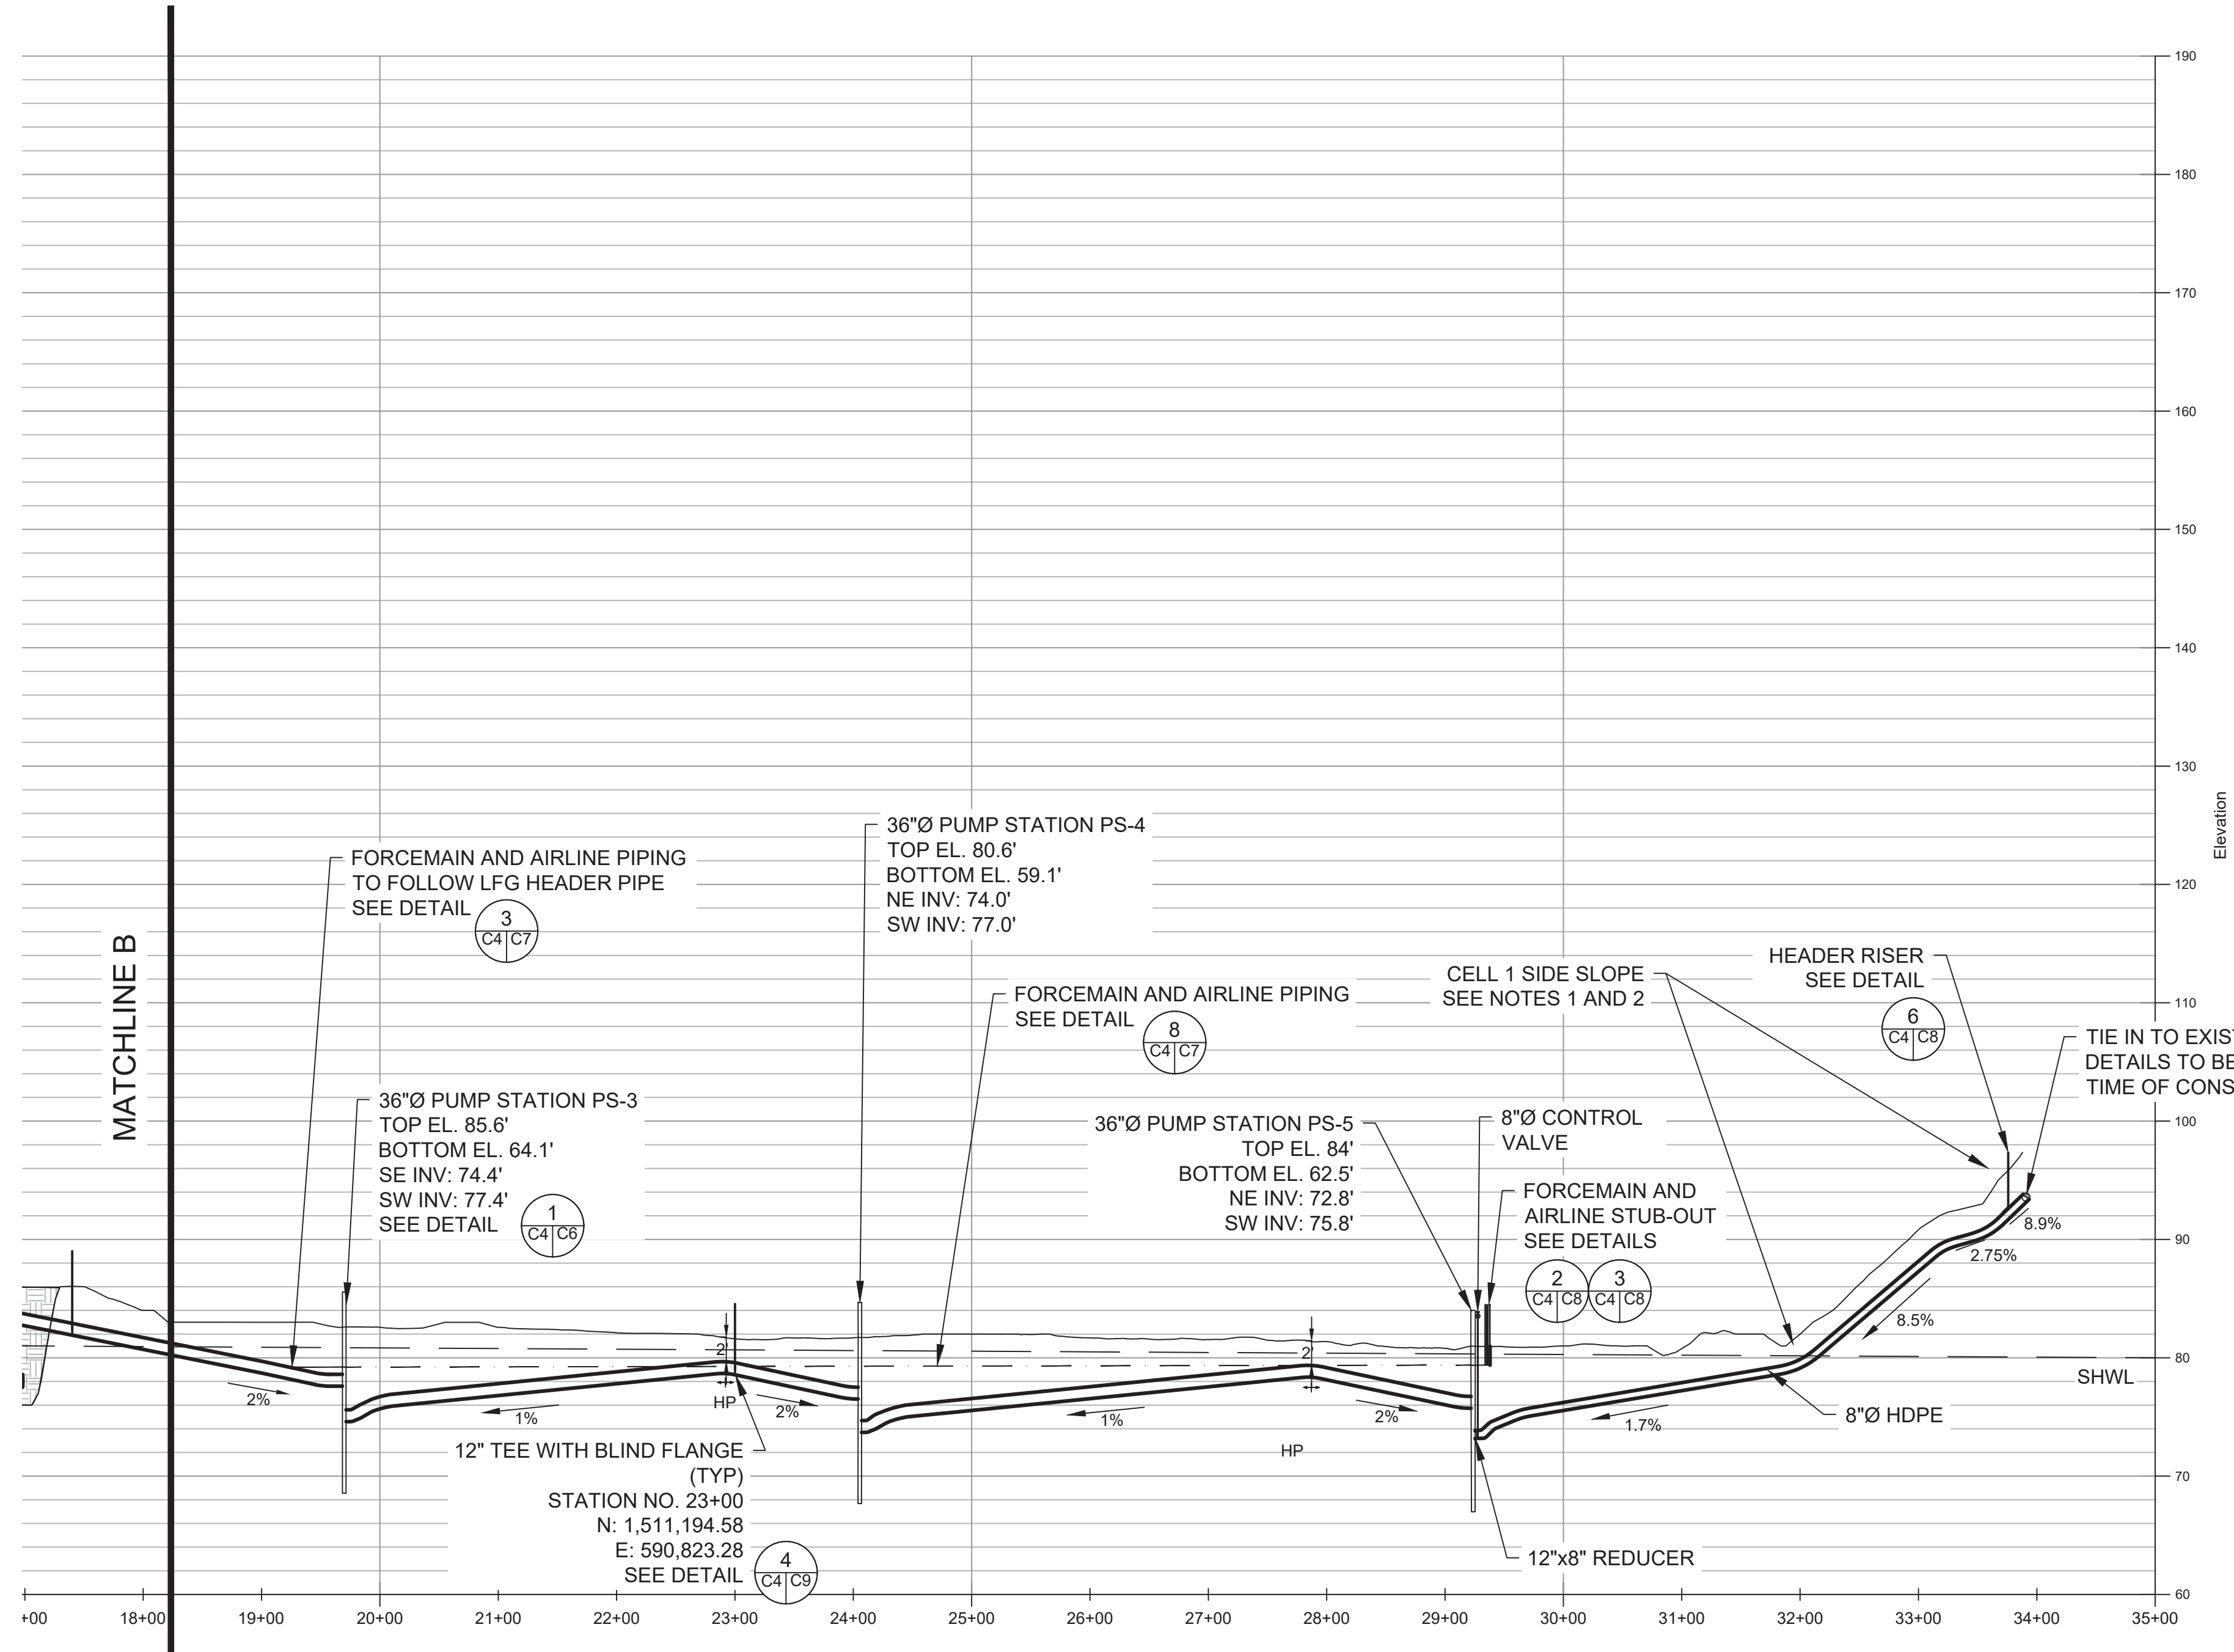
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C3

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A B C D E F

WEST ← → EAST

HEADER PROFILES - SOUTH



- NOTES:
1. HEADER PIPE TO BE PLACED ON OR ABOVE TOP LINER OF CELL 1. DEPTH OF LINER BELOW SURFACE TO BE VERIFIED BY CONTRACTOR. ANY DAMAGE TO THE LINER TO BE REPAIRED BY THE CONTRACTOR AT NO COST TO THE OWNER.
 2. DISTURBED AREA ON CELL 1 SIDE SLOPE IS TO BE SODDED.
 3. VERTICAL SCALE IS EXAGGERATED BY A FACTOR OF 10. DUE TO THE EXAGGERATED SCALE IT MAY APPEAR THAT ANGLED FITTINGS WILL BE REQUIRED IN AREAS IN WHICH THEY ARE NOT.

SCALE:
HORIZONTAL: 1" = 100'
VERTICAL: 1" = 10'

Signature: Robert E. Miskay, P.E.
Florida Registration # 40176
Date: _____

REV. No	DATE	DRAWN BY	CHKD BY	REMARKS




HEADER PROFILES - SOUTH (2 OF 2)
LFG HEADER EXPANSION
ORANGE COUNTY CLASS III LANDFILL
ORANGE COUNTY, FLORIDA

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DRAWING NO.
C4

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HEADER PROFILES -WEST



SCALE:
HORIZONTAL: 1" = 70'
VERTICAL: 1" = 7'

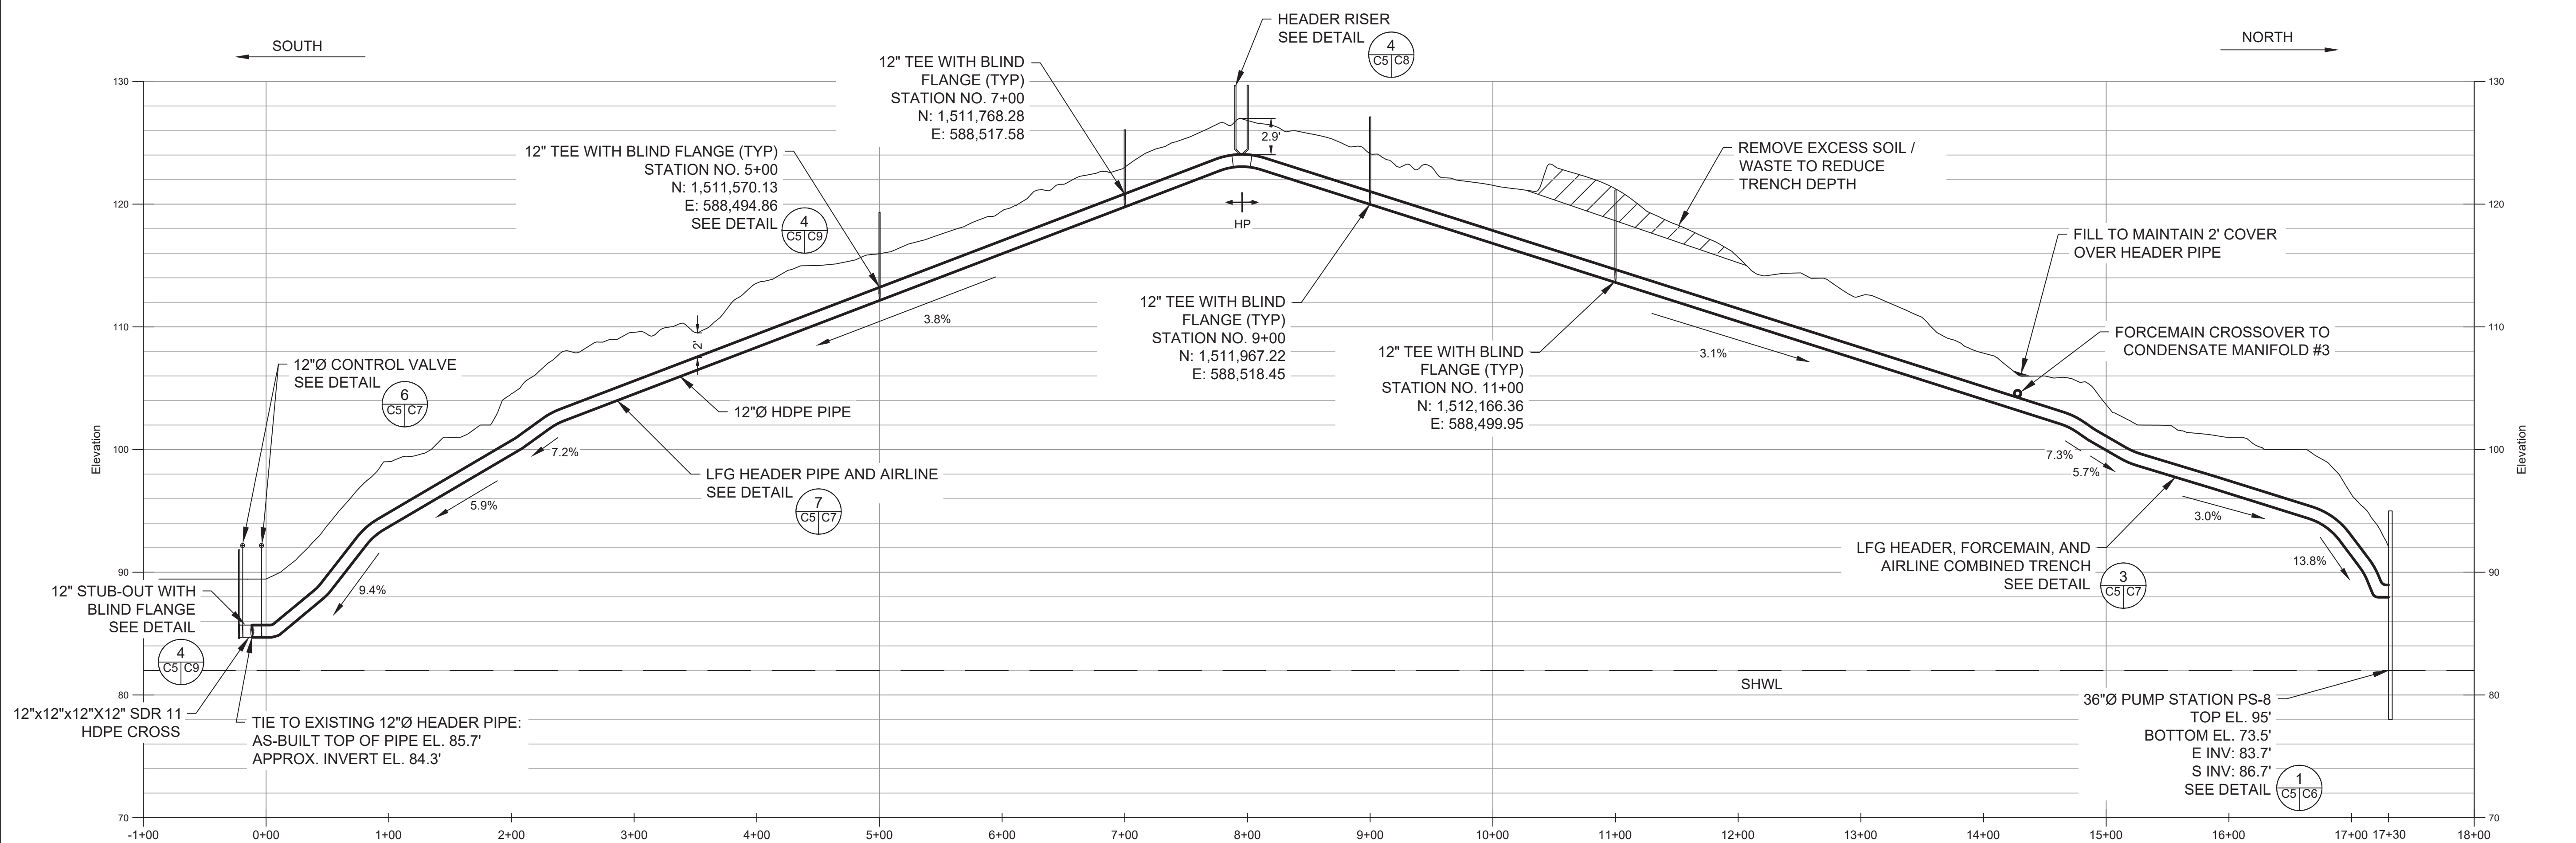NOTE: VERTICAL SCALE IS EXAGGERATED BY A FACTOR OF 10. DUE TO THE EXAGGERATED SCALE IT MAY APPEAR THAT ANGLED FITTINGS WILL BE REQUIRED IN AREAS IN WHICH THEY ARE NOT.

Signature: Robert E. Maskey, P.E.
Florida Registration # 40176
Date: _____

REV. No.	DATE	DRAWN BY	CHKD BY	REMARKS




HEADER PROFILES - WEST
LFG HEADER EXPANSION
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ORANGE COUNTY, FLORIDA

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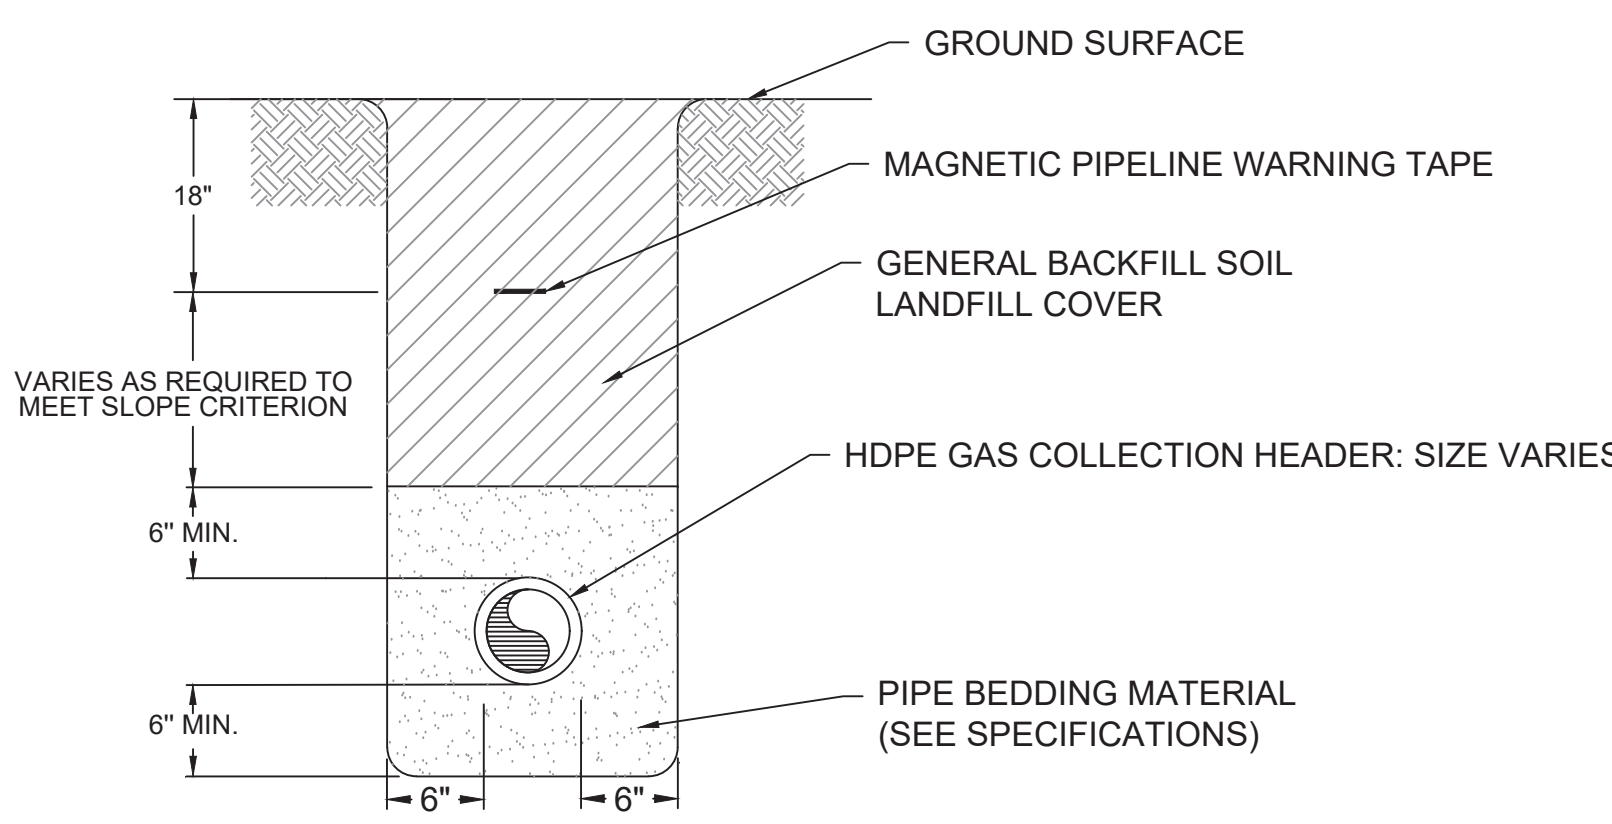
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C5

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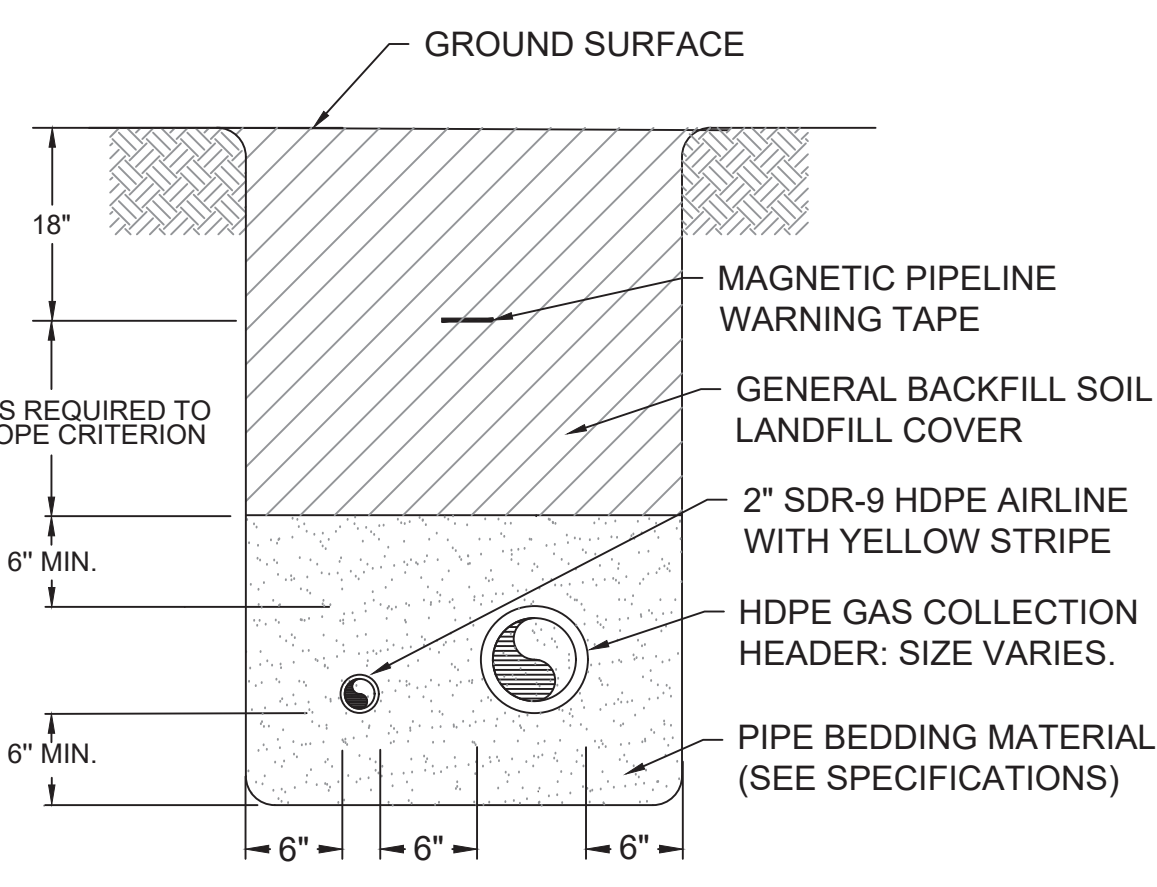
1 **1**
C1|C7 C2|C7
FORCEMAIN AND AIRLINE TRENCH DETAIL NTS

NOTE: FORCEMAIN TO BE INSTALLED ON THE LANDFILL SIDE (INSIDE) OF THE TRENCH. AIRLINE TO BE INSTALLED ON THE ROAD SIDE (OUTSIDE) OF THE TRENCH.

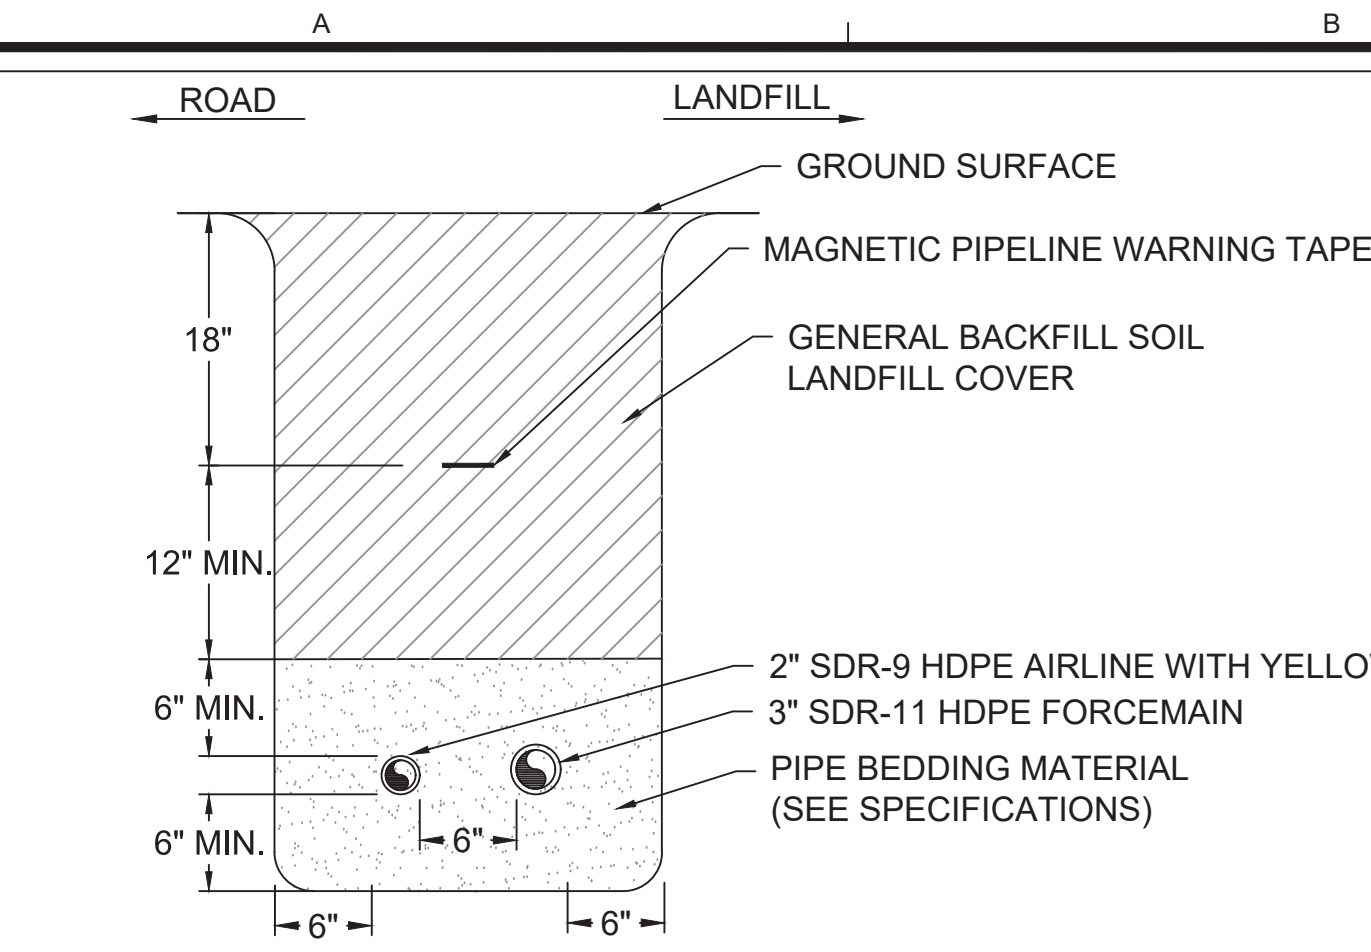


2
C1|C7
HEADER TRENCH DETAIL NTS


NO FORCEMAIN OR AIRLINE




7 **7**
C1|C7 C5|C7
AIRLINE AND HEADER TRENCH DETAIL NTS

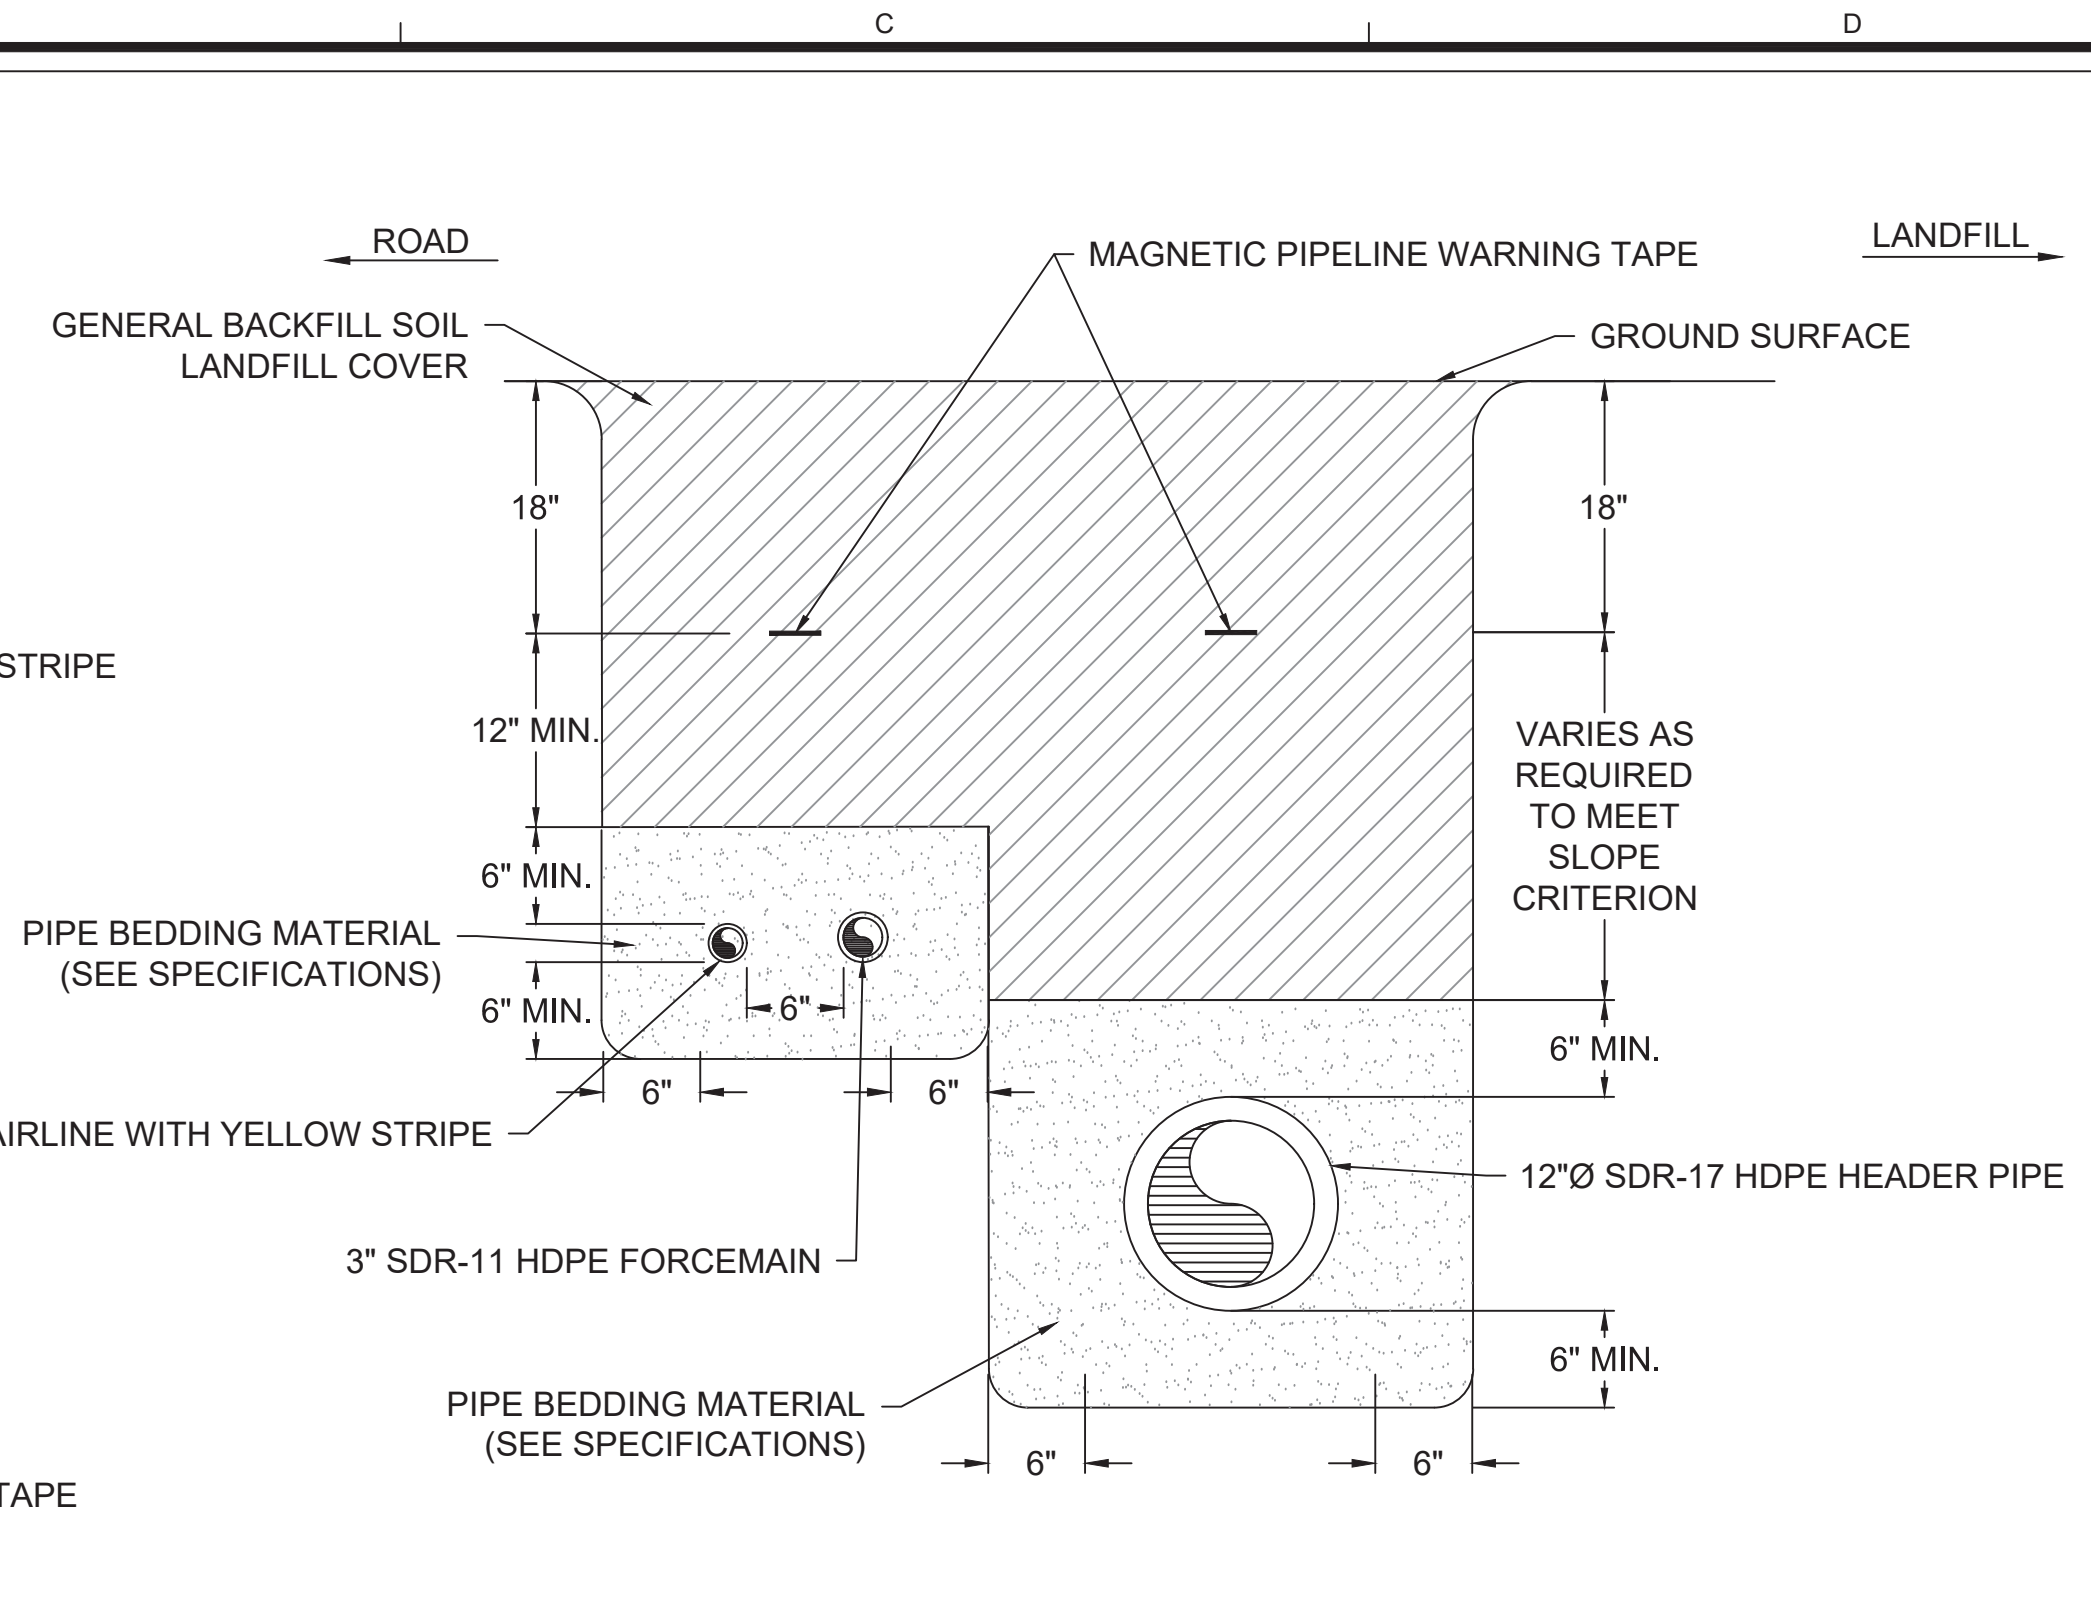

8 **8**
C1|C7 C4|C7
COMBINED PIPING TRENCH DETAIL NTS

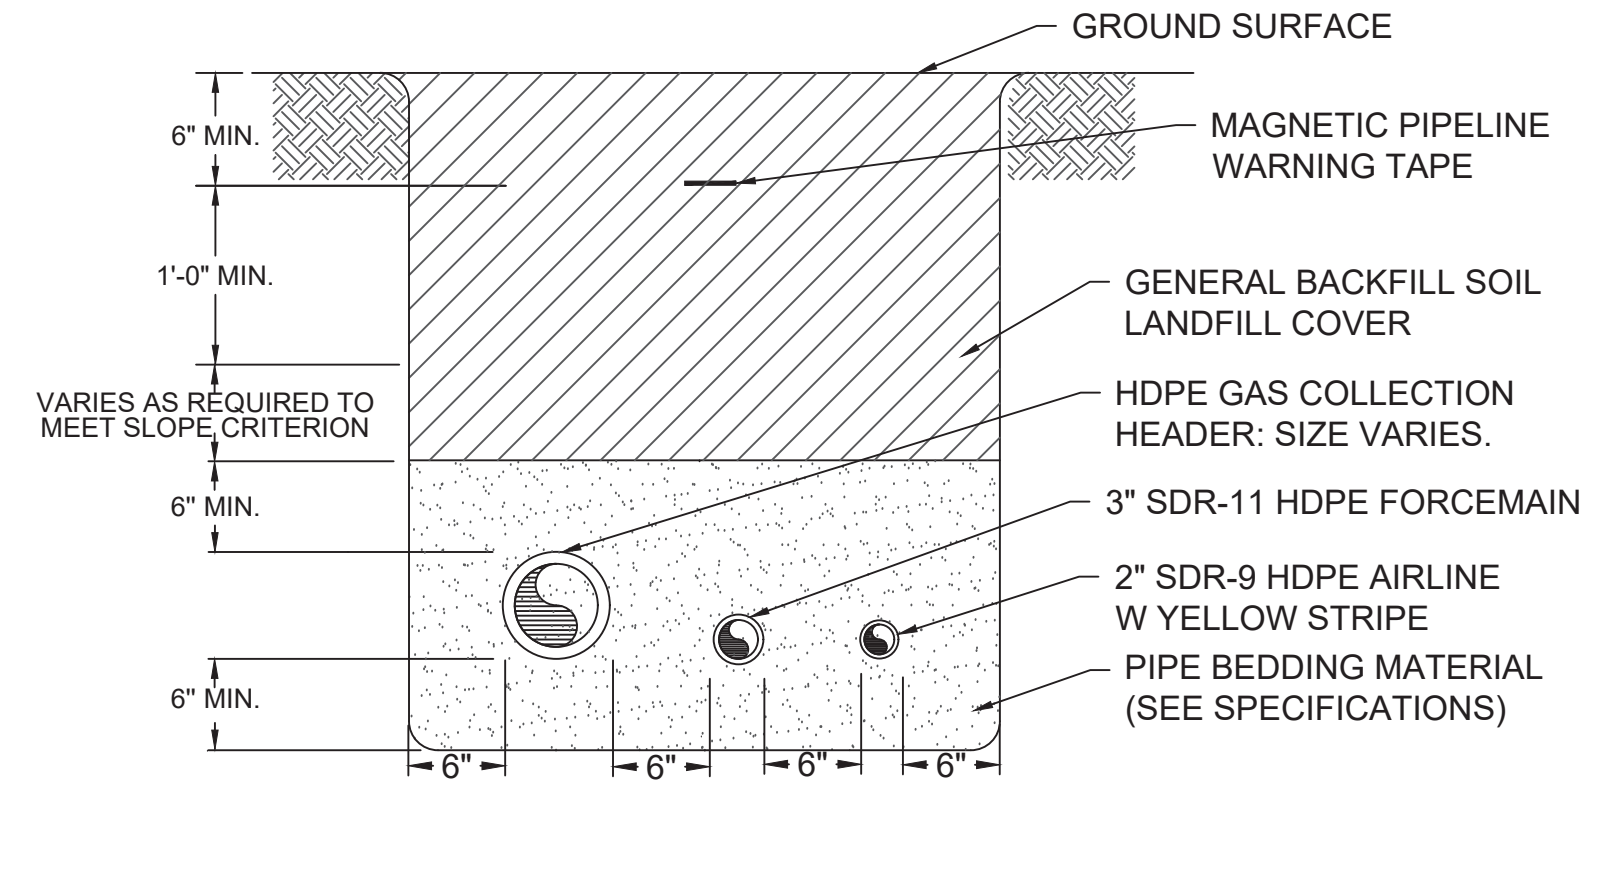


3 **3** **3**
C1|C7 C2|C7 C4|C7
3 **3**
C5|C7 C9|C7
COMBINED PIPING TRENCH DETAIL NTS

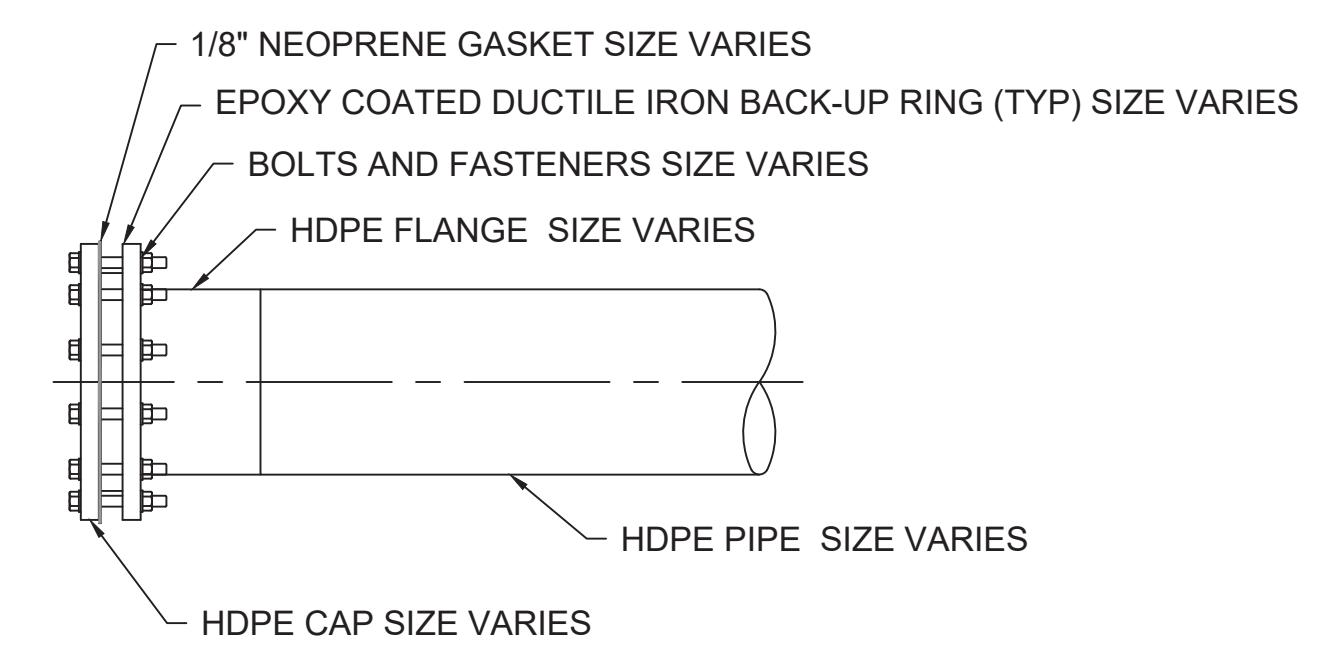


4 **4**
C8|C7 C9|C7
BLIND FLANGE CONNECTION DETAIL NTS

NOTE: BELOW GRADE FLANGE NUTS, BOLTS, STUDS, AND WASHERS TO BE STAINLESS STEEL TYPE 316. BELOW GRADE FLANGE INSTALLATIONS TO BE WRAPPED IN PLASTIC SHEETING.

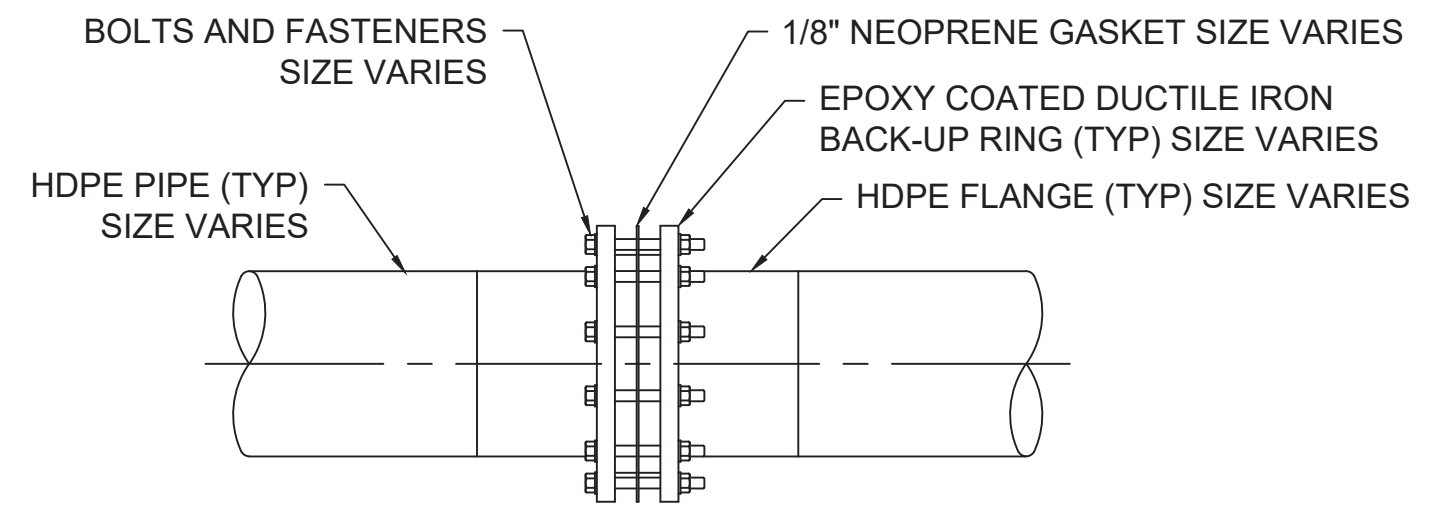

5 **5**
C6|C7 C9|C7
FLANGE CONNECTION DETAIL NTS

NOTE: BELOW GRADE FLANGE NUTS, BOLTS, STUDS, AND WASHERS TO BE STAINLESS STEEL TYPE 316. BELOW GRADE FLANGE INSTALLATIONS TO BE WRAPPED IN PLASTIC SHEETING.

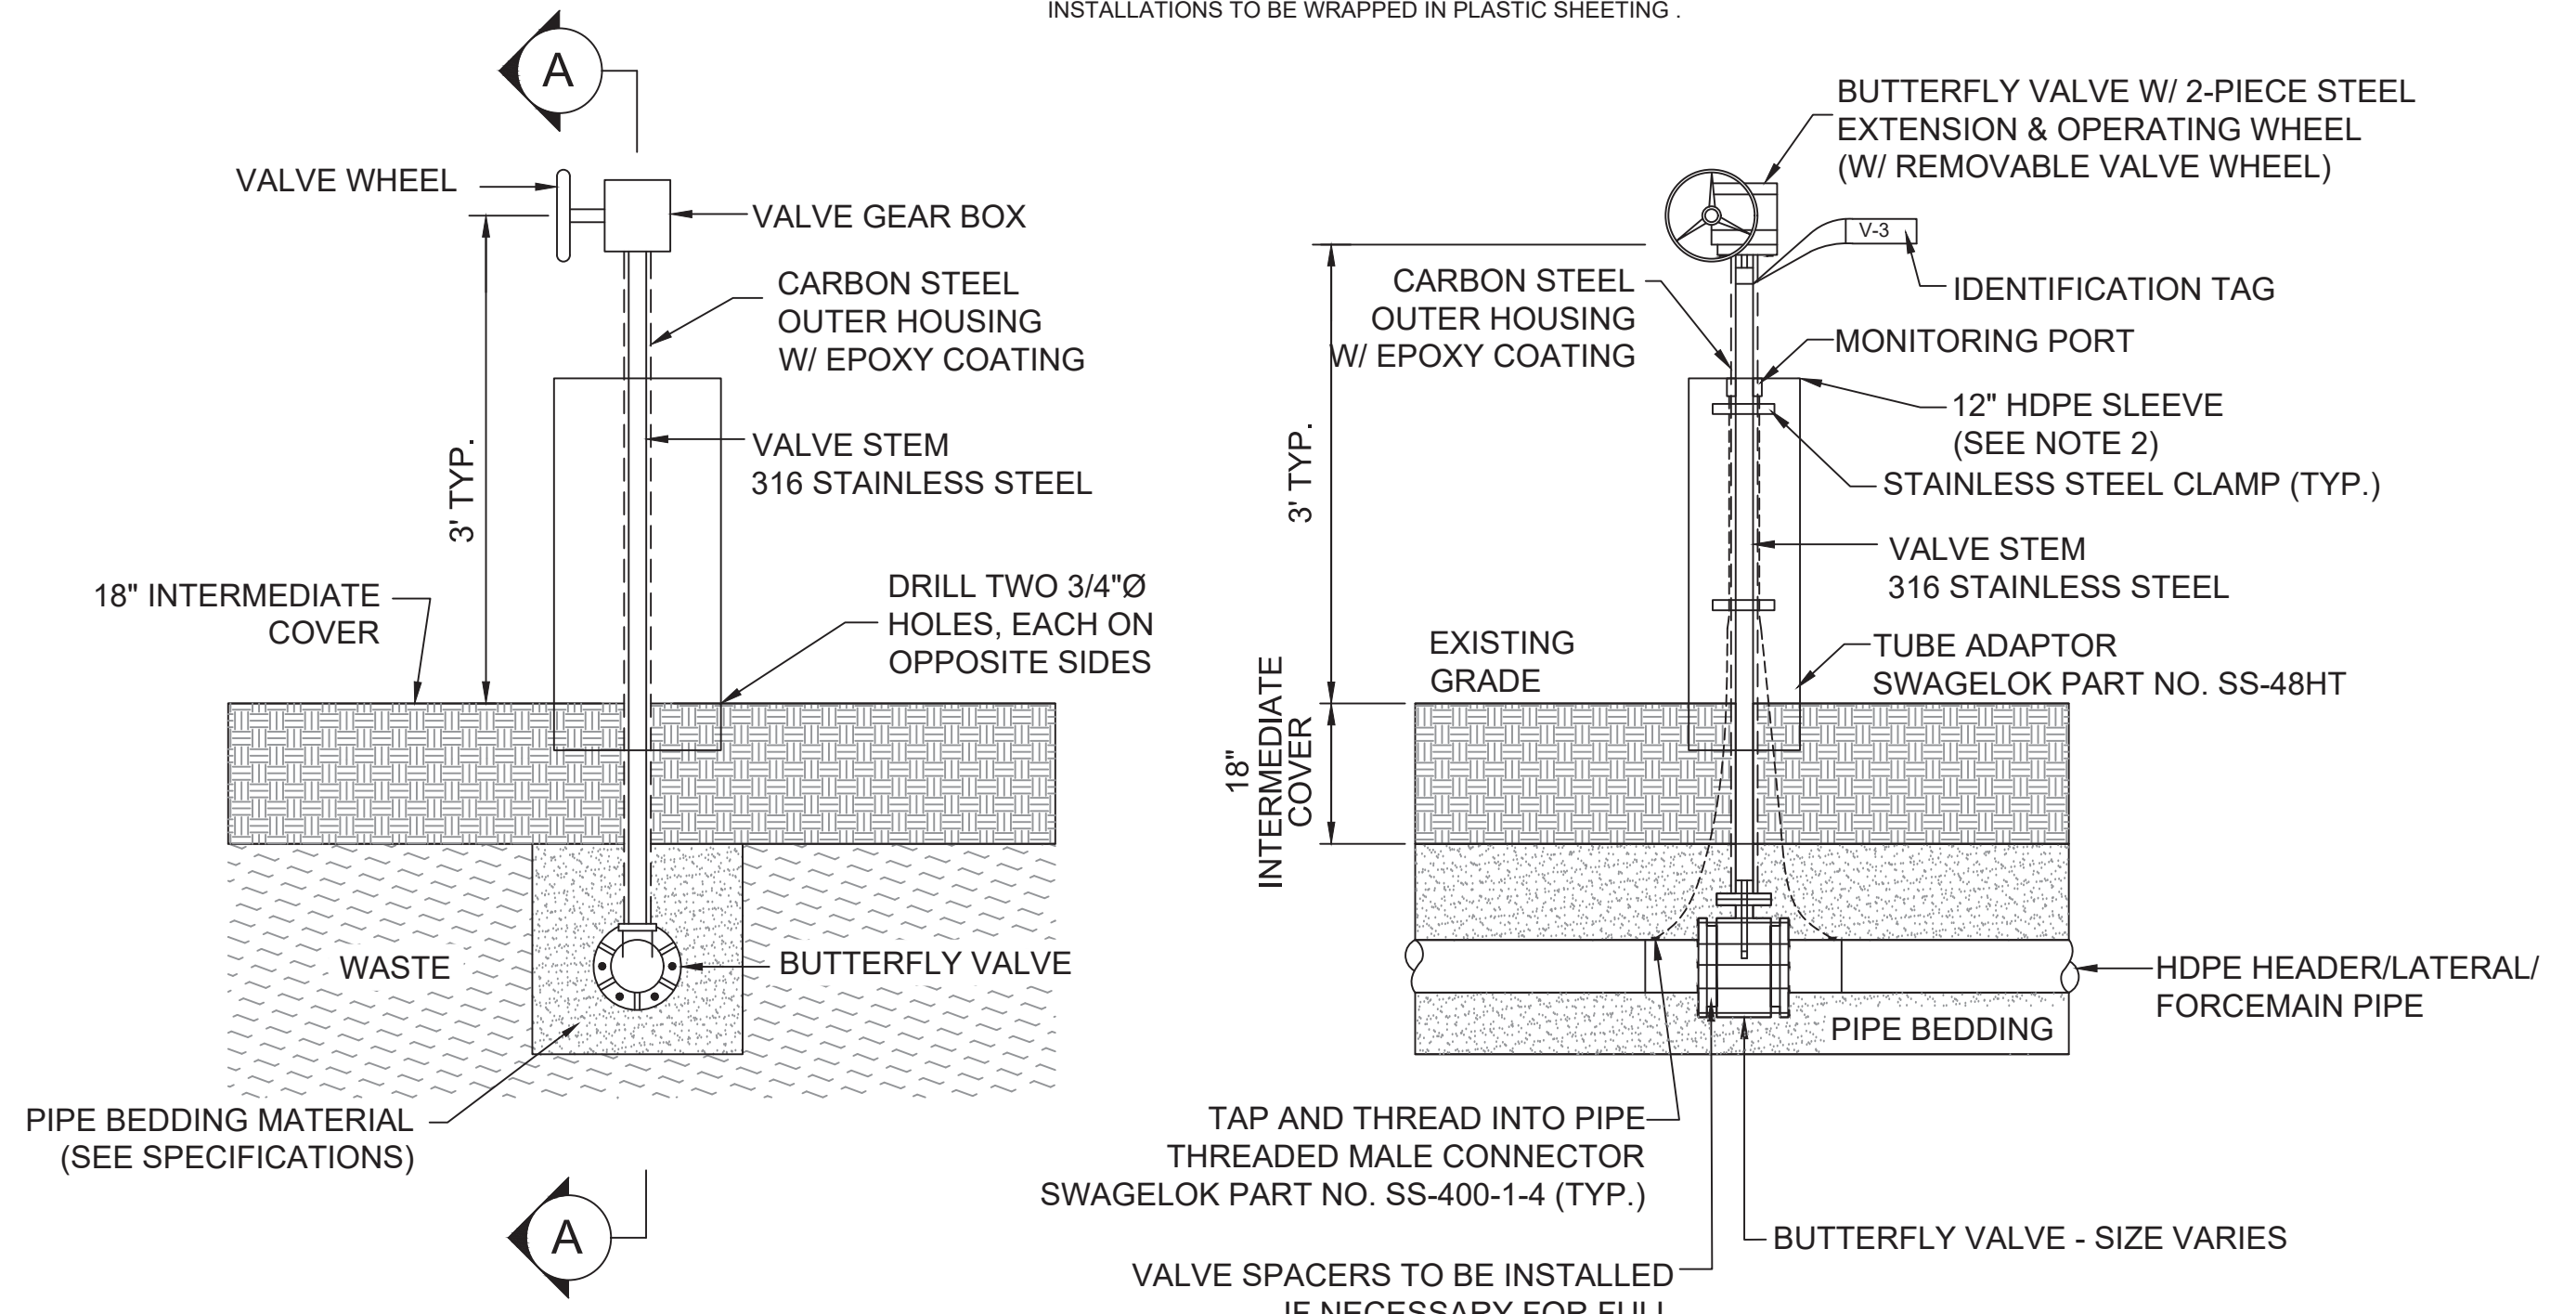

NOTES:
1. ALL VALVES SHALL BE INSPECTED BY OWNER'S REPRESENTATIVE PRIOR TO BACKFILL.
2. HDPE SLEEVE SHALL BE EMBEDDED AT LEAST 6" INTO THE COMPACTED SOIL LAYER AND TERMINATE AT THE SAME ELEVATION AS THE SAMPLING PORTS.
3. HEADER VALVES TO BE 8"Ø OR 12"Ø DEPENDING ON LOCATION AND HEADER PIPE SIZE. REFER TO DRAWING C1 FOR LOCATIONS.

6 **6** **6**
C1|C7 C2|C7 C5|C7
TYPICAL CONTROL VALVE DETAIL NTS

REFER TO DRAWING G-2 FOR LEGEND.

Date _____
Signature _____
Robert E. Maskey, P.E.
Florida Registration # 40176

REV. No.	DATE	DRAWN BY	CHECKED BY	REMARKS




DETAILS (2 OF 4)
ORANGE COUNTY CLASS III LANDFILL
ORANGE COUNTY, FLORIDA

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(407) 475-9163 FAX 475-9169
Certification of Authorization # 7831
S2Li


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C7

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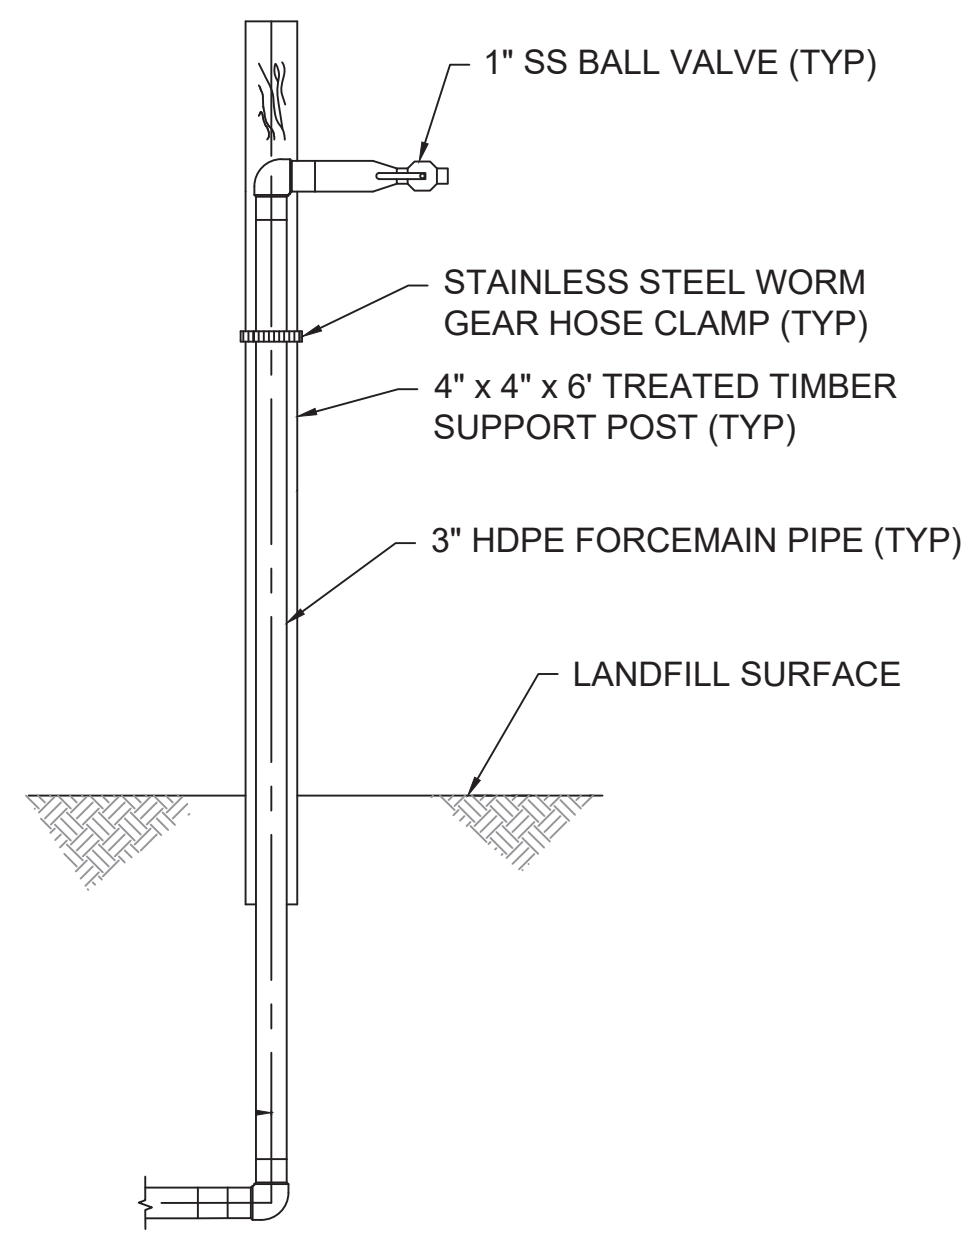
1
C1/C8 FORCEMAIN AND AIRLINE CROSSOVER DETAIL NTS

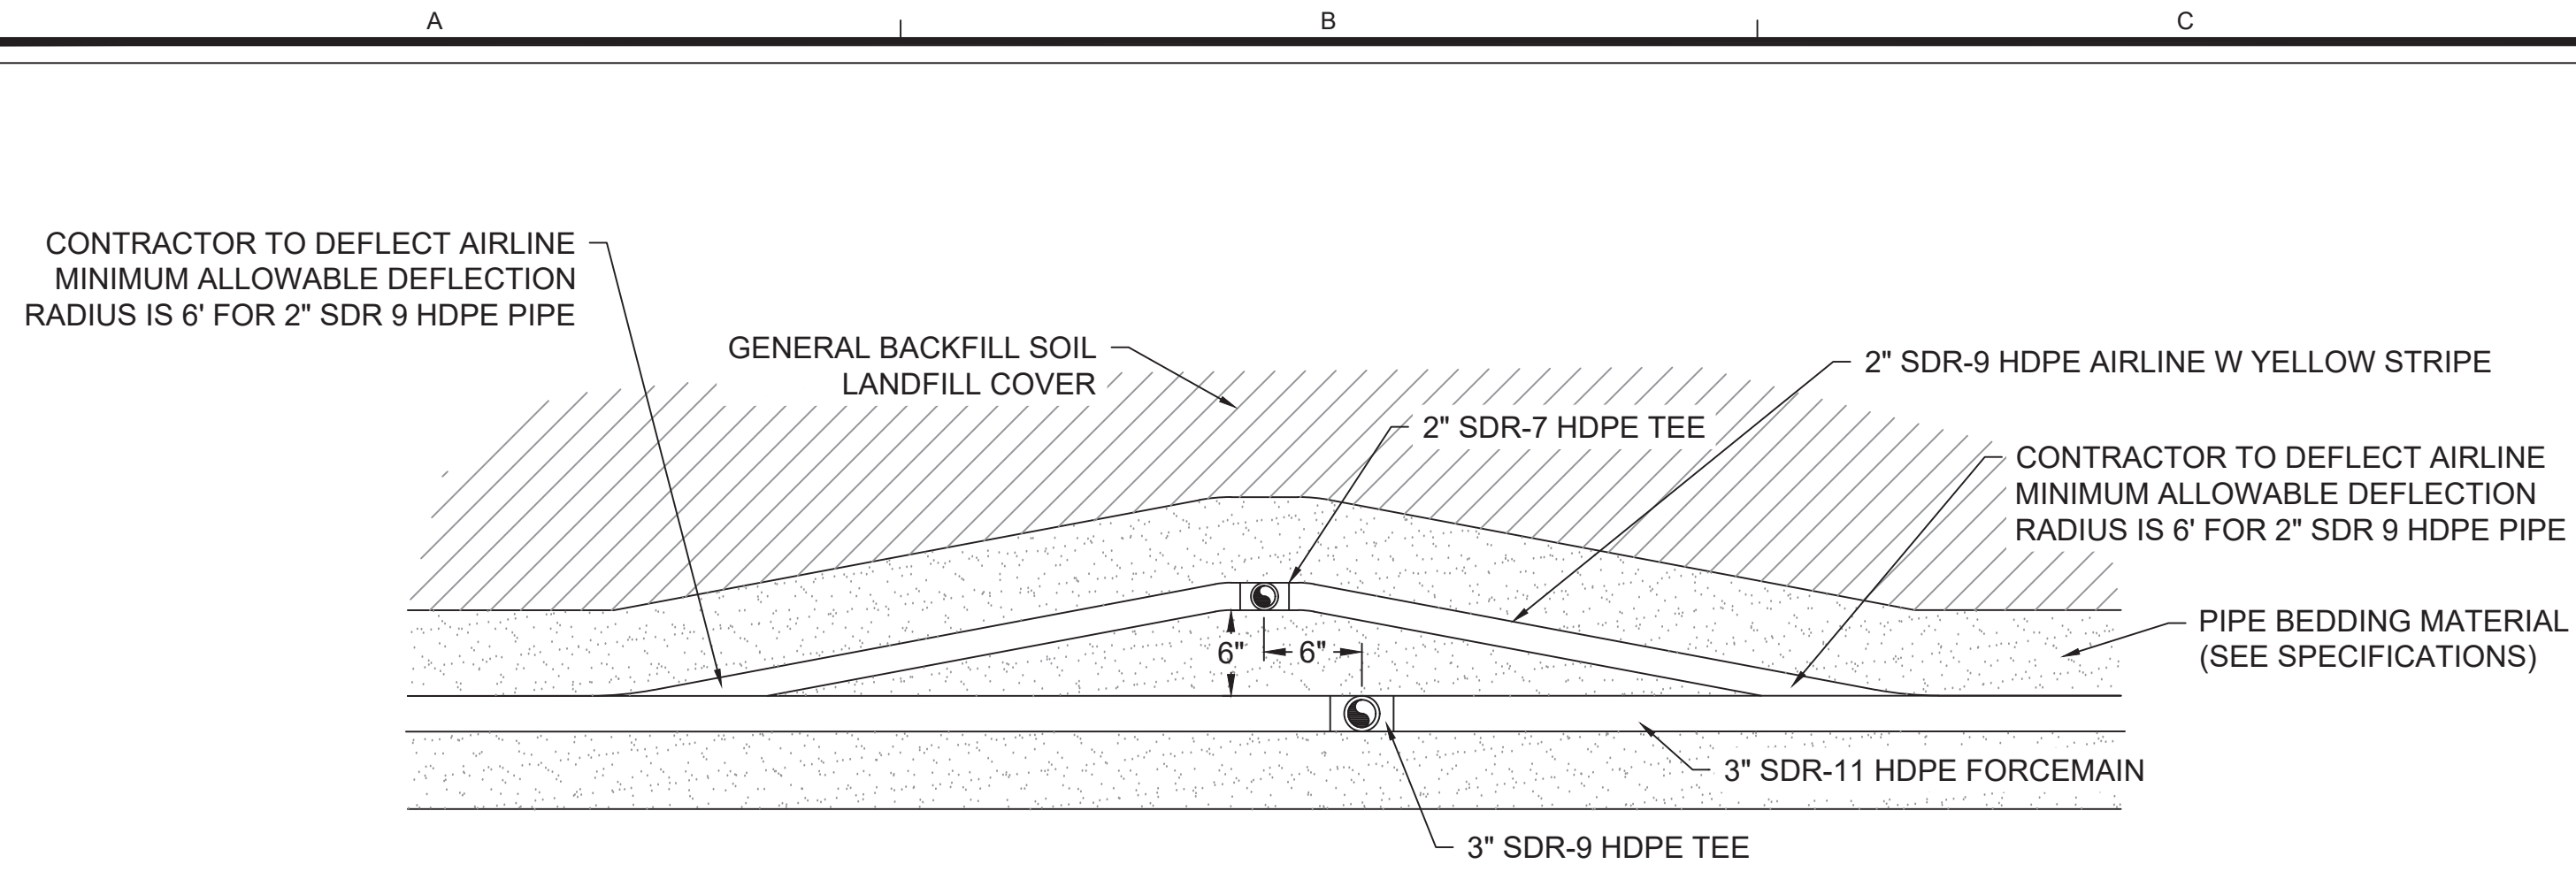NOTE:
DEFLECT AIRLINE 6" ABOVE FORCEMAIN WHEN CROSSING TO MAKE CONNECTIONS AT PUMP STATIONS.




2
C1/C8 2
C2/C8 2
C4/C8 2
C9/C8 2 TYPICAL AIRLINE ISOLATION / BLOWOFF STATION DETAIL NTS

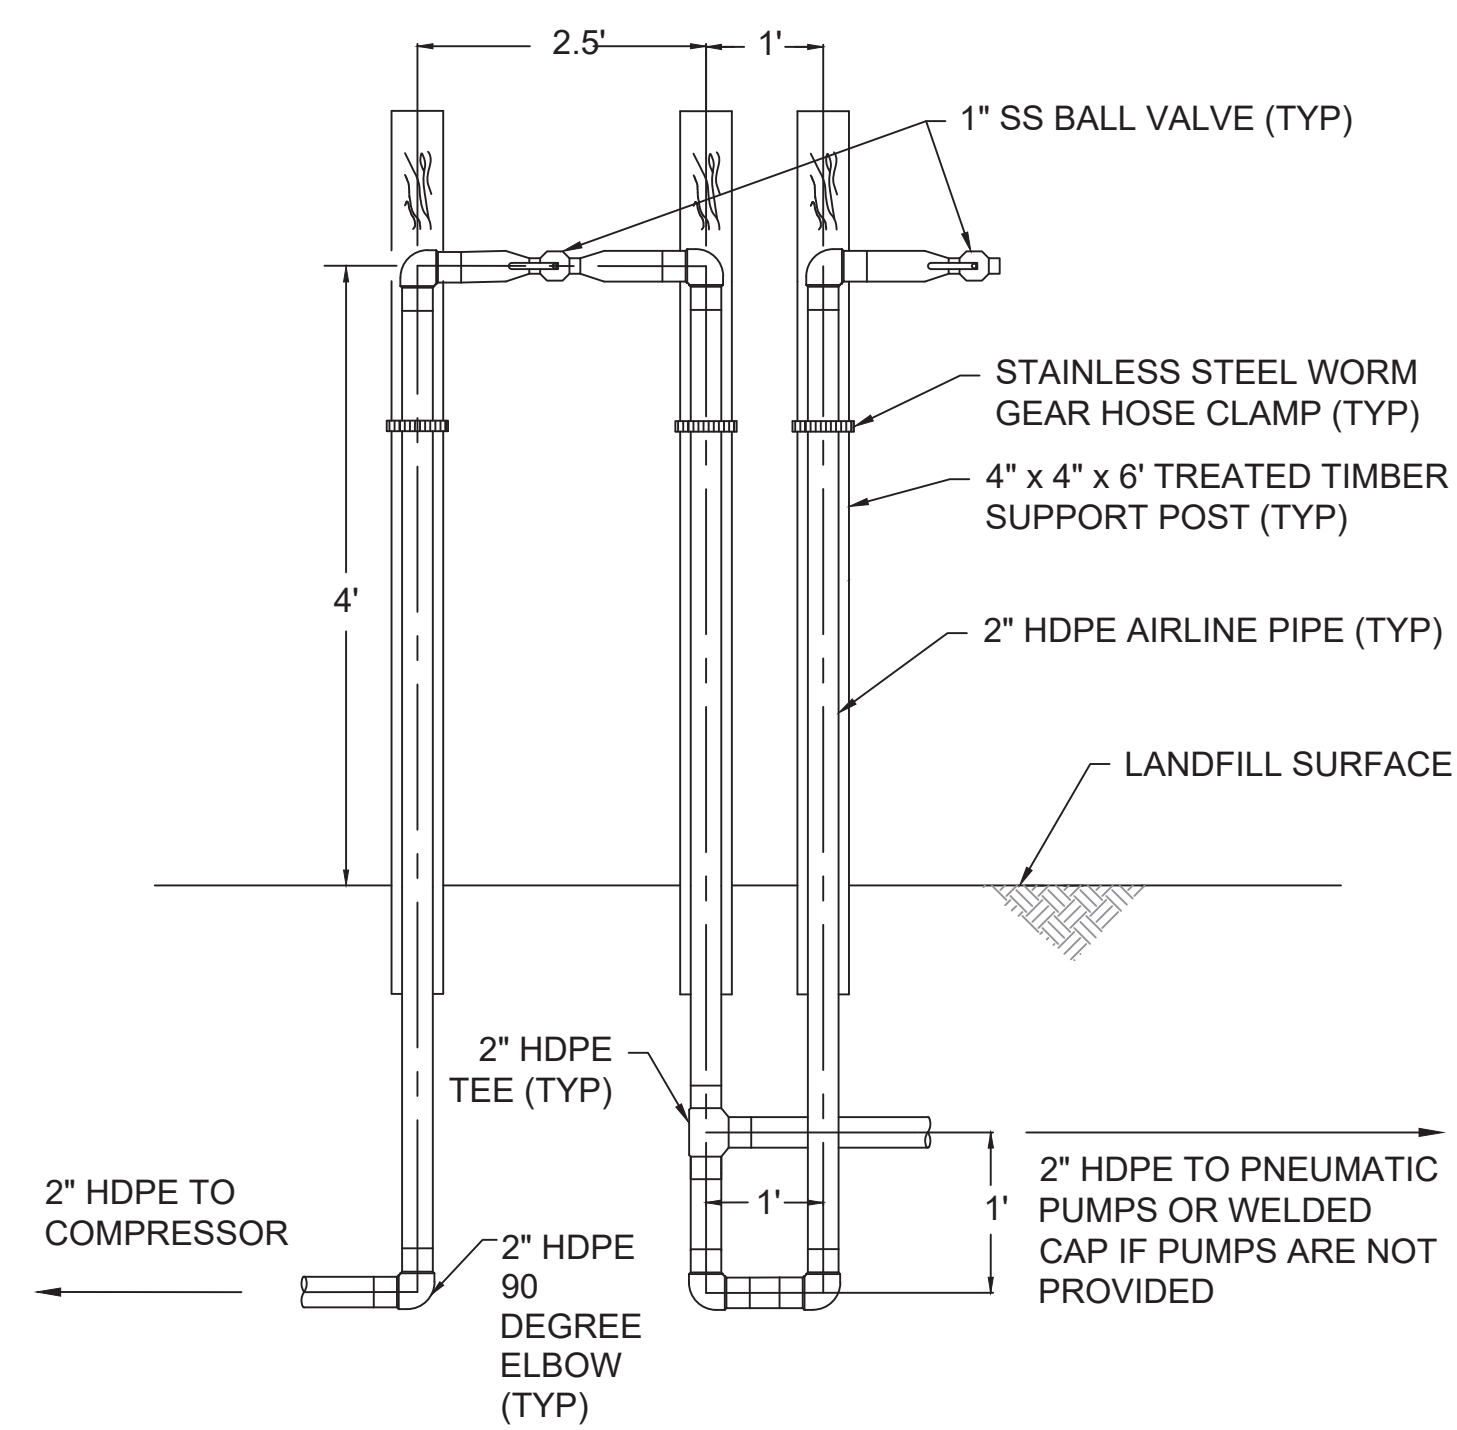NOTE:
CLAMPS AND FITTINGS TO BE STAINLESS STEEL TYPE 316




3
C1/C8 3
C2/C8 3
C4/C8 3 TYPICAL FORCEMAIN STUB-OUT DETAIL NTS

NOTE:
CLAMPS AND FITTINGS TO BE STAINLESS STEEL TYPE 316

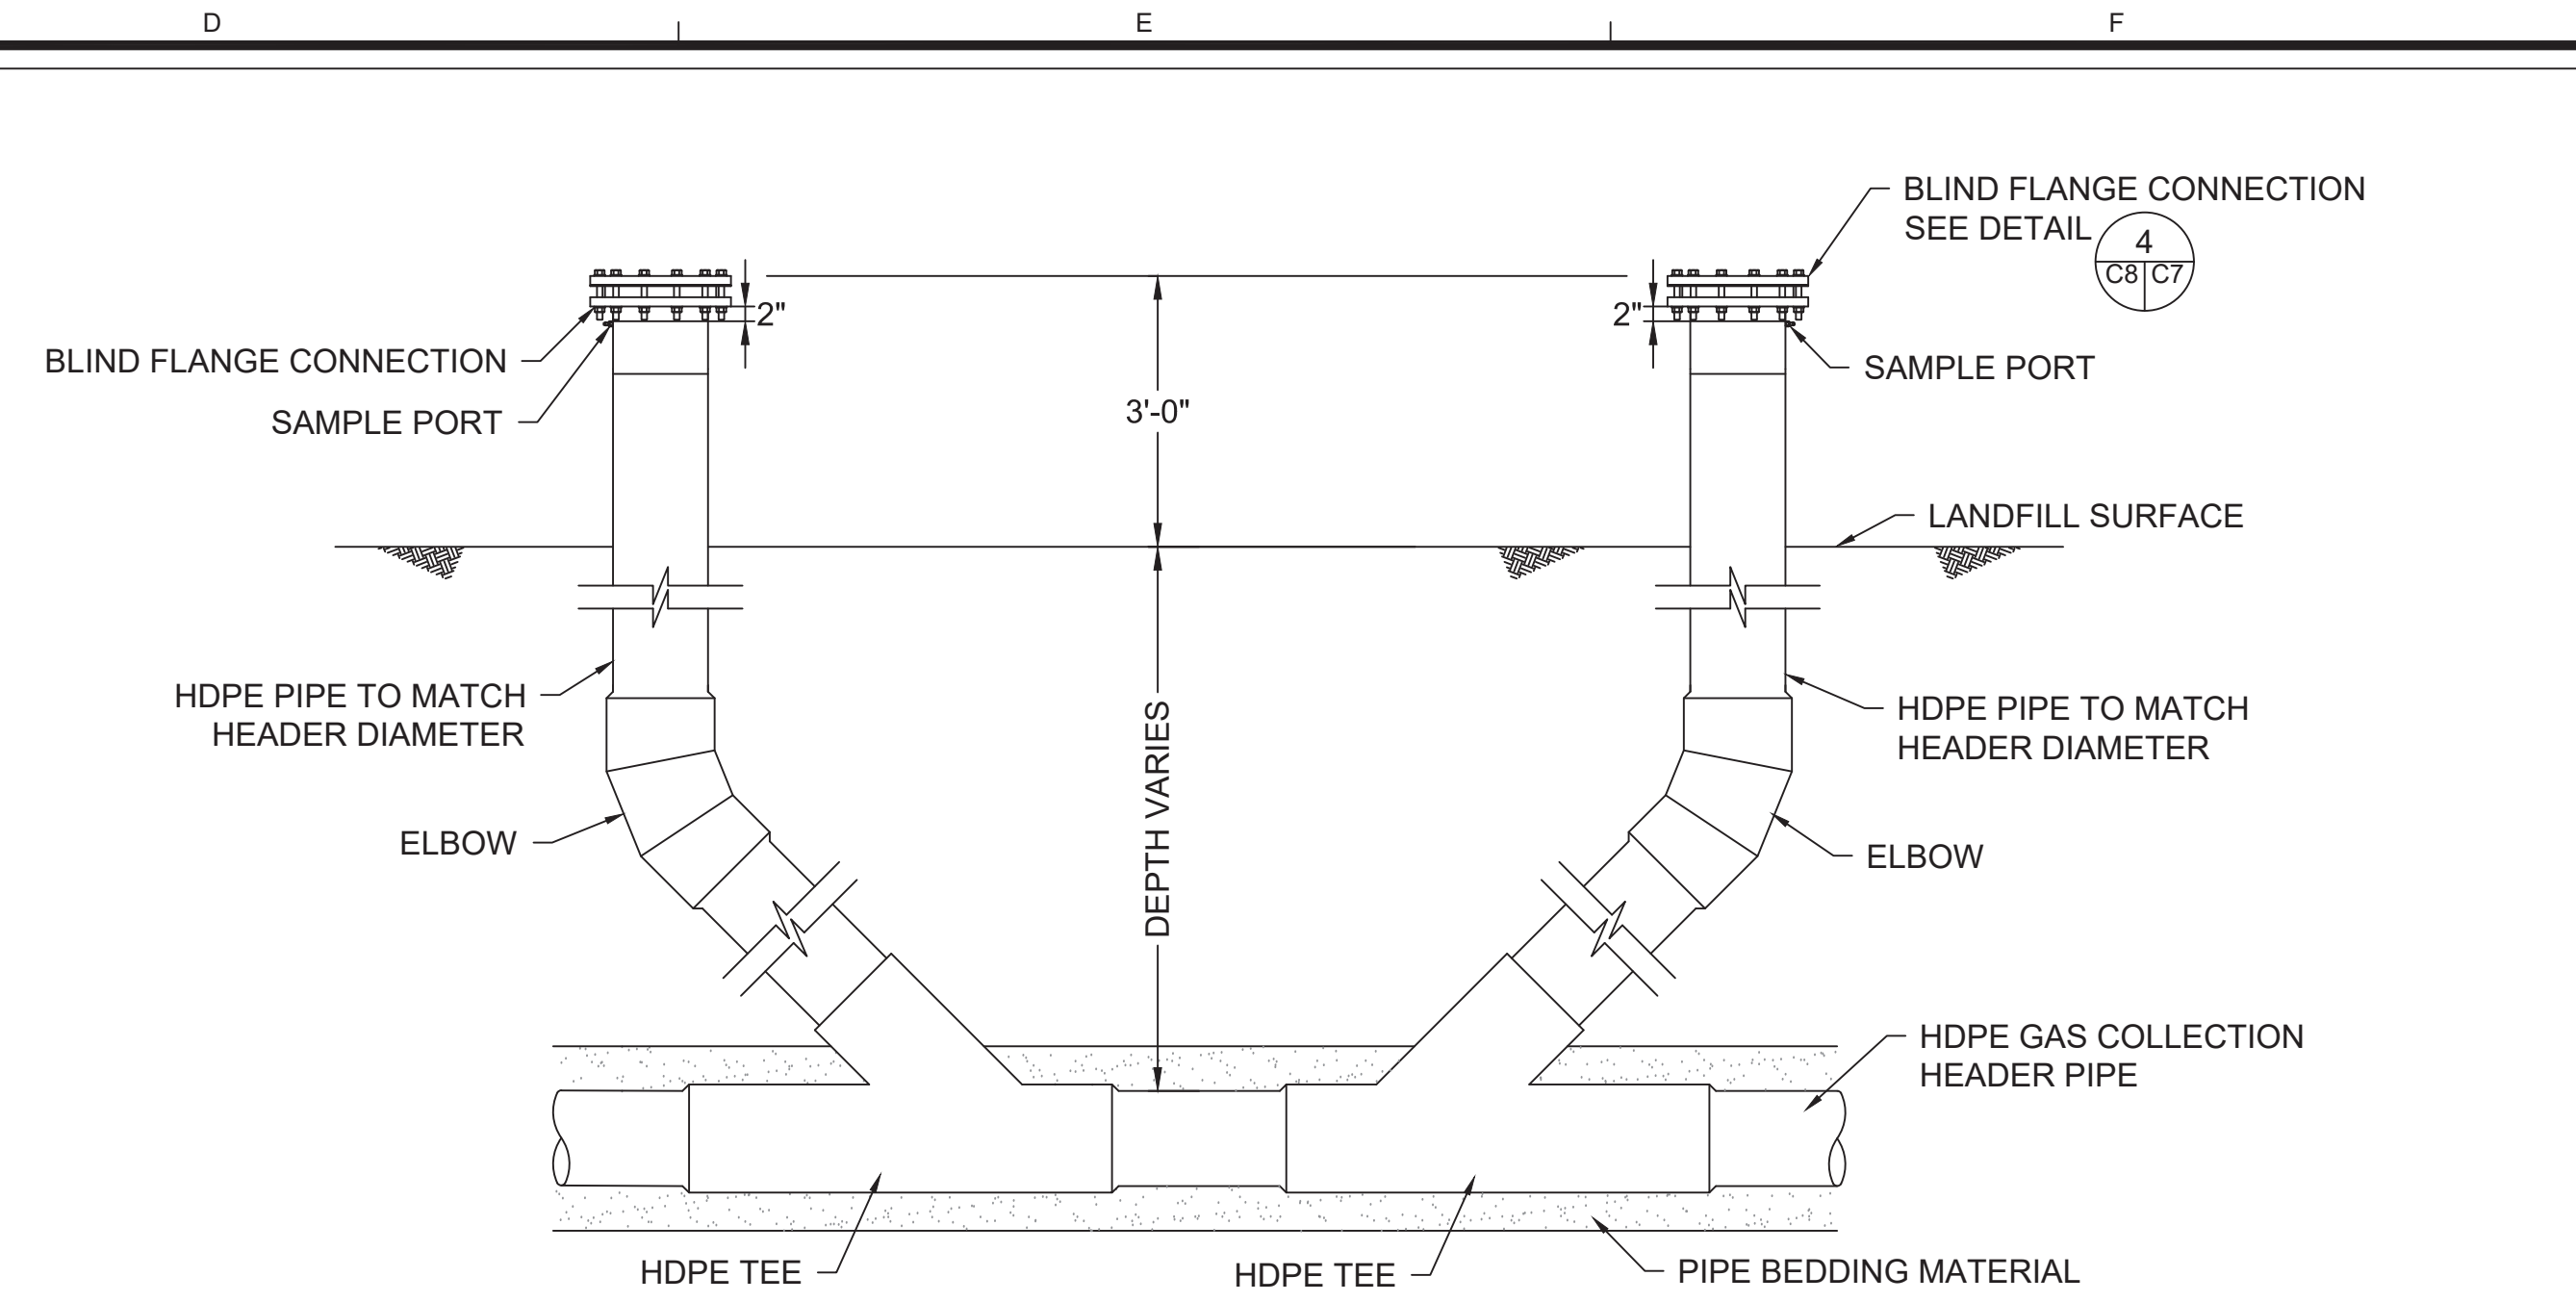


4
C1/C8 4
C2/C8 4
C3/C8 4
C5/C8 4 TYPICAL HEADER RISER DETAIL NTS

NOTE:
1. ELBOWS SHOULD BE FACTORY FABRICATED MULTI-SEGMENTED TO PERMIT PASSAGE OF VIDEO EQUIPMENT OR PRESSURE WASHING EQUIPMENT
2. HEADER RISERS TO BE INSTALLED AT HIGH POINTS IN HEADER LINE

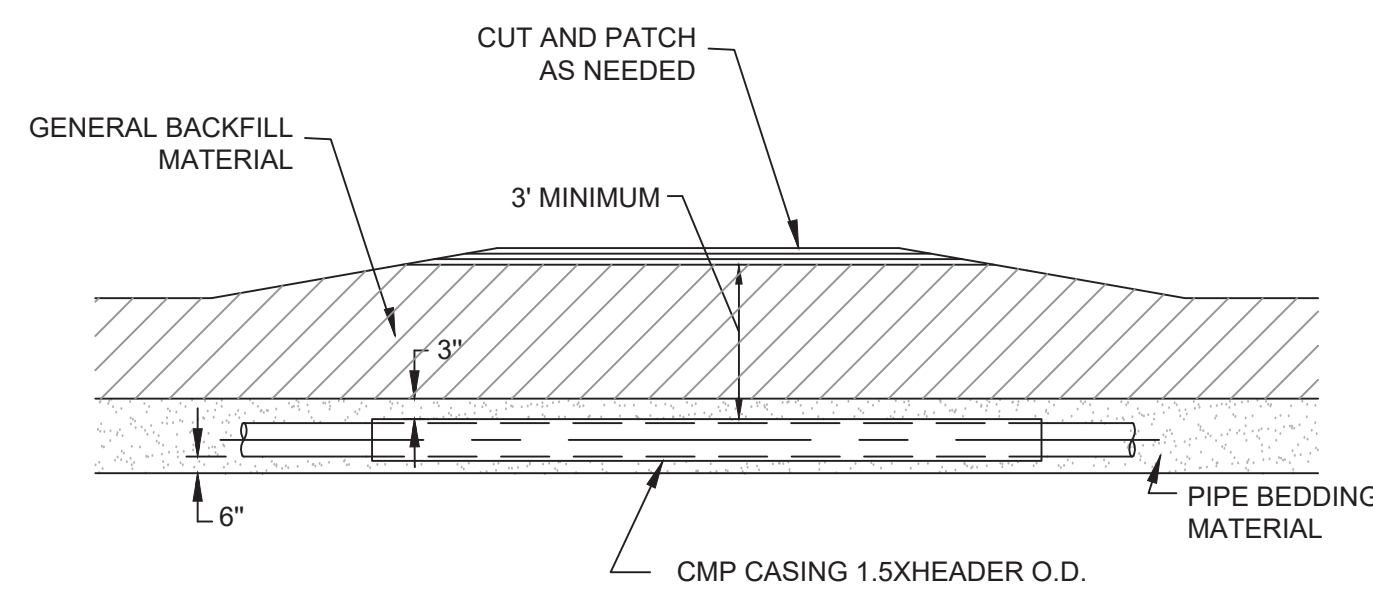

5
C3/C8 5
C9/C8 5 TYPICAL ROAD CASING DETAIL NTS

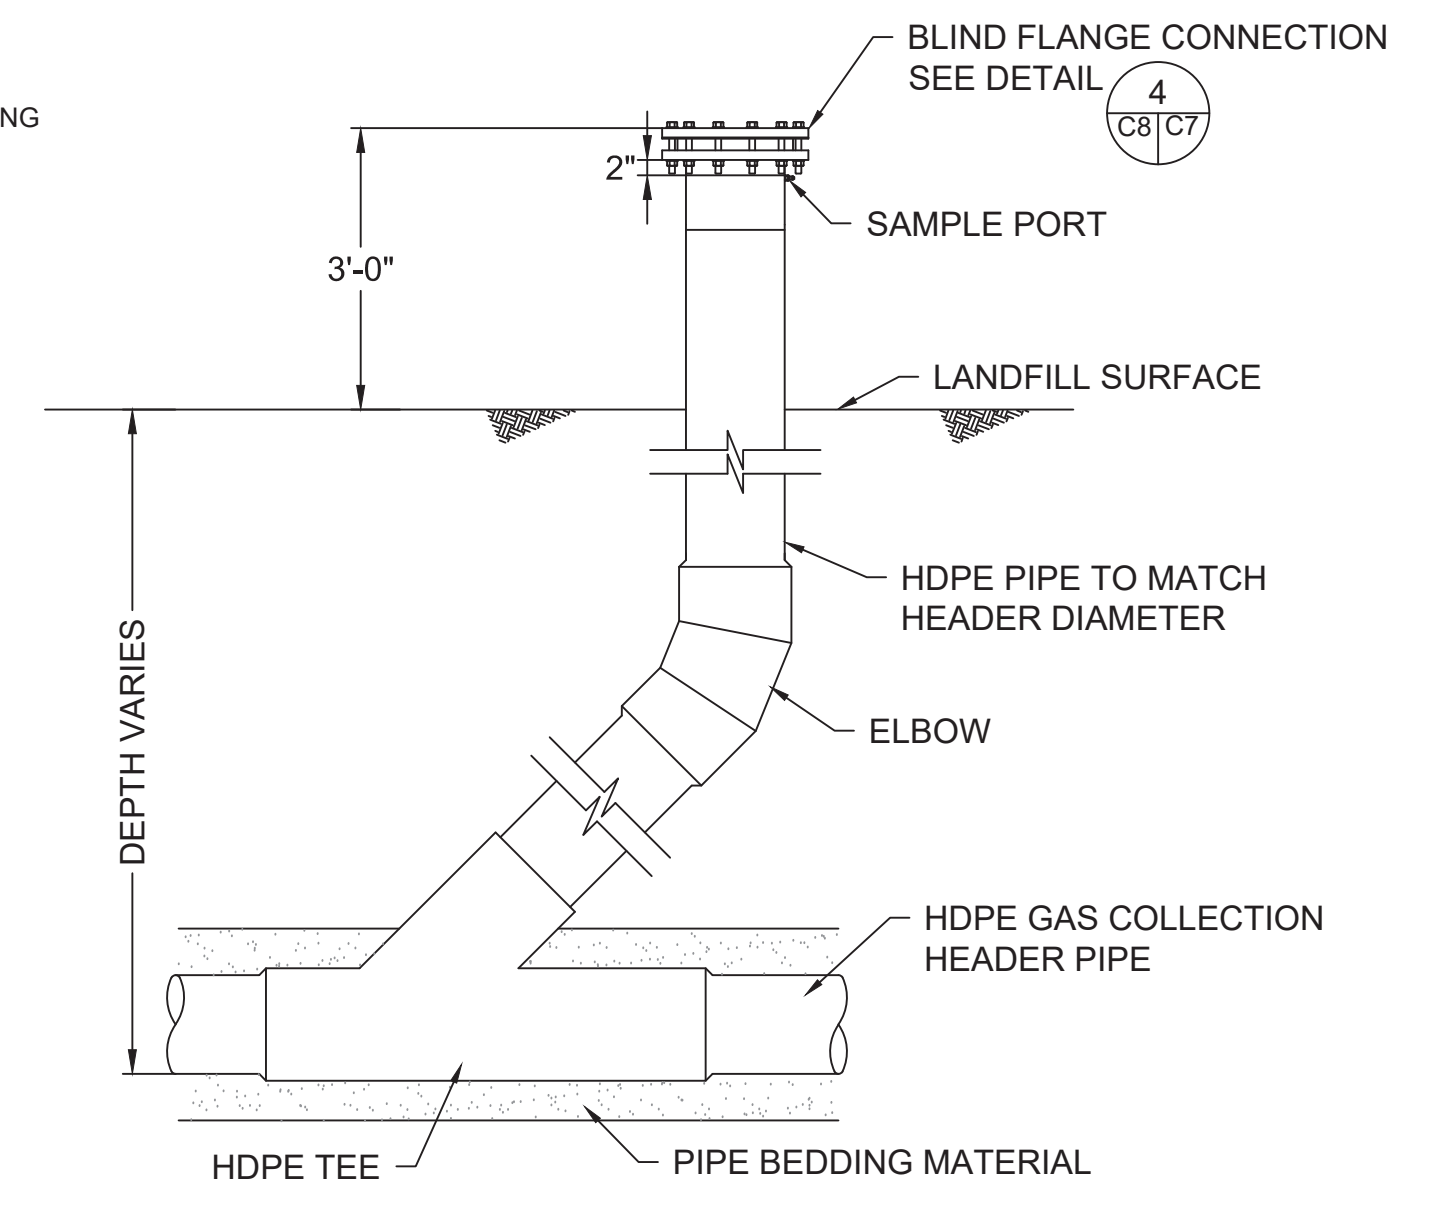

6
C1/C8 6
C4/C8 6 HEADER RISER DETAIL NTS

NOTE:
1. ELBOWS SHOULD BE FACTORY FABRICATED MULTI-SEGMENTED TO PERMIT PASSAGE OF VIDEO EQUIPMENT OR PRESSURE WASHING EQUIPMENT
2. HEADER RISERS TO BE INSTALLED AT HIGH POINTS IN HEADER LINE

Date _____
Signature _____
Robert E. Maskey, P.E.
Florida Registration # 40176

REV. No.	DATE	BY	CHKD BY	REMARKS



DETAILS (3 OF 4)
ORANGE COUNTY CLASS III LANDFILL
ORANGE COUNTY, FLORIDA


531 Versailles Drive, Suite 202
Maitland, Florida 32751
(407) 475-9163 FAX 475-9169
Certification of Authorization # 7831
S2Li

DRAWING NO.
C8


REFER TO DRAWING G-2 FOR LEGEND.

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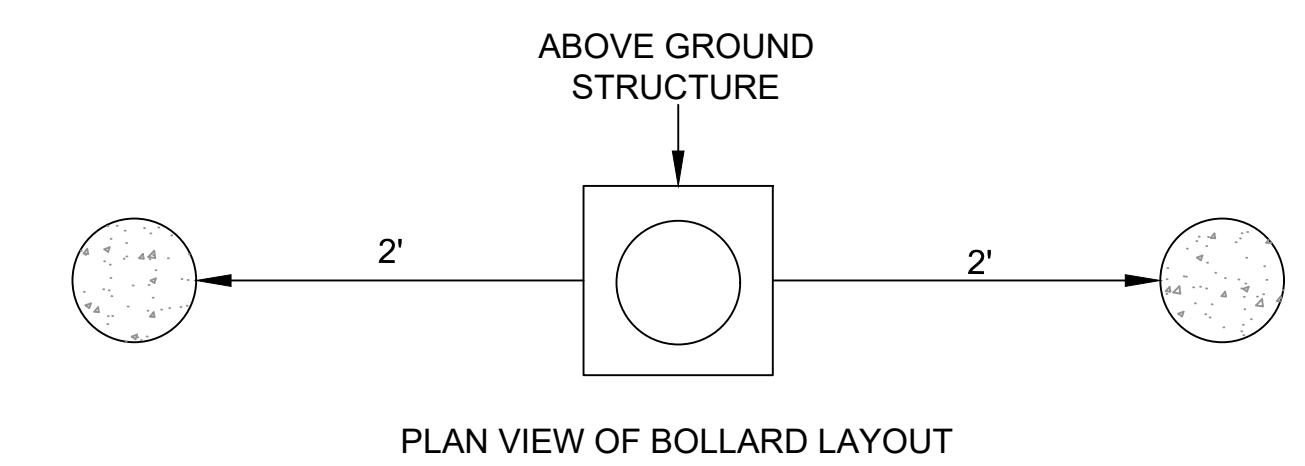
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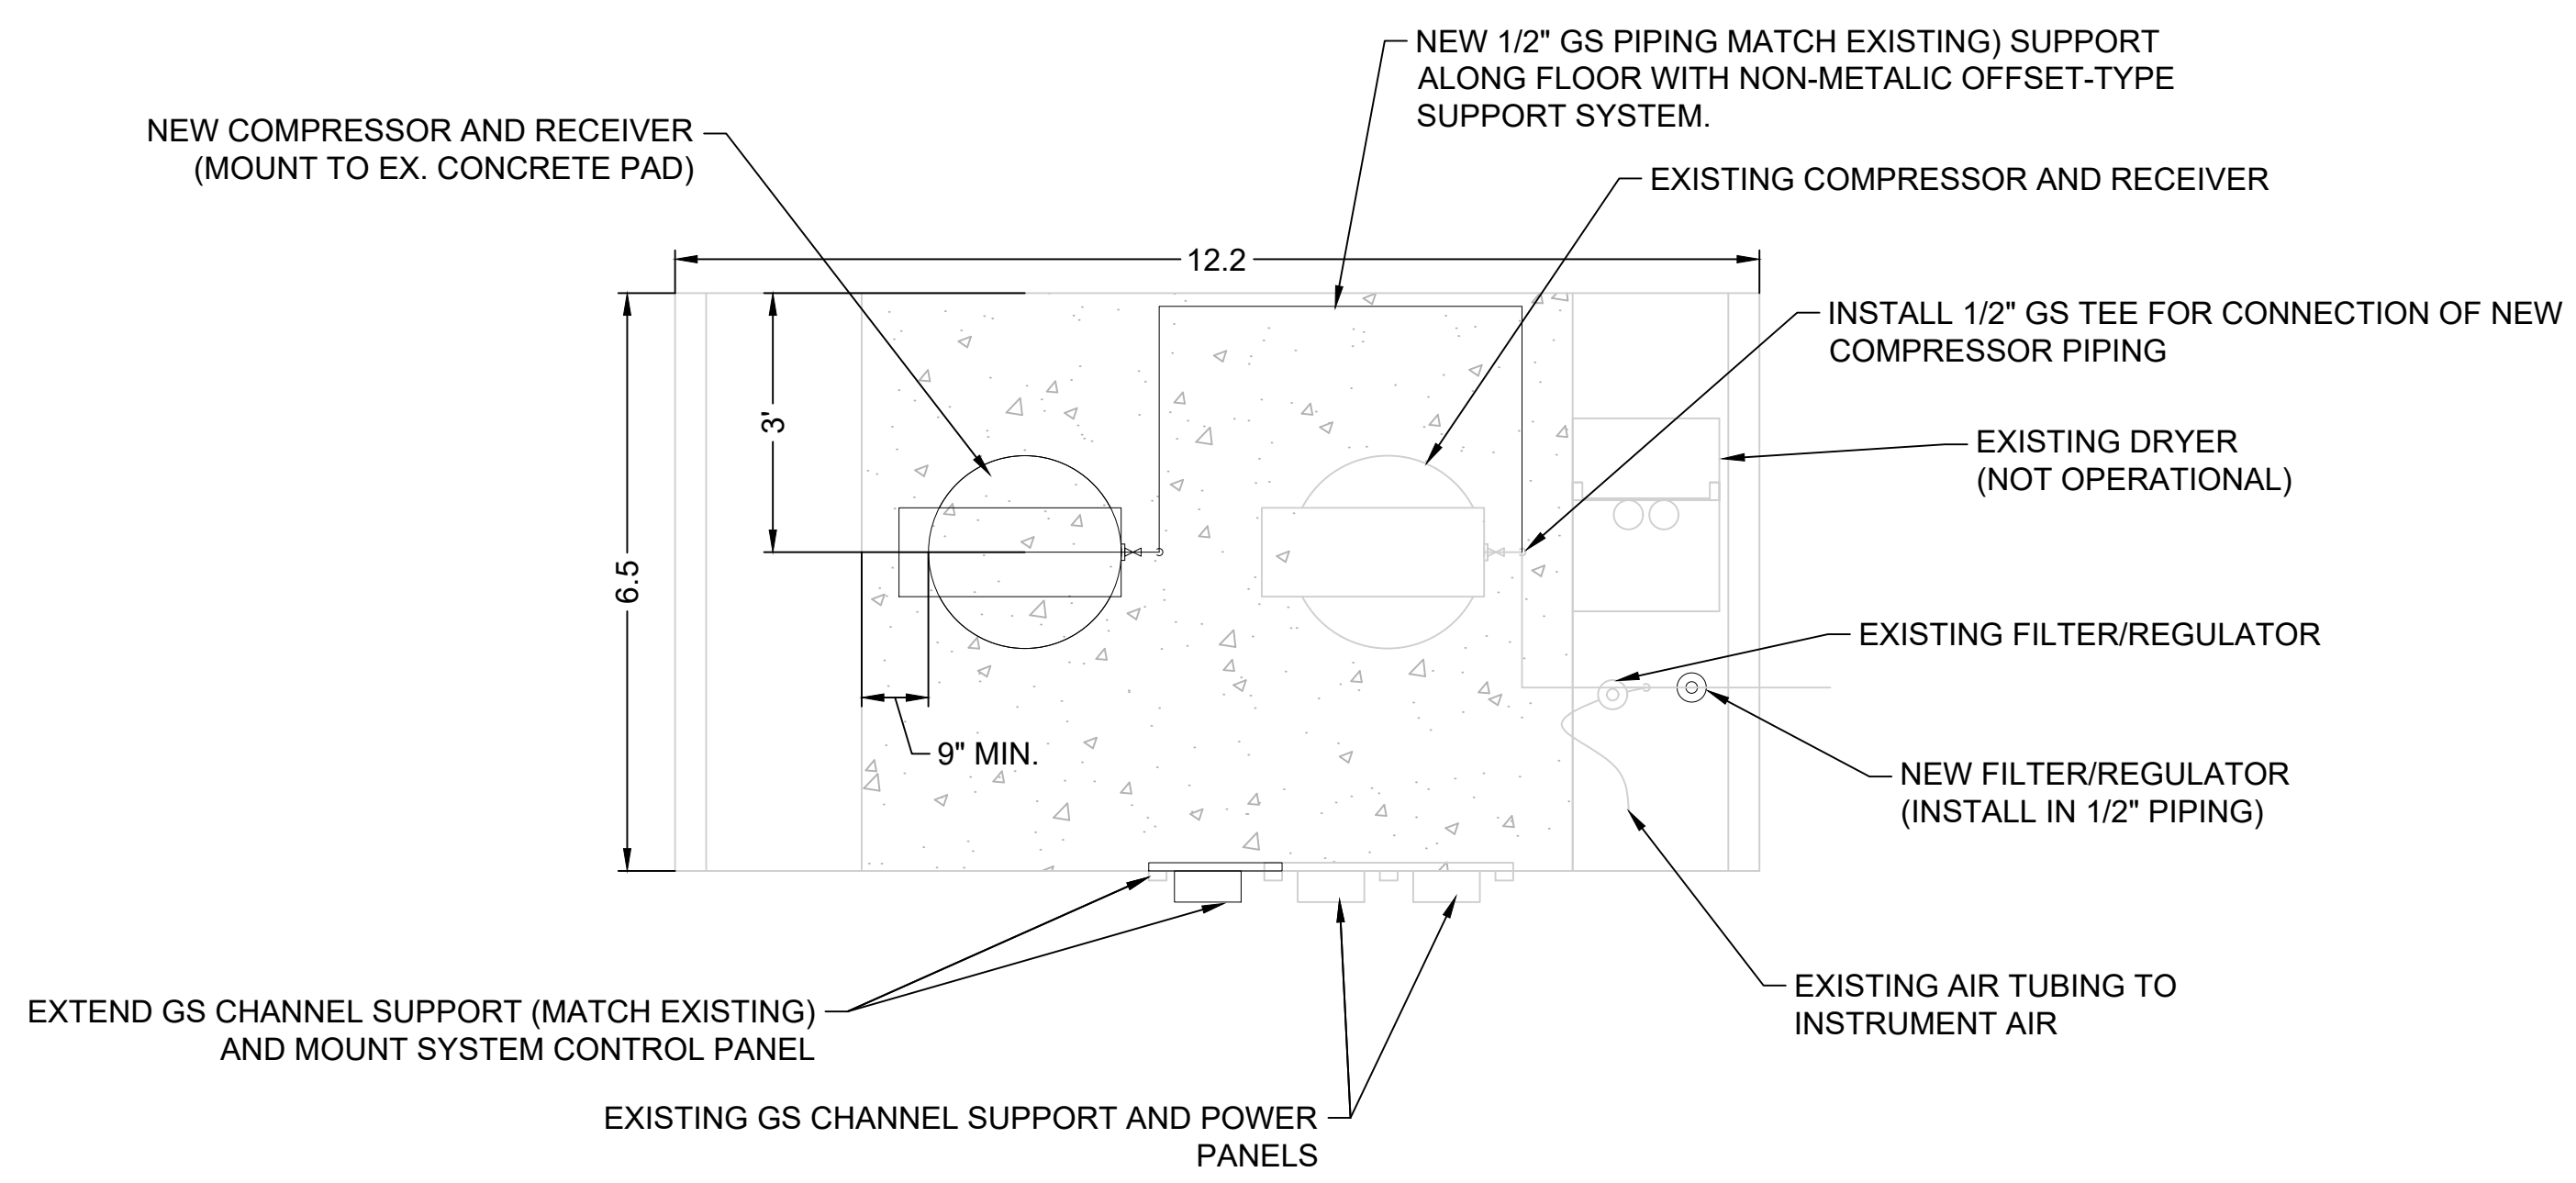
1 CONNECTION TO EXISTING LATERAL PIPE DETAIL
NTS

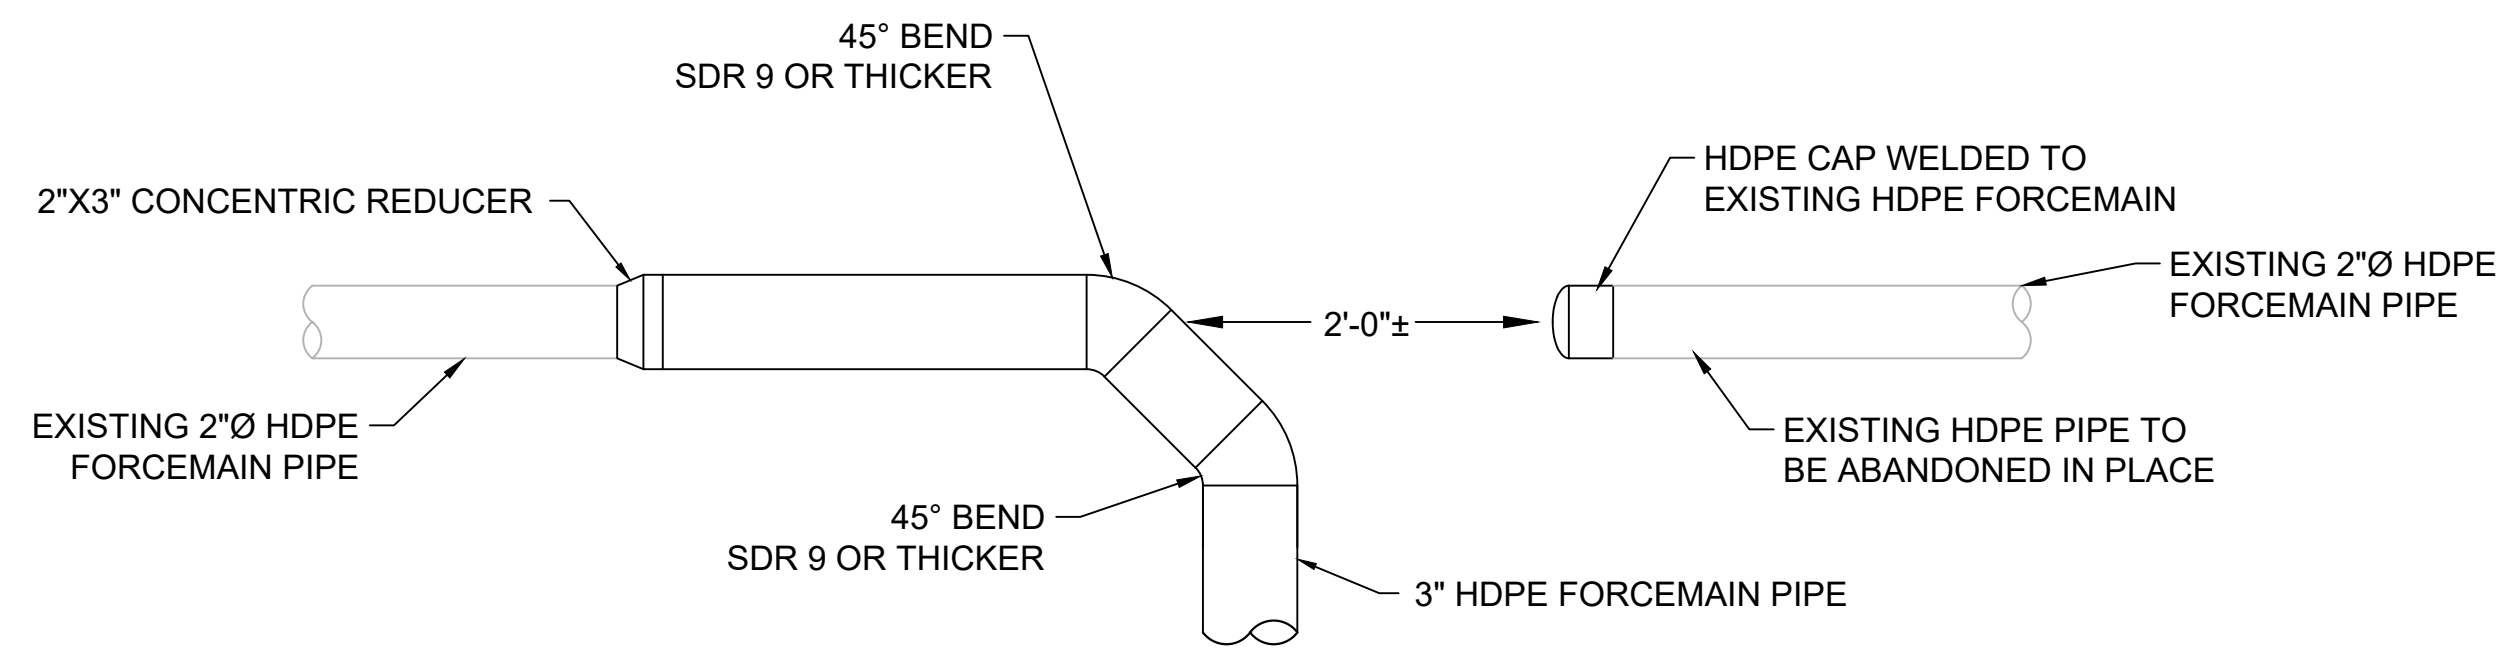

2 BOLLARD DETAIL
NTS

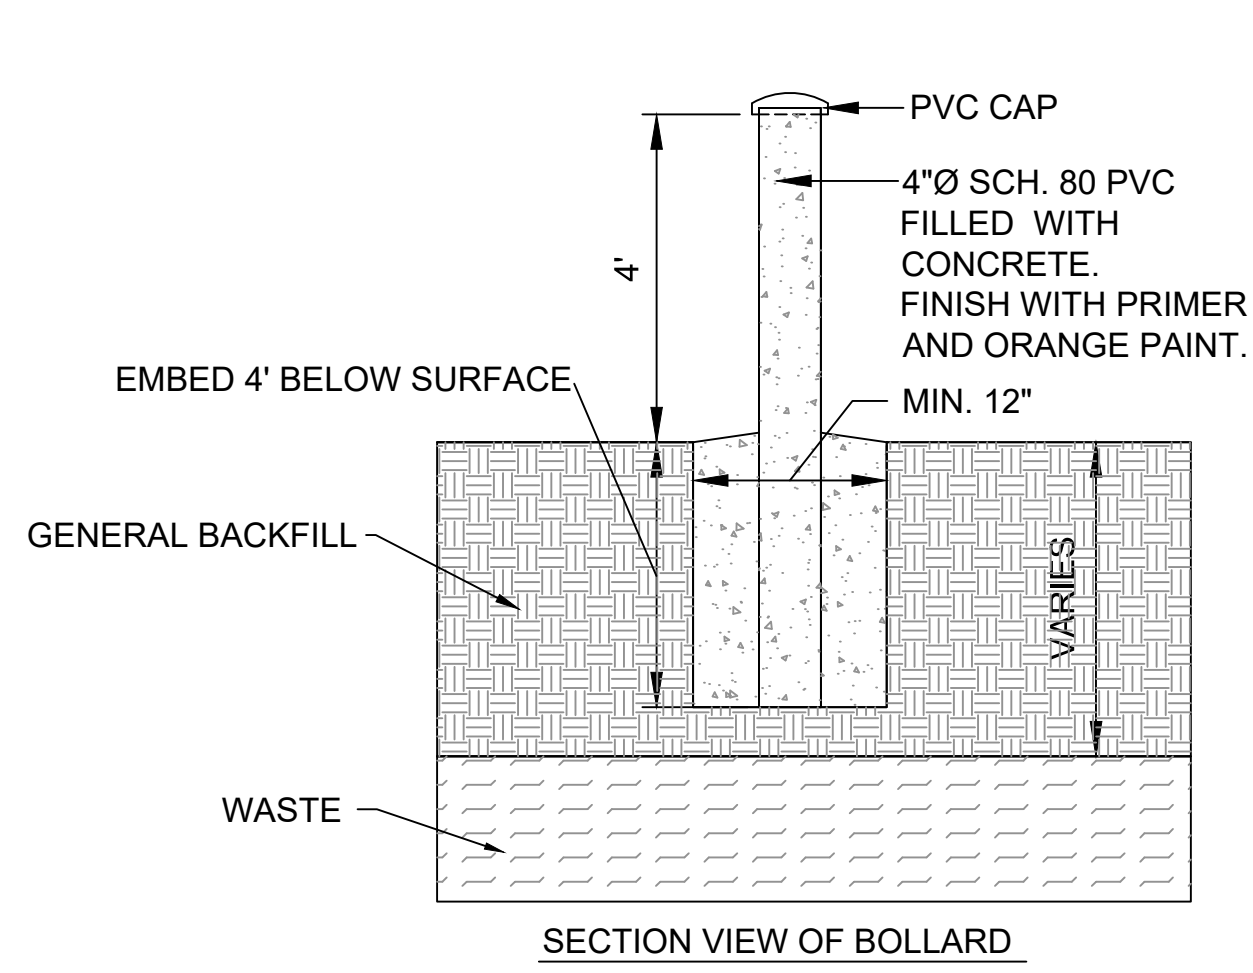

- NOTES:
1. BOLLARDS ARE TO BE PLACED VERTICALLY AT ALL ABOVE GROUND STRUCTURES AND VALVE LOCATIONS.
 2. TWO BOLLARDS REQUIRED AT THE SPECIFIED LOCATIONS, UNLESS OTHERWISE NOTED.
 3. BOLLARD PLACEMENT MAY BE INTO WASTE.
 4. BOLLARDS TO BE PLACED AT ALL ABOVE GROUND STRUCTURES.
 5. BOLLARDS ARE NOT TO BE PLACED ABOVE PIPING.





5 AIR COMPRESSOR AREA
NTS

- NOTES
1. COMPRESSOR SYSTEM SHALL REMAIN IN OPERATION DURING CONSTRUCTION. TEMPORARY SHUTDOWNS FOR CONNECTIONS TO EXISTING PIPING OR OTHER WORK SHALL BE LIMITED TO A MAXIMUM OF 4 HOURS.
 2. THE CONTRACTOR SHALL BE RESPONSIBLE FOR ELECTRICAL AND CONTROL WIRING WORK AND FOR OBTAINING ANY REQUIRED PERMITS. ALL ELECTRICAL WORK SHALL BE IN ACCORDANCE WITH THE MOST RECENT NEC.



4 BLIND FLANGE (TYP)
FOR FUTURE LFG CONNECTIONS
NTS

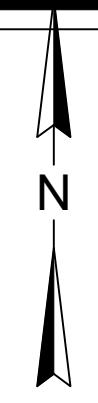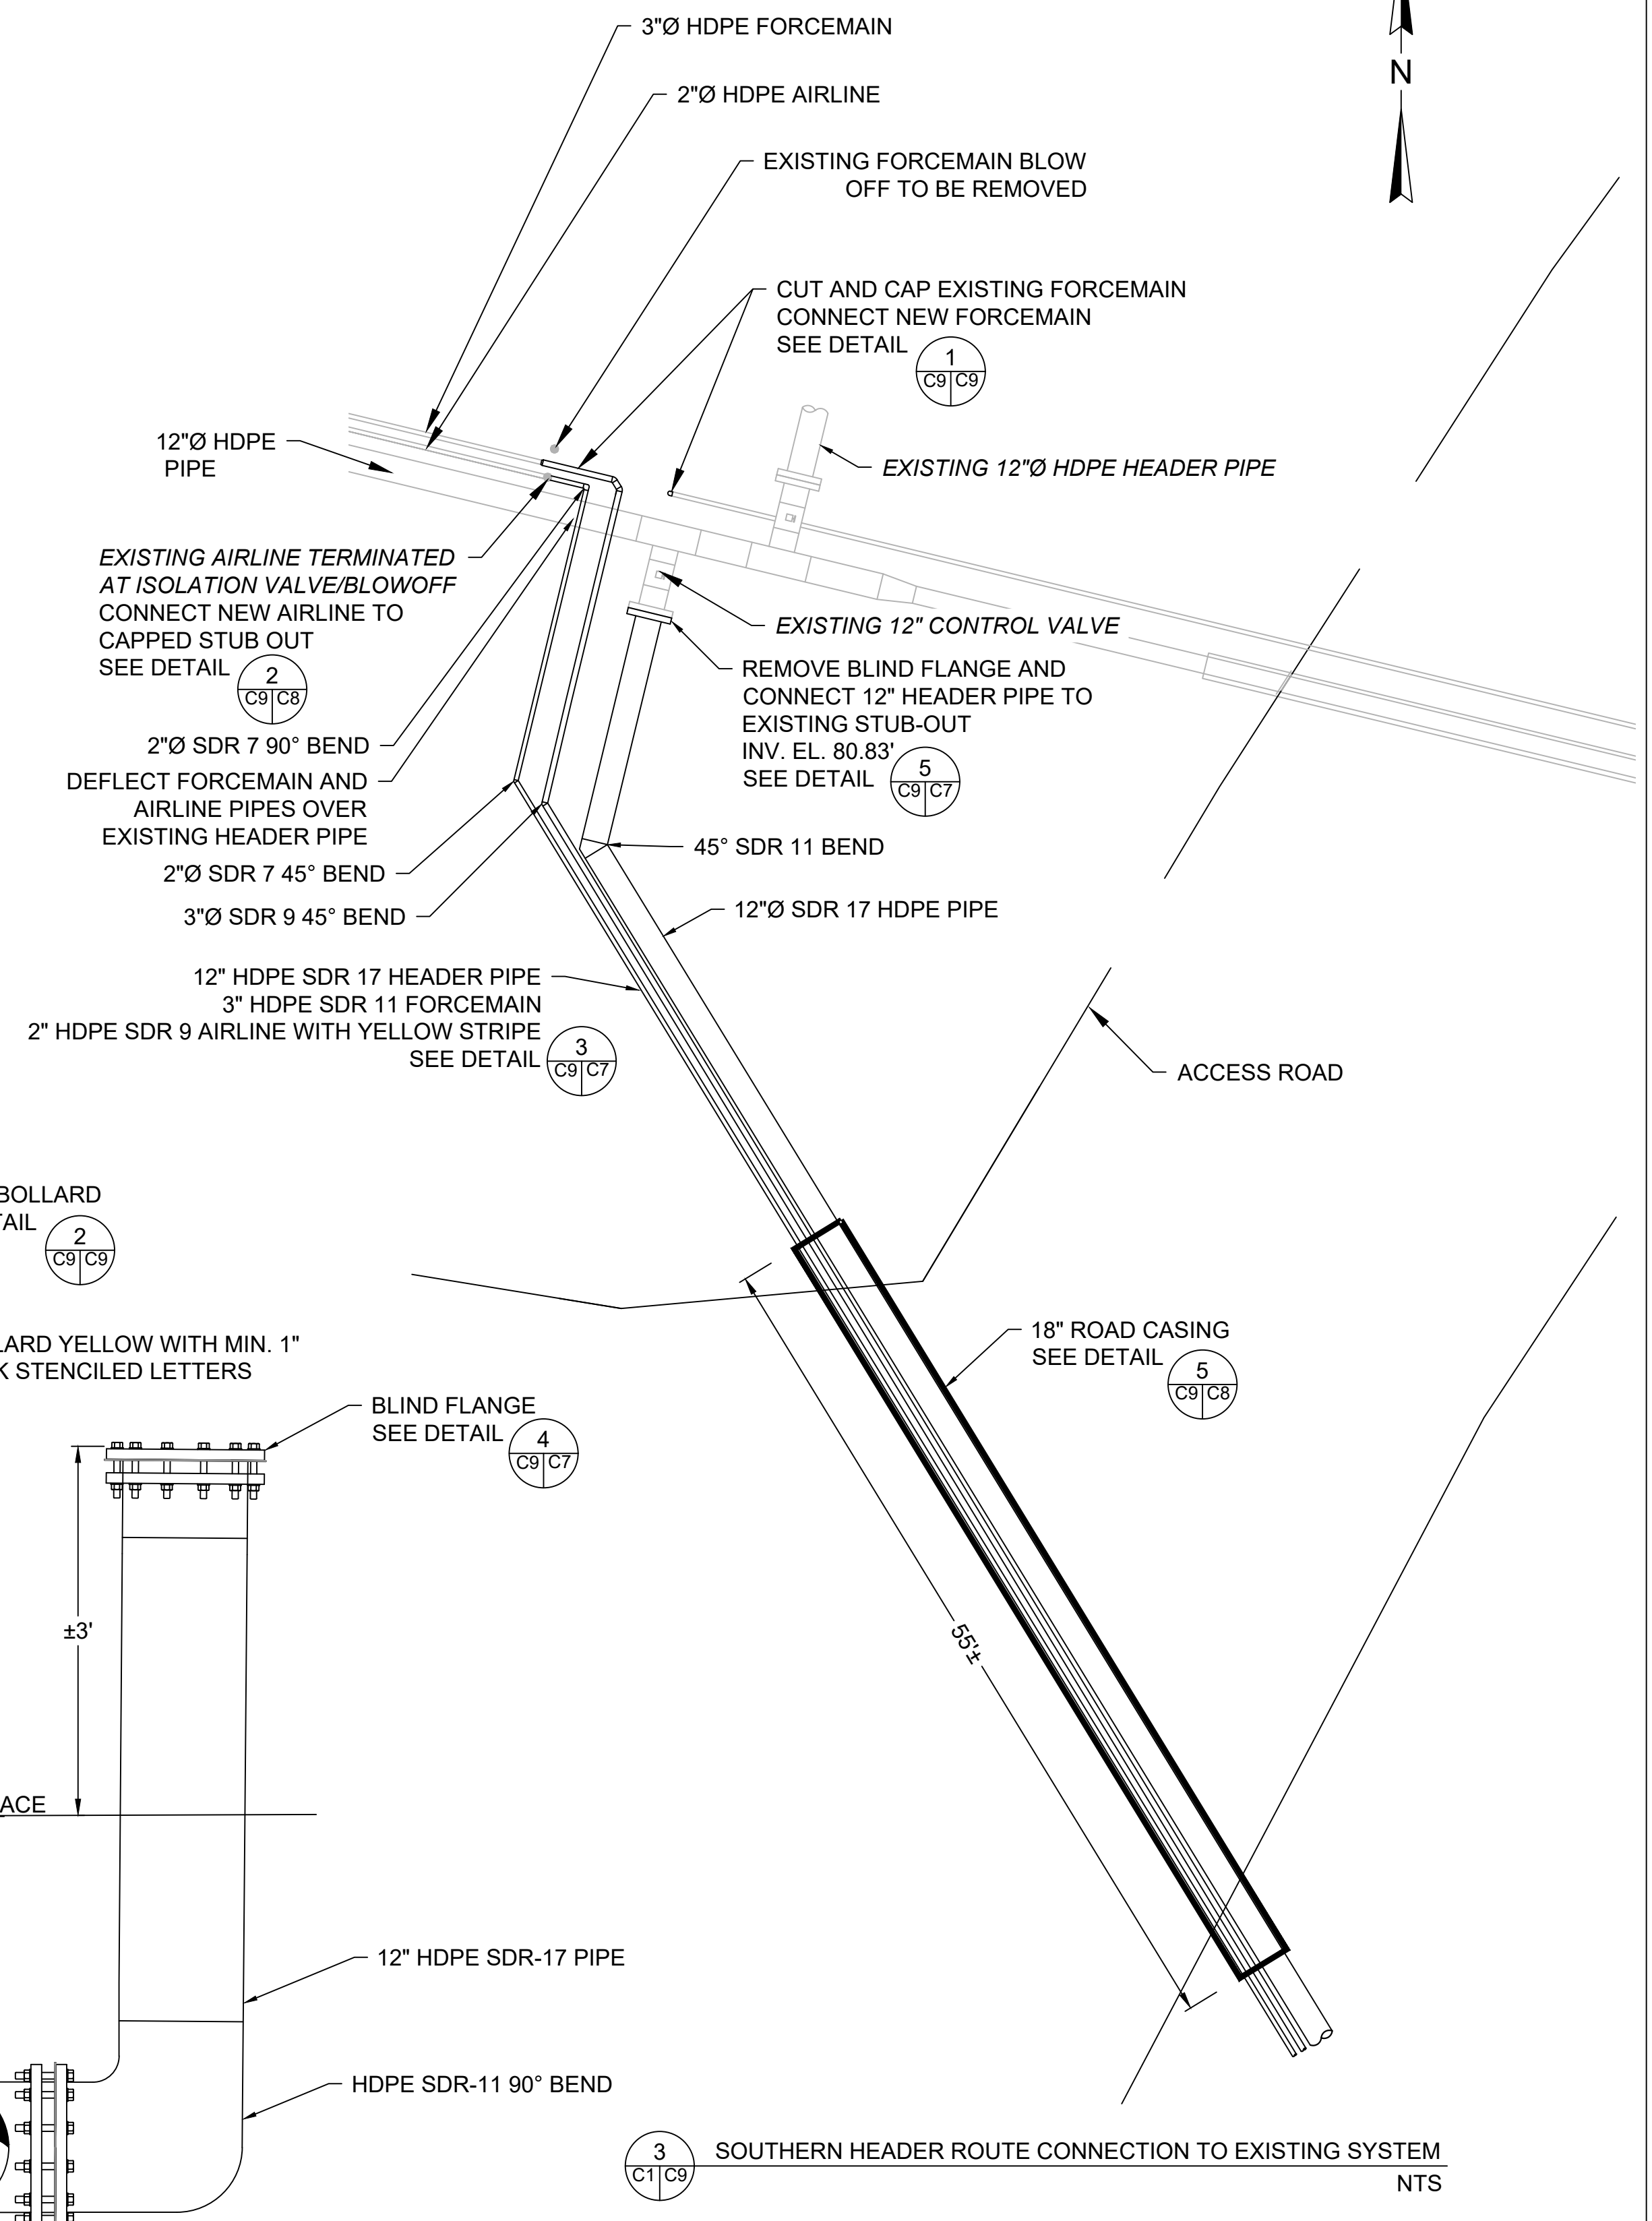

Date _____
Signature _____
Robert E. Maskey, P.E.
Florida Registration # 40176

REV. No.	DATE	DRAWN BY	CHKD BY	REMARKS



DETAILS (4 OF 4)
ORANGE COUNTY CLASS III LANDFILL
ORANGE COUNTY, FLORIDA

531 Versailles Drive, Suite 202
Maitland, Florida 32751
(407) 475-9163 FAX 475-9169
Certification of Authorization # 7831
S2Li

DRAWING NO.
C9

REFER TO DRAWING G-2 FOR LEGEND.

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