

PROJECT SPECIFIC NOTES - CIVIL

1. DURING CONSTRUCTION CONTRACTOR SHALL INSURE MINIMUM DISTURBANCES TO FACILITY OPERATIONS AND SHALL TAKE CARE TO KEEP EXPOSED AREAS TO A MINIMUM TIME TO REDUCE DUST POLLUTION AND MINIMIZE TRAFFIC DETOUR.

2. CONTRACTOR TO MAINTAIN INLET BARRIERS AND SILT BARRIERS IN GOOD CONDITIONS TO PREVENT INTRODUCTION OF SUSPENDED MATERIALS CAUSED BY HIS CONSTRUCTION ACTIVITIES INTO VARIOUS STORM WATER PONDS FOUND AT THE FIRE STATION FACILITY.

3. CONTRACTOR SHALL BE RESPONSIBLE FOR THE CORRECTION OF ANY EROSION, SEDIMENTATION OR WATER QUALITY PROBLEMS WITHIN STORM WATER PONDS THAT RESULT FROM HIS CONSTRUCTION ACTIVITIES.


4. TO AVOID DAMAGES TO THE UNDERGROUND UTILITIES TRENCHING EQUIPMENT IS NOT ALLOWED TO OPERATE ON SODDED AREAS. CONTRACTOR TO HAND DUG UTILITIES TRENCH FOR LAYING CONDUITS


5. SAWCUTTING FOR INSTALLATION OF CONCRETE PAD TO BE IN CONFORMANCE WITH ALIGNMENT AND DEPTH AS SHOWN ON DRAWINGS. FOR ANY SUBSTANTIAL DEVIATION IN ALIGNMENT CONTRACTOR TO SUBMIT IN WRITING TO ORANGE COUNTY PROJECT MANAGER FOR REVIEW AND APPROVAL BEFORE WORK.

INSTALL AND CONNECT UTILITIES LINES SUCH AS 6. POWER AT LOCATION AND DEPTH AS SHOWN ON ELECTRICAL DRAWINGS.





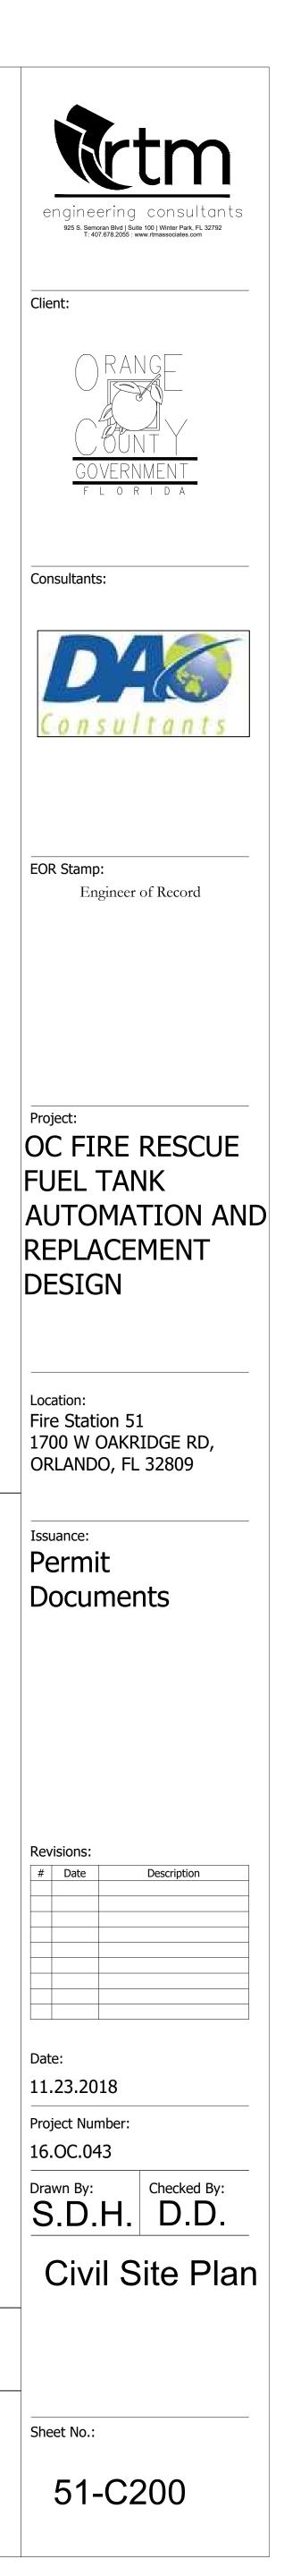

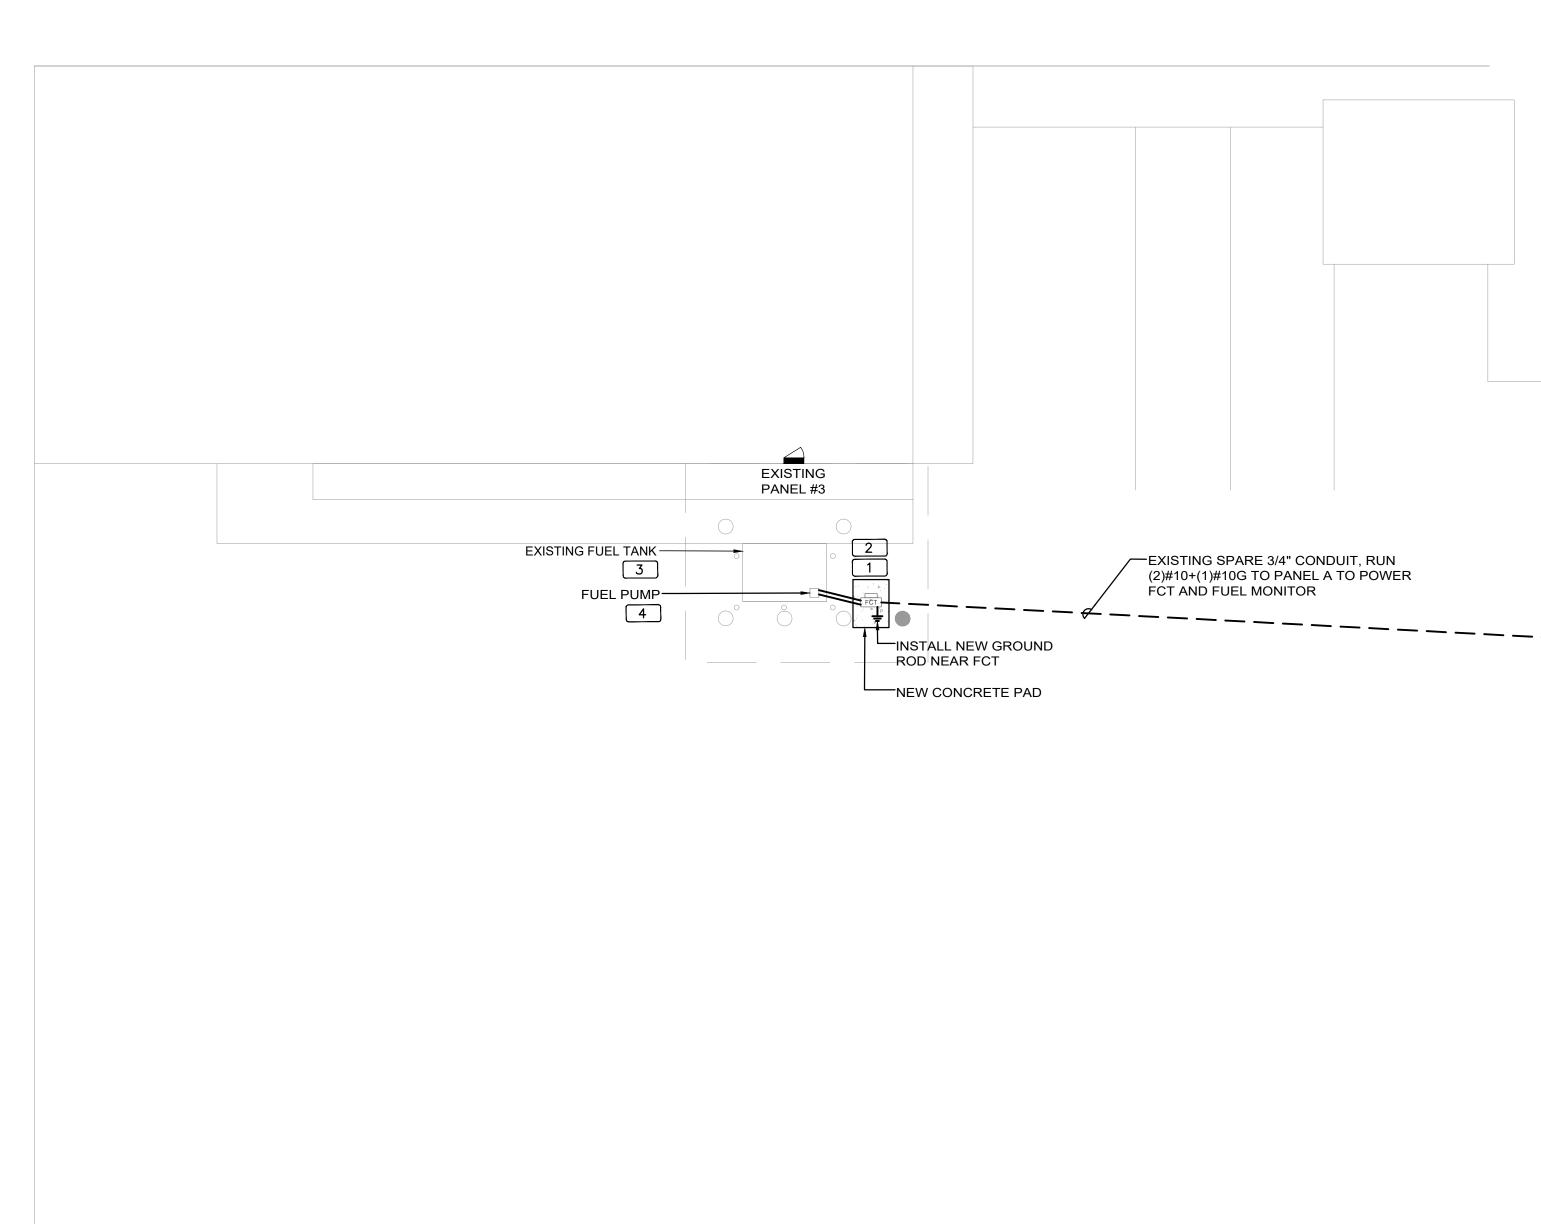

NORTH FIRE STATION 51 SITE PLAN - NEW POWER PLAN 0 4' 8' 16' 24' 1/8" = 1'-0"


GENERAL NOTES


- 1. PAINT ALL CONDUIT ABOVE GROUND TO MATCH.
- 2. PROVIDE EXPLOSION PROOF SEAL-OFF'S AT EACH END OF ALL CONDUIT RUNS. INSTALLATION SHALL MEET REQUIREMENTS OF NEC ARTICLE 514.

KEY NOTES

1 NEW FUEL CONTROL UNIT (FCT), BASIS OF DESIGN EJ WARD W4 IOT. PROVIDE FUEL CONTROL UNIT WITH INTEGRAL NETWORK SWITCH AND WITH 'BACKPACK' MOUNTING HARDWARE. 2 NEW FUEL MONITOR, BASIS OF DESIGN OMTECH PROTEUS-K. MOUNT TO FCT WITH HARDWARE PROVIDED WITH FCT. SEE 3/E201 FOR MORE INFORMATION. 3 PROVIDE AND INSTALL NEW TANK FLOAT SYSTEM.

4 PROVIDE AND INSTALL NEW ELECTRONIC PULSER, BASIS OF DESIGN OPW MODEL 800-F, SEE 2/E201 FOR MORE INFORMATION.

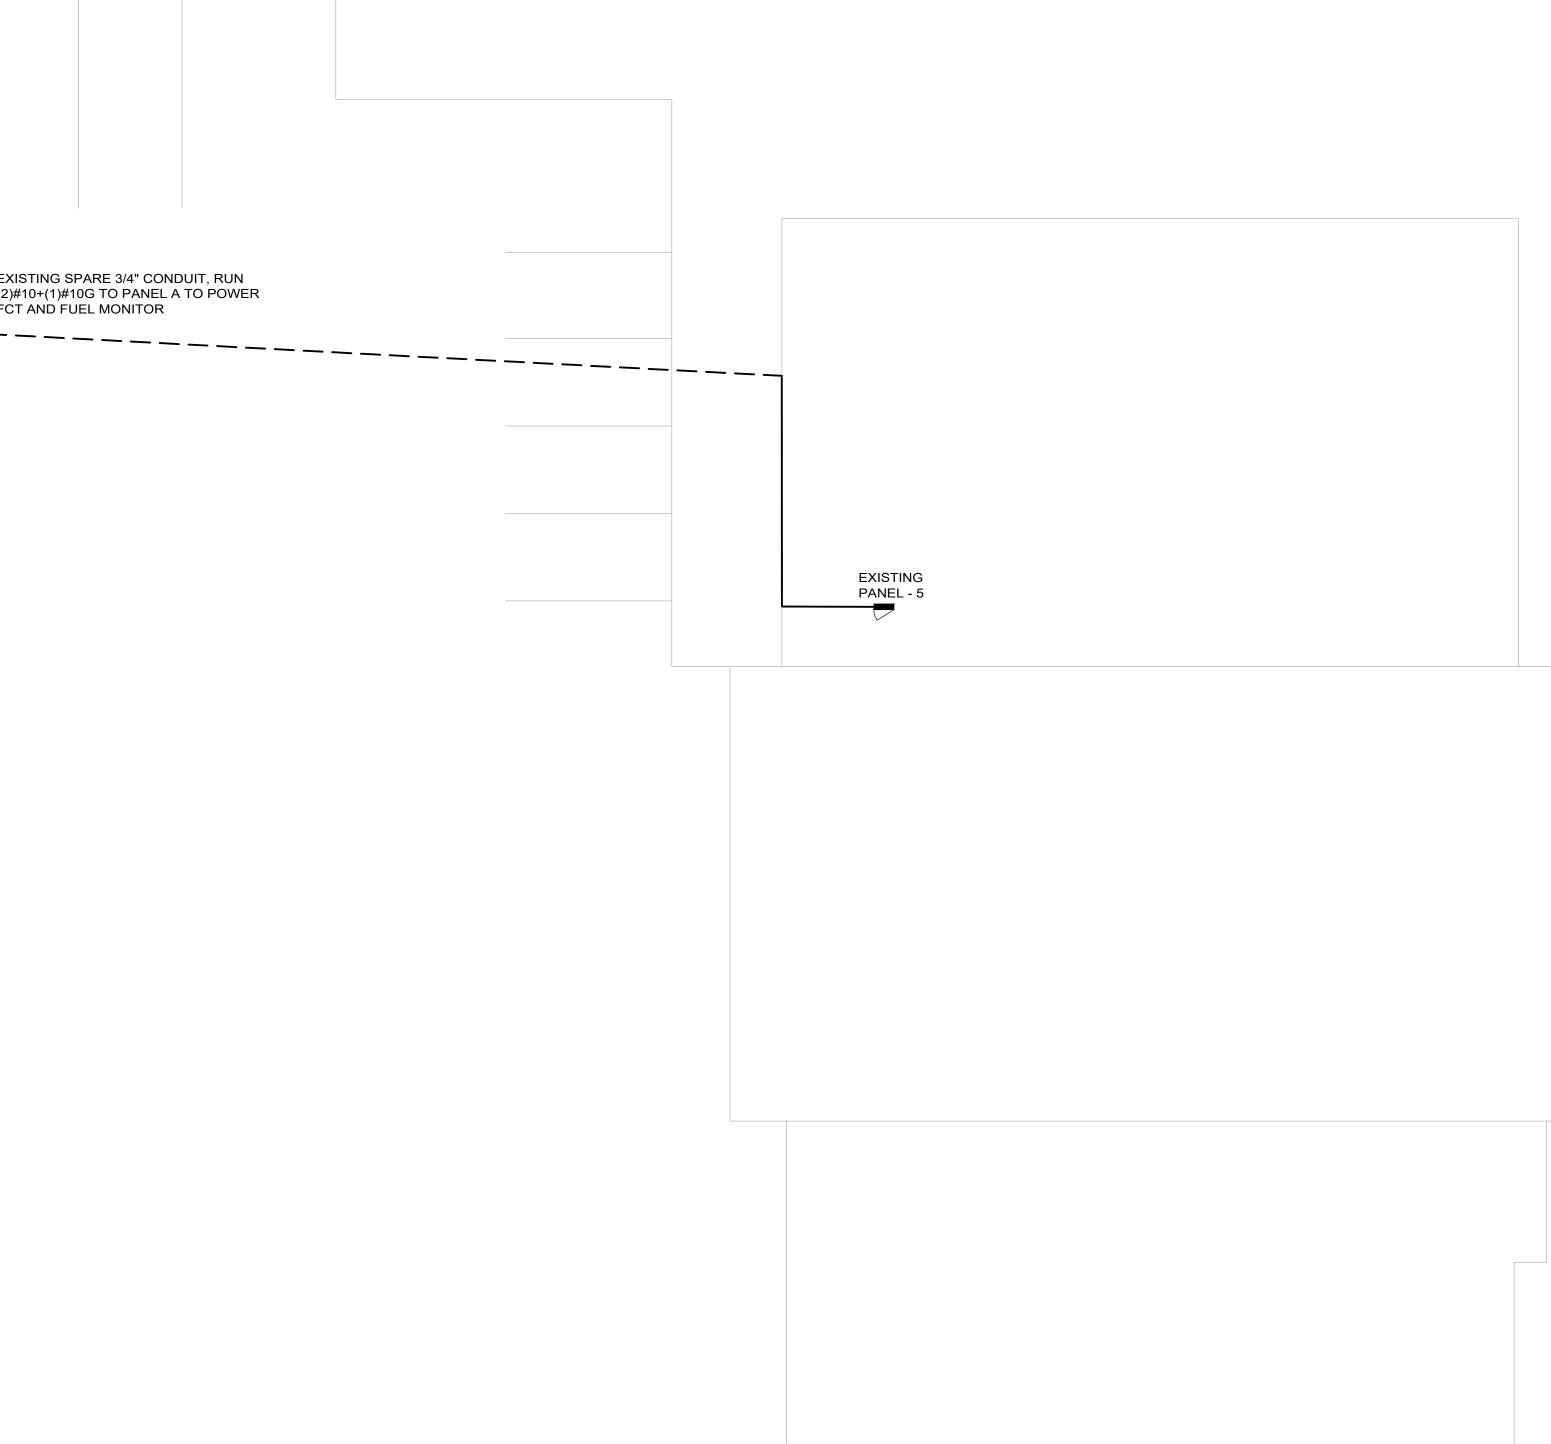

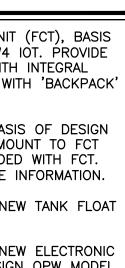



Client:



Consultants:





Location: Fire Station 51 1700 W OAKRIDGE RD, ORLANDO, FL 32809

Issuance: 100% Design Documents

Revisions: # Date Description

Date:

11.23.2018 Project Number:

Checked By:

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ELECTRICAL

POWER PLAN

51-E101

16.OC.043


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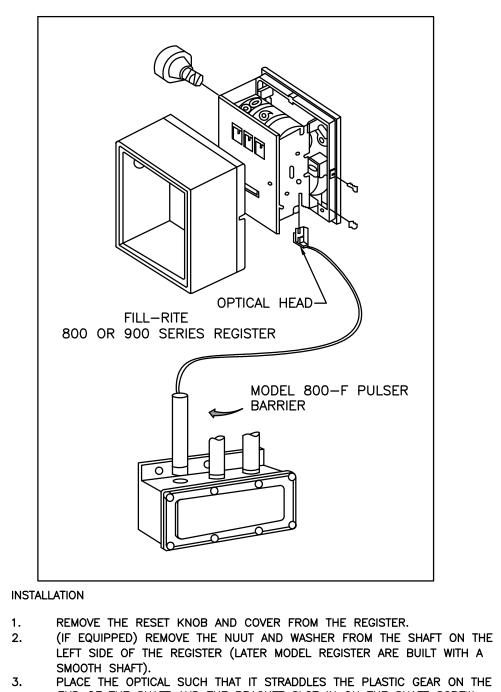
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ME

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120V/1PH POWER INPUT





3.
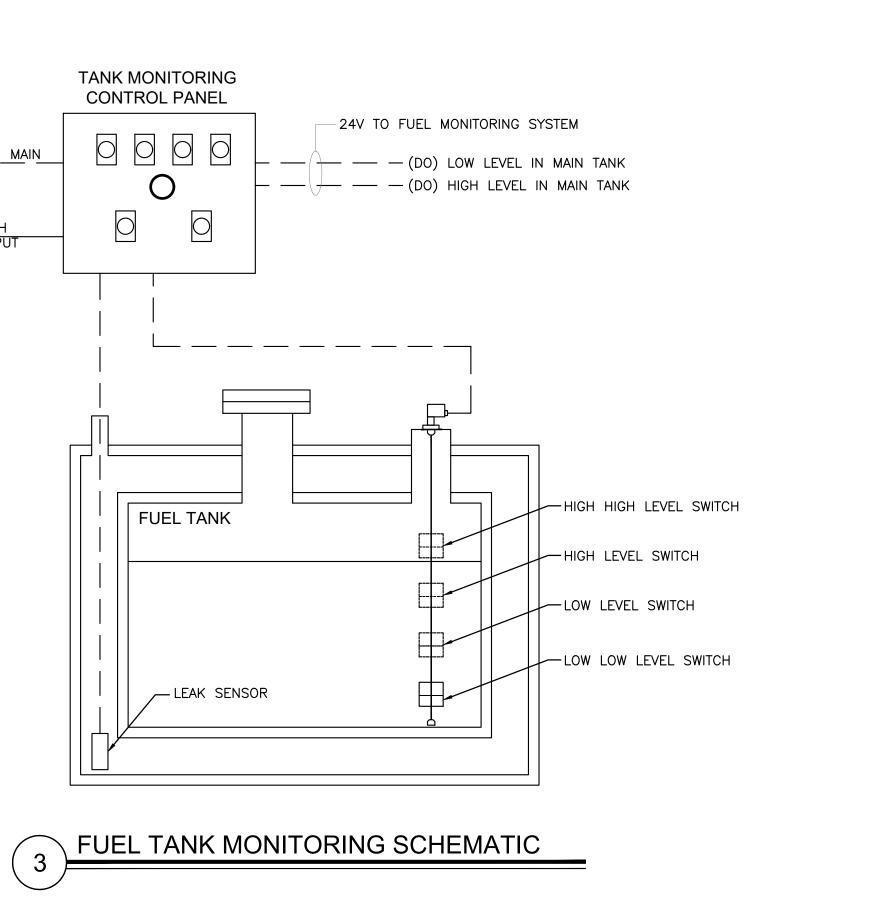
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OVERALL DEMAND FACTOR ______

PLACE THE OPTICAL SUCH THAT IT STRADDLES THE PLASTIC GEAR ON THE END OF THE SHAFT AND THE BRACKET SLOT IN ON THE SHAFT SCREW. (IF EQUIPPED) REPLACE THE WASHER AND NUT REMOVED IN STEP.2. ON LATE MODELS, SECURE THE OPTICAL HEAD WITH THE SUPPLIED PUSH NUT. REPLACE THE REGISTER COVER AND RESET BOX.

INSTALL THE BARRIER INTO THE JUNCTION BOX. CONNECT THE POWER WIRES ACCORDING TO THE DRAWING PROVIDED. PAY PARTICULAR YOU ARE INSTALLING TO MATCH THE PROPER WIRE COLORS TO 8. CONNECT THE RED WIRES TO THE PULSING CIRCUIT.


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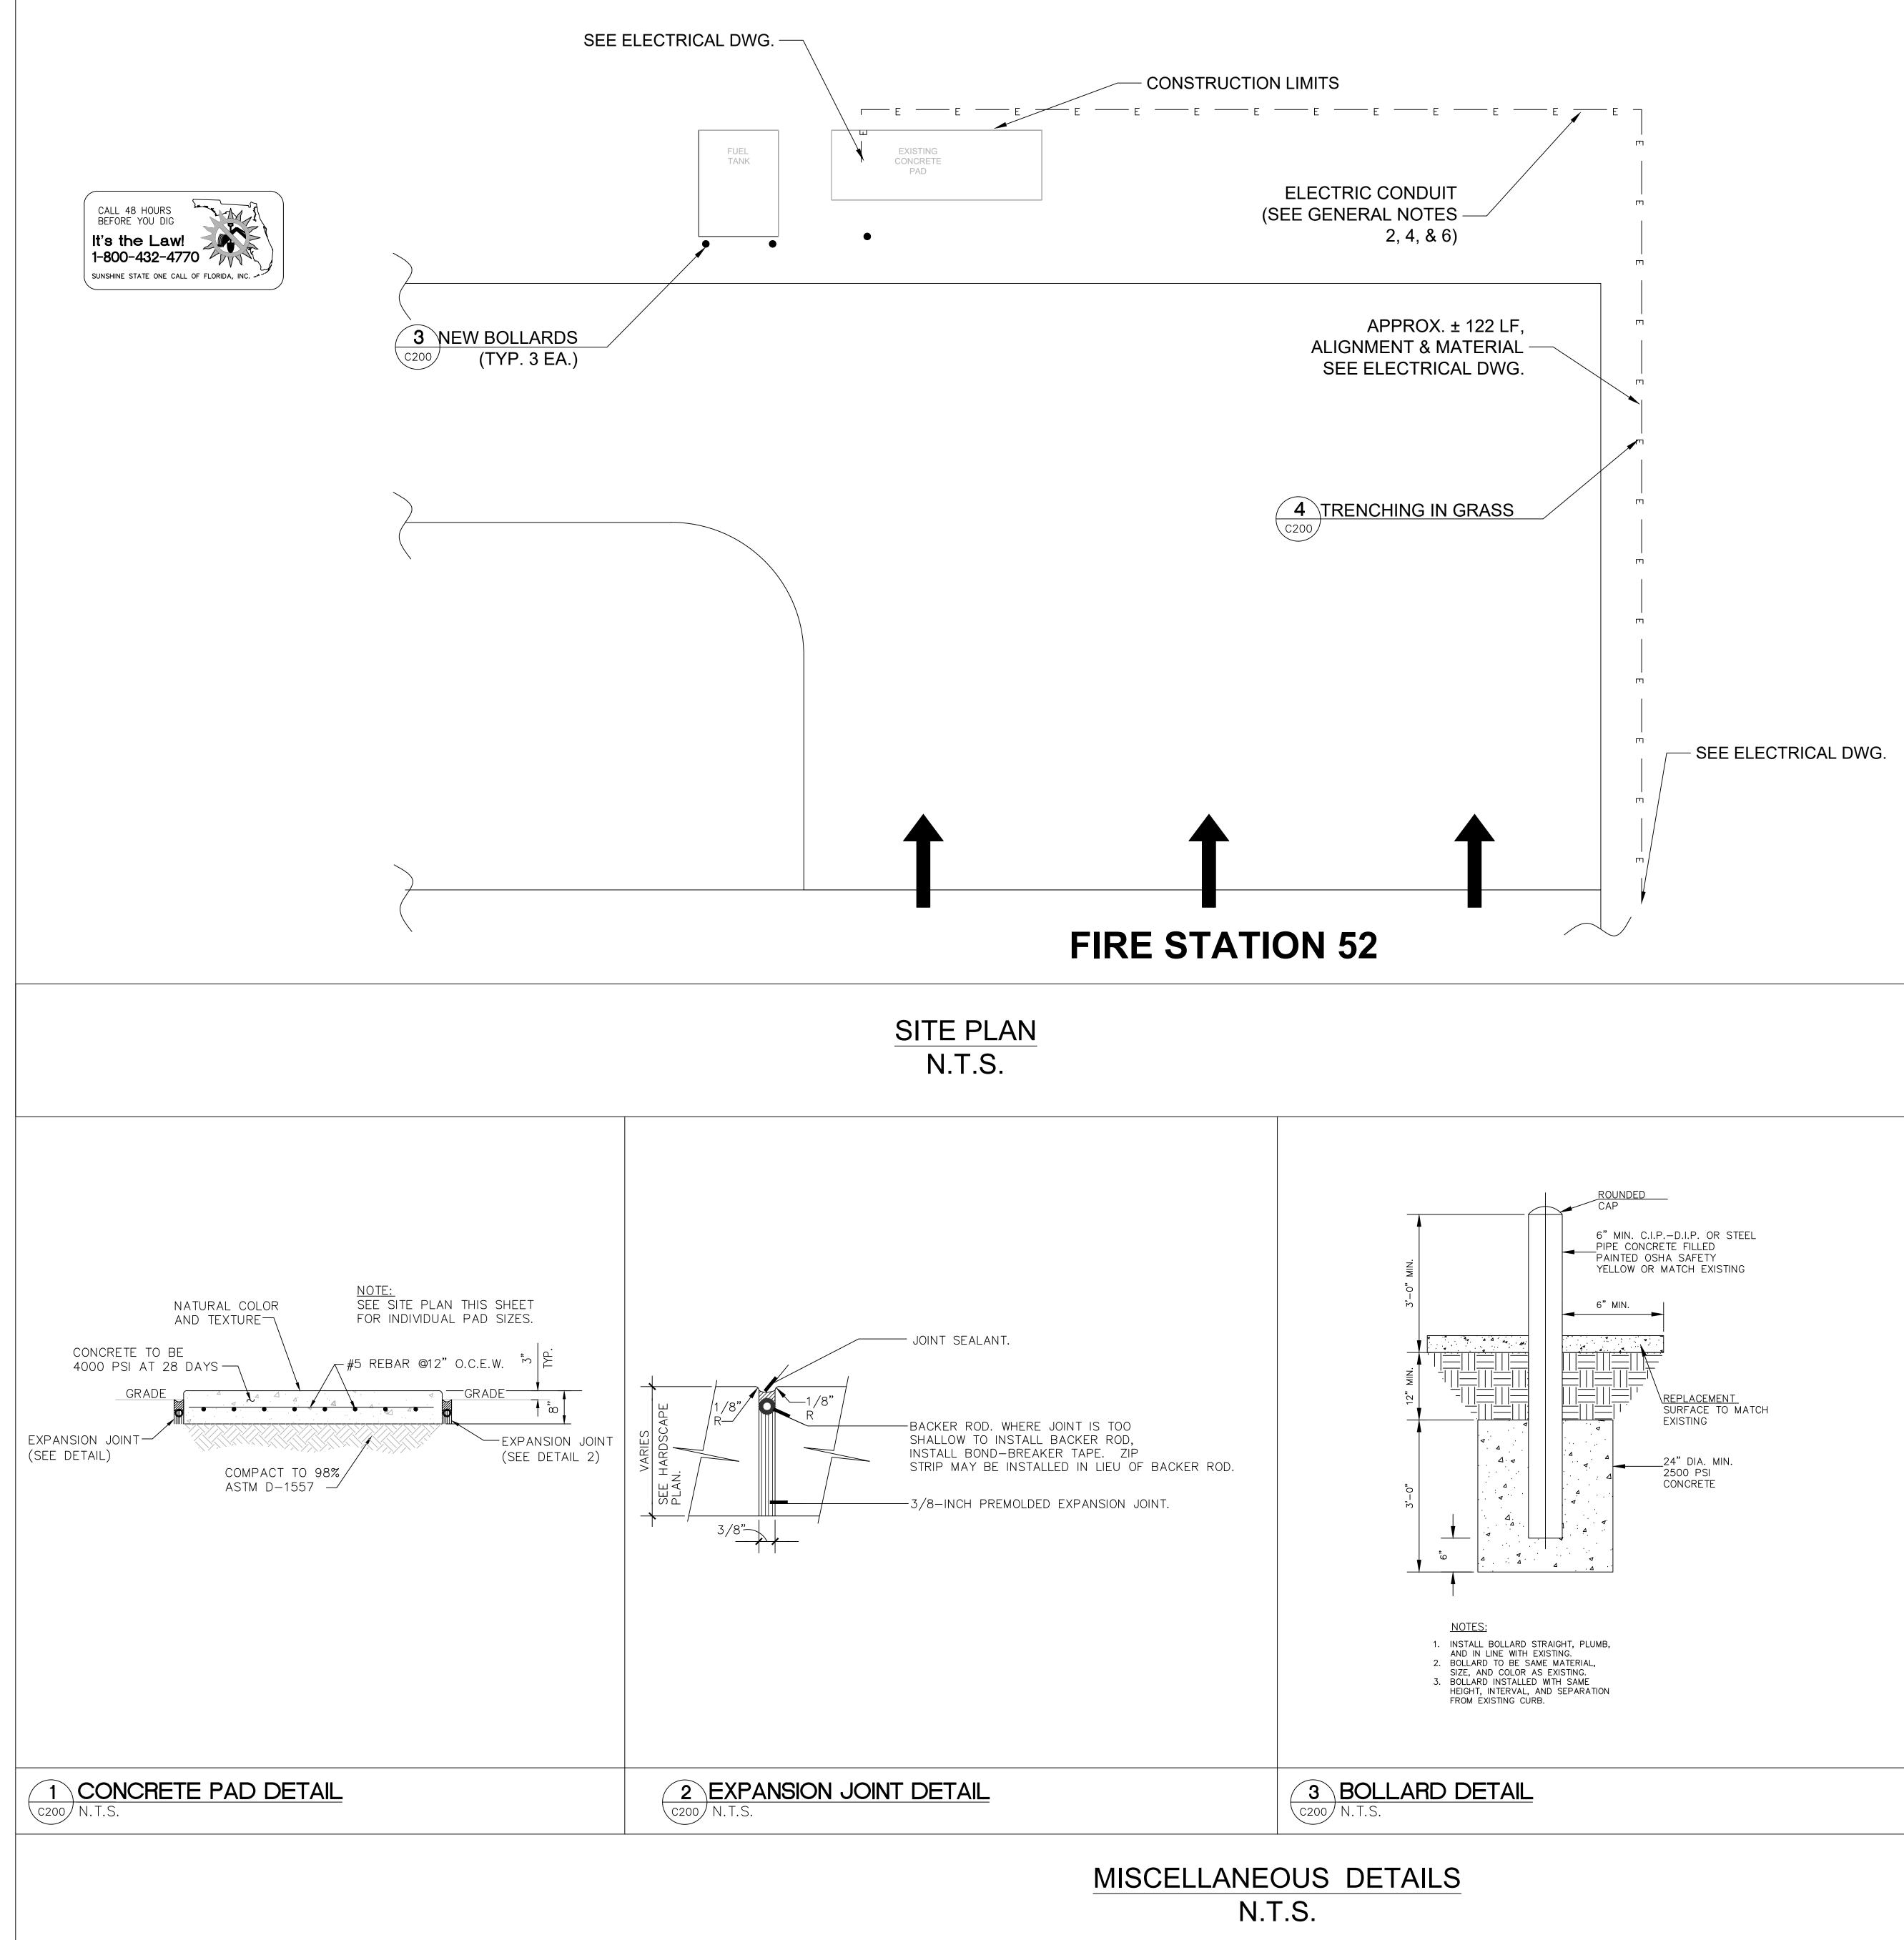
CONTACT OPW FUEL MANAGEMENT SYSTEMS IN CASE OF TROUBLE OR UNUSUAL APPLICATION.

TELEPHONE 708-485-4200 FAX 708-485-7137

> PULSER INSTALLATION DETAIL





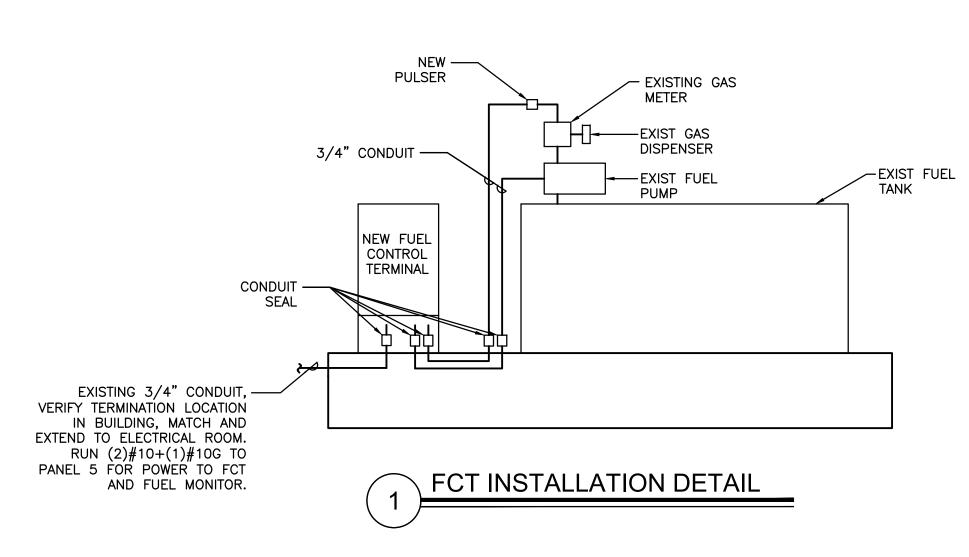

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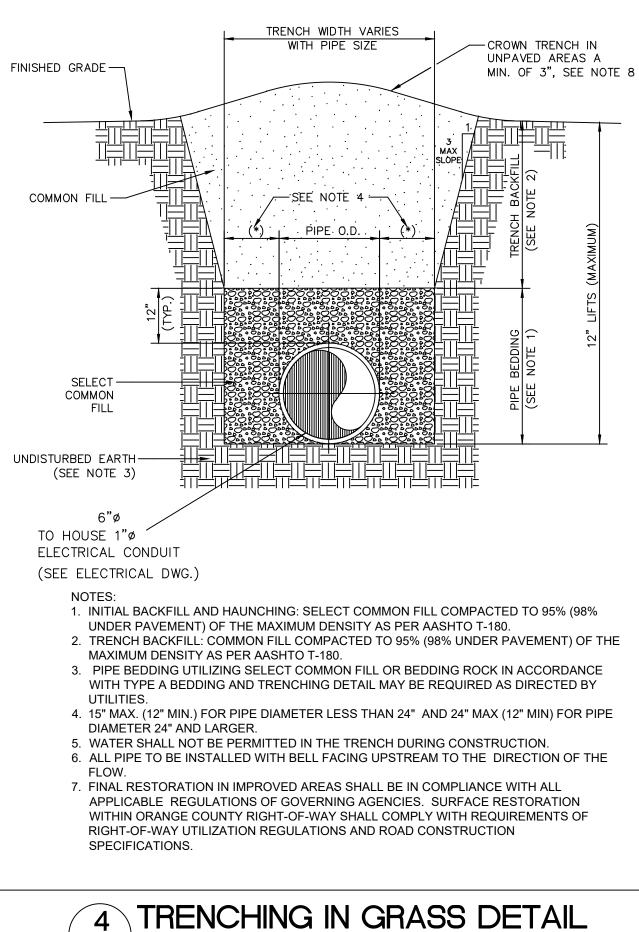
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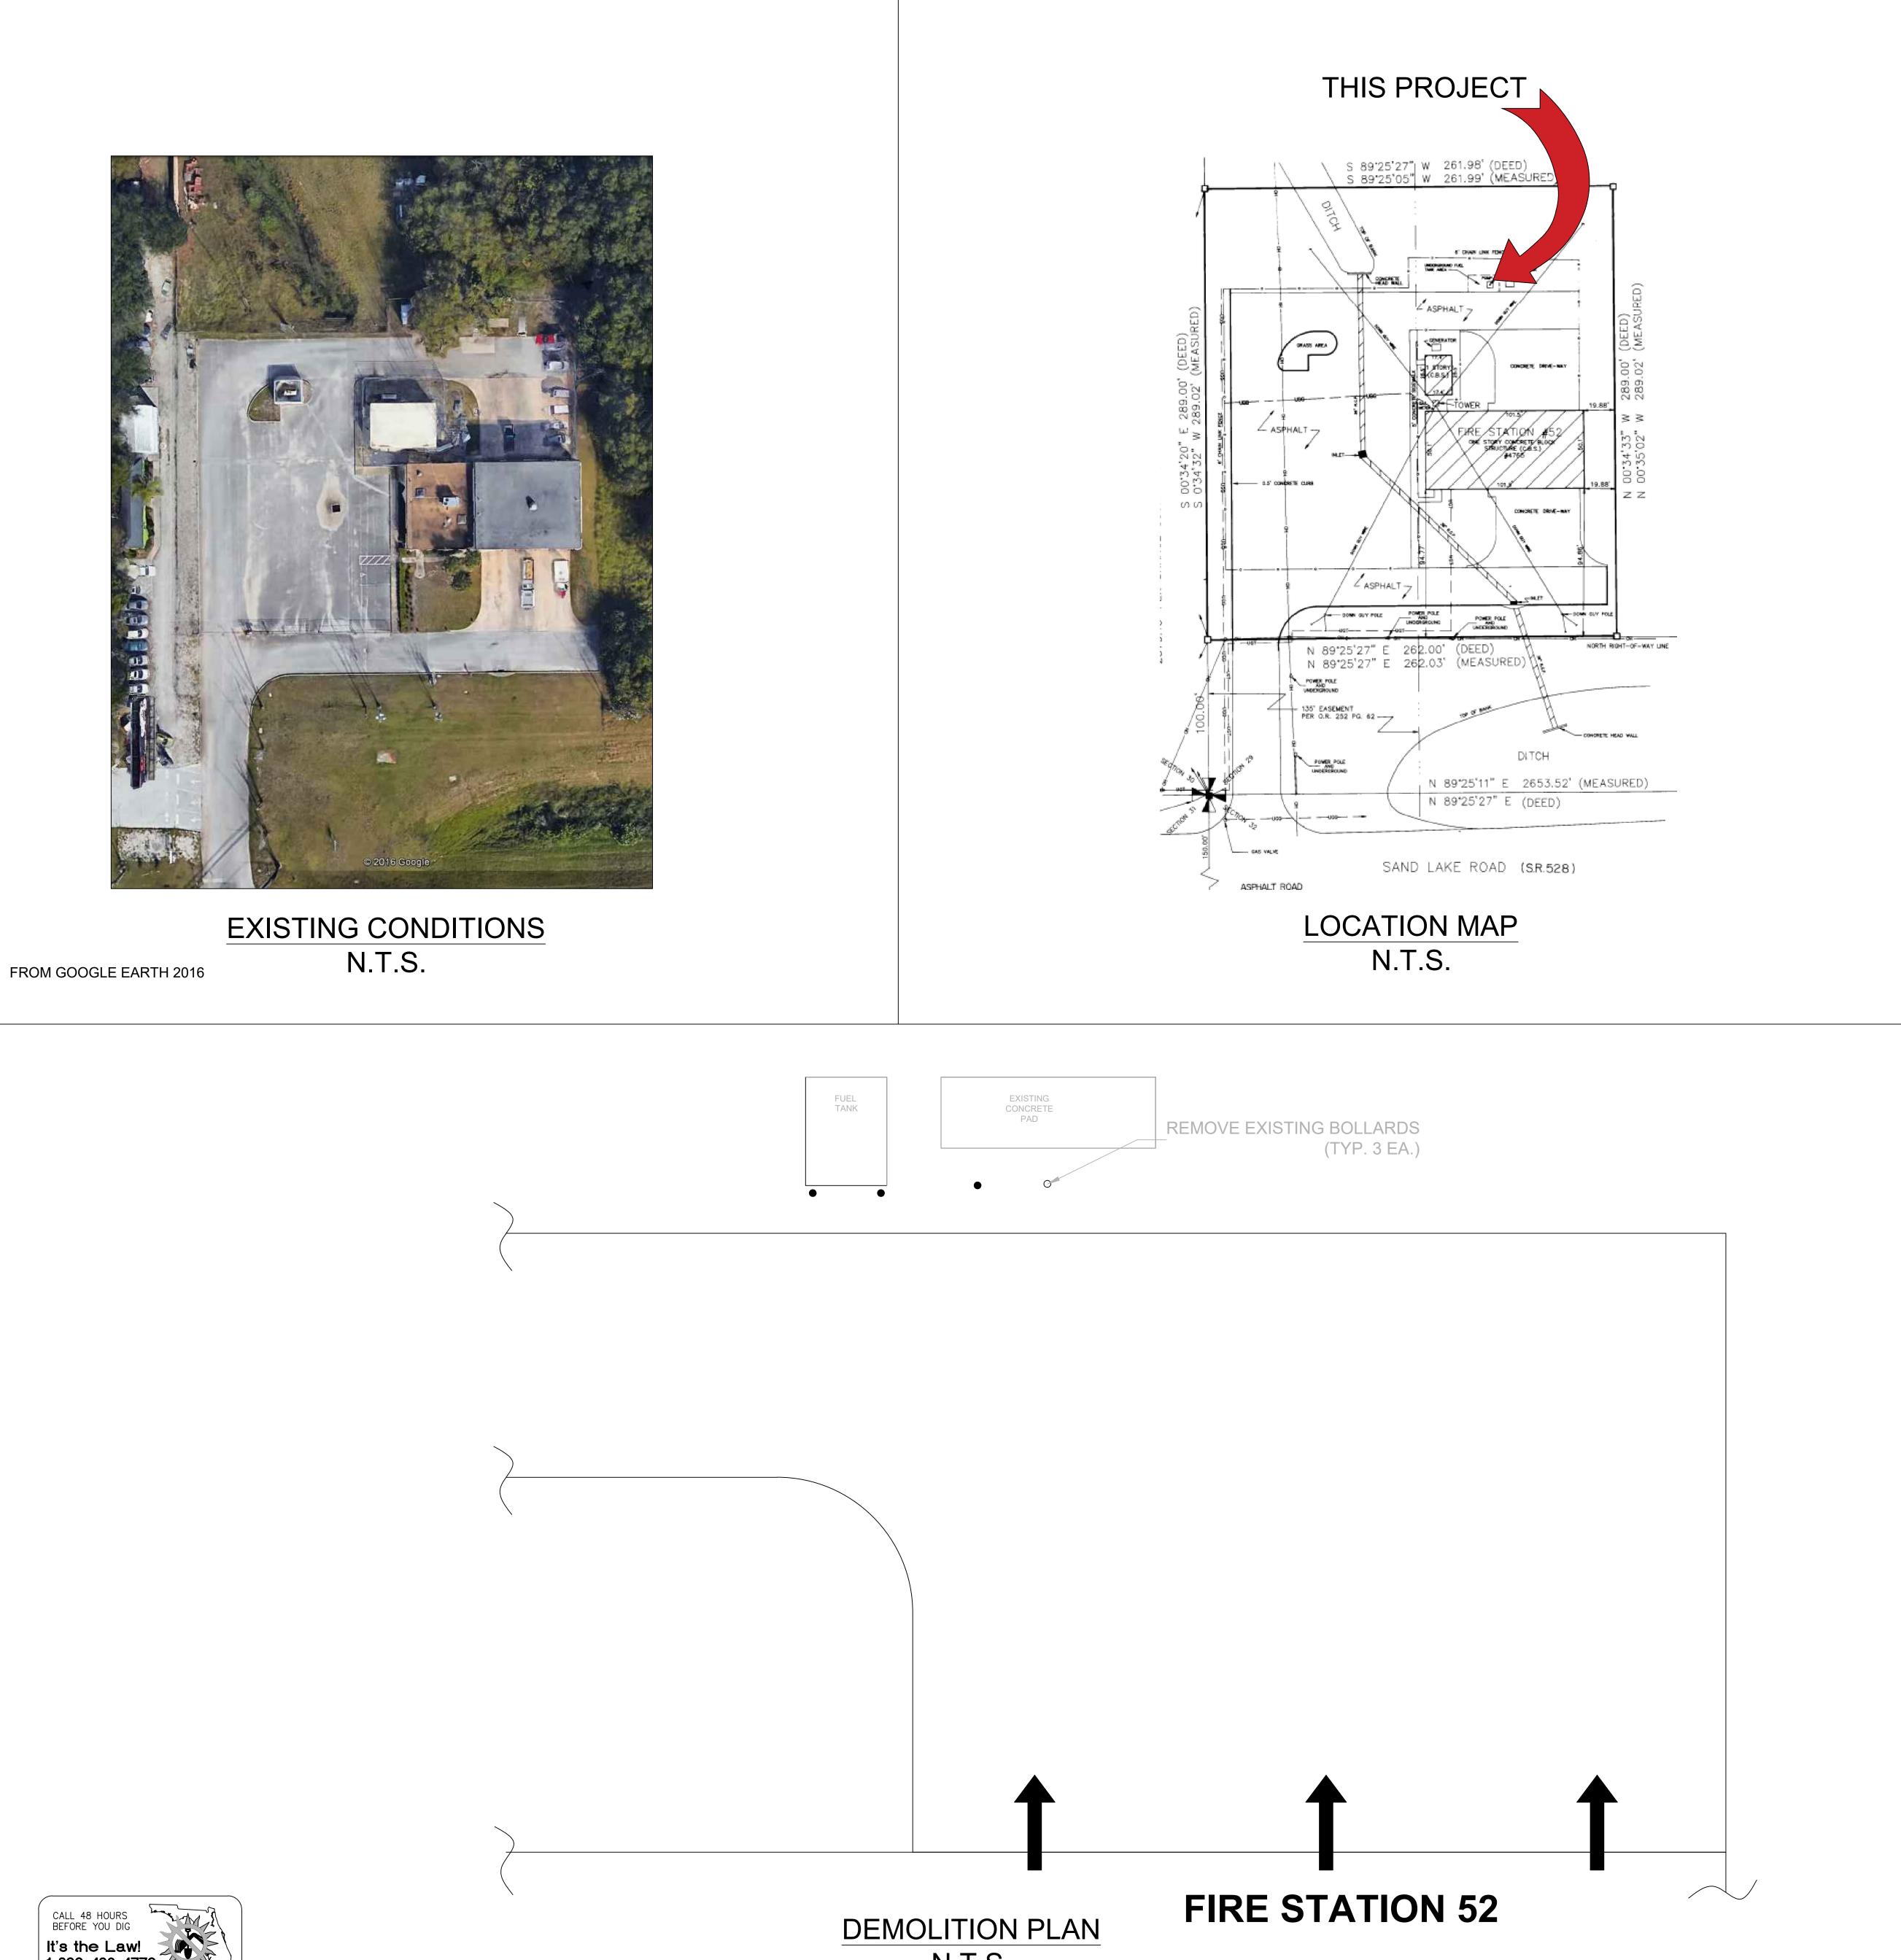
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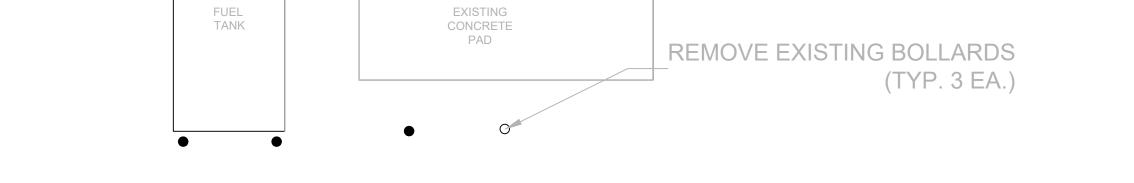
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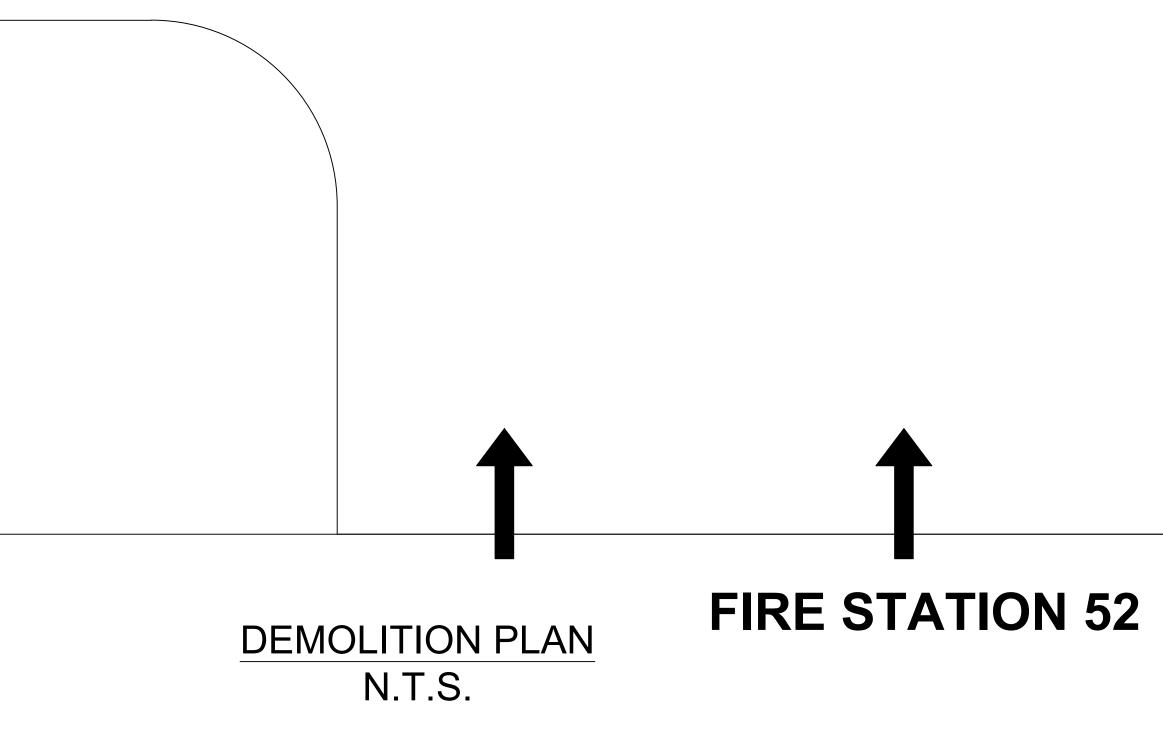
engineering consultants 925 S. Semoran Blvd | Suite 100 | Winter Park, FL 32792 T: 407.678.2055 : www.tmassociates.com Client: ∩ RANGE BUNT FLORIDA Consultants: EOR Stamp: Project: OC FIRE RESCUE FUEL TANK AUTOMATION AND REPLACEMENT DESIGN Location: Fire Station 52 4765 W SAND LAKE RD, ORLANDO, FL 32819 Issuance: Permit Documents Revisions: # Date Description Date: 11.23.2018 Project Number: 16.OC.043 Checked By: Drawn By: S.D.H. D.D. Civil Site Plan Sheet No.: 52-C200











GENERAL NOTES - CIVIL

1. THIS PROJECT IS LOCATED WITHIN THE ORANGE COUNTY FIRE RESCUE STATION. TO WORK WITHIN THIS FIRE STATION CONTRACTOR HAS TO OBSERVE, FOLLOW AND ABIDE THOROUGHLY, METICULOUSLY AND STRICTLY TO EACH AND EVERY SECURITY RULES AND REGULATIONS CONCERNING SUCH AS BUT NOT LIMITED TO WORKERS WORKING HOURS, INGRESS AND EGRESS POINTS FOR CONTRACTOR PERSONNEL, VEHICLE AND EQUIPMENT.

TOPOGRAPHIC INFORMATION AS SHOWN ON DRAWINGS IS PROVIDED FOR INFORMATION PURPOSE ONLY. CONTRACTOR TO CALL SUNSHINE ONE CALL OF FLORIDA 1-800-432-4770 TO LOCATE UNDERGROUND UTILITIES AT LOCATIONS OF TRENCHING AND PAVEMENT CUT AS SHOWN ON DRAWINGS.

3. ORANGE COUNTY PROJECT MANAGER AND ENGINEER DO NOT ASSUME RESPONSIBILITY FOR ACCURACY OF LOCATION AND/OR DEPTH OF ABOVE GROUND UTILITIES.

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11. AT THE END OF EACH DAY CONTRACTOR SHALL SECURELY PROTECT ANY CONSTRUCTION AREAS DISTURBED BY SAW CUTTING AND/OR TRENCHING AND REMOVE DEBRIS TRASH AND OTHER CONSTRUCTION MATERIALS, AND MOVE EACH AND EVERY VEHICLE, EQUIPMENT, AND ANCILLARIES OUT OF THE FIRE STATION TO THE SATISFACTION OF ORANGE COUNTY PROJECT MANAGER.

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ngineering consultar 925 S. Semoran Bivd | Suite 100 | Winter Park, FL 32792 T: 407.678.2055 : www.ttmassociates.com

Client:



Consultants:

EOR Stamp:

Project: OC FIRE RESCU FUEL TANK AUTOMATION A REPLACEMENT DESIGN

Location: Fire Station 52 4765 W SAND LAKE RD, ORLANDO, FL 32819

Issuance: Permit Documents

Revisions: # Date Description

Date:

11.23.2018 Project Number:


Drawn By: Checked By: **S.D.H.** Civil Demo

Plan

52-C100

16.OC.043

Sheet No.:

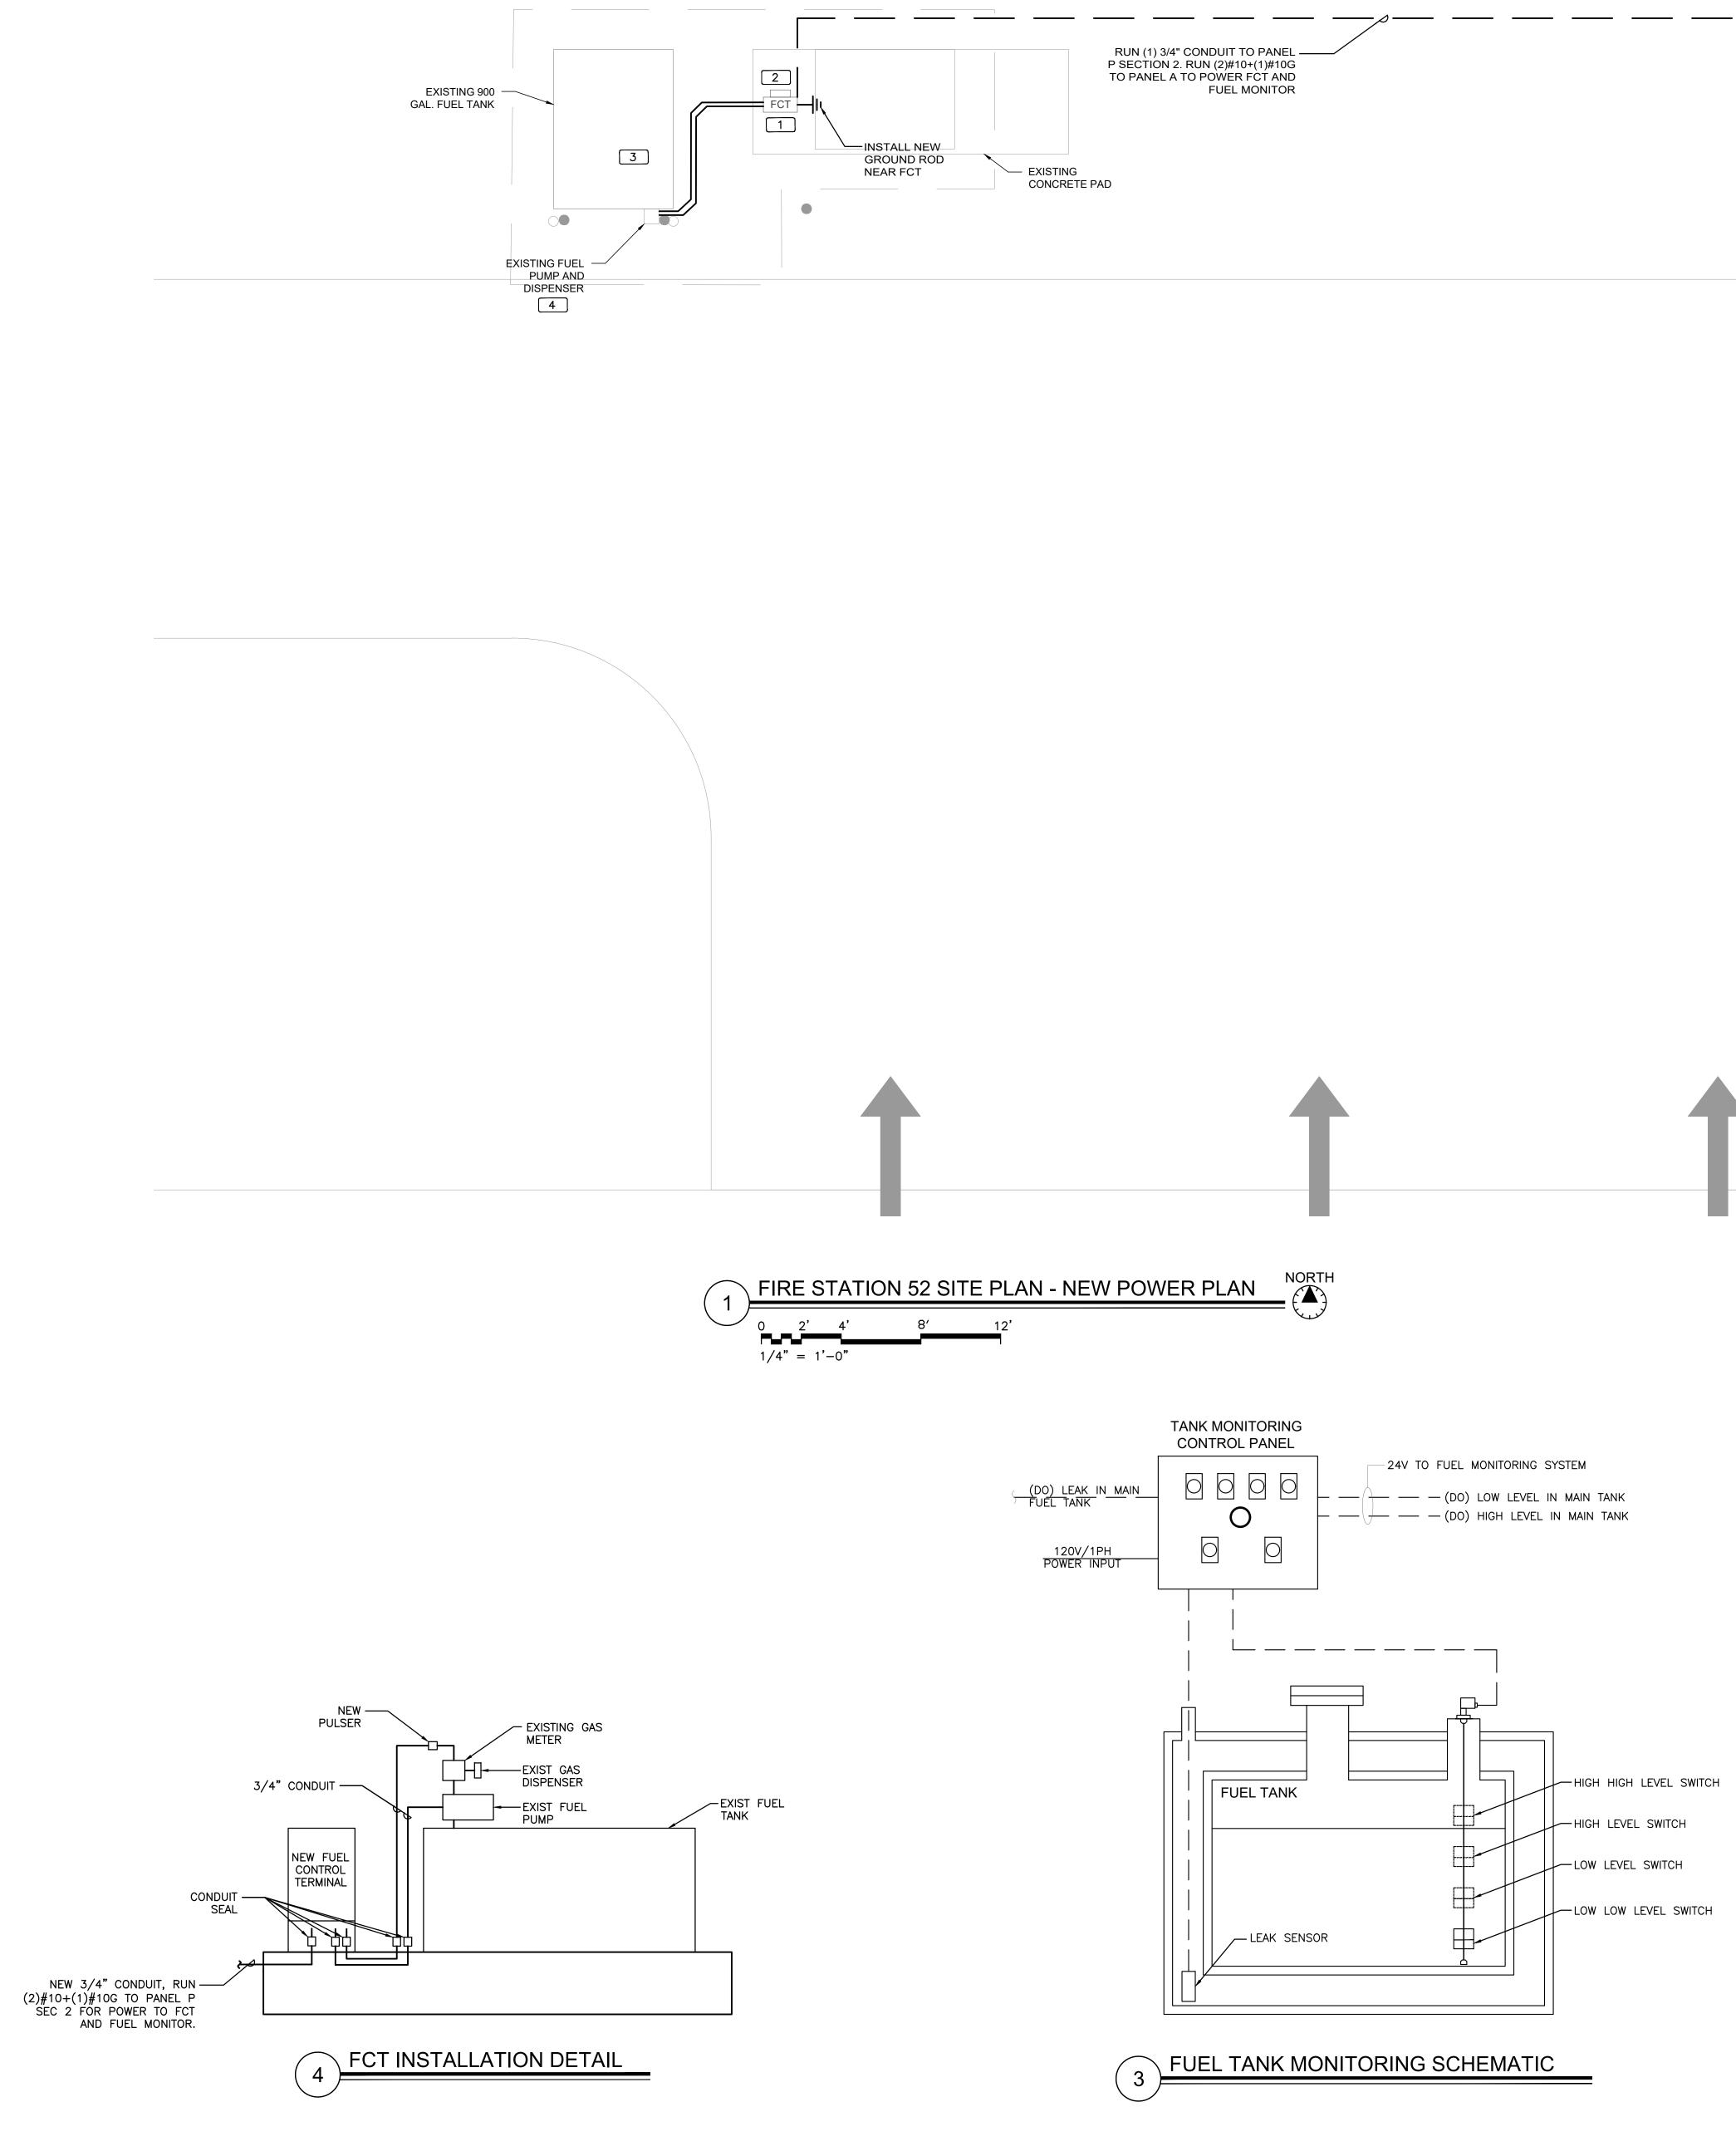


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KEY N	IOTES
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4 PROVIDE AND INSTALL NEW ELECTRONIC PULSER, BASIS OF DESIGN OPW MODEL 800-F, SEE 2/E201 FOR MORE INFORMATION.




optical head Δ FILL-RITE 800 OR 900 SERIES REGISTER MODEL 800-F PULSER INSTALLATION

- REMOVE THE RESET KNOB AND COVER FROM THE REGISTER. (IF EQUIPPED) REMOVE THE NUUT AND WASHER FROM THE SHAFT ON THE LEFT SIDE OF THE REGISTER (LATER MODEL REGISTER ARE BUILT WITH A SMOOTH SHAFT).
- PLACE THE OPTICAL SUCH THAT IT STRADDLES THE PLASTIC GEAR ON THE END OF THE SHAFT AND THE BRACKET SLOT IN ON THE SHAFT SCREW. 4. (IF EQUIPPED) REPLACE THE WASHER AND NUT REMOVED IN STEP.2. ON LATE MODELS, SECURE THE OPTICAL HEAD WITH THE SUPPLIED PUSH NUT. REPLACE THE REGISTER COVER AND RESET BOX.
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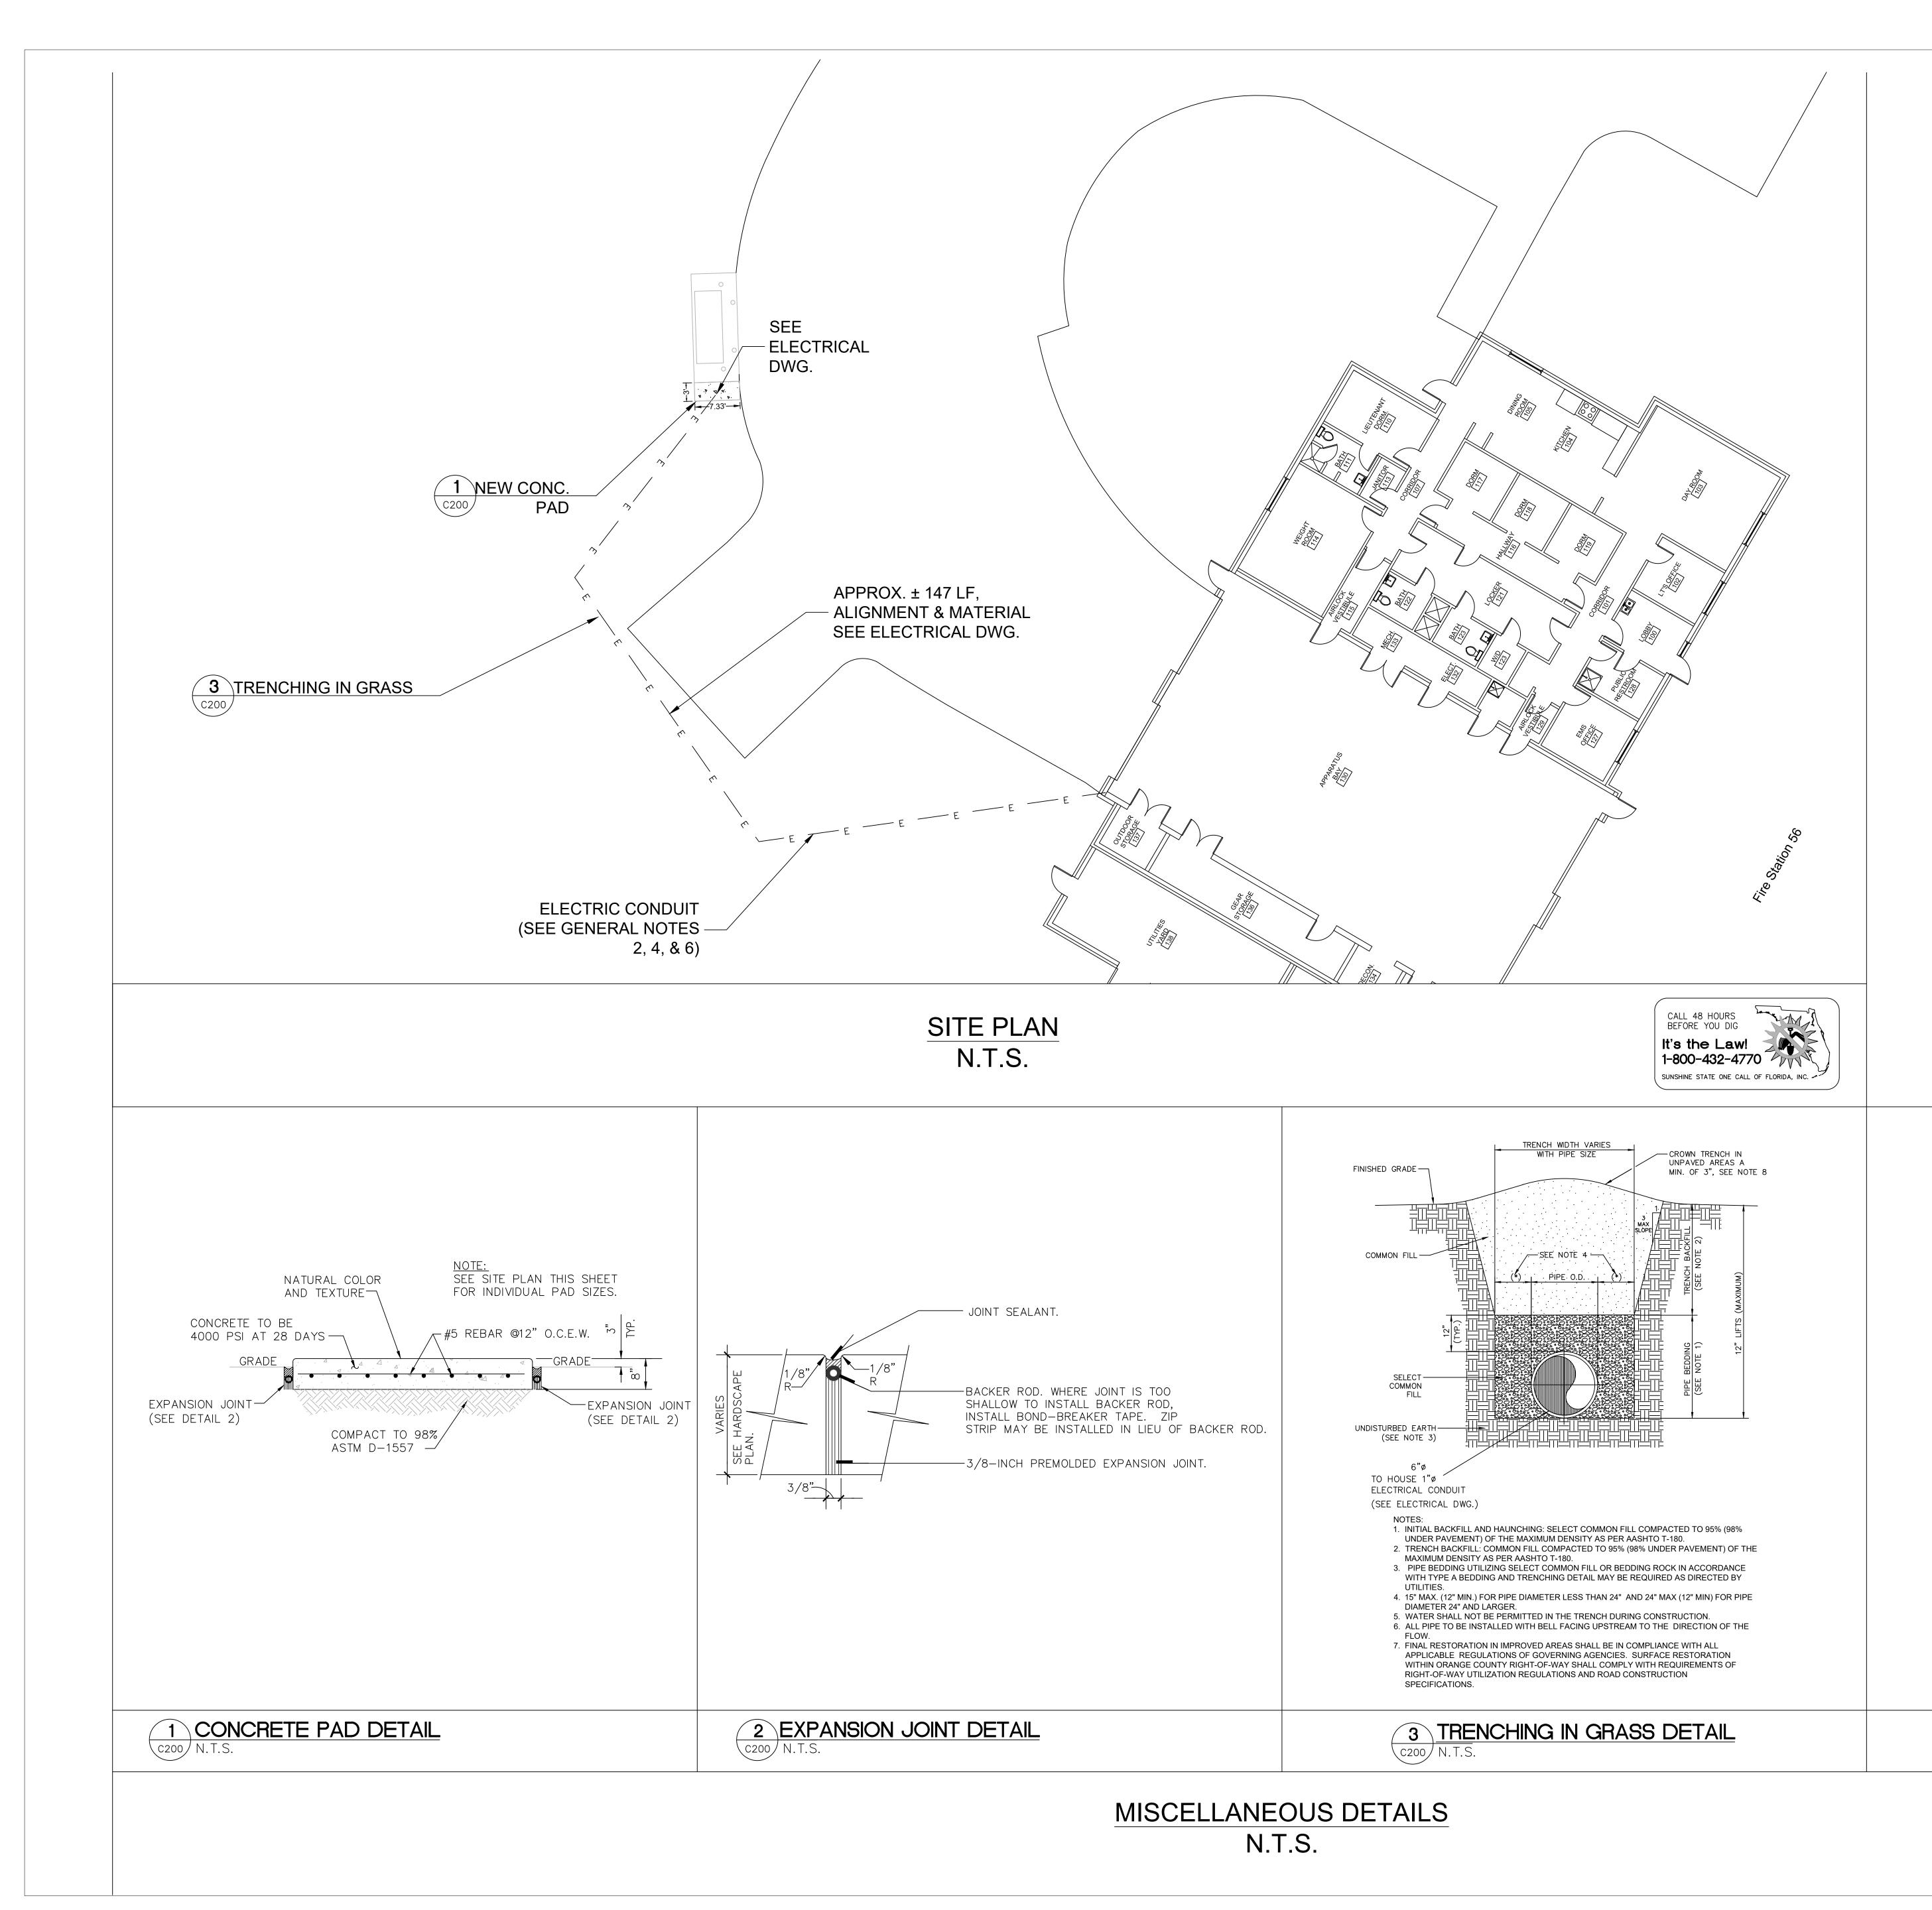
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52-E101

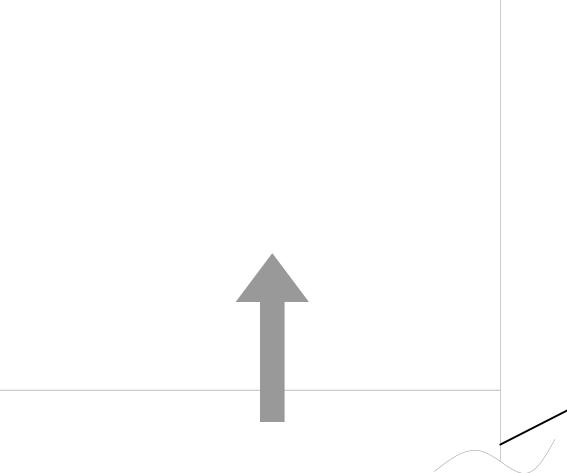

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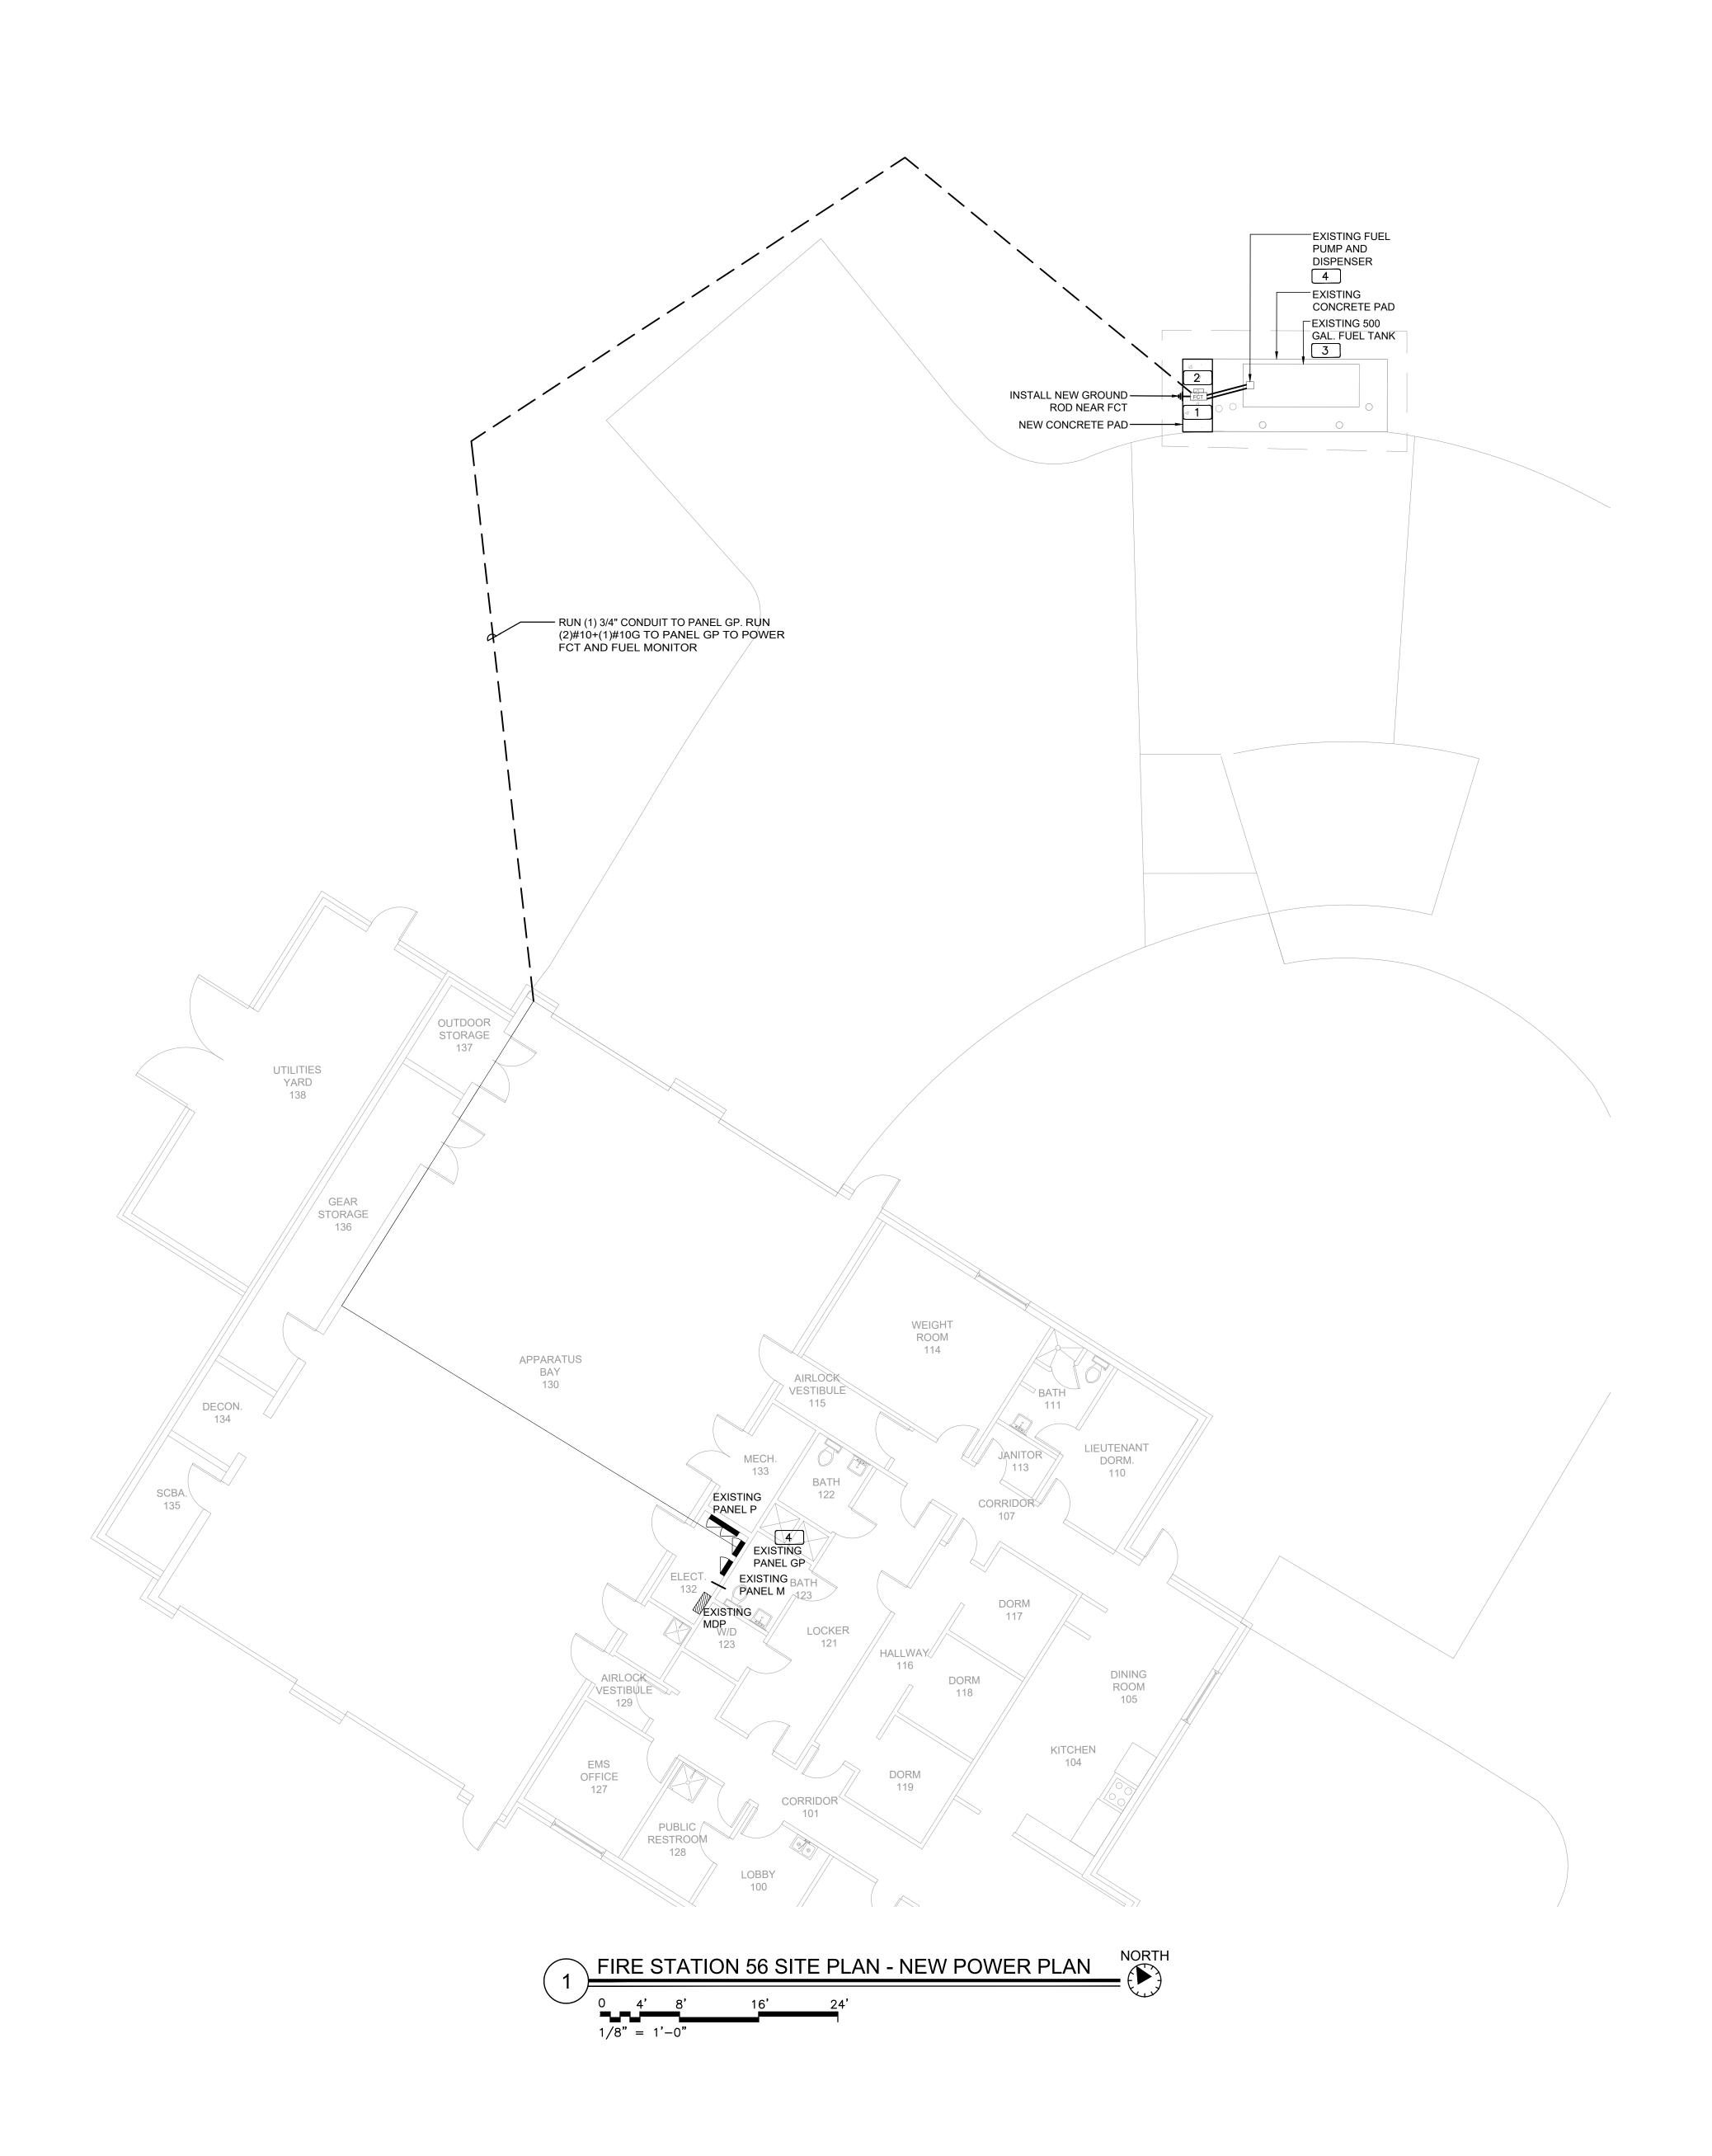
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Revisions: # Date Description

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SP
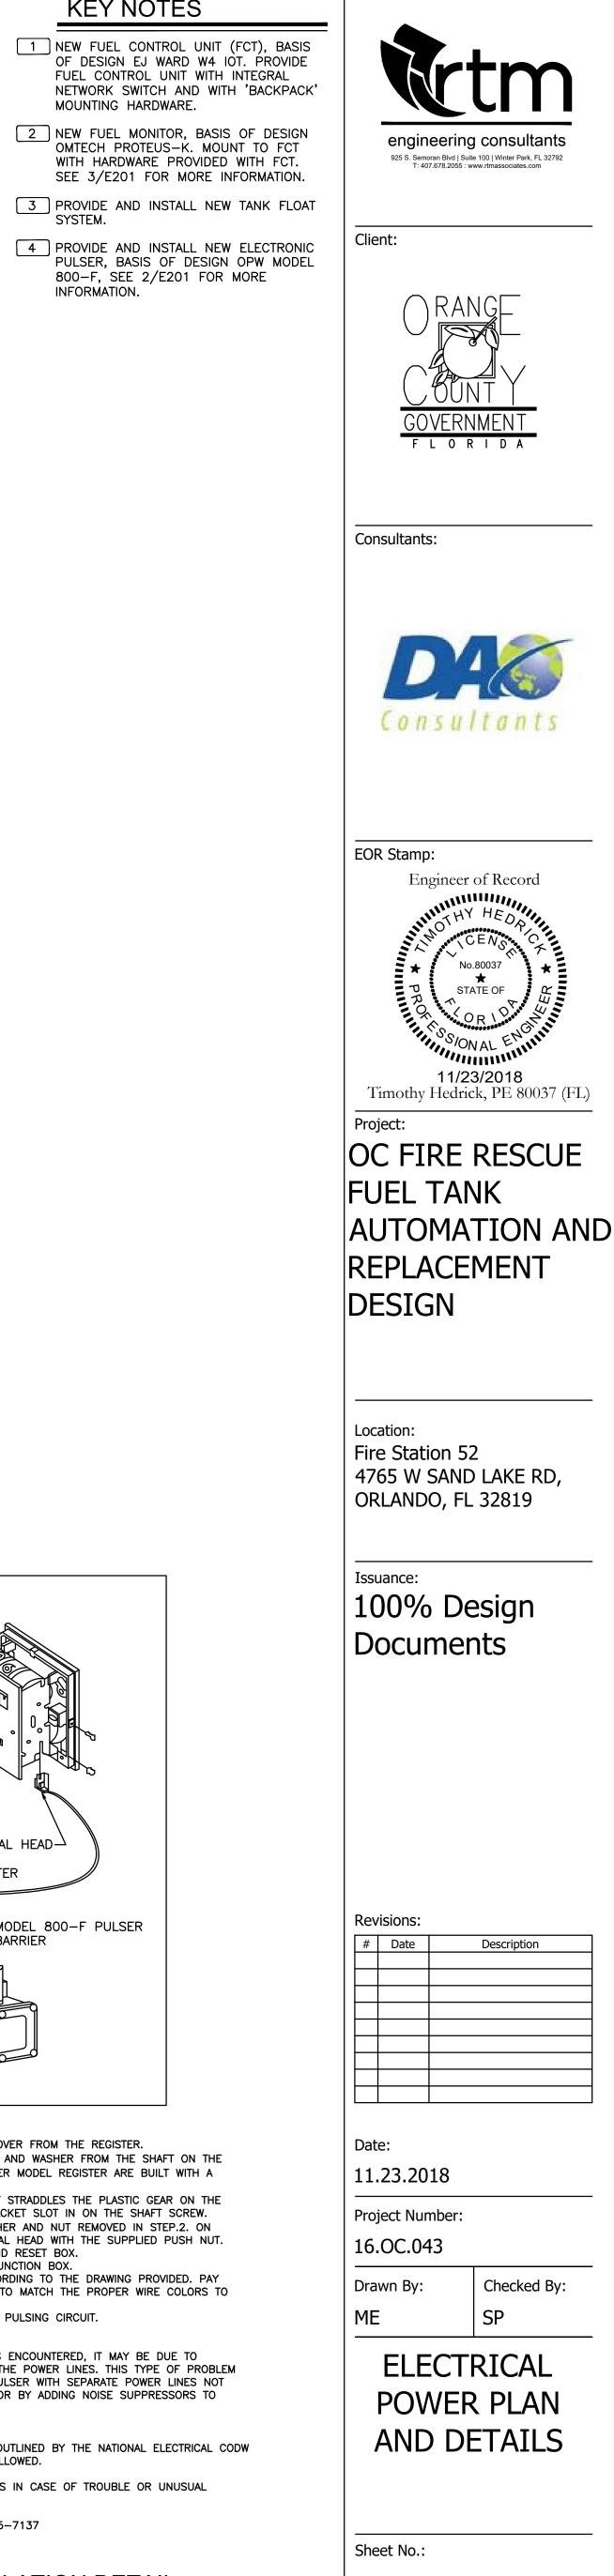
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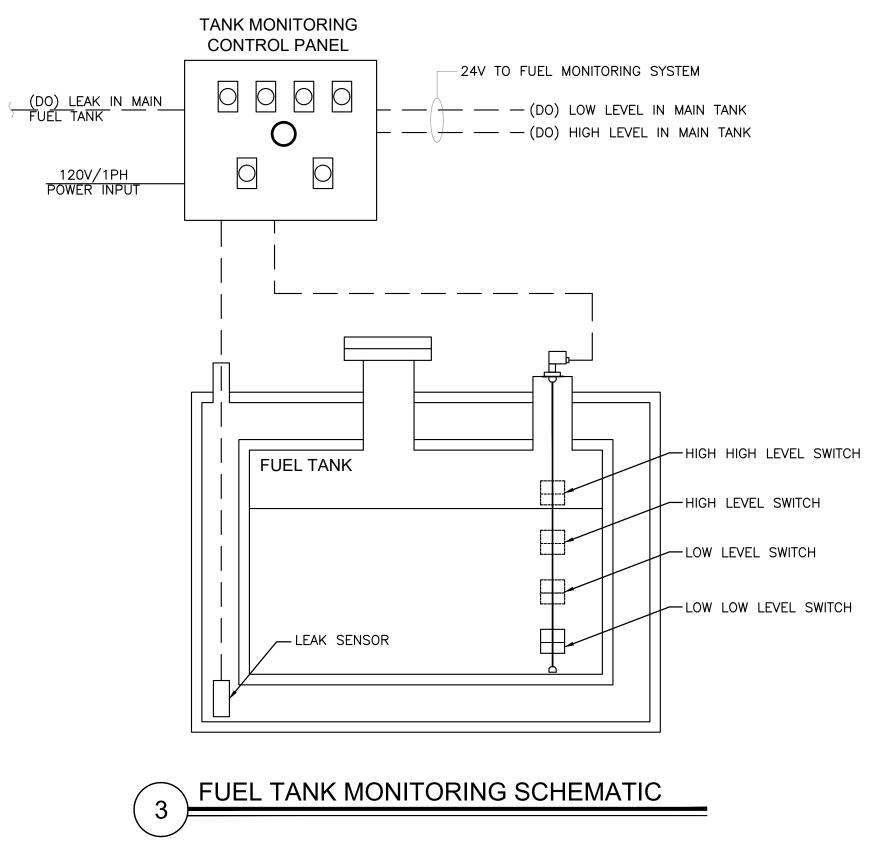
POWER PLAN

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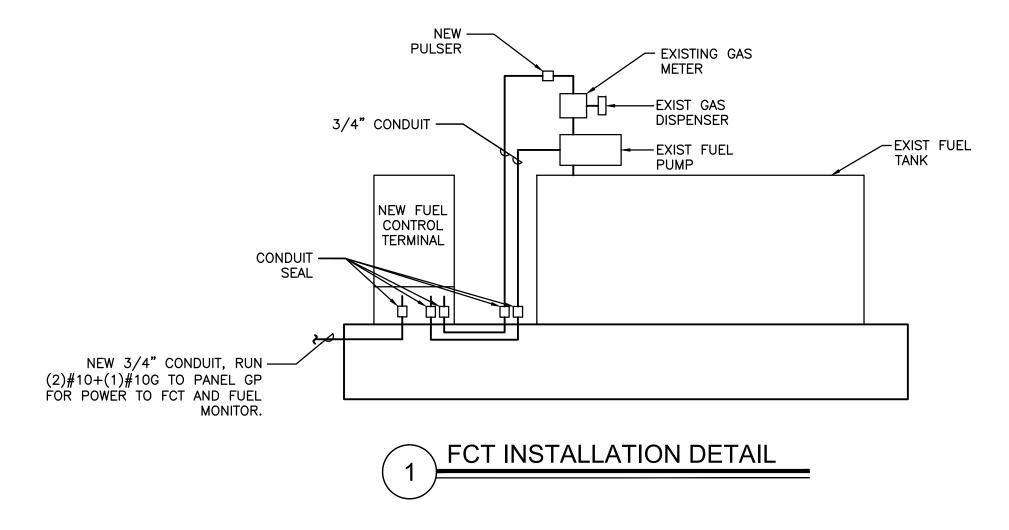
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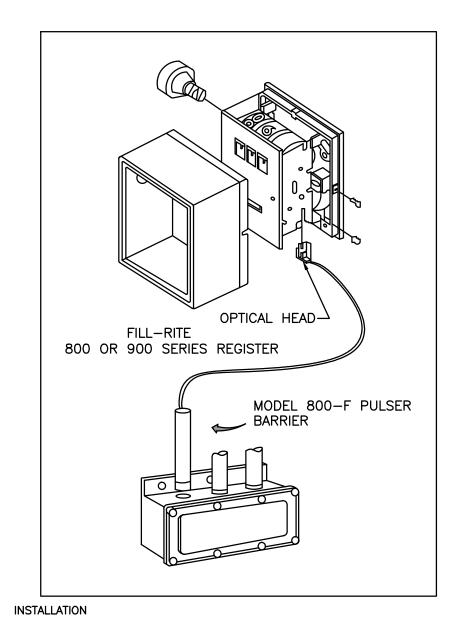
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1	GAS PUMP	3/4"	#10	#10	#10	30/2	м	1450 500			L	20/2	3/4"	#12	#12	#12	LIGHTS	2
3			#10				м		1450 500		L			#12				4
5	DISPENSER	3/4"	#12	#12	#12	20/2	N			1000	N	20/2	3/4"	#12	#12	#12	MONITOR	6
7			#12				N	1000			N			#12				8
9	CARD READER	3/4"	#12	#12	#12	20/2	N		1000		N	20/2	3/4"	#12	#12	#12	EXISTING LOAD	10
11			#12				N			1000 1000	N			#12				12
13	SPACE	-	-	-	-	-	-	800	-		N	20/1	3/4"	#12	#12	#12	EXISTING LOAD	14
15	SPACE	-	-	-	-	-	_		- 800		N	20/1	3/4"	#12	#12	#12	GP	16
17	EXISTING LOAD	3/4"	#12	#12	#12	20/2	N			1250	-	-	_	-	-	-	SPACE	18
19			#12				N	1250			_	-	_	-	-	-	SPACE	20
21	SPACE	-	-	-	-	-	_				_	_	_	_	-	-	SPACE	22
23	SPACE	-	-	-	-	-	_				-	_	_	_	-	-	SPACE	24
25	FCT & FUEL MONITOR	3/4"	#10	# 10	#10	20/1	N	840 33	-		N	30/3	3/4"	#10	#10	#10	SURGE SUPRESSOR	26
27	SPACE	-	-	-	-	-	-		- 33		N			#10				28
29	SPACE	-	-	-	-	-	_				N			#10				30
	INTERRUP	t ratin	G:					6873	4783	5283]			FR	OM:			
LOA		EMAND ACTOR	MINIM FEED		LOAE)S		100	NNECTE	D DEM		MININ FEED			INING INUOU	IS LOA	ADS <u>0</u> 1.25 <u>0</u>	
REC	CEPTS TO 10 KVA 0	1.25 1.0 0.5	0 0		MOT	-SEAS ORS GEST		_	<u>2900</u> 0	1. 0.2		0		NON-	INING -CONT ND LC		US LOADS <u>13039</u> 1.0 <u>13039</u> 1.0	
		0.0 1.0	0 0			ER HE HEN E			0	1. 1.		0					ED LOAD <u>16.9</u> KVA <u>47.1</u> NEL CAP. <u>17.2</u> KVA <u>47.7</u>	

OVERALL DEMAND FACTOR ______





- REMOVE THE RESET KNOB AND COVER FROM THE REGISTER. (IF EQUIPPED) REMOVE THE NUUT AND WASHER FROM THE SHAFT ON THE LEFT SIDE OF THE REGISTER (LATER MODEL REGISTER ARE BUILT WITH A
- 3. PLACE THE OPTICAL SUCH THAT IT STRADDLES THE PLASTIC GEAR ON THE END OF THE SHAFT AND THE BRACKET SLOT IN ON THE SHAFT SCREW.
- 4. (IF EQUIPPED) REPLACE THE WASHER AND NUT REMOVED IN STEP.2. ON LATE MODELS, SECURE THE OPTICAL HEAD WITH THE SUPPLIED PUSH NUT. REPLACE THE REGISTER COVER AND RESET BOX. 5.
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- THE PROPER CONNECTIONS. 8. CONNECT THE RED WIRES TO THE PULSING CIRCUIT.

IF ERRATIC OPERATION OF THE PULSER IS ENCOUNTERED, IT MAY BE DUE TO ELECTRICAL NOISE OR FLUCTUATIONS OF THE POWER LINES. THIS TYPE OF PROBLEM CAN BE ELIMINATED BY POWERING THE PULSER WITH SEPARATE POWER LINES NOT CONNECTED TO MOTORS OR SOLENOIDS, OR BY ADDING NOISE SUPPRESSORS TO EACH MOTOR AND/OR SOLENOID.

ALL APPROPRIATE WIRING PRACTICES AS OUTLINED BY THE NATIONAL ELECTRICAL CODW AND STATE LOCAL CODES SHOULD BE FOLLOWED. CONTACT OPW FUEL MANAGEMENT SYSTEMS IN CASE OF TROUBLE OR UNUSUAL APPLICATION.

2 PULSER INSTALLATION DETAIL

TELEPHONE 708-485-4200 FAX 708-485-7137





GENERAL NOTES - CIVIL

1. THIS PROJECT IS LOCATED WITHIN THE ORANGE COUNTY FIRE RESCUE STATION. TO WORK WITHIN THIS FIRE STATION CONTRACTOR HAS TO OBSERVE, FOLLOW AND ABIDE THOROUGHLY, METICULOUSLY AND STRICTLY TO EACH AND EVERY SECURITY RULES AND REGULATIONS CONCERNING SUCH AS BUT NOT LIMITED TO WORKERS WORKING HOURS, INGRESS AND EGRESS POINTS FOR CONTRACTOR PERSONNEL, VEHICLE AND EQUIPMENT.

TOPOGRAPHIC INFORMATION AS SHOWN ON DRAWINGS 2. IS PROVIDED FOR INFORMATION PURPOSE ONLY. CONTRACTOR TO CALL SUNSHINE ONE CALL OF FLORIDA 1-800-432-4770 TO LOCATE UNDERGROUND UTILITIES AT LOCATIONS OF TRENCHING AND PAVEMENT CUT AS SHOWN ON DRAWINGS.

3. ORANGE COUNTY PROJECT MANAGER AND ENGINEER DO NOT ASSUME RESPONSIBILITY FOR ACCURACY OF LOCATION AND/OR DEPTH OF ABOVE GROUND UTILITIES.

4. ALIGNMENT OF UTILITIES IS SHOWN TO INDICATE INTENT OF ENGINEER TO CONNECT THESE LINES BETWEEN UTILITIES FOUND.

CONTRACTOR TO VISIT SITE TO FAMILIARIZE HIMSELF 5. WITH EXISTING FIELD CONDITIONS AND LOCATIONS OF EXISTING UTILITIES AS SHOWN ON DRAWINGS. CONTRACTOR TO IMMEDIATELY NOTIFY ORANGE COUNTY PROJECT MANAGER IN WRITING ANY DISCREPANCY OBSERVED FOR PROPER CLARIFICATION.

6. CONTRACTOR TO OBTAIN NECESSARY CONSTRUCTION PERMITS FROM ORANGE COUNTY BUILDING DEPARTMENT AND POST PERMITS ON SITE FOR INSPECTION BY COUNTY INSPECTORS.

BEFORE COMMENCING WORK CONTRACTOR TO SUBMIT TO ORANGE COUNTY PROJECT MANAGER SUCH AS BUT NOT LIMITED TO PHASE OF WORK, SCHEDULE, CREWS, EQUIPMENT WITH ANCILLARIES AND MAINTENANCE OF WORK AREA WITH PROPER BARRICADES FOR REVIEW AND APPROVAL.

DURING CONSTRUCTION CONTRACTOR SHALL INSURE MINIMUM DISTURBANCES TO FIRE STATION OPERATIONS AND SHALL TAKE CARE TO KEEP FIRE TRUCK EXITS CLEARED AT ALL TIME.


CONTRACTOR IS NOT ALLOWED TO PARK VEHICLE, 9. EQUIPMENT, MATERIALS AND ANCILLARIES OVERNIGHT WITHIN THE LIMITS OF THE FIRE STATION.


10. CONTRACTOR TO BRING INSIDE THE FIRE STATION VEHICLE, EQUIPMENT, MATERIALS AND ANCILLARIES IN QUANTITIES SUFFICIENT FOR EACH DAY OF WORK.

11. AT THE END OF EACH DAY CONTRACTOR SHALL SECURELY PROTECT ANY CONSTRUCTION AREAS DISTURBED BY SAW CUTTING AND/OR TRENCHING AND REMOVE DEBRIS TRASH AND OTHER CONSTRUCTION MATERIALS, AND MOVE EACH AND EVERY VEHICLE, EQUIPMENT, AND ANCILLARIES OUT OF THE FIRE STATION TO THE SATISFACTION OF ORANGE COUNTY PROJECT MANAGER.

12. AT THE END OF CONSTRUCTION AND BEFORE CLOSE-OUT CONTRACTOR TO THOROUGHLY CLEAN JOB SITE OF DEBRIS, TRASH, OTHER CONSTRUCTION MATERIALS TO THE SATISFACTION OF ORANGE COUNTY PROJECT MANAGER.

13. AT FINAL INSPECTION CONTRACTOR TO SUBMIT TO ORANGE COUNTY PROJECT MANAGER MARKED-UP DRAWINGS SHOWING ACTUAL ALIGNMENT AND DEPTH OF EACH AND EVERY UTILITIES LINE INSTALLED FOR ENGINEER TO RECORD ON AS-BUILT DRAWINGS.

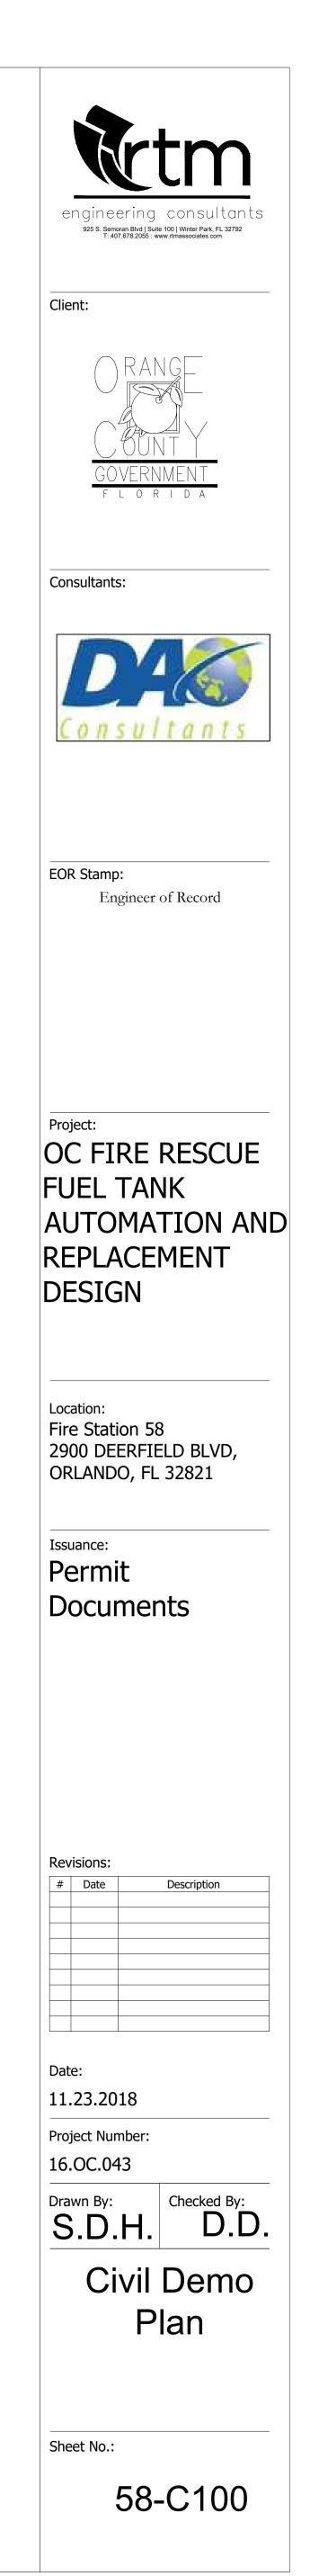

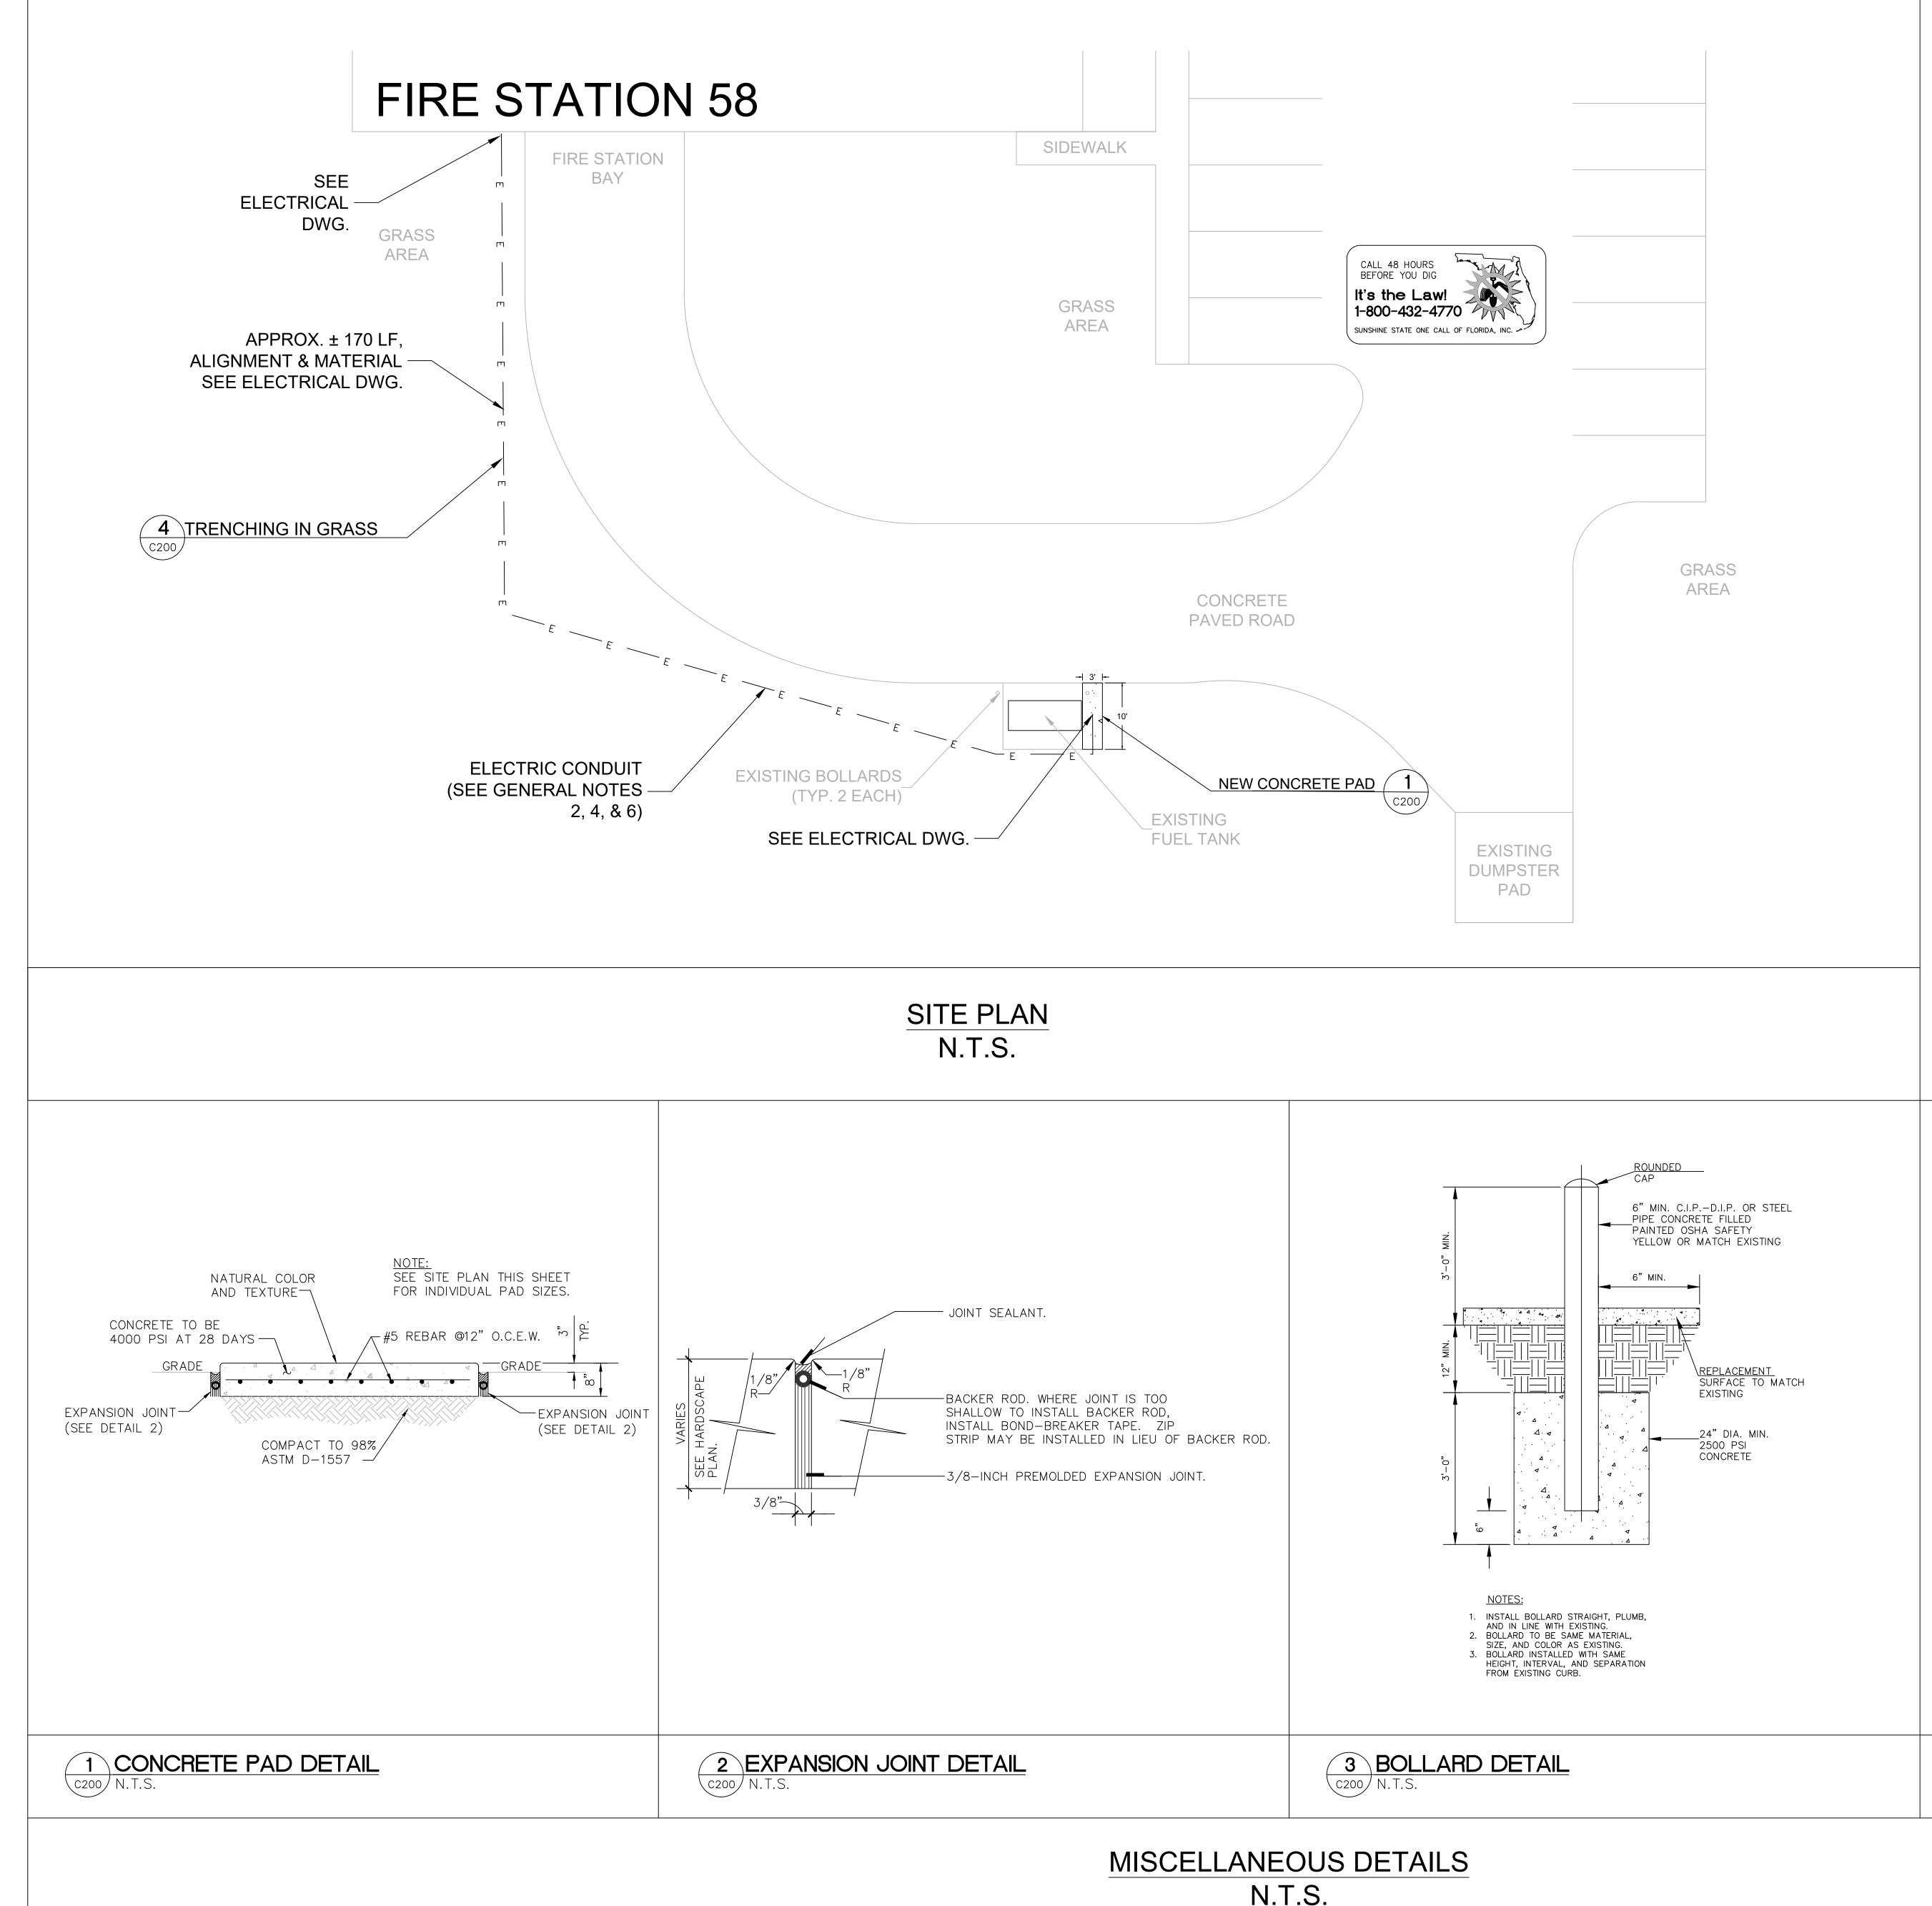

N.T.S.

PROJECT SPECIFIC NOTES - CIVIL

1. DURING CONSTRUCTION CONTRACTOR SHALL INSURE MINIMUM DISTURBANCES TO FACILITY OPERATIONS AND SHALL TAKE CARE TO KEEP EXPOSED AREAS TO A MINIMUM TIME TO REDUCE DUST POLLUTION AND MINIMIZE TRAFFIC DETOUR.


2. CONTRACTOR TO MAINTAIN INLET BARRIERS AND SILT BARRIERS IN GOOD CONDITIONS TO PREVENT INTRODUCTION OF SUSPENDED MATERIALS CAUSED BY HIS CONSTRUCTION ACTIVITIES INTO VARIOUS STORM WATER PONDS FOUND AT THE FIRE STATION FACILITY.

3. CONTRACTOR SHALL BE RESPONSIBLE FOR THE CORRECTION OF ANY EROSION, SEDIMENTATION OR WATER QUALITY PROBLEMS WITHIN STORM WATER PONDS THAT RESULT FROM HIS CONSTRUCTION ACTIVITIES.


4. TO AVOID DAMAGES TO THE UNDERGROUND UTILITIES TRENCHING EQUIPMENT IS NOT ALLOWED TO OPERATE ON SODDED AREAS. CONTRACTOR TO HAND DUG UTILITIES TRENCH FOR LAYING CONDUITS


5. SAWCUTTING FOR INSTALLATION OF CONCRETE PAD TO BE IN CONFORMANCE WITH ALIGNMENT AND DEPTH AS SHOWN ON DRAWINGS. FOR ANY SUBSTANTIAL DEVIATION IN ALIGNMENT CONTRACTOR TO SUBMIT IN WRITING TO ORANGE COUNTY PROJECT MANAGER FOR REVIEW AND APPROVAL BEFORE WORK.

6. INSTALL AND CONNECT UTILITIES LINES SUCH AS POWER AT LOCATION AND DEPTH AS SHOWN ON ELECTRICAL DRAWINGS.

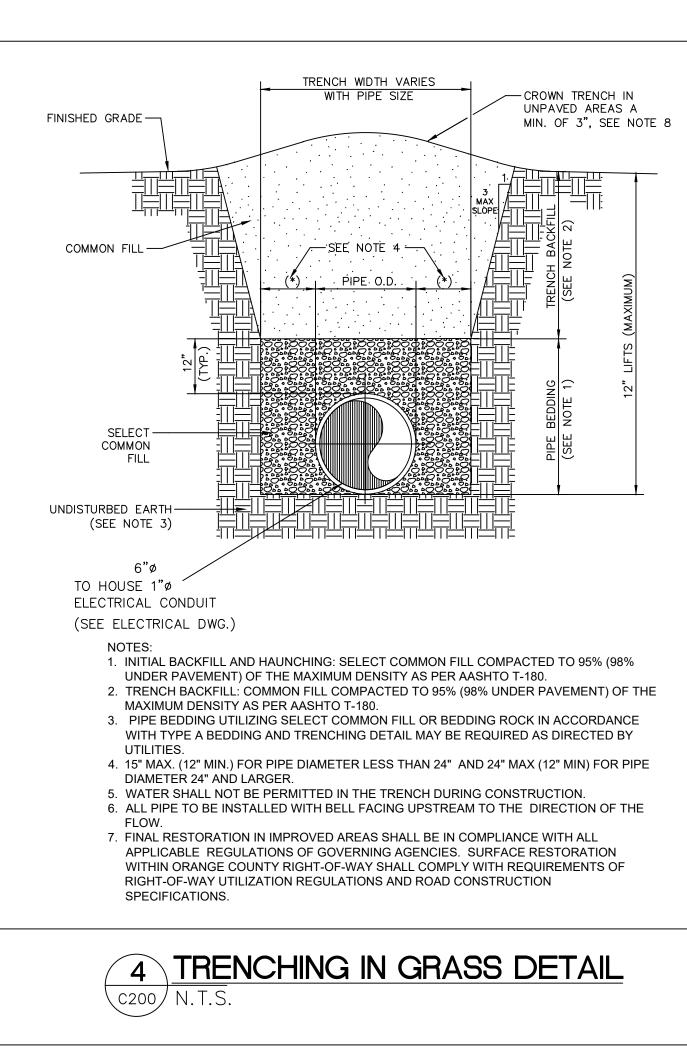



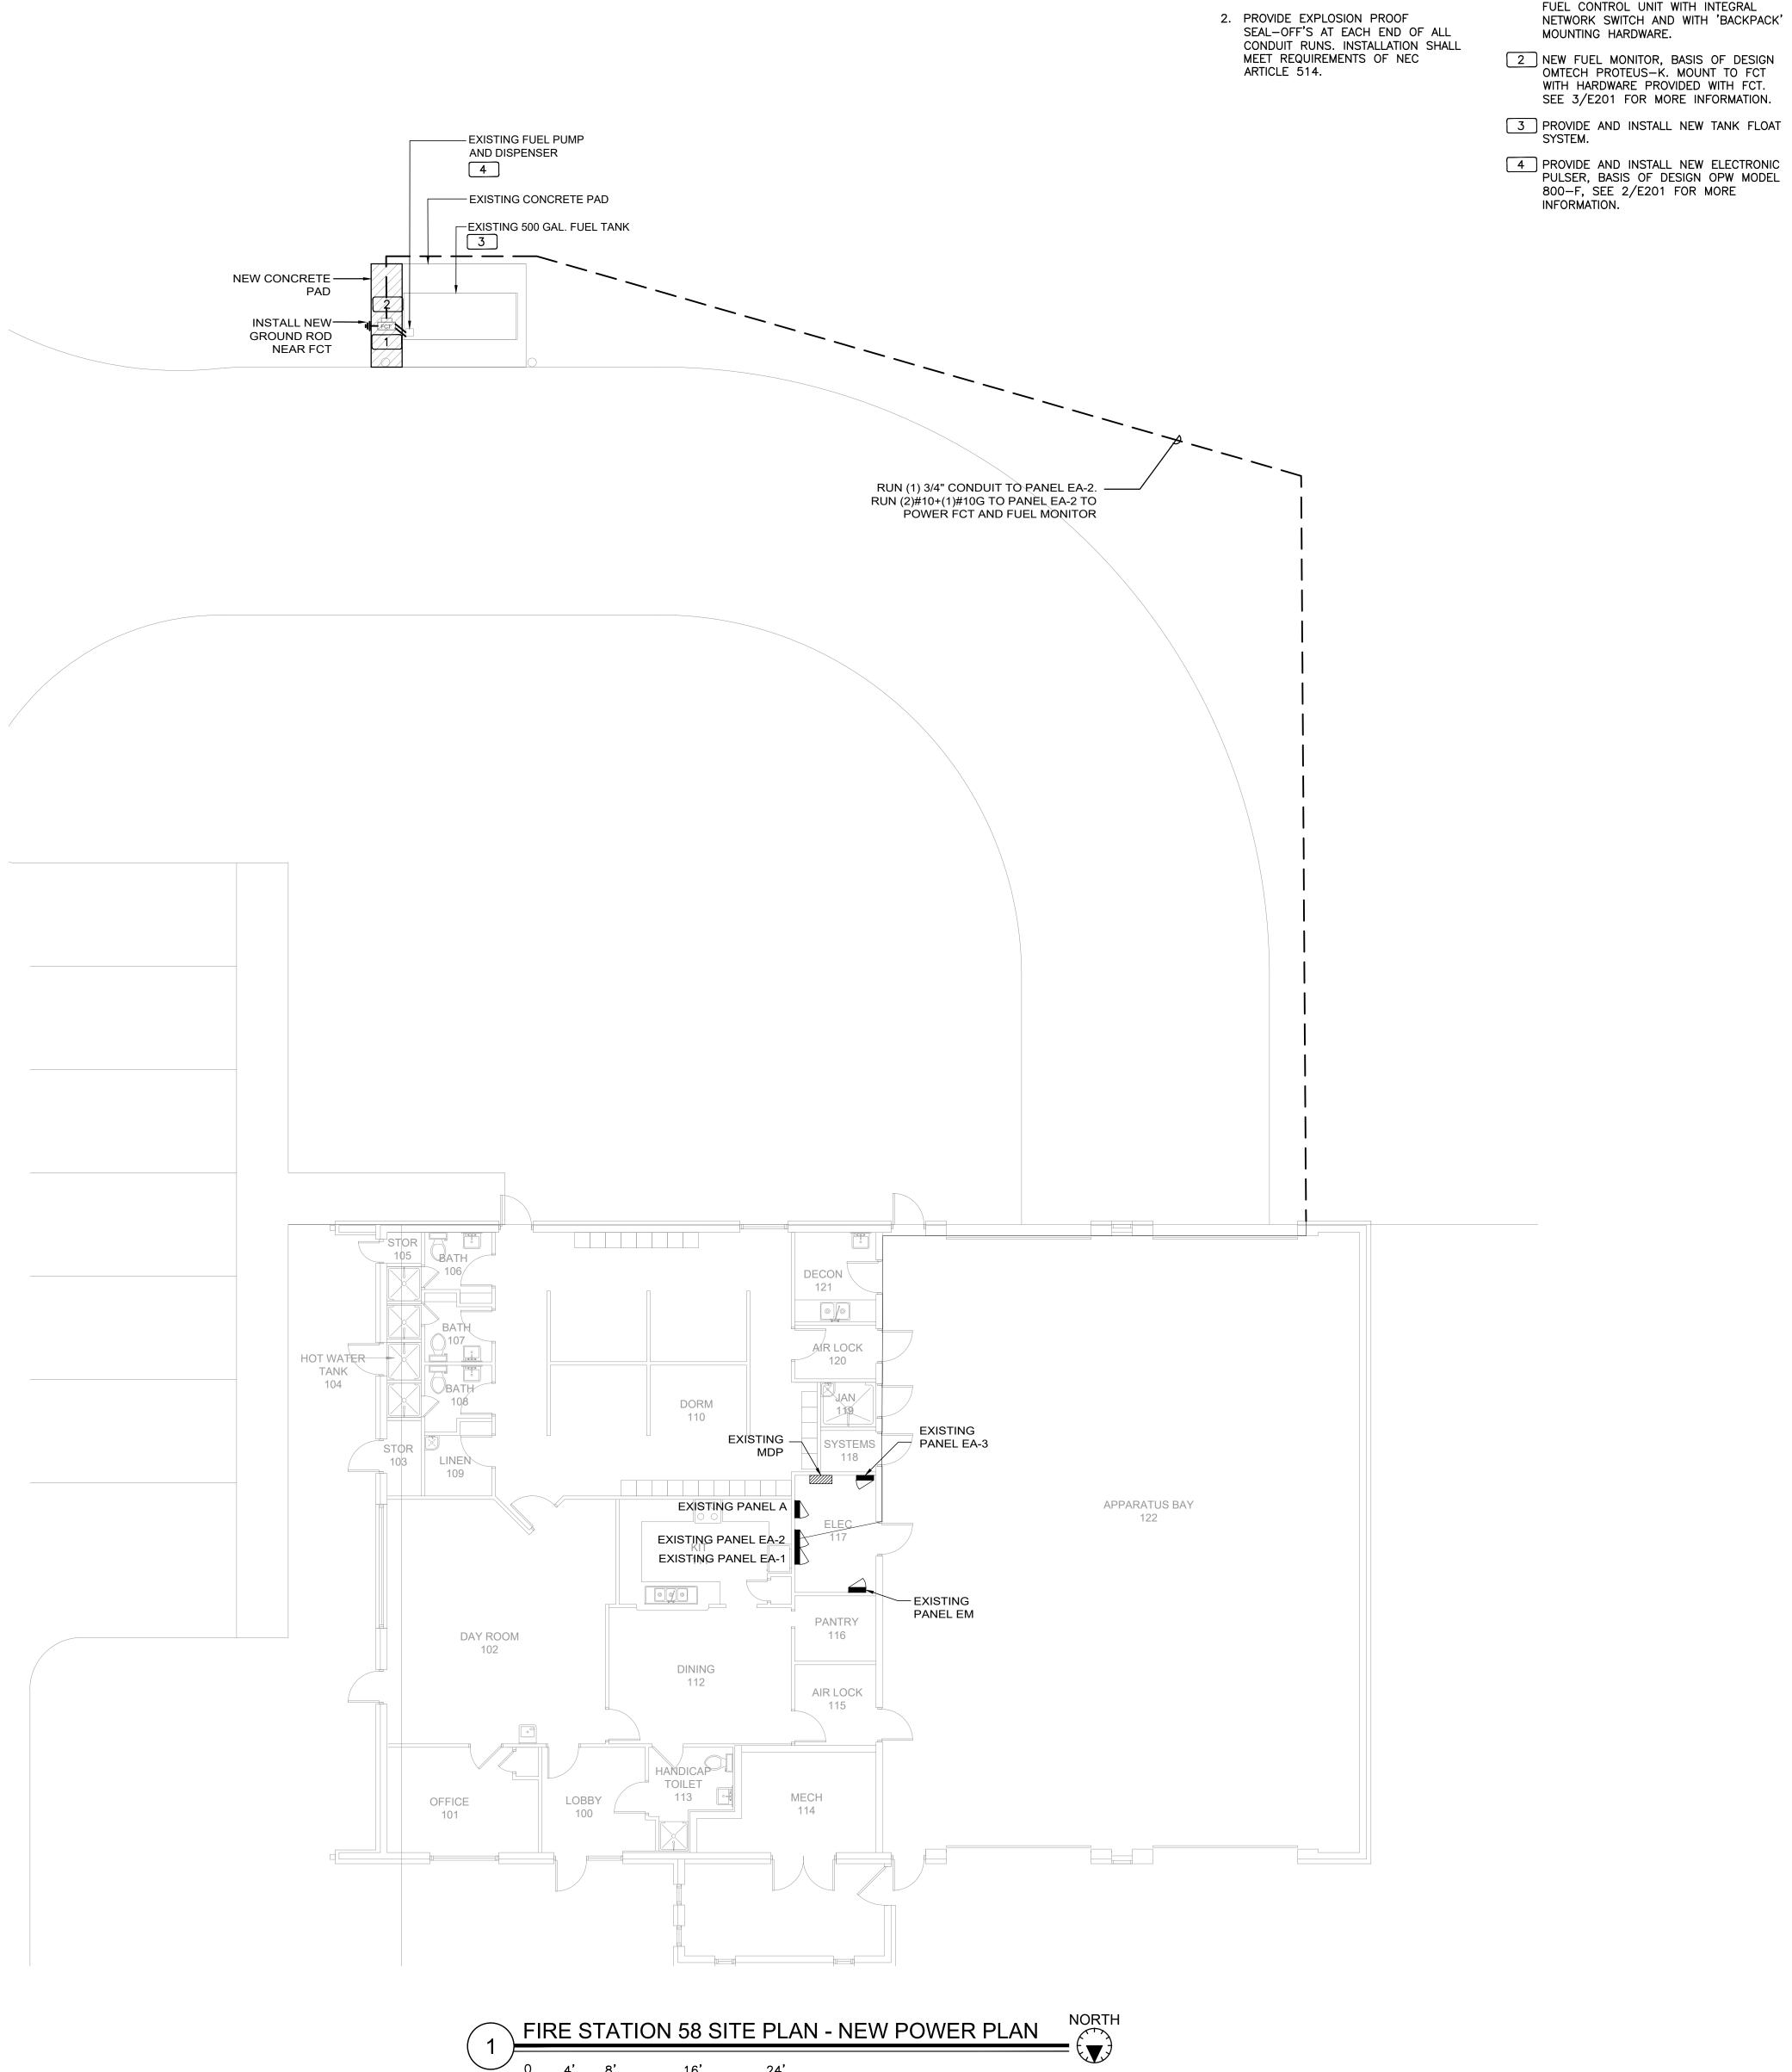


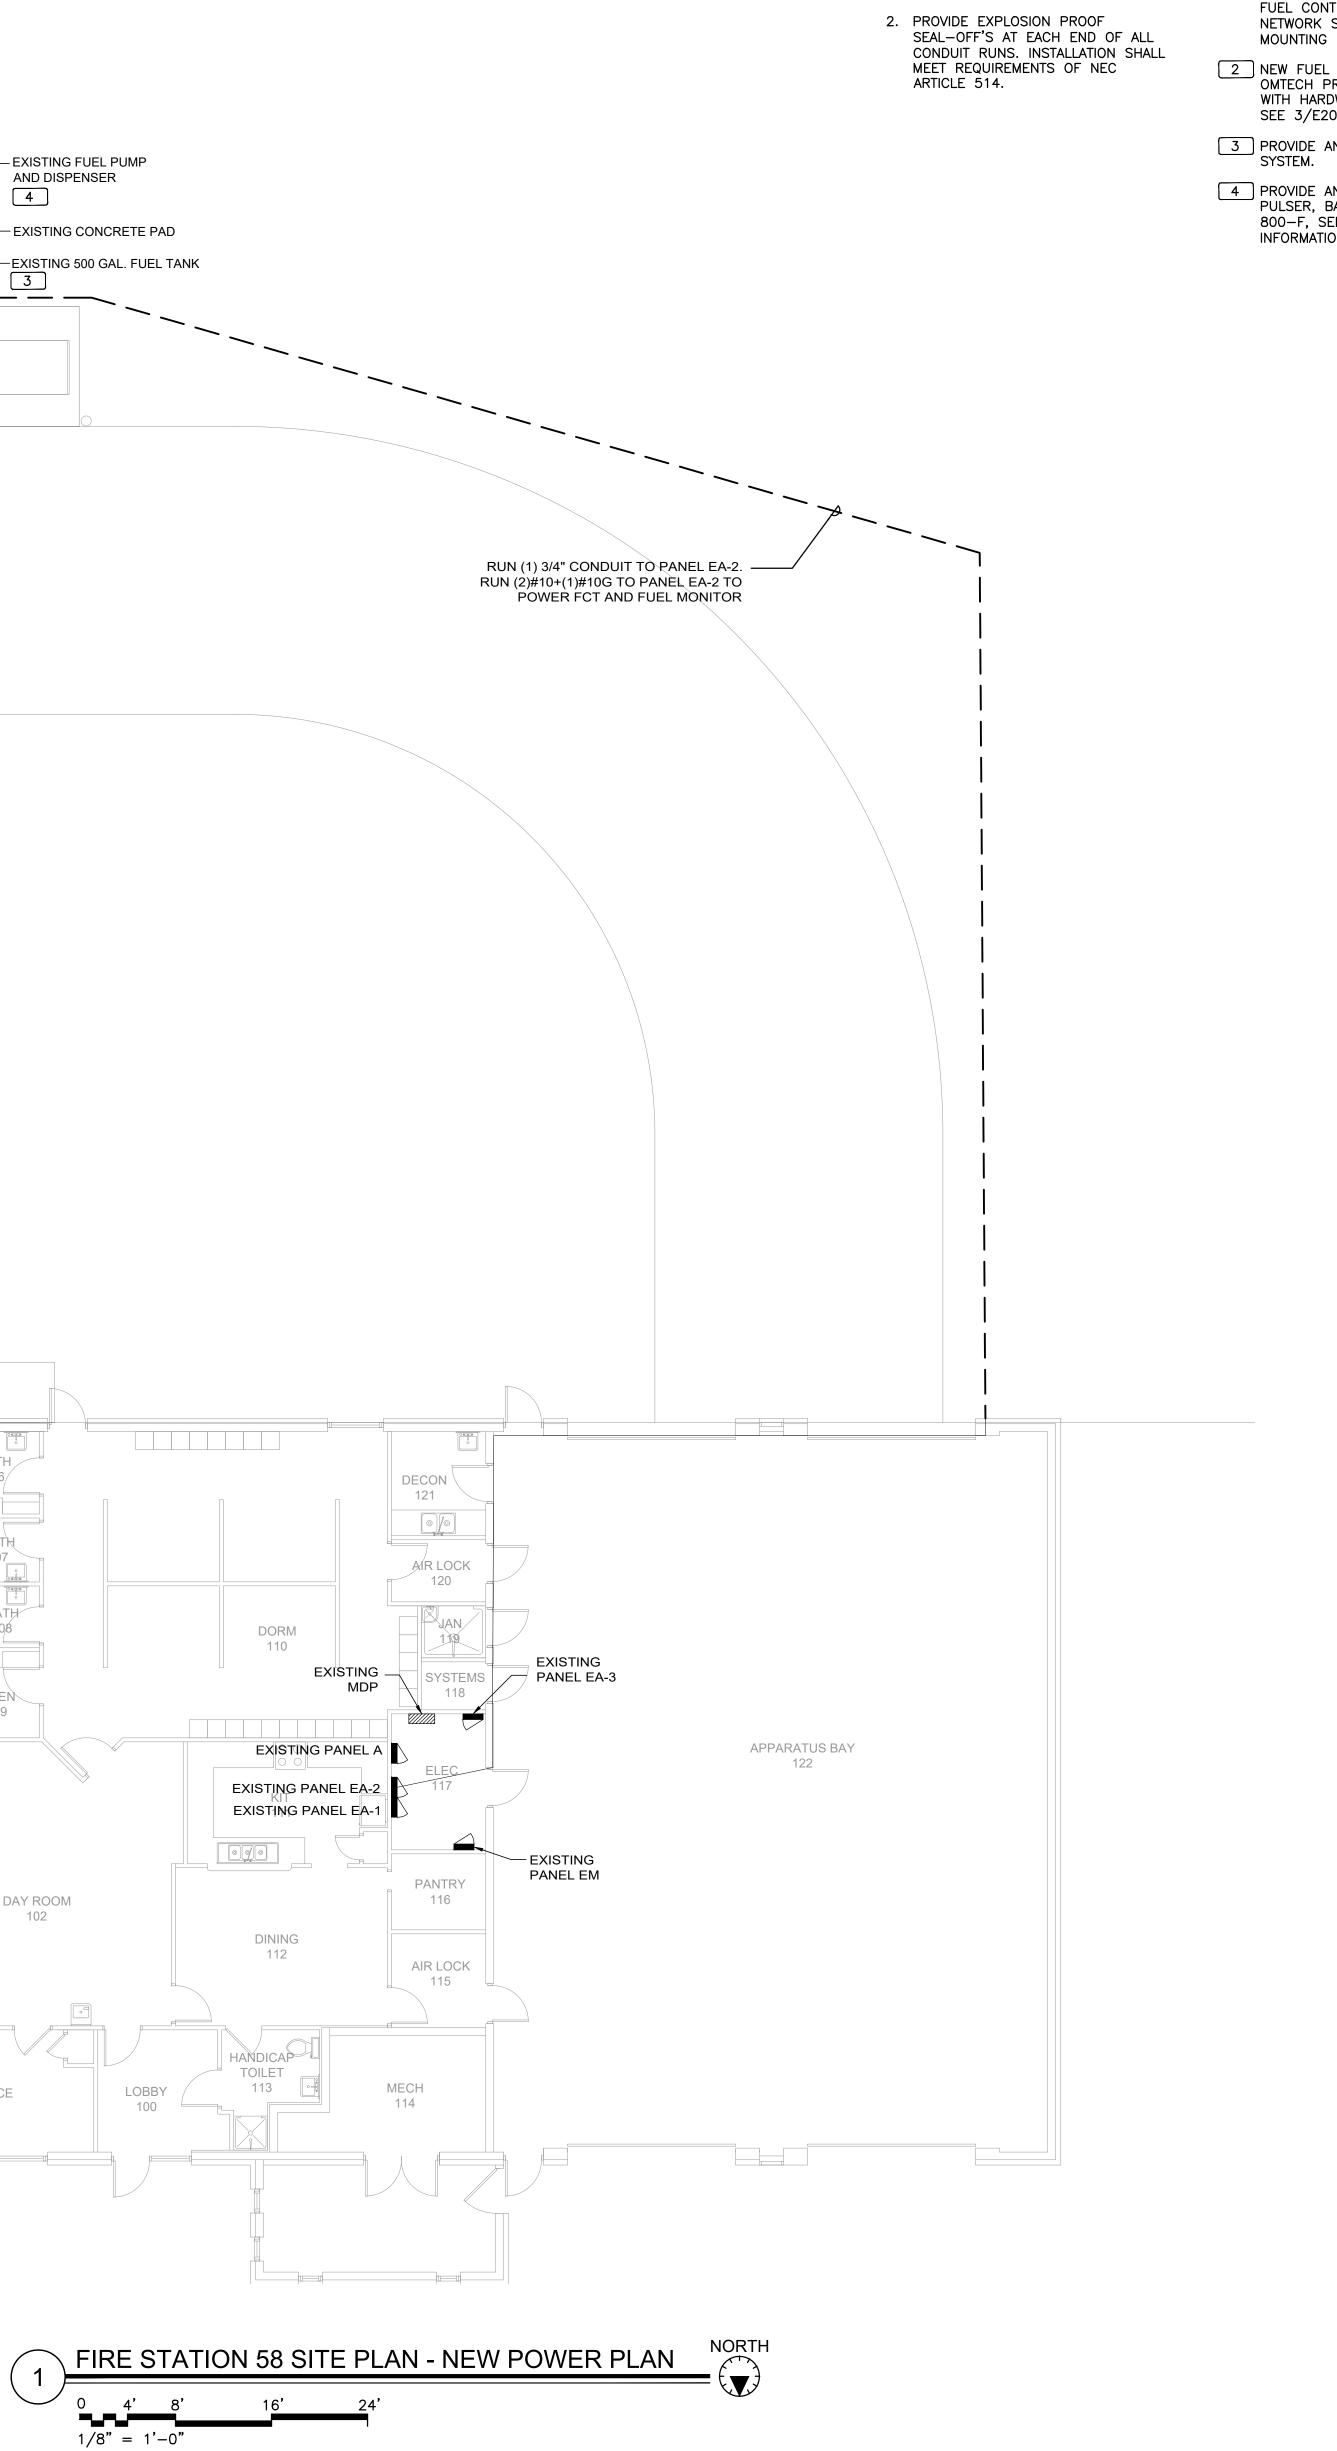

GENERAL NOTES

1. PAINT ALL CONDUIT ABOVE GROUND TO MATCH.

KEY NOTES

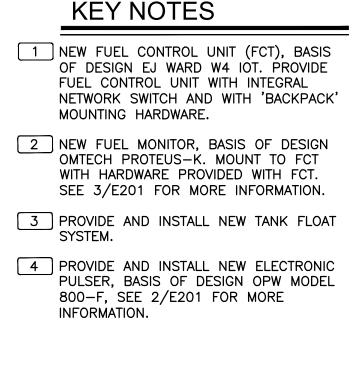



Client:



Consultants:





Location: Fire Station 58 2900 DEERFIELD BLVD, ORLANDO, FL 32821

Issuance: 100% Design Documents

Description

Checked By:

SP

ELECTRICAL

POWER PLAN

58-E101

Date

Revisions:

Project Number:

16.OC.043

Drawn By:


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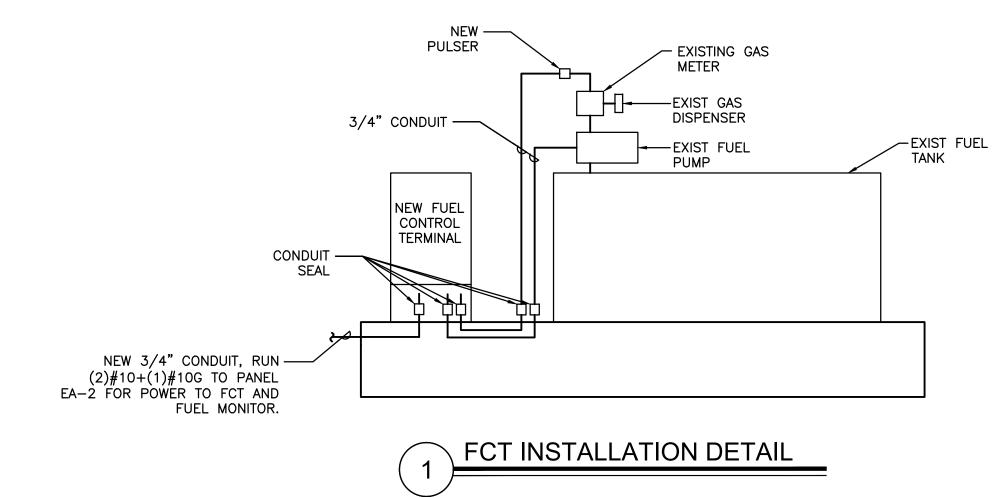
ME


Date: 11.23.2018

UPDATED: 4, ISSUED FOR:	/28/2017 1:00 : APPROVAL	pm	EX	ISTINC	S PAN	NEL	EA-1						DATED: 11/12/2018 SUED FOR: APPROVA			EX	ISTIN	G PA	NEL	EA-	2				
		LOCATION: EI VOLTAGE: 1 TRIM: S			:	SYSTEM:	25A MLO 3ø, 4W TING 225A		FEED:	N. LOAD: 53.5 D: TOP JND BUS: YES					CATION: ELEC _TAGE: 1201 M: SURI	Y/208V			SYSTEM	00A MLC : 3ø, 4W Ating 100		FEED:	LOAD: 21.9 TOP D BUS: YES C		
СКТ	LOAD SERVED	CON	D PHASE NEUT	GND BKR D	MD L1	L2	L3 DMD	BKR COND	PHASE NE	EUT GND	LOAD SERVED	CKT CK	T LOAD S	ERVED	COND	PHASE NEUT	GND BKR	DMD L1	L2	L3 DM	D BKR COND	PHASE NEU	GND	LOAD SERVED	СКТ
1	LIGHTS			20/1	L <u>500</u> 2000		N	30/1			SHORE LINE	2 3	1 EXISTING	G LOAD			20/1	N <u>800</u> N 800		N	20/1			EXISTING LOAD	32 34 36 38 40 42 42 44
3	LIGHTS			20/1	L	<u>500</u> 800	R	20/1			RECEPT	4 33	3 EXISTING	G LOAD			20/1	N	800 800	N	20/1			EXISTING LOAD	34
5	LIGHTS			20/1	L		500 800 R	20/1			RECEPT	6 35	5 EXISTING	G LOAD			20/1			800 N	20/1			EXISTING LOAD	36
7	LIGHTS			20/1	L <u>500</u> 800		R	20/1			RECEPT	8 37	7 EXISTING	G LOAD			20/1	N <u>800</u> N 800	_	N	20/1			EXISTING LOAD	38
9	LIGHTS			20/1	L	500 800	R	20/1			RECEPT	10 39) EXISTING	G LOAD			20/1	N	800 800	N	20/1			EXISTING LOAD	40
11	LIGHTS			20/1	L		500 800 R	20/1			RECEPT	12 4	1 EXISTING	G LOAD			20/1	N	_	800 N	20/1			EXISTING LOAD	42
13	RECEPT			20/1	R 800		R	20/1			RECEPT	14 43	3 EXISTING	G LOAD			20/1	N 2500	-	N	30/3			EXISTING LOAD	
15	RECEPT			20/1	R	800 800	R	20/1			RECEPT	16 45	5 EXISTING	G LOAD			20/1	N	800 2500	N					46
17	RECEPT			20/1	R		800 R	20/1			RECEPT	18 47	7 EXISTING	G LOAD			20/1	N		800 2500 N					48
19	RECEPT			20/1	R 800 R 800		N	20/1			BATTERY	20 49) EXISTING	G LOAD			20/1	N 800			20/1			EXISTING LOAD	50
21	REFRIG			20/1		1000	м	20/1			FUEL PUMP	22 5 '	FCT & FUEL	MONITOR	3/4"	#10 #10	#10 20/1	N	840	_			_	"	52
23	DISHWASHER			20/1	к	1	000 N	20/1			EXISTING LOAD	24 53	3 ,,		-			_	_				_	,,	54
25	RANGE			50/2	к <u>3750</u> к 800		K	20/1			DISPOSAL	26 55	-) ,,		_				_	_			-	,,	46 48 50 52 54 56 58 60
27					К	<u>3750</u> 1000	к	20/1			MICROWAVE	28 57	7 ,,		-			_	-	_			_	,,	58
29	EXISTING LOAD			20/1	N		800 N	20/1			RELAY CONTROL	30 59) "		-			-	_				_	"	60
		NTERRUPT RAT	ING:		11550 1	11200 7	7600		FROM	И:			·	INTER	RUPT RATING	3:		8100	7340	6500		FROM:			
LOADS (IN	VA) CONNE	ECTED DEMANE FACTOR	MINIMUM FEEDER	LOADS	CON	INECTED	DEMAND FACTOR	MINIMUM FEEDER	REMAINI CONTINU	ING UOUS LOADS	1.25	- L	OADS (IN VA)	CONNECTE	DEMAND FACTOR	MINIMUM FEEDER	LOADS	СО	NNECTED	DEMAND FACTOR	MINIMUM FEEDER	REMAINING CONTINUC	; PUS LOADS	01.25(0
LIGHTING RECEPTS T RECEPTS F		00 1.0	<u> </u>	NON-SEASO MOTORS LARGEST MO	1	1250 0	1.0 0.25	<u> 1250 </u> <u> 0 </u>		ING ONTINUOUS LO D LOADS	ADS <u>28300</u> 1.0 <u>28300</u> <u>0</u> 1.0 <u>0</u>	- F	LIGHTING RECEPTS TO 10 KVA RECEPTS REMAINING		1.0	0 0 0	NON-SEAS MOTORS LARGEST N	_	0 0	1.0 0.25	 0	REMAINING NON-CON DEMAND	ITINUOUS LOADS	5 <u>21940</u> 1.0 <u>219</u> 1.0	
SPACE HEA			0 0	WATER HEAT		0 1300	1.0 0.65	0 		CONNECTED LO		-	SPACE HEATING	0 0		0	WATER HEA KITCHEN E	_	0	1.0 1.0	0		NNECTED LOAD DER/PANEL CAF	KVA 2 KVA	

OVERALL DEMAND FACTOR _______



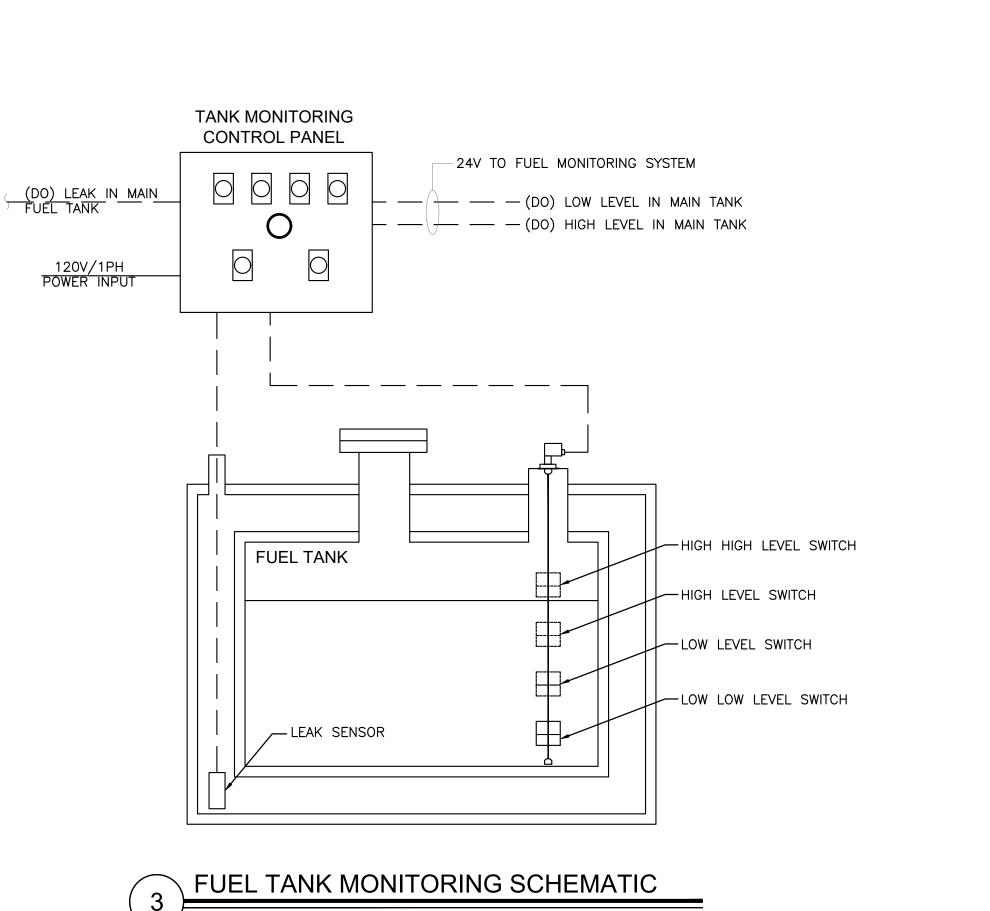

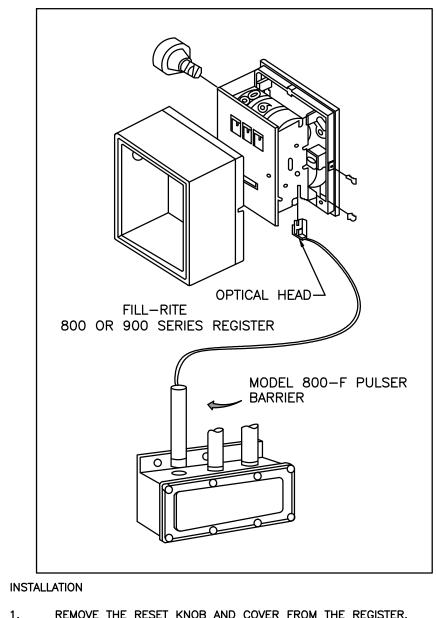


- REMOVE THE RESET KNOB AND COVER FROM THE REGISTER. (IF EQUIPPED) REMOVE THE NUUT AND WASHER FROM THE SHAFT ON THE LEFT SIDE OF THE REGISTER (LATER MODEL REGISTER ARE BUILT WITH A SMOOTH SHAFT). PLACE THE OPTICAL SUCH THAT IT STRADDLES THE PLASTIC GEAR ON THE END OF THE SHAFT AND THE BRACKET SLOT IN ON THE SHAFT SCREW.
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IF ERRATIC OPERATION OF THE PULSER IS ENCOUNTERED, IT MAY BE DUE TO ELECTRICAL NOISE OR FLUCTUATIONS OF THE POWER LINES. THIS TYPE OF PROBLEM CAN BE ELIMINATED BY POWERING THE PULSER WITH SEPARATE POWER LINES NOT CONNECTED TO MOTORS OR SOLENOIDS, OR BY ADDING NOISE SUPPRESSORS TO EACH MOTOR AND/OR SOLENOID.

ALL APPROPRIATE WIRING PRACTICES AS OUTLINED BY THE NATIONAL ELECTRICAL CODW AND STATE LOCAL CODES SHOULD BE FOLLOWED. CONTACT OPW FUEL MANAGEMENT SYSTEMS IN CASE OF TROUBLE OR UNUSUAL APPLICATION.

TELEPHONE 708-485-4200 FAX 708-485-7137



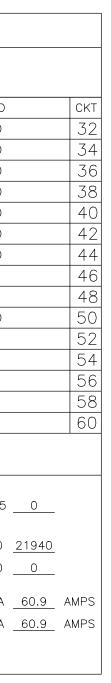

OVERALL DEMAND FACTOR 1.00



Client:



Consultants:



EOR Stamp: Engineer of Record A * PROKIN No.80037 * STATE OF Project: OC FIRE RESCUE FUEL TANK **AUTOMATION AND** REPLACEMENT

Location: Fire Station 58 2900 DEERFIELD BLVD, ORLANDO, FL 32821

DESIGN

Issuance: 100% Design Documents

Revisions: # Date Description

Checked By:

SP

ELECTRICAL

PANEL

SCHEDULES

AND DETAILS

58-E201

Date:


11.23.2018 Project Number:

MF

Sheet No.:

Drawn By:

16.OC.043

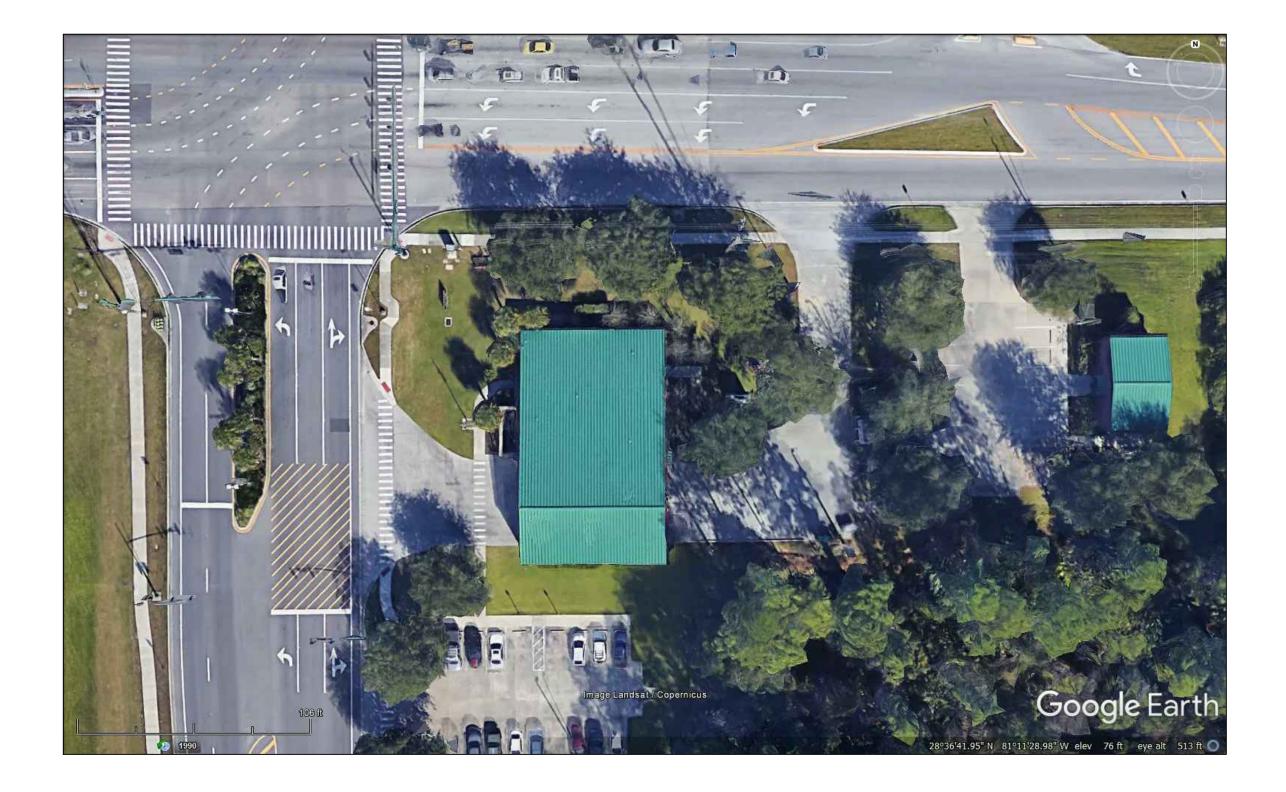

EXISTING CONDITIONS N.T.S.

FROM GOOGLE EARTH 2016

S

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C

DEMOLITION NOTES


1. CONTRACTOR TO VERIFY LOCATION AND DIMENSION OF EXISTING JOINTS

2. OWNER INTENT IS TO REMOVE ENTIRE PAVED AREA BETWEEN JOINTS TO INSTALL ELECTRICAL CONDUIT.

3. CONTRACTOR SHALL ADJUST CONDUIT ALIGNMENT TO MINIMIZE REMOVAL OF PAVED AREAS.

FIRE BAY

EXISTING CONC. PAVED DRIVEWAY

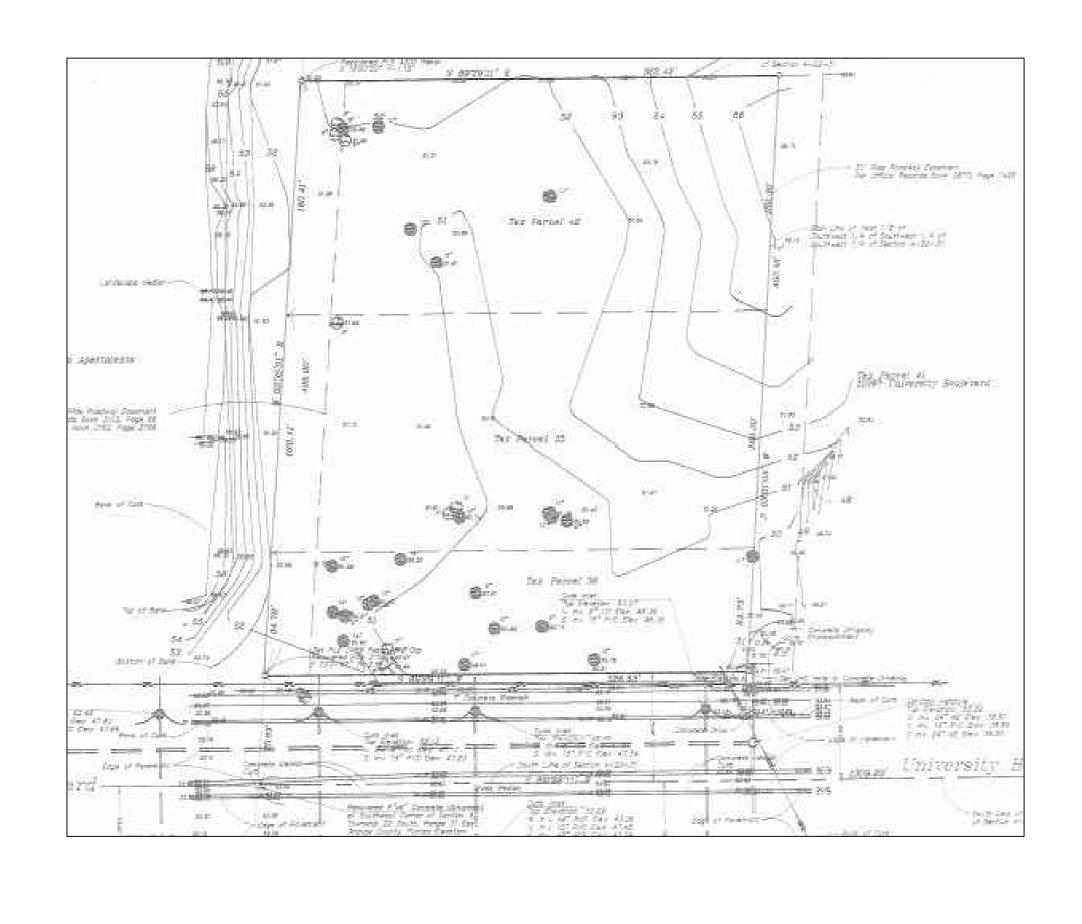


LOCATION MAP N.T.S.

GRASS AREA



O FUEL TANK



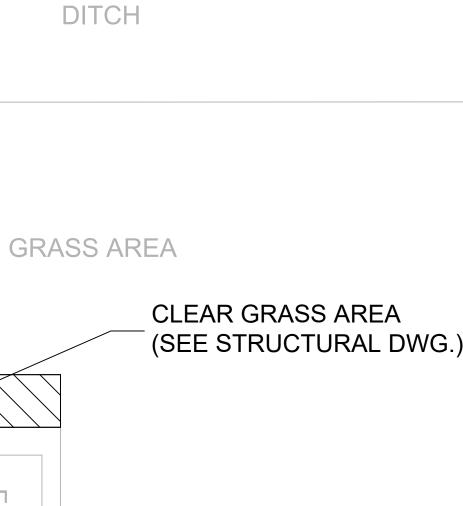

CONC.

CONC. APRON

SAW CUT CONC. SIDEWALK

GENERAL NOTES - CIVIL

1. THIS PROJECT IS LOCATED WITHIN THE ORANGE COUNTY FIRE RESCUE STATION. TO WORK WITHIN THIS FIRE STATION CONTRACTOR HAS TO OBSERVE, FOLLOW AND ABIDE THOROUGHLY, METICULOUSLY AND STRICTLY TO EACH AND EVERY SECURITY RULES AND REGULATIONS CONCERNING SUCH AS BUT NOT LIMITED TO WORKERS WORKING HOURS, INGRESS AND EGRESS POINTS FOR CONTRACTOR PERSONNEL, VEHICLE AND EQUIPMENT.

2. TOPOGRAPHIC INFORMATION AS SHOWN ON DRAWINGS IS PROVIDED FOR INFORMATION PURPOSE ONLY. CONTRACTOR TO CALL SUNSHINE ONE CALL OF FLORIDA 1-800-432-4770 TO LOCATE UNDERGROUND UTILITIES AT LOCATIONS OF TRENCHING AND PAVEMENT CUT AS SHOWN ON DRAWINGS.

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4. ALIGNMENT OF UTILITIES IS SHOWN TO INDICATE INTENT OF ENGINEER TO CONNECT THESE LINES BETWEEN UTILITIES FOUND ON SITE .

5. CONTRACTOR TO VISIT SITE TO FAMILIARIZE HIMSELF WITH EXISTING FIELD CONDITIONS AND LOCATIONS OF EXISTING UTILITIES AND PROPOSED ALIGNMENT TO COMMERCIAL WASHER-DRYER AS SHOWN ON DRAWINGS. CONTRACTOR TO IMMEDIATELY NOTIFY ORANGE COUNTY PROJECT MANAGER IN WRITING ANY DISCREPANCY OBSERVED FOR PROPER CLARIFICATION.

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8. DURING CONSTRUCTION CONTRACTOR SHALL INSURE MINIMUM DISTURBANCES TO FIRE STATION OPERATIONS AND SHALL TAKE CARE TO KEEP FIRE TRUCK EXITS CLEARED AT ALL TIME.

9. CONTRACTOR IS NOT ALLOWED TO PARK VEHICLE, EQUIPMENT, MATERIALS AND ANCILLARIES OVERNIGHT WITHIN THE LIMITS OF THE FIRE STATION.

10. CONTRACTOR TO BRING INSIDE THE FIRE STATION VEHICLE, EQUIPMENT, MATERIALS AND ANCILLARIES IN QUANTITIES SUFFICIENT FOR EACH DAY OF WORK.

11. SAW CUTTING, TRENCHING, AND EXCAVATION FOR INSTALLATION OF UTILITIES LINES TO BE IN CONFORMANCE WITH ALIGNMENT AND DEPTH AS SHOWN ON DRAWINGS. FOR ANY SUBSTANTIAL DEVIATION IN ALIGNMENT CONTRACTOR TO SUBMIT IN WRITING TO ORANGE COUNTY PROJECT MANAGER FOR REVIEW AND APPROVAL BEFORE WORK.

12. CONTRACTOR TO SAW CUT CONCRETE AND ASPHALT PAVEMENT TO WIDTH AND DEPTH AS SHOWN ON DRAWINGS FOR LAYING UTILITIES LINES.

13. EXCESS EXCAVATED MATERIALS FROM TRENCHING AND/OR SAW CUTTING SHALL BE DISPOSED OFFSITE OR AS DIRECTED BY ORANGE COUNTY PROJECT MANAGER.

14. ALL EXISTING SODDED AREAS DISTURBED DURING CONSTRUCTION SHALL BE REPLACED WITH THE SAME TYPE OF SOD AT THE TIME OF JOB COMPLETION.


15. CONTRACTOR TO USE RAPID CURING CONCRETE TYPE III 4000 LBS FOR PAVED AREAS TO MATCH EXISTING CONDITIONS. SAW CUT EXPANSION JOINTS TO MATCH EXISTING PATTERN. PROTECT NEW CONCRETE AREA WITH STANDARD TRAFFIC PLATES.

16. AT THE END OF EACH DAY CONTRACTOR SHALL SECURELY PROTECT ANY CONSTRUCTION AREAS DISTURBED BY SAW CUTTING AND/OR TRENCHING AND REMOVE DEBRIS, TRASH AND OTHER CONSTRUCTION MATERIALS, AND MOVE EACH AND EVERY VEHICLE, EQUIPMENT, AND ANCILLARIES OUT OF THE FIRE STATION TO THE SATISFACTION OF ORANGE COUNTY PROJECT MANAGER.


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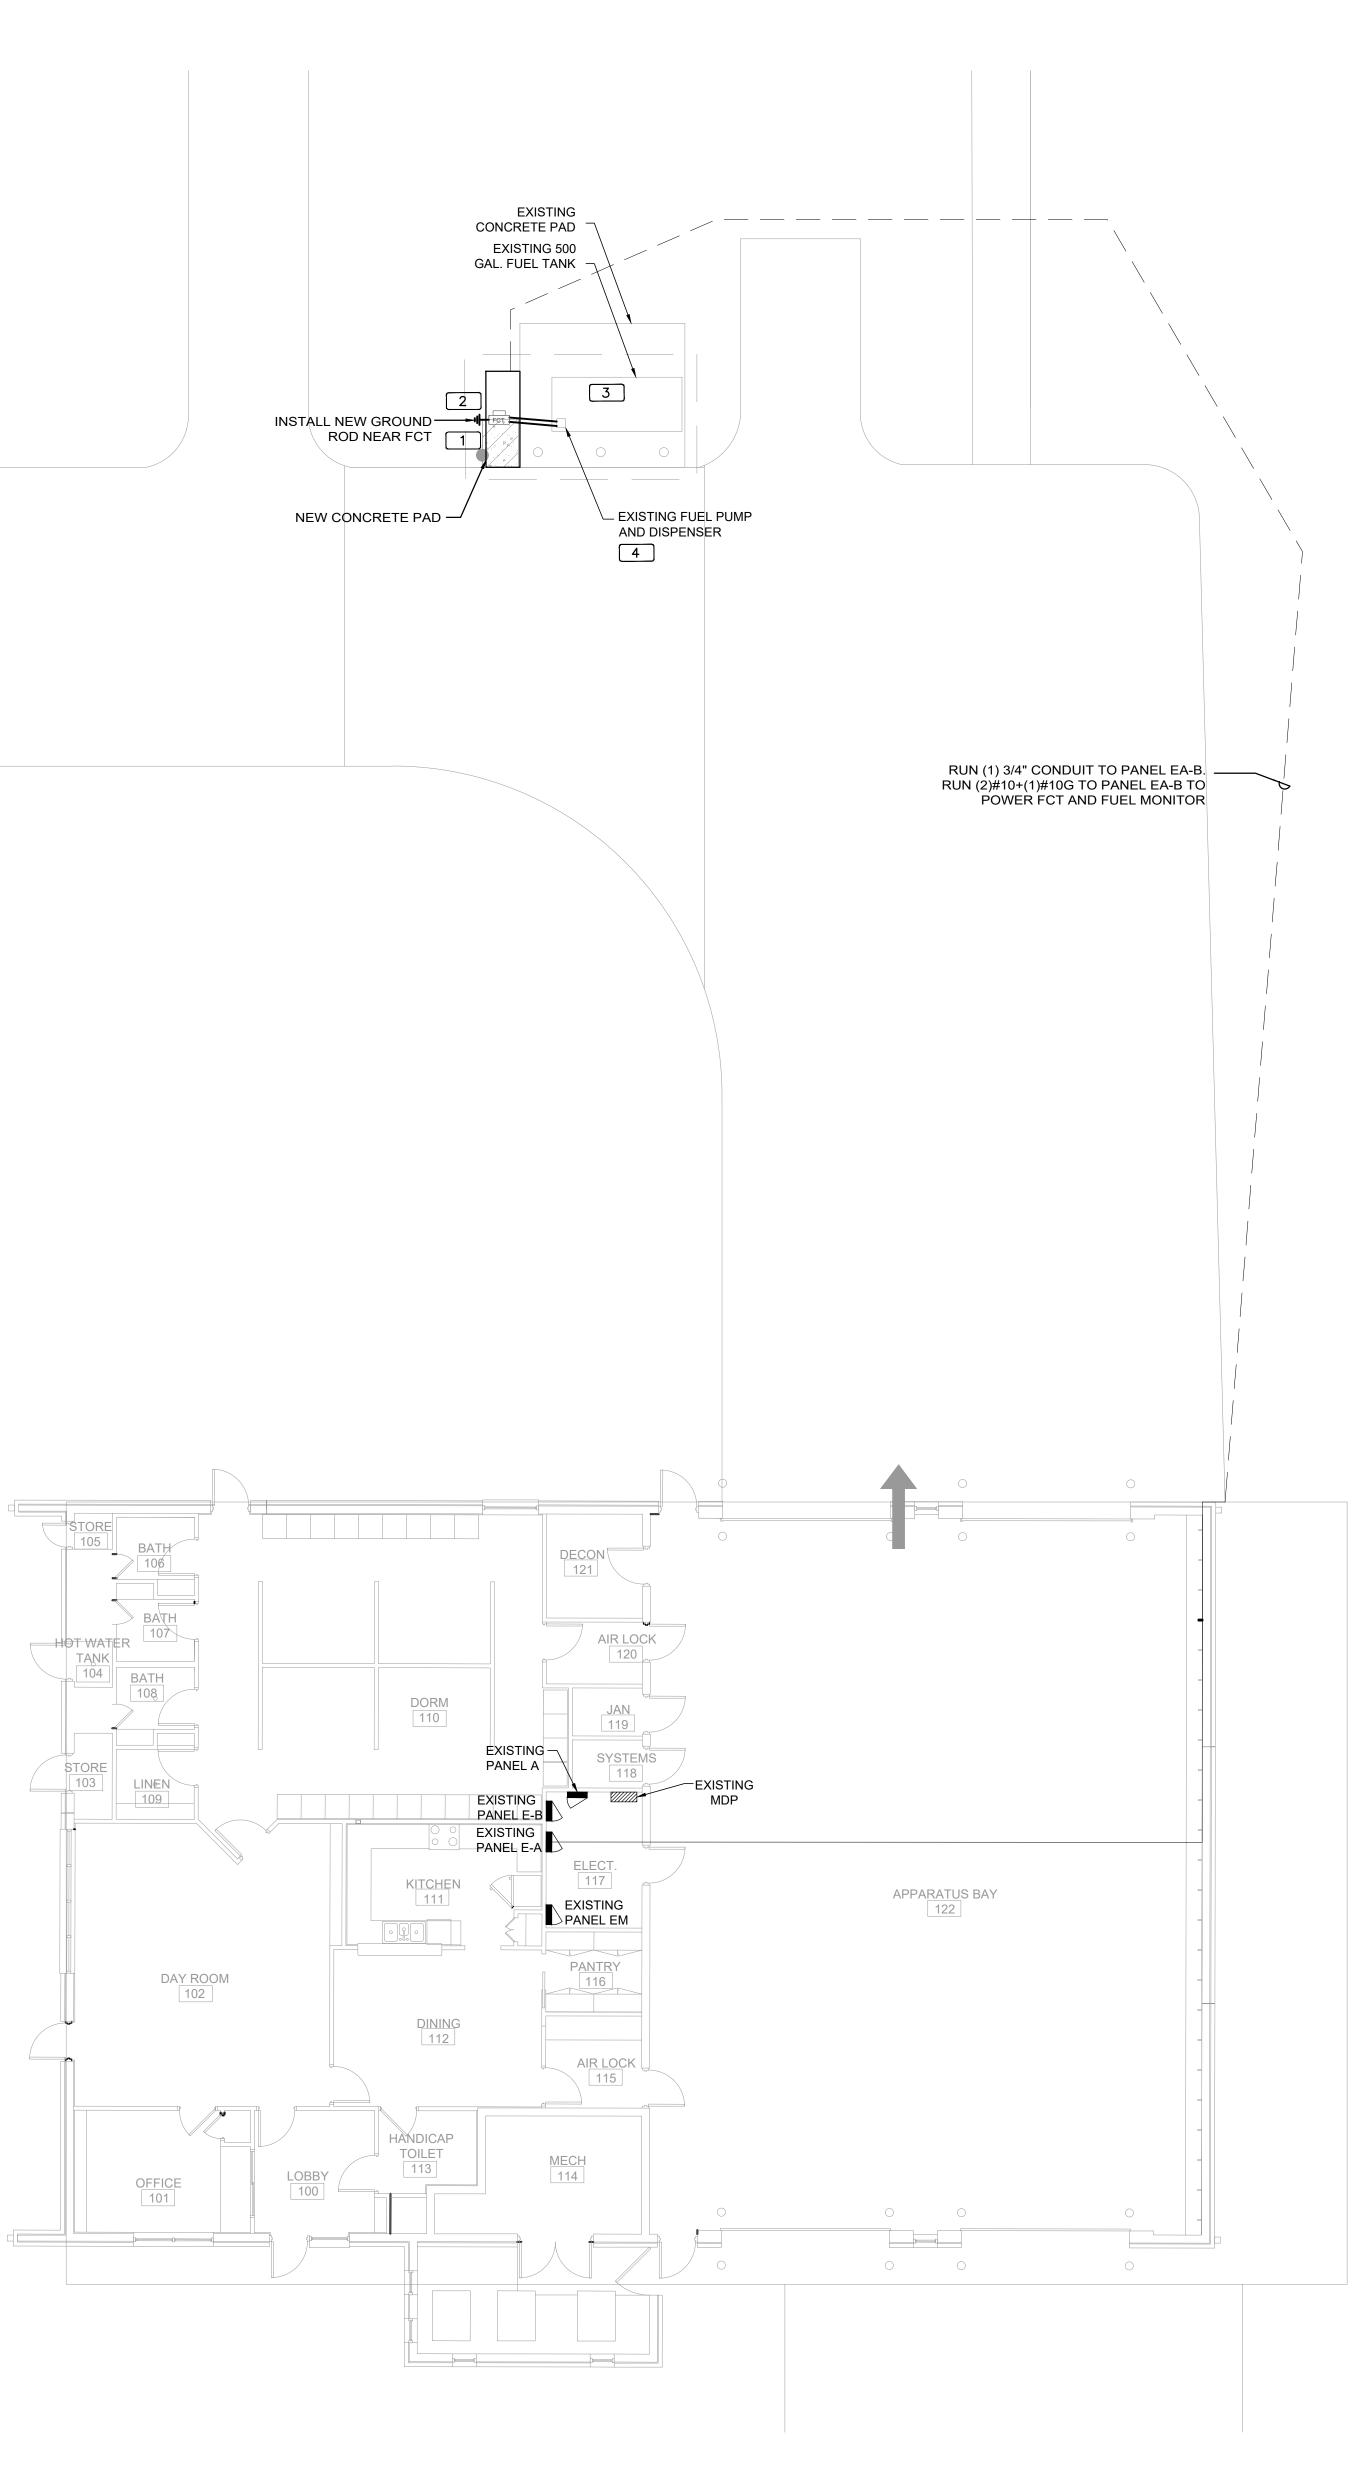
18. AT FINAL INSPECTION CONTRACTOR TO SUBMIT TO ORANGE COUNTY PROJECT MANAGER MARKED-UP DRAWINGS SHOWING ACTUAL ALIGNMENT AND DEPTH OF EACH AND EVERY UTILITIES LINE INSTALLED FOR ENGINEER TO RECORD ON AS-BUILT DRAWINGS.




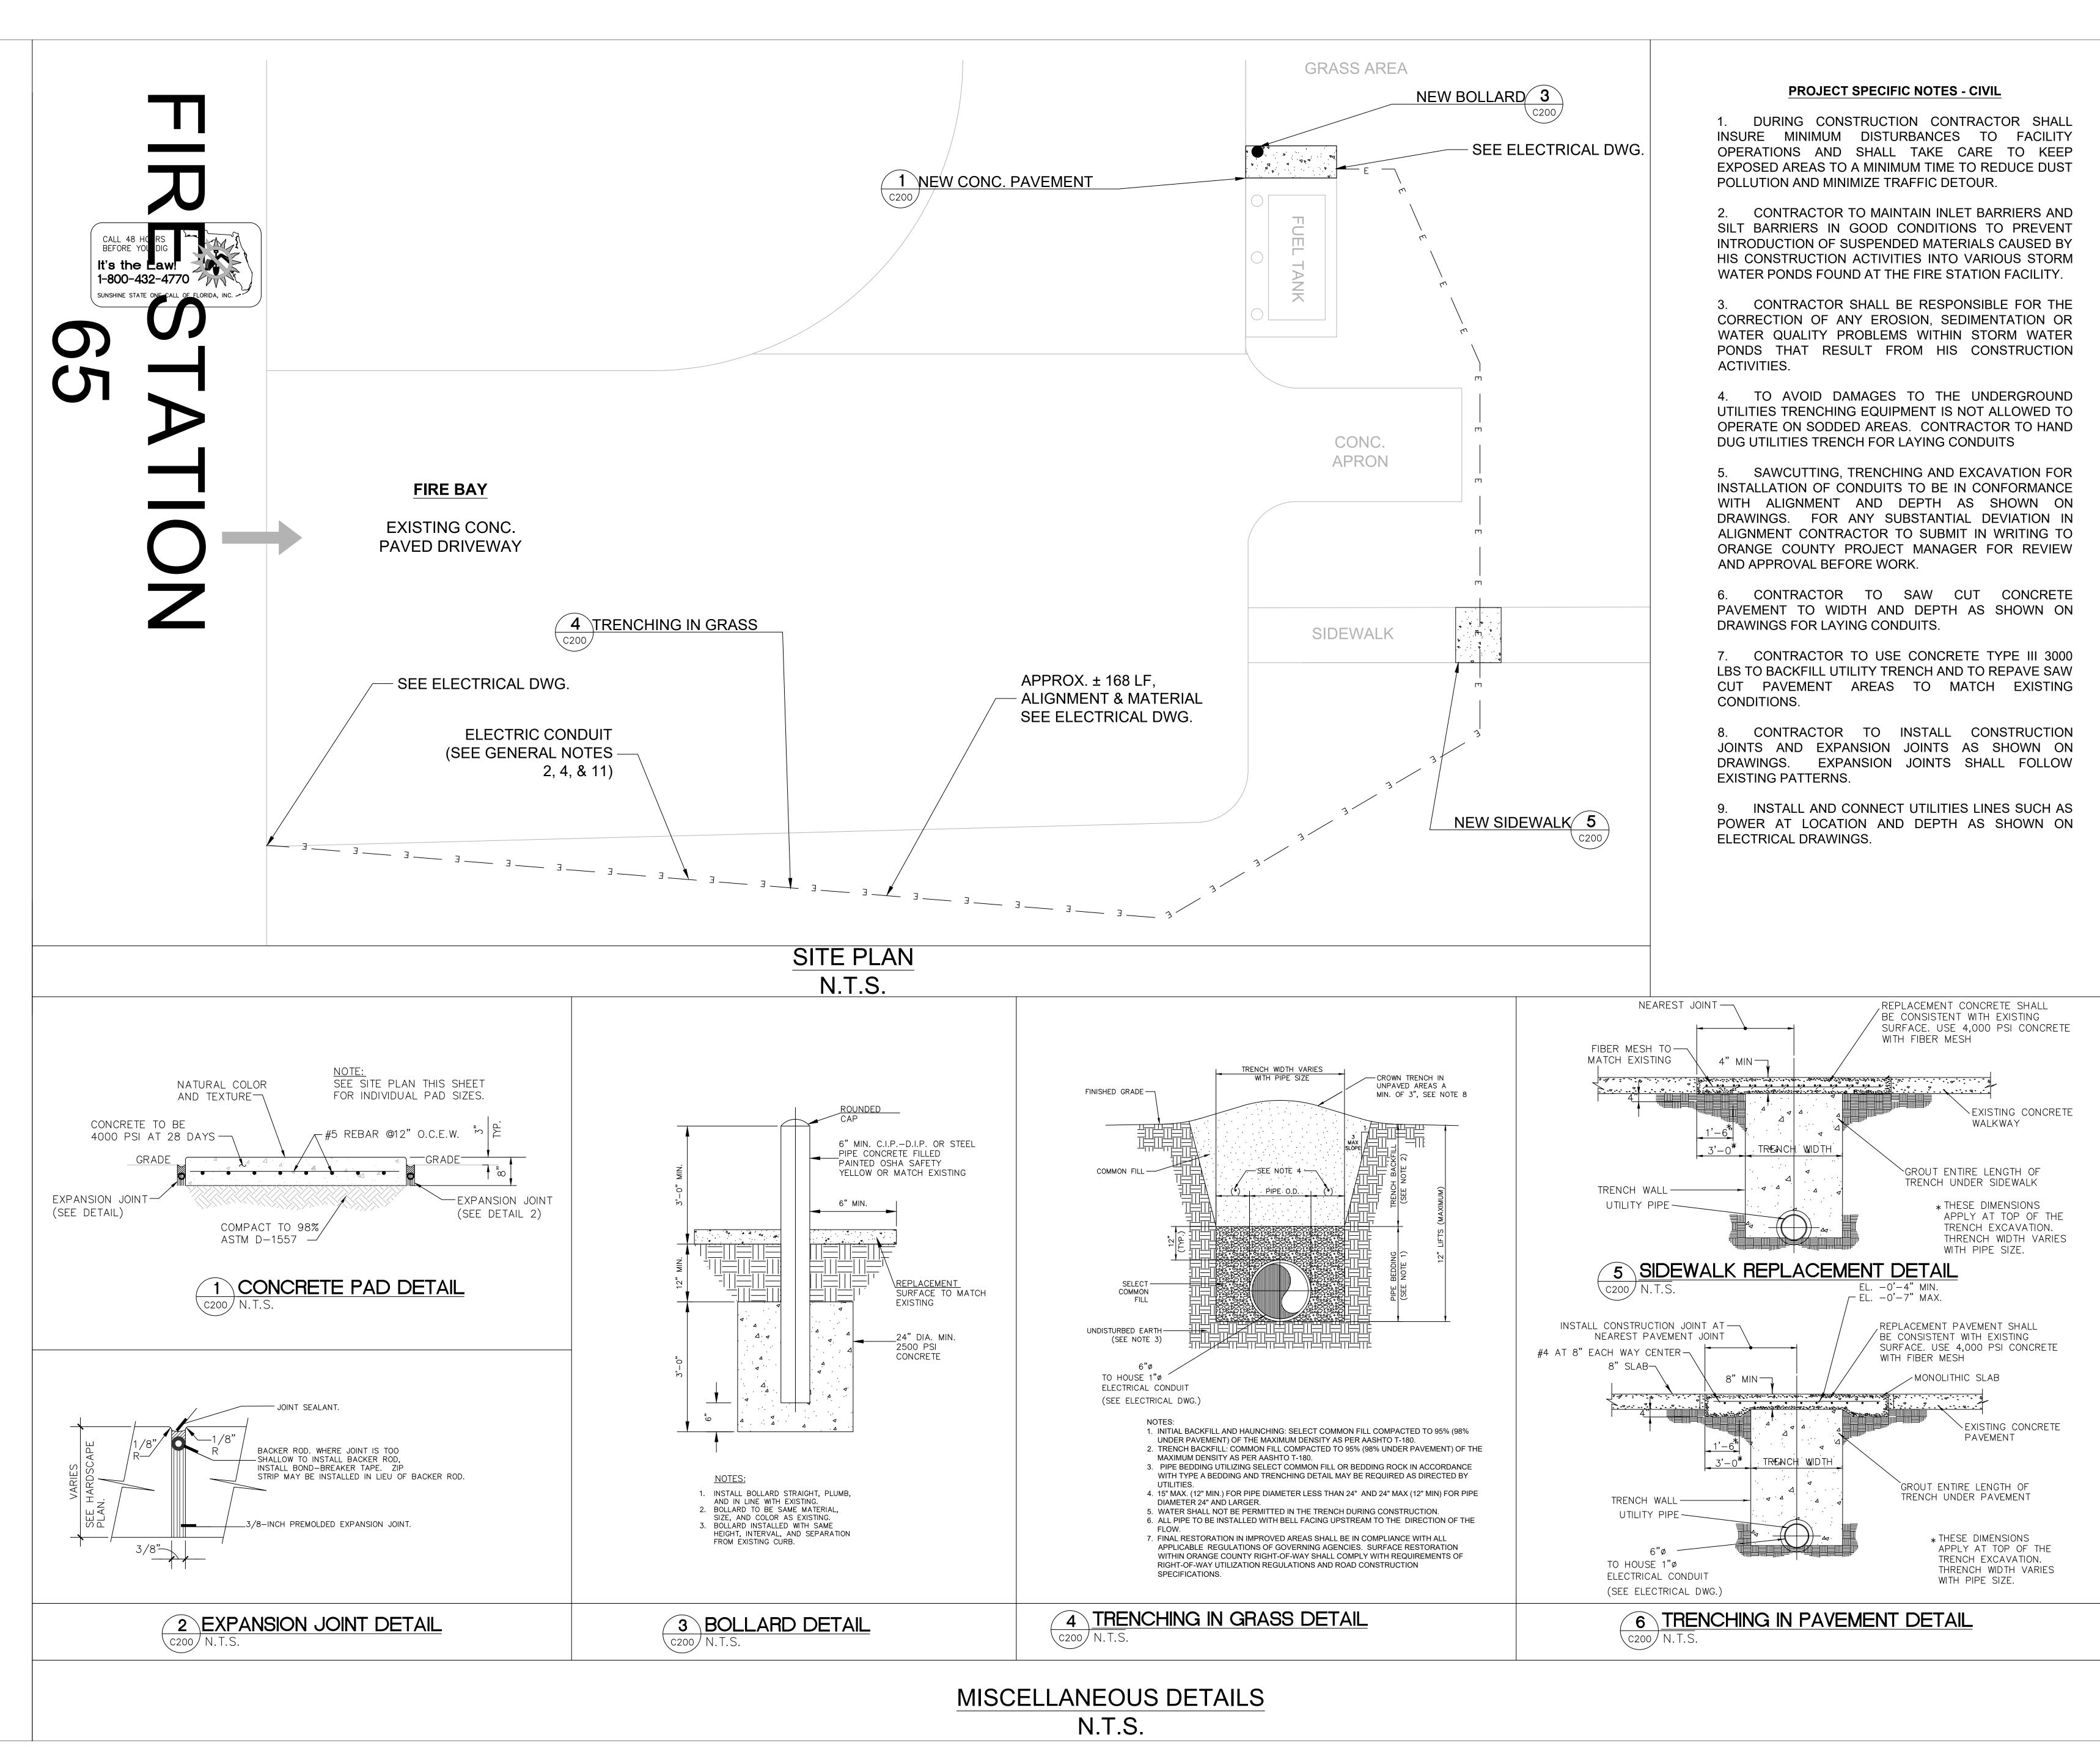

engineering consultants 925 S. Semoran Blvd | Suite 100 | Winter Park, FL 32792 T: 407.678.2055 : www.rtmassociates.com Client: DVERNMENT FLORIDA Consultants: EOR Stamp: Project: OC FIRE RESCUE FUEL TANK AUTOMATION AND REPLACEMENT DESIGN Location: Fire Station 65 4999 N ORION BLVD, ORLANDO, FL 32876 Issuance: 100% Design Documents Revisions: # Date Description Date: 11.23.2018 Project Number: 16.OC.043 Drawn By: Checked By: S.D.H. D.D. Civil Site Plan Sheet No.: 65-C200




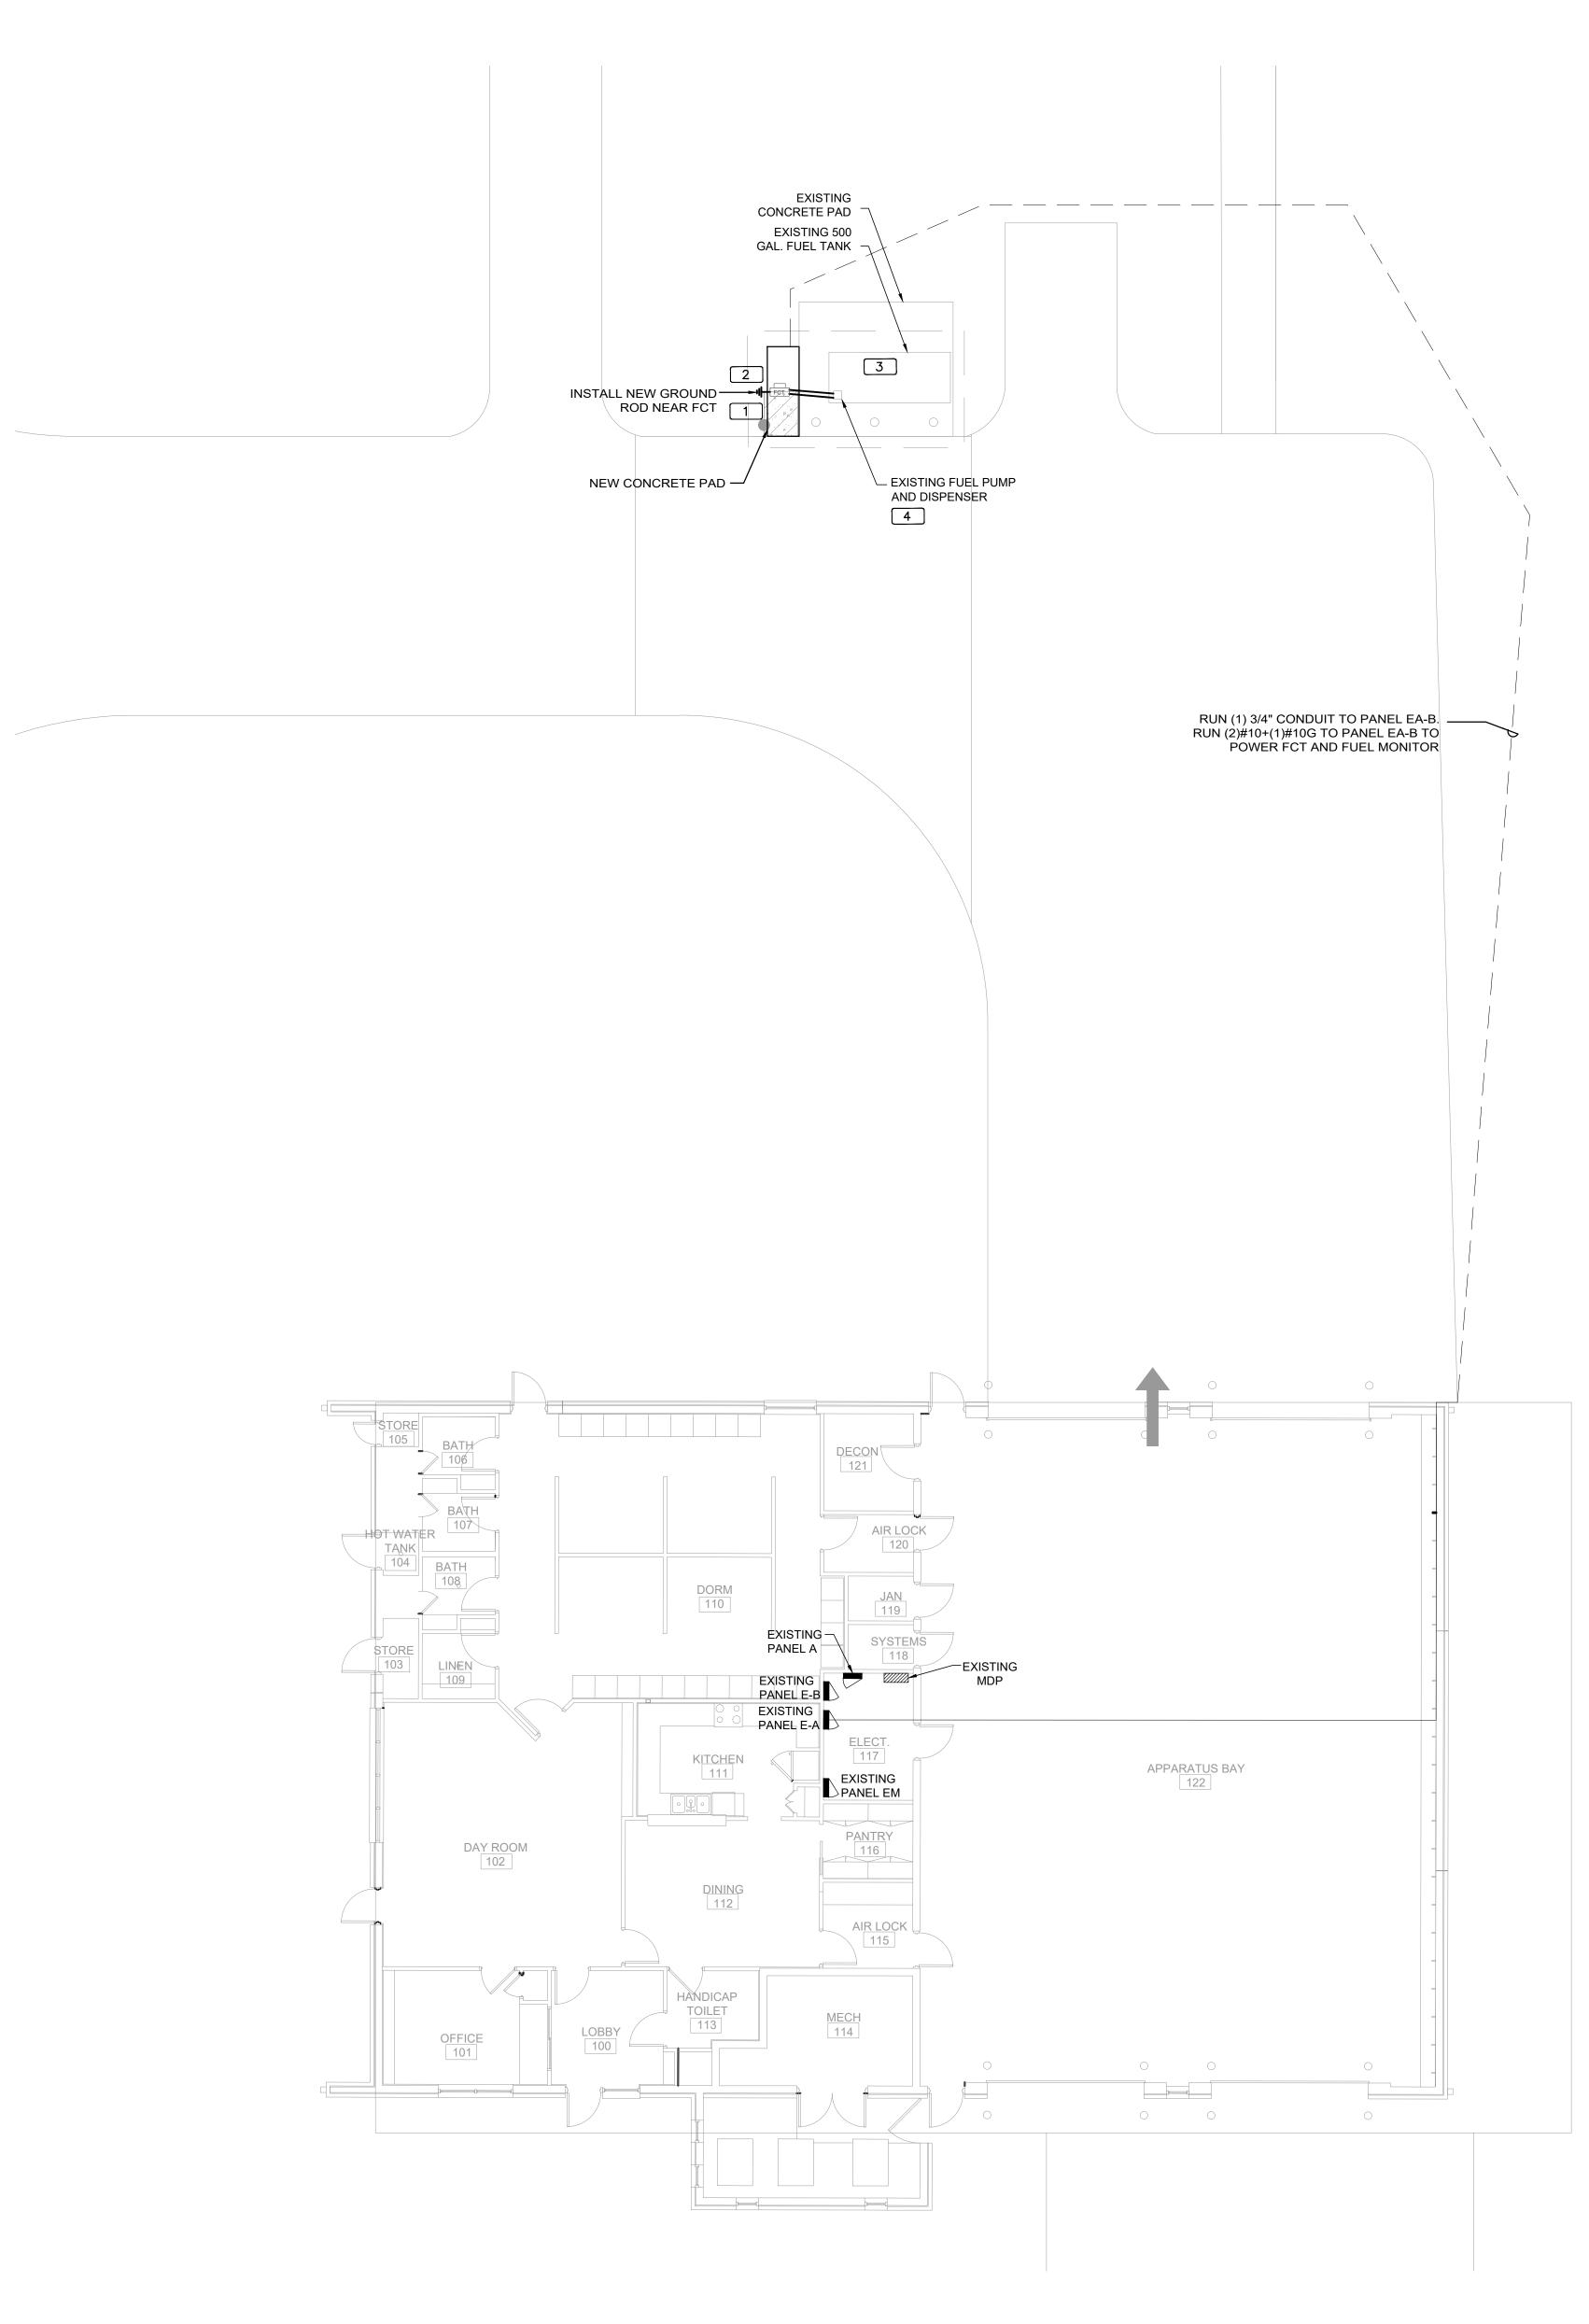

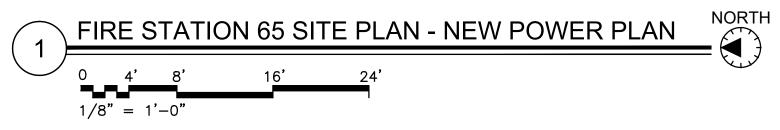



GENERAL NOTES **KEY NOTES** 1 REVIDEEINEVONTUREOL TANKI (KRONT), OBASIS BASISESIENDESIGWARDMWAEQOPROPTEOVADE FUEL CONTROL UNIT WITH INTEGRAL 2 REPUBLEK ASMITCHSTAND WATCH TASAGKITARAT 1. PAINT ALL CONDUIT ABOVE GROUND TO MATCH. 2. PROVIDE EXPLOSION PROOF SEAL-OFF'S AT EACH END OF ALL CONDUIT RUNS. INSTALLATION SHALL MOUTHING HARDWARE. BREWVIEUELANDONNETALLBASTY DEEDERSANC OMILEERI PARSTELOS-IRENIGNOPPO MODEL APPT-FHAREFWARETAR OVIDED SWITHTFEZPI SEE SUPERO INFORMATORE INFORMATION. MEET REQUIREMENTS OF NEC 3 PROVIDE AND INSTALL NEW TANK FLOAT SYSTEM. 4 PROVIDE AND INSTALL NEW ELECTRONIC PULSER, BASIS OF DESIGN OPW MODEL 800-F, SEE 2/E201 FOR MORE INFORMATION.


ARTICLE 514.

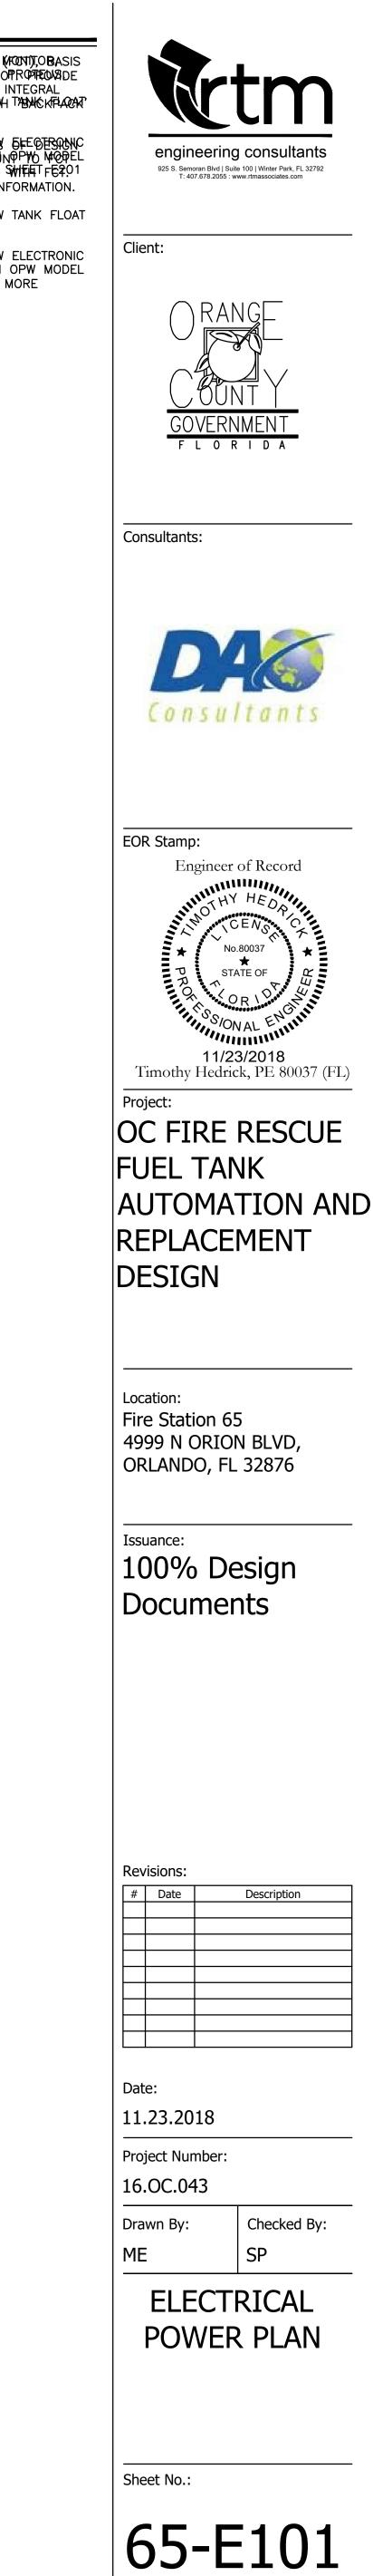

UPDATED: 5/1/2017 3:40 p ISSUED FOR: APPROVAL	m E	EXISTING P	ANEL EA	A-A			UPDATED: 1 ISSUED FOR	1/13/2018 2:39 p : APPROVAL	om	EXI	STING F	PANEL	EA-E	3			
	LOCATION: ELEC RM VOLTAGE: 120Y/208 TRIM: SURFACE	V	MAIN: 225A M SYSTEM: 3Ø, BUS RATING	4W	CONN. LOAD: 46.2 K FEED: TOP GROUND BUS: YES CO			,	LOCATION: ELEC VOLTAGE: 120 TRIM: SUR	Y/208V		SYSTEI	225A MLO M: 3ø, 4W Ating 225A		CONN. LOAD: FEED: TOP GROUND BUS:		
CKT LOAD SERVED	COND PHASE	NEUT GND BKR DMD	L1 L2 L3	DMD BKR CON	ND PHASE NEUT GND	LOAD SERVED CKT	CKT	LOAD SERVED	COND	PHASE NEUT	GND BKR DMD	L1 L2	L3 DMD	BKR COND	PHASE NEUT GND	LOAD SERVED	СКТ
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3 EXISTING LOAD		20/1 N	800 800	N 20/1		EXISTING LOAD 4	33	EXISTING LOAD			20/1 N	800 800	N	20/1		EXISTING LOAD	34
5 EXISTING LOAD		20/1 _N		N 20/1		EXISTING LOAD 6	35	EXISTING LOAD			20/1 N		800 N	20/1		EXISTING LOAD	36
7 EXISTING LOAD		20/1 _N 8	<u>300</u> 300	N 20/1		EXISTING LOAD 8	37	EXISTING LOAD			20/1 _N -	800 840	N	20/1 3/4"	#10 #10 #10	FCT & FUEL MONITOR	34 36 38
9 EXISTING LOAD		20/1 N	800	N 20/1		EXISTING LOAD 1 C	39	EXISTING LOAD			20/1 N	800	_			SPACE	40
11 EXISTING LOAD		20/1 _N	800 800	N 20/1		EXISTING LOAD 12	41	EXISTING LOAD			20/1 N		800 _			SPACE	42
13 EXISTING LOAD		20/1 _N 8	<u>300</u> 300	N 20/1		EXISTING LOAD 14	43	EXISTING LOAD			20/1 _N -	800	_			SPACE	44
15 EXISTING LOAD		20/1 N	800	N 20/1		EXISTING LOAD 16	45	EXISTING LOAD			15/1 N	600	_			SPACE	46
17 EXISTING LOAD		20/1 _N	800 800	N 20/1		EXISTING LOAD 18	47	EXISTING LOAD			20/1 N		800 _			SPACE	48
19 EXISTING LOAD		20/1 _N 8	<u>300</u> 300	N 20/1		EXISTING LOAD 2C	49	SPACE	-			-	_			SPACE	50
21 EXISTING LOAD		20/1 N	800	M 20/2		FUEL PUMP 22	51	SPACE	-				_			SPACE	52 54 56
23 EXISTING LOAD		20/1 _N	800			NEUTRAL DISC. 24	53	SPACE	-							SPACE	54
25 EXISTING LOAD		50/2 N 40	000	N 20/1		EXISTING LOAD 26	55	SPACE	_			- 1667	N	20/3		EXISTING LOAD	56
27		N N	4000	N 20/1		EXISTING LOAD 28	57	SPACE	-			1667	N				58
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RECEPTS REMAINING	D 1.25 O D 1.0 O D 0.5 O	MOTORS LARGEST MOTOR	<u> 1000 </u>	25	REMAINING NON-CONTINUOUS LOADS DEMAND LOADS	<u>45201</u> 1.0 <u>45201</u> <u>0</u> 1.0 <u>0</u>	LIGHTING RECEPTS 1 RECEPTS F	REMAINING 0	0.5	0 0	NON-SEASONAL MOTORS LARGEST MOTOR			 	REMAINING NON-CONTINUOUS DEMAND LOADS	0 1.0 0	
SPACE HEATING			1.0		TOTAL CONNECTED LOAD	<u>46.2</u> KVA <u>128.3</u> AMPS					WATER HEATING	0	1.0		TOTAL CONNECTE	D LOAD <u>15.2</u> KVA <u>42.</u>	.3_ AMPS
AIR CONDITIONING) 1.0 <u>0</u>	KITCHEN EQUIP.	1.0	<u> </u>	MIN. FEEDER/PANEL CAP.	<u>46.2</u> KVA <u>128.3</u> AMPS	AIR CONDI	TIONING <u>0</u>	1.0	0	KITCHEN EQUIP.	0	1.0		MIN. FEEDER/PAN	NEL CAP. <u>15.2</u> KVA <u>42.</u>	.3_ AMPS
					OVERALL DEMAND FACTOR	_1.00									OVERALL DEMAND	FACTOR <u>1.00</u>	

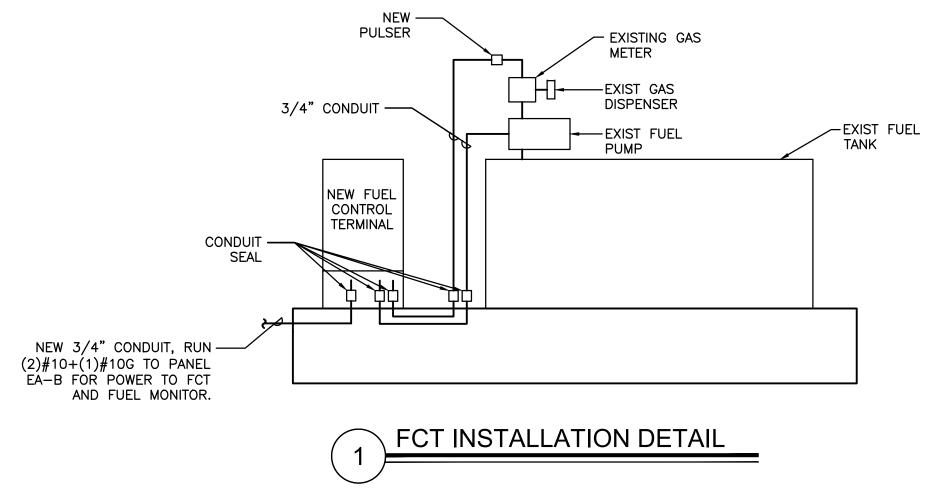

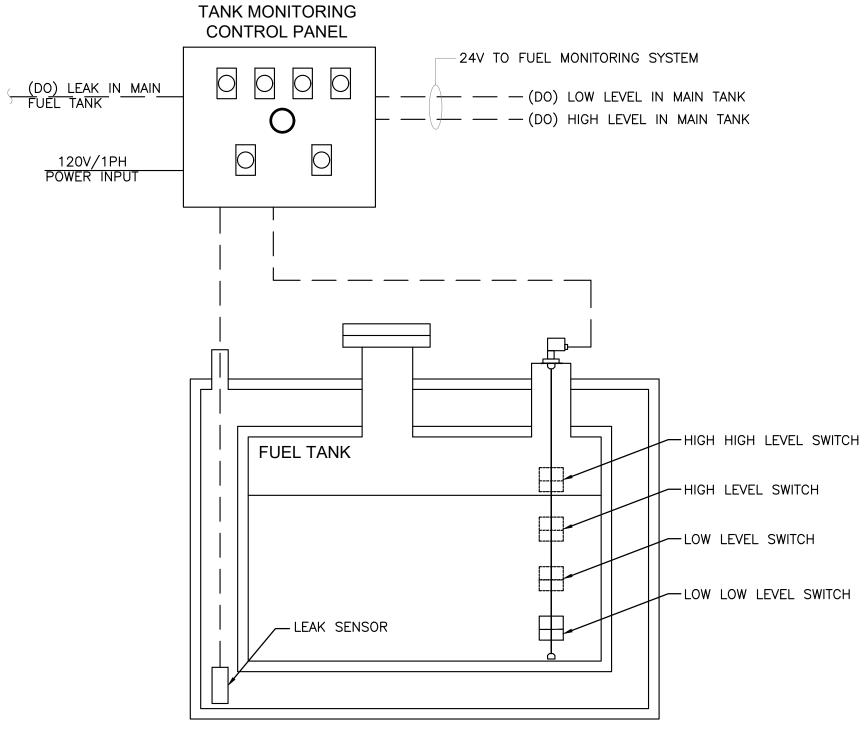

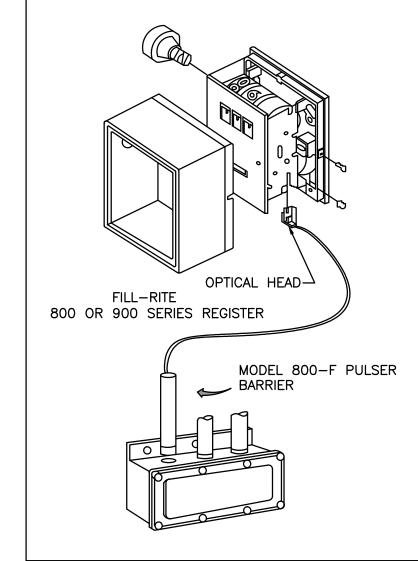

INSTALLATION

- REMOVE THE RESET KNOB AND COVER FROM THE REGISTER. 2.
- (IF EQUIPPED) REMOVE THE NUUT AND WASHER FROM THE SHAFT ON THE LEFT SIDE OF THE REGISTER (LATER MODEL REGISTER ARE BUILT WITH A SMOOTH SHAFT). 3.
- PLACE THE OPTICAL SUCH THAT IT STRADDLES THE PLASTIC GEAR ON THE END OF THE SHAFT AND THE BRACKET SLOT IN ON THE SHAFT SCREW. (IF EQUIPPED) REPLACE THE WASHER AND NUT REMOVED IN STEP.2. ON LATE MODELS, SECURE THE OPTICAL HEAD WITH THE SUPPLIED PUSH NUT.
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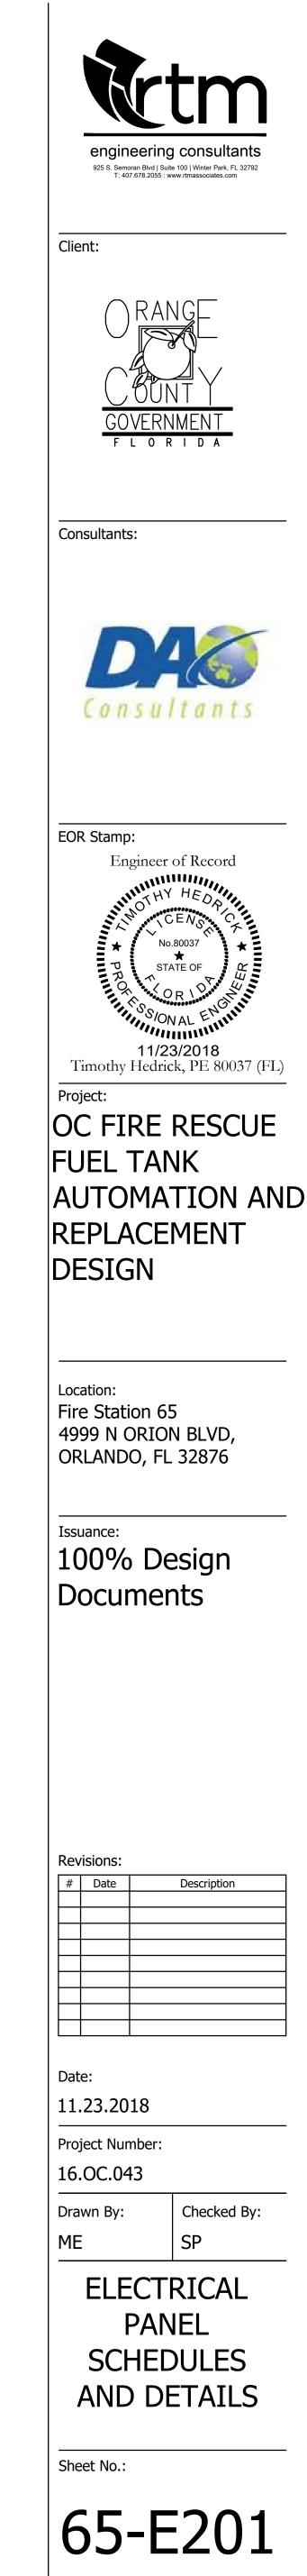
IF ERRATIC OPERATION OF THE PULSER IS ENCOUNTERED, IT MAY BE DUE TO ELECTRICAL NOISE OR FLUCTUATIONS OF THE POWER LINES. THIS TYPE OF PROBLEM CAN BE ELIMINATED BY POWERING THE PULSER WITH SEPARATE POWER LINES NOT CONNECTED TO MOTORS OR SOLENOIDS, OR BY ADDING NOISE SUPPRESSORS TO EACH MOTOR AND/OR SOLENOID.

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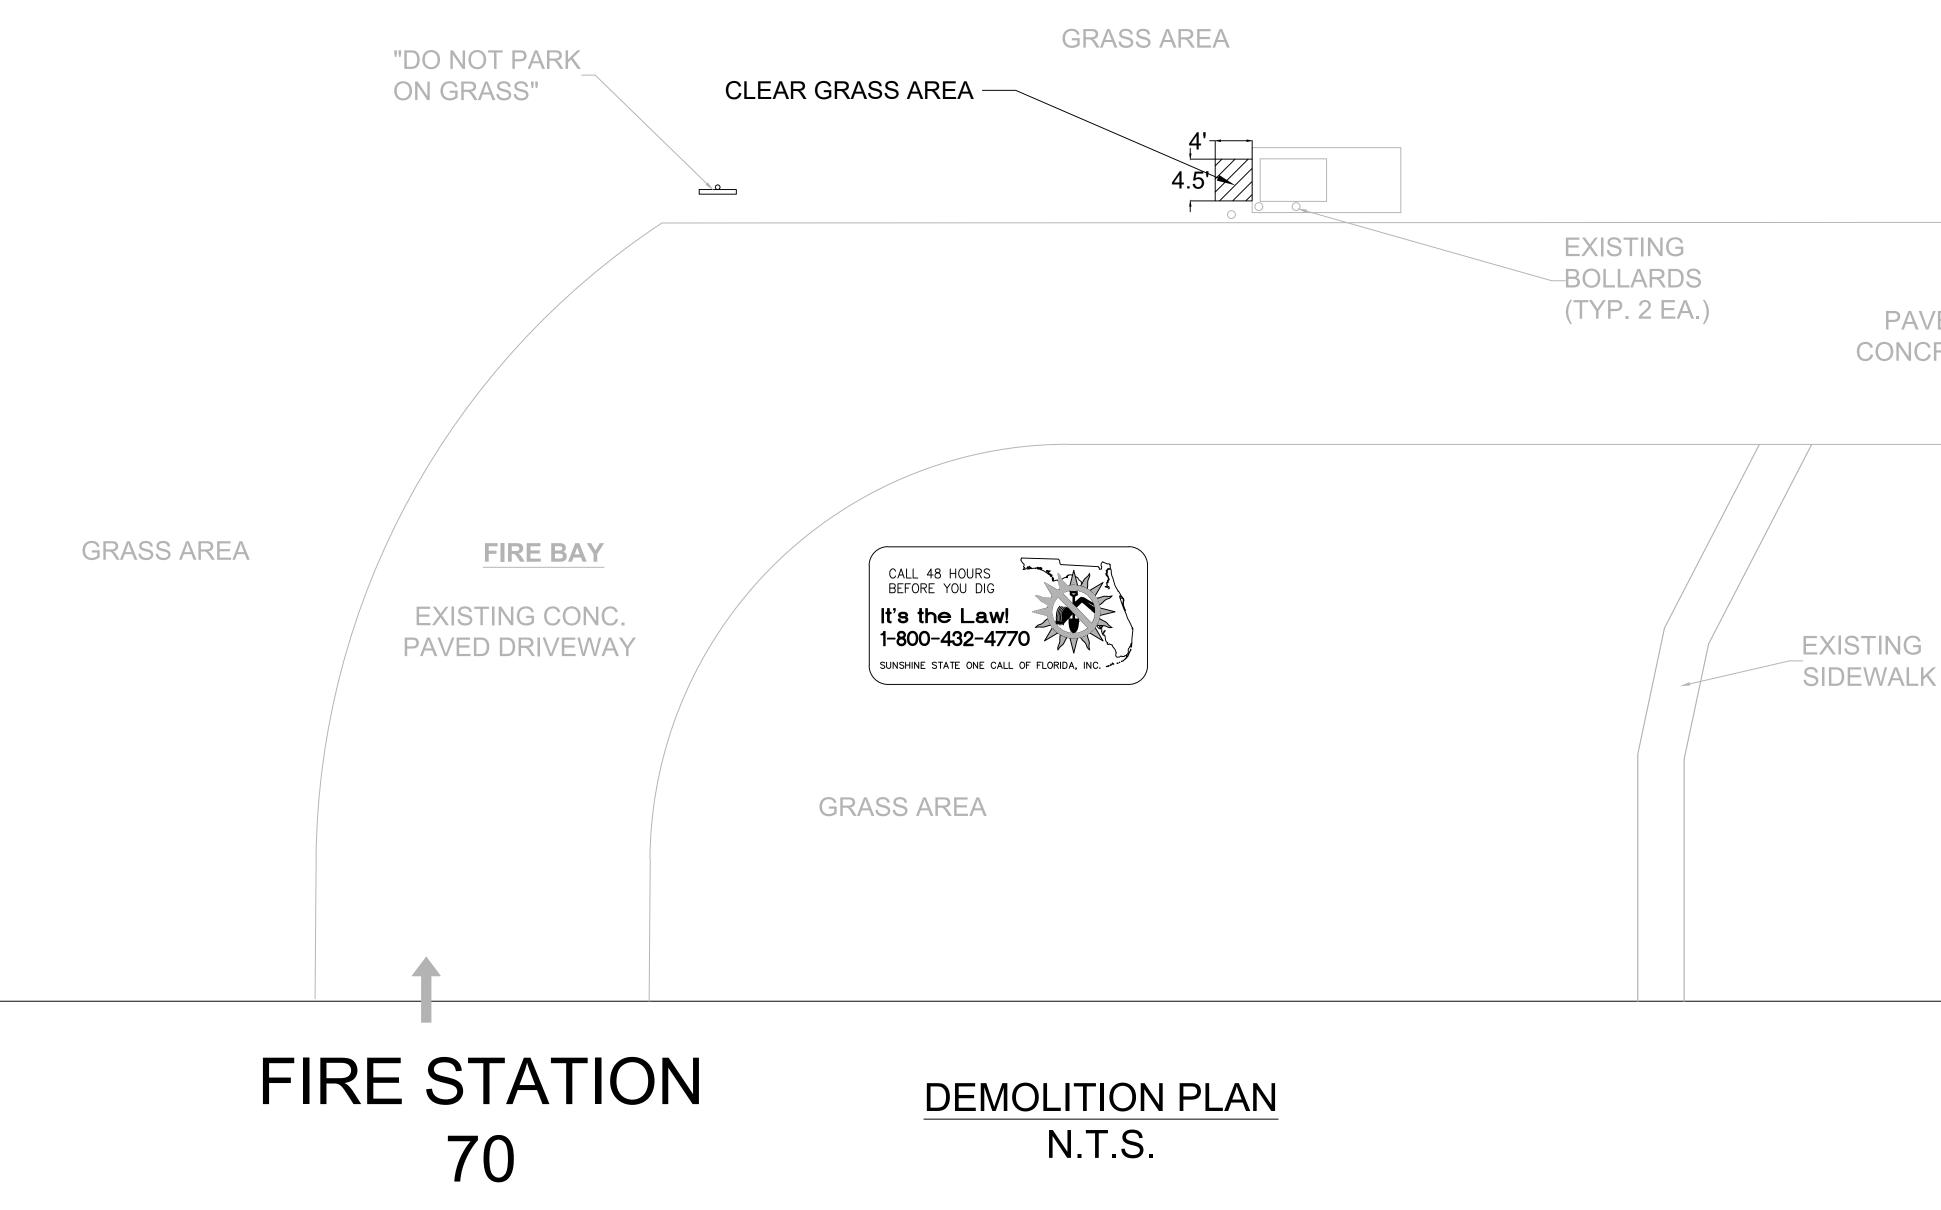
TELEPHONE 708-485-4200 FAX 708-485-7137



FUEL TANK MONITORING SCHEMATIC







PAVED CONCRETE

GENERAL NOTES - CIVIL

1. THIS PROJECT IS LOCATED WITHIN THE ORANGE COUNTY FIRE RESCUE STATION. TO WORK WITHIN THIS FIRE STATION CONTRACTOR HAS TO OBSERVE, FOLLOW AND ABIDE THOROUGHLY, METICULOUSLY AND STRICTLY TO EACH AND EVERY SECURITY RULES AND REGULATIONS CONCERNING SUCH AS BUT NOT LIMITED TO WORKERS WORKING HOURS, INGRESS AND EGRESS POINTS FOR CONTRACTOR PERSONNEL, VEHICLE AND EQUIPMENT

TOPOGRAPHIC INFORMATION AS SHOWN ON DRAWINGS IS PROVIDED FOR INFORMATION PURPOSE ONLY CONTRACTOR TO CALL SUNSHINE ONE CALL OF FLORIDA 1-800-432-4770 TO LOCATE UNDERGROUND UTILITIES AT LOCATIONS OF TRENCHING AND PAVEMENT CUT AS SHOWN ON DRAWINGS.

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4. ALIGNMENT OF UTILITIES IS SHOWN TO INDICATE INTENT OF ENGINEER TO CONNECT THESE LINES BETWEEN UTILITIES FOUND.

5. CONTRACTOR TO VISIT SITE TO FAMILIARIZE HIMSELF WITH EXISTING FIELD CONDITIONS AND LOCATIONS OF EXISTING UTILITIES AS SHOWN ON DRAWINGS. CONTRACTOR TO IMMEDIATELY NOTIFY ORANGE COUNTY PROJECT MANAGER IN WRITING ANY DISCREPANCY OBSERVED FOR PROPER CLARIFICATION.

6. CONTRACTOR TO OBTAIN NECESSARY CONSTRUCTION PERMITS FROM ORANGE COUNTY BUILDING DEPARTMENT AND POST PERMITS ON SITE FOR INSPECTION BY COUNTY INSPECTORS.

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8. DURING CONSTRUCTION CONTRACTOR SHALL INSURE MINIMUM DISTURBANCES TO FIRE STATION OPERATIONS AND SHALL TAKE CARE TO KEEP FIRE TRUCK EXITS CLEARED AT ALL TIME.


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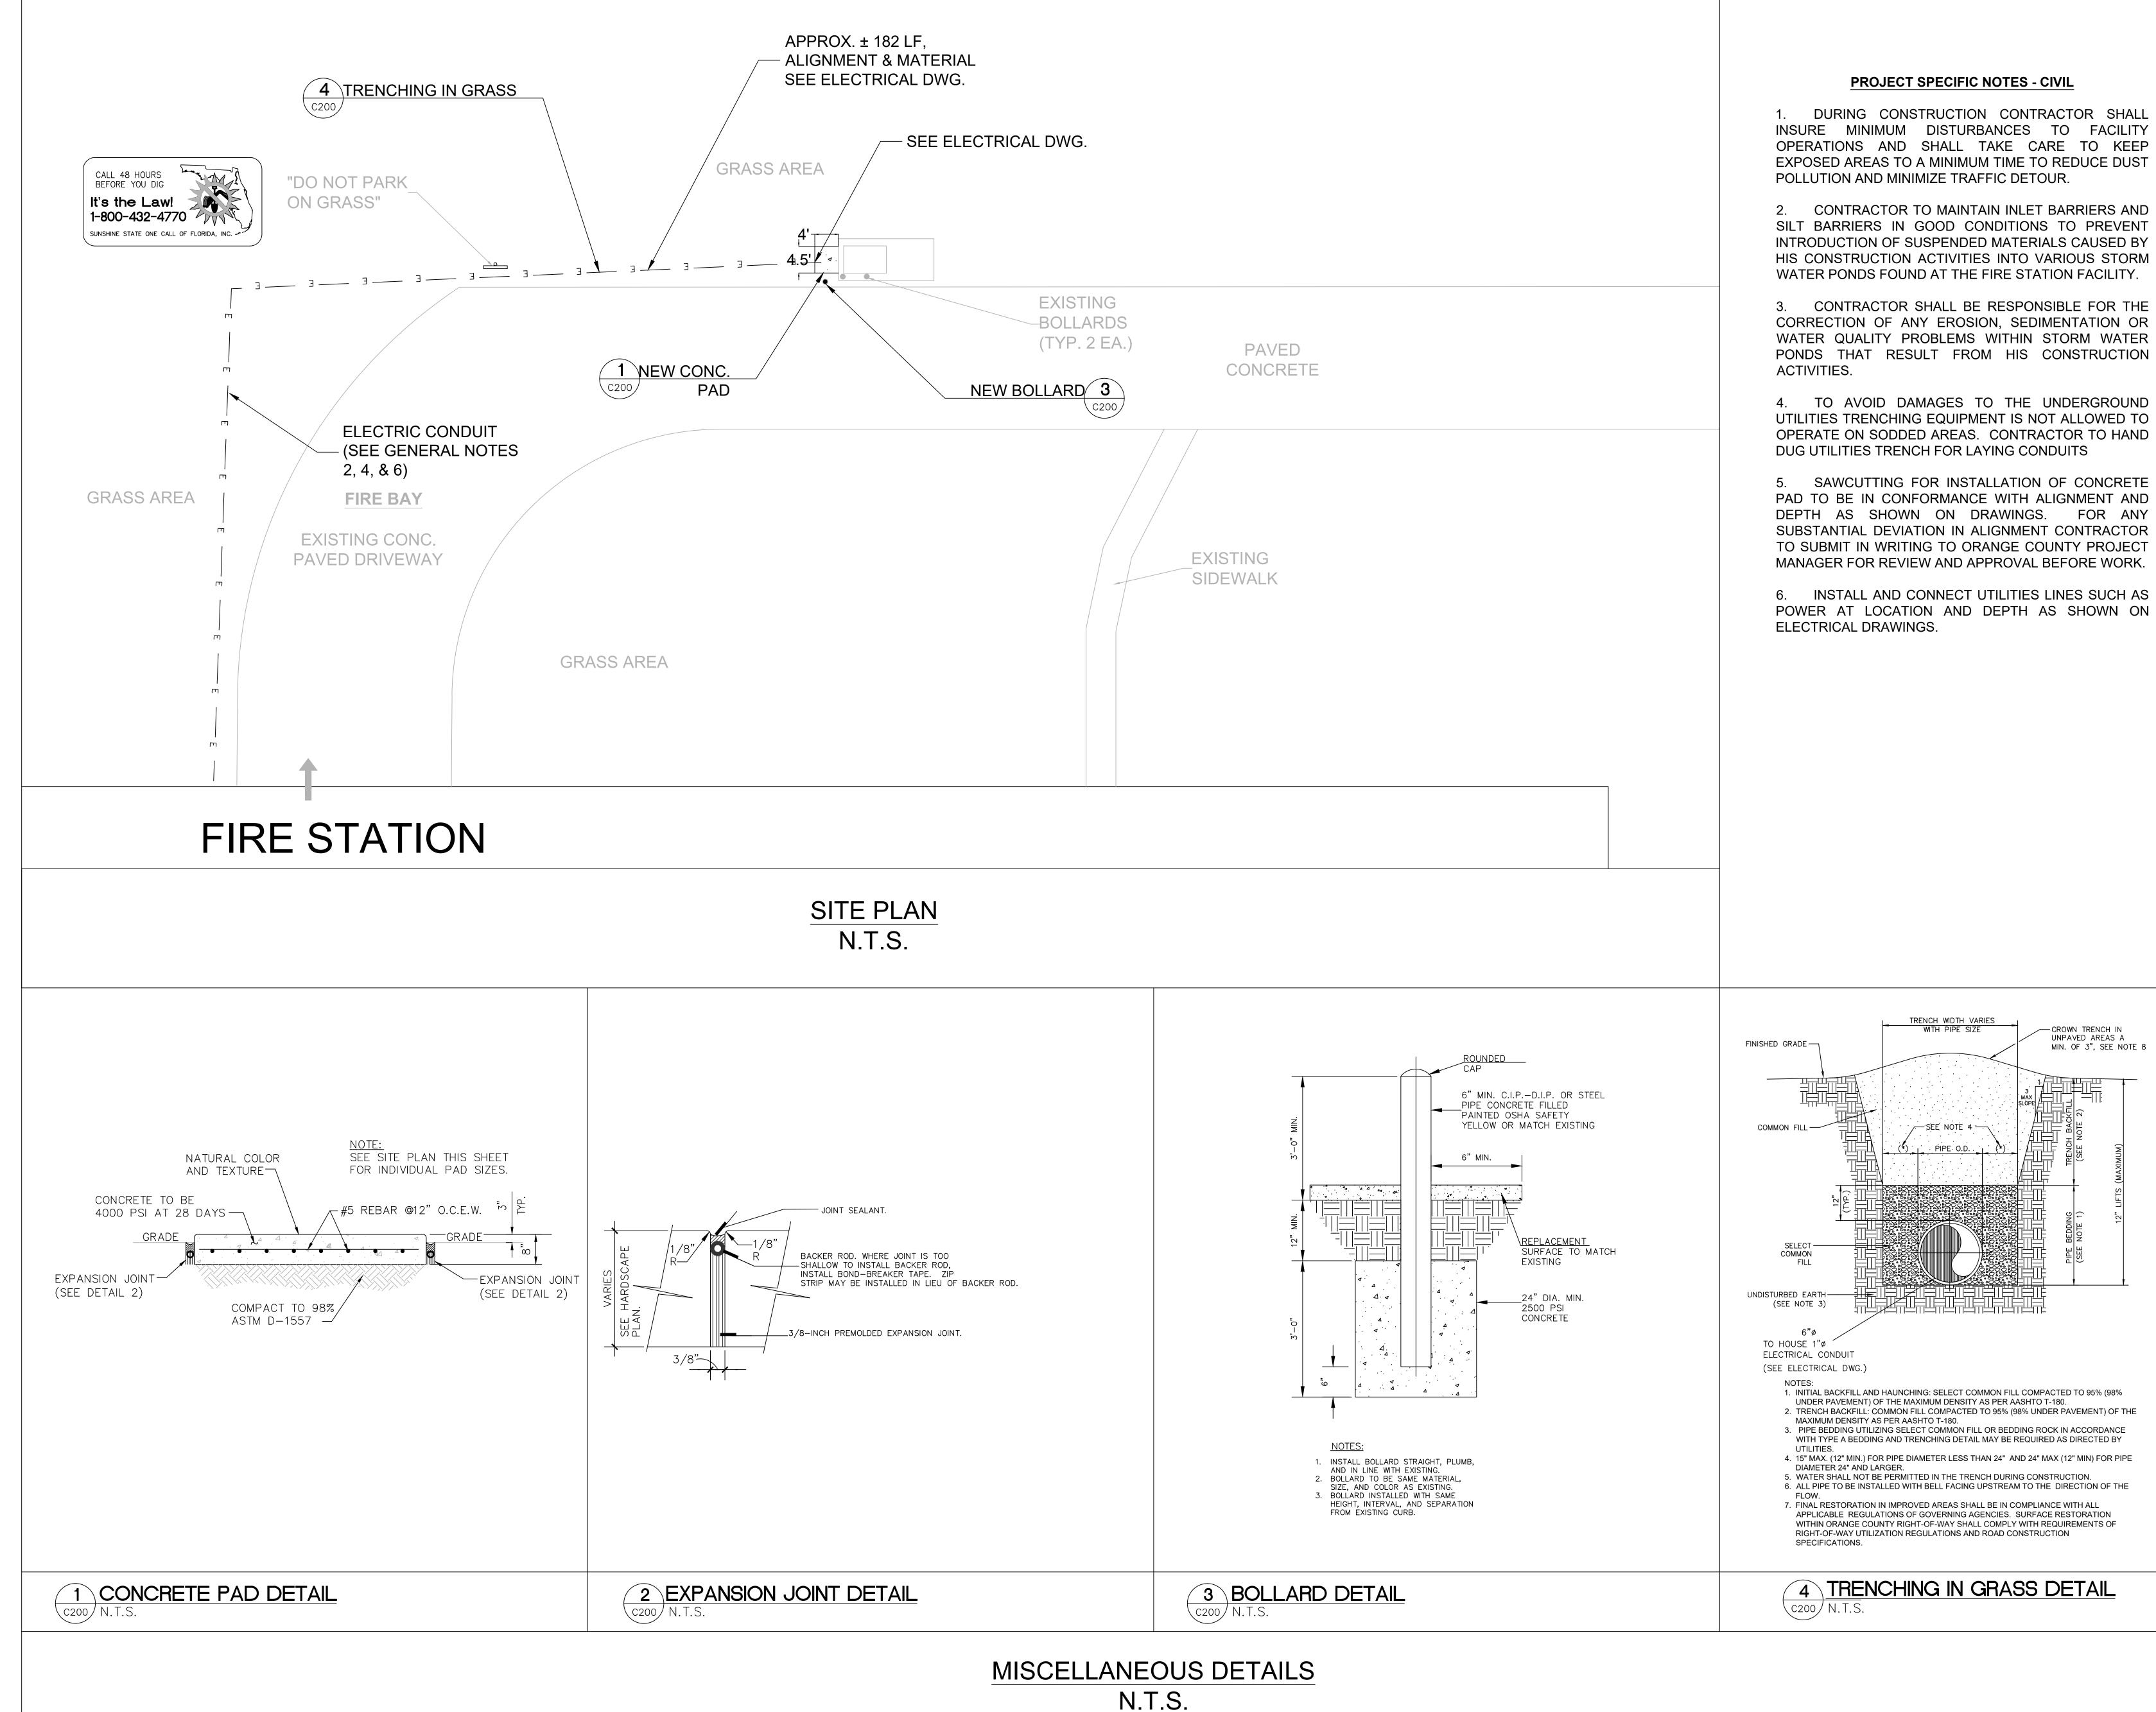
10. CONTRACTOR TO BRING INSIDE THE FIRE STATION VEHICLE, EQUIPMENT, MATERIALS AND ANCILLARIES IN QUANTITIES SUFFICIENT FOR EACH DAY OF WORK.

11. AT THE END OF EACH DAY CONTRACTOR SHALL SECURELY PROTECT ANY CONSTRUCTION AREAS DISTURBED BY SAW CUTTING AND/OR TRENCHING AND REMOVE DEBRIS, TRASH AND OTHER CONSTRUCTION MATERIALS, AND MOVE EACH AND EVERY VEHICLE, EQUIPMENT, AND ANCILLARIES OUT OF THE FIRE STATION TO THE SATISFACTION OF ORANGE COUNTY PROJECT MANAGER.


12. AT THE END OF CONSTRUCTION AND BEFORE CLOSE-OUT CONTRACTOR TO THOROUGHLY CLEAN JOB SITE OF DEBRIS, TRASH, OTHER CONSTRUCTION MATERIALS TO THE SATISFACTION OF ORANGE COUNTY PROJECT MANAGER.

13. AT FINAL INSPECTION CONTRACTOR TO SUBMIT TO ORANGE COUNTY PROJECT MANAGER MARKED-UP DRAWINGS SHOWING ACTUAL ALIGNMENT AND DEPTH OF EACH AND EVERY UTILITIES LINE INSTALLED FOR ENGINEER TO RECORD ON AS-BUILT DRAWINGS.




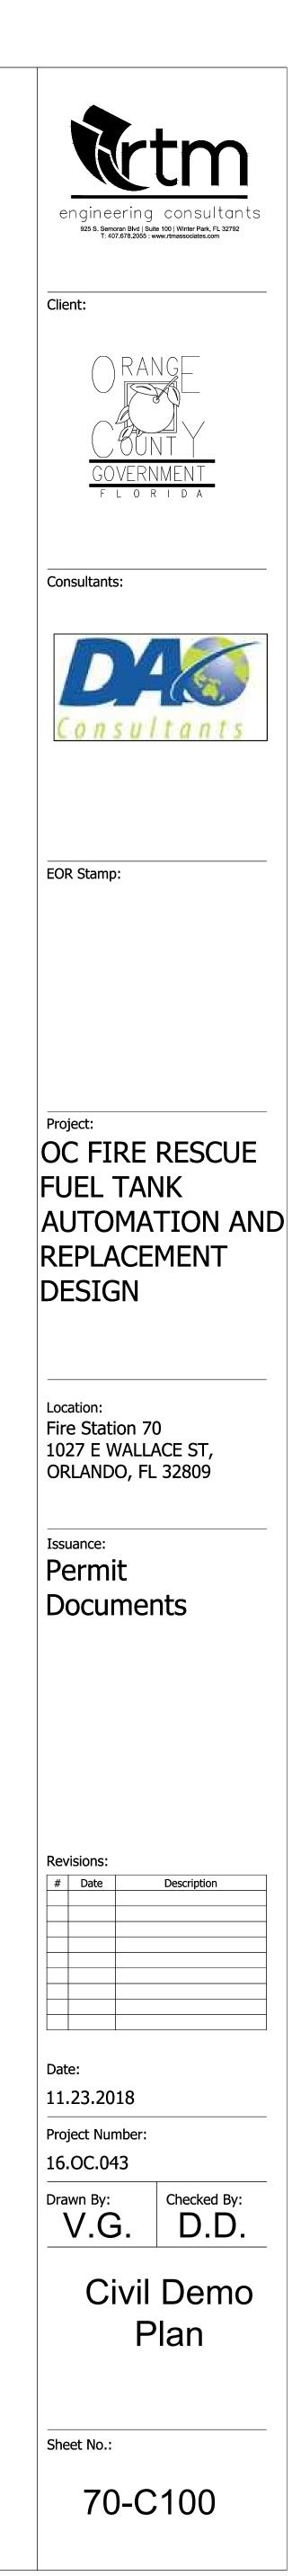



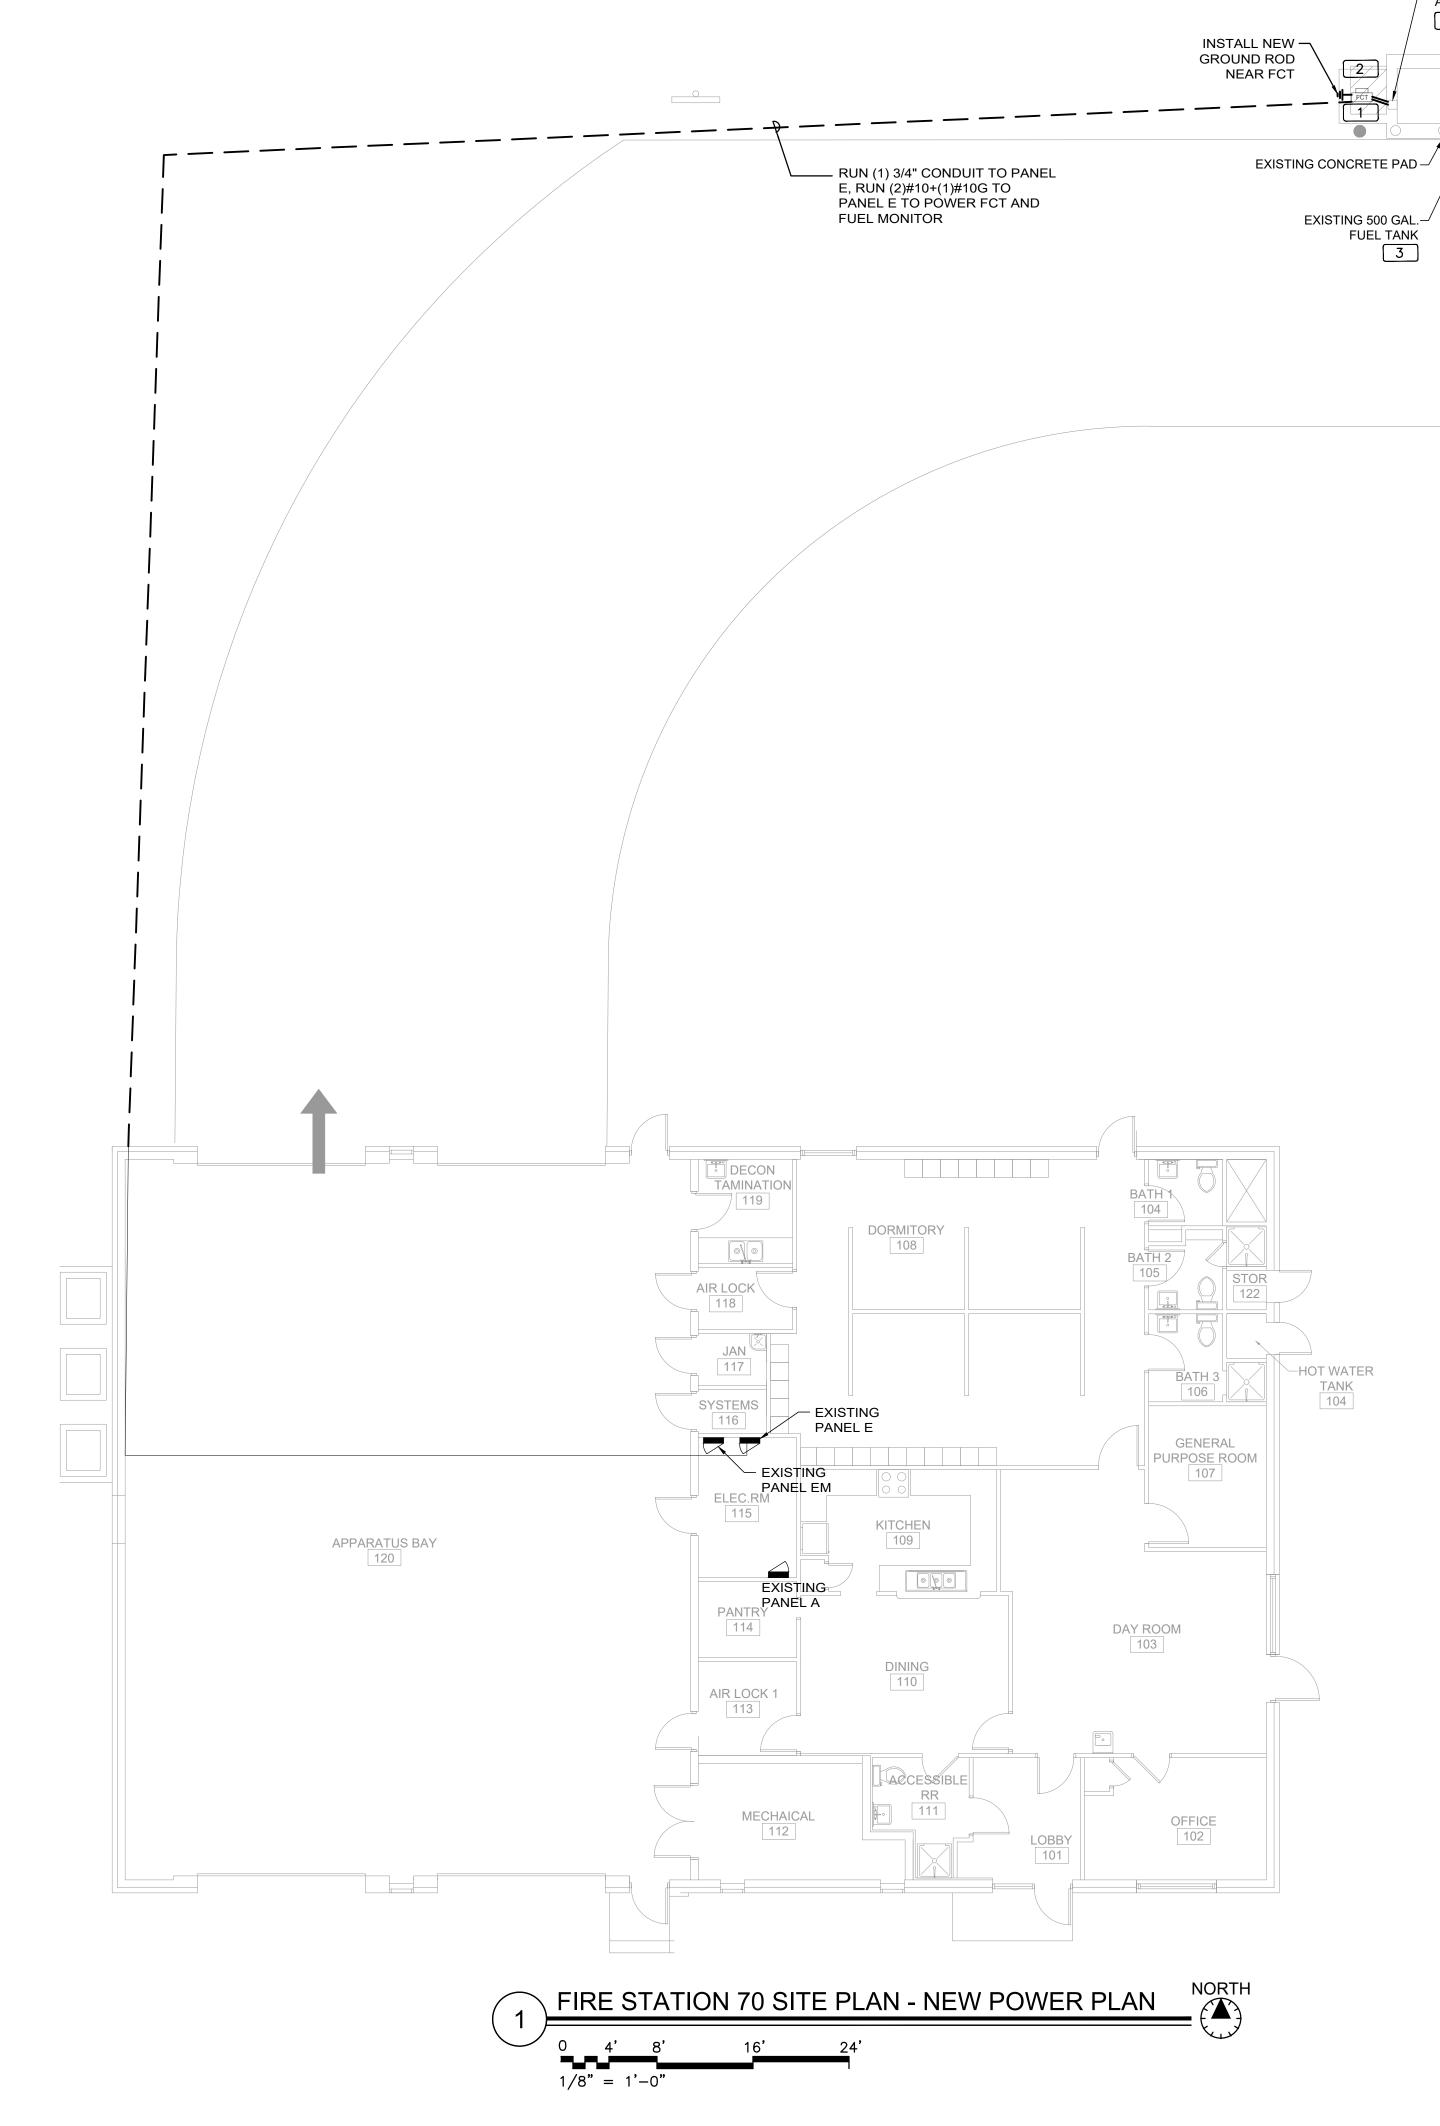

GENERAL NOTES **KEY NOTES** 1 NEW FUEL CONTROL UNIT (FCT), BASIS OF DESIGN EJ WARD W4 IOT. PROVIDE FUEL CONTROL UNIT WITH INTEGRAL NETWORK SWITCH AND WITH 'BACKPACK' 1. PAINT ALL CONDUIT ABOVE GROUND TO MATCH. 2. PROVIDE EXPLOSION PROOF SEAL-OFF'S AT EACH END OF ALL CONDUIT RUNS. INSTALLATION SHALL MOUNTING HARDWARE. 2 NEW FUEL MONITOR, BASIS OF DESIGN OMTECH PROTEUS-K. MOUNT TO FCT MEET REQUIREMENTS OF NEC ARTICLE 514. WITH HARDWARE PROVIDED WITH FCT. SEE 3/E201 FOR MORE INFORMATION. 3 PROVIDE AND INSTALL NEW TANK FLOAT SYSTEM. 4 PROVIDE AND INSTALL NEW ELECTRONIC PULSER, BASIS OF DESIGN OPW MODEL 800-F, SEE 2/E201 FOR MORE INFORMATION. _ EXISTING FUEL PUMP AND DISPENSER 4

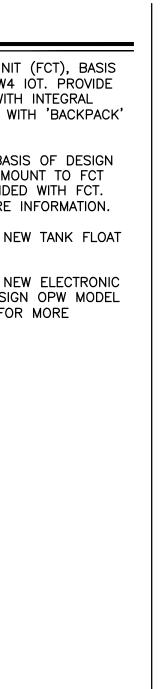



Client:



Consultants:





Location: Fire Station 70 1027 E WALLACE ST, ORLANDO, FL 32809

Issuance: 100% Design Documents

Description

Checked By:

SP

ELECTRICAL

POWER PLAN

70-E101

Revisions: # Date


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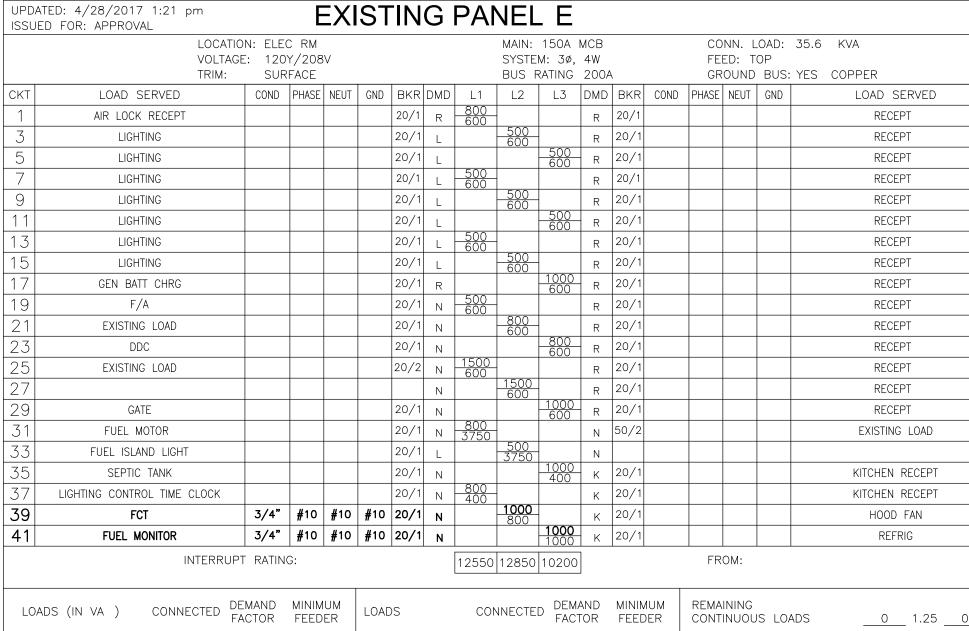
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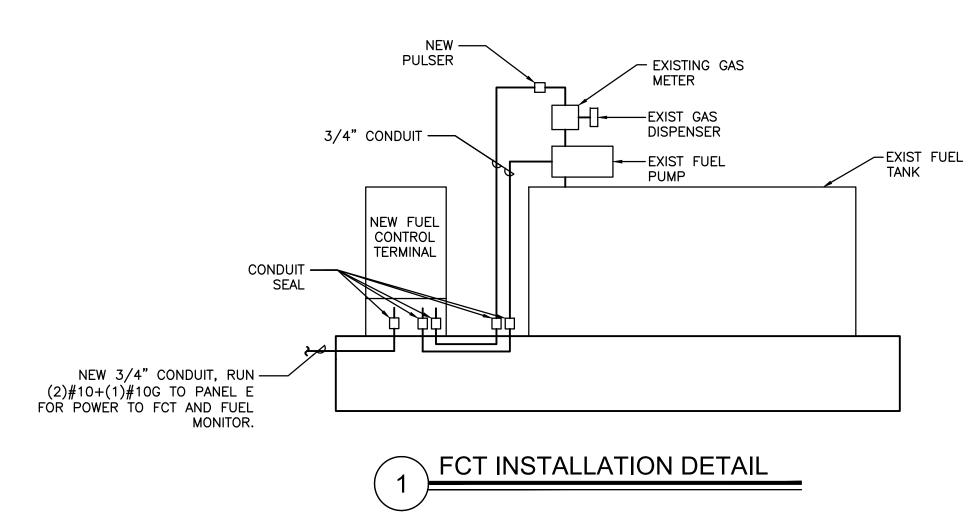
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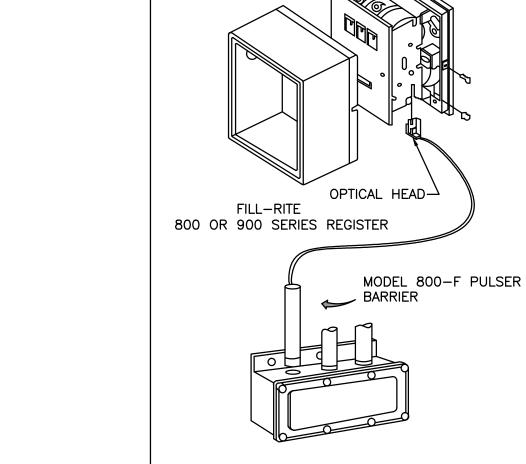
ME

Date: 11.23.2018 Project Number:







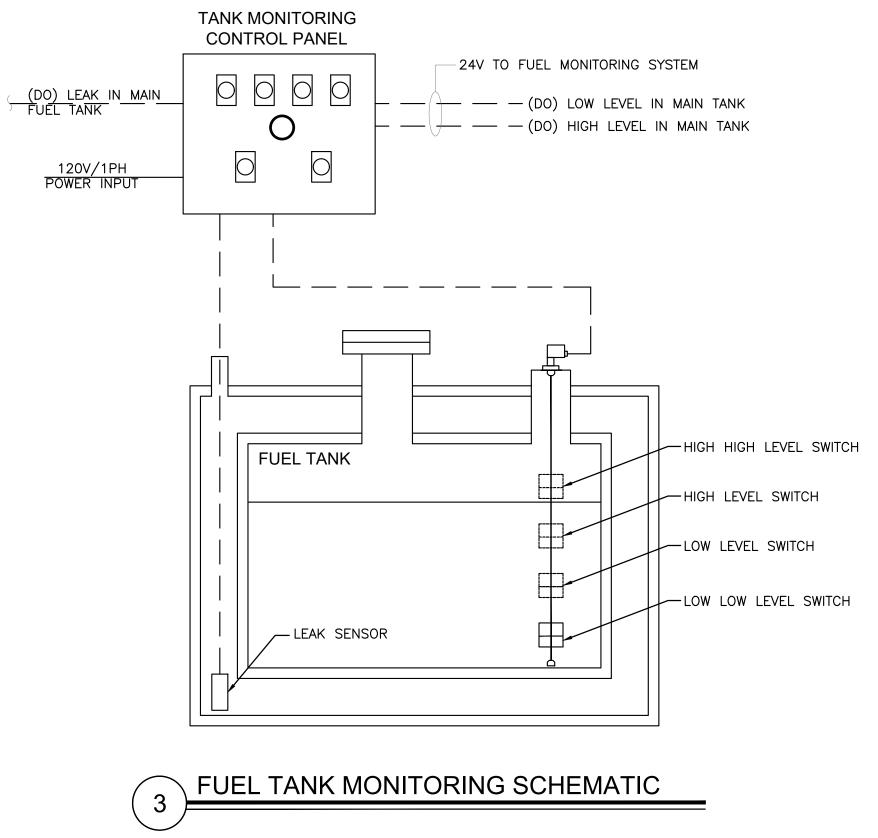

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TELEPHONE 708-485-4200 FAX 708-485-7137



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	LOCATIC VOLTAGI TRIM:	E: 120		V					SYSTE	150A M: 3ø, RATING	4W	ł		FE	ED: T	OP	35.6 KVA YES COPPER	
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1	AIR LOCK RECEPT					20/1	R	800 600	-		R	20/1					RECEPT	2
3	LIGHTING					20/1	L		500 600	-	R	20/1					RECEPT	4
5	LIGHTING					20/1	L			500 600	R	20/1					RECEPT	6
7	LIGHTING					20/1	L	500 600	-		R	20/1					RECEPT	8
9	LIGHTING					20/1	L	000	500 600	-	R	20/1					RECEPT	10
11	LIGHTING					20/1	L			500 600	R	20/1					RECEPT	12
13	LIGHTING					20/1	L	500 600	-		R	20/1					RECEPT	14
15	LIGHTING					20/1	L		500 600	-	R	20/1					RECEPT	16
17	GEN BATT CHRG					20/1	R			1000	R	20/1					RECEPT	18
19	F/A					20/1	N	500 600	-		R	20/1					RECEPT	20
21	EXISTING LOAD					20/1	N		<u>800</u>	-	R	20/1					RECEPT	22
23	DDC					20/1	Ν			800 600	R	20/1					RECEPT	24
25	EXISTING LOAD					20/2	N	1500 600	-		R	20/1					RECEPT	26
27							N		1500 600	-	R	20/1					RECEPT	28
29	GATE					20/1	Ν			1000 600	R	20/1					RECEPT	30
31	FUEL MOTOR					20/1	Ν	800 3750	-	000	N	50/2					EXISTING LOAD	32
33	FUEL ISLAND LIGHT					20/1	L		500 3750	-	N							34
35	SEPTIC TANK					20/1	Ν			1000	ĸ	20/1					KITCHEN RECEPT	36
37	LIGHTING CONTROL TIME CLOCK					20/1	Ν	800 400	-		к	20/1					KITCHEN RECEPT	38
39	FCT	3/4"	# 10	# 10	# 10	20/1	Ν		1000 800	-	к	20/1					HOOD FAN	40
41	FUEL MONITOR	3/4"	# 10	# 10	# 10	20/1	N			1000	ĸ	20/1					REFRIG	42
	INTERRUP [*]	t ratin	G:					12550	12850	10200]			FR	OM:			
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	CONDITIONING 0	0		KITCH	ien e	QUIP	'	2600	0.		208					NEL CAP. <u>35.7</u> KVA <u>99.1</u>		
														OVER/	ALL D	EMANE	FACTOR <u>1.00</u>	





Consultants:



EOR Stamp: Engineer of Record HY HE No.80037 = * * PR STATE OF · SIONAL . Project: OC FIRE RESCUE FUEL TANK **AUTOMATION AND** REPLACEMENT

Location: Fire Station 70 1027 E WALLACE ST, ORLANDO, FL 32809

DESIGN

Issuance: 100% Design Documents

Revisions: # Date Description

Checked By:

SP

ELECTRICAL

PANEL

SCHEDULES

AND DETAILS


70-E201


Date: 11.23.2018 Project Number: 16.OC.043

Drawn By:

Sheet No.:

MF

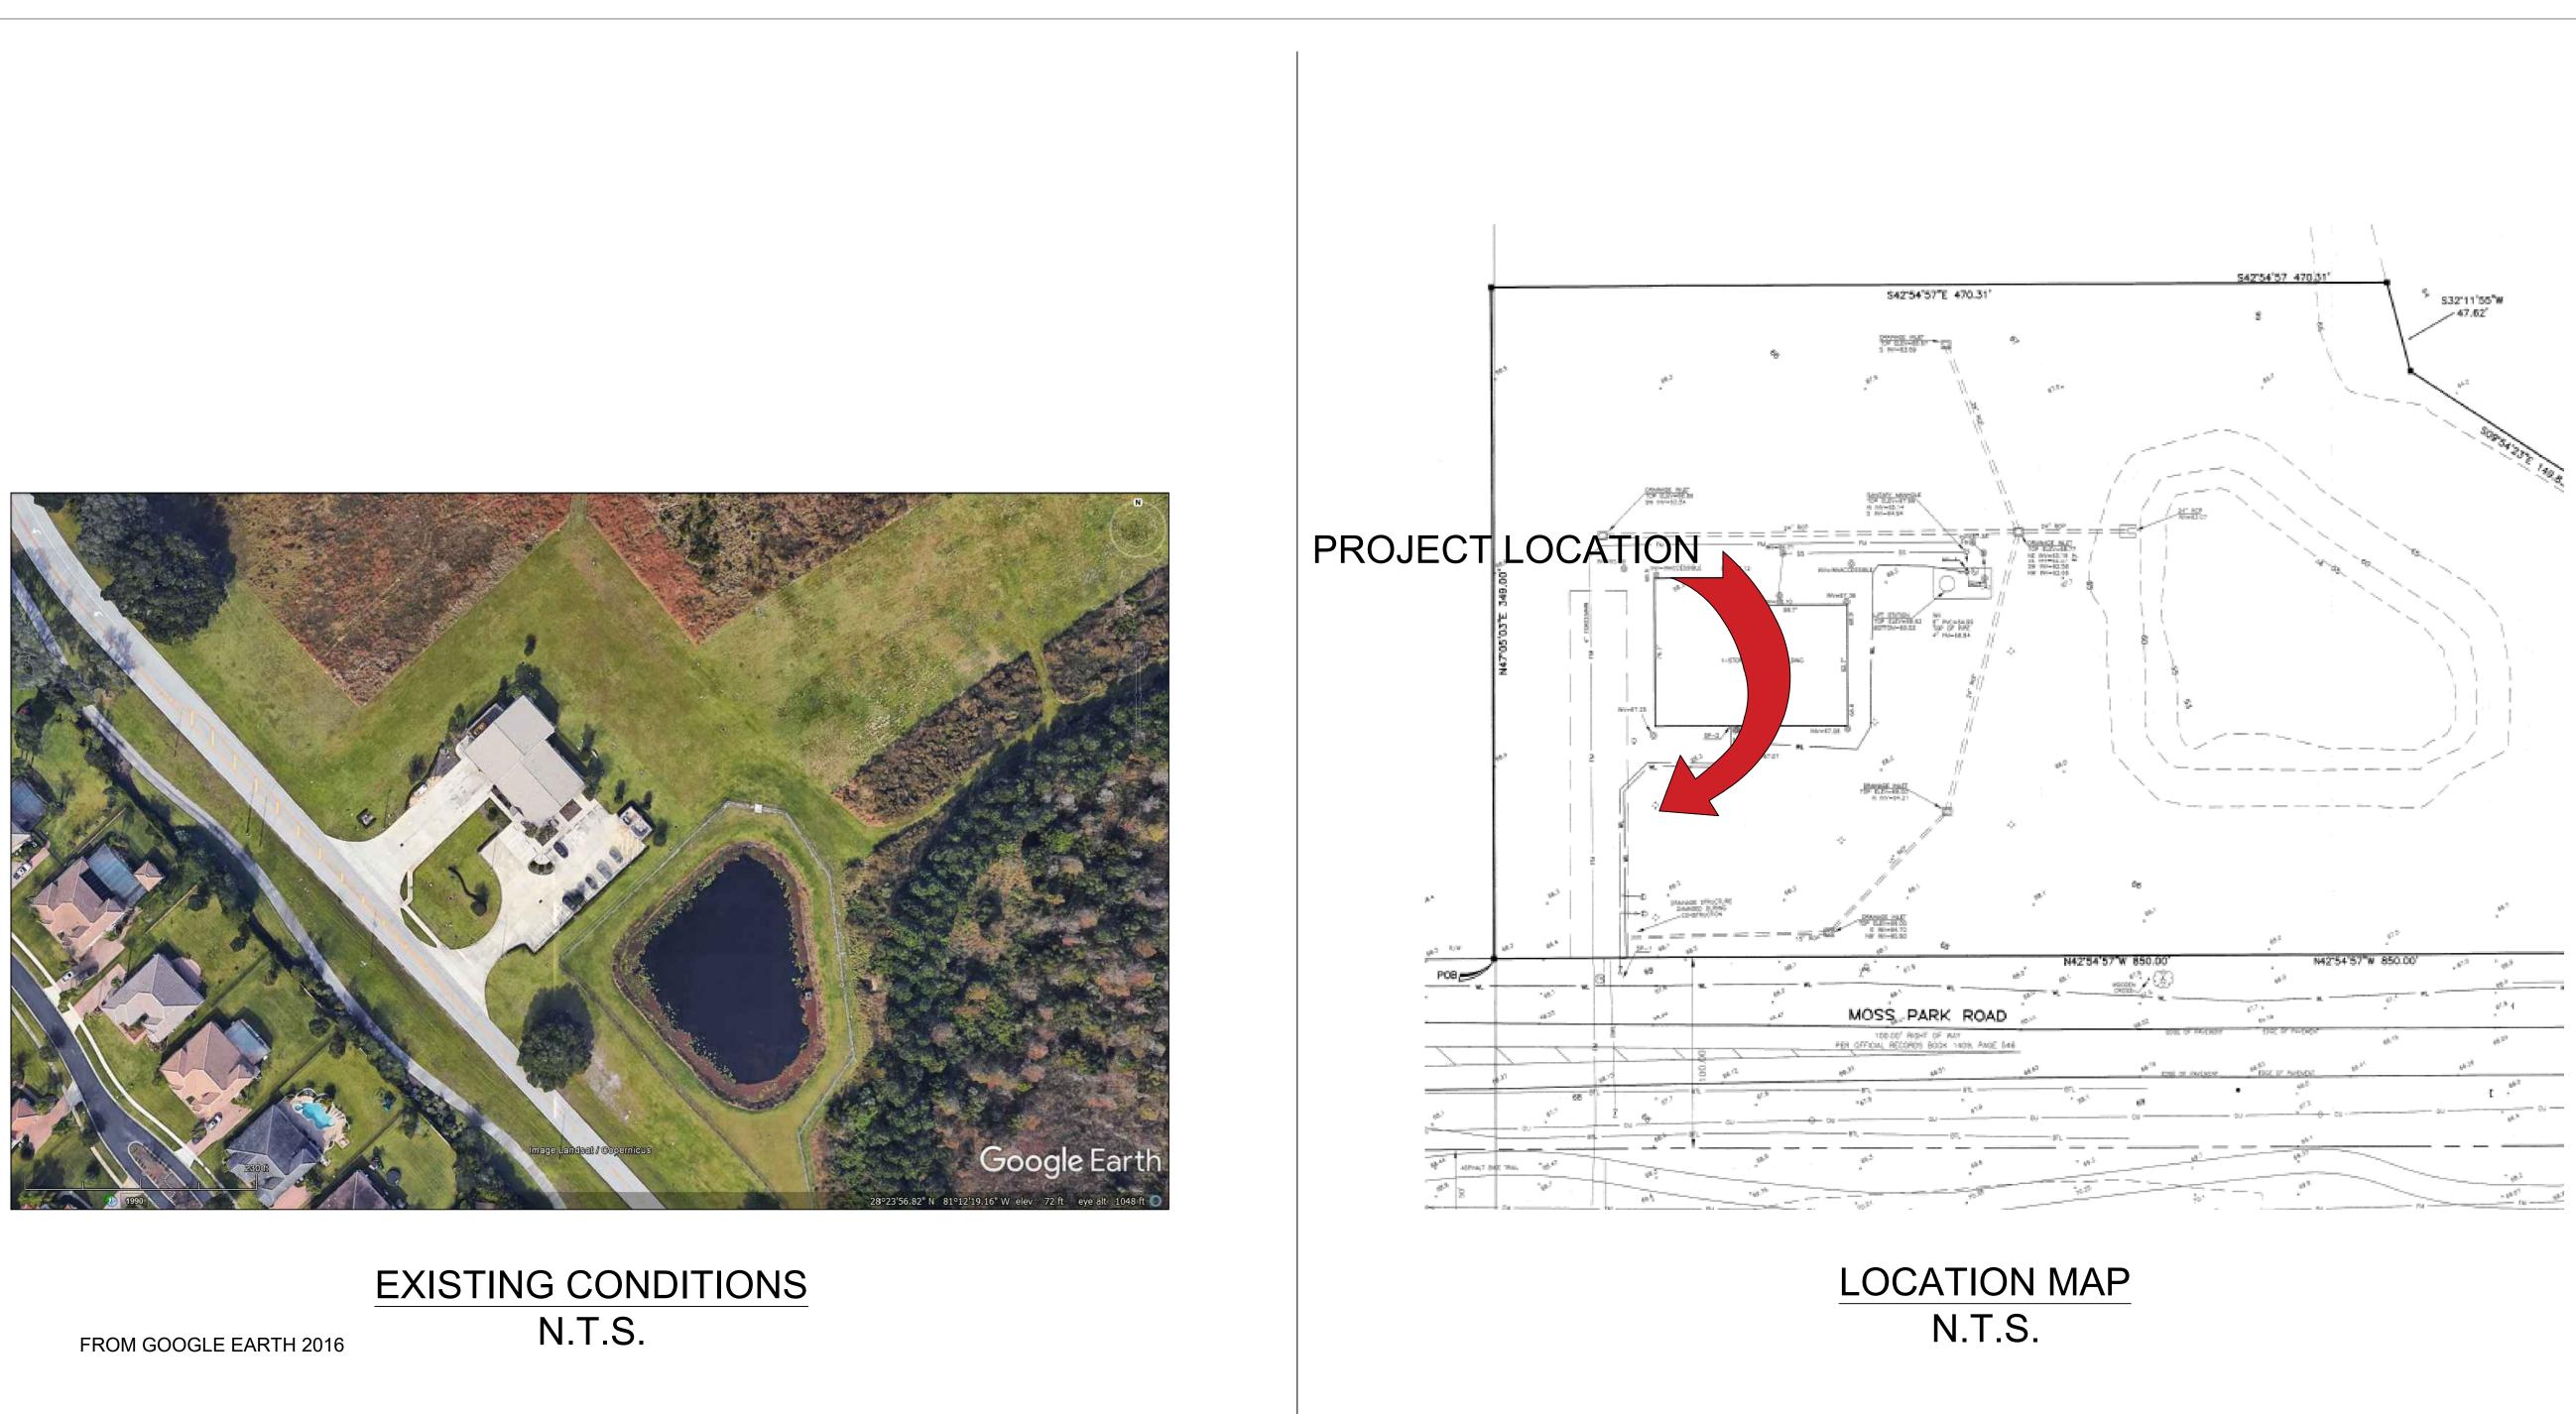

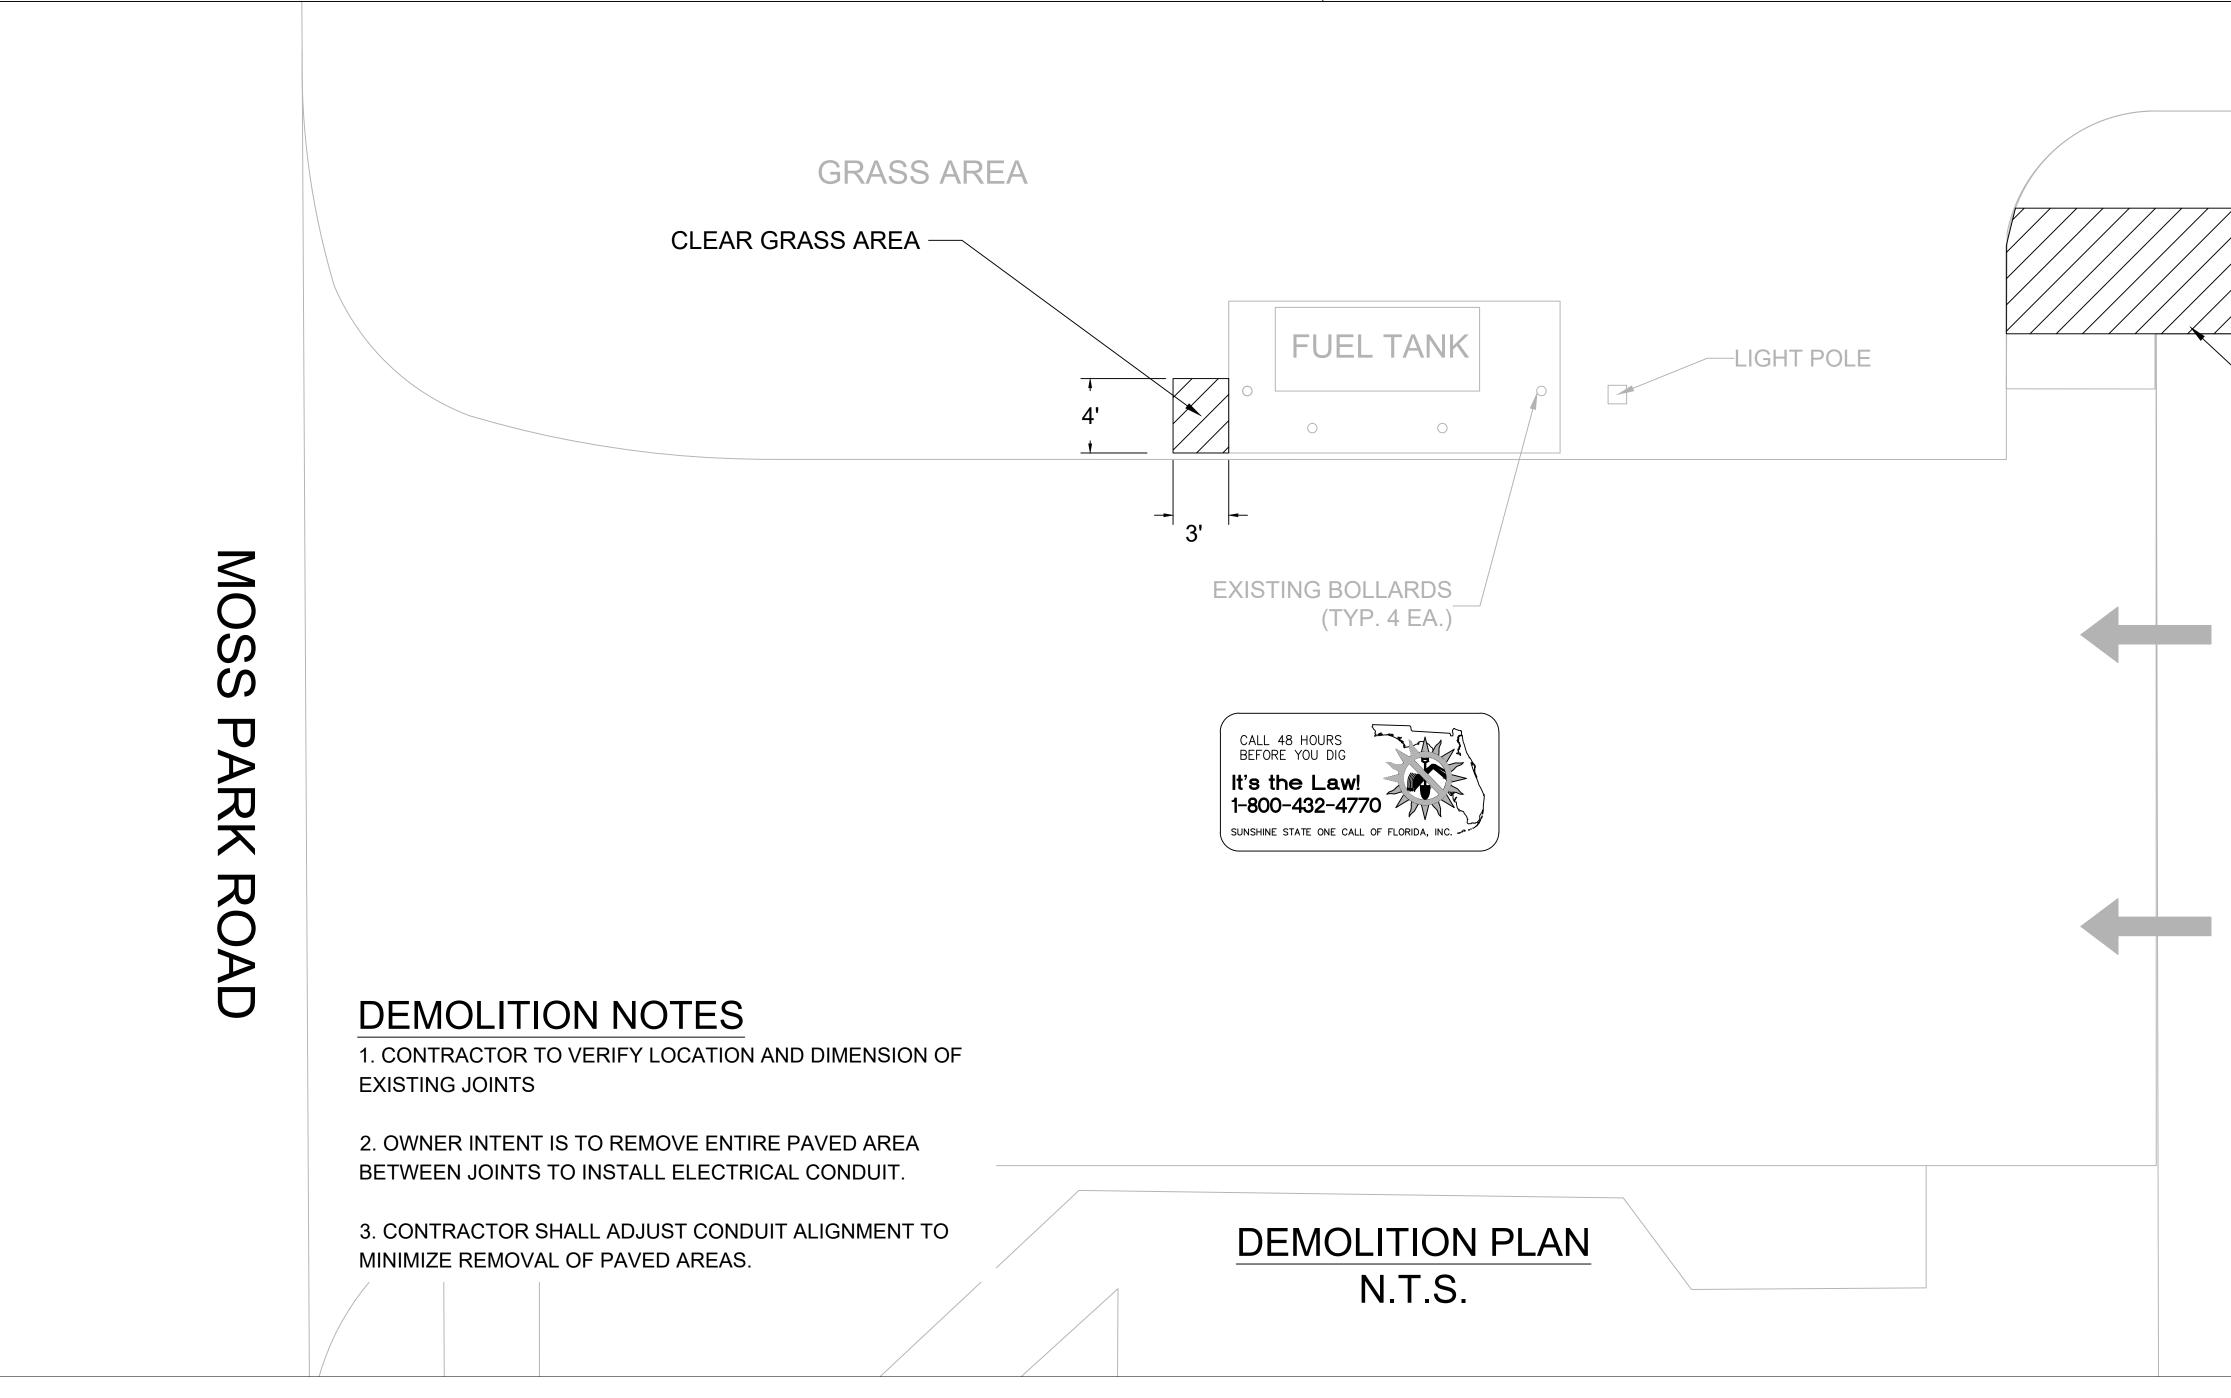



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12. CONTRACTOR TO SAW CUT CONCRETE AND ASPHALT PAVEMENT TO WIDTH AND DEPTH AS SHOWN ON DRAWINGS FOR LAYING UTILITIES LINES.

13. EXCESS EXCAVATED MATERIALS FROM TRENCHING AND/OR SAW CUTTING SHALL BE DISPOSED OFFSITE OR AS DIRECTED BY ORANGE COUNTY PROJECT MANAGER.


14. ALL EXISTING SODDED AREAS DISTURBED DURING CONSTRUCTION SHALL BE REPLACED WITH THE SAME TYPE OF SOD AT THE TIME OF JOB COMPLETION.

15. CONTRACTOR TO USE RAPID CURING CONCRETE TYPE III 4000 LBS FOR PAVED AREAS TO MATCH EXISTING CONDITIONS. SAW CUT EXPANSION JOINTS TO MATCH EXISTING PATTERN. PROTECT NEW CONCRETE AREA WITH STANDARD TRAFFIC PLATES.


16. AT THE END OF EACH DAY CONTRACTOR SHALL SECURELY PROTECT ANY CONSTRUCTION AREAS DISTURBED BY SAW CUTTING AND/OR TRENCHING AND REMOVE DEBRIS, TRASH AND OTHER CONSTRUCTION MATERIALS, AND MOVE EACH AND EVERY VEHICLE, EQUIPMENT, AND ANCILLARIES OUT OF THE FIRE STATION TO THE SATISFACTION OF ORANGE COUNTY PROJECT MANAGER.


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18. AT FINAL INSPECTION CONTRACTOR TO SUBMIT TO ORANGE COUNTY PROJECT MANAGER MARKED-UP DRAWINGS SHOWING ACTUAL ALIGNMENT AND DEPTH OF EACH AND EVERY UTILITIES LINE INSTALLED FOR ENGINEER TO RECORD ON AS-BUILT DRAWINGS.

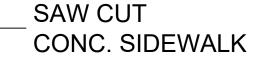



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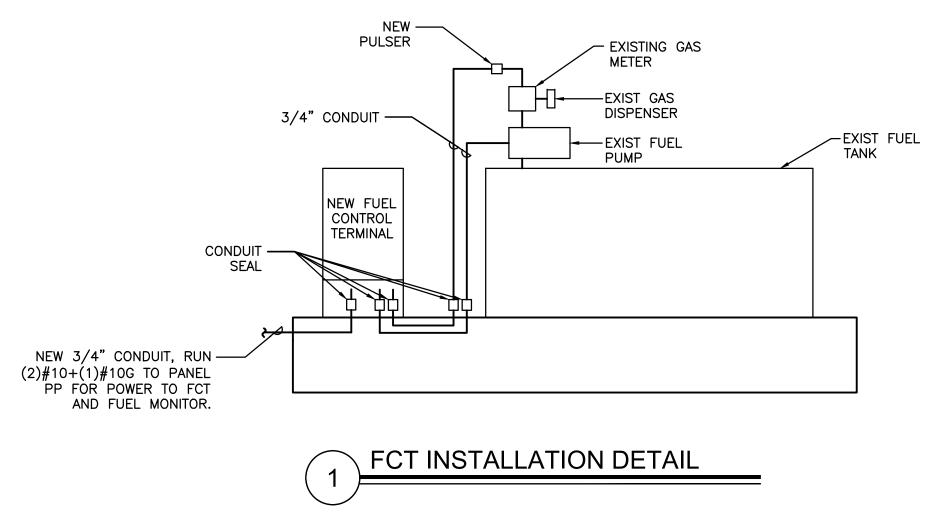





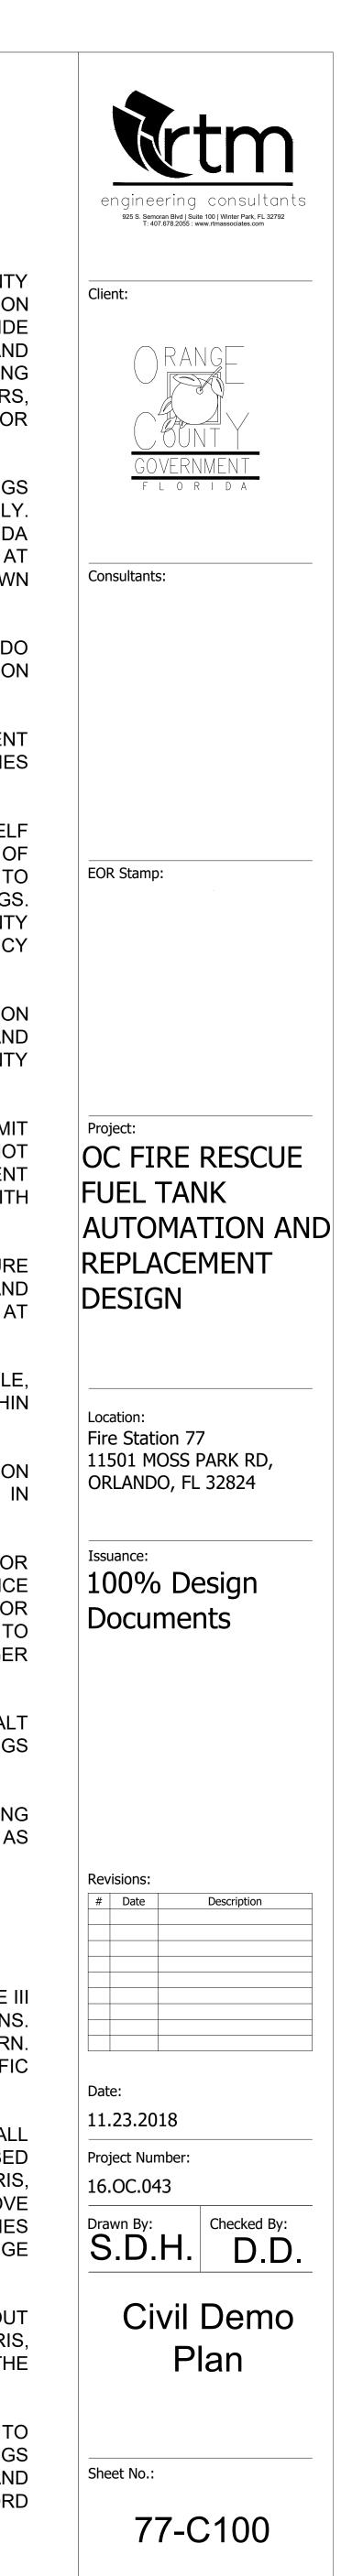

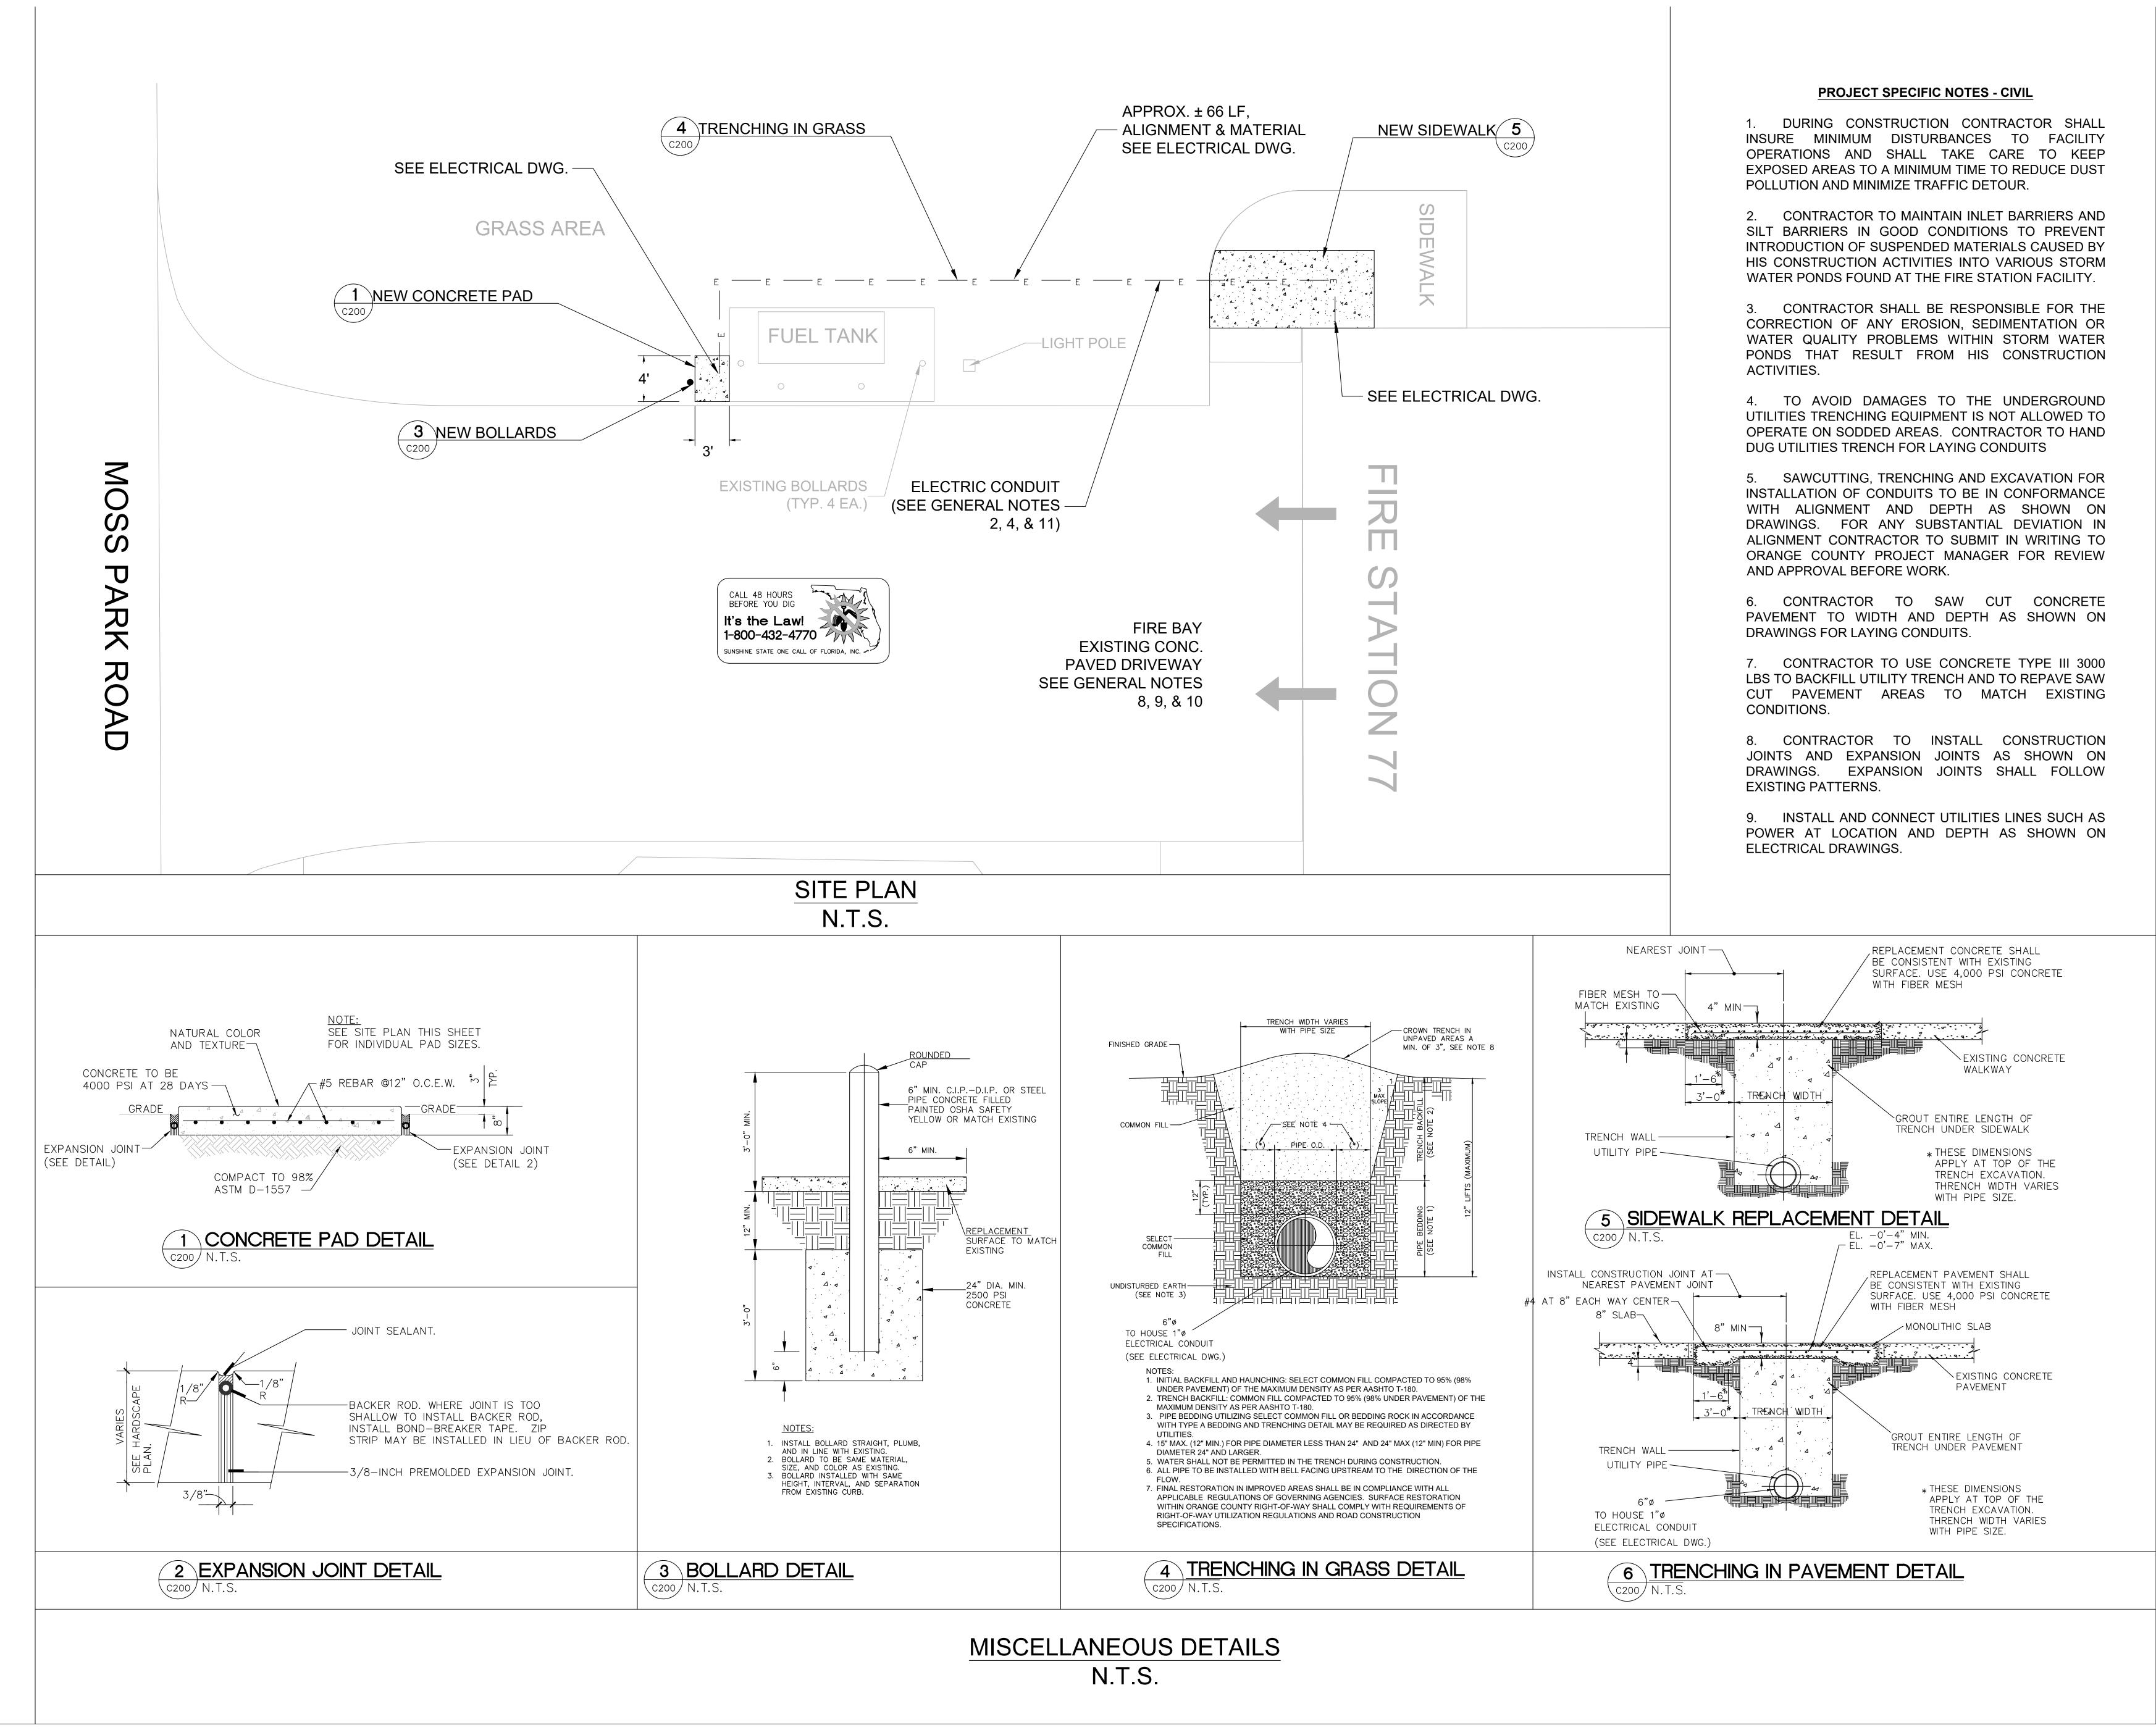


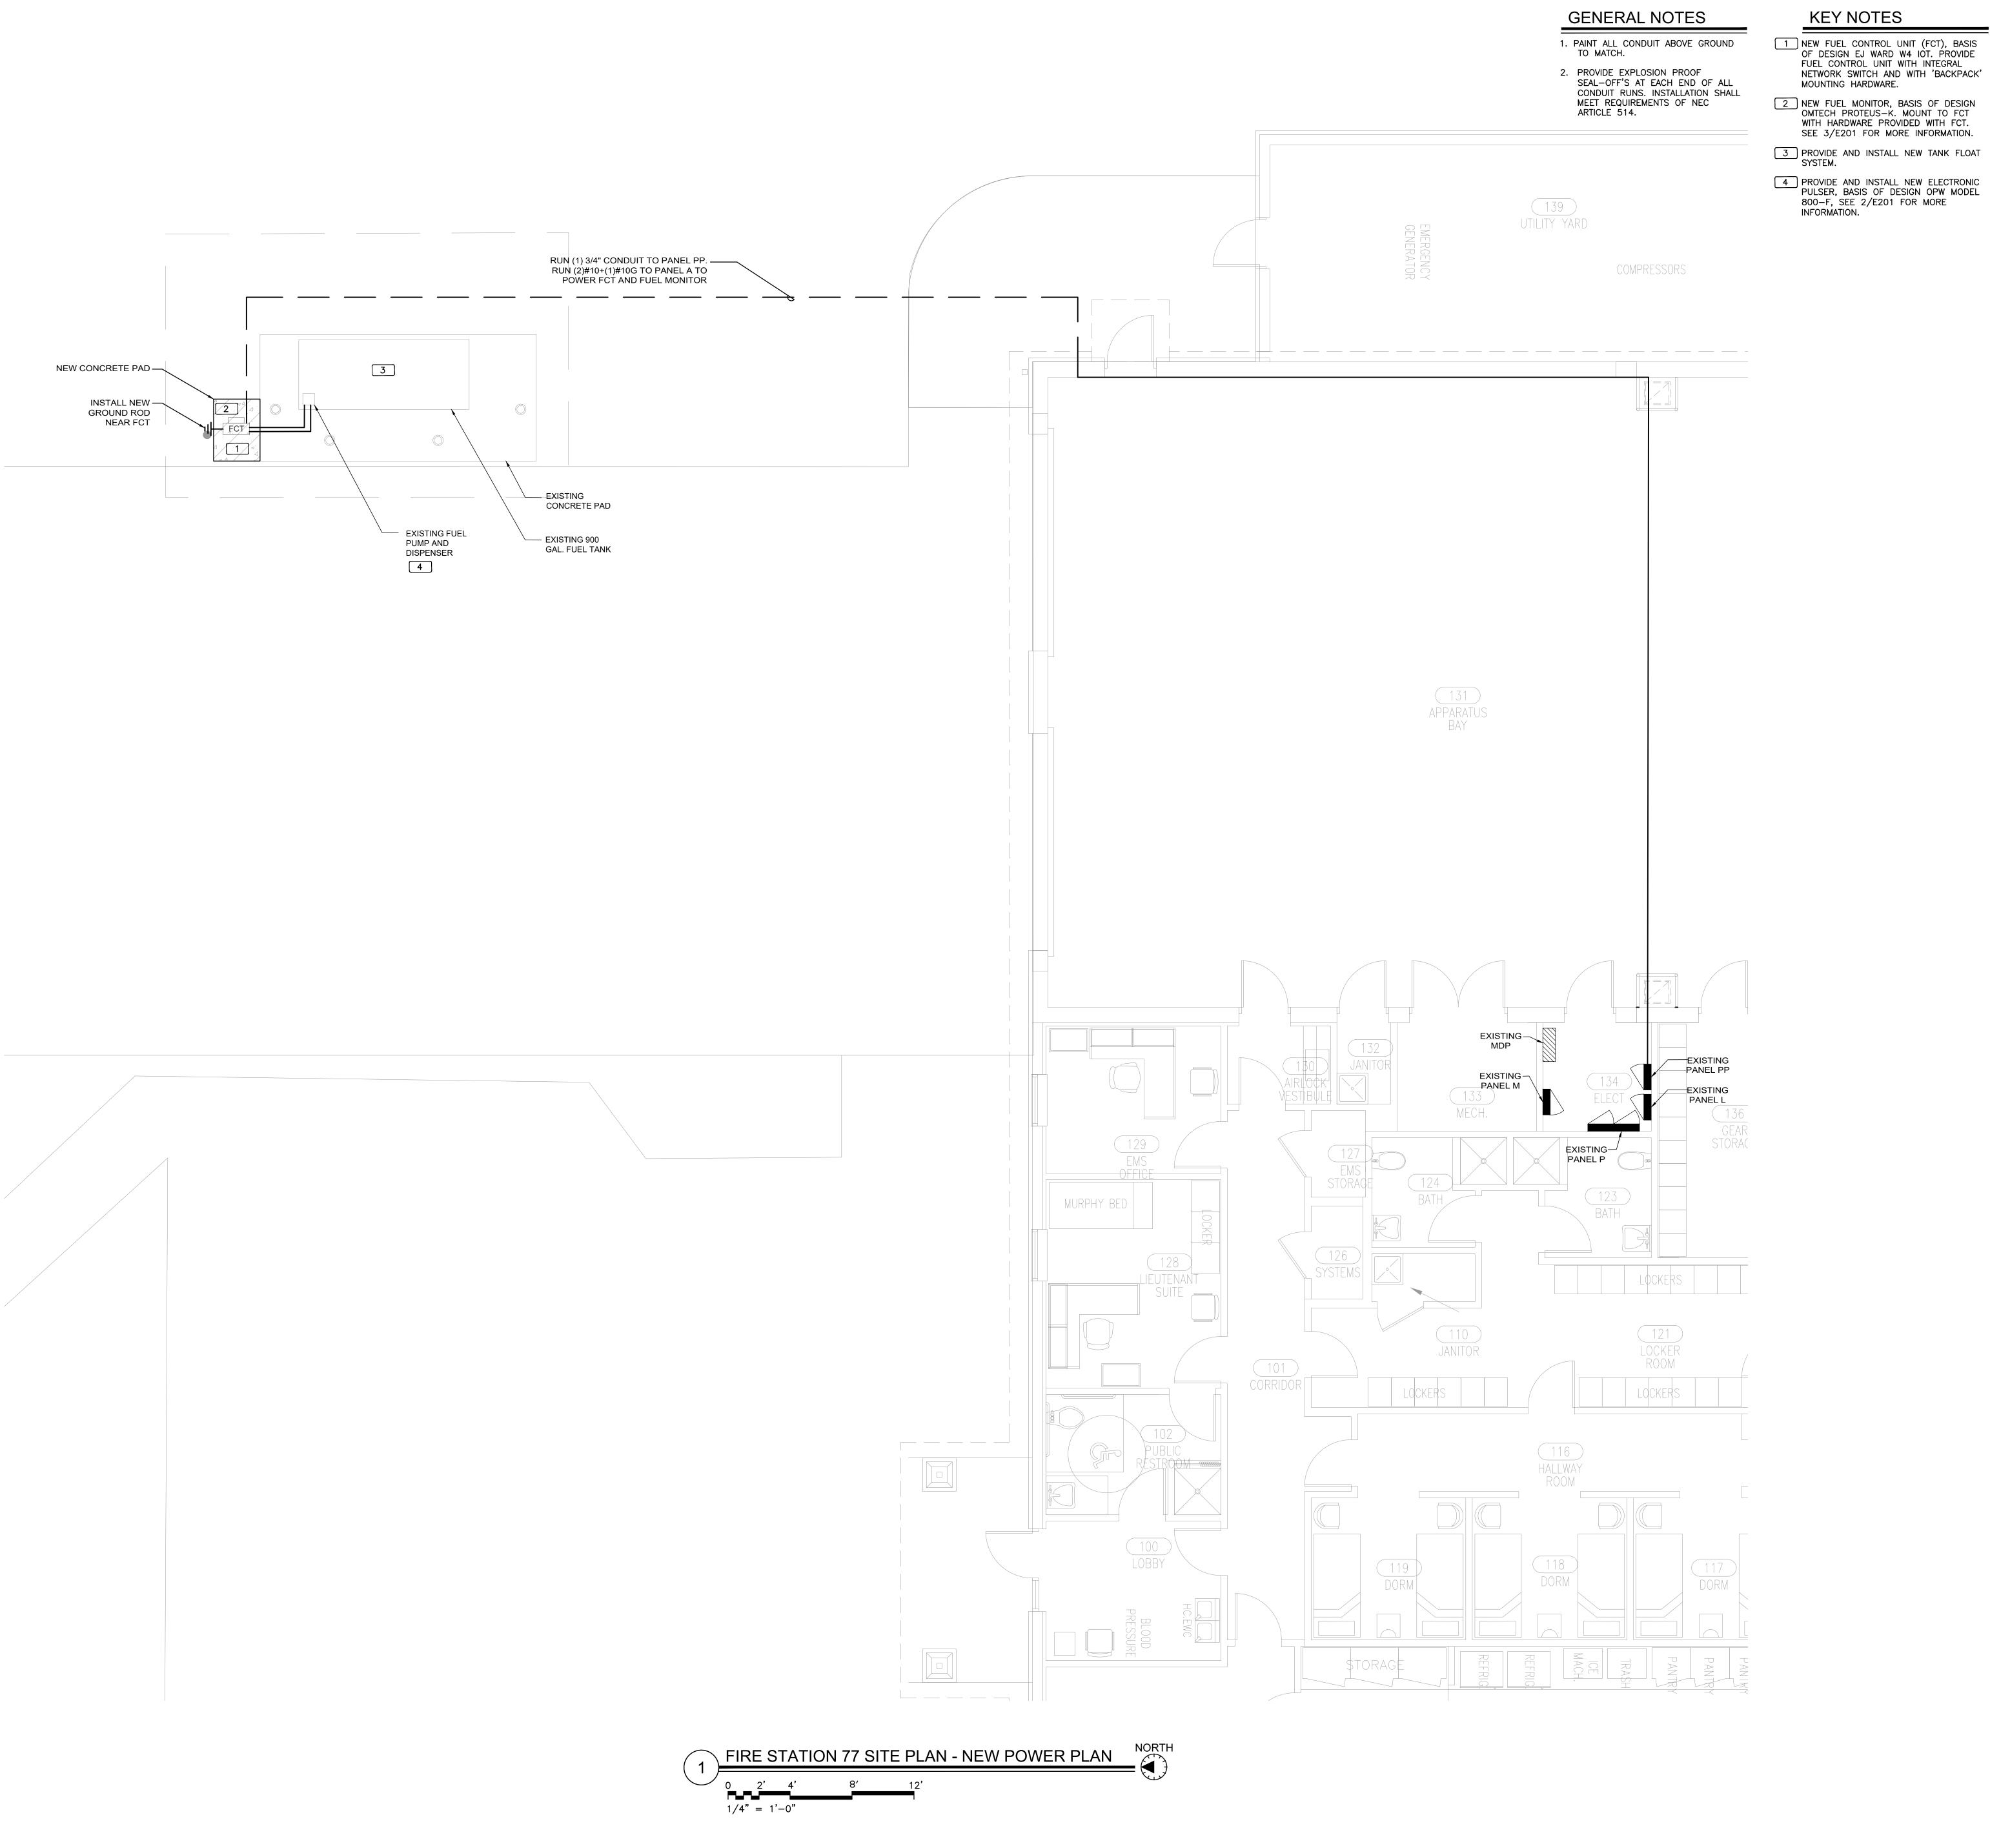

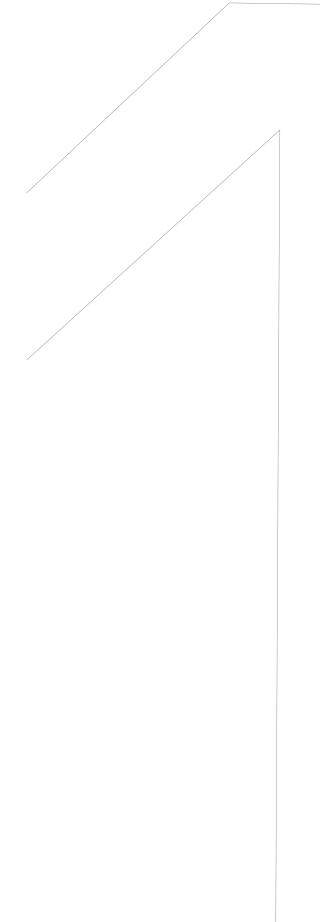

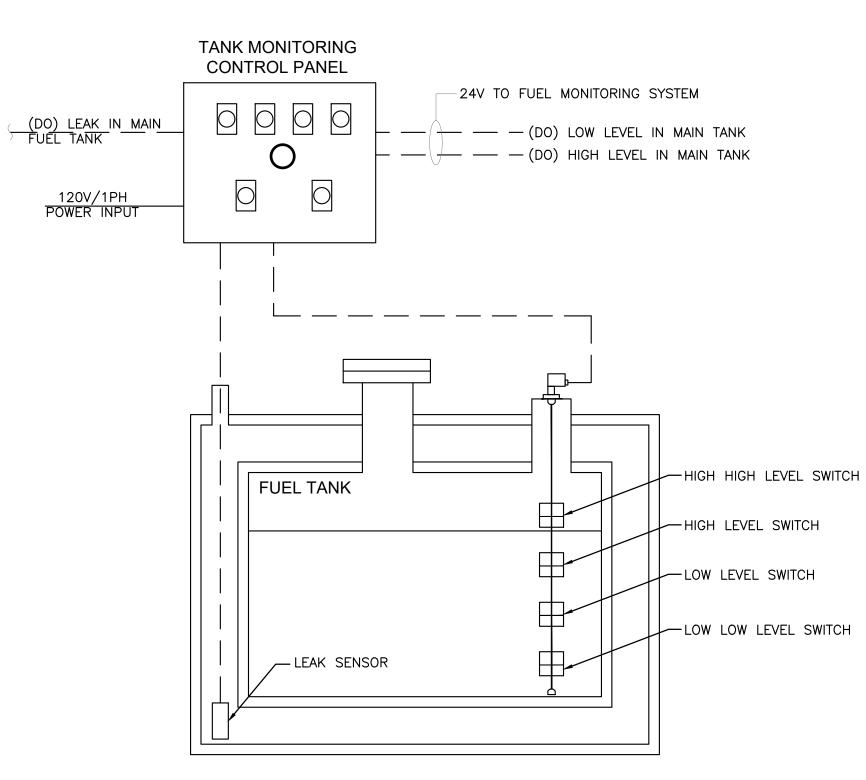

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INSTALLATION

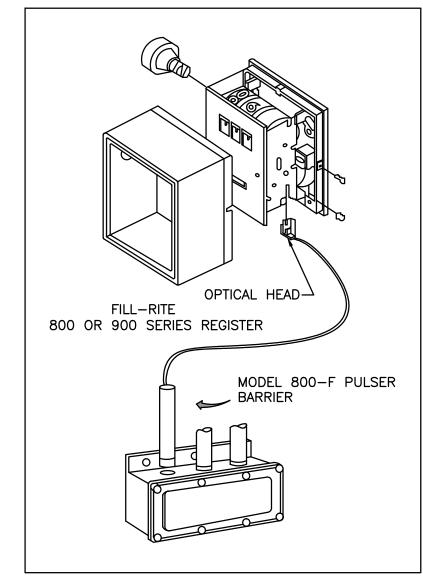- REMOVE THE RESET KNOB AND COVER FROM THE REGISTER. 2.
- (IF EQUIPPED) REMOVE THE NUUT AND WASHER FROM THE SHAFT ON THE LEFT SIDE OF THE REGISTER (LATER MODEL REGISTER ARE BUILT WITH A SMOOTH SHAFT). PLACE THE OPTICAL SUCH THAT IT STRADDLES THE PLASTIC GEAR ON THE END OF THE SHAFT AND THE BRACKET SLOT IN ON THE SHAFT SCREW. 3.
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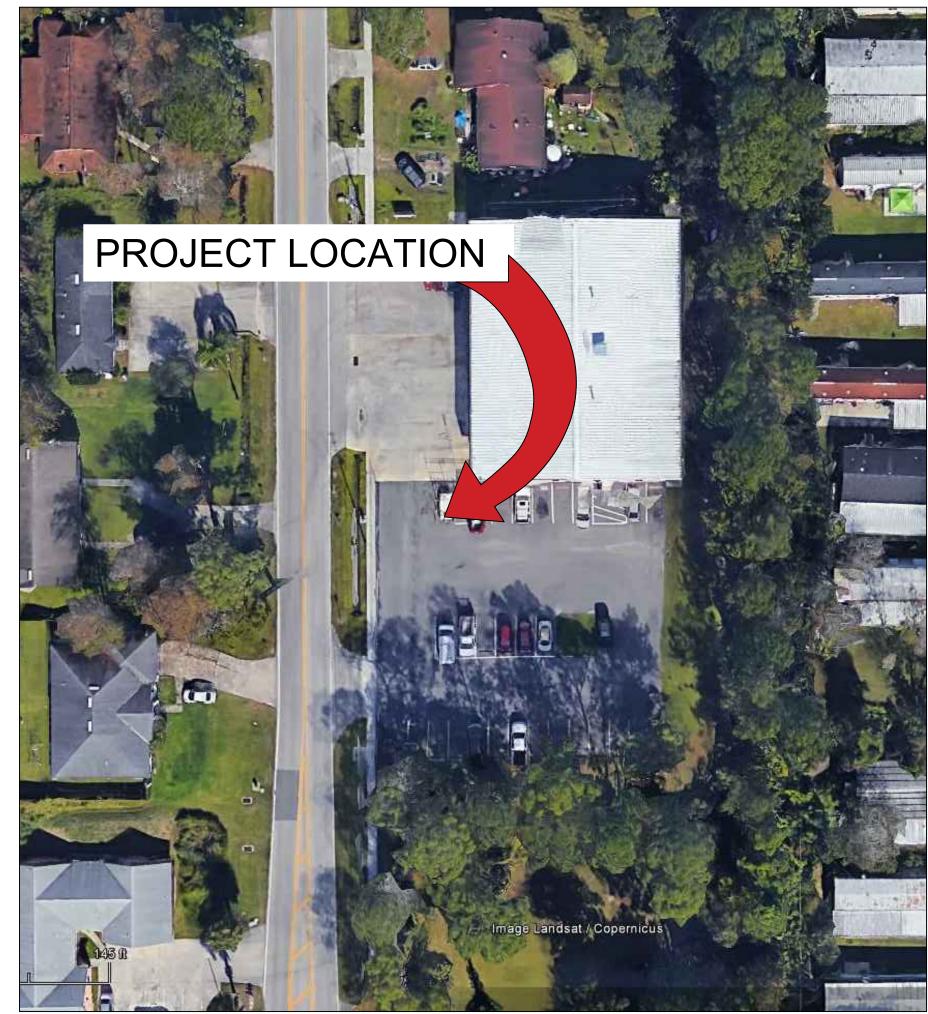
TELEPHONE 708-485-4200 FAX 708-485-7137



FUEL TANK MONITORING SCHEMATIC







GENERAL NOTES - CIVIL

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ALIGNMENT OF UTILITIES IS SHOWN TO INDICATE INTENT CONTRACTOR TO VISIT SITE TO FAMILIARIZE HIMSELF CONTRACTOR TO OBTAIN NECESSARY CONSTRUCTION

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12. CONTRACTOR TO SAW CUT CONCRETE AND ASPHALT PAVEMENT TO WIDTH AND DEPTH AS SHOWN ON DRAWINGS FOR LAYING UTILITIES LINES.

13. EXCESS EXCAVATED MATERIALS FROM TRENCHING AND/OR SAW CUTTING SHALL BE DISPOSED OFFSITE OR AS DIRECTED BY ORANGE COUNTY PROJECT MANAGER.


14. ALL EXISTING SODDED AREAS DISTURBED DURING CONSTRUCTION SHALL BE REPLACED WITH THE SAME TYPE OF SOD AT THE TIME OF JOB COMPLETION.

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Sheet No.:

	Demo an
Drawn By: V.G.	Checked By:
16.OC.043	
Project Number:	

Date Description

Revisions:

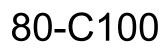Date:

11.23.2018

Issuance: Permit Documents

Location: Fire Station 80 1841 N BONNEVILLE RD, ORLANDO, FL 32826

Project: OC FIRE RESCUE FUEL TANK AUTOMATION AND REPLACEMENT DESIGN


EOR Stamp:


Consultants:


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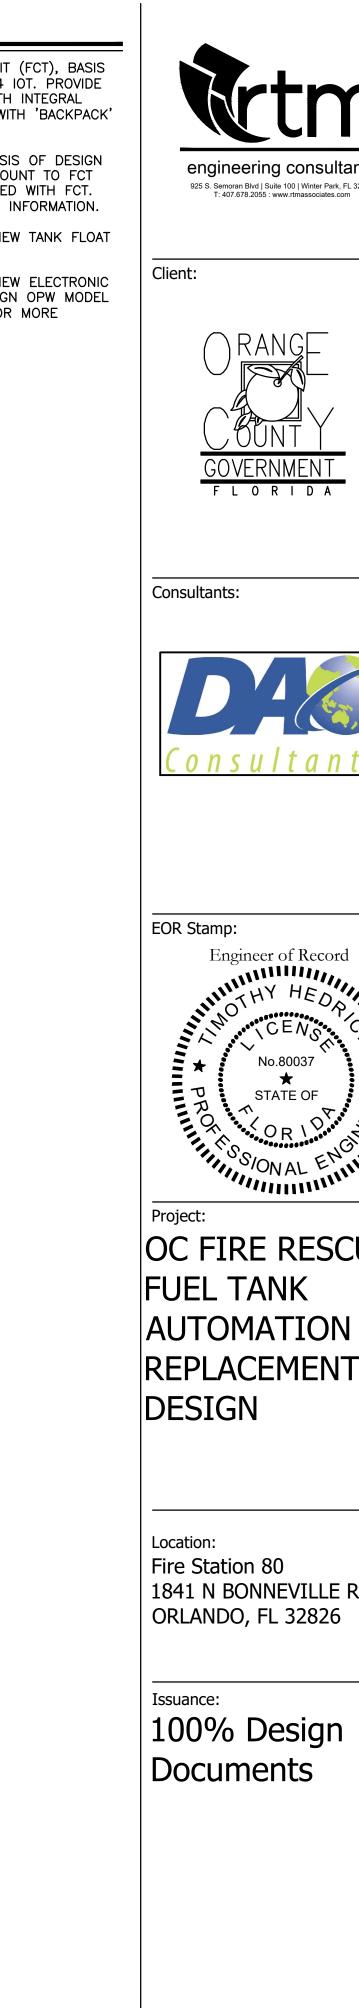
OVERNMEN FLORIDA

ngineering consultants 925 S. Semoran Blvd | Suite 100 | Winter Park, FL 32792 T: 407.678.2055 : www.rtmassociates.com



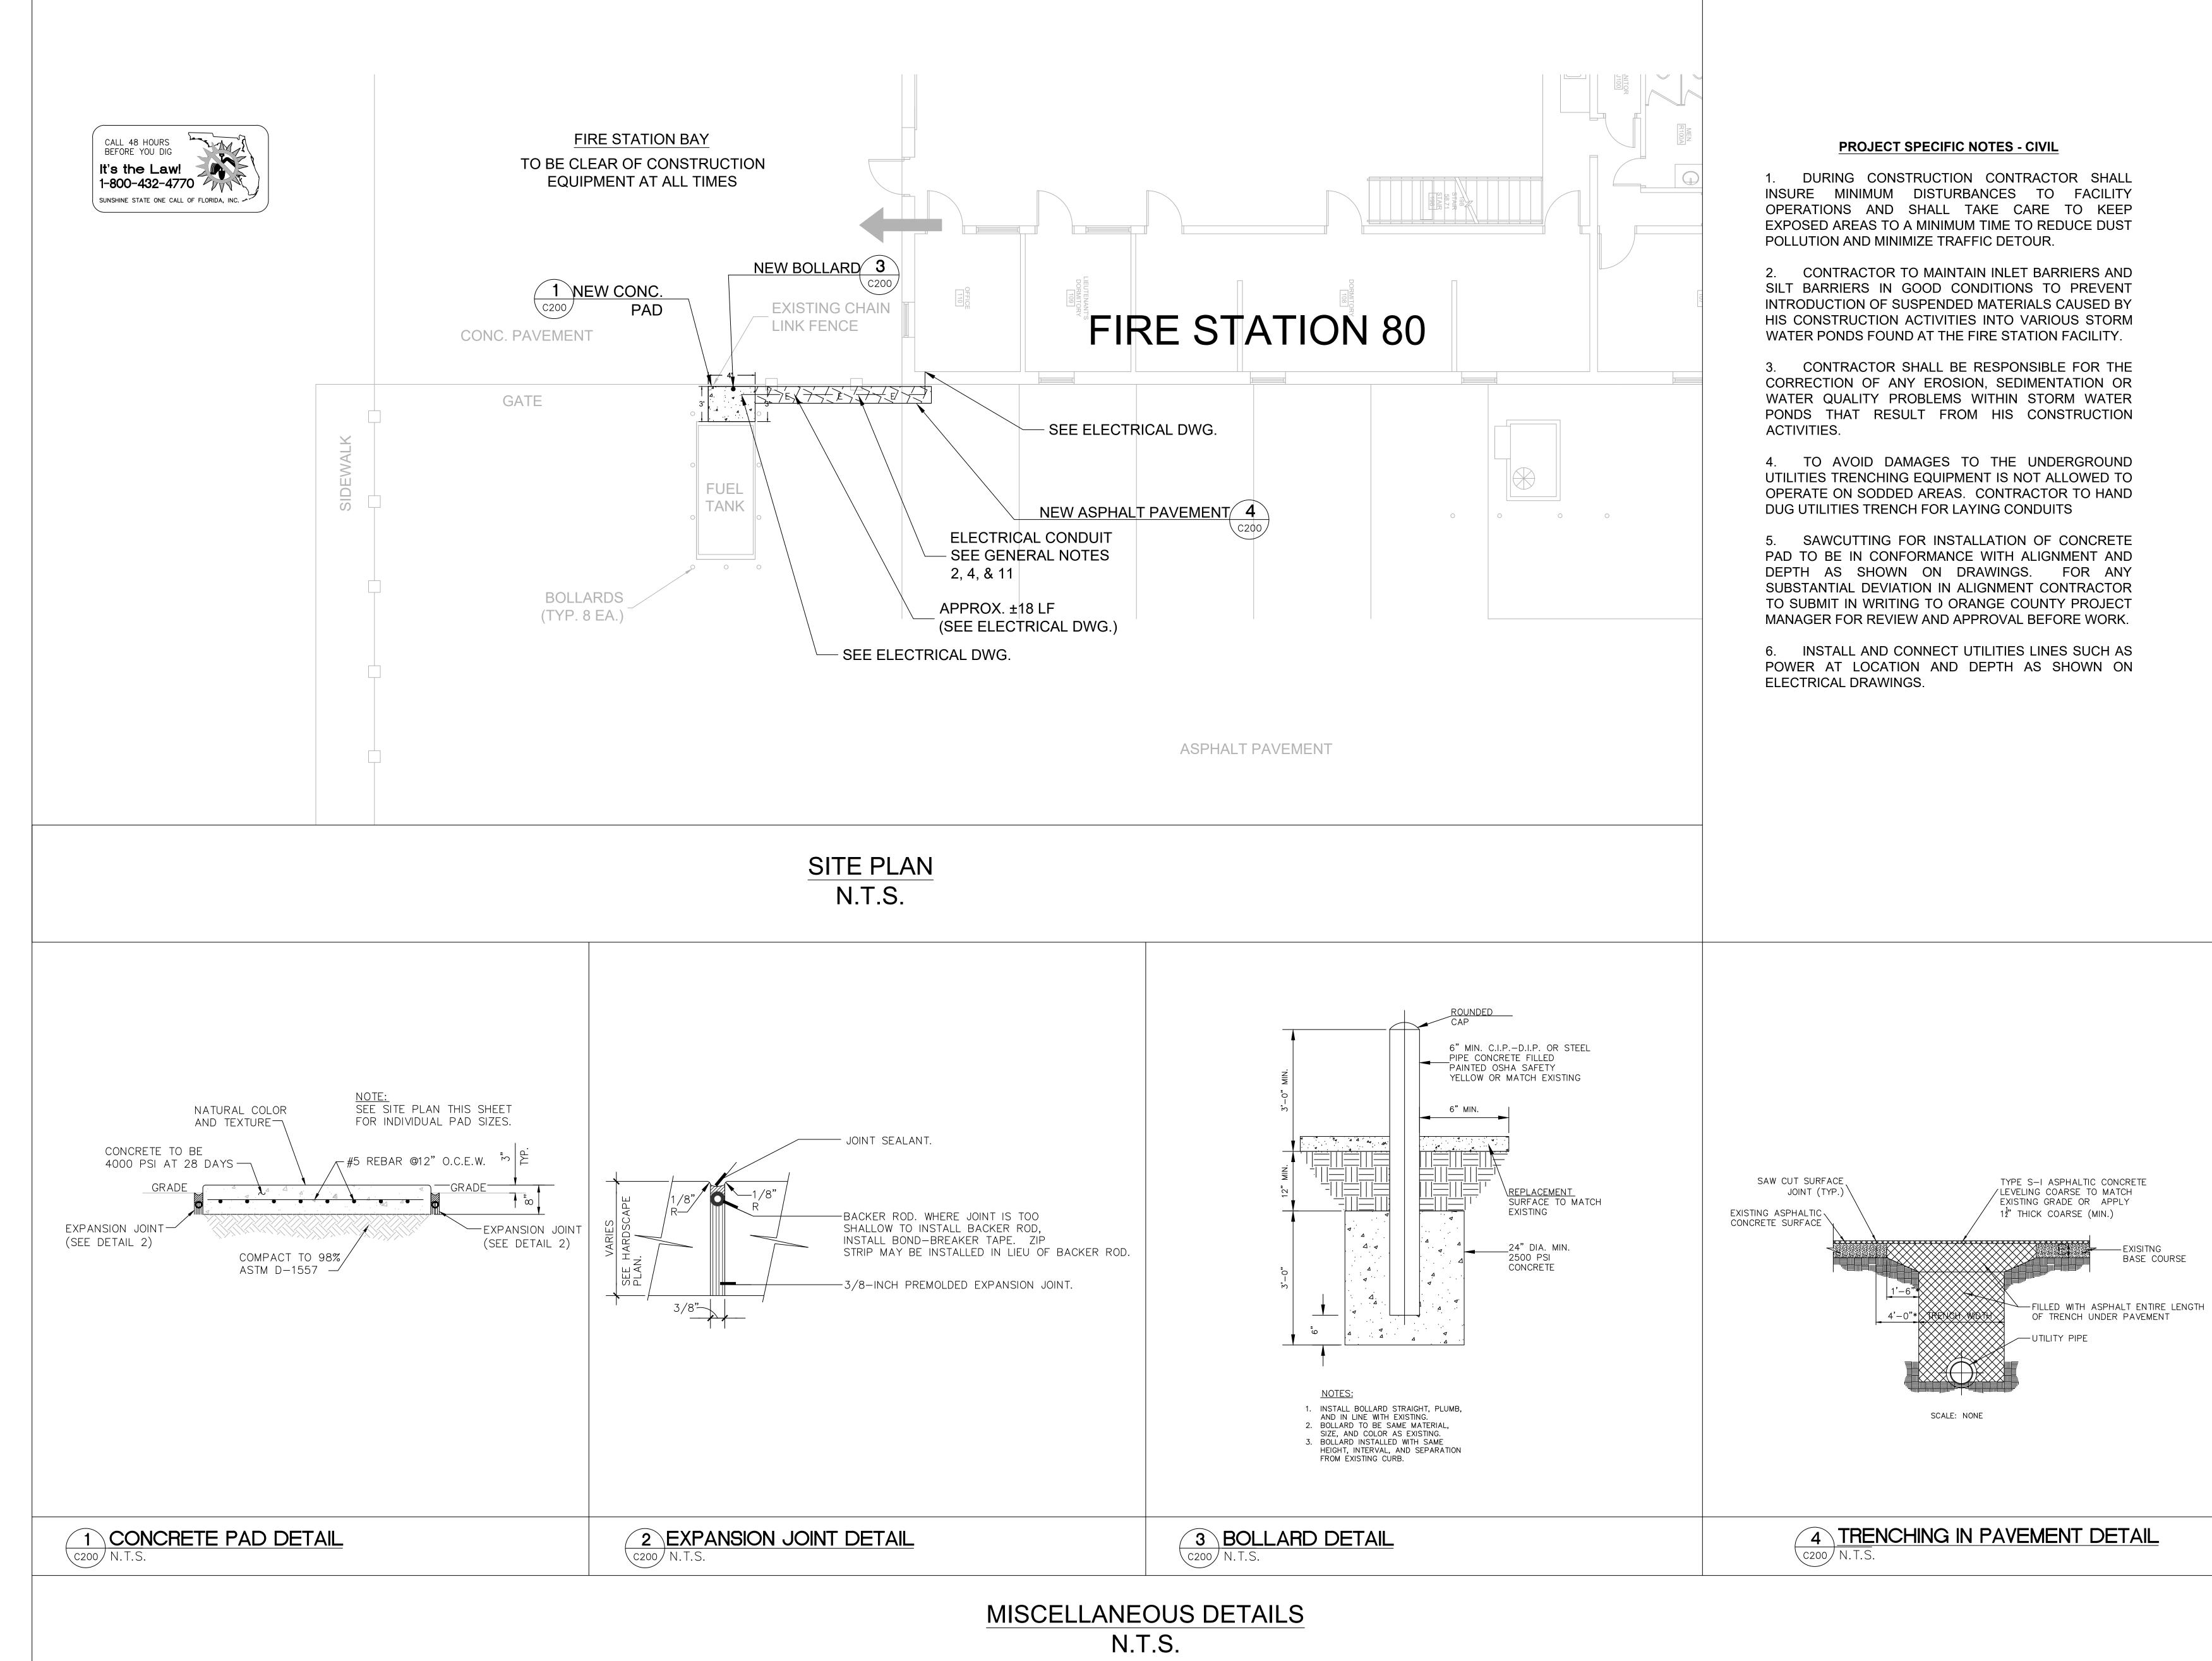

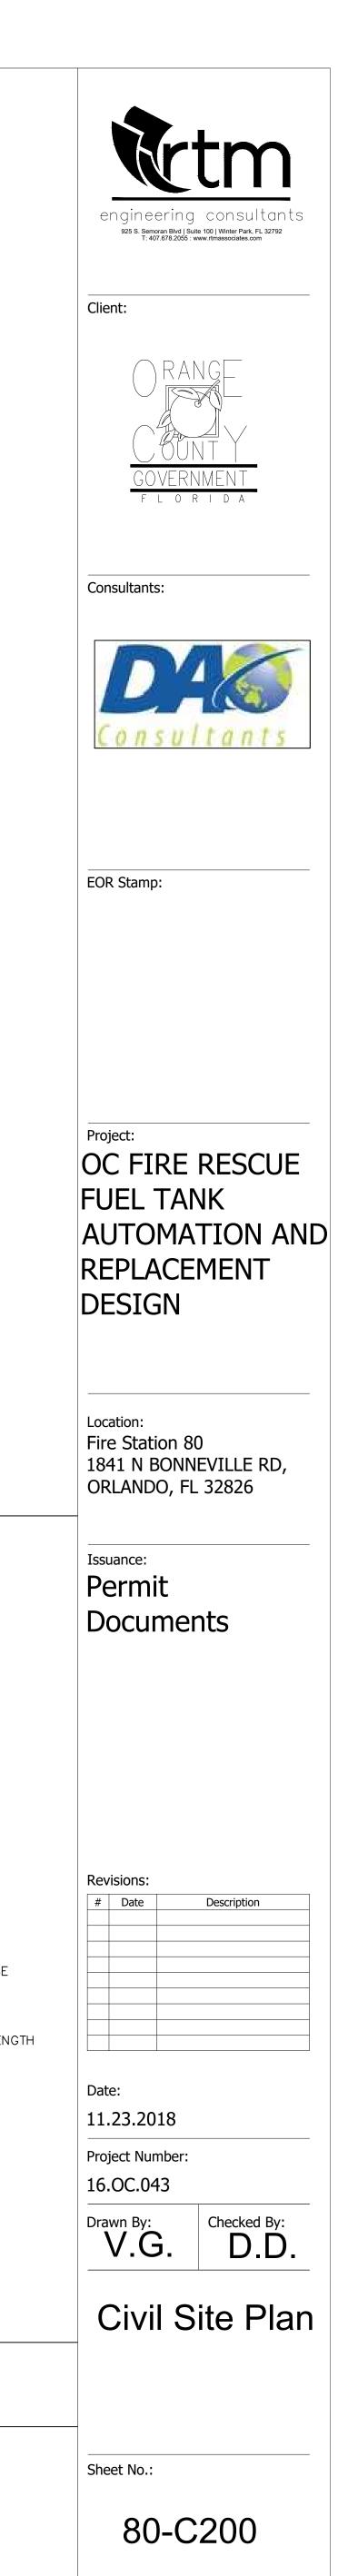

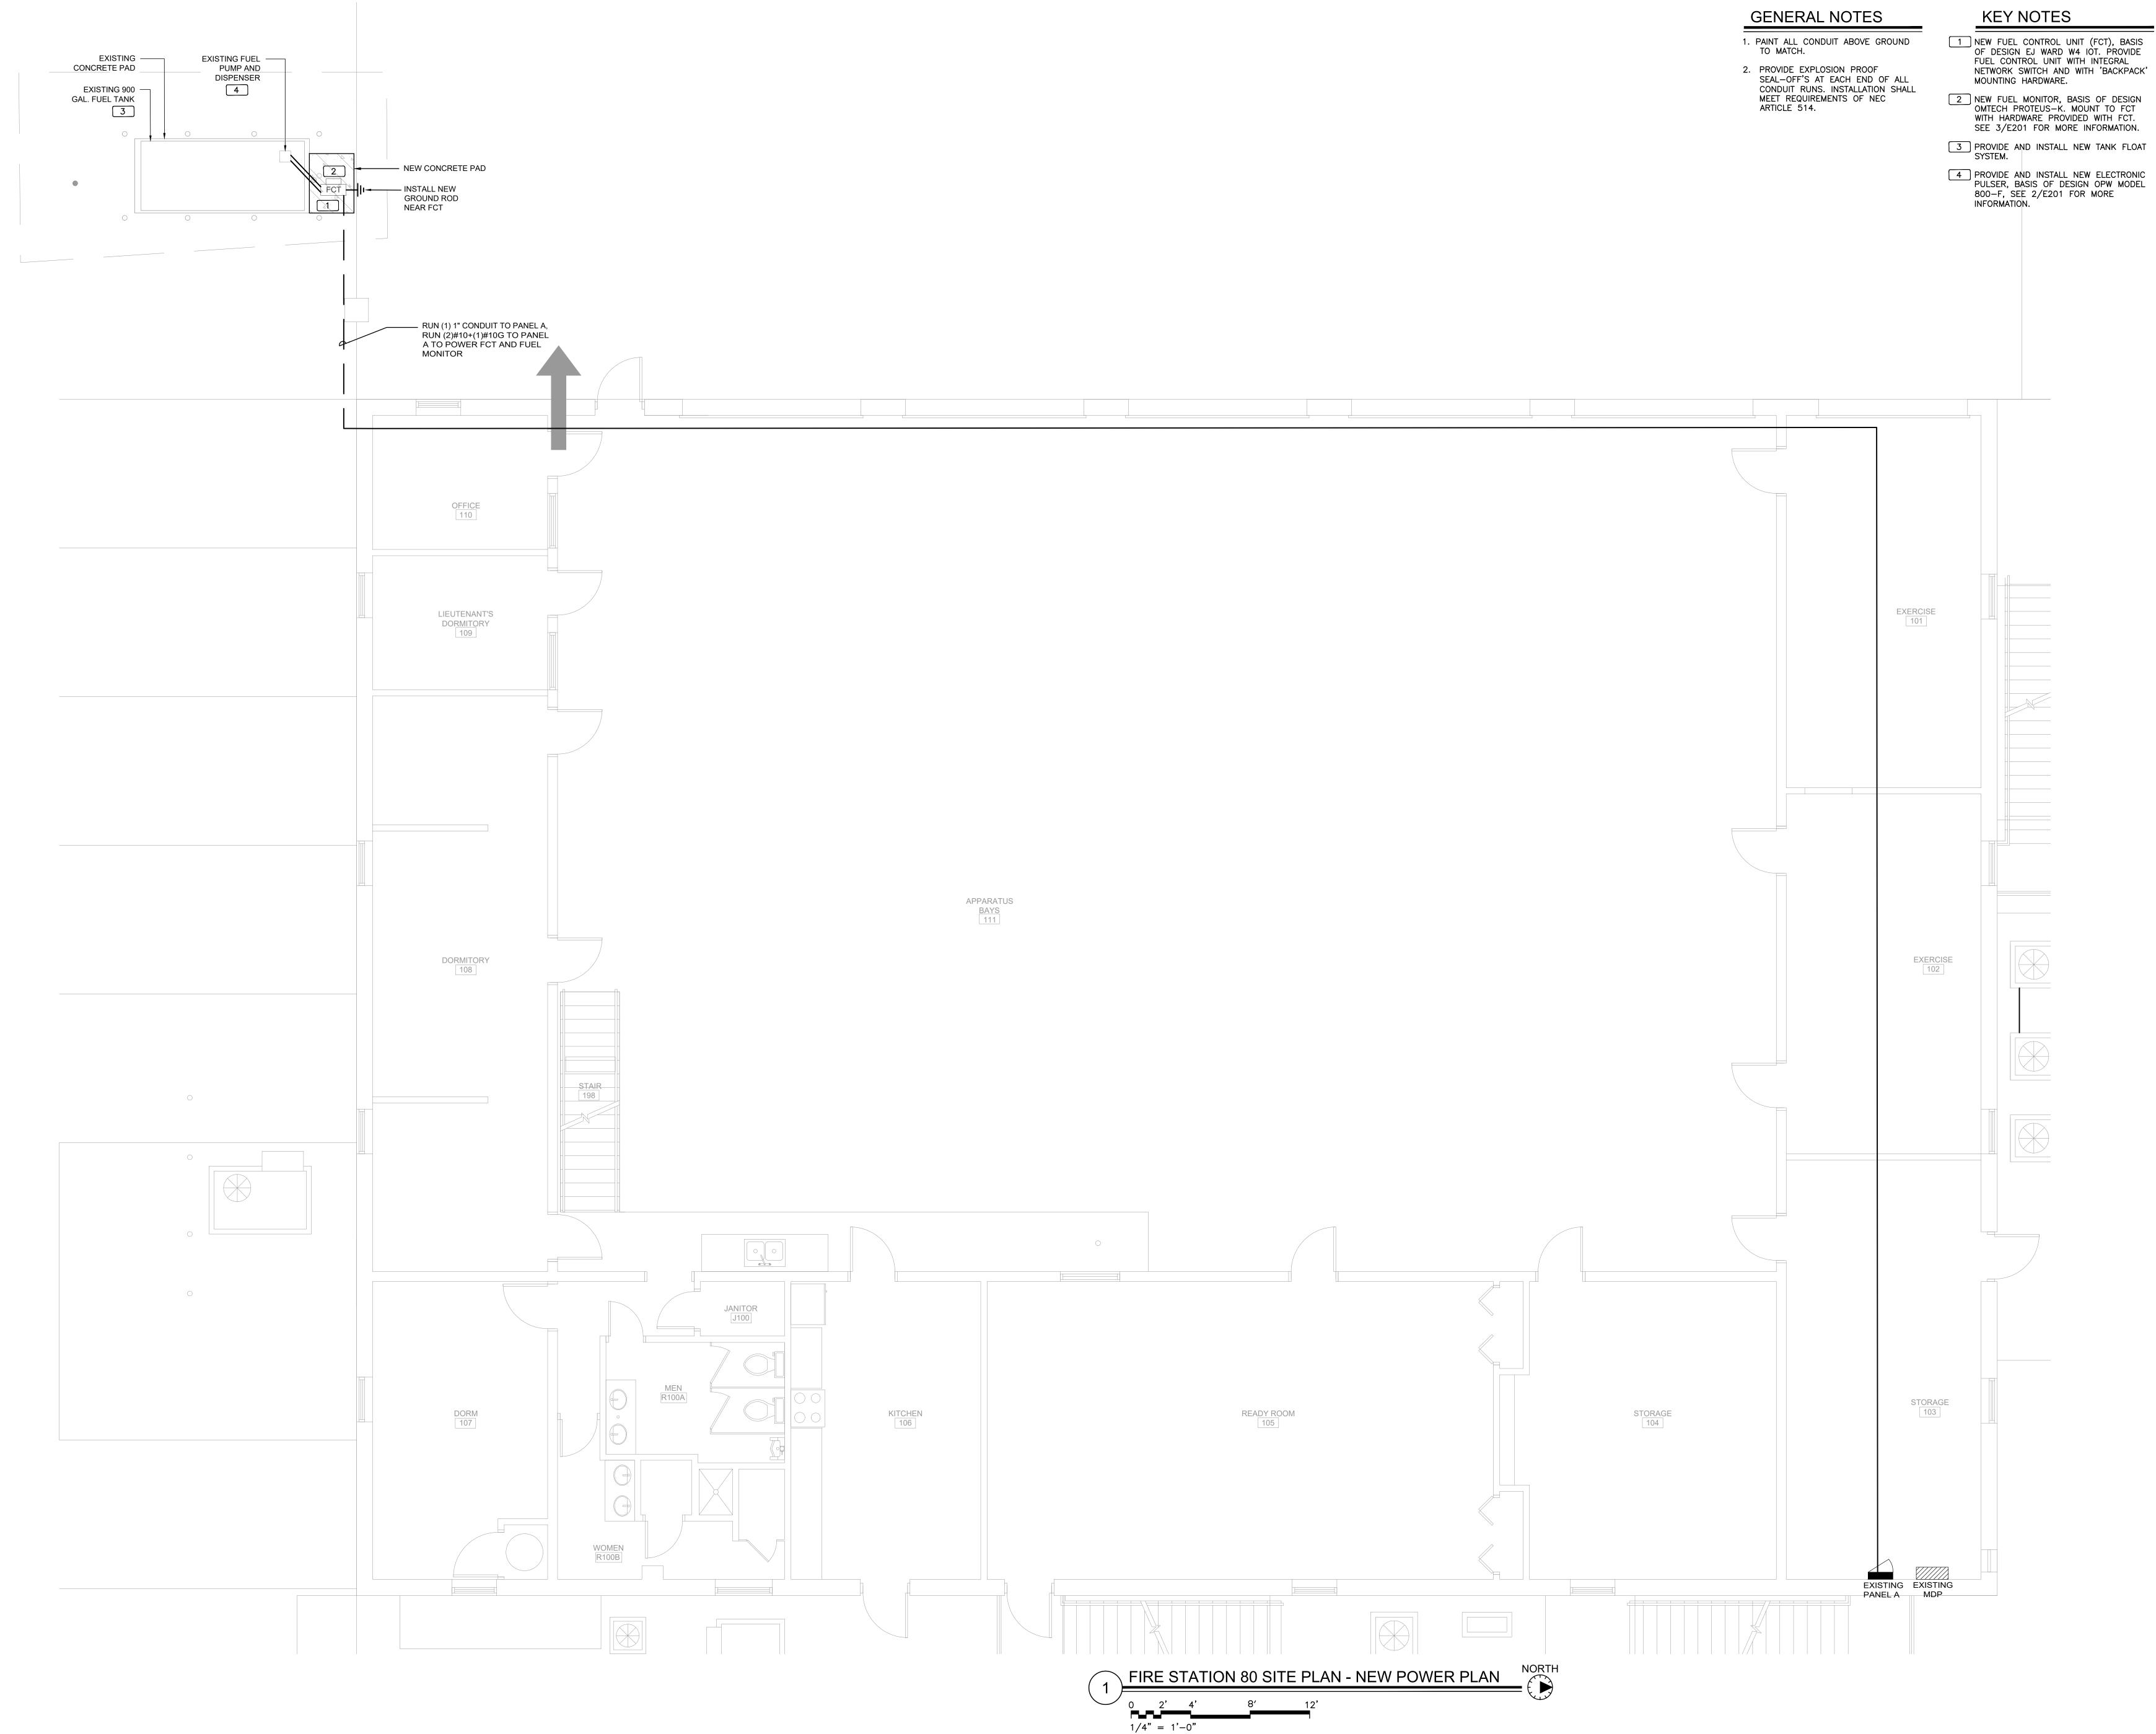



No.80037 \star : * STATE OF OC FIRE RESCUE FUEL TANK AUTOMATION AND REPLACEMENT DESIGN

Location: Fire Station 80 1841 N BONNEVILLE RD, ORLANDO, FL 32826

100% Design Documents

Revisions: # Date Description

Project Number: 16.OC.043

Drawn By:

Sheet No.:

MF

Date: 11.23.2018


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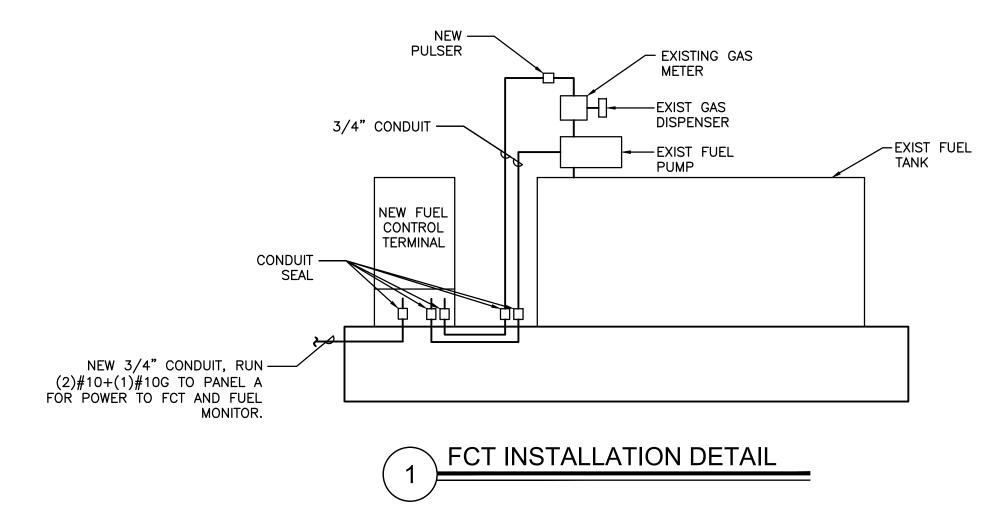
ELECTRICAL


POWER PLAN

80-E101



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INSTALLATION
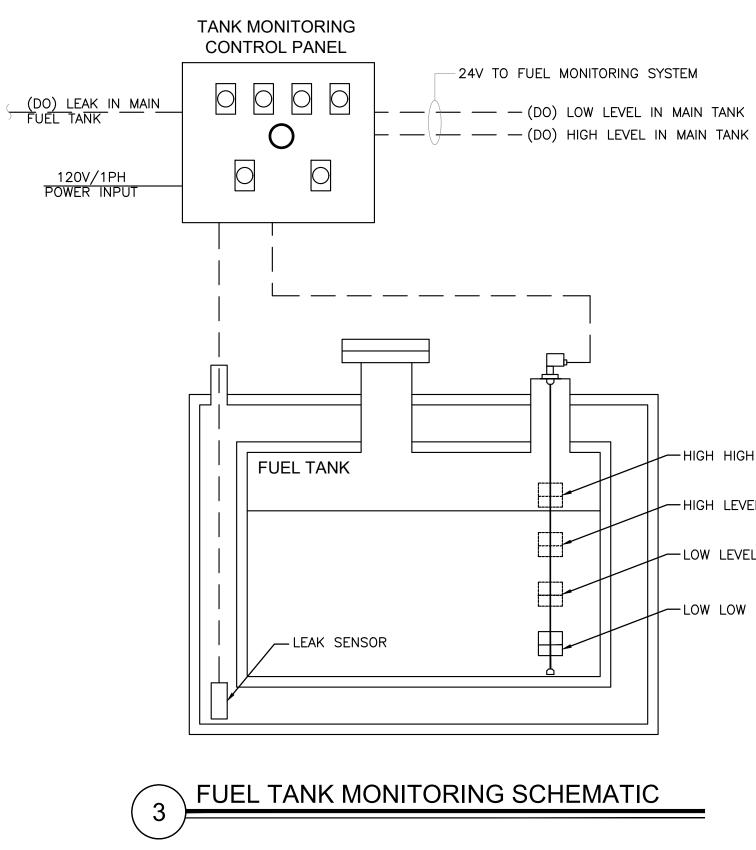
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APPLICATION.

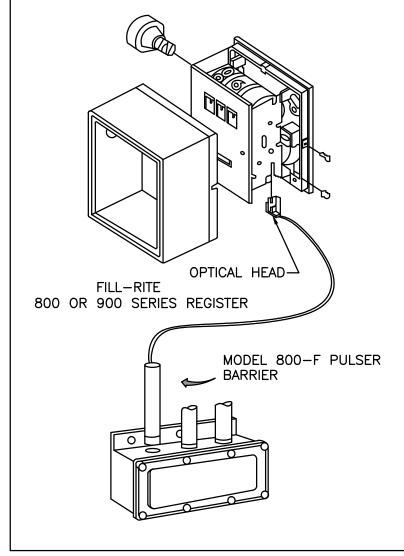2 PULSER INSTALLATION DETAIL


TELEPHONE 708-485-4200 FAX 708-485-7137


HIGH HIGH LEVEL SWITCH

-HIGH LEVEL SWITCH

-LOW LEVEL SWITCH

LOW LOW LEVEL SWITCH

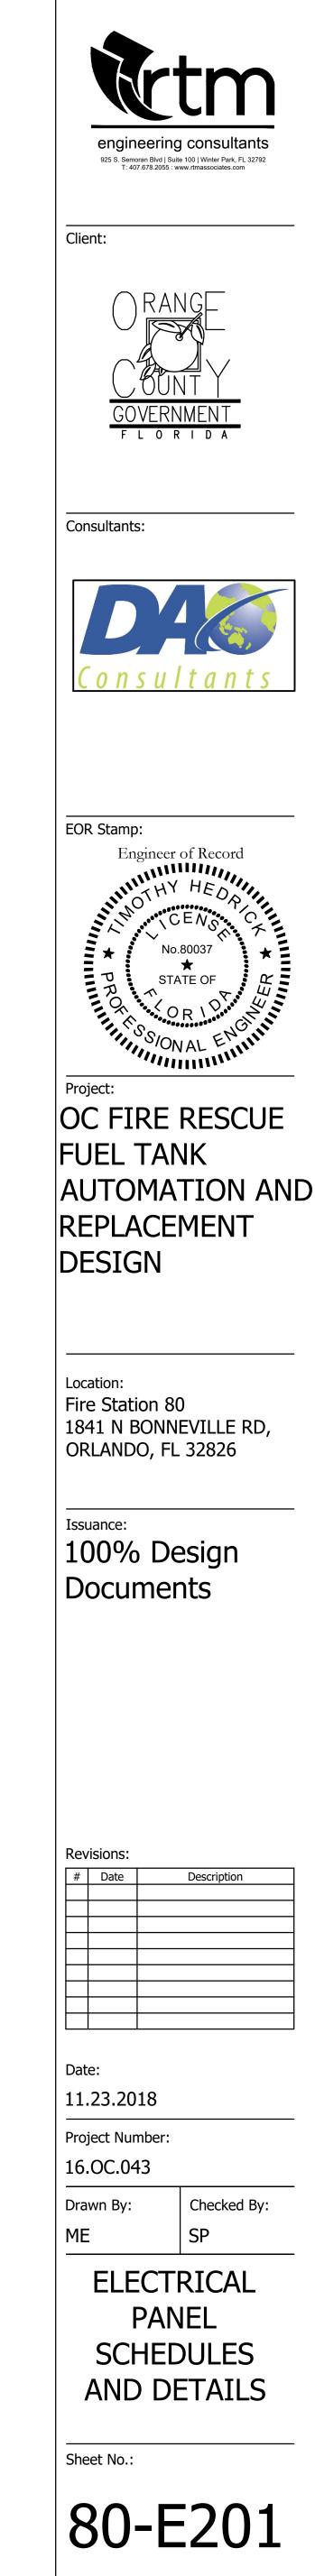

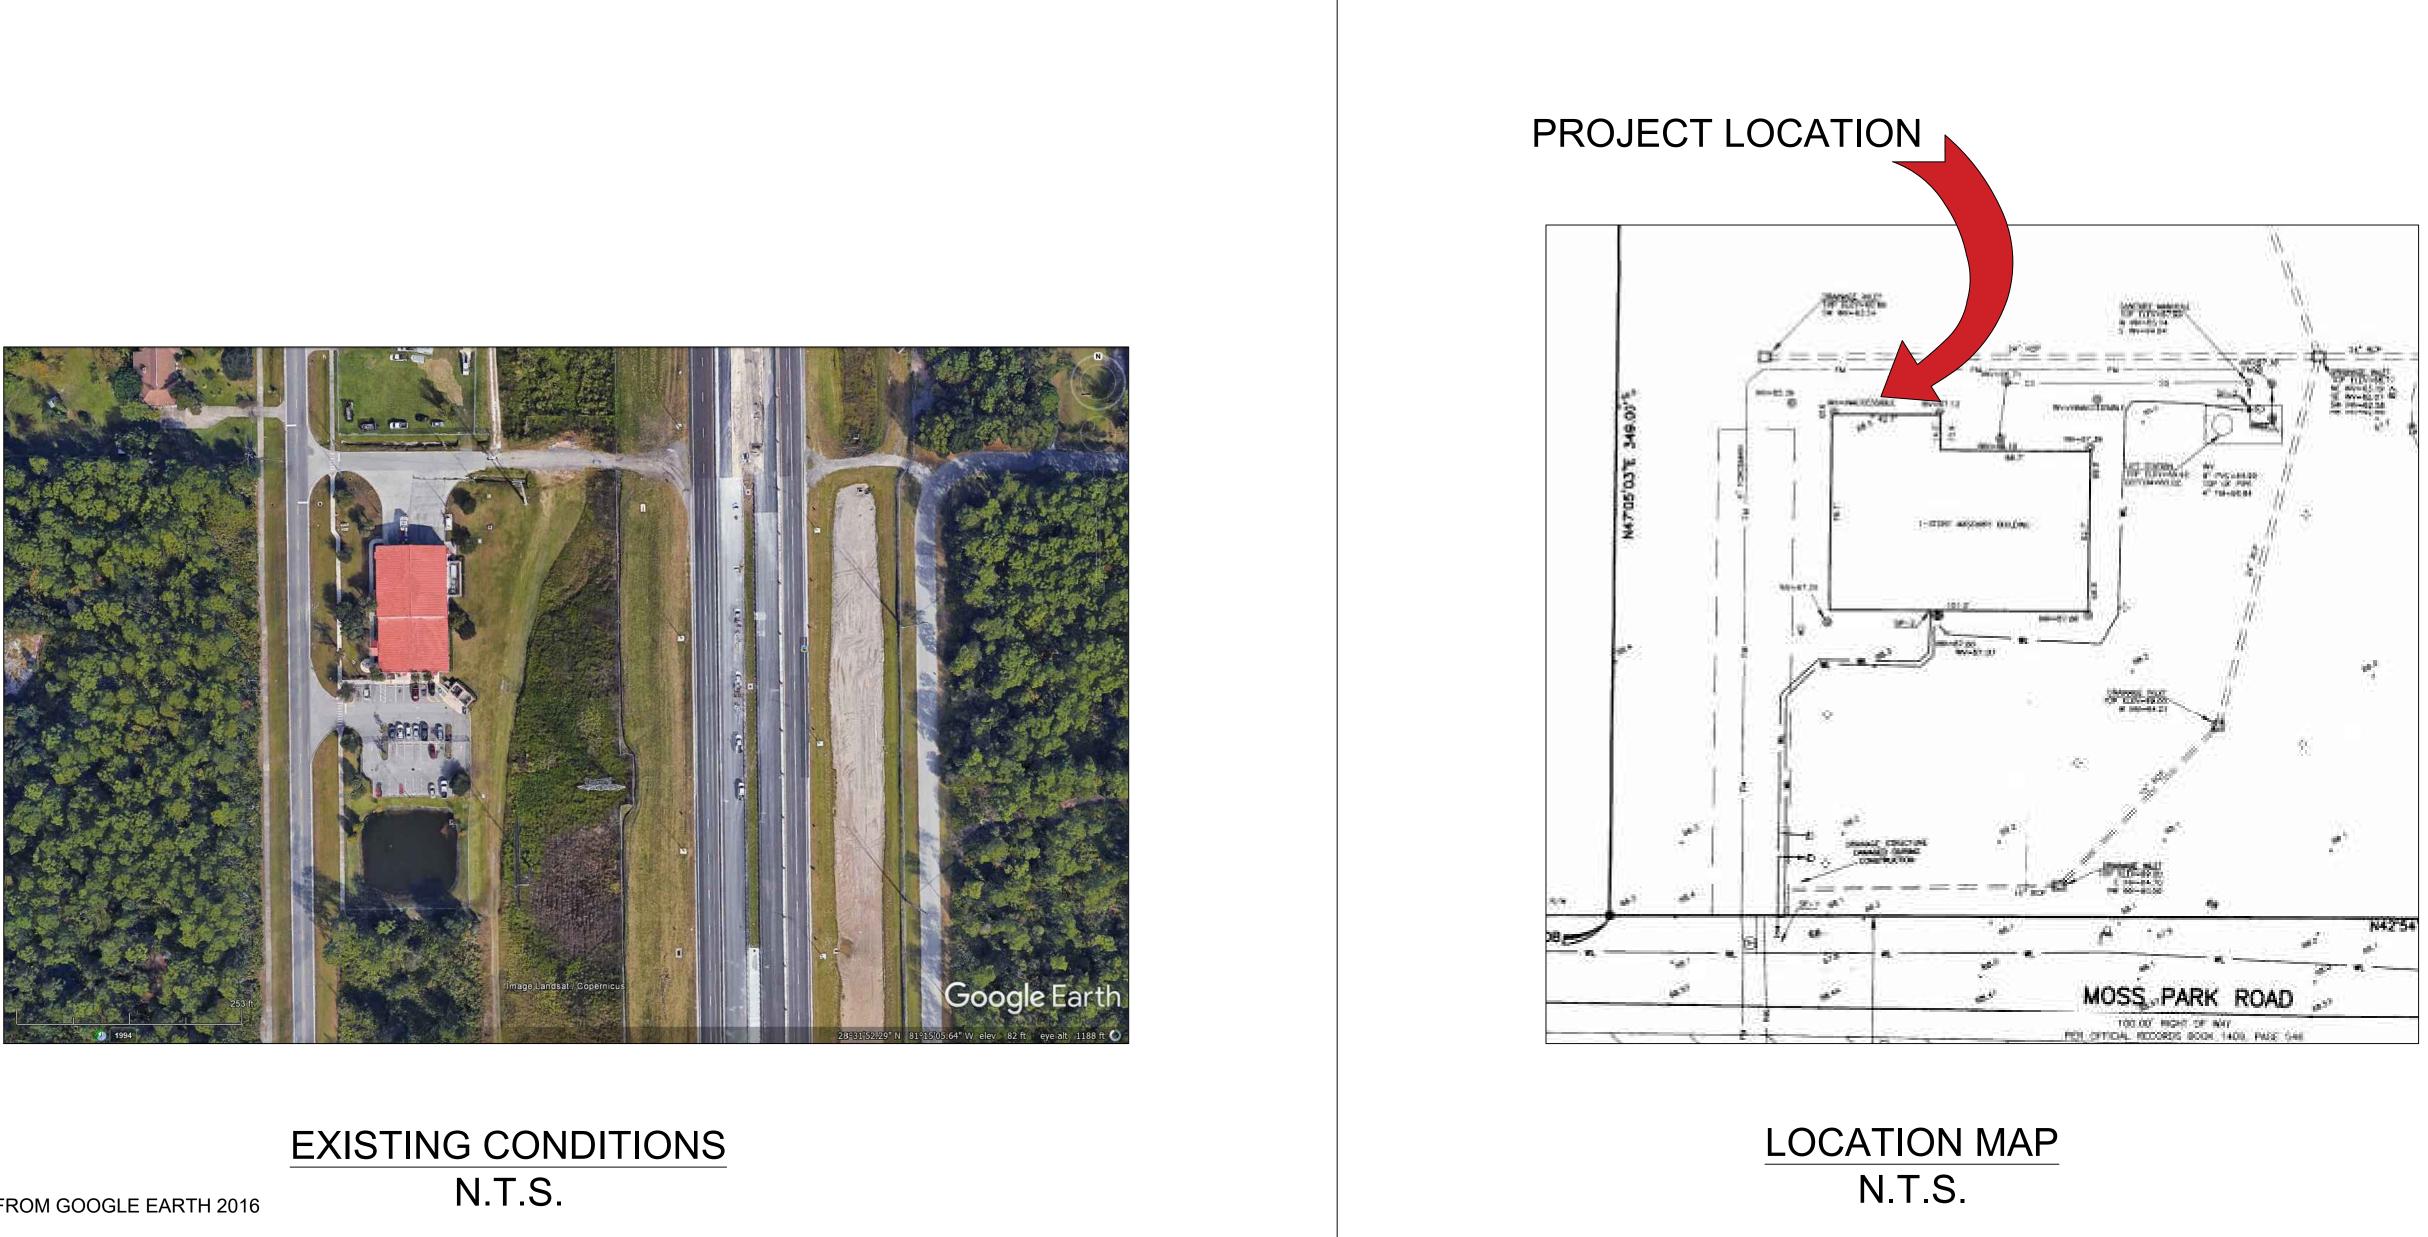


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EXISTING BOLLARDS

PAVED CONCRETE



GRASS AREA

GENERAL NOTES - CIVIL

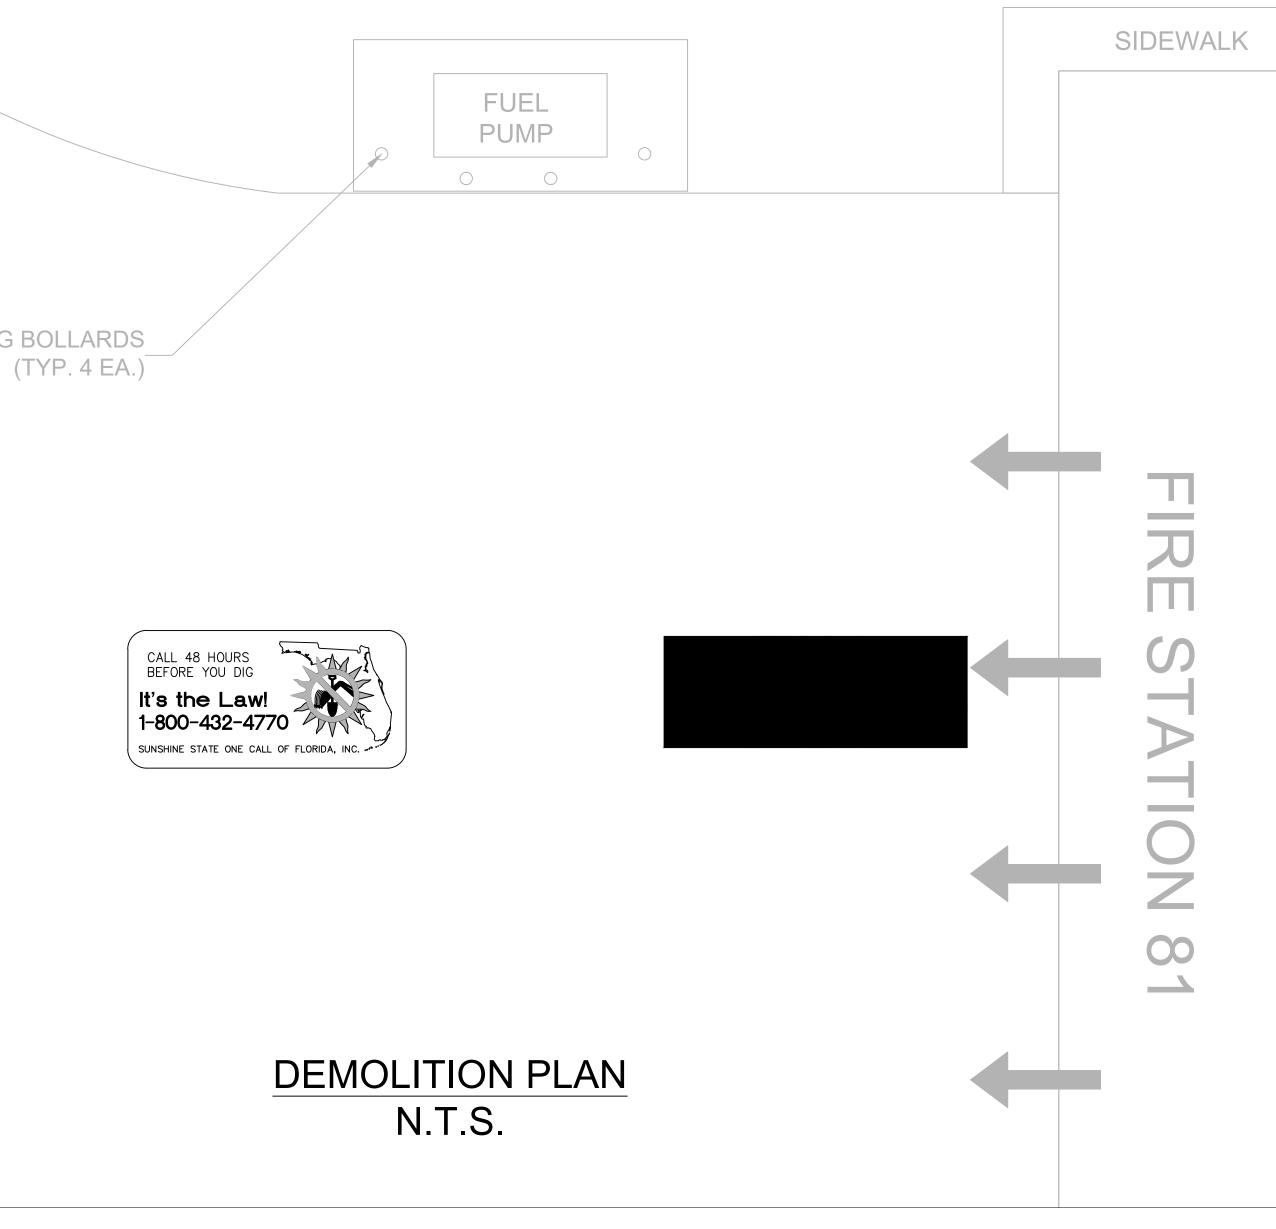1. THIS PROJECT IS LOCATED WITHIN THE ORANGE COUNTY FIRE RESCUE STATION. TO WORK WITHIN THIS FIRE STATION CONTRACTOR HAS TO OBSERVE, FOLLOW AND ABIDE THOROUGHLY, METICULOUSLY AND STRICTLY TO EACH AND EVERY SECURITY RULES AND REGULATIONS CONCERNING SUCH AS BUT NOT LIMITED TO WORKERS WORKING HOURS, INGRESS AND EGRESS POINTS FOR CONTRACTOR PERSONNEL, VEHICLE AND EQUIPMENT.

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3. ORANGE COUNTY PROJECT MANAGER AND ENGINEER DO NOT ASSUME RESPONSIBILITY FOR ACCURACY OF LOCATION AND/OR DEPTH OF ABOVE GROUND UTILITIES.

4. ALIGNMENT OF UTILITIES IS SHOWN TO INDICATE INTENT OF ENGINEER TO CONNECT THESE LINES BETWEEN UTILITIES FOUND.

5. CONTRACTOR TO VISIT SITE TO FAMILIARIZE HIMSELF WITH EXISTING FIELD CONDITIONS AND LOCATIONS OF EXISTING UTILITIES AS SHOWN ON DRAWINGS. CONTRACTOR TO IMMEDIATELY NOTIFY ORANGE COUNTY PROJECT MANAGER IN WRITING ANY DISCREPANCY OBSERVED FOR PROPER CLARIFICATION.

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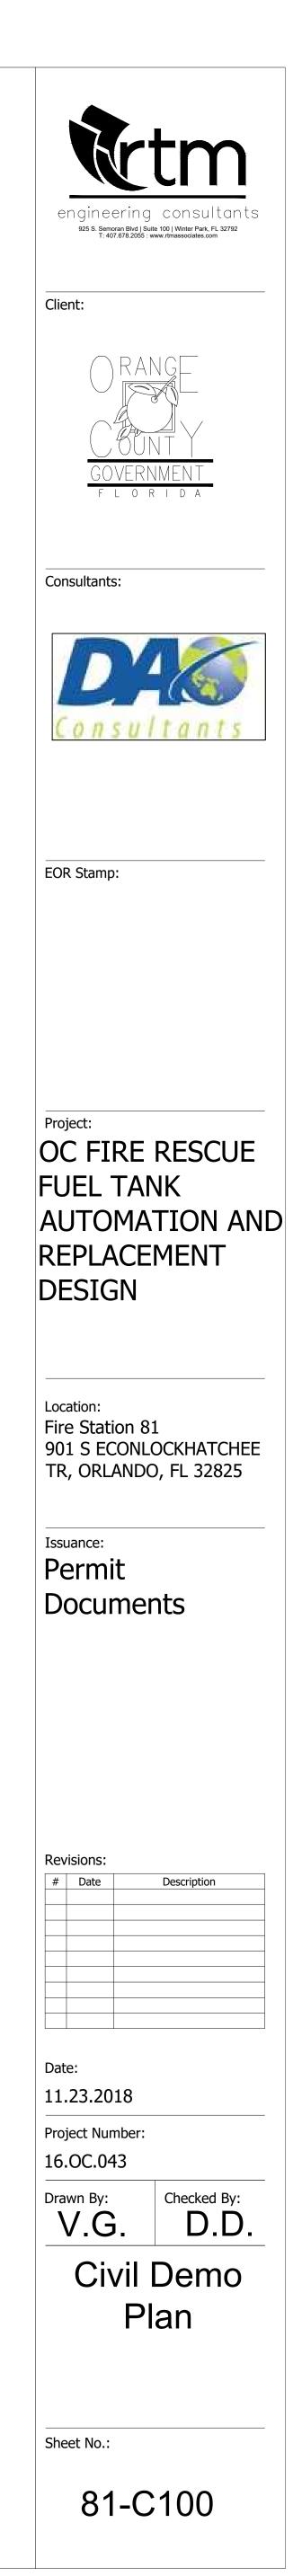
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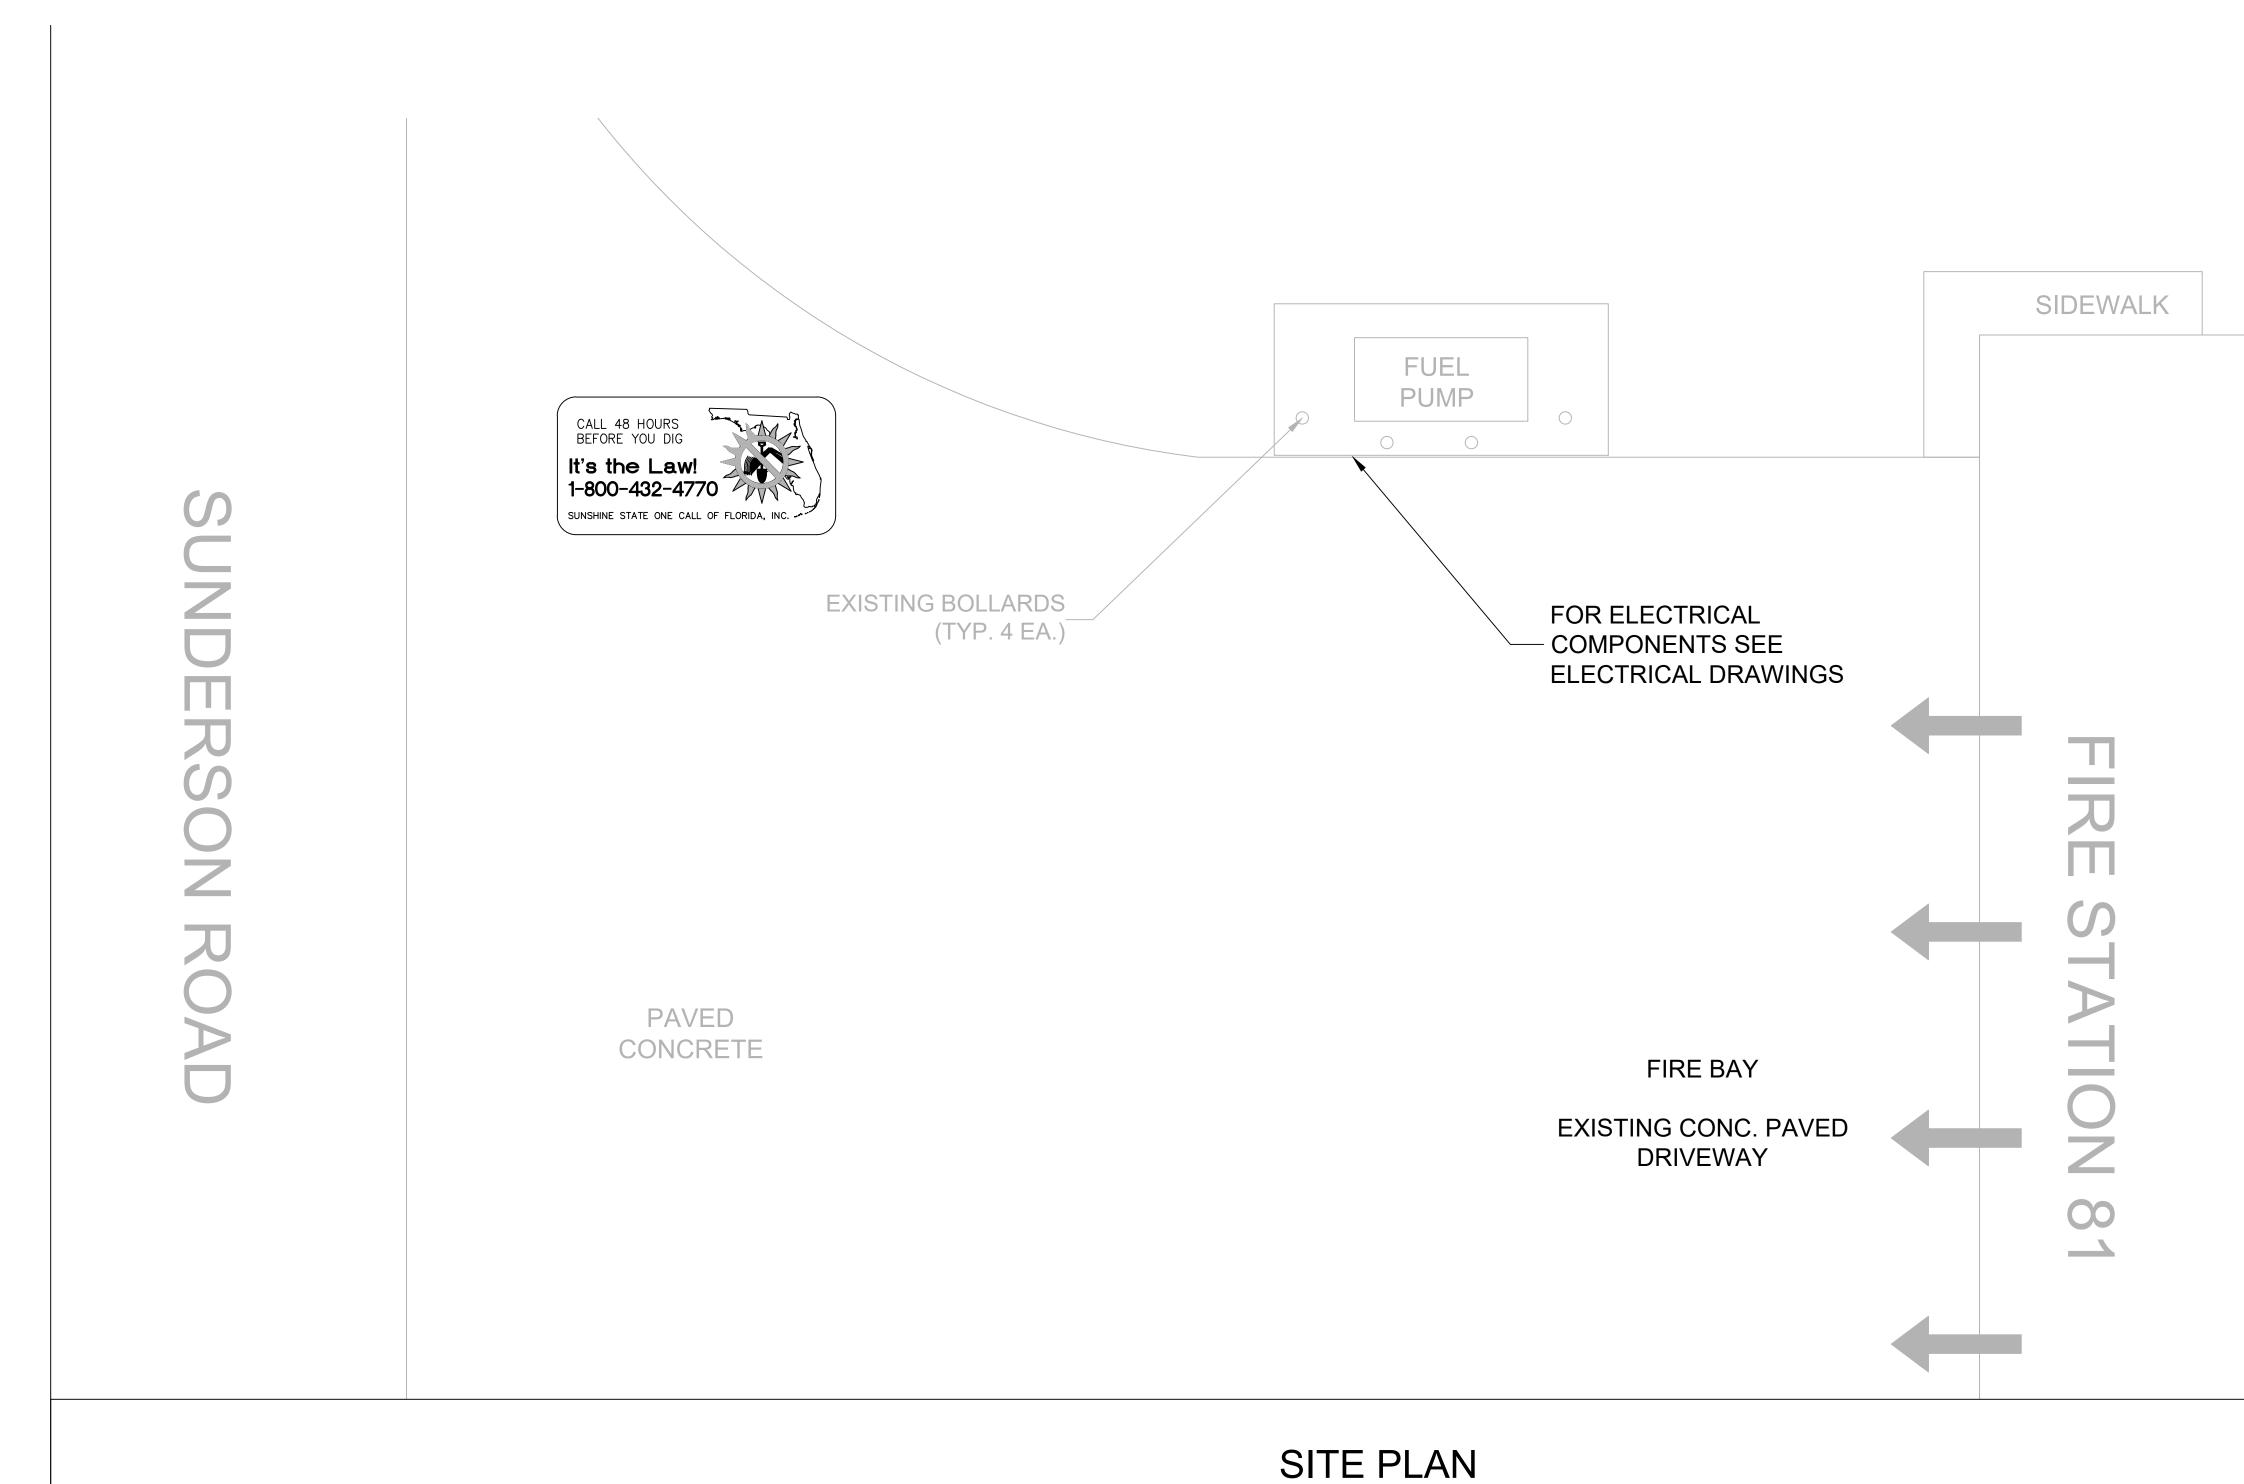
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N.T.S.

GRASS AREA

PROJECT SPECIFIC NOTES - CIVIL

1. DURING CONSTRUCTION CONTRACTOR SHALL INSURE MINIMUM DISTURBANCES TO FACILITY OPERATIONS AND SHALL TAKE CARE TO KEEP EXPOSED AREAS TO A MINIMUM TIME TO REDUCE DUST POLLUTION AND MINIMIZE TRAFFIC DETOUR.


2. CONTRACTOR TO MAINTAIN INLET BARRIERS AND SILT BARRIERS IN GOOD CONDITIONS TO PREVENT INTRODUCTION OF SUSPENDED MATERIALS CAUSED BY HIS CONSTRUCTION ACTIVITIES INTO VARIOUS STORM WATER PONDS FOUND AT THE FIRE STATION FACILITY.


3. CONTRACTOR SHALL BE RESPONSIBLE FOR THE CORRECTION OF ANY EROSION, SEDIMENTATION OR WATER QUALITY PROBLEMS WITHIN STORM WATER PONDS THAT RESULT FROM HIS CONSTRUCTION ACTIVITIES.


4. TO AVOID DAMAGES TO THE UNDERGROUND UTILITIES TRENCHING EQUIPMENT IS NOT ALLOWED TO OPERATE ON SODDED AREAS. CONTRACTOR TO HAND DUG UTILITIES TRENCH FOR LAYING CONDUITS

5. SAWCUTTING FOR INSTALLATION OF CONCRETE PAD TO BE IN CONFORMANCE WITH ALIGNMENT AND DEPTH AS SHOWN ON DRAWINGS. FOR ANY SUBSTANTIAL DEVIATION IN ALIGNMENT CONTRACTOR TO SUBMIT IN WRITING TO ORANGE COUNTY PROJECT MANAGER FOR REVIEW AND APPROVAL BEFORE WORK.

6. INSTALL AND CONNECT UTILITIES LINES SUCH AS POWER AT LOCATION AND DEPTH AS SHOWN ON ELECTRICAL DRAWINGS.

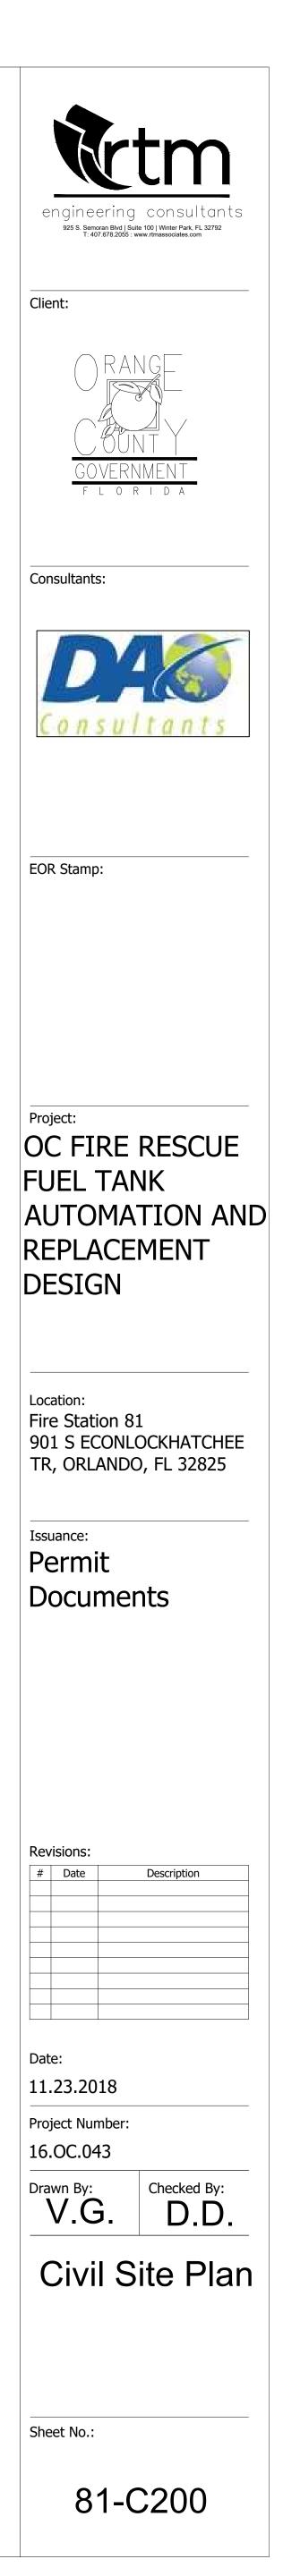

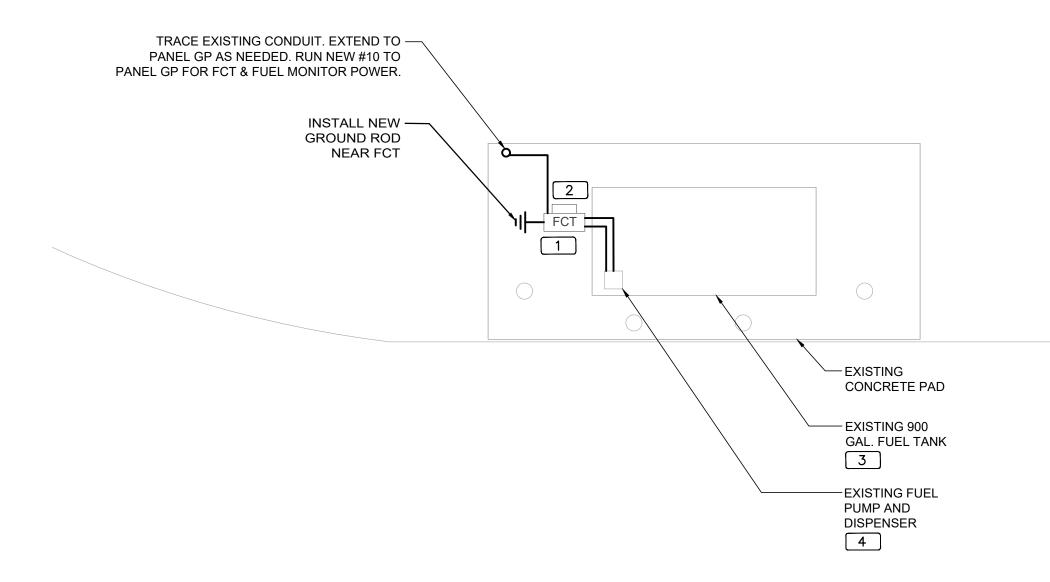

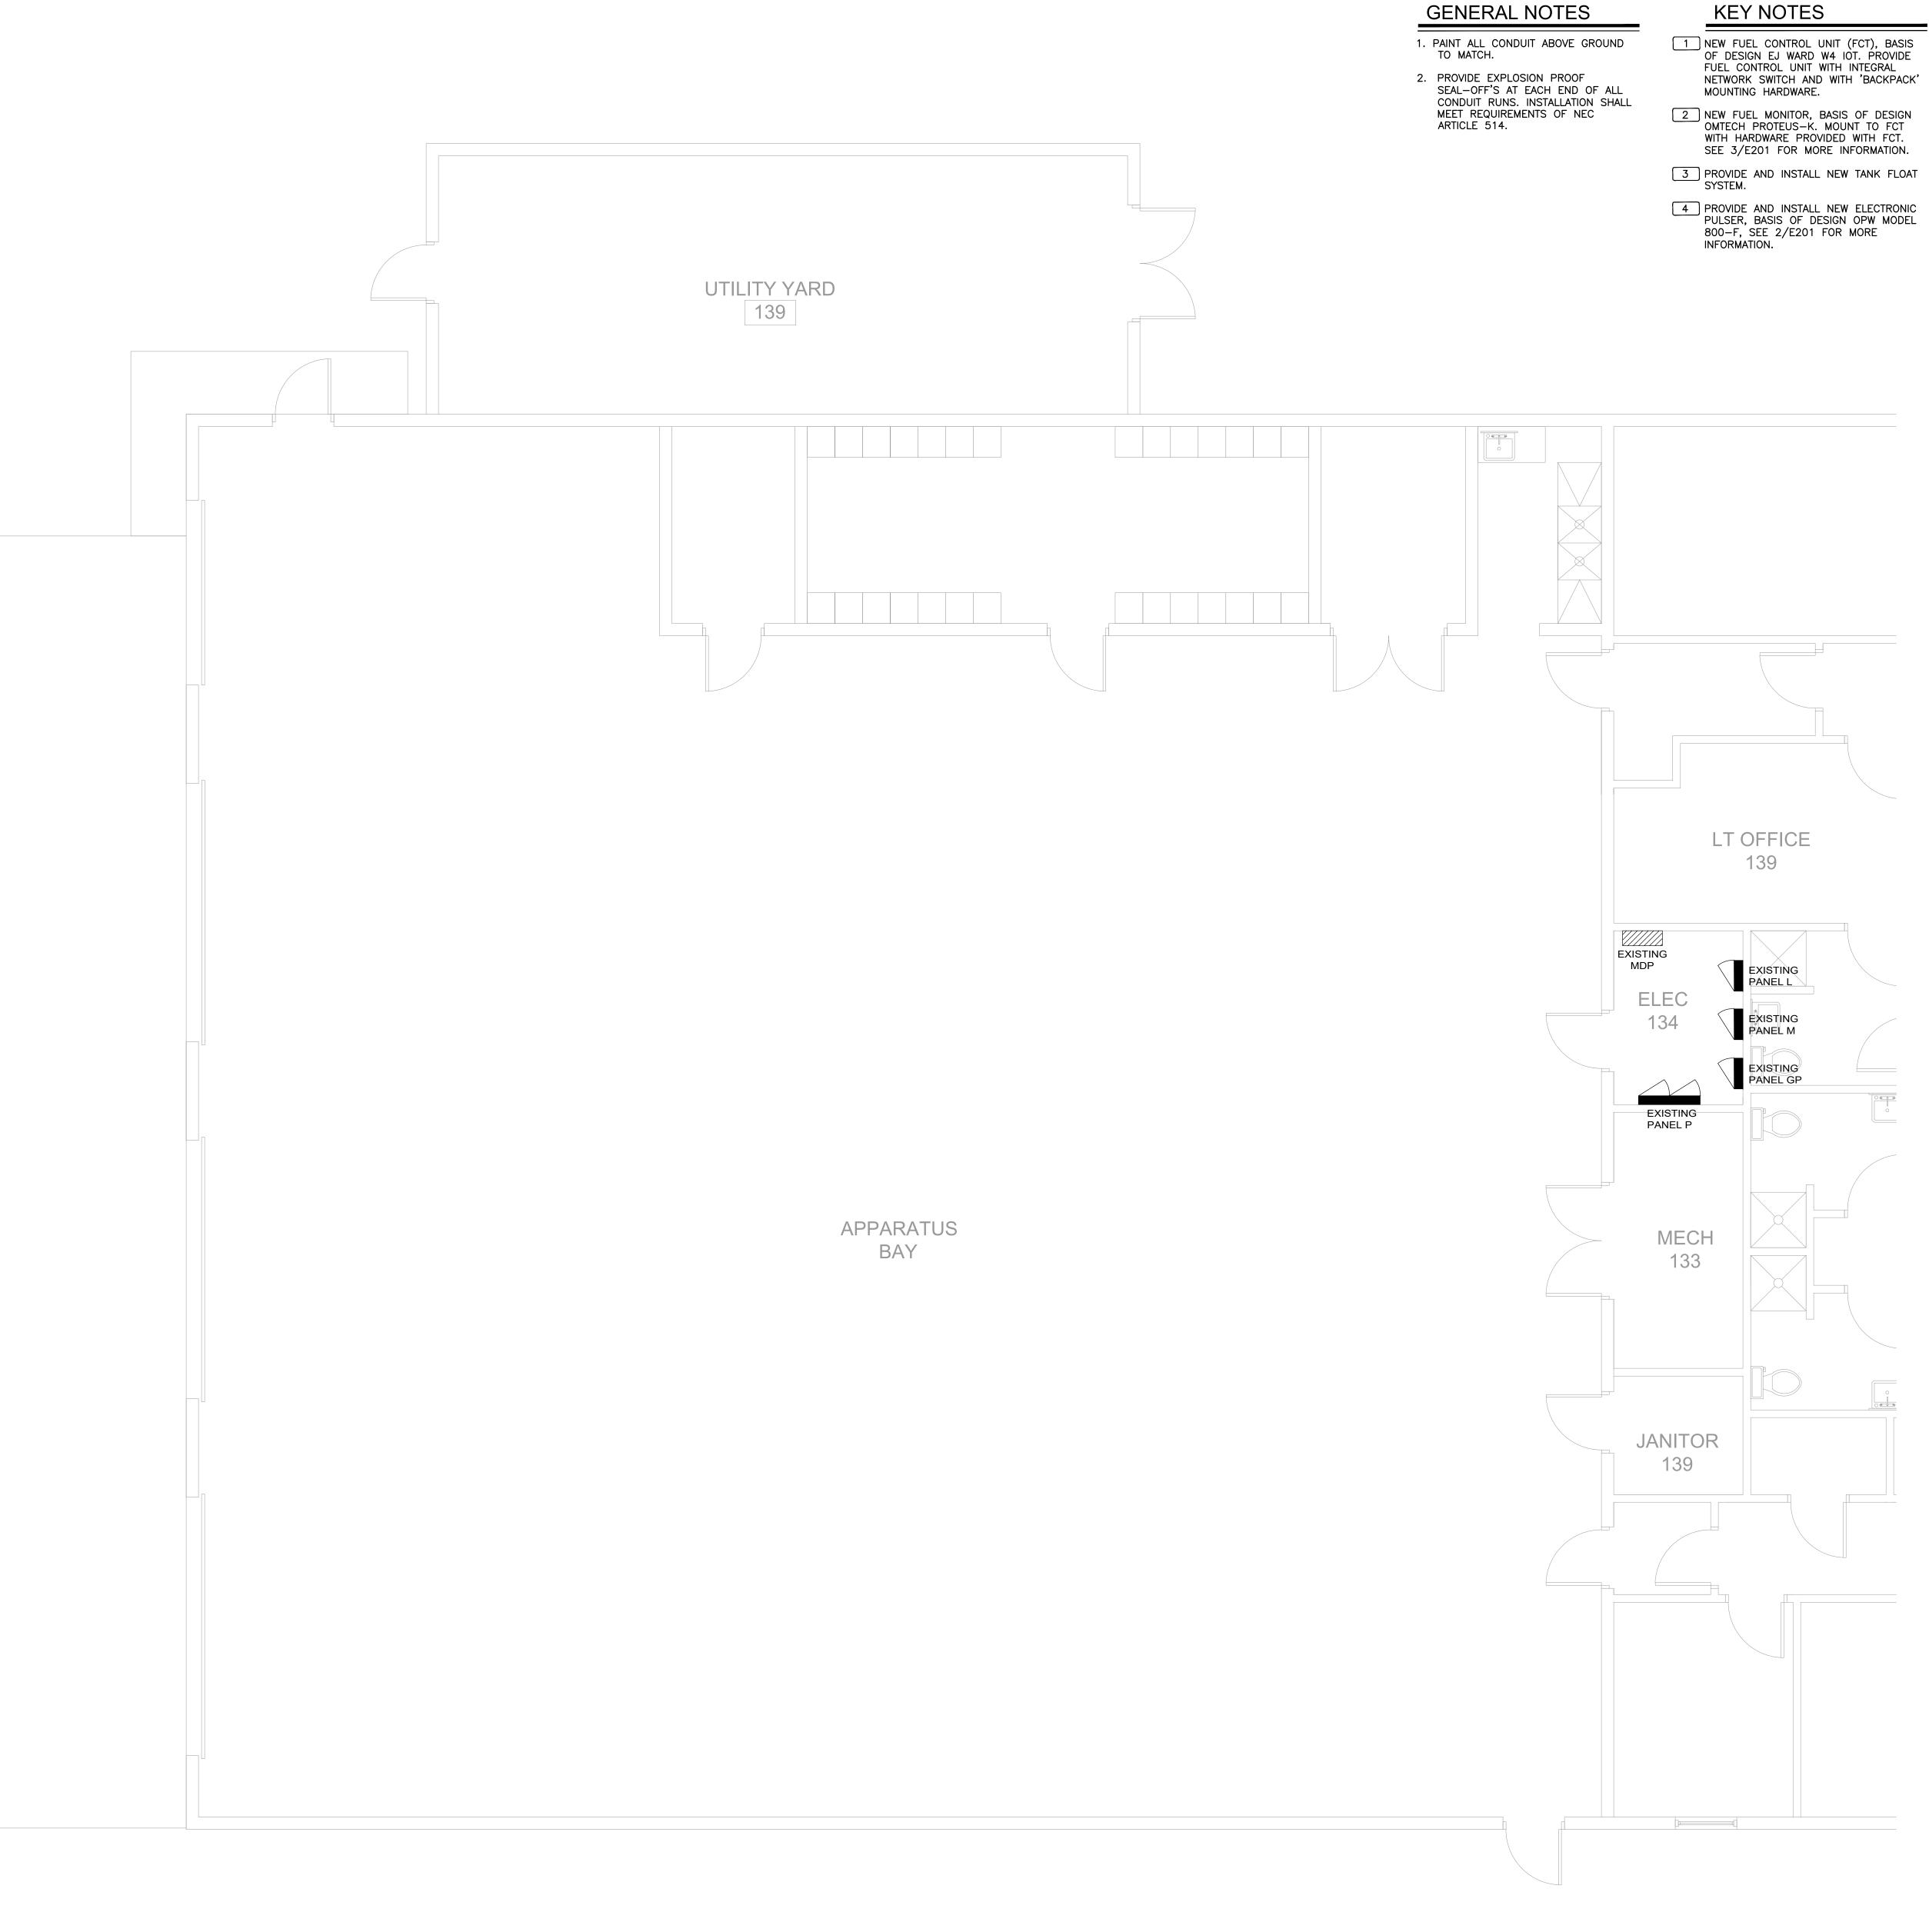

FIRE STATION 81 SITE PLAN - NEW POWER PLAN 8′ 12'

