

CONSTRUCTION PLANS FOR PLAYGROUND IMPROVEMENTS ORANGE COUNTY, FLORIDA

ATTENTION IS DIRECTED TO THE FACT THAT HESE PLANS MAY HAVE BEEN CHANGED IN SIZE BY REPRODUCTION. THIS MUST BE CONSIDERED WHEN OBTAINING SCALED DATA.

II" X I7" DRAWINGS ± HALF SIZE 22" X 34" DRAWINGS ± TO SCALE

2. INFORMATION SHOWN WITHIN THESE PLANS ARE REFERENCED TO THE NORTH AMERICAN VERTICAL DATUM OF 1988 (NAVD88).

UTILITIES ENCOUNTERED


WATER & SEWER: ORANGE COUNTY UTILITIES WATER: ORLANDO UTILITIES COMMISSION ELECTRIC: ORLANDO UTILITIES COMMISSION PHONE: AT&T FLORIDA (GM9510@ATT.COM)

PLANS WERE PREPARED TO AVAILABLE INFORMATION TO ADEQUATELY ADDRESS CONDITIONS AS THEY EXISTED AT THE TIME OF PLANS PREPARATION. DEEDS, CONDITIONS AND OWNERSHIP OF PROPERTIES MAY HAVE CHANGED SINCE PROJECT DESIGN. THE COUNTY'S REPRESENTATIVE WILL ADDRESS CHANGES AND NEEDS WITH THE PROPERTY OWNER OR THEIR REPRESENTATIVES. CONTRACTOR SHALL WORK WITH THE COUNTY'S REPRESENTATIVE IN ADDRESSING AND MEETING NEEDS AND CONDITIONS THAT MAY HAVE CHANGED SINCE PLANS PREPARATION.

CERTIFICATION TO PLANS

I HEREBY CERTIFY THAT THE DESIGN FOR THIS PROJECT AND THE ATTACHED CONSTRUCTION PLANS COMPLY WITH THE REQUIREMENTS OF SECTION 336.045 OF THE FLORIDA STATUTES AND ARE IN SUBSTANTIAL CONFORMANCE WITH THE STANDARDS CONTAINED IN THE EDITION OF THE "MANUAL FOR UNIFORM MINIMUM STANDARDS FOR DESIGN, CONSTRUCTION AND MAINTENANCE FOR STREETS AND HIGHWAYS" IN EFFECT ON THIS DATE AS ADOPTED BY THE FLORIDA DEPARTMENT OF TRANSPORTATION PURSUANT TO SUBSECTION 336.045 (I) OF THE FLORIDA STATUTES.

JEFFREY J. EARHART

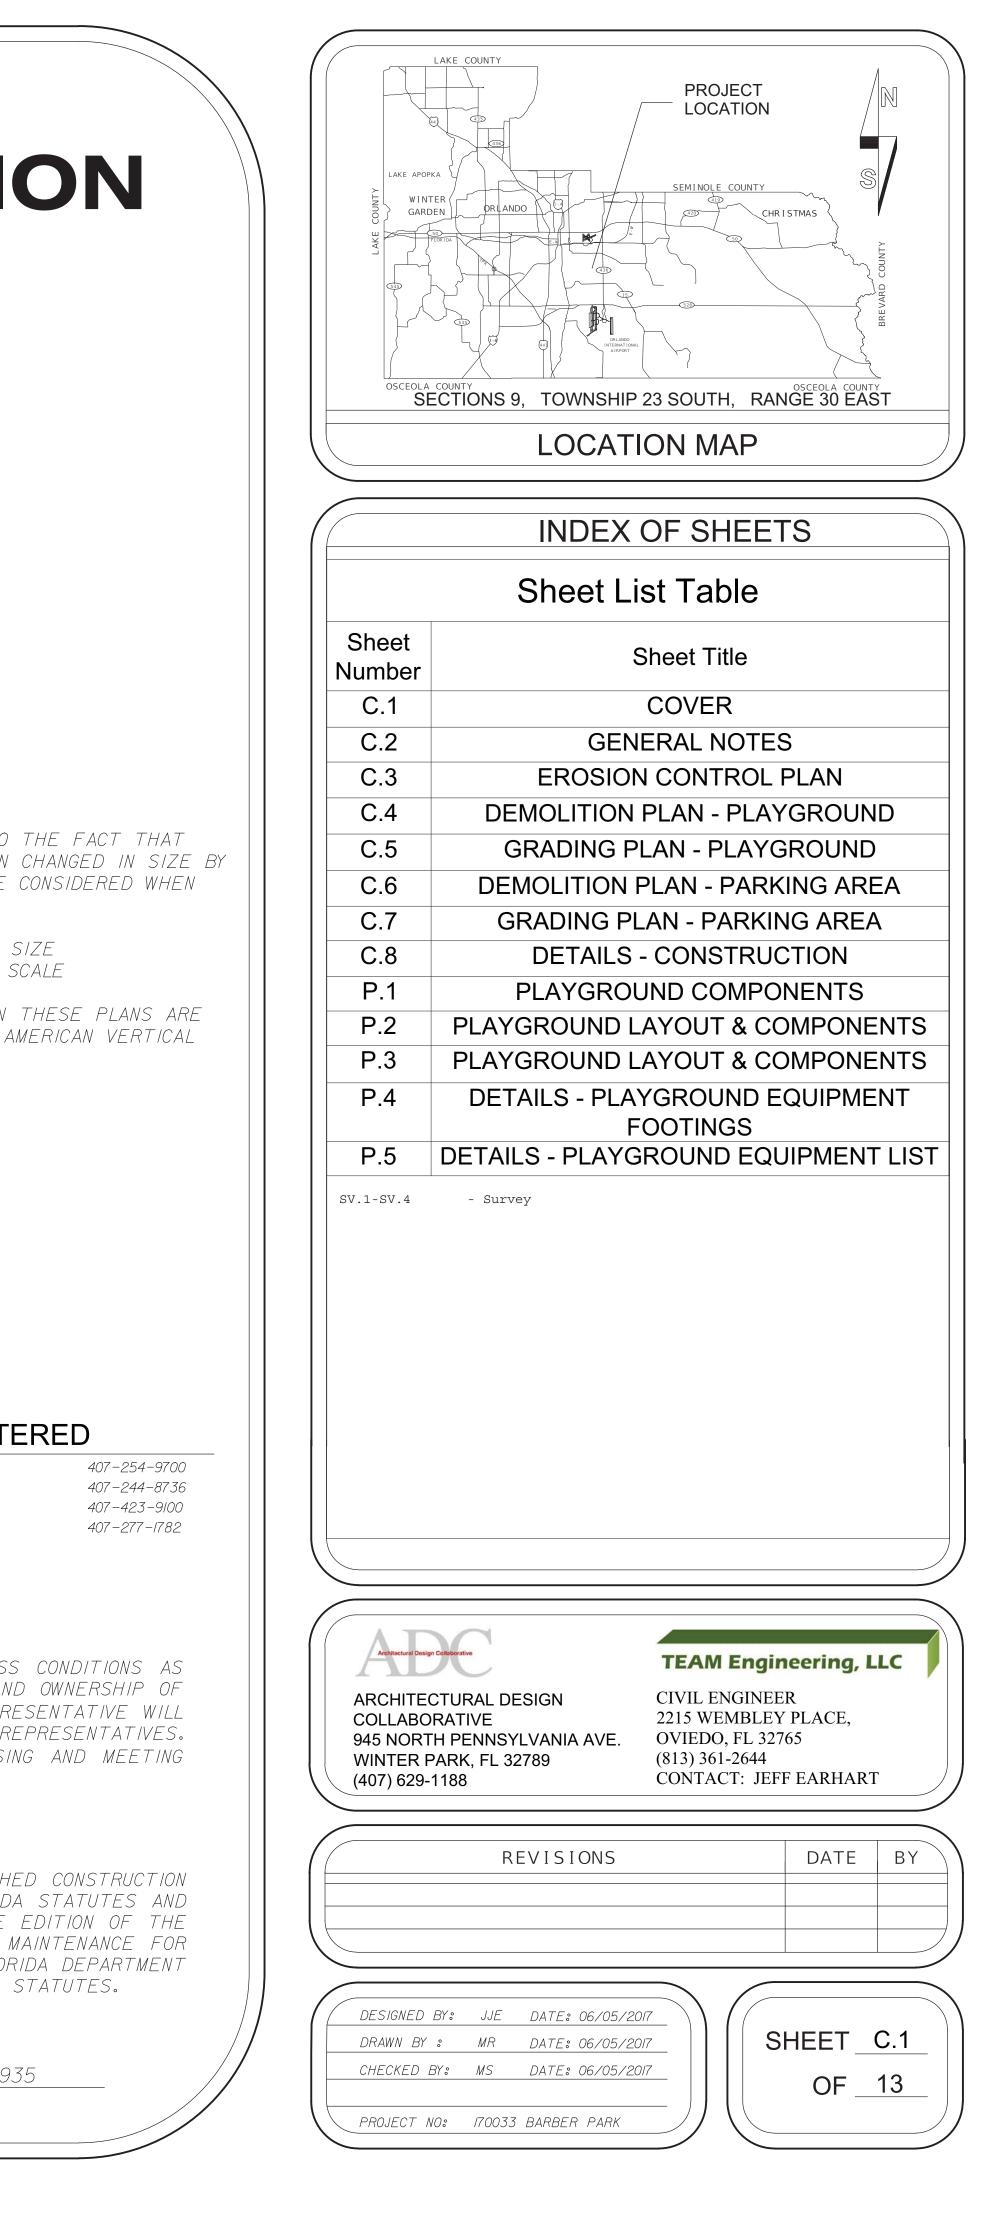

GENERAL NOTES: 1. ALL ELEVATIONS SHOWN IN THESE PLANS ARE BASED ON THE NORTH AMERICAN VERTICAL DATUM OF 1988 (NAVD88).

2. ALL CONSTRUCTION SHALL BE IN ACCORDANCE WITH AND CONFORM TO THE MOST STRINGENT REQUIREMENTS OF THE PROJECT SPECIFICATIONS, THE FLORIDA DEPARTMENT OF TRANSPORTATION STANDARD SPECIFICATIONS FOR ROAD AND BRIDGE CONSTRUCTION, AND SUPPLEMENTS THERETO, AND ORANGE COUNTY ROAD CONSTRUCTION SPECIFICATIONS.

3. SUBSURFACE INFORMATION SHOWN ON THESE DRAWINGS WAS OBTAINED FOR USE IN ESTABLISHING TOPOGRAPHIC FEATURES FOR THE PROJECT. THE ACCURACY OF THIS INFORMATION IS NOT GUARANTEED AND IS NOT TO BE CONSTRUED AS PART OF THE PLAN GOVERNING CONSTRUCTION OF THE PROJECT. IT IS THE RESPONSIBILITY OF THE CONTRACTOR TO INQUIRE OF THE OWNER IF ADDITIONAL INFORMATION IS AVAILABLE, TO MAKE ARRANGEMENTS TO REVIEW SAME PRIOR TO BIDDING, AND TO MAKE HIS OWN DETERMINATION AS TO ALL SUBSURFACE CONDITIONS.

5. THE DISPOSAL OF EXCESS EARTHWORK MATERIALS SHALL BE THE RESPONSIBILITY OF THE CONTRACTOR. APPROVAL(S) OF THE DISPOSAL SITES SHALL BE OBTAINED FROM ORANGE COUNTY PRIOR TO DISPOSAL. ALL EXCESS MATERIALS ARE THE PROPERTY AND RESPONSIBILITY OF THE CONTRACTOR.

6. ALL EXISTING TREES WITHIN THE FOOTPRINT OF THE CONSTRUCTION LIMITS ARE TO BE REMOVED AS CLEARING AND GRUBBING UNLESS OTHERWISE DIRECTED.

7. SOD ALL DISTURBED AREAS UNLESS OTHERWISE SHOWN ON THE PLANS. SOD SHALL MATCH EXISTING TYPE SOD UNLESS OTHERWISE DIRECTED BY THE ENGINEER.

9. PEGGED SOD TO BE PLACED ON ALL SLOPES 1:2 OR STEEPER.

10. SAWCUT CONCRETE DRIVEWAYS AS REQUIRED FOR CONSTRUCTION.

11. ALL PAVEMENT OFFSETS SHOWN ARE TO PROPOSED CENTERLINE OF CONSTRUCTION; ALL RADII AND DIMENSIONS ARE TO PROPOSED EDGE OF PAVEMENT.

12. FOR STABILIZATION AT TURNOUTS AND DRIVEWAYS CONNECTIONS SEE STANDARD INDEX No. 515 AND TYPICAL SECTIONS FOR DEPTH AND LBR.

13. DRIVEWAY LOCATIONS AND WIDTHS SHOWN ARE APPROXIMATE AND MAY BE ADJUSTED AS NECESSARY AS DIRECTED BY THE ENGINEER.

14. THE CONTRACTOR SHALL PERFORM HIS WORK IN ACCORDANCE WITH REQUIREMENTS OF THE VARIOUS PERMITS INCLUDED IN THE BID SPECIFICATIONS. PAYMENT IS INCLUDED IN THE BID PRICE FOR SECTION 104; "PREVENTION, CONTROL, AND ABATEMENT OF EROSION AND WATER POLLUTION", EXCLUDING ITEMS SPECIFIED ELSEWHERE. ENVIRONMENTAL CONTROLS SHALL BE USED AT LOCATIONS DESIGNATED IN THE STORMWATER POLLUTION PREVENTION PLAN AND/OR DESIGNATED BY THE ENGINEER.

15. THE INFORMATION SHOWN ON THESE DRAWINGS CONCERNING TYPE AND LOCATION OF UNDERGROUND AND OTHER UTILITIES IS BASED ON AVAILABLE RECORDS AND SURVEYS BUT IS NOT GUARANTEED TO BE ACCURATE OR ALL INCLUSIVE. THE CONTRACTOR SHALL MAKE HIS OWN DETERMINATION AS TO THE TYPE AND LOCATION OF THE UTILITIES AS MAY BE NECESSARY TO AVOID DAMAGE THERETO AND IS RESPONSIBLE FOR COORDINATING UTILITY RELOCATION WITH PROJECT CONSTRUCTION. PRIOR TO ORDERING DRAINAGE STRUCTURES, THE CONTRACTOR SHALL DETERMINE IF DRAINAGE/UTILITY CONFLICTS EXIST. INFORMATION ON CONFLICTS IS TO BE SUBMITTED TO THE ENGINEER AS SOON AS POSSIBLE AFTER DISCOVERY FOR RESOLUTION. SUNSHINE STATE ONE CALL MUST BE NOTIFIED FOR LOCATES AT 1-800-432-4770.

16. UTILITIES ARE TO BE ADJUSTED BY THE CONTRACTOR OR AS DIRECTED BY THE ENGINEER

17. THE CONTRACTOR SHALL NOTIFY ALL GAS UTILITY COMPANIES A MINIMUM OF TWO WORKING DAYS PRIOR TO EXCAVATION AS REQUIRED BY CHAPTER 77-153 OF THE FLORIDA STATUTES.

18. ALL DRAINAGE PIPES SHALL BE STEEL REINFORCED CONCRETE PIPES, CLASS III, UNLESS OTHERWISE NOTED.

19. INLET ELEVATIONS SHOWN IN THE PLANS REFER TO THE EDGE OF PAVEMENT AT THE CENTER OF CURB INLETS AND THE TOP OF THE GRATE FOR DITCH BOTTOM INLETS.

20. ALL EXCAVATIONS SHALL BE REQUIRED TO CONFORM TO THE PROVISIONS OF PART IV OF CHAPTER 553.60, F.S., ALSO KNOWN AS THE "TRENCH SAFETY ACT", TO PROTECT EXISTING PAVEMENT, STRUCTURES, FOUNDATIONS, AND CONSTRUCTION PERSONNEL DURING CONSTRUCTION OF THE PROJECT.

22. ALL MANHOLE COVERS SHALL INCLUDE THE ORANGE COUNTY LOGO AND BE IDENTIFIED AS "ORANGE COUNTY SANITARY", "ORANGE COUNTY STORM", OR "ORANGE COUNTY WATER", AS APPROPRIATE. (SEE DETAILS BELOW)

23. ALL INLET/MANHOLE - PIPE JOINTS SHALL BE FILLED WITH NON-SHRINK GROUT, COVERED WITH AN ASPHALTIC MASTIC COATING, AND WRAPPED WITH A FILTER FABRIC MATERIAL PER SECTION 13.03.03 OF THE ORANGE COUNTY ROAD CONSTRUCTION SPECIFICATIONS.

24. ALL CURB INLETS. DITCH BOTTOM INLETS. AND MANHOLES SHALL HAVE TRAFFIC BEARING FRAMES AND COVERS OR GRATES MEETING HS-20 LOADING REQUIREMENTS.

25. ALL EXISTING DRAINAGE STRUCTURES AND PIPES WITHIN THE LIMITS OF CONSTRUCTION SHALL REMAIN, UNLESS OTHERWISE SHOWN IN THE PLANS OR DIRECTED BY THE ENGINEER.

26. DESIGN CHANGES OF PIPE INVERTS NOT EXCEEDING PLUS OR MINUS ONE FOOT WILL NOT BE CONSIDERED AS A BASIS /FOR ADDITIONAL COMPENSATION FOR THE PERTINENT PIPE BID ITEM OR FOR MODIFICATION OF PRECAST STRUCTURES.

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NO.



GENERAL NOTES CONTINUED:

27. ALL (P.R.M.'s) IRONS AND MONUMENTS SHOWN ON PLANS, OR FOUND, SHALL BE PRESERVED. THOSE SHOWN IN PROPOSED PAVEMENT SHALL BE PROTECTED WITH CAST IRON VALVE BOX.

28. ANY U.S.C. AND G.S. MONUMENTS WITHIN THE LIMITS OF CONSTRUCTION SHALL BE PROTECTED. IF IN DANGER OF DAMAGE, THE CONTRACTOR SHALL NOTIFY THE PROJECT ENGINEER, ORANGE COUNTY SURVEY SECTION 407-836-7940 AND BOTH SHALL NOTIFY: DAVID NEWCOMER, NOAA AND RANDY WEGNER, NOAA, C/O FLDEP, BUREAU OF SURVEY AND MAPPING, MS 105, 3900 COMMONWEALTH BOULEVARD, TALLAHASSEE, FL 32399–3000, TELEPHONE: (850) 245–2606, FAX: (850) 245–2645.

29. PUBLIC LAND CORNERS WITHIN THE LIMITS OF CONSTRUCTION SHALL BE PROTECTED. IF A CORNER MONUMENT IS IN DANGER OF BEING DESTROYED OR DISTURBED, THE CONTRACTOR SHALL NOTIFY THE PROJECT ENGINEER AND THE COUNTY SURVEYOR, WITHOUT DELAY, BY TELEPHONE 407-836-7940. THE CONTRACTOR SHALL PROVIDE WRITTEN FOLLOW UP CONFIRMATION WITHIN 48 HOURS OF TELEPHONE NOTIFICATION.

30. PRIOR TO BEGINNING ANY CONSTRUCTION, THE CONTRACTOR SHALL SUBMIT TO ORANGE COUNTY CAPITAL PROJECTS DIVISION A SET OF FIELD NOTES VERIFYING THE BENCHMARK ELEVATIONS AND THE REFERENCE POINT TIES SHOWN ON THE TITLE SHEET AND PLAN AND PROFILE SHEETS, AND/OR A SET OF FIELD NOTES FOR ALL ADDITIONAL BENCHMARK AND REFERENCE POINT TIES PROPOSED TO BE USED IN CONSTRUCTING THE PROJECT WITH THEIR LOCATION, DESCRIPTION AND ELEVATION, BASED ON ORANGE COUNTY DATUM. ALL SUBMITTALS SHALL BE SIGNED AND SEALED BY A PROFESSIONAL LAND SURVEYOR REGISTERED IN THE STATE OF FLORIDA.

31. TO MEET ADA REQUIREMENTS, ALL SIDEWALK CONSTRUCTION SHALL COMPLY WITH THE FLORIDA ACCESSIBILITY CODE FOR BUILDING CONSTRUCTION, STATE FDOT INDEX 304, INDEX 310, AND INDEX 600.

32. THE LOCATIONS OF THE UTILITIES SHOWN IN THE PLANS (INCLUDING THOSE DESIGNATED Vv, Vh AND Vvh) ARE BASED ON LIMITED INVESTIGATION TECHNIQUES AND SHOULD BE CONSIDERED APPROXIMATE ONLY. THE VERIFIED LOCATIONS/ELEVATIONS APPLY ONLY AT THE POINTS SHOWN. INTERPOLATIONS BETWEEN THESE POINTS HAVE NOT BEEN VERIFIED.

33. CONTRACTOR IS TO MAINTAIN UNINTERRUPTED ACCESS TO ALL DRIVEWAYS AND SIDE STREETS AT ALL TIMES AND IS TO NOTIFY PROPERTY OWNERS FIVE DAYS PRIOR TO STARTING CONSTRUCTION.

34. PRIOR TO COMMENCEMENT OF WORK, THE CONTRACTOR SHALL CALL SUNSHINE ONE TWO BUSINESS DAYS IN ADVANCE OF PERFORMING ANY UTILITY ADJUSTMENTS OR RELOCATIONS. SUNSHINE ONE PHONE NUMBER 1-(800)-432-4770.

35. CONTRACTOR TO VIDEOTAPE AND PHOTOGRAPH THE LIMITS OF CONSTRUCTION PRIOR CONSTRUCTION AND GIVE A COPY TO THE COUNTY. COST TO BE INCLUDED IN THE PRICE BID FOR ITEM NO. 101-1, MOBILIZATION.

36. THE RUNNING SLOPE OF WALKING SURFACES ON AN ACCESSIBLE ROUTE SHALL NOT BE STEEPER THAN 1:20. THE CROSS SLOPE OF WALKING SURFACES SHALL NOT BE STEEPER THAN 1:48. FBC ACCESSIBILITY 403.3. THE CONTRACTOR SHALL REVISE ELEVATION AND SIDE LOCATIONS TO MEET THIS REQUIREMENT AS NEEDED.

37. CITY OF ORLANDO'S GUIDELINES FOR EROSION SEDIMENT CONTROL (A.K.A. THE BLUE SHEET) WILL SERVE AS A GUIDE FOR THE IMPLEMENTATION OF EROSION SEDIMENT CONTROL MEASURES. THE BLUE SHEET CAN BE FOUND ON THE CITY OF ORLANDO WEBSITE.




GENERAL NOTES





SHEET NUMBER



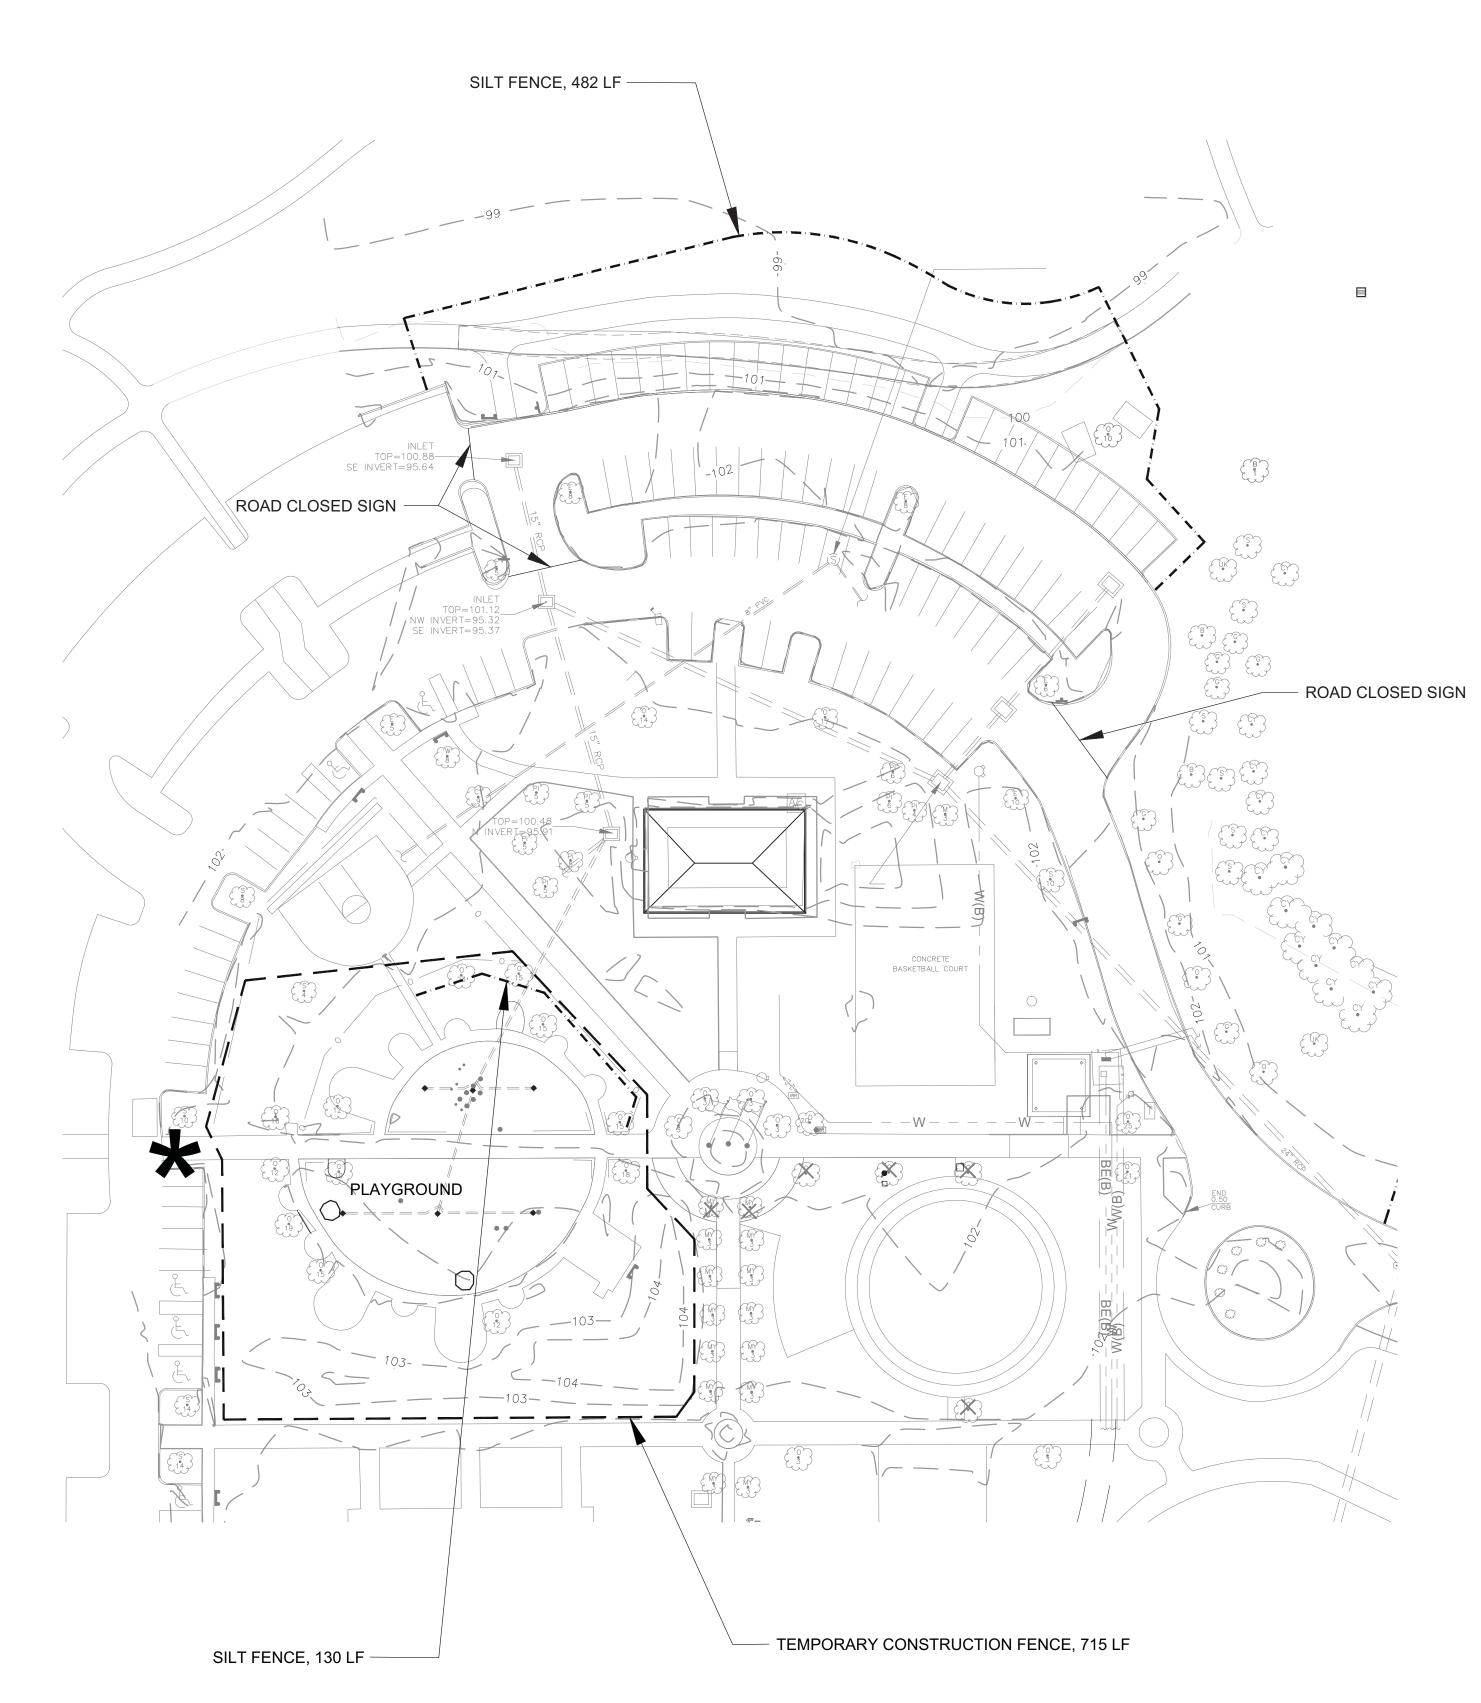

			Architectural Design Collaborative	TEAM E
2	09/28/2017	100% Submission	ARCHITECTURAL DESIGN	TEA 2215
1	06/09/2017	60% Submission	COLLABORATIVE 945 N. PENNSYLVANIA AVENUE	ORLA
NO.	DATE	REVISION	WINTER PARK, FLORIDA 32789 (407) 629-1188	(40

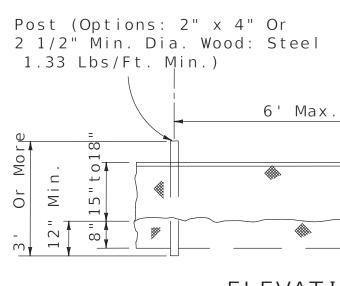

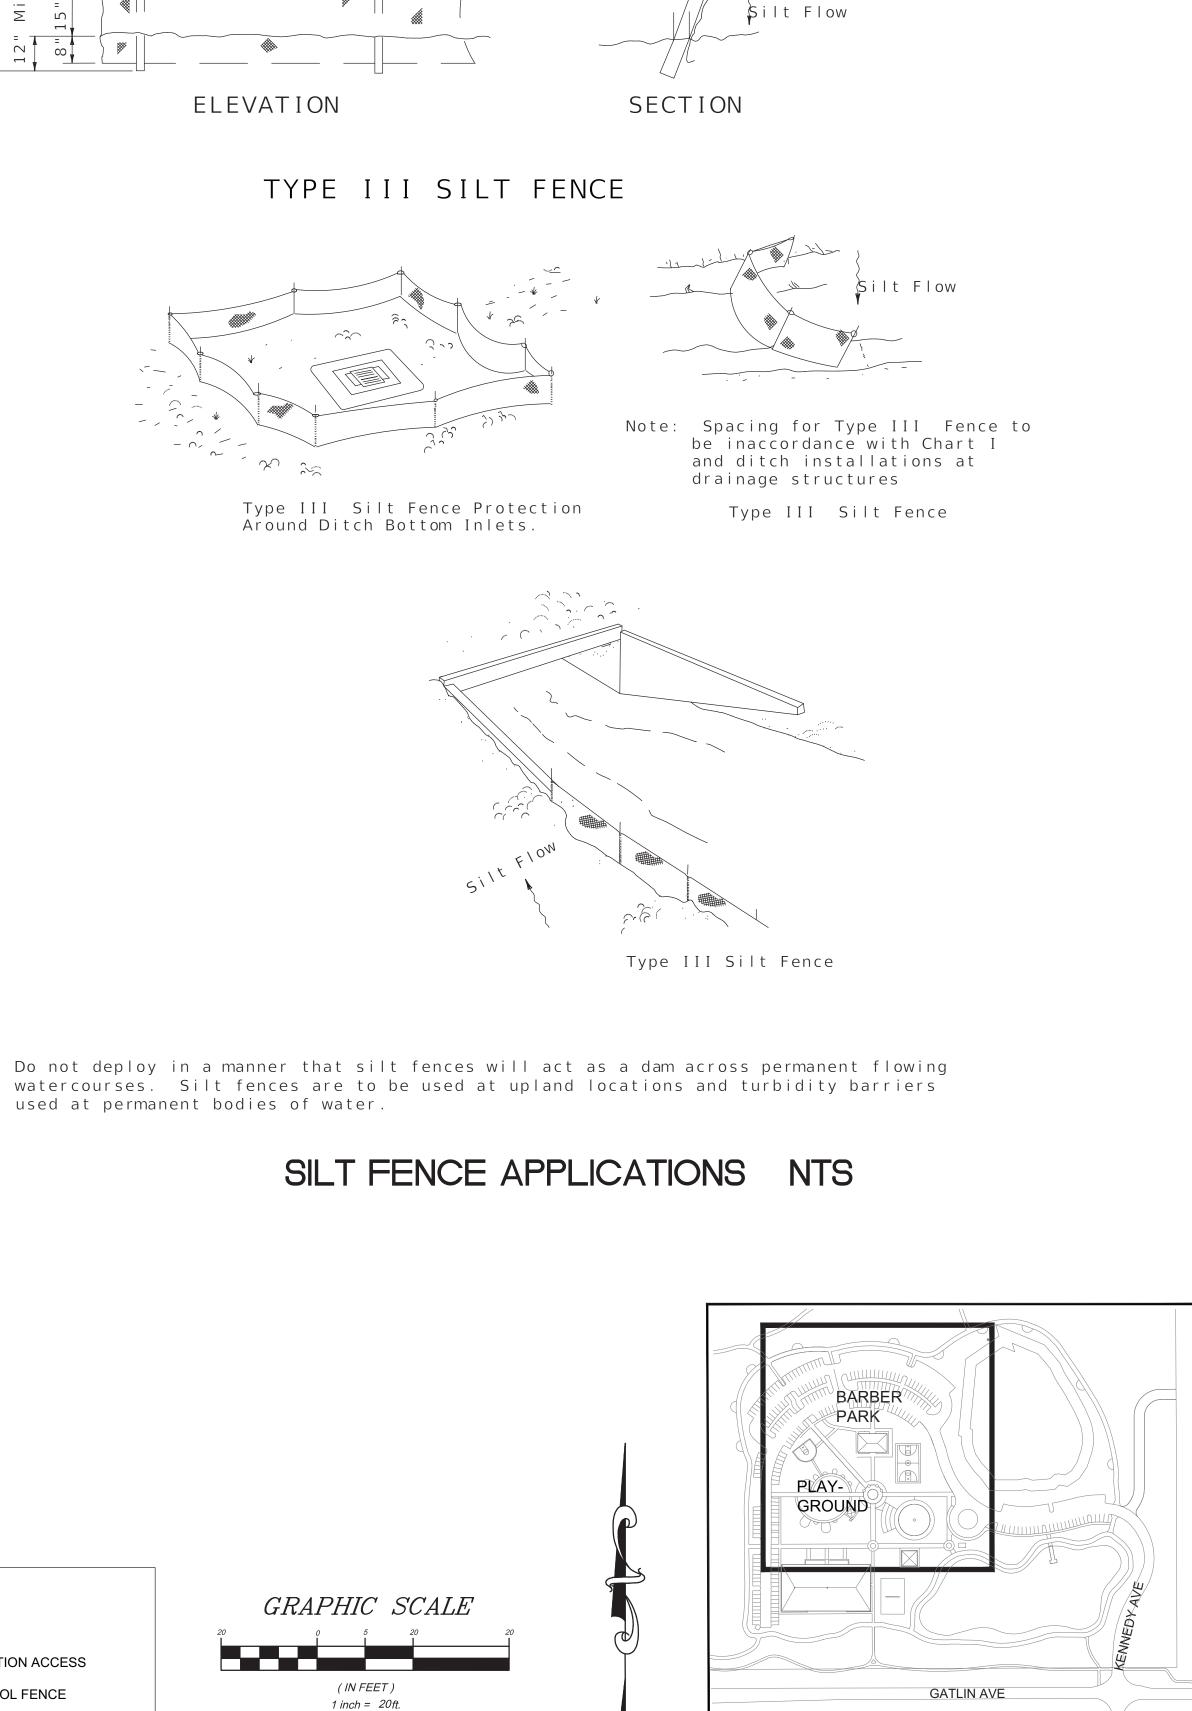

Optional Post Positions


اب -اب - Filter Fabric (In

Conformance With $\frac{1}{\omega}$ Sec. 985 FDOT Spec.

#

Principle Post Position (Canted 20° Toward Flow)

— Filter Fabric

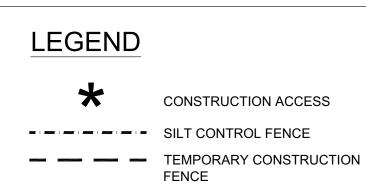

CONSTRUCTION ACCESS

I Engineering, LLC

TEAM ENGINEERING 215 WEMBLEY PLACE DRLANDO. FL 32765 (407) 267-8905 COA-29813



BARBER PARK ORANGE COUNTY GOVERNMENT GOVERNMENTPLAYGROUNDFLORIDAIMPROVEMENTS3701 GATLIN AVENUE, ORLANDO, FL 32812

Contour Interval = 1 ft.


EROSION CONTROL PLAN

KEY MAP


NTS


SHEET NUMBER

C.3

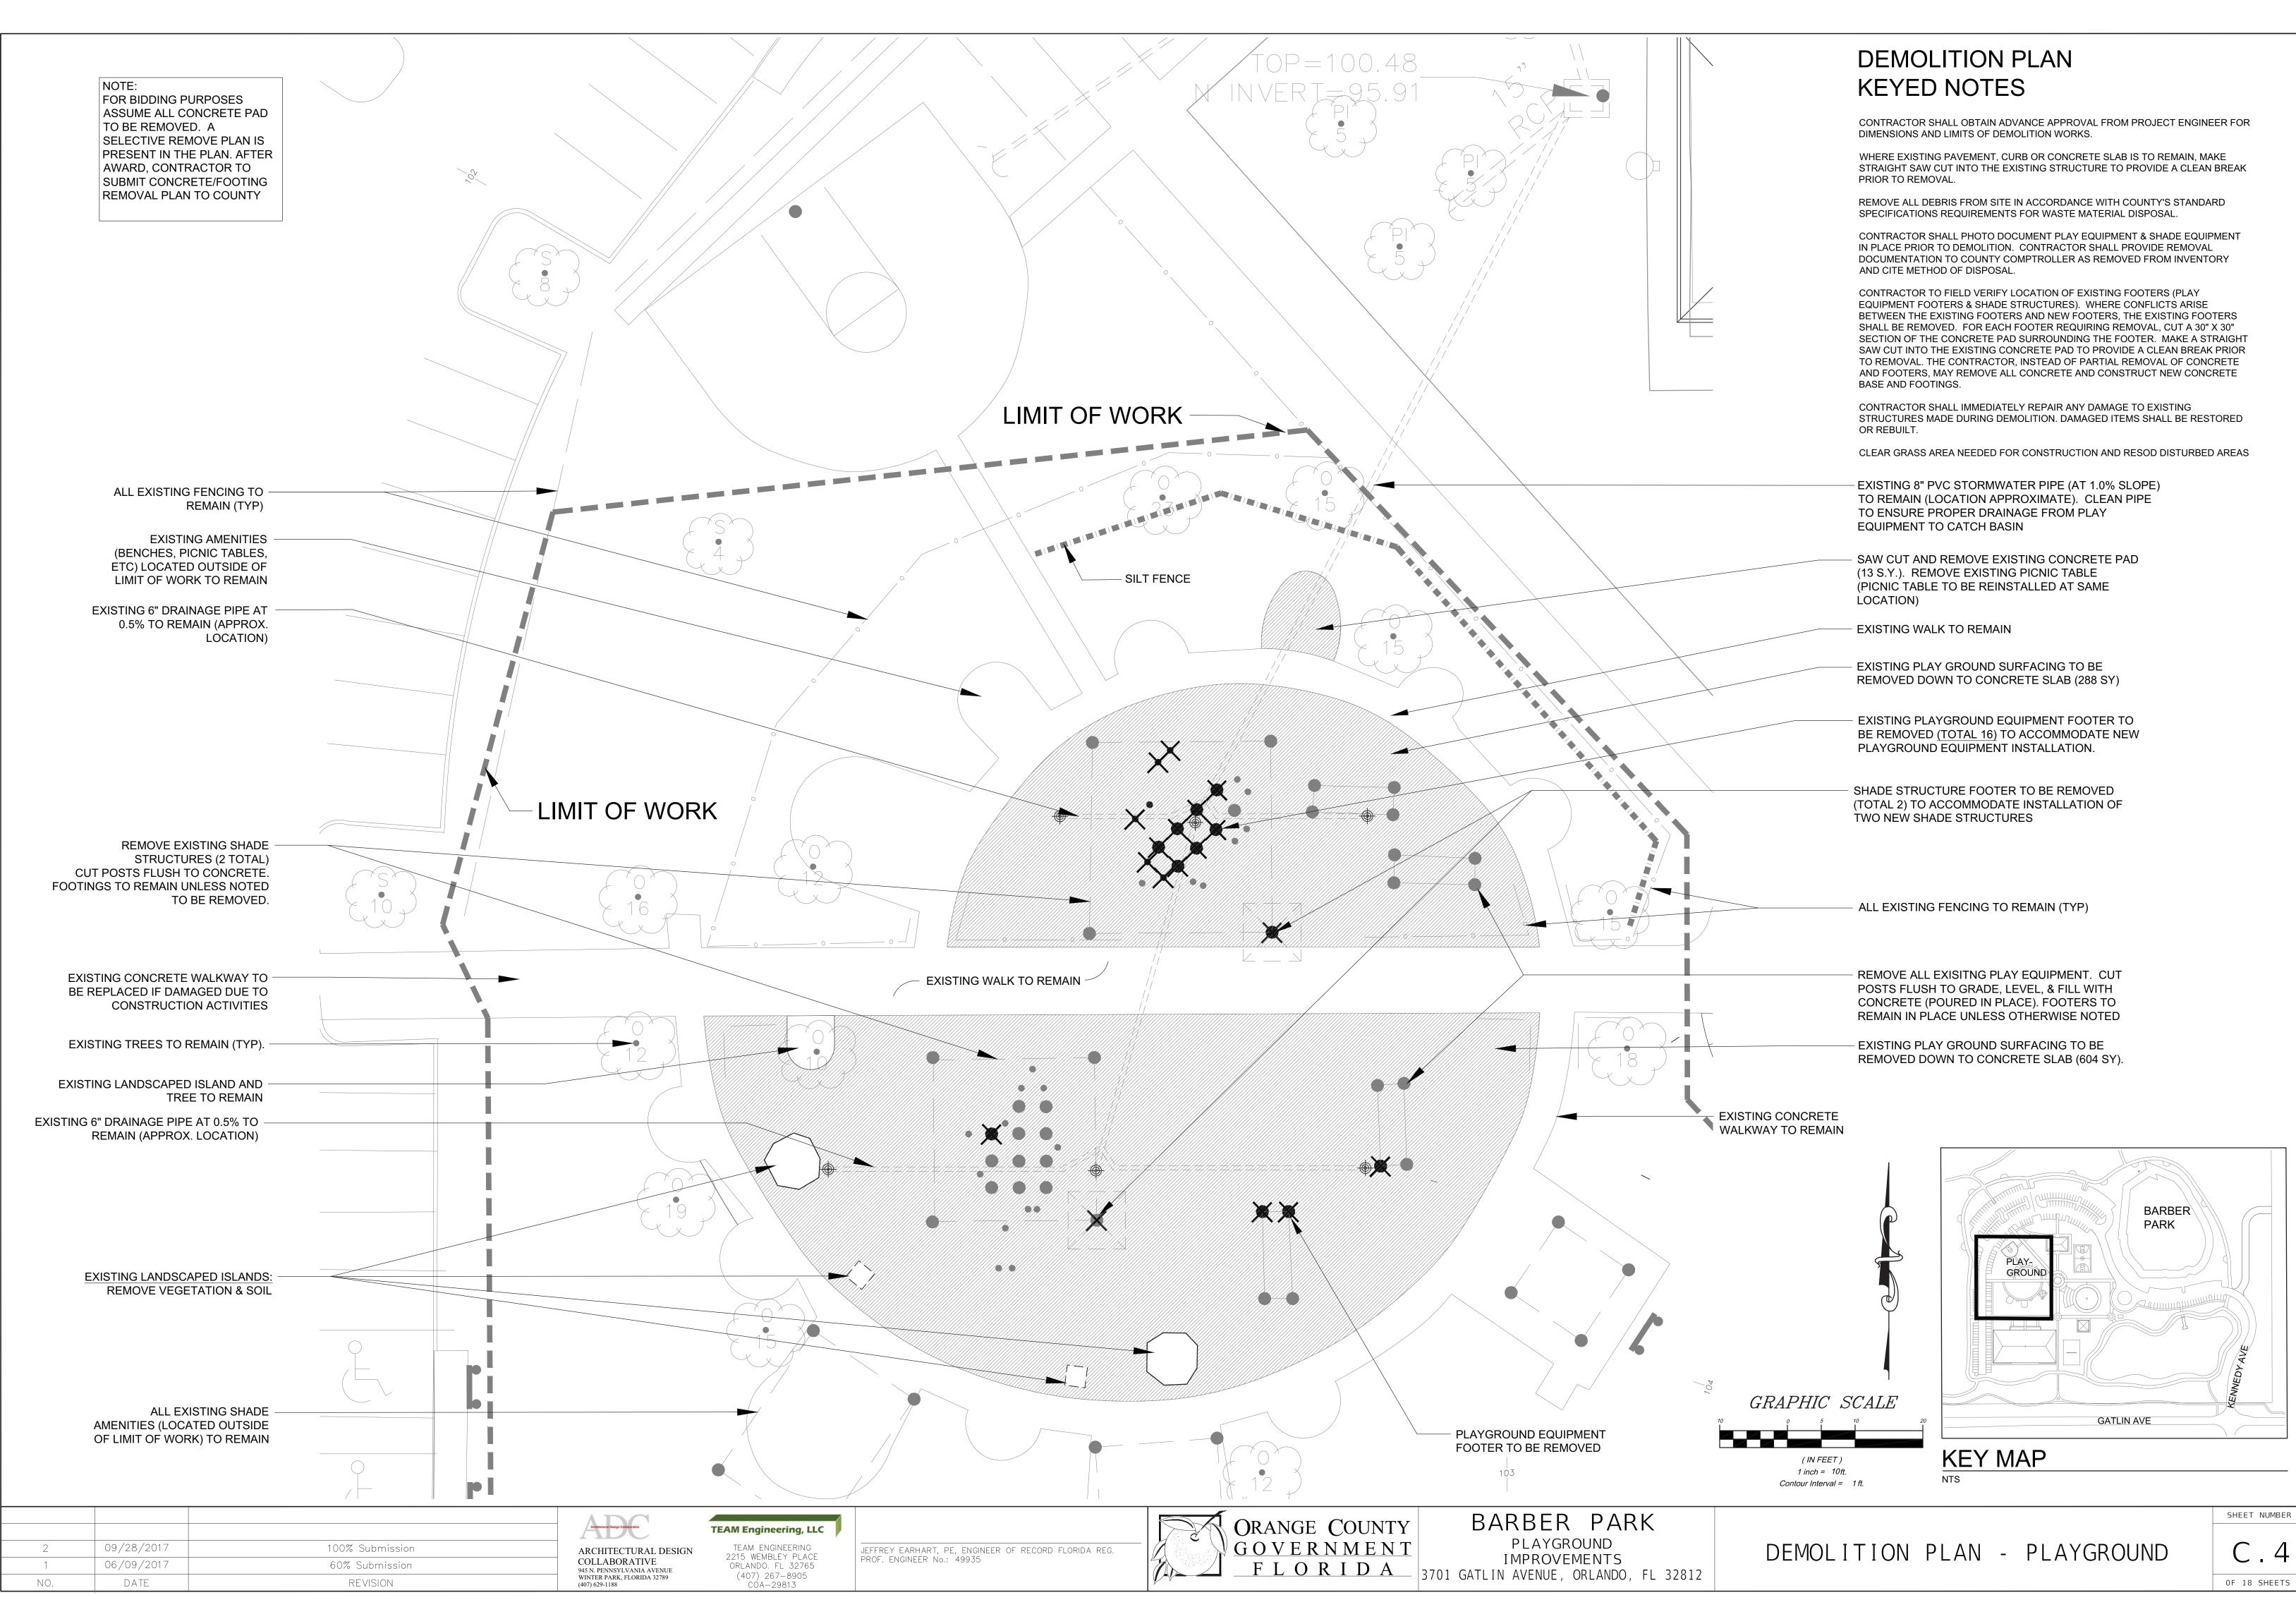

DATE 2018-06-06

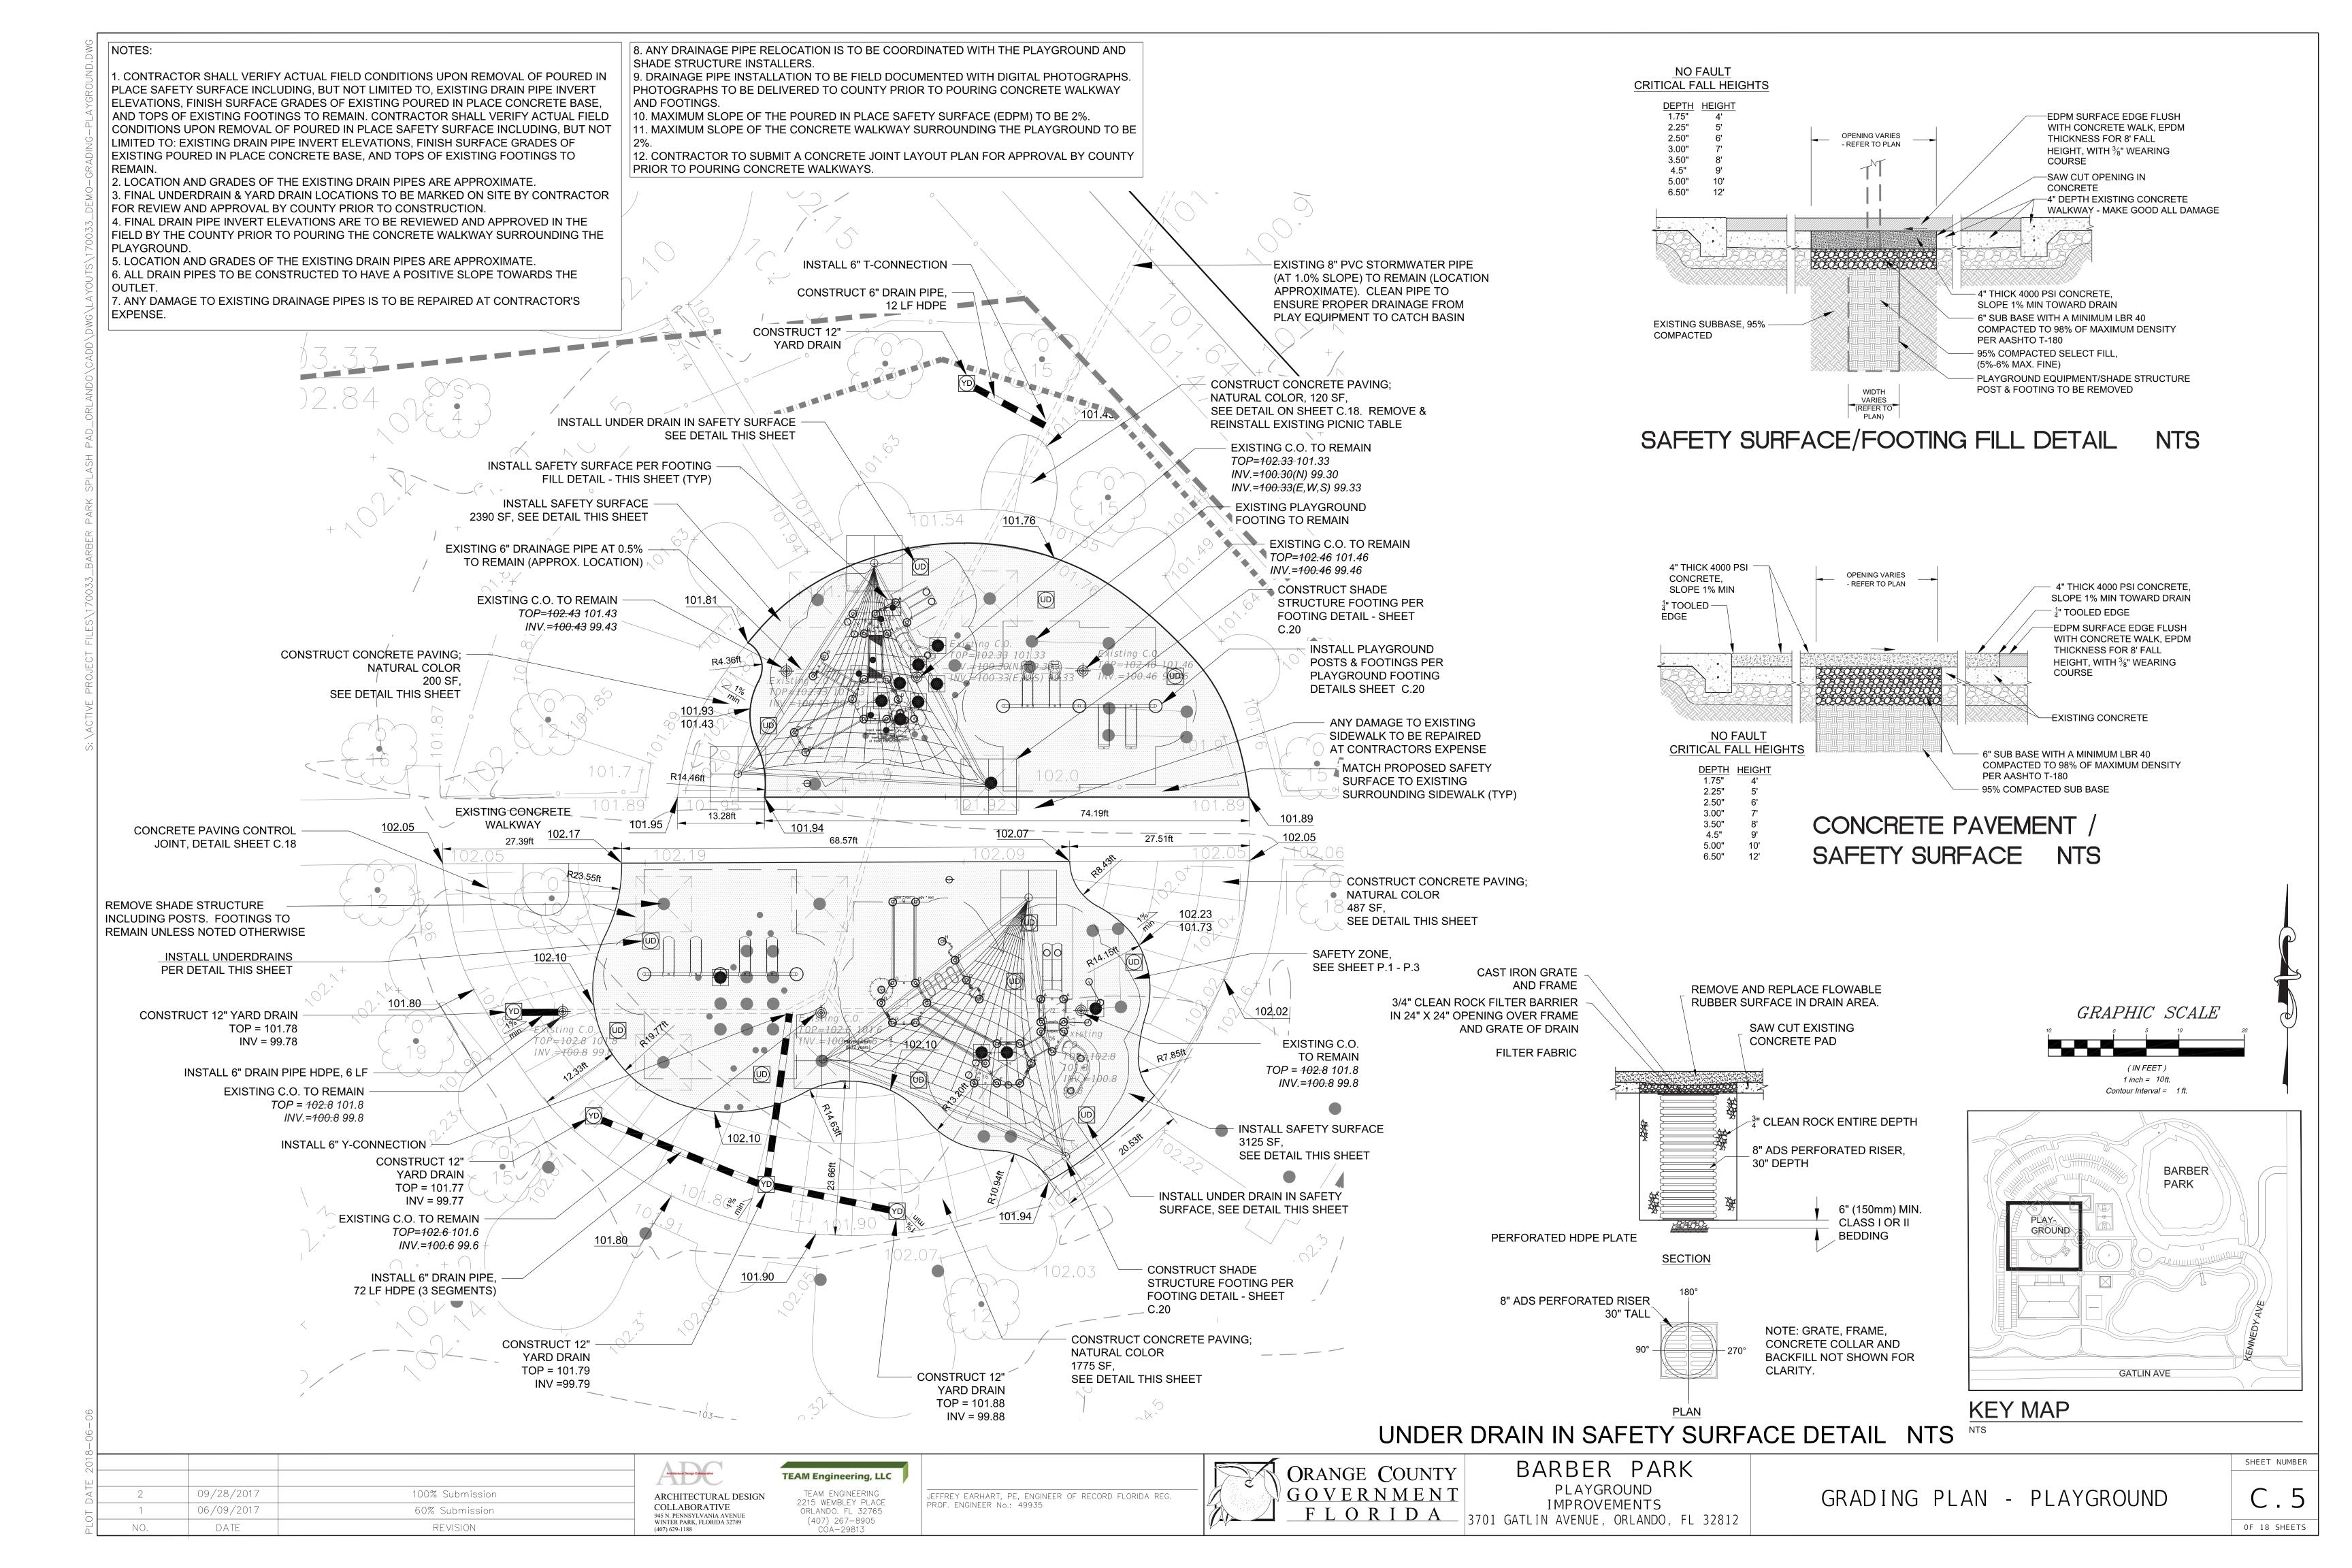

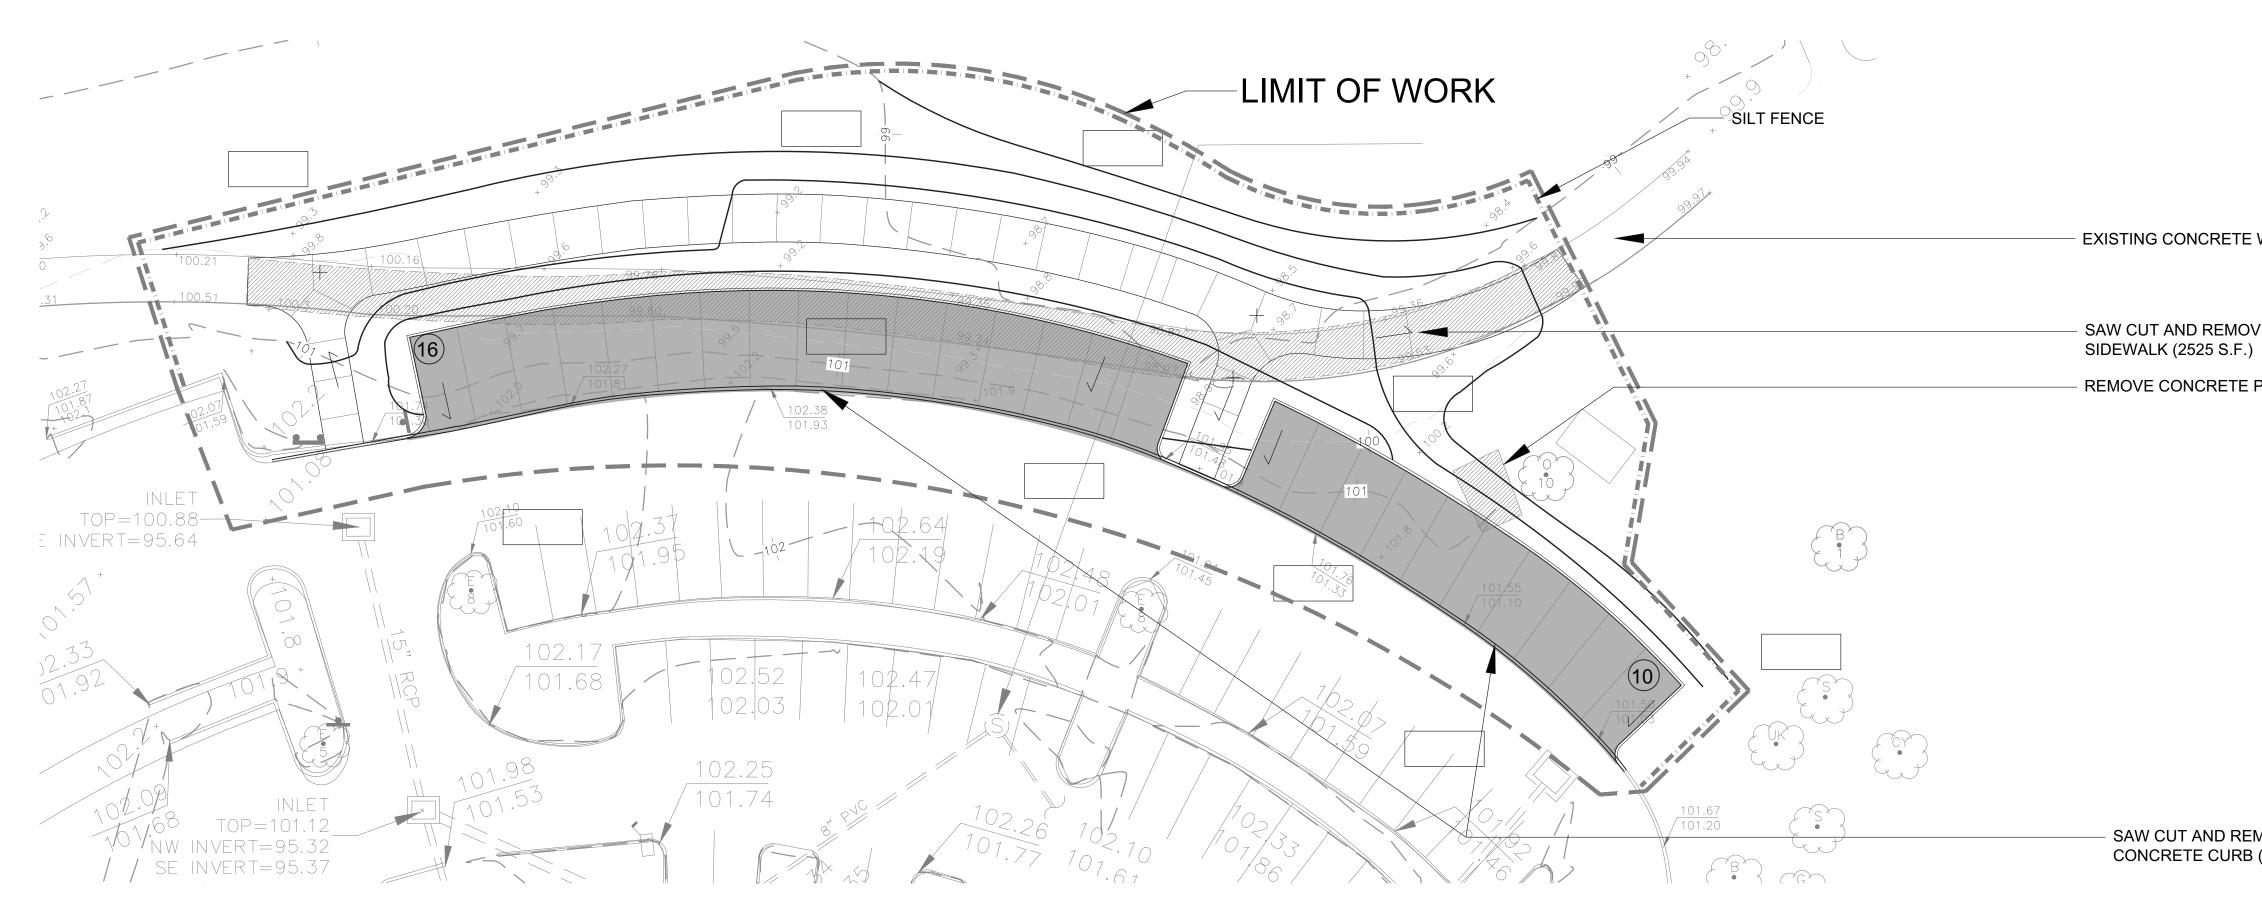

ADDITIVE 1 - NORTH PARKING AREA & WALKWAY



			ADC
2	09/28/2017	100% Submission	ARCHITECTURAL DESIGN
1	06/09/2017	60% Submission	COLLABORATIVE 945 N. PENNSYLVANIA AVENUE
NO.	DATE	REVISION	WINTER PARK, FLORIDA 32789 (407) 629-1188



TEAM Engineering, LLC



DEMOLITION PLAN **KEYED NOTES**

CONTRACTOR SHALL OBTAIN ADVANCE APPROVAL FROM PROJECT ENGINEERS FOR DIMENSIONS AND LIMITS OF DEMOLITION WORKS.

WHERE EXISTING PAVEMENT, CURB OR CONCRETE SLAB IS TO REMAIN, MAKE STRAIGHT SAW CUT INTO THE EXISTING STRUCTURE TO PROVIDE A CLEAN BREAK PRIOR TO REMOVAL.


REMOVE ALL DEBRIS FROM SITE IN ACCORDANCE WITH COUNTY'S STANDARD SPECIFICATIONS REQUIREMENTS FOR WASTE MATERIAL DISPOSAL.

CONTRACTOR SHALL IMMEDIATELY REPAIR ANY DAMAGE TO EXISTING STRUCTURES MADE DURING DEMOLITION. DAMAGED ITEMS SHALL BE RESTORED OR REBUILT.

CLEAR GRASS AREA NEEDED FOR CONSTRUCTION AND RESOD DISTURBED AREAS

NOTE: ALL DEMOLITION WORK SHOWN ON THIS SHEET TO BE INCLUDED IN ADDITIVE ITEM 1

- SAW CUT AND REMOVE TYPE D CONCRETE CURB (305 L.F.)

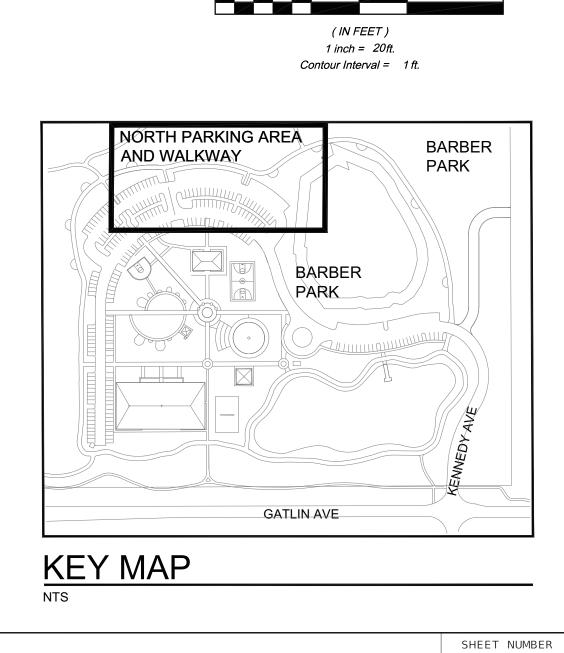

GRAPHIC SCALE




DEMOLITION PLAN - PARKING AREA ADDITIVE ONE



- EXISTING CONCRETE WALKWAY TO REMAIN

SAW CUT AND REMOVE EXISTING 10 FT. WIDE CONCRETE - REMOVE CONCRETE PAD (140 S.F.)

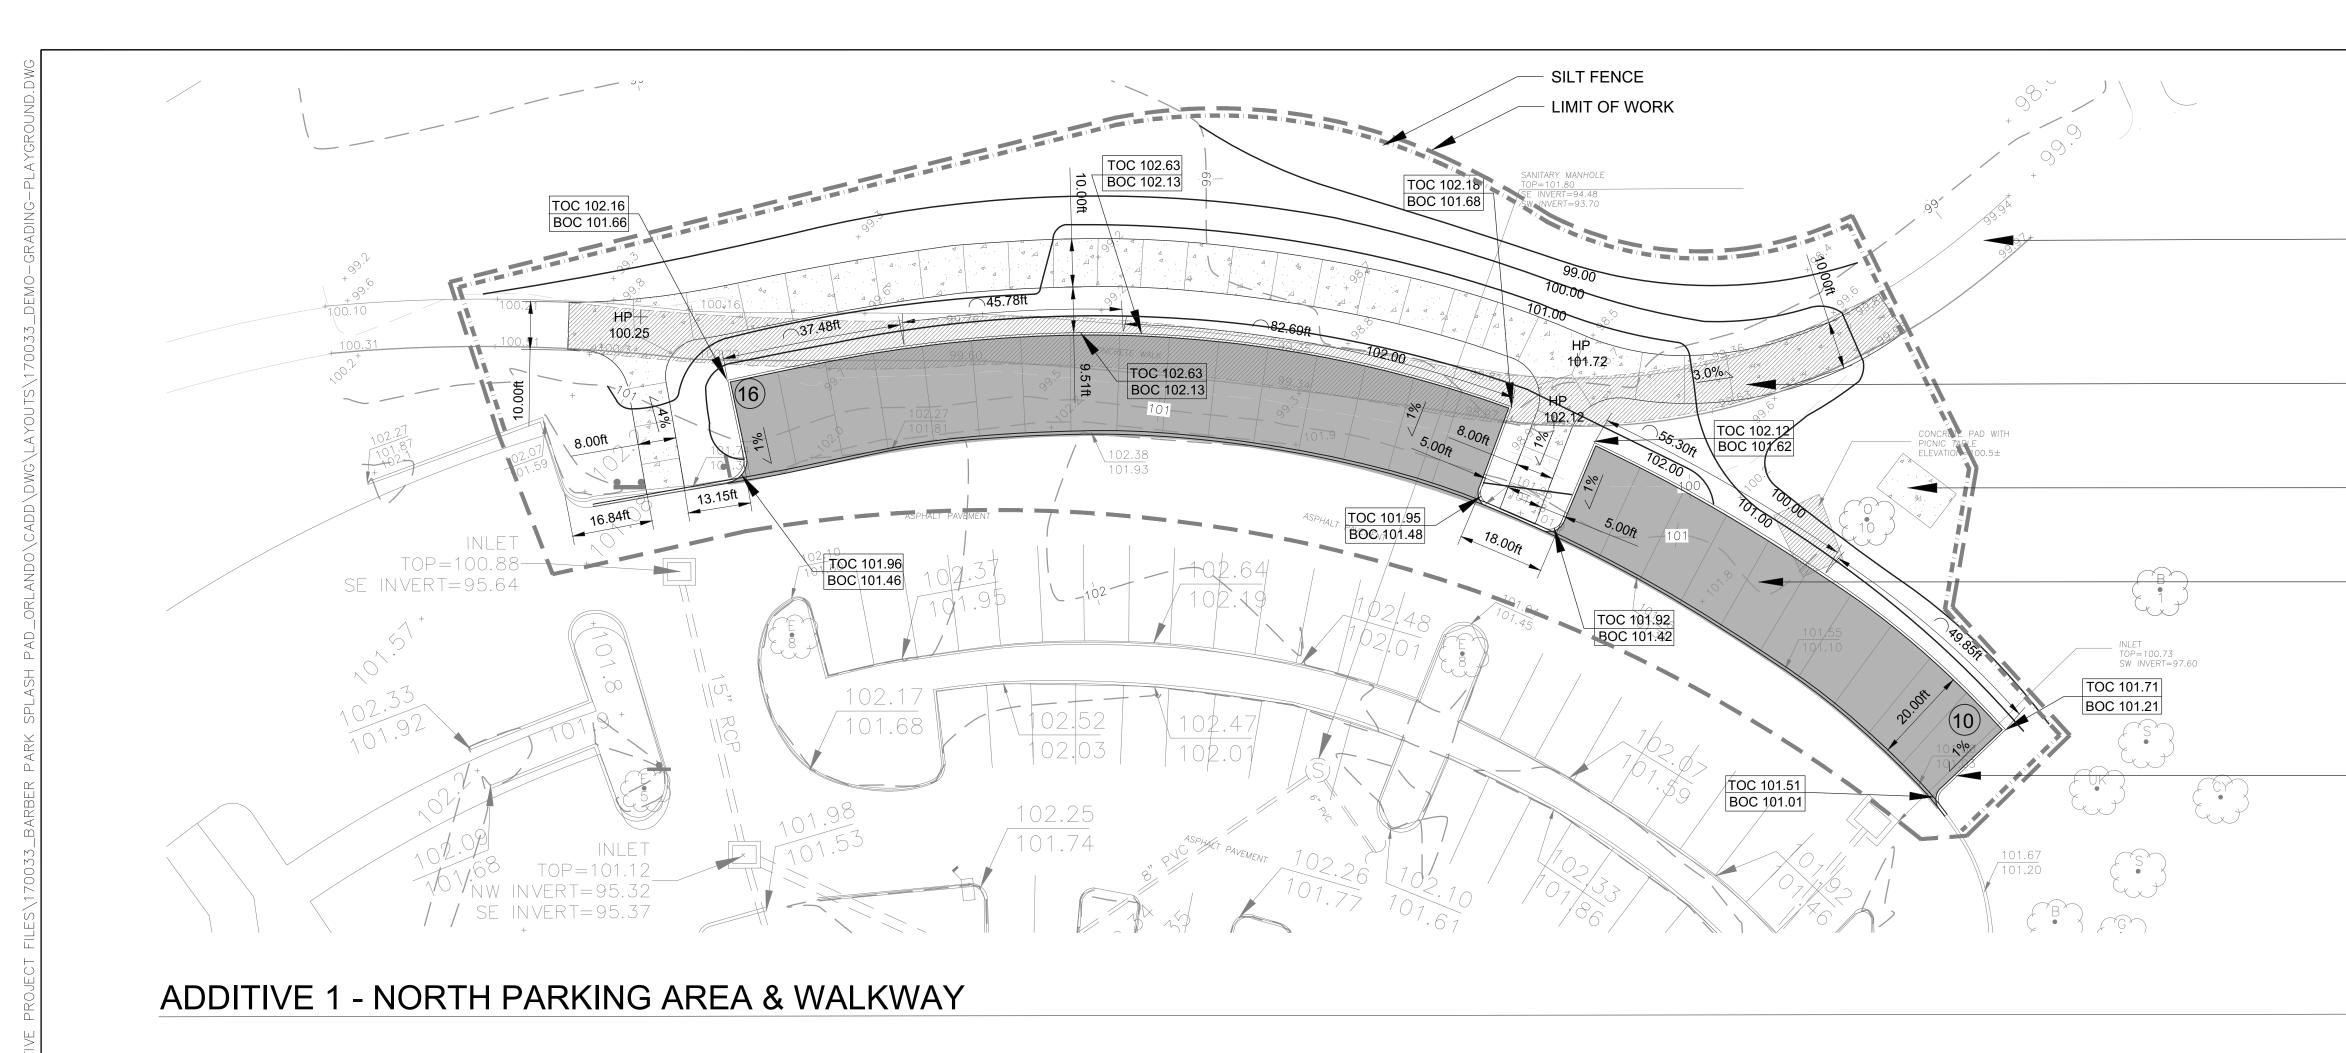



			Attactor
2	09/28/2017	100% Submission	ARCHITECTURAL DESIGN
1	06/09/2017	60% Submission	COLLABORATIVE 945 N. PENNSYLVANIA AVENUE
NO.	DATE	REVISION	WINTER PARK, FLORIDA 32789 (407) 629-1188

TEAM Engineering, LLC



NOTES: 1. ALL PAVING AND SIDEWALK WORK SHOWN ON THIS SHEET TO BE INCLUDED IN ADDITIVE ITEM 1

2. ALL SIDEWALKS TO HAVE A MAXIMUM RUNNING SLOPE OF 5% AND A MAXIMUM CROSS SLOPE OF 2%

- EXISTING CONCRETE WALKWAY TO REMAIN

CONSTRUCT CONCRETE WALKWAY 3100 SF


- CONSTRUCT 9'X14' CONCRETE PAD 126 SF. REINSTALL EXISTING PICNIC TABLE

- INSTALL ASPHALT PAVEMENT 5435 SF

- CONSTRUCT TYPE D CONCRETE CURB 405 LF

GRAPHIC SCALE

(IN FEET) 1 inch = 20ft. Contour Interval = 1 ft.

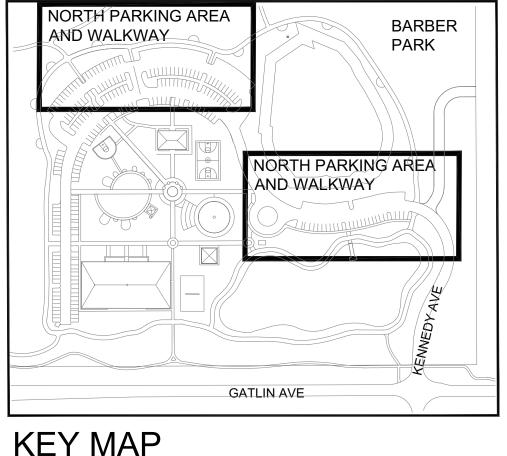






GRADING PLAN - PARKING AREA ADDITIVE ONE



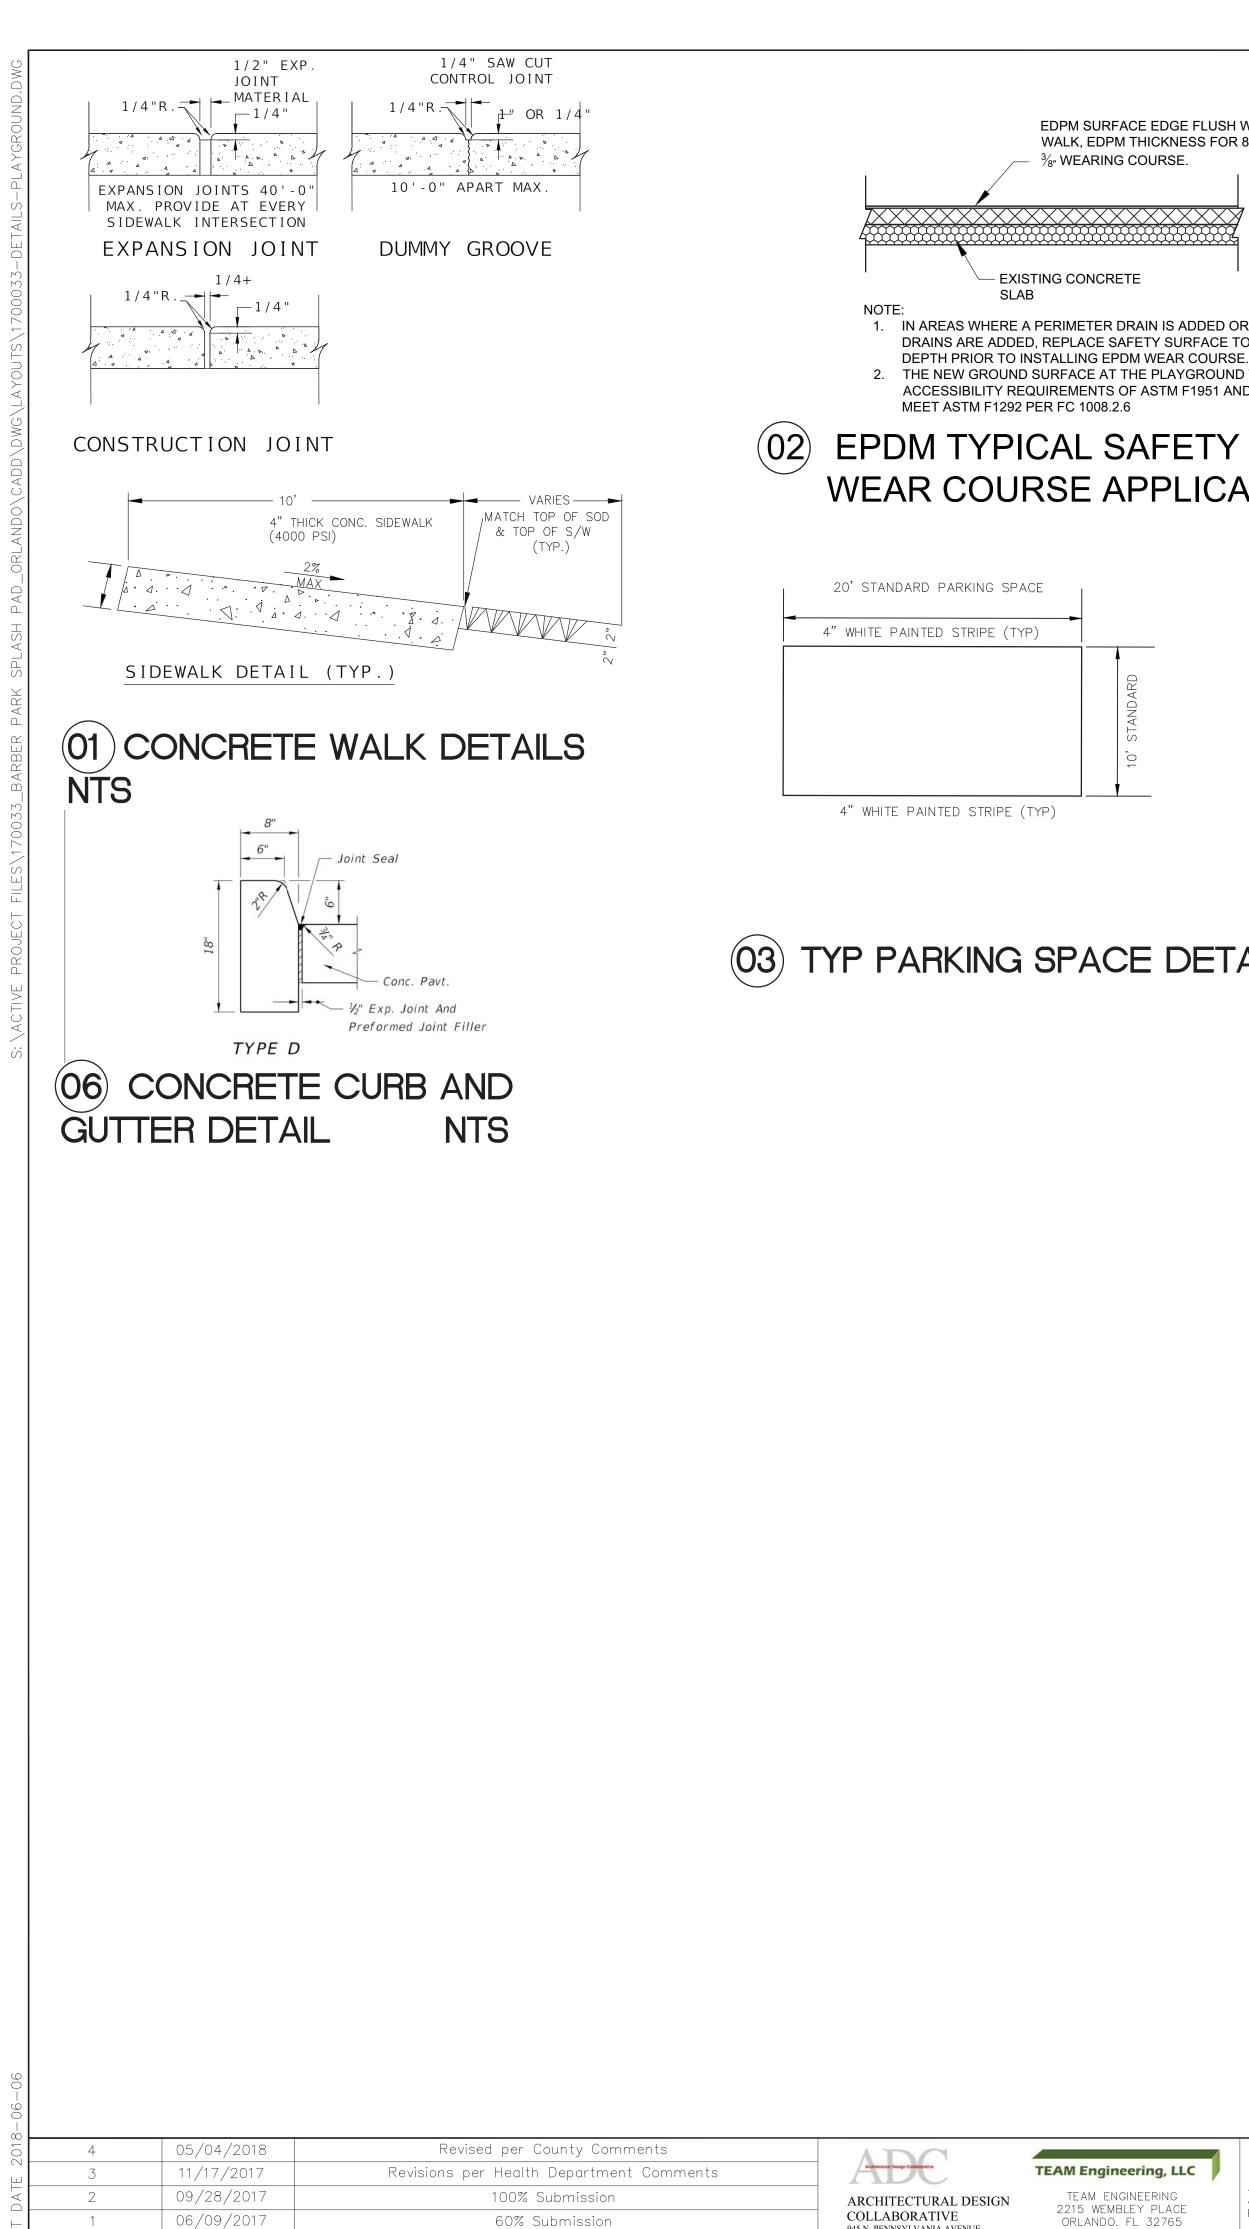

REVISION

NO.

DATE

EDPM SURFACE EDGE FLUSH WITH CONCRETE WALK, EDPM THICKNESS FOR 8' FALL HEIGHT WITH ³/_{8"} WEARING COURSE.

1. IN AREAS WHERE A PERIMETER DRAIN IS ADDED OR WHERE UNDER DRAINS ARE ADDED, REPLACE SAFETY SURFACE TO A MATCHING 2. THE NEW GROUND SURFACE AT THE PLAYGROUND WILL MEET ACCESSIBILITY REQUIREMENTS OF ASTM F1951 AND USE ZONES WILL

EPDM TYPICAL SAFETY SURFACE WEAR COURSE APPLICATION NTS

1 1/2"ASPHALTIC CONCRETE WEA SURFACE F.D.O.T. TYPE S-9.5 SURFACE COURSE TO BE CONST IN ACCORDANCE WITH F.D.O.T. SPECIFICATION SECTIONS 330,33	RUCTED
	PRIME COAT - ASPHALT EMULTION TYPE RS-2 OR LIQUID ASPHALT RC-70 OR RC-250
	8" LIMEROCK BASE WITH MINIMUM LBR100 COMPACTED TO 98% OF MAXIMUM DENSITY AS DETERMINED BY AASHTO T-180 LIMEROCK TO CONFORM WITH F.D.O.T. SPECIFICATION SECTIONS 200 AND 90, OR RECYCLED CRUSHED CONCRETE
	12" SUB BASE WITH MINIMUN LBR 40 COMPACTED TO 98% OF MAXIMUM DENSITY AS DETERMINED BY AASHTO



T-180.




TYP PARKING SPACE DETAIL NTS

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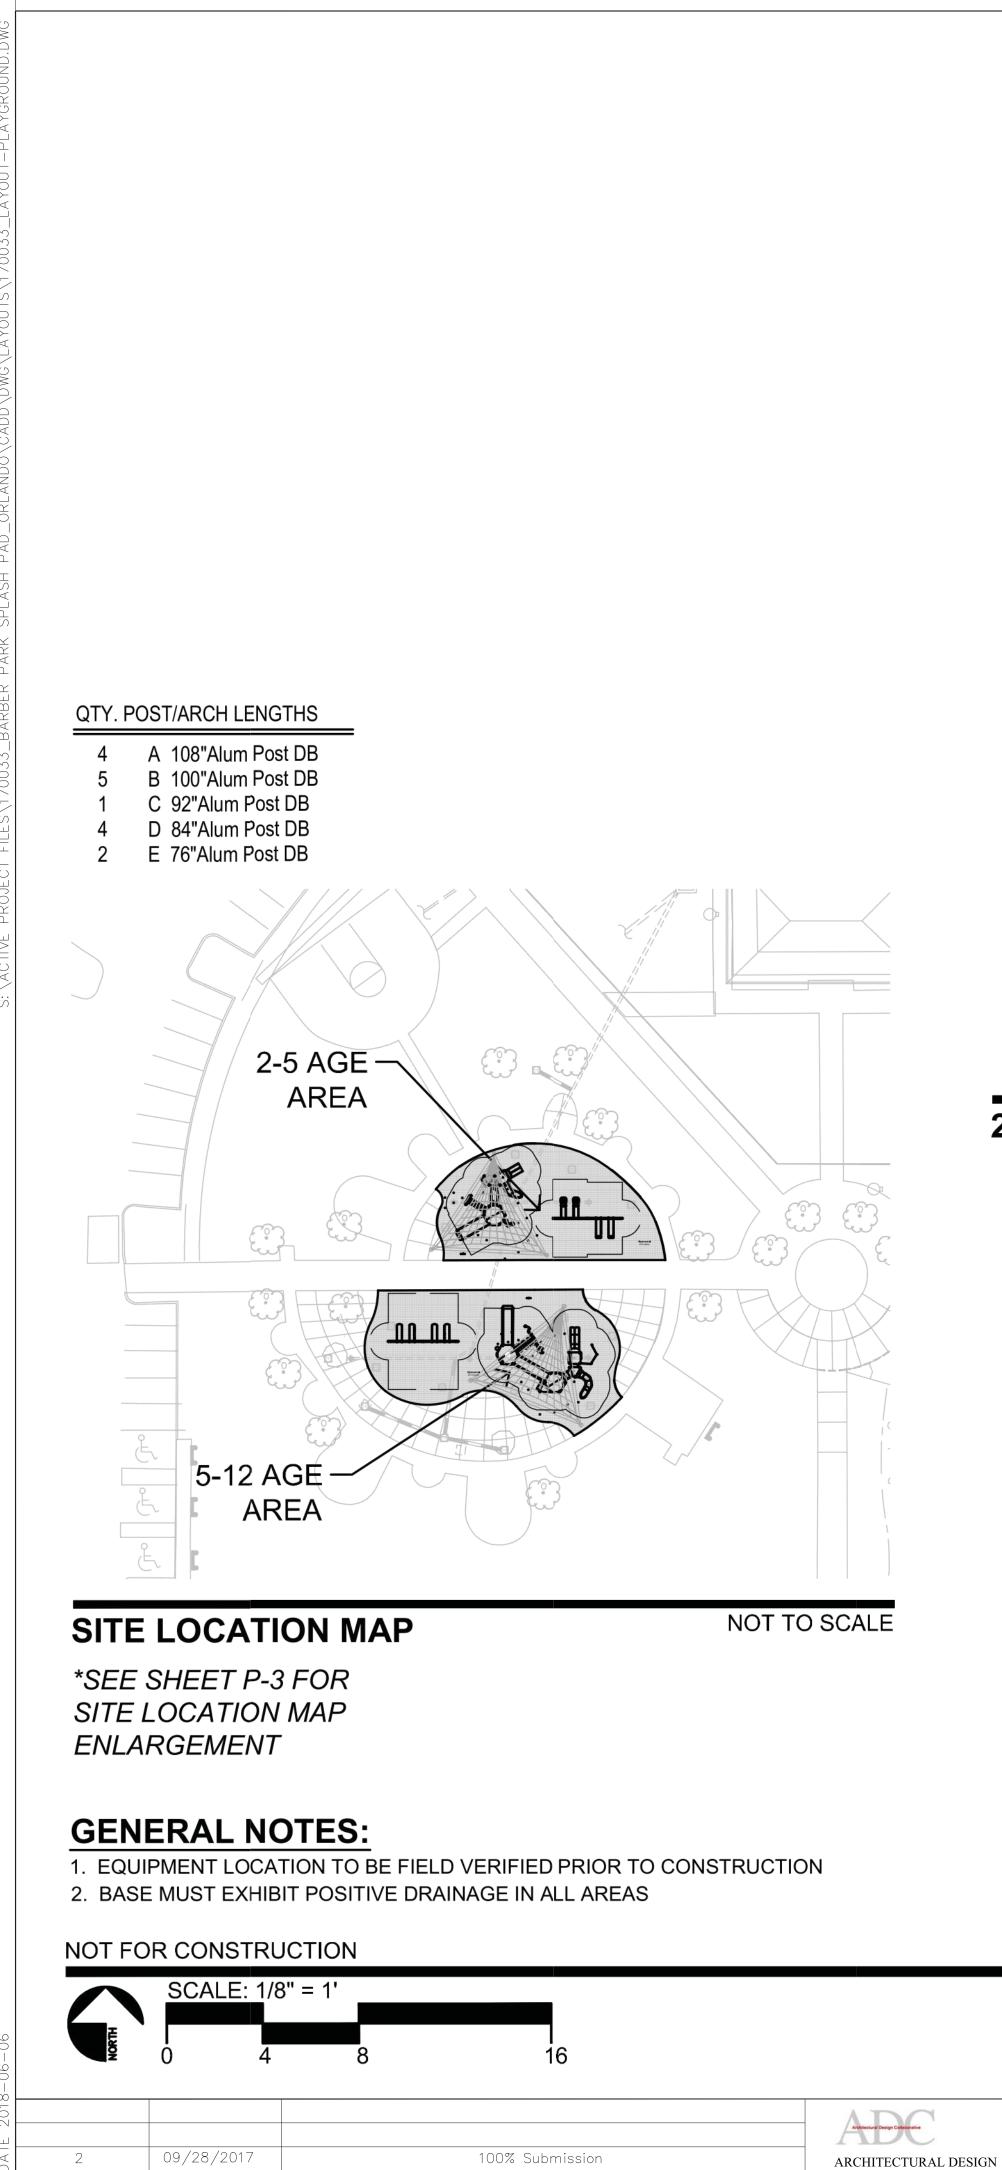




HANDICAP RAMP AND DETECTABLE WARNING (05) SURFACE DETAILS NTS

DETAILS - CONSTRUCTION

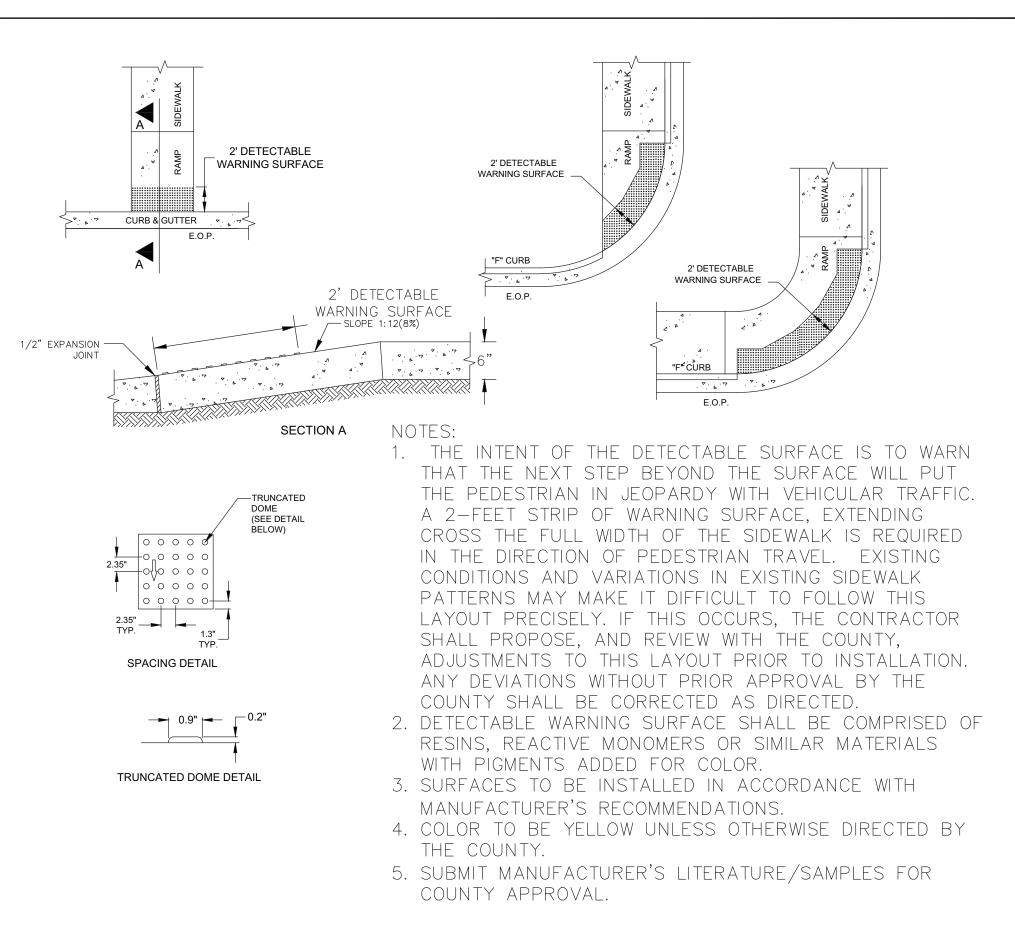SHEET NUMBER



60% Submissior


REVISION

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NO.

06/09/2017

DATE

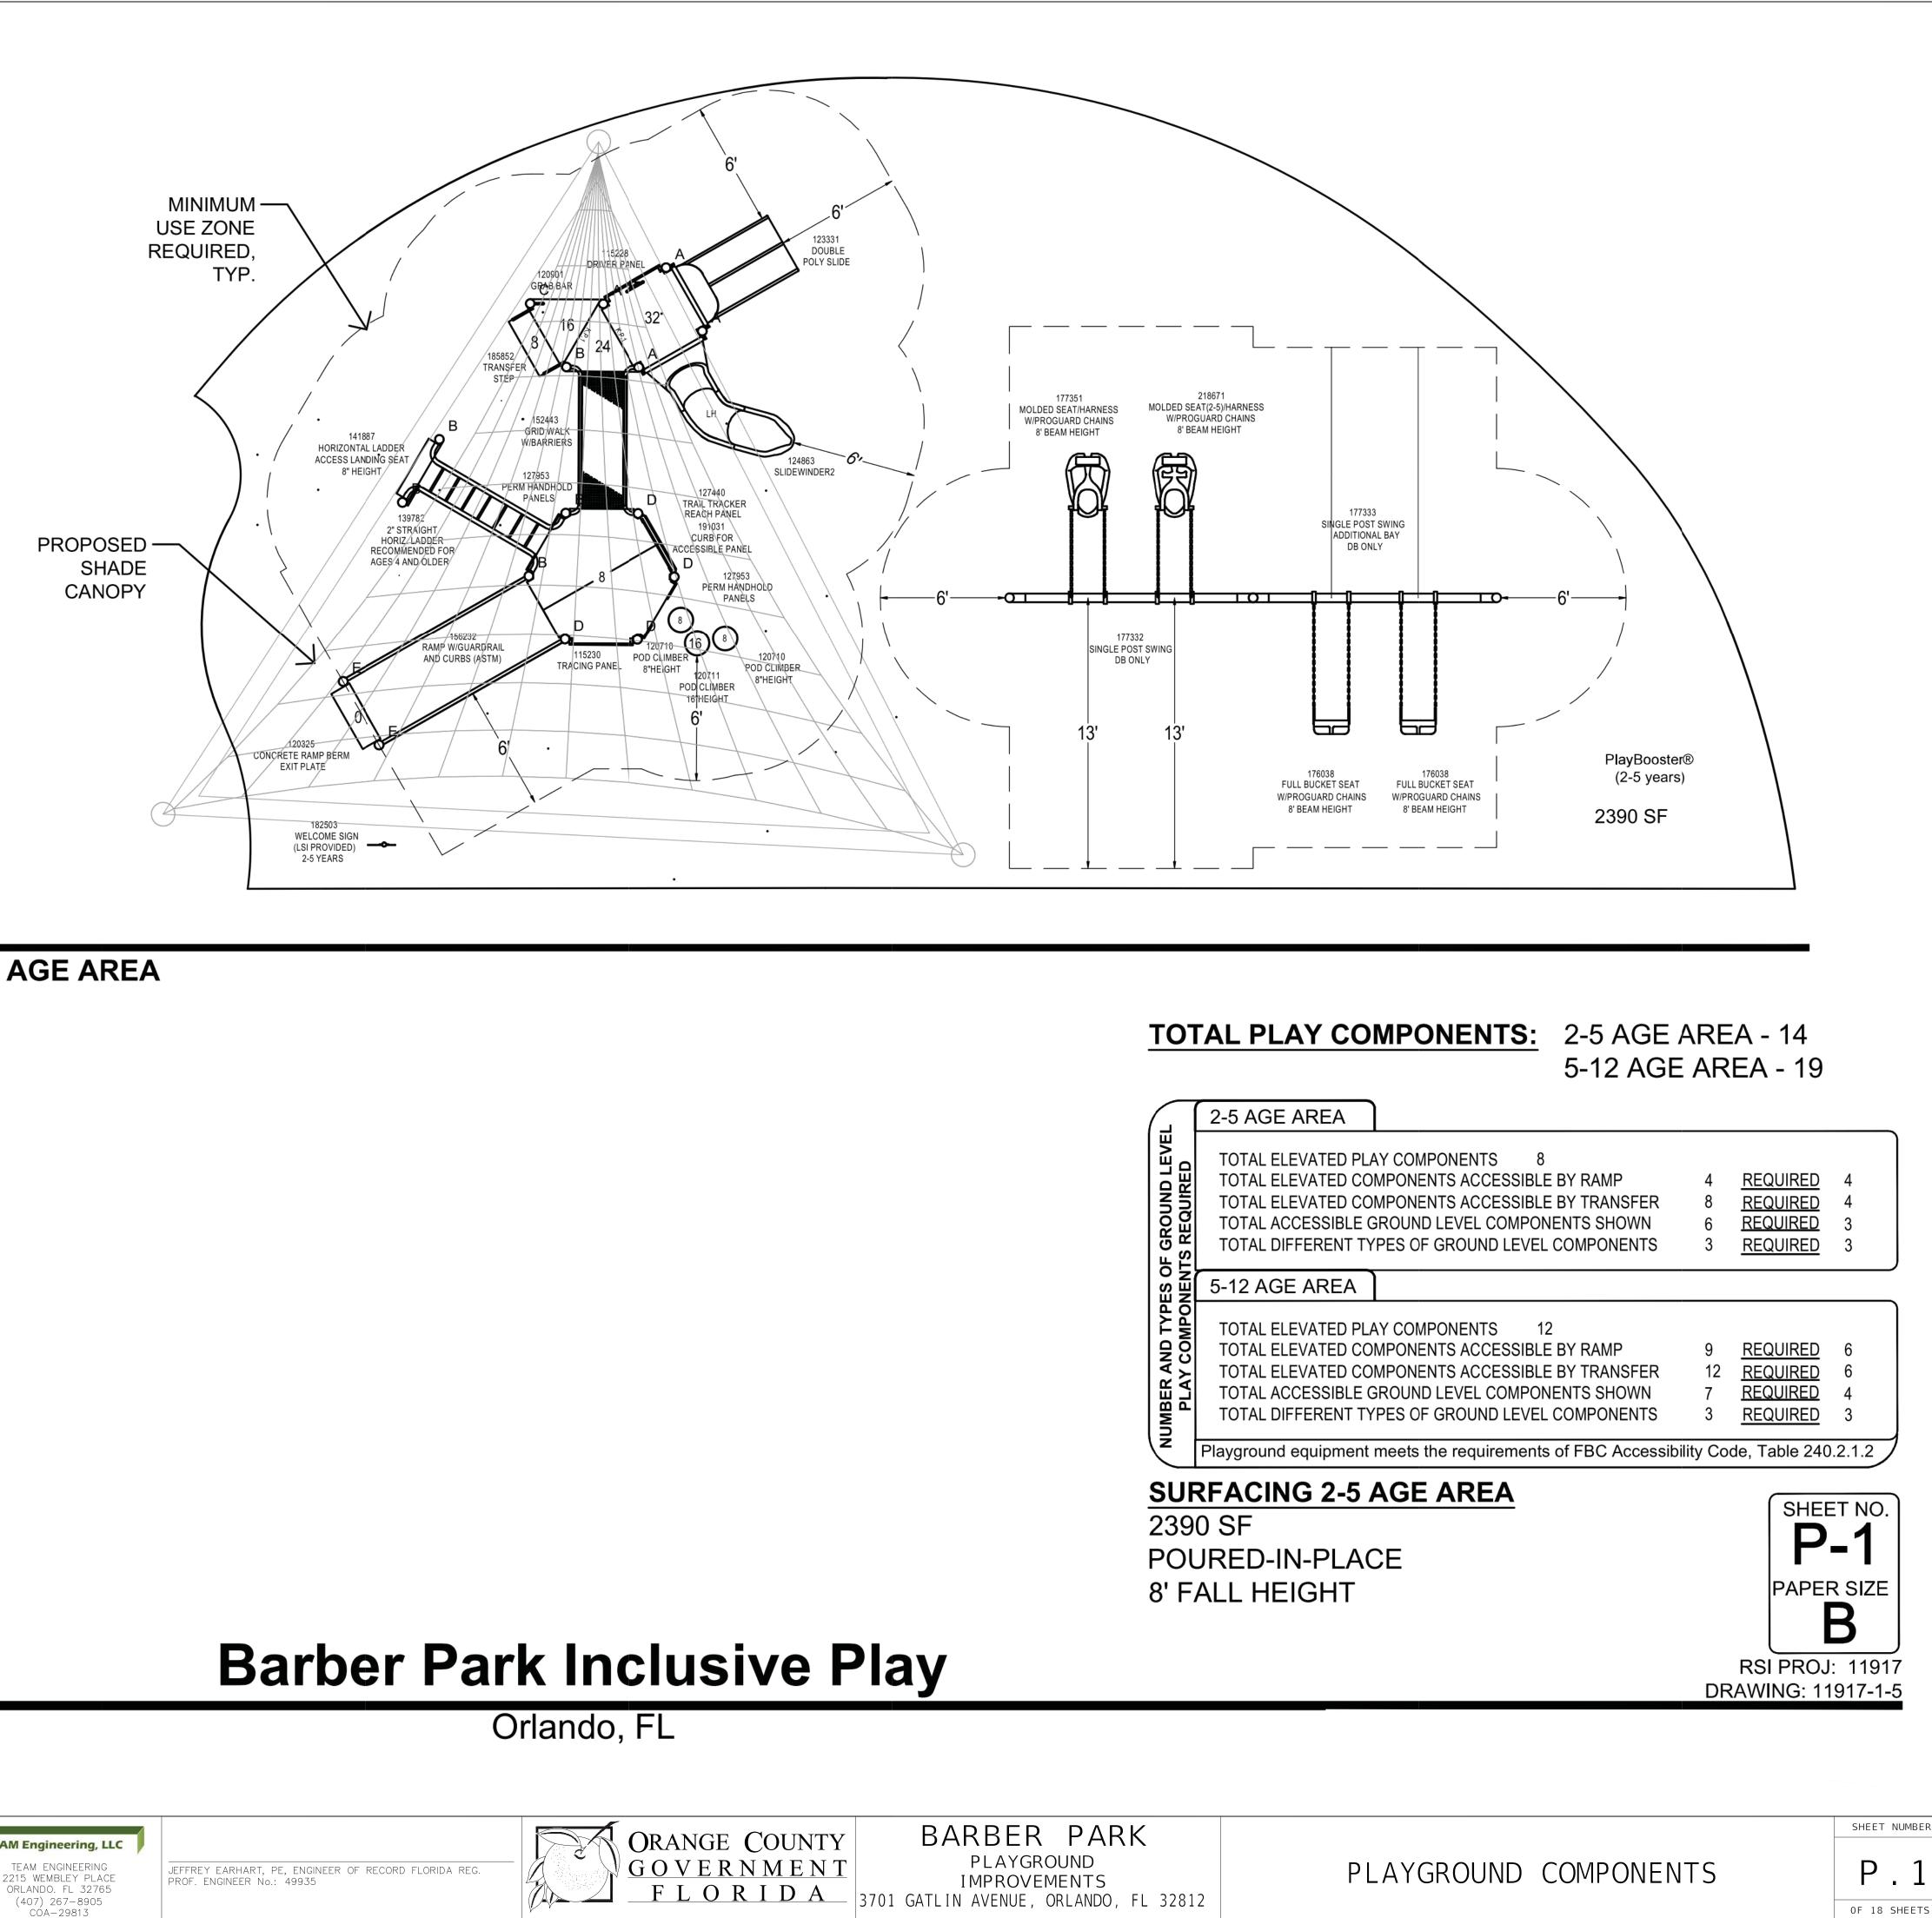

2-5 AGE AREA

TEAM Engineering, LLC


COLLABORATIVE


(407) 629-1188

945 N. PENNSYLVANIA AVENU WINTER PARK, FLORIDA 32789





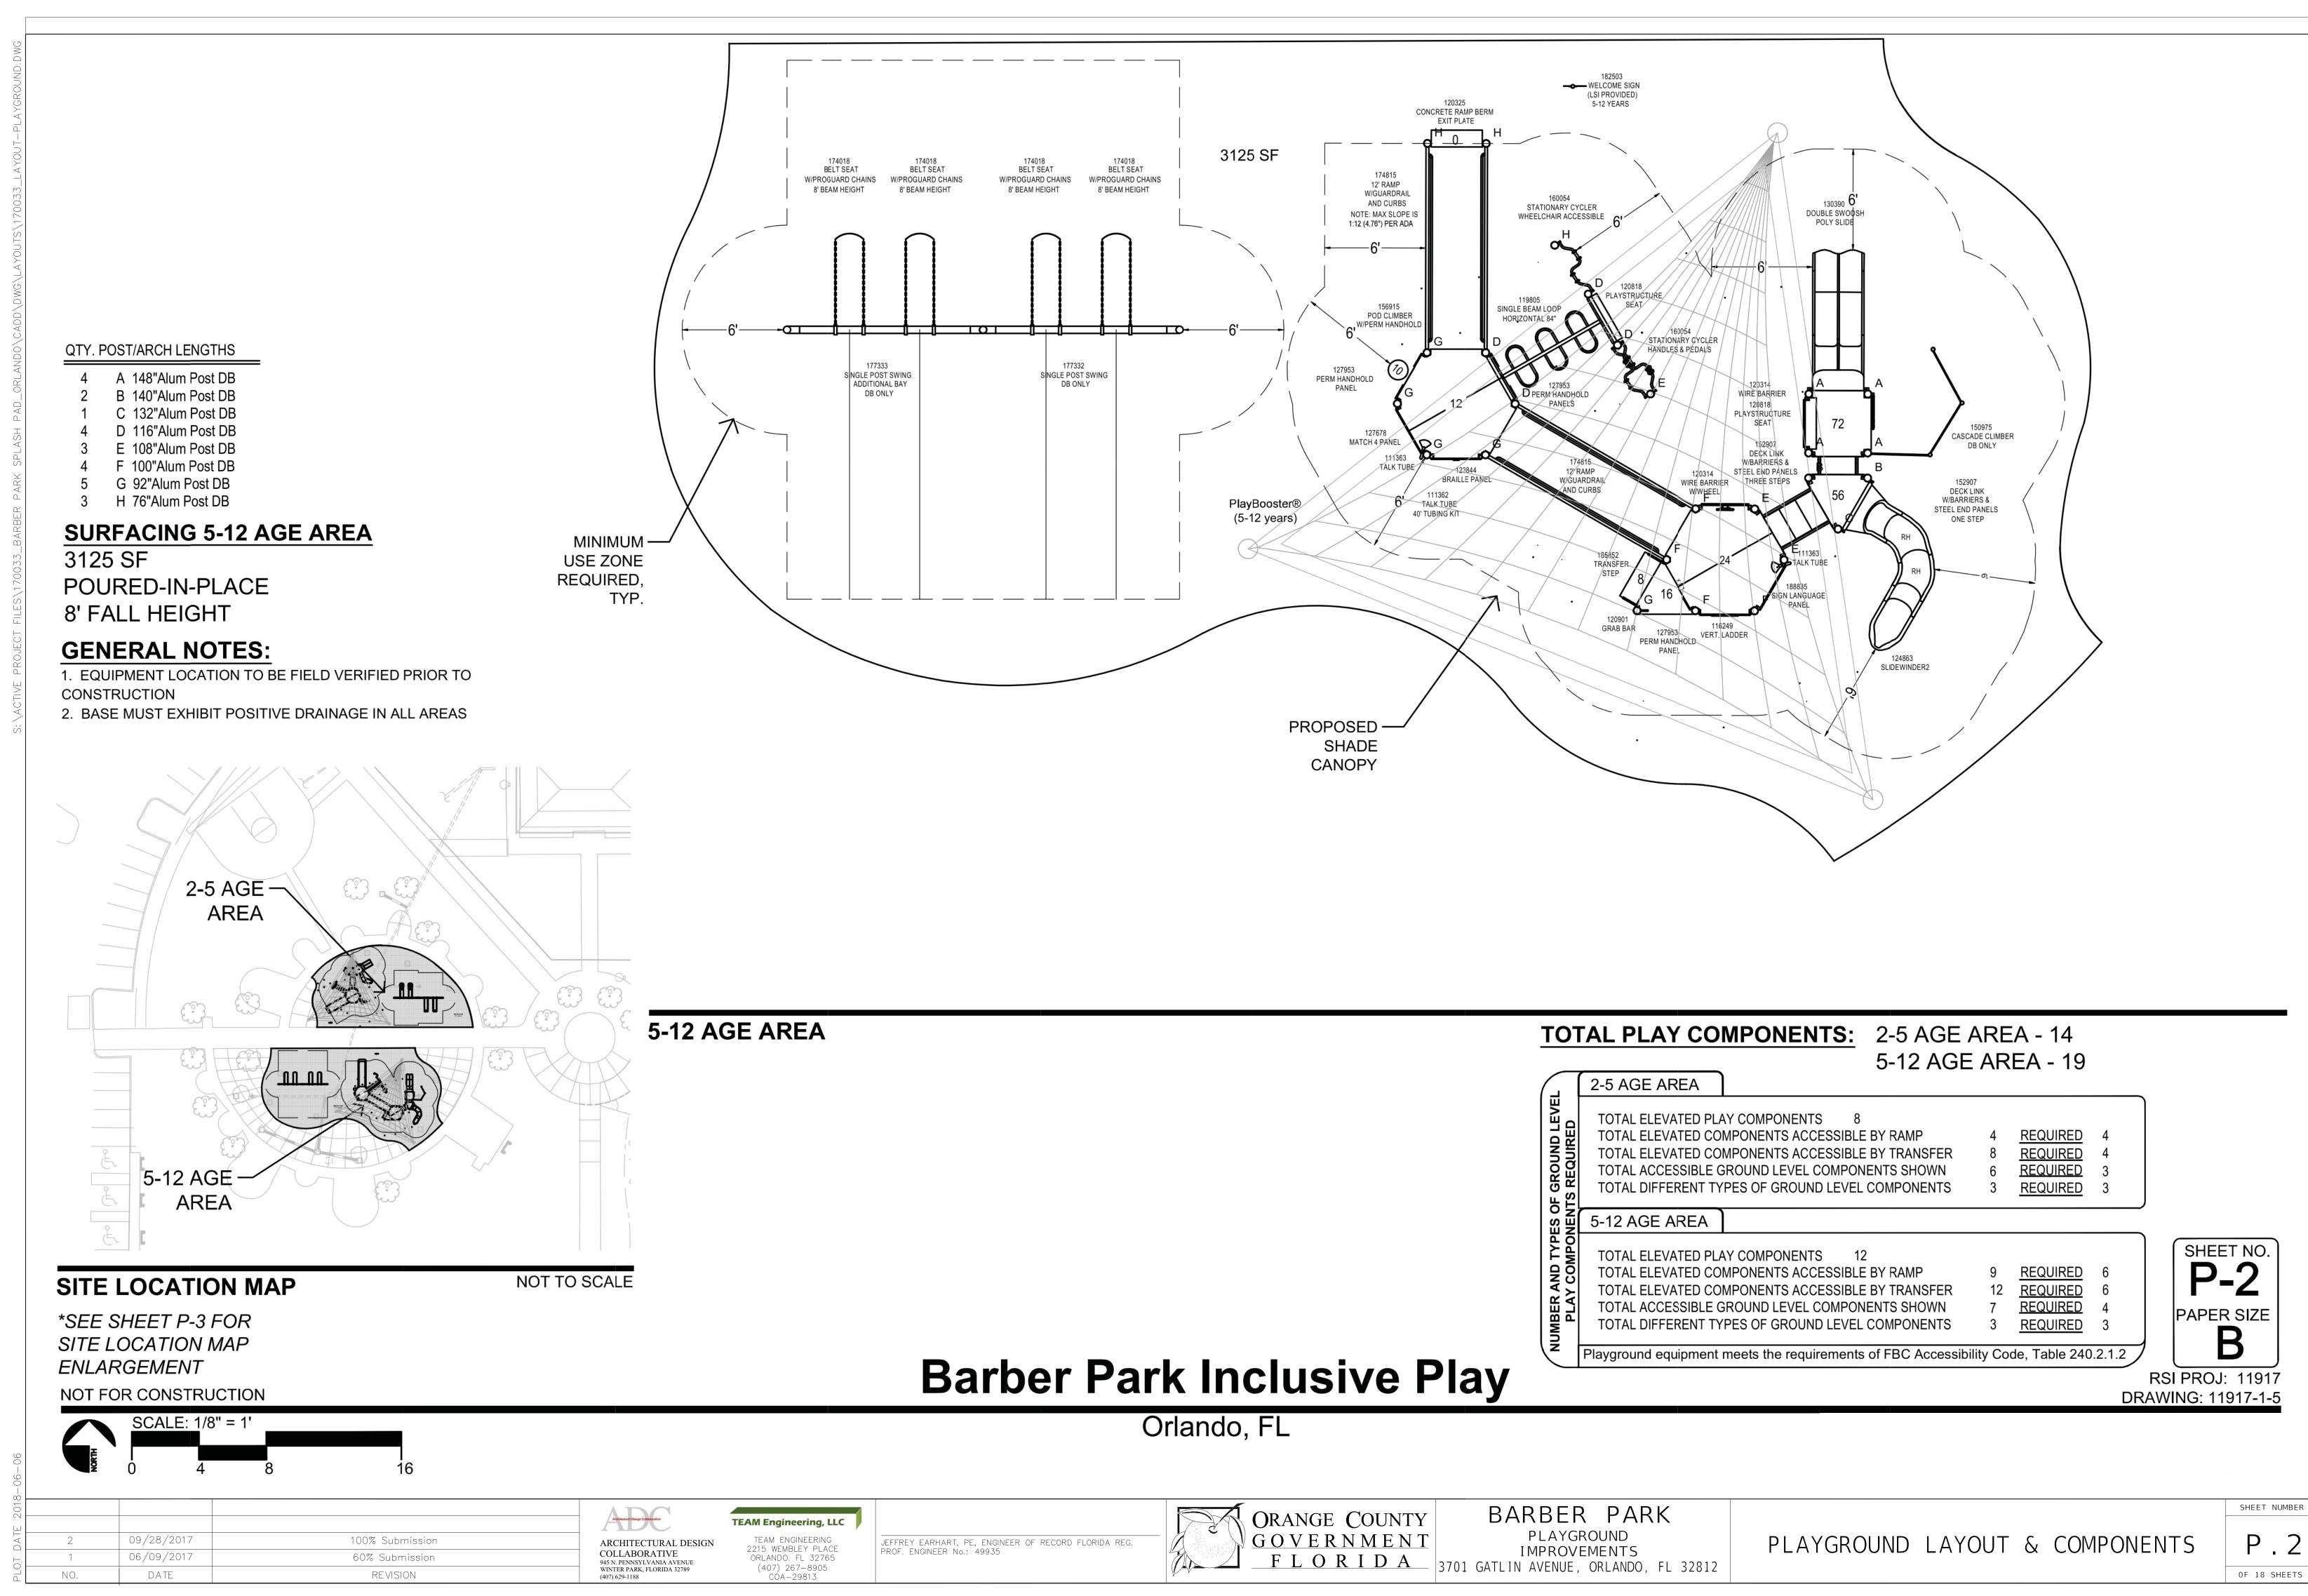

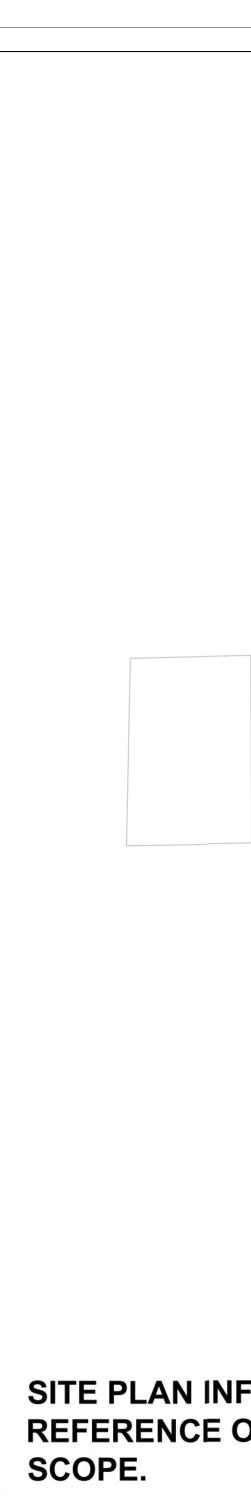

SITE PLAN INFORMATION SHOWN FOR **REFERENCE ONLY. NOT PART OF THIS SURFACING 2-5 AGE AREA**

2390 SF POURED-IN-PLACE 8' FALL HEIGHT **SURFACING 5-12 AGE AREA** 3125 SF POURED-IN-PLACE 8' FALL HEIGHT

GENERAL NOTES:

1. EQUIPMENT LOCATION TO BE FIELD VERIFIED PRIOR TO CONSTRUCTION 2. BASE MUST EXHIBIT POSITIVE DRAINAGE IN ALL AREAS

32

100% Submission

60% Submission

REVISION

NOT FOR CONSTRUCTION <u>SCALE: 1/16" = 1'</u>

09/28/2017

06/09/2017

DATE


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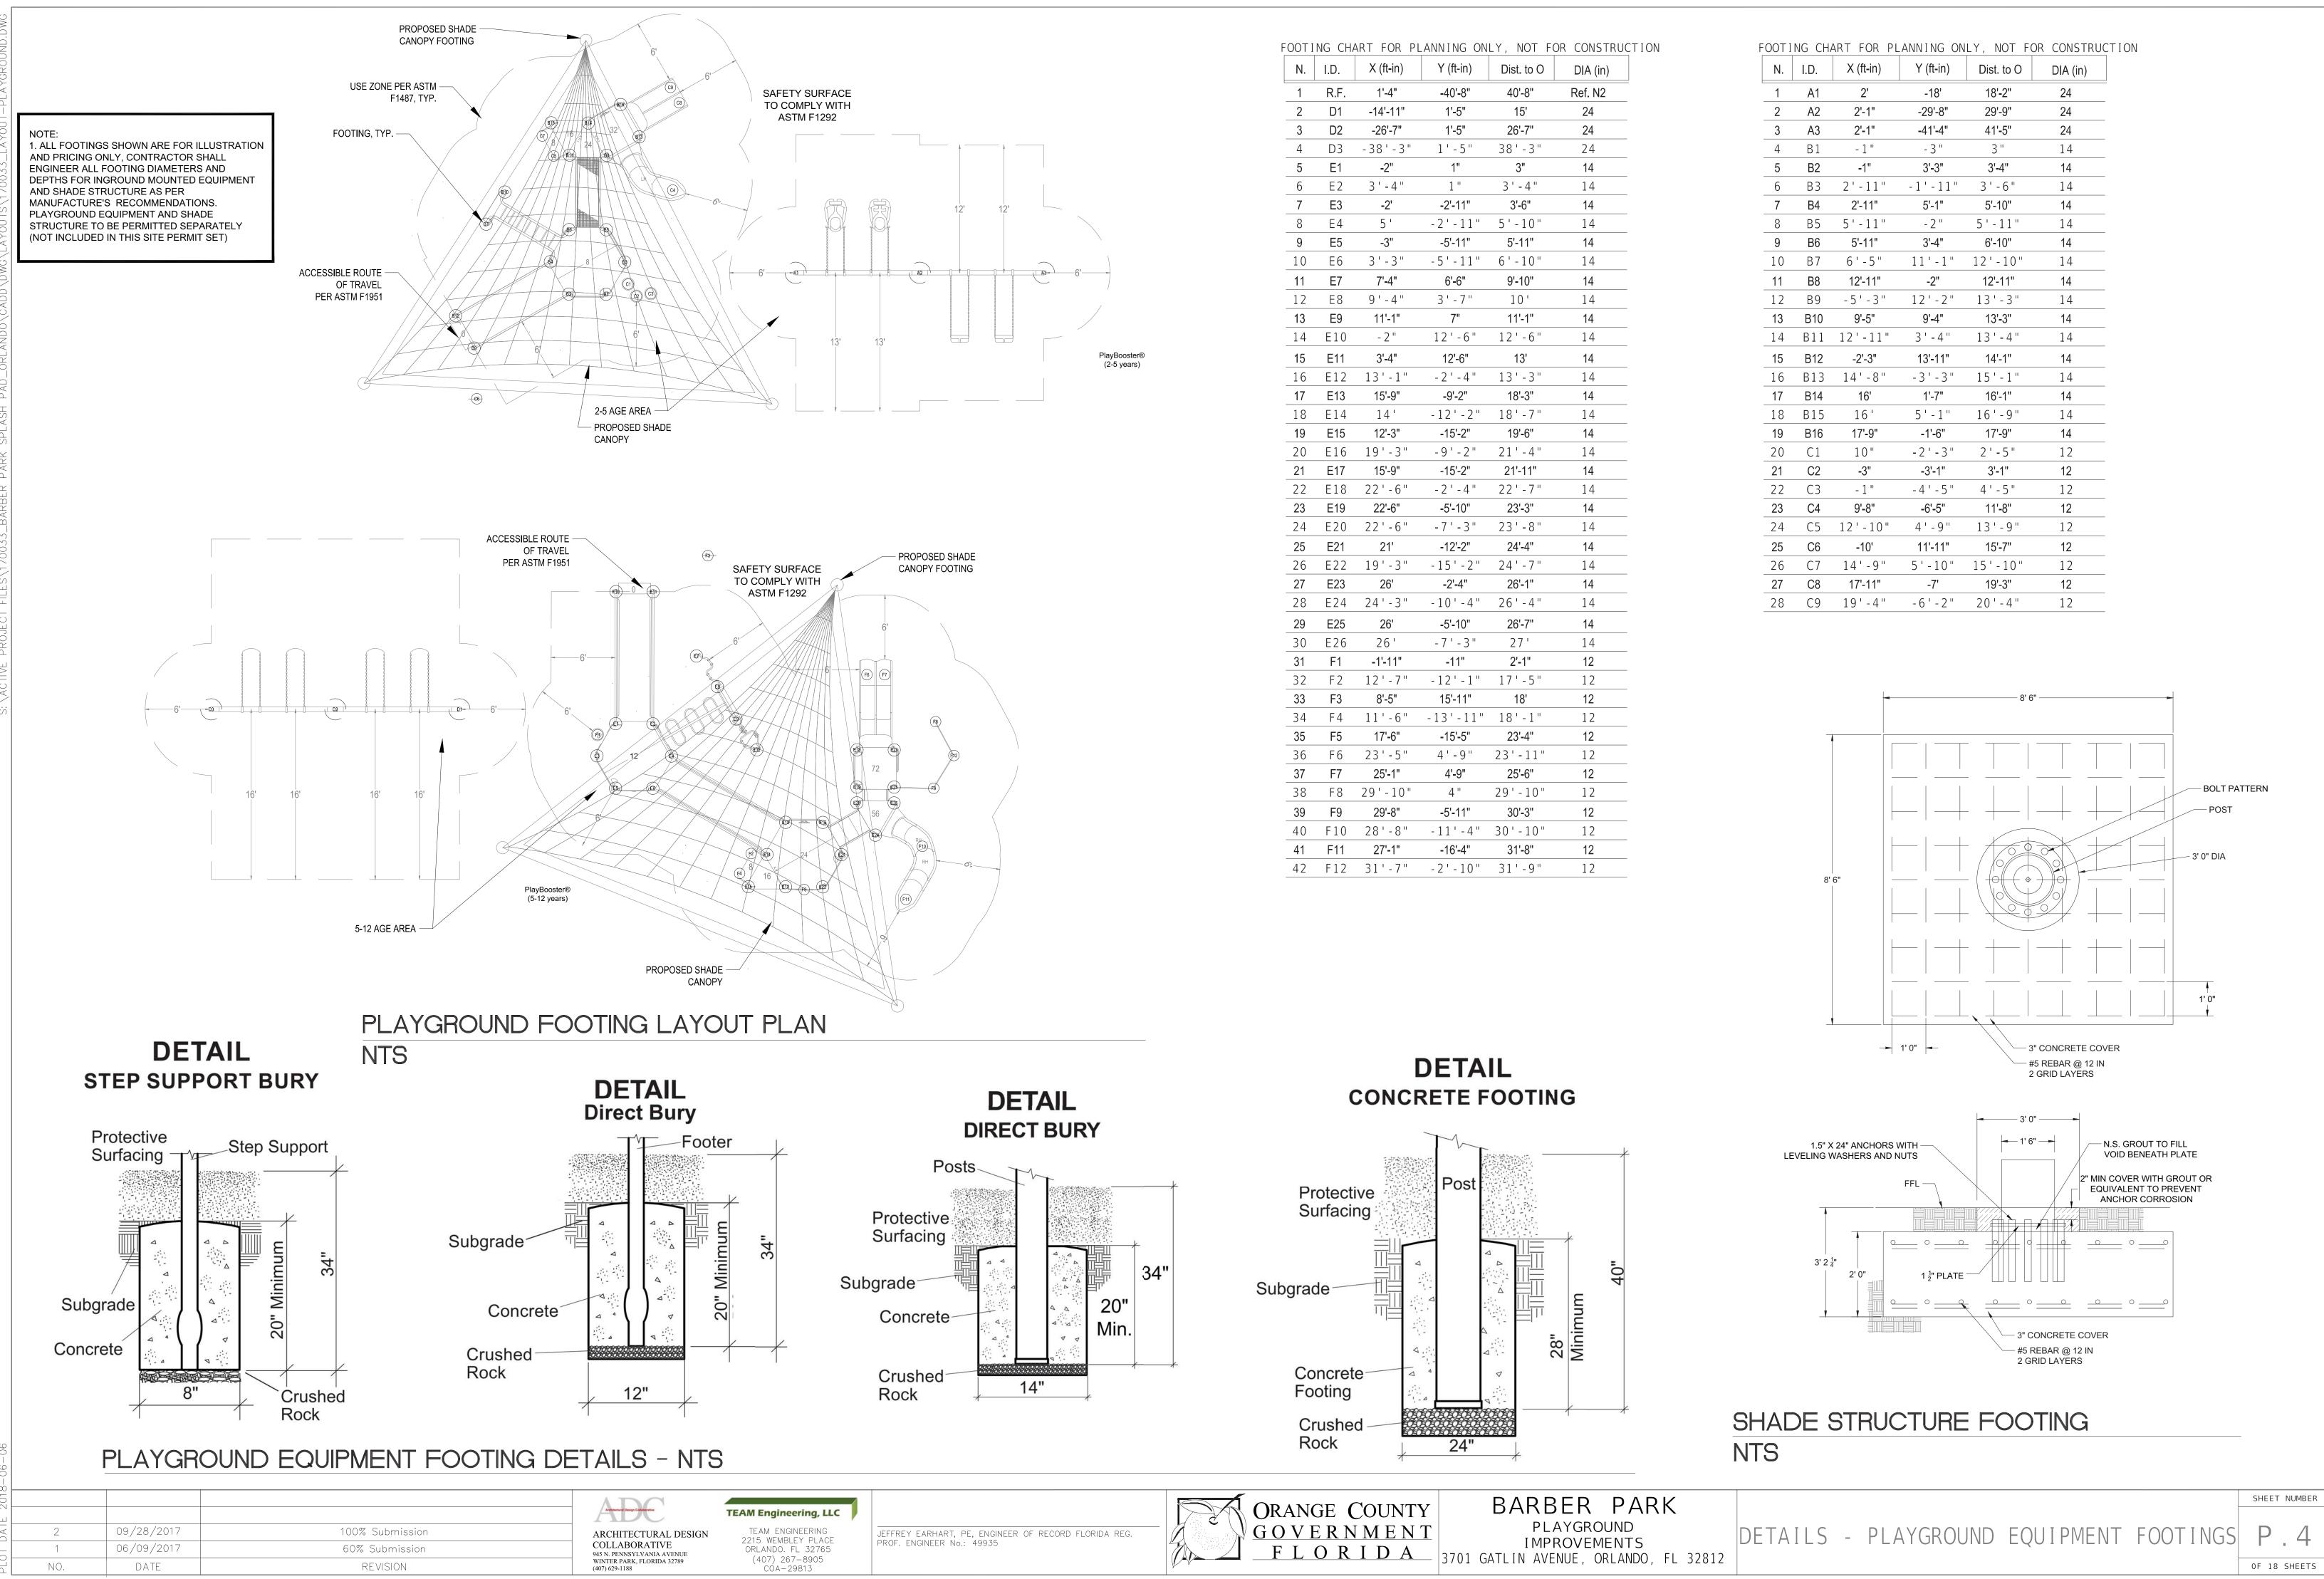
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FOOTI	NG CH	ART FOR PI	ANNING ON	LY, NOT F	OR CONSTR
N.	I.D.	X (ft-in)	Y (ft-in)	Dist. to O	DIA (in)
1	R.F.	1'-4"	-40'-8"	40'-8"	Ref. N2
2	D1	-14'-11"	1'-5"	15'	24
3	D2	-26'-7"	1'-5"	26'-7"	24
4	D3	-38'-3"	1'-5"	38'-3"	24
5	E1	-2"	1"	3"	14
6	E2	3 ' - 4 "	1 "	3 ' - 4 "	14
7	E3	-2'	-2'-11"	3'-6"	14
8	E4	5 '	-2'-11"	5'-10"	14
9	E5	-3"	-5'-11"	5'-11"	14
10	E6	3'-3"	-5'-11"	6'-10"	14
11	E7	7'-4"	6'-6"	9'-10"	14
12	E8	9 ' - 4 ''	3'-7"	10'	14
13	E9	11'-1"	7"	11'-1"	14
14	E10	- 2 "	12'-6"	12'-6"	14
15	E11	3'-4"	12'-6"	13'	14
16	E12	13'-1"	- 2 ' - 4 "	13'-3"	14
17	E13	15'-9"	-9'-2"	18'-3"	14
18	E14	14 '	-12'-2"	18'-7"	14
19	E15	12'-3"	-15'-2"	19'-6"	14
20	E16	19'-3"	-9'-2"	21'-4"	14
21	E17	15'-9"	-15'-2"	21'-11"	14
22	E18	22'-6"	-2'-4"	22'-7"	14
23	E19	22'-6"	-5'-10"	23'-3"	14
24	E20	22'-6"	-7'-3"	23'-8"	14
25	E21	21'	-12'-2"	24'-4"	14
26	E22	19'-3"	-15'-2"	24'-7"	14
27	E23	26'	-2'-4"	26'-1"	14
28	E24	24'-3"	-10'-4"	26'-4"	14
29	E25	26'	-5'-10"	26'-7"	14
30	E26	26 '	-7'-3"	27'	14
31	F1	-1'-11"	-11"	2'-1"	12
32	F 2	12'-7"	-12'-1"	17'-5"	12
33	F3	8'-5"	15'-11"	18'	12
34	F 4	11'-6"	-13'-11"	18'-1"	12
35	F5	17'-6"	-15'-5"	23'-4"	12
36	F6	23'-5"	4'-9"	23'-11"	12
37	F7	25'-1"	4'-9"	25'-6"	12
38	F8	29'-10"	4 "	29'-10"	12
39	F9	29'-8"	-5'-11"	30'-3"	12
40	F10	28'-8"	-11'-4"	30'-10"	12
41	F11	27'-1"	-16'-4"	31'-8"	12
42	F12	31'-7"	-2'-10"	31'-9"	12

1	A1	2'	-18'	18'-2"	24
2	A2	2'-1"	-29'-8"	29'-9"	24
3	A3	2'-1"	-41'-4"	41'-5"	24
4	B1	- 1 "	- 3 "	3 "	14
5	B2	-1"	3'-3"	3'-4"	14
6	B3	2'-11"	-1'-11"	3'-6"	14
7	B4	2'-11"	5'-1"	5'-10"	14
8	B5	5'-11"	- 2 "	5 ' - 11 "	14
9	B6	5'-11"	3'-4"	6'-10"	14
10	Β7	6'-5"	11'-1"	12'-10"	14
11	B8	12'-11"	-2"	12'-11"	14
12	В9	-5'-3"	12'-2"	13'-3"	14
13	B10	9'-5"	9'-4"	13'-3"	14
14	B11	12'-11"	3'-4"	13'-4"	14
15	B12	-2'-3"	13'-11"	14'-1"	14
16	B13	14'-8"	-3'-3"	15'-1"	14
17	B14	16'	1'-7"	16'-1"	14
18	B15	16'	5'-1"	16'-9"	14
19	B16	17'-9"	-1'-6"	17'-9"	14
20	C1	10"	-2'-3"	2 ' - 5 "	12
21	C2	-3"	-3'-1"	3'-1"	12
22	С3	- 1 "	-4'-5"	4 ' - 5 "	12
23	C4	9'-8"	-6'-5"	11'-8"	12
24	C5	12'-10"	4 ' - 9 "	13'-9"	12
25	C6	-10'	11'-11"	15'-7"	12
26	С7	14'-9"	5'-10"	15'-10"	12
27	C8	17'-11"	-7'	19'-3"	12
28	С9	19'-4"	-6'-2"	20'-4"	12

Play	Booster® (2-5	years)	1	150975B	Cascade Climber 72"Dk DB Only
Slide	25		1	152907A	Deck Link w/Barriers Steel end panels 1 Step
1	123331A	Double Slide 32"Dk DB	1	152907C	Deck Link w/Barriers Steel end panels 3 Steps
1	124863A	SlideWinder2 32"Dk DB	1	156915A	Pod Climber 16"Dk DB Left Mounted Handhold
Over	head Events		1	116249A	Vertical Ladder 24"Dk DB
1	139782A	2"Horizontal Ladder Connected Between Decks	Ove	rhead Events	
1	141887A	Access/Landing Assembly Seat Barrier Right 8"Dk	1	119805A	Single Beam Loop Horiz Lad 84"Connected Between Decks Bridges & Ramp
Brid	ges & Ramps		2	174815A	12' Ramp w/Guardrails and Curbs
1	152443A	Grid Walk w/Barriers	1	120325A	Ramp Berm Exit Plate
1	120325A	Ramp Berm Exit Plate	Con	crete Wall	30.0 340.00
1	156232A	Ramp w/Guardrails w/Curbs Meets ASTM	Encl	osures	
Enclo	osures		1	123844A	Braille Panel Above Deck
1	191031A	Accessible Panel Curb	2	127953B	Handhold Panel
1	115228A	Driver Panel Above Deck	1	127953A	Handhold Panel Set
2	127953A	Handhold Panel Set	1	127678A	Match 4 Panel Above Deck
1	115230A	Tracing Panel Above Deck	1	188835A	Sign Language Panel Above Deck
1	127440A	Trail Tracker Reach Panel Above Deck	1	120314A	Wire Barrier Above Deck
Moti	ion & More Fu	in	1	120314B	Wire Barrier w/Wheel Above Deck
1	120901A	Grab Bar	Mot	ion & More Fu	un
Deck	S		1	120901A	Grab Bar
1	178710A	Hexagon Tenderdeck	2	120818A	Playstructure Seat
2	121948A	Kick Plate 8"Rise	1	160054D	Stationary Cycler Accessible Handles Only
1	111228A	Square Tenderdeck	1	160054C	Stationary Cycler Pedals & Handles
1	185852A	Transfer Step w/2 Handloops DB	1	111362A	Talk Tube 40' Tubing Kit PB
2	111231A	Triangular Tenderdeck	1	111363B	Talk Tube Deck Mounted 16"Dk DB Only
Post	S		1	111363C	Talk Tube Deck Mounted 24"Dk DB Only
5	111404G	100"Alum Post DB	Deck	<s< td=""><td></td></s<>	
4	111404F	108"Alum Post DB	2	178710A	Hexagon Tenderdeck
2	111404J	76"Alum Post DB	1	121948A	Kick Plate 8"Rise
4	1114041	84"Alum Post DB	1	111228A	Square Tenderdeck
1	111404H	92"Alum Post DB	1	185852A	Transfer Step w/2 Handloops DB
Free	standing Play		2	111231A	Triangular Tenderdeck
Clim	bers		Post	S	
1	120711A	Pod Climber 16" DB	4	111404G	100"Alum Post DB
2	120710A	Pod Climber 8" DB	3	111404F	108"Alum Post DB
Swin	lgs		4	111404E	116"Alum Post DB
2	176038A	Full Bucket Seat ProGuard Chains for 8' Beam Height	1	111404C	132"Alum Post DB
1	218671C	Molded Bucket Seat (2-5 yrs) w/Harness ProGuard Chains for 8' Beam	2	111404B	140"Alum Post DB
Heig			4	111404A	148"Alum Post DB
1 Heig	177351A ht	Molded Bucket Seat (5-12 yrs) w/Harness ProGuard Chains for 8' Beam	3	111404J	76"Alum Post DB
1	177332A	Single Post Swing Frame 8' Beam Height Only	5	111404H	92"Alum Post DB
1	177333A	Single Post Swing Frame Additional Bay 8' Beam Height Only	Free	standing Play	
Sign		engle i est ennig i rame Additional bay o beam neight only	Swir	ngs	
1	, 182503A	Welcome Sign (LSI Provided) Ages 2-5 years Direct Bury	4	174018A	Belt Seat ProGuard Chains for 8' Beam Height
-	102303A	The second of th	1	177332A	Single Post Swing Frame 8' Beam Height Only
			1	177333A	Single Post Swing Frame Additional Bay 8' Beam Height Only
Play	Booster® (5-1	2 years)	Sign	S	
Slide	2S		1	182503C	Welcome Sign (LSI Provided) Ages 5-12 years Direct Bury
1	130390A	Double Swoosh Slide 72"Dk DB			

1	130390A	Double Swoosh Slide 72"Dk DB
1	124863D	SlideWinder2 56"Dk DB 2 Right Climbers W/Permalene Handholds

2

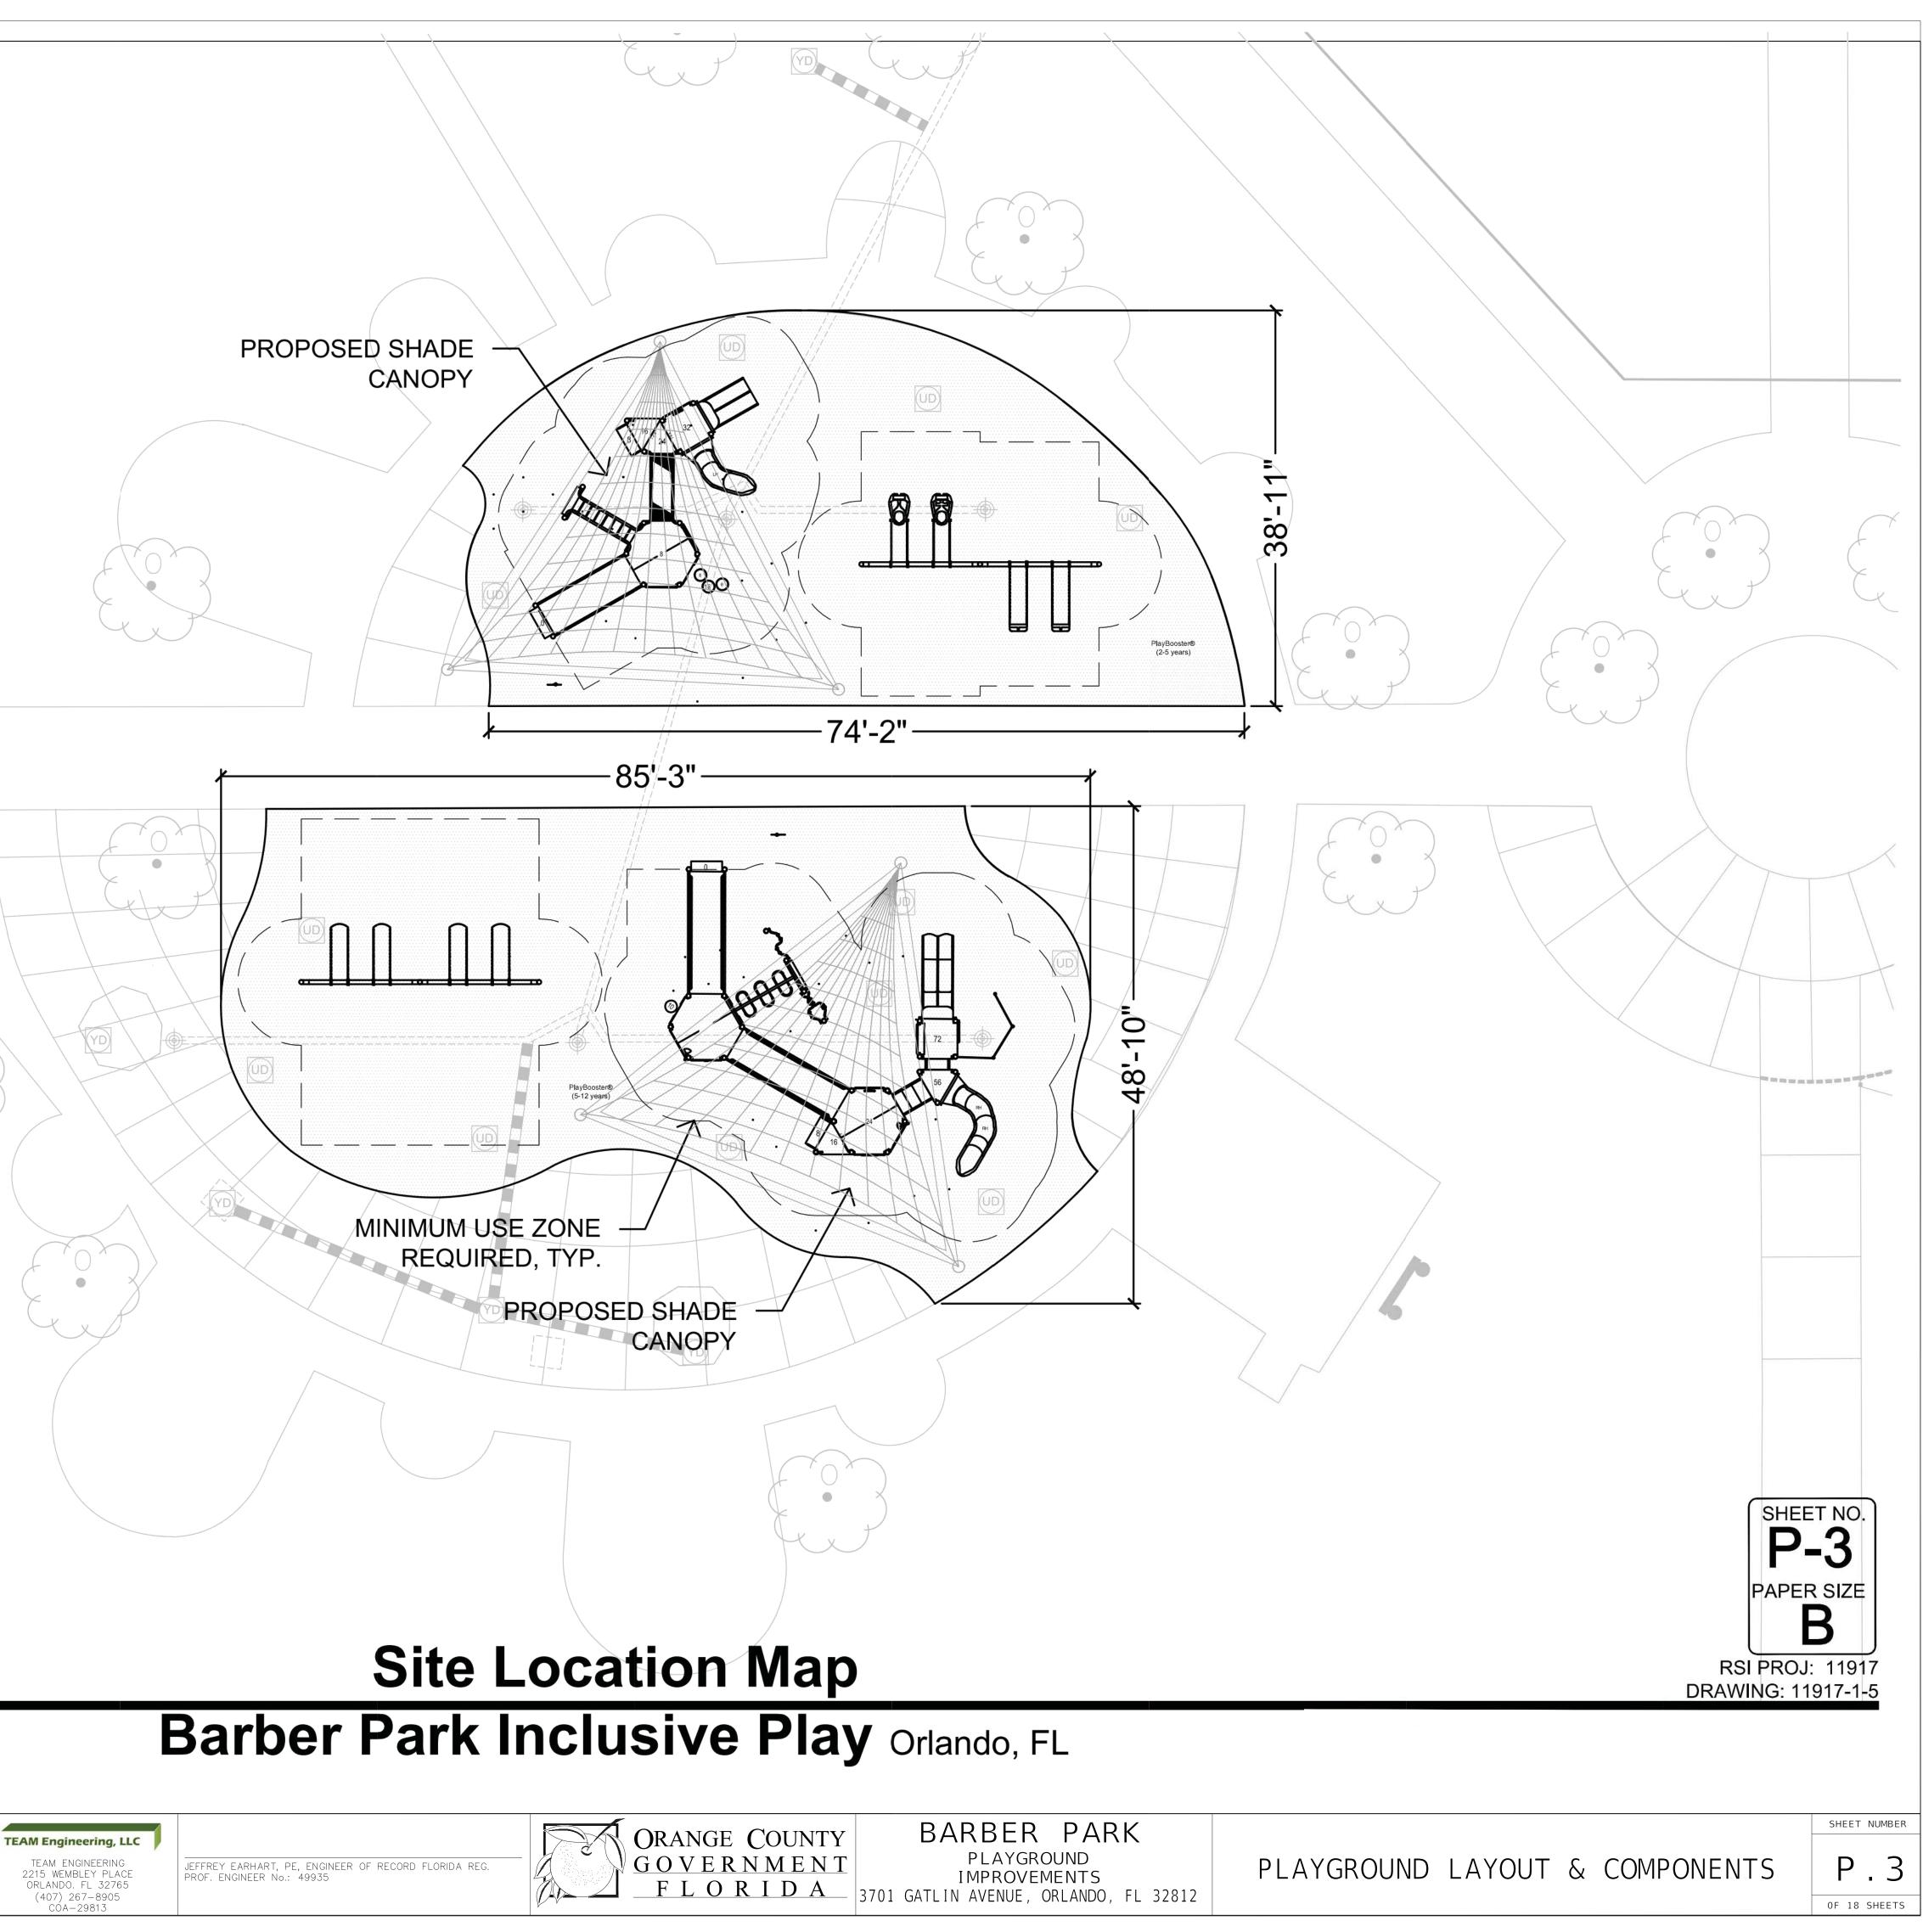
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NO.

100% Submission 60% Submission REVISION






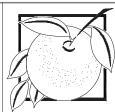

DETAILS - PLAYGROUND EQUIPMENT LIST

SHEET NUMBER



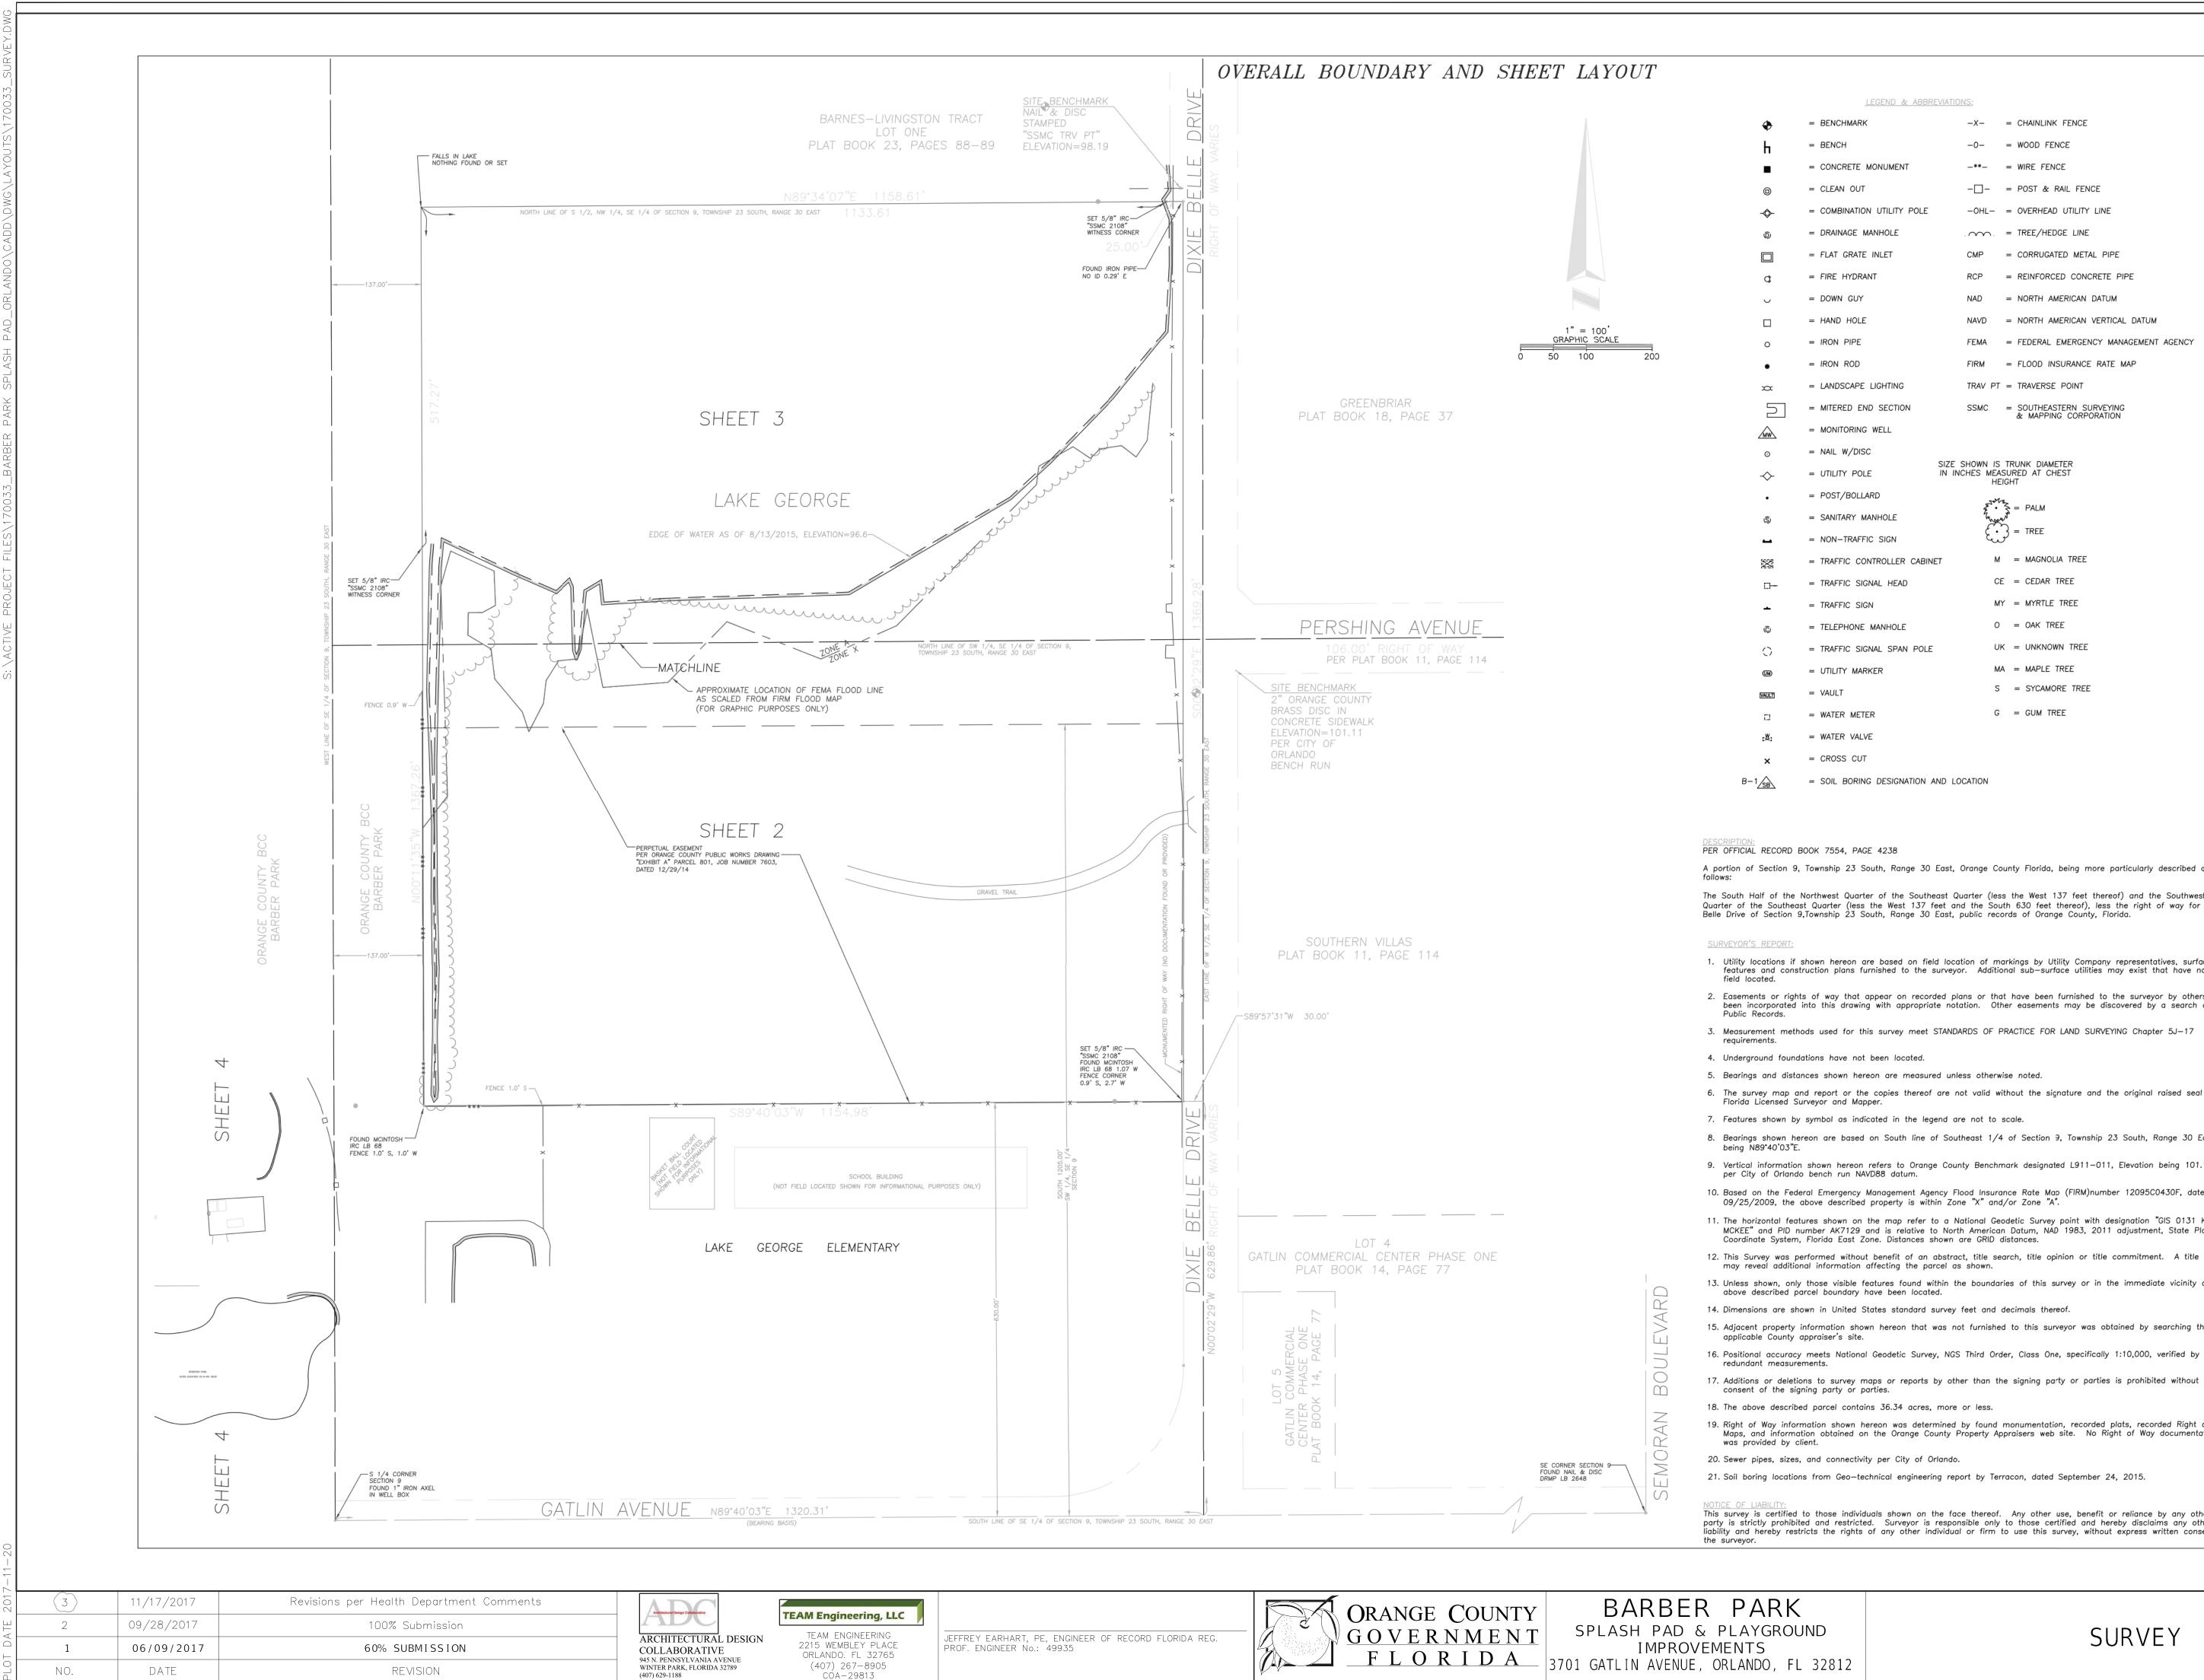

		ORANGE COUNTY	BARBER PARK
I ENGINEERING WEMBLEY PLACE NDO. FL 32765 7) 267-8905	JEFFREY EARHART, PE, ENGINEER OF RECORD FLORIDA REG. PROF. ENGINEER No.: 49935	<u>GOVERNMENT</u>	SPLASH PAD & PLAYGROUND IMPROVEMENTS 3701 GATLIN AVENUE, ORLANDO, FL 3283

vey maps or reports by other than the signing party or parties is prohibited without writter or parties.
contains 36.34 acres, more or less.
own hereon was determined by found monumentation, recorded plats, recorded Right of Way ned on the Orange County Property Appraisers web site. No Right of Way documentation
nectivity per City of Orlando.
eo-technical engineering report by Terracon, dated September 24, 2015.
individuals shown on the face thereof. Any other use, benefit or reliance by any other stricted. Surveyor is responsible only to those certified and hereby disclaims any other
rights of any other individual or firm to use this survey, without express written consent of
SURVEY
· · · - ·
2

LEGEND & ABBREVIATIONS:

= BENCHMARK

= CLEAN OUT

= CONCRETE MONUMENT

= DRAINAGE MANHOLE

= FLAT GRATE INLET

= FIRE HYDRANT

= DOWN GUY

= HAND HOLE

= IRON PIPE

= IRON ROD

= LANDSCAPE LIGHTING

= MITERED END SECTION

= MONITORING WELL

= NAIL W/DISC

= UTILITY POLE

= POST/BOLLARD

= SANITARY MANHOLE

= NON-TRAFFIC SIGN

= TRAFFIC SIGNAL HEAD

= TELEPHONE MANHOLE

= TRAFFIC SIGNAL SPAN POLE

= SOIL BORING DESIGNATION AND LOCATION

= TRAFFIC SIGN

= UTILITY MARKER

= WATER METER

= WATER VALVE

= CROSS CUT

= VAULT

= TRAFFIC CONTROLLER CABINET

= COMBINATION UTILITY POLE

= BENCH

X

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SIZE SHOWN IS TRUNK DIAMETER IN INCHES MEASURED AT CHEST


	ВҮ	JLG	JLG	JLG		
NS:						
-X- = CHAINLINK FENCE		DATA				4 S 2-4
-0- = WOOD FENCE	NOIS	ADDITIONAL	-	Ŧ		1 OF SHEET
-**- = WIRE FENCE	REVISION	ઝ	AL DATA	AL DATA		~
$-\Box - = POST & RAIL FENCE$		SHEET 4	ADDITIONAL	ADDITIONAL		NUMBER WITHOUT
-OHL- = OVERHEAD UTILITY LINE		ADDED SH	ADDED AD	ADDED AD		SHEET
CMP = CORRUGATED METAL PIPE	E	ADI	ADI		_	S NOT V
CMP = CORRUGATED METAL PIPE RCP = REINFORCED CONCRETE PIPE	REVISION DATE	9/24/2015	05/15/2017	06/23/2017		~
NAD = NORTH AMERICAN DATUM	EVISIO	9/24,	05/15	06/23		
NAVD = NORTH AMERICAN VERTICAL DATUM	<u> </u>					
FEMA = FEDERAL EMERGENCY MANAGEMENT AGENCY						
FIRM = FLOOD INSURANCE RATE MAP						
TRAV PT = TRAVERSE POINT						L .
SSMC = SOUTHEASTERN SURVEYING & MAPPING CORPORATION						PETERSEN I Land Surveyor
SHOWN IS TRUNK DIAMETER HES MEASURED AT CHEST HEIGHT						JAMES L. PE Registered I
$z_{f}^{s} \cdot z_{f}^{s} = PALM$				1	ł	
$\left\{ \begin{array}{c} & \\ & \\ \end{array} \right\} = TREE$		ł	计社		#	H
M = MAGNOLIA TREE			Ħ	1		Ì
CE = CEDAR TREE						Ħ
MY = MYRTLE TREE				1 - 1		Ħ
O = OAK TREE		ţ	Æ	Ì	1	
UK = UNKNOWN TREE			~	\checkmark		<u> </u>
MA = MAPLE TREE		ING			B9105	COM
S = SYCAMORE TREE		E	RAJ	rd	50 har I	ring.ce
G = GUM TREE		SURVEYIN	CORPORA	uleva	Florida 32810–4350 Certification Number 182108	urvey
ATION		SOUTHEASTERN	AND MAPPING	6500 All	-	مەرەرە mail: info@s
range County Florida, being more particularly described as					_	
rter (less the West 137 feet thereof) and the Southwest the South 630 feet thereof), less the right of way for Dixie ublic records of Orange County, Florida.	TANTAN	ur vey		Studu		1"=100"
ion of markings by Utility Company representatives, surface . Additional sub—surface utilities may exist that have not been	0	2				Scale:
ns or that have been furnished to the surveyor by others have tion. Other easements may be discovered by a search of the		STADITC	Dowl	w.n Fascihilitv		JLG
RDS OF PRACTICE FOR LAND SURVEYING Chapter 5J—17	C C C L	od o T	Barbar Da	Fields-		Drawn By: JL
ss otherwise noted. It valid without the signature and the original raised seal of a	A CHART DA	DOULINALY &		u Antij Dramosa	an a man	/2015
e not to scale. neast 1/4 of Section 9, Township 23 South, Range 30 East as	04.64	En o		1 2 2 2 2 2		9/15/201
y Benchmark designated L911-011, Elevation being 101.11 feet	þ	9				
			Project:			Field Date:
od Insurance Rate Map (FIRM)number 12095C0430F, dated "X" and/or Zone "A".	-					Ē
tional Geodetic Survey point with designation "GIS 0131 KAREN American Datum, NAD 1983, 2011 adjustment, State Plane re GRID distances. , title search, title opinion or title commitment. A title search		Commissioners				
shown.		mmc				
		of Cc				
eet and decimals thereof. furnished to this surveyor was obtained by searching the		Board c				
Third Order, Class One, specifically 1:10,000, verified by						
		ounty	2			
r than the signing party or parties is prohibited without written		te Cou				
or less.	Certified to:	Orange)			
by found monumentation, recorded plats, recorded Right of Way operty Appraisers web site. No Right of Way documentation	Certif					



NUMBER

1 OF 4



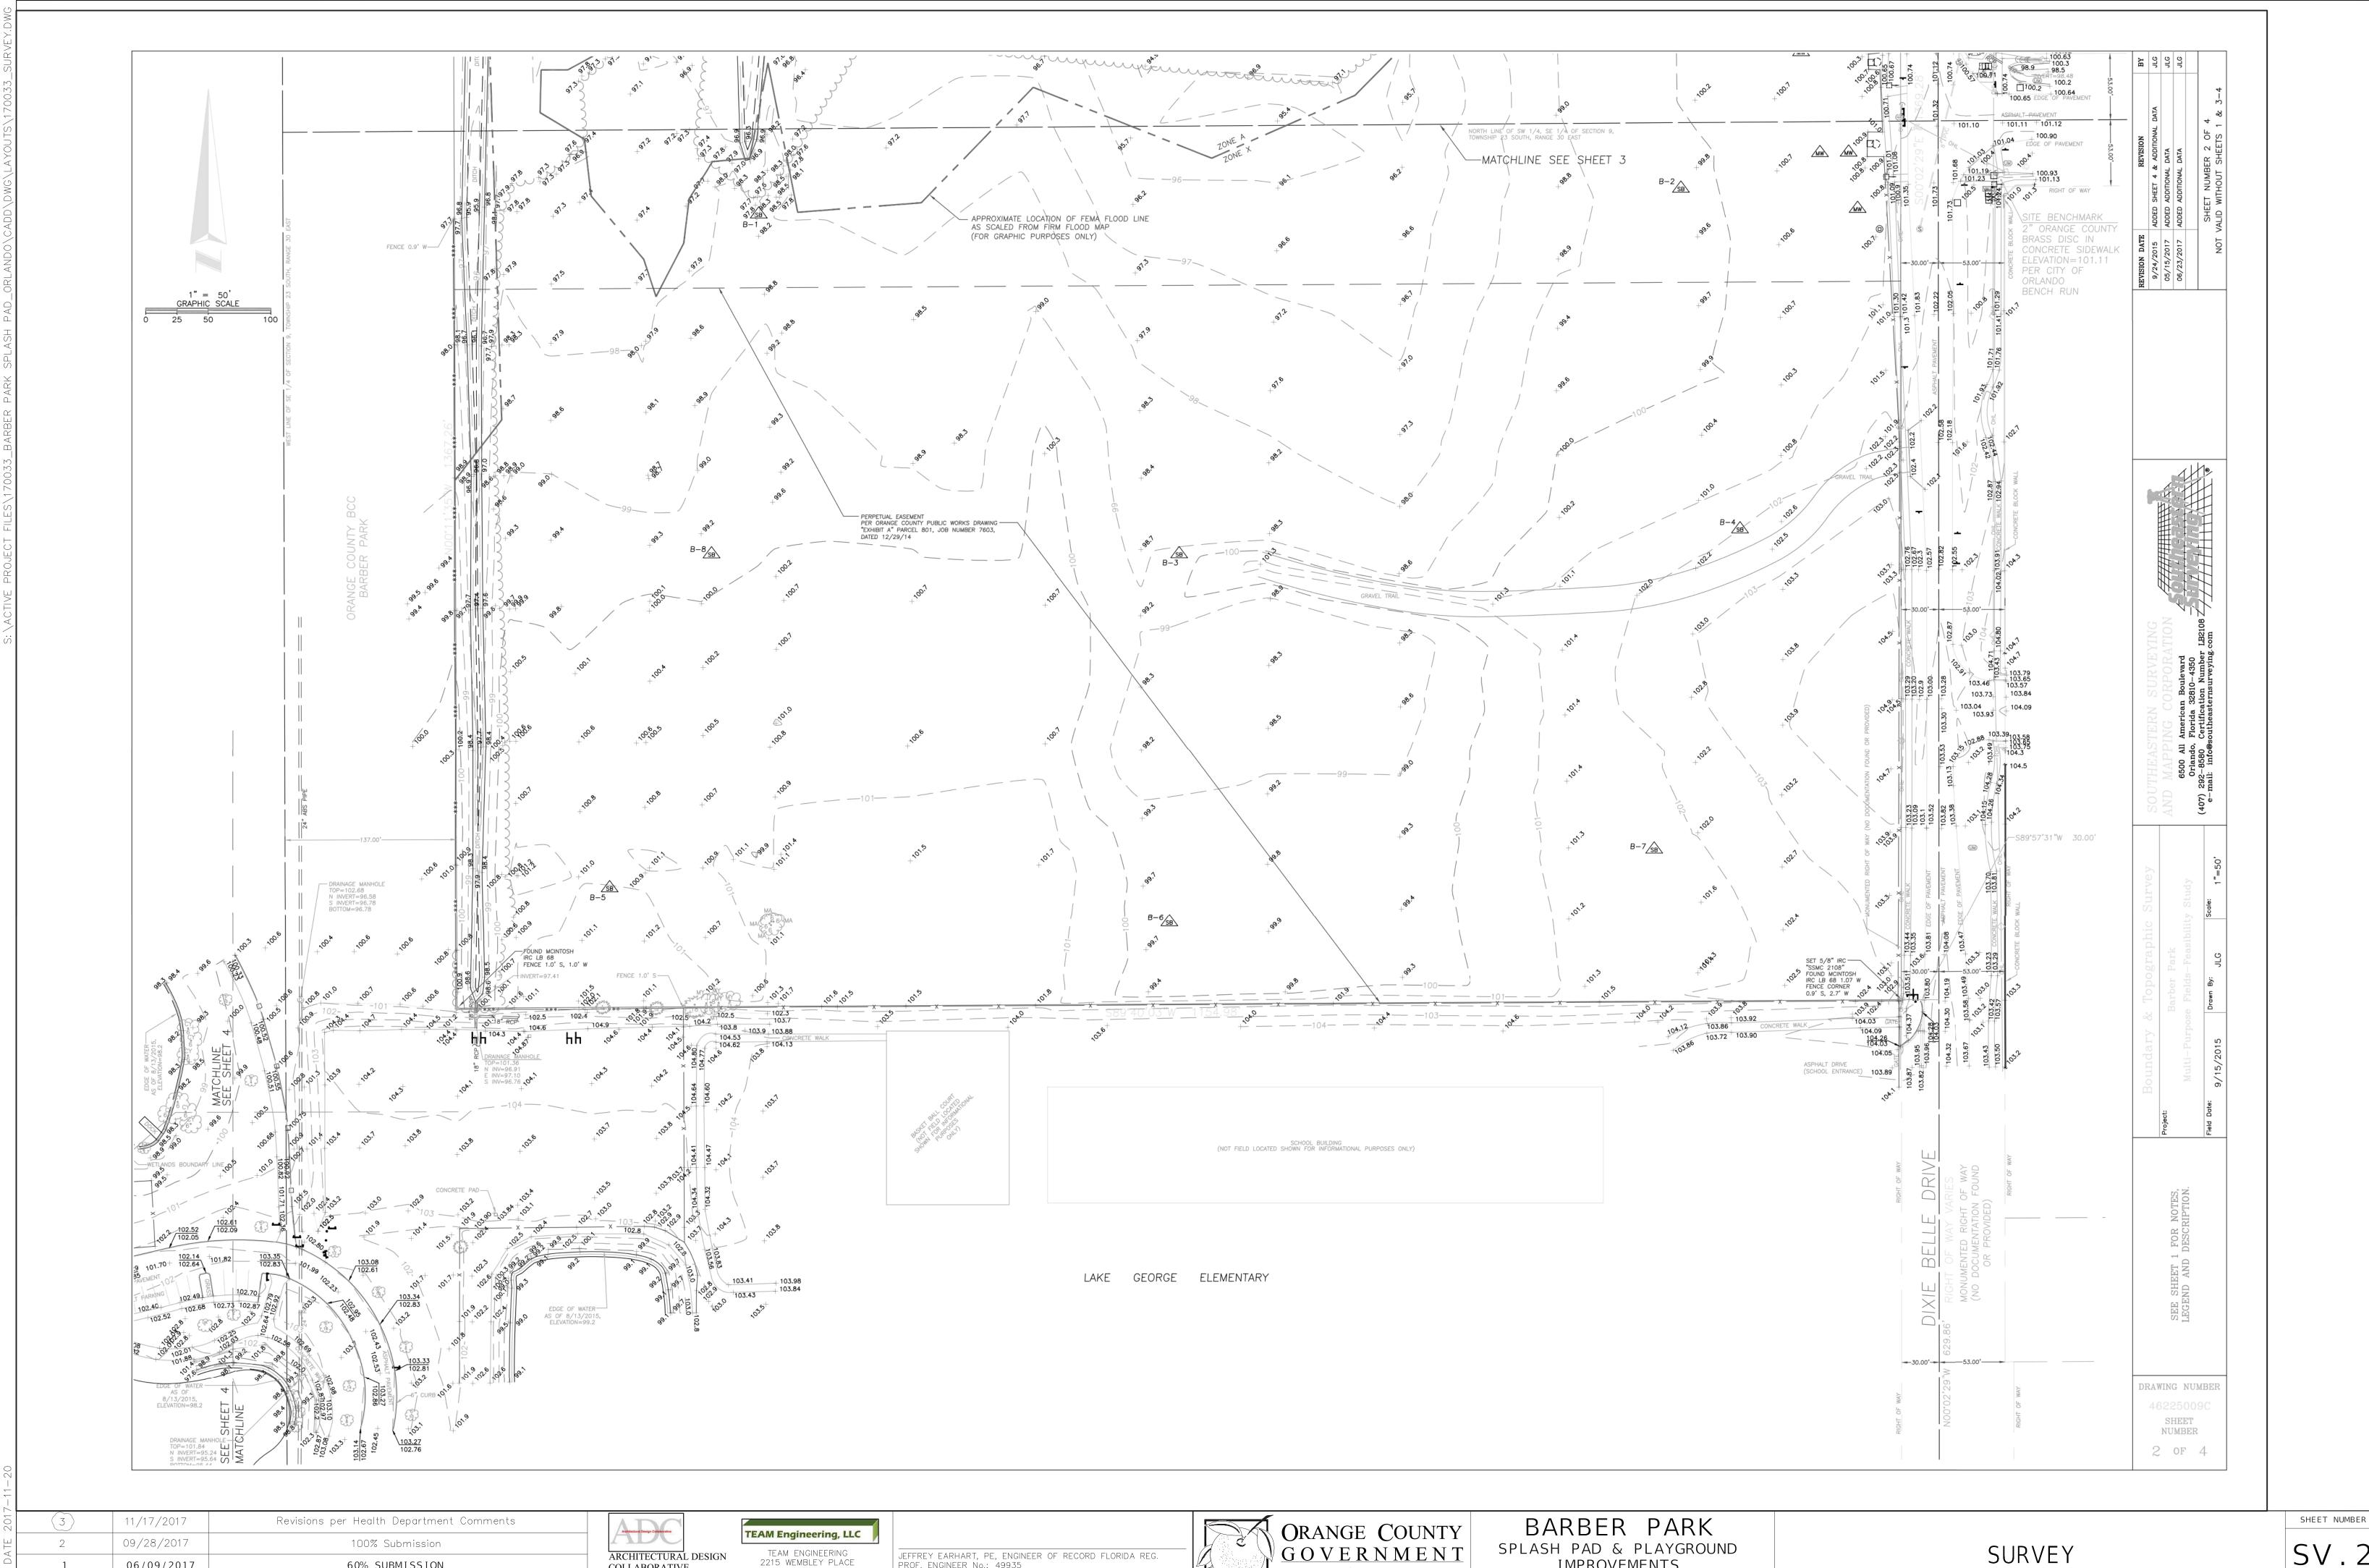

201	3	11/17/2017	Revisions per Health Department Comments	Architectural Design Collaborative	TEAL
A TE	2	09/28/2017	100% Submission	ADC	TEAI
T D/	1	06/09/2017	60% SUBMISSION	ARCHITECTURAL DESIGN COLLABORATIVE	22 C
PLO	NO.	DATE	REVISION	945 N. PENNSYLVANIA AVENUE WINTER PARK, FLORIDA 32789 (407) 629-1188	

TEAM ENGINEERING 2215 WEMBLEY PLACE ORLANDO. FL 32765 (407) 267-8905 COA-29813


JEFFREY EARHART, PE, ENGINEER OF RECORD FLORIDA REG. PROF. ENGINEER No.: 49935




GOVERNMENT
FLORIDASPLASH PAD & PLAYGROUND
IMPROVEMENTS
3701 GATLIN AVENUE, ORLANDO, FL 32812

SURVEY

SV.2

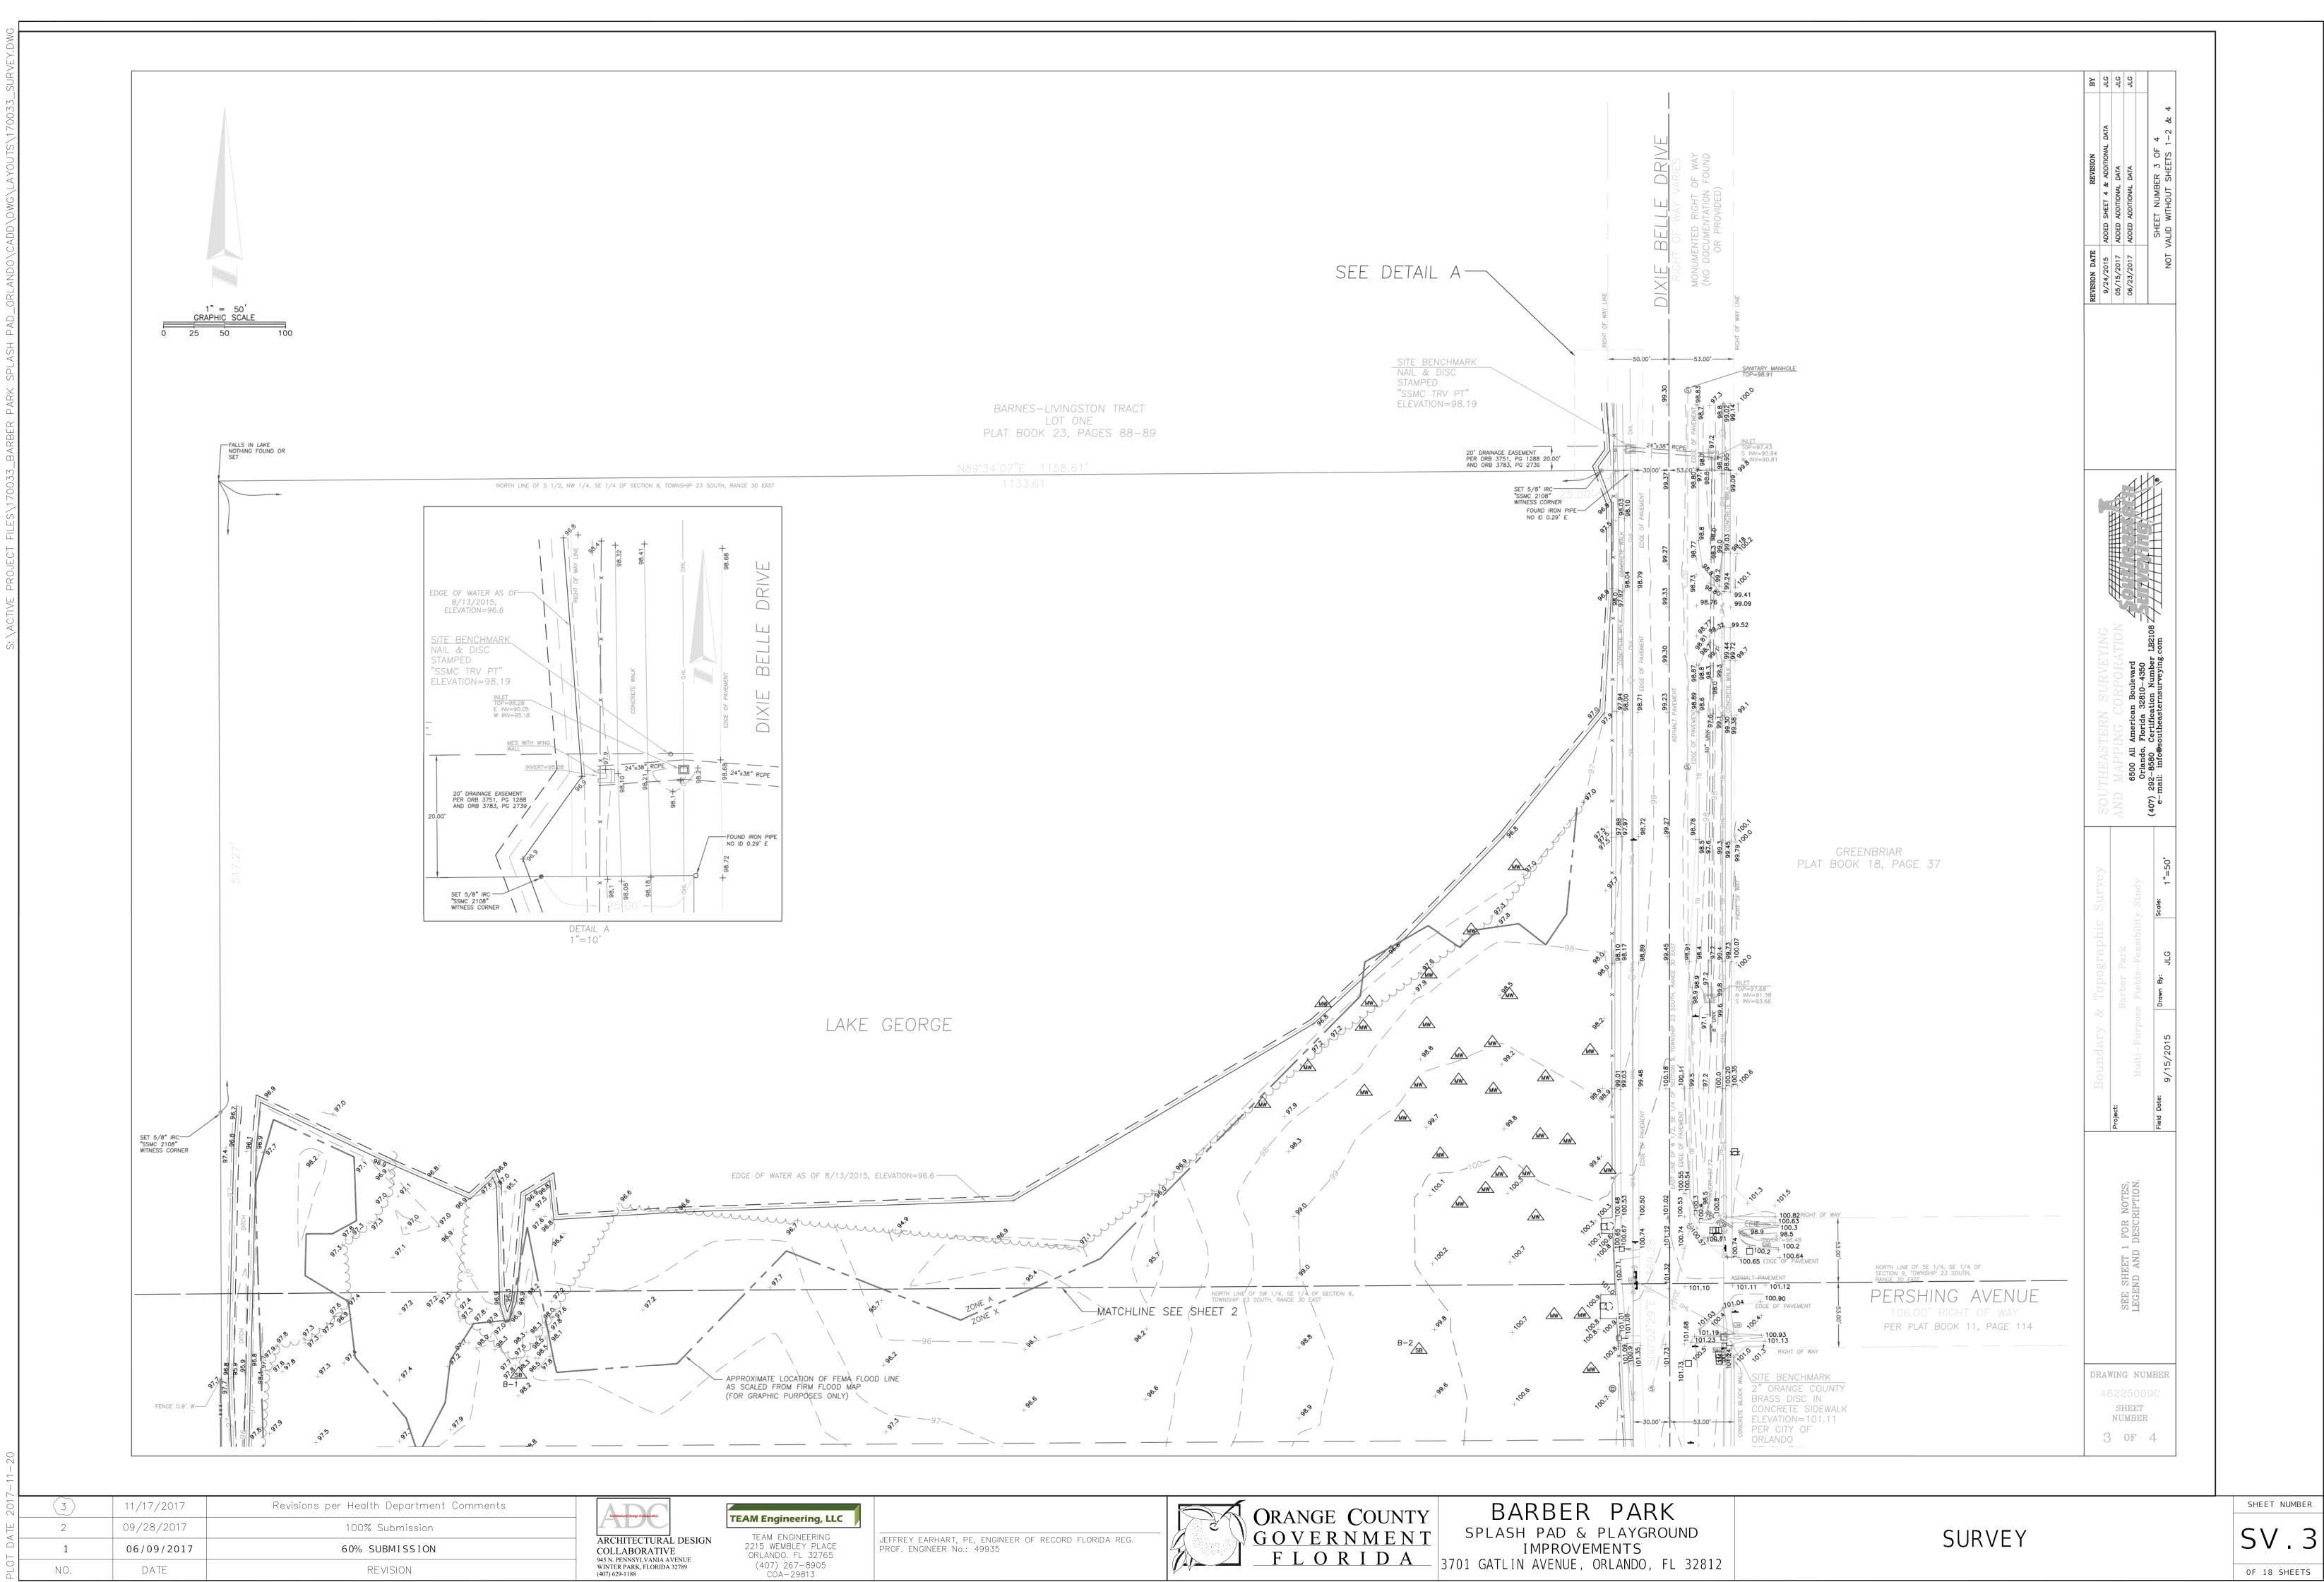

ingineering, LLC	
M ENGINEERING WEMBLEY PLACE	
ANDO. FL 32765	
07) 267-8905	

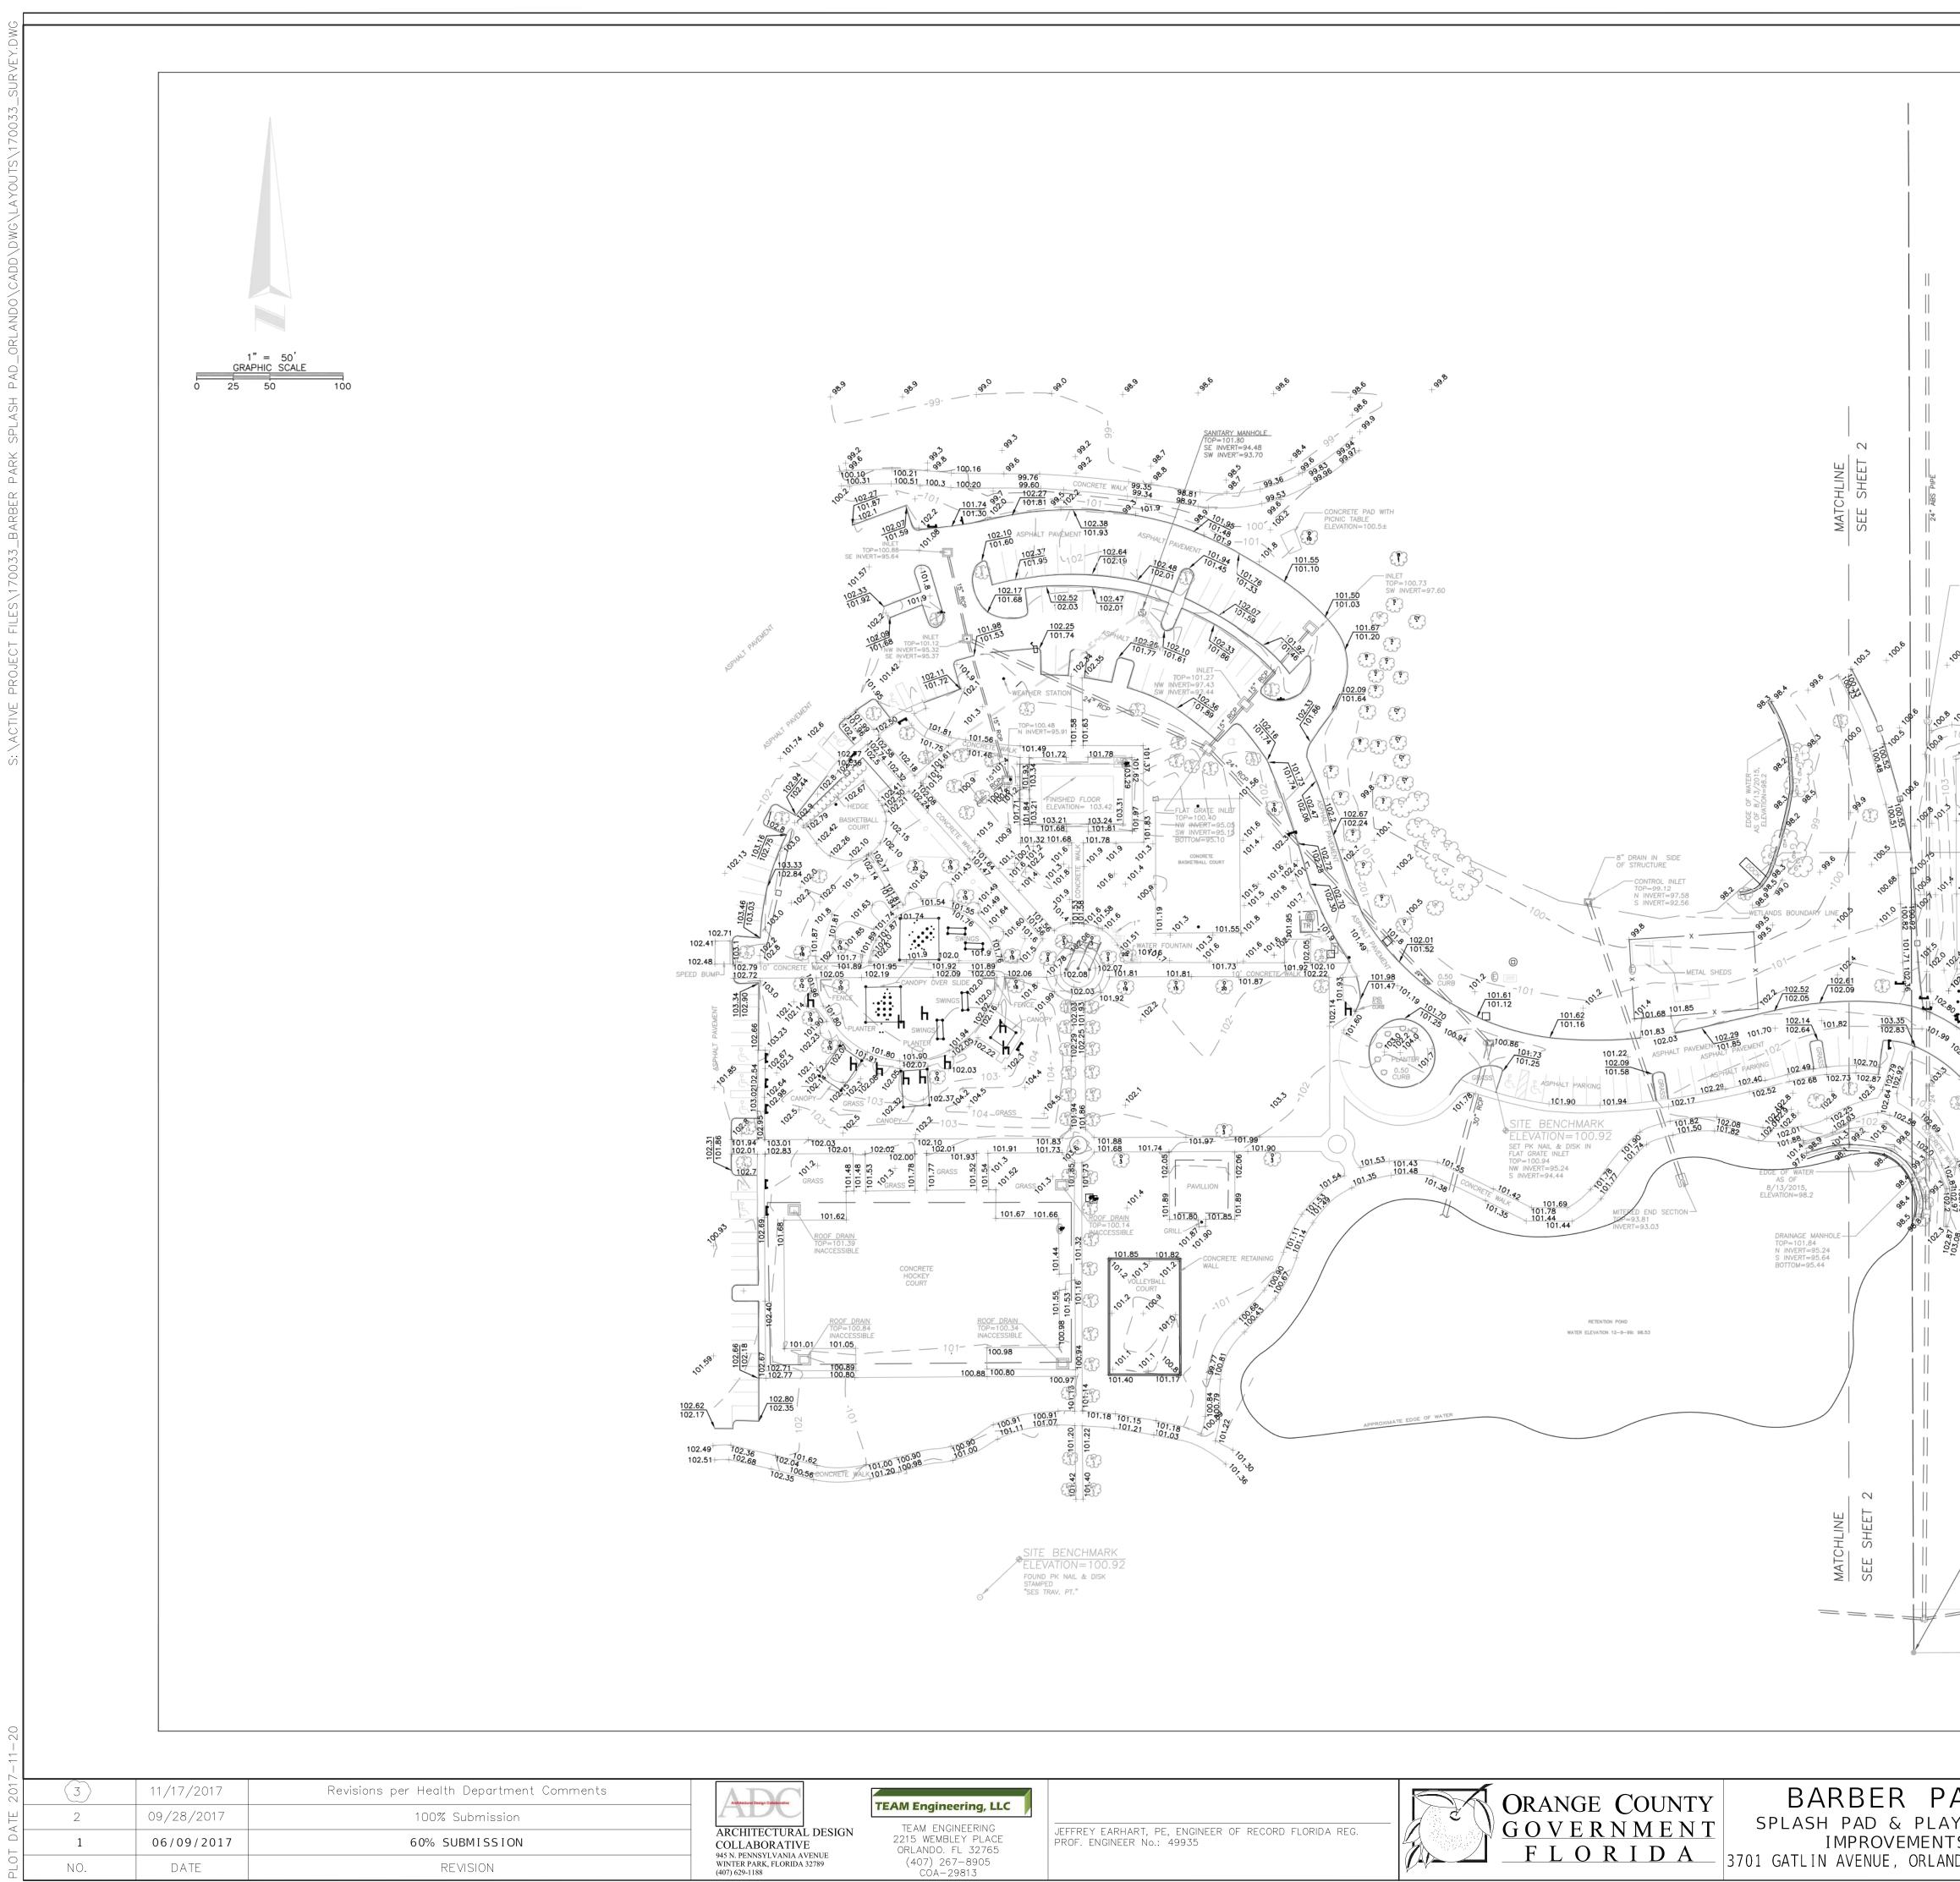

ngineering, LLC	

ORANGE COUNT BCC BARBER PARK	REVISION DATE REVISION 05/15/2015 ADDED SHEET 4 & ADDITIONAL DATA 05/15/2017 ADDED ADDITIONAL DATA 06/23/2017 ADDED ADDITIONAL DATA 0107 VALID WITHOUT SHEETS 1-3	
$ \frac{1}{100} $	Boundary & Topographic Survey SourthEASTERN SURVEYING Peet Barber Park Multi-Purpose Palder Pearkillty Sung SourthEASTERN SURVEYING Multi-Purpose Palder Pearkillty Sung Gon And Priot Constrantion And Priot And Priot And Priot Priot And Priot And Priot Priot And Pri	
S 1/4 CORNER SECTION 9 FOUND 1" IRON AXEL IN WELL BOX	REET NUMBER 4 OF 4	
PARK LAYGROUND INTS LANDO, FL 32812	SURVEY	SHEET NUMBER SV.4 OF 18 SHEETS