

ORANGE COUNTY UTILITIES

PORTER TRANSFER STATION SITE IMPROVEMENTS


CONSTRUCTION DRAWINGS

CIP NO. 4410-038-1061-6310

SEQ NO. 91566

ORLANDO, FLORIDA



MARCH 2018

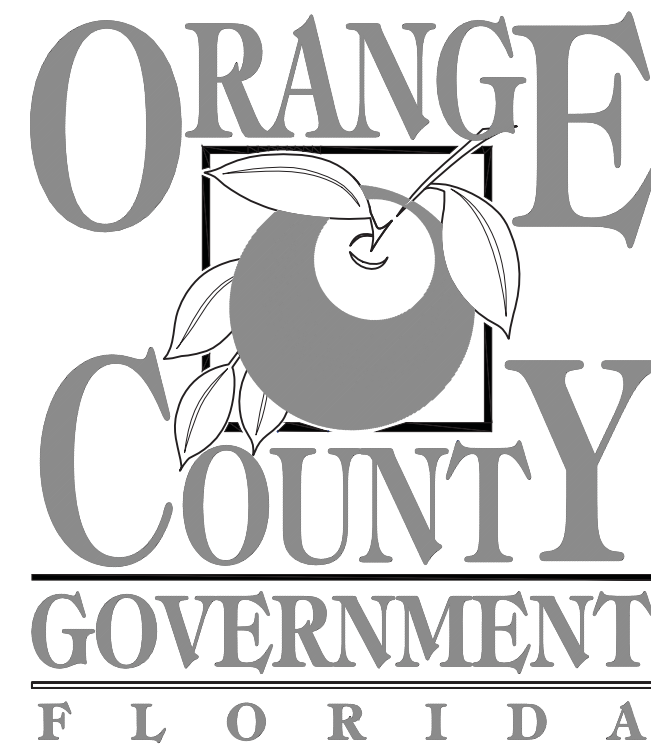

GOVERNING OFFICIALS:

TERESA JACOBS - ORANGE COUNTY MAYOR
 BETSY VANDERLEY - COMMISSIONER, DISTRICT 1
 BRYAN NELSON - COMMISSIONER, DISTRICT 2
 PETE CLARKE - COMMISSIONER, DISTRICT 3
 JENNIFER THOMPSON - COMMISSIONER, DISTRICT 4
 EMILY BONILLA - COMMISSIONER, DISTRICT 5
 VICTORIA P. SIPLIN - COMMISSIONER, DISTRICT 6
 AJIT LALCHANDANI - COUNTY ADMINISTRATOR

RAY HANSON - DIRECTOR ORANGE COUNTY UTILITY DEPARTMENT
 JAMES W. BECKER - MANAGER SOLID WASTE DIVISION

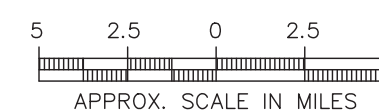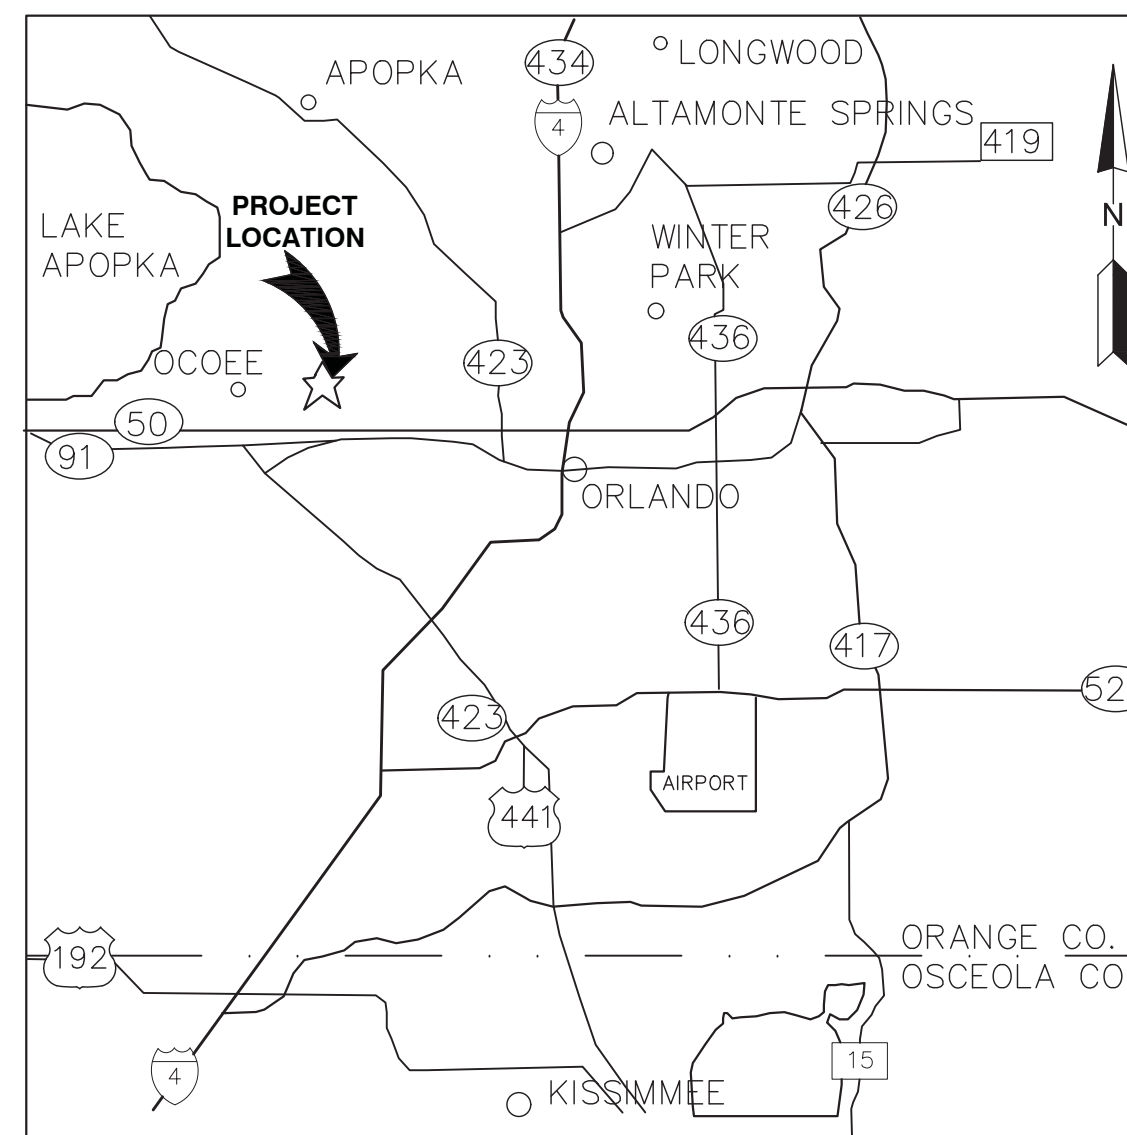

LOCATION MAP
 PORTER TRANSFER STATION
 1326 GOOD HOMES ROAD
 ORLANDO, FL 32818

SCS ENGINEERS
 STEARNS, CONRAD AND SCHMIDT
 CONSULTING ENGINEERS, INC.
 5850 SOUTH SEMORAN BLVD.
 ORLANDO, FLORIDA 32822
 PH. (407) 204-3231 FAX. (813) 623-6757
 FLORIDA CERTIFICATE OF AUTHORIZATION NO. 00004892
 WWW.SCSENGINEERS.COM

SCS PROJECT NO. 09216054.01

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This item has been electronically signed and sealed by David M. Beben, PE on March 20, 2018 using a SHA-1 authentication code. Printed copies of this document are not considered signed and sealed and the SHA-1 authentication code must be verified on any electronic copies.

ISSUED FOR BID

DATE: 3/20/18

David Beben
 PE No. 73005
 Florida
 Digitally signed by David Beben PE No. 73005 Florida Date: 2018.03.20 13:59:21 -04'00'

DAVID M. BEBEN, P.E.
 LICENSE NO. 73005

GENERAL NOTES

- ALL ELEVATIONS ARE REFERRED TO NORTH AMERICAN VERTICAL DATUM OF 1988 (NVAD 88) UTILIZING ORANGE COUNTY BENCH MARK #L1057014 AND L1057018.
- LOCATIONS, ELEVATIONS, AND DIMENSIONS OF EXISTING UTILITIES, STRUCTURES AND OTHER FEATURES ARE SHOWN ACCORDING TO THE BEST INFORMATION AVAILABLE AT THE TIME OF PREPARATION OF THESE DRAWINGS BUT DO NOT PURPORT TO BE ABSOLUTELY CORRECT. PRIOR TO CONSTRUCTION, THE CONTRACTOR SHALL VERIFY AND AGREE TO BE FULLY RESPONSIBLE FOR ANY AND ALL DAMAGES WHICH MIGHT BE OCCASIONED BY HIS FAILURE TO EXACTLY LOCATE AND PRESERVE ANY AND ALL EXISTING UTILITIES, STRUCTURES, AND OTHER FEATURES AFFECTING HIS WORK.
- THE CONTRACTOR SHALL REPLACE ANY MONUMENT, FENCE, ETC. WITH THE SAME TYPE OF MATERIAL THAT WAS REMOVED DURING CONSTRUCTION, COST TO BE INCIDENTAL TO OTHER CONSTRUCTION, AND NO EXTRA COMPENSATION SHALL BE ALLOWED.
- TOPOGRAPHIC SURVEY WAS PERFORMED BY:
APEX ENGINEERING, INC.
PO BOX 568891
ORLANDO, FLORIDA 32856-8891
PHONE: (407) 306-0904
PHONE: (407) 277-5492
- THE CONTRACTOR SHALL CONTACT THE ENGINEER'S OFFICE IMMEDIATELY UPON FINDING ANY CONFLICTS DURING CONSTRUCTION ON ANY IMPROVEMENTS SHOWN ON THE DRAWINGS.
- EROSION CONTROL AND SEDIMENTATION CONTROL DEVICES SHALL BE IN PLACE PRIOR TO BEGINNING ANY WORK. THEY SHALL BE INSTALLED TO THE LIMITS SHOWN IN THE DRAWINGS, AS REQUIRED IN THE SPECIFICATIONS, IN ACCORDANCE WITH ALL REGULATORY AGENCY SPECIFICATIONS AND REQUIREMENTS (SEE EROSION CONTROL NOTES.)
- THE CONTRACTOR SHALL, BY REPAIR OR REPLACEMENT, RETURN TO EQUAL OR BETTER CONDITION ALL PAVEMENT, LANDSCAPING, PONDS, ROADS, UTILITIES, AND OTHER ITEMS DAMAGED BY HIS WORK.
- DURING CONSTRUCTION, THE CONTRACTOR IS RESPONSIBLE FOR REMOVAL, PROTECTION, AND REPLACEMENT OF ITEMS ON PRIVATE PROPERTY AND PUBLIC RIGHTS OF WAY SUCH AS FENCES, SOD, SHRUBS, TREES, SURVEYING MARKERS, ETC.
- THE SITE IS A FORMER LANDFILL AND UNDER ROUTINE GROUNDWATER MONITORING AUTHORIZED BY THE FLORIDA DEPARTMENT OF ENVIRONMENTAL PROTECTION (FDEP).
- ALL CONSTRUCTION SHALL CONFORM TO ORANGE COUNTY STANDARDS AND SPECIFICATIONS AND TO THE FLORIDA DEPARTMENT OF TRANSPORTATION STANDARD SPECIFICATIONS FOR ROAD AND BRIDGE CONSTRUCTION, MOST RECENT EDITIONS.
- CONTRACTOR SHALL BE RESPONSIBLE FOR PROPER DISPOSAL OF ALL CONSTRUCTION AND DEMOLITION DEBRIS AND ANY SOLID WASTE MATERIAL THAT IS EXCAVATED FROM THE SITE ACCORDING TO THE CONTRACT DOCUMENTS.
- A DEWATERING PERMIT MAY BE REQUIRED BY THE FDEP AND THE ST. JOHNS RIVER WATER MANAGEMENT DISTRICT (SJRWMD) PRIOR TO ANY PUMPING, ETC. AND SHALL BE OBTAINED BY THE CONTRACTOR. CONTRACTOR IS RESPONSIBLE FOR THE DESIGN, INSTALLATION, PERMIT, TESTING AND OPERATION OF AN ADEQUATE DEWATERING SYSTEM TO DEWATER EXCAVATIONS FOR CONSTRUCTION. CONTRACTOR SHALL BE RESPONSIBLE FOR OBTAINING ALL FLORIDA DEPARTMENT OF ENVIRONMENTAL PROTECTION PERMITS AND LABORATORY ANALYSIS REQUIRED TO MEET THE PERMIT CONDITIONS.
- ALL PRIVATE AND PUBLIC PROPERTY AFFECTED BY THIS WORK SHALL BE RESTORED TO A CONDITION EQUAL TO OR BETTER THAN THE CONDITION EXISTING PLANS. COSTS TO BE INCIDENTAL TO OTHER CONSTRUCTION AND NO EXTRA COMPENSATION TO BE ALLOWED.
- INSTALLATION OF ALL STORM SEWERS, INLETS, MANHOLES, AND APPURTENANCES SHALL BE IN ACCORDANCE WITH THE REQUIREMENTS OF THE APPLICABLE SECTIONS OF ORANGE COUNTY STANDARD SPECIFICATIONS, OR AS INDICATED ON THE DRAWINGS.
- THE LIMITS OF CONSTRUCTION SHOWN ON THE DRAWINGS SHALL BE STRICTLY OBSERVED BY THE CONTRACTOR. ALL INGRESS, EGRESS AND TRAFFIC PATTERNS ON THE SITE SHALL BE WITHIN THE LIMITS OF CONSTRUCTION OR ON HAUL ROADS SHOWN ON THE DRAWINGS. ALL CONSTRUCTION AREAS SHALL BE CLEARLY POSTED.
- ALL REINFORCED CONCRETE PIPE (RCP) SHALL BE MINIMUM CLASS III.
- IN AREAS REQUIRING FILL MATERIAL, THE CONTRACTOR WILL STRIP OR OTHERWISE REMOVE ALL VEGETATION SUCH AS BRUSH, HEAVY SODS, HEAVY GROWTH OF GRASS, DECAYED VEGETABLE MATTER, RUBBISH AND ANY OTHER DELETERIOUS MATERIAL BEFORE EMBANKMENT IS STARTED. IMMEDIATELY PRIOR TO THE PLACING OF FILL MATERIALS, THE ENTIRE AREA UPON WHICH FILL IS TO BE PLACED, SHALL BE SCARIFIED. A POLYMER SHALL BE APPLIED TO AREAS OF EMBANKMENT IF LEFT UNSTABILIZED FOR MORE THAN 24 HOURS.
- THE CONTRACTOR SHALL NOTIFY THE ENGINEER OF RECORD AND OWNER FIVE WORKING DAYS PRIOR TO COMMENCING CONSTRUCTION.
- CONTRACTOR SHALL SUBMIT A DETAILED WORK PLAN FOR REVIEW WITHIN 15 DAYS OF AWARD OF CONTRACT WHICH WILL INCLUDE THE PROPOSED CONSTRUCTION SEQUENCE.
- CONTRACTOR CANNOT AFFECT OPERATION OR TRAFFIC OF EXISTING TRANSFER STATION.
- THIS IS A FACILITY DEVELOPED OVER A FORMER LANDFILL. TAKE ALL APPROPRIATE PRECAUTIONS WHEN DISTURBING EXISTING WASTE AND FOLLOW ALL LOCAL, STATE, AND FEDERAL REGULATIONS.
- EXCAVATED WASTE MATERIAL SHALL BE PROPERLY DISPOSED OF PER THE CONTRACT DOCUMENTS AT THE END OF EACH DAY. EXCAVATION SHALL BE BACK FILLED WITH CLEAN FILL IN ACCORDANCE WITH THE SPECIFICATIONS. EXCAVATED WASTE SHALL NOT BE MIXED WITH CONSTRUCTION DEBRIS.
- CONTRACTOR SHALL IMMEDIATELY NOTIFY THE ENGINEER OF RECORD AND OWNER OF ANY DISCHARGES OR RELEASED OF IDENTIFIED CONTAMINATION FROM EXCAVATED WASTE MATERIAL.
- EXCEPT IN THE EVENT OF AN EMERGENCY, NO WORK SHALL BE CONDUCTED BETWEEN THE HOURS OF 6 PM AND 7 AM MONDAY THROUGH SATURDAY. IF THE PROPERTY AND EFFICIENT PROSECUTION OF THE WORK REQUIRES OPERATIONS DURING THE NIGHT, WRITTEN PERMISSION OF THE OWNER SHALL BE OBTAINED BEFORE STARTING SUCH ITEMS OF THE WORK.
- ALL AREAS DISTURBED SHALL RECEIVE SODDING UNLESS ANOTHER TREATMENT IS SPECIFIED.
- IF WASTE IS EXPOSED DURING THE CLEARING AND GRUBBING OPERATION, THE WASTE SHALL BE COVERED WITH 12" OF CLEAN FILL THE SAME DAY.
- CONTRACTOR SHALL BE RESPONSIBLE FOR PROVIDING WASH BINS AND/OR OTHER TYPES OF CONTAINMENT FOR CONCRETE WASHOUT ACTIVITIES.

EROSION CONTROL

IT IS THE CONTRACTOR'S RESPONSIBILITY TO IMPLEMENT THE EROSION AND TURBIDITY CONTROLS AS SHOWN ON THE EROSION AND TURBIDITY CONTROL PLAN. IT IS ALSO THE CONTRACTOR'S RESPONSIBILITY TO ENSURE THESE CONTROLS ARE PROPERLY INSTALLED, MAINTAINED AND FUNCTIONING PROPERLY AT THE END OF EACH WORKING DAY TO PREVENT TURBID OR POLLUTED WATER FROM LEAVING THE PROJECT SITE. THE CONTRACTOR WILL ADJUST THE EROSION AND TURBIDITY CONTROLS SHOWN ON THE EROSION AND TURBIDITY CONTROL PLAN AND ADD ADDITIONAL CONTROL MEASURES, AS REQUIRED, TO ENSURE THE SITE MEETS ALL FEDERAL, STATE AND LOCAL EROSION AND TURBIDITY CONTROL REQUIREMENTS. THE FOLLOWING BEST MANAGEMENT PRACTICES WILL BE IMPLEMENTED BY THE CONTRACTOR AS REQUIRED BY THE EROSION AND TURBIDITY CONTROL PLAN AND AS REQUIRED BY THE REGULATORY AGENCIES.

- EROSION CONTROL MEASURES SHALL BE CONSTRUCTED AS A FIRST STEP BEFORE ANY LAND-DISTURBING TAKES PLACE TO MEET THE EROSION AND TURBIDITY REQUIREMENTS IMPOSED ON THE PROJECT.
- ALL SEDIMENT CONTROL MEASURES ARE TO BE ADJUSTED TO MEET FIELD CONDITIONS AT THE TIME OF CONSTRUCTION AND BE CONSTRUCTED PRIOR TO ANY GRADING OR DISTURBANCE OF EXISTING SURFACE MATERIAL ON BALANCE OF SITE. PERIMETER SEDIMENT BARRIERS SHALL BE CONSTRUCTED TO PREVENT SEDIMENT OR TRASH FROM FLOWING OR FLOATING ON TO ADJACENT PROPERTIES.
- DURING CONSTRUCTION OF THE PROJECT, SOIL STOCK PILES SHALL BE STABILIZED OR PROTECTED WITH

SEDIMENT TRAPPING MEASURES. THE CONTRACTOR IS RESPONSIBLE FOR THE TEMPORARY PROTECTIONS AND PERMANENT STABILIZATION OF ALL SOIL STOCKPILES ON SITE AS WELL AS SOIL INTENTIONALLY TRANSPORTED FROM THE PROJECT SITE.

- AFTER 0.50 INCHES OR GREATER OF RAINFALL SEDIMENT CONTROL STRUCTURES WILL BE INSPECTED FOR INTEGRITY. ANY DAMAGED DEVICES SHALL BE REPAIRED IMMEDIATELY.
- CONCENTRATED RUNOFF SHALL NOT FLOW DOWN CUT OR FILL SLOPES UNLESS CONTAINED WITHIN AN ADEQUATE TEMPORARY OR PERMANENT CHANNEL, FLUME OR SLOPE DRAIN STRUCTURE.
- WHENEVER WATER SEEPS FROM A SLOPE FACE ADEQUATE DRAINAGE OR OTHER PROTECTION SHALL BE PROVIDED.
- SEDIMENT WILL BE PREVENTED FROM ENTERING ANY STORM DRAIN SYSTEM. NO FILTER FABRIC SHALL BE USED ON STORM DRAINS OR PAVED ROADS. ONLY DROP BAG INLET PROTECTION WILL BE PERMITTED ON PAVED ROADS.
- BEFORE TEMPORARY OR NEWLY CONSTRUCTED STORMWATER CONVEYANCE CHANNELS ARE MADE OPERATIONAL ADEQUATE OUTLET PROTECTION AND ANY REQUIRED TEMPORARY OR PERMANENT CHANNEL LINING SHALL BE INSTALLED IN BOTH THE CONVEYANCE CHANNEL AND RECEIVING CHANNEL.
- STOCKPILING MATERIAL: NO EXCAVATED MATERIAL SHALL BE STOCKPILED IN SUCH A MANNER AS TO DIRECT RUNOFF DIRECTLY OFF THE PROJECT SITE INTO ANY ADJACENT WATER BODY OR STORM WATER COLLECTION FACILITY. STOCKPILED WASTE SHALL NOT BE STOCKPILED OVERNIGHT.
- THE CONTRACTOR WILL BE RESPONSIBLE FOR PREPARING A STORMWATER POLLUTION PREVENTION PLAN (SWPPP) IN ACCORDANCE WITH EPA'S NPDES REGULATIONS. THE CONTRACTOR WILL BE RESPONSIBLE FOR SUBMITTING A NOTICE ON INTENT (NOI) TO DEP FORTY-EIGHT (48) HOURS PRIOR TO COMMENCING CONSTRUCTION.
- THE EROSION CONTROL MEASURES SHOWN ON THESE DRAWINGS ARE THE MINIMUM. THE CONTRACTOR SHALL PROVIDE ADDITIONAL MEASURES, AS NECESSARY, TO PREVENT TURBID DISCHARGE FROM LEAVING THE SITE.
- THE CONTRACTOR SHALL BE RESPONSIBLE FOR IMPLEMENTING, MONITORING AND MODIFYING THE SWPPP FOR CONSTRUCTION ACTIVITIES INCLUDING SWPPP REQUIRED INSPECTIONS TO MEET CHANGING PROJECT SITE CONDITIONS.
- WHEN ALL DISTURBED SOILS HAVE BEEN STABILIZED AND TEMPORARY EROSION AND SEDIMENT CONTROL MEASURES HAVE BEEN REMOVED, THIS CONSTITUTES THE ELIMINATION OF STORMWATER DISCHARGES ASSOCIATED WITH THE CONSTRUCTION ACTIVITIES. AT THIS TIME THE CONTRACTOR SHALL COMPLETE AND FILE A NOTICE OF TERMINATION (NOT).
- MAINTENANCE: ALL FEATURES OF THE PROJECT DESIGNED AND CONSTRUCTED TO PREVENT EROSION AND SEDIMENT SHALL BE MAINTAINED DURING THE LIFE OF THE CONSTRUCTION SO AS TO FUNCTION AS THEY WERE ORIGINALLY DESIGNED AND CONSTRUCTED.
- THE CONTRACTOR SHALL STAGE THE WORK SUCH THAT THE STORMWATER FLOW IS ALWAYS MAINTAINED AND NO FLOODING IS ALLOWED DURING CONSTRUCTION. DEWATERING, TEMPORARY DRAINAGE STRUCTURES, BY-PASS PUMPING AND/OR ANY OTHER MEANS AND METHODS REQUIRED FOR CONSTRUCTION IN THE PROJECT AREA SHALL BE INCLUDED IN THE COST OF MOBILIZATION. NO ADDITIONAL COMPENSATION SHALL BE ALLOWED.

GEOTECHNICAL RECOMMENDATIONS

GENERAL:

- CONTRACTOR SHALL REFER TO "GEOTECHNICAL EXPLORATION PORTER TRANSFER STATION IMPROVEMENTS REPORT" DATED, 8/31/2017 PREPARED BY BLUE MARLIN ENGINEERING.
- THE CONTRACTOR SHALL REFER TO TECHNICAL SPECIFICATIONS FOR ADDITIONAL INFORMATION.
- THE CONTRACTOR SHALL PROVIDE SUBMITTALS FOR THE GEOTECHNICAL COMPONENTS FOR REVIEW AND APPROVAL BY THE ENGINEER. REFER TO SPECIFICATIONS FOR SUBMITTAL DETAILS.
- IT IS EVIDENT FROM SITE OBSERVATIONS AND THE RESULTS OF THE FIELD EXPLORATION THAT FILL SOILS CONTAINING BURIED DEBRIS AND WASTE ARE PRESENT ON THE SITE.
- THE PRESENCE OF DEBRIS AND OTHER HARD MATERIALS SHOULD BE ANTICIPATED TO BE ENCOUNTERED IN ALL EXCAVATIONS AT VARIOUS DEPTHS WITHIN THE SUBSURFACE PROFILE. THE CONTRACTOR SHALL ANTICIPATE THE NEED FOR SPECIALIZED EQUIPMENT AND/OR HANDLING TECHNIQUES TO FACILITATE EXCAVATIONS, DEWATERING, AND PENETRATION.

EARTHWORK SITE PREPARATION:

- AFTER STRIPPING AND GRUBBING AND PRIOR TO ADDING FILL, PROOFROLL THE SUBGRADE WITH A HEAVY VIBRATORY ROLLER WITH A MINIMUM STATIC DRUM WEIGHT OF 10 TONS FOR AT LEAST 10 OVERLAPPING PASSES IN EACH OF TWO PERPENDICULAR DIRECTIONS AT WALKING SPEED IN THE PRESENCE OF THE ENGINEER OR AS DIRECTED BY THE ENGINEER. ADDITIONAL PASSES WILL BE REQUIRED IF CONTINUED SETTLEMENT IS OBSERVED. ADJUST THE MOISTURE CONTENT OF THE SUBGRADE SOILS AS NEEDED TO FACILITATE COMPACTION.
- COMPACTION OF SUBGRADE SOILS BELOW THE PROPOSED ROADWAYS, RAMPS, AND OTHER STRUCTURAL AREAS SHOULD EXTEND A MINIMUM HORIZONTAL MARGIN OF 5 FEET BEYOND THE EDGE OF THE PAVEMENT AND STRUCTURAL AREAS. COMPACTION OF THE SUBGRADE SOILS SHOULD BE VERIFIED TO A DEPTH OF ONE FOOT AND MEET OR EXCEED THE MINIMUM COMPACTION CRITERIA.
- ANY LOW AREAS RESULTING FROM THE STRIPPING, GRUBBING AND PROOFROLLING OPERATIONS SHALL BE FILLED TO FINISHED GRADE WITH COMPACTED STRUCTURAL FILL PER THE TECHNICAL SPECIFICATIONS.

ROADWAYS:

- FOR THE PROPOSED ROADWAYS AREAS, A SINGLE LAYER OF HIGH-STRENGTH GEOGRID REINFORCEMENT (TRI-AXIAL GEOGRID) SHALL BE INSTALLED BETWEEN THE COMPACTED SUBGRADE AND THE STABILIZED SUBGRADE. NOTE OTHER GEOGRID TYPES SHALL BE USED UNDER CONCRETE FOUNDATIONS AND BUILDING FOOTINGS. THE GEOGRID SHALL BE INSTALLED PER MANUFACTURER'S INSTRUCTIONS AND SECTION 02070.

PIPELINES:

- WHERE THE PIPE ALIGNMENT PASSES OVER FILL WITH DEBRIS, HEAVY COMPACTION SHALL TAKE PLACE AT THE PIPE INVERT ELEVATION AS WITH ROADWAYS AND RAMPS. HIGH-STRENGTH GEOTEXTILE SHOULD BE PLACED WITHIN THE TRENCH BELOW THE BEDDING, UP THE TRENCH SIDEWALL, AND ANCHORED A MINIMUM OF 3 FEET ON EITHER SIDE OF THE TRENCH AT A DEPTH OF ABOUT 1 FOOT.

MAINTENANCE OF TRAFFIC

- EXISTING TRAFFIC CONTROL SIGNS SHALL BE MAINTAINED OPERATIONAL AT ALL TIMES.
- ACCESS FOR LOCAL TRAFFIC WITH DESTINATIONS WITHIN THE PROJECT LIMITS SHALL BE MAINTAINED. IF DURING CONSTRUCTION ACCESS FOR LOCAL TRAFFIC IS CHANGED, THEN THE CONTRACTOR SHALL NOTIFY THE OWNER A MINIMUM OF THREE (3) WORKING DAYS IN ADVANCE. IF DURING CONSTRUCTION ROAD CLOSURES ARE REQUIRED, THEN THE CONTRACTOR SHALL NOTIFY THE OWNER A MINIMUM OF FIVE (5) WORKING DAYS IN ADVANCE.
- PRIOR TO COMMENCING WORK, THE CONTRACTOR SHALL FURNISH, ERECT AND MAINTAIN ALL BARRICADES, WARNING SIGNS, AND MARKINGS FOR HAZARDS AND THE CONTROL OF TRAFFIC, IN REASONABLE CONFORMITY WITH THE U.S. DEPARTMENT OF TRANSPORTATION MANUAL OF UNIFORM TRAFFIC CONTROL DEVICES FOR STREETS AND HIGHWAYS, OR AS DIRECTED BY THE OWNER, SUCH AS TO EFFECTIVELY PREVENT ACCIDENTS IN ALL PLACES WHERE THE WORK CAUSES OBSTRUCTION TO THE NORMAL TRAFFIC OR CONSTITUTES IN ANY WAY A HAZARD TO THE PUBLIC.
- EXISTING TRANSFER STATION MUST REMAIN OPERATIONAL DURING CONSTRUCTION OF NEW FACILITY. A TRAFFIC CONTROL PLAN MUST BE APPROVED BY THE OWNER PRIOR TO COMMENCING CONSTRUCTION.

GENERAL SIGNAGE AND STRIPING NOTES

- ALL SIGNS AND PAVEMENT MARKINGS SHALL BE IN ACCORDANCE WITH THE MANUAL OF UNIFORM TRAFFIC CONTROL DEVICES.
- ALL PAVEMENT STRIPING AND MARKINGS SHALL BE THERMOPLASTIC, MANUFACTURED AND INSTALLED IN ACCORDANCE WITH SECTION 711 OF THE LATEST EDITION OF THE F.D.O.T. STANDARD SPECIFICATIONS FOR ROAD AND BRIDGE CONSTRUCTION.
- DIMENSIONS ARE TO THE CENTERLINE OF MARKINGS.
- BLUE PAVEMENT MARKINGS SHALL BE TINTED TO MATCH SHADE 15180 OF FEDERAL STANDARDS 595a. SEE F.D.O.T. ROADWAY AND TRAFFIC DESIGN STANDARDS, INDEX NO. 17346.
- ALL SIGN FACES SHALL BE ENGINEERING GRADE REFLECTIVE SHEETING.
- SIGN SHALL BE CONSTRUCTED OF 0.080" THICK ALUMINUM.

SEQUENCE OF CONSTRUCTION:

- ALL Bmps TO BE INSTALLED BEFORE ANY LAND DISTURBING ACTIVITIES OR DEMOLITION ARE PERFORMED.
- INSTALL SEDIMENT CONTROL BARRIER IN AREAS DEDICATED FOR STOCKPILES OF EXCAVATED MATERIAL TO BE SAVED IN ACCORDANCE WITH THIS PLAN.
- INSTALL APPROPRIATE TRAFFIC CONTROLS AND M.O.T. EXCAVATE AND STOCKPILE EXISTING MATERIAL TO BE SAVED. HAUL EXCESS MATERIAL AND WASTE THROUGH THE EXISTING SCALE AND UNLOAD ON THE PORTER TRANSFER STATION FLOOR. THE CONTRACTOR WILL NOT BE CHARGED A DISPOSAL FEE BY THE OWNER FOR THIS MATERIAL. COMPLETE DEMOLITION.
- CONSTRUCT NEW CITIZEN'S UNLOADING AREA, HOUSEHOLD HAZARDOUS WASTE (HHW) FACILITY AND ASSOCIATED IMPROVEMENTS AND SOUTHERN BYPASS ROAD.
- INSTALL APPROPRIATE TRAFFIC CONTROLS AND M.O.T. INSTALL NEW SCALE AND SCALEHOUSE.
- DURING THE FACILITY'S NON-OPERATIONAL HOURS, DEMOLISH THE EXISTING SCALE ONCE THE NEW SCALE AND SCALEHOUSE ARE OPERATIONAL AND CONSTRUCT ROADWAY IN FORMER SCALES LOCATION.
- RESURFACE VEGETATION AREAS UPON COMPLETION OF CONSTRUCTION ACTIVITIES PER THE DRAWINGS AND TECHNICAL SPECIFICATIONS. SLOPED AREAS 6(H) TO 1(V) OR GREATER SHALL BE REVEGETATED WITH SOD WITHIN 72 HOURS OF FINAL GRADING.


UTILITY NOTES:

- THE CONTRACTOR SHALL NOTIFY THE APPROPRIATE UTILITY COMPANY FORTY-EIGHT (48) HOURS IN ADVANCE OF ANY EXCAVATION INVOLVING ITS UTILITIES SO THAT A COMPANY REPRESENTATIVE CAN BE PRESENT. THE LOCATION OF THE UTILITIES SHOWN IN THE DRAWINGS ARE APPROXIMATE. THE EXACT LOCATION SHALL BE DETERMINED BY THE CONTRACTOR DURING CONSTRUCTION. THE CONTRACTOR SHALL ALSO CONTACT THE "SUNSHINE STATE ONE CALL SYSTEM" FOR UNDERGROUND LOCATION OF EXISTING UTILITIES A MINIMUM OF 48 HRS. PRIOR TO EXCAVATION.
- EXISTING UTILITIES AND FACILITIES SHOWN ON THE DRAWINGS WERE LOCATED FROM THE OWNER'S RECORDS OF UNDERGROUND FACILITIES. GUARANTEE IS NOT MADE THAT ALL EXISTING FACILITIES ARE SHOWN NOR THAT THOSE FACILITIES SHOWN ARE ENTIRELY ACCURATE. THE CONTRACTOR SHALL BE RESPONSIBLE FOR PROTECTION OF ALL UTILITIES TO REMAIN IN PLACE.
- THE CONTRACTOR SHALL BE RESPONSIBLE TO VERIFY IF OTHER UTILITIES (NOT SHOWN IN THE PLANS) EXIST WITHIN THE AREA OF CONSTRUCTION. SHOULD THERE BE OTHER UTILITIES, THE CONTRACTOR SHALL NOTIFY THE APPROPRIATE UTILITY OWNERS TO RESOLVE UTILITY CONFLICTS AND UTILITY ADJUSTMENT, AS REQUIRED.
- UTILITIES ARE TO BE ADJUSTED OR RELOCATED BY THE UTILITY COMPANIES UNLESS OTHERWISE NOTED.
- THE CONTRACTOR SHALL BE RESPONSIBLE FOR THE LOCATION AND PROTECTION OF ALL UTILITIES THAT MAY EXIST, ABOVE OR BELOW GROUND. THE CONTRACTOR IS RESPONSIBLE FOR PROTECTION OF ALL UTILITIES TO REMAIN IN PLACE.
- ALL WORK SHALL BE IN ACCORDANCE WITH ORANGE COUNTY UTILITIES, WATER AND WASTEWATER UTILITY STANDARDS.



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David Beben Digitally signed by David Beben PE No. 73005 Florida Date: 2018.03.20 14:01:00 -0400 DAVID M. BEBEN, PE LICENSE NO. 73005	
CHK BY	
DESCRIPTION	
DATE	
REV	◀◀◀◀◀◀
SHEET TITLE	GENERAL NOTES
PROJECT TITLE	PORTER TRANSFER STATION SITE IMPROVEMENTS
CLIENT	ORANGE COUNTY SOLID WASTE DIVISION ORLANDO, FLORIDA
CADD FILE:	05401NOTES
DATE:	MARCH 2018
SCALE:	AS SHOWN
DRAWING NO.	2
SHEET	2 of 34

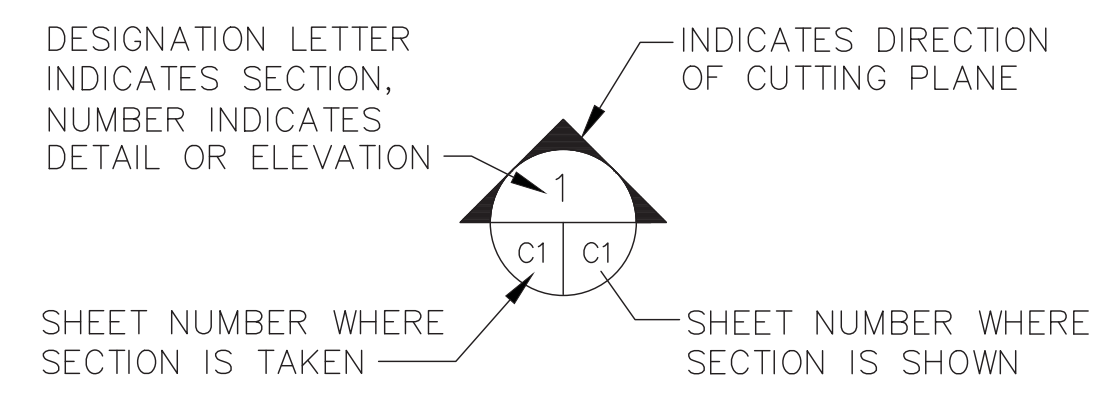

SECTION AND DETAIL DESIGNATION

ISSUED FOR BID

DATE: 3/20/18




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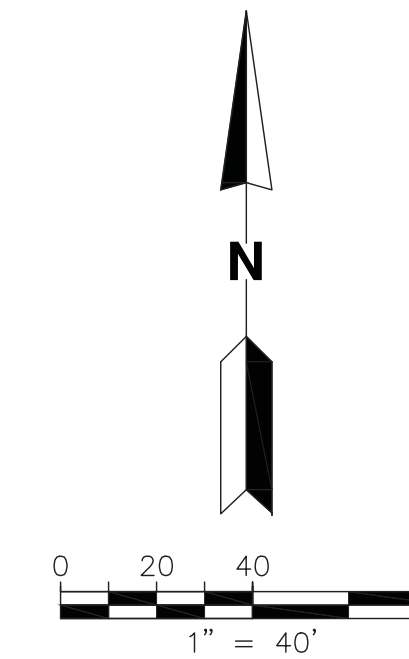
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LEGEND

- APPROXIMATE PROPERTY BOUNDARY
- APPROXIMATE LIMITS OF CONSTRUCTION



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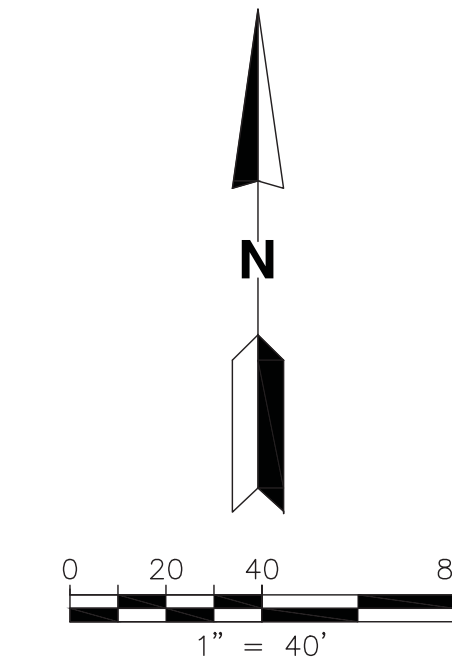

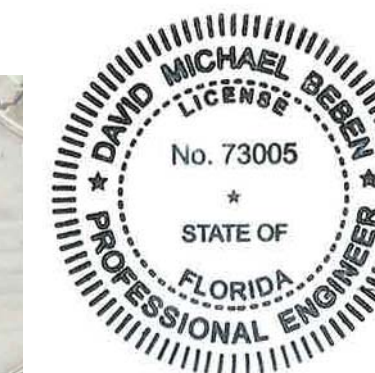
<p>SCS ENGINEERS STEARNS, CONRAD AND SCHMIDT CONSULTING ENGINEERS 5850 SOUTH SEMORAN BLVD, ORLANDO, FLORIDA 32822 PH (407) 204-3231 FAX NO. (813) 623-6757 FLORIDA CERTIFICATE OF AUTHORIZATION NO. 00004892 PROJ. NO. 09216054.01 DWG. BY: KKC C/A BY: SAT/CAJ DES. BY: SRF CHK. BY: SRF APP. BY: SRF</p>	<p>ORANGE COUNTY SOLID WASTE DIVISION ORLANDO, FLORIDA</p>	<p>OVERALL SITE PLAN AERIAL PORTER TRANSFER STATION SITE IMPROVEMENTS</p>	<p>David Beben PE No. 73005 Florida Digitally signed by David Beben PE No. 73005 Florida Date: 2018.03.20 14:02:06 -0400</p>
<p>CADD FILE: 05401EXIST-AERIAL</p>		<p>DATE: MARCH 2018</p>	
<p>SCALE: AS SHOWN</p>		<p>DRAWING NO. 3</p>	
<p>SHEET 3 of 34</p>		<p>DATE: 3/20/18</p>	

ISSUED FOR BID



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David Beben PE
No. 73005
Florida
Digitally signed by David Beben PE No. 73005
Date: 2018.03.20 14:03:13 -04'00'
DAVID M. BEBEN, PE
LICENSE NO. 73005

CHK. BY	DESCRIPTION	DATE	REV

SHEET TITLE
EXISTING CONDITIONS
PROJECT TITLE
**PORTER TRANSFER STATION
SITE IMPROVEMENTS**

CLIENT
**ORANGE COUNTY
SOLID WASTE DIVISION
ORLANDO, FLORIDA**

SCS ENGINEERS
STEARNS, CONRAD AND SCHMIDT
CONSULTING ENGINEERS
5850 SOUTH SEMORAN BLVD, ORLANDO, FLORIDA 32822
PH (407) 204-3231 FAX NO. (813) 623-6757
FLORIDA CERTIFICATE OF AUTHORIZATION NO. 00004892
REG. NO. 09216054.01 DWN. BY: KKC C/A: SRF/CFAR
ISS. BY: SRF APP. BY: SRF

CADD FILE:
05401TOPO
DATE:
MARCH 2018
SCALE:
AS SHOWN
DRAWING NO.
4
SHEET 4 of 34




- NOTES:**
- TOPOGRAPHIC SURVEY PERFORMED BY APEX ENGINEERING, INC. P.O. BOX 568891, ORLANDO, FLORIDA 32856. DATE OF SURVEY: MARCH 23, 2017. UNLESS IT BEARS THE SIGNATURE AND THE ORIGINAL RAISED SEAL OF A FLORIDA LICENSED SURVEYOR AND MAPPER, THIS MAP IS FOR INFORMATIONAL PURPOSES ONLY AND IS NOT VALID.
 - LANDS SHOWN HEREON WERE NOT ABSTRACTED BY THE SURVEYOR FOR RIGHT OF WAYS AND/OR EASEMENTS OF RECORD OR OWNERSHIP.
 - NO UNDERGROUND UTILITIES OR STRUCTURES WERE LOCATED UNLESS OTHERWISE SHOWN.
 - THE HORIZONTAL DATUM IS RELATIVE TO NORTH AMERICAN DATUM, NAD 1983, 2007 ADJUSTED, STATE PLANE COORDINATE SYSTEM, EAST ZONE.
 - VERTICAL DATUM IS BASED ON THE NORTH AMERICAN VERTICAL DATUM OF 1988 (NAVD 88) UTILIZING ORANGE COUNTY BENCH MARK # L1057014 AND L1057018.
 - LOCATIONS, ELEVATIONS, AND DIMENSIONS OF EXISTING UTILITIES, STRUCTURES AND OTHER FEATURES ARE SHOWN ACCORDING TO THE BEST INFORMATION AVAILABLE AT THE TIME OF PREPARATION OF THESE PLANS AND SERVE AS NOTICE TO THE CONTRACTOR THAT UNDERGROUND UTILITIES EXIST. THE CONTRACTOR SHALL VERIFY THE LOCATIONS, ELEVATIONS AND DIMENSIONS OF ALL EXISTING UTILITIES, STRUCTURES, AND OTHER FEATURES AFFECTING CONTRACTOR PRIOR TO CONSTRUCTION. THE CONTRACTOR SHALL NOTIFY THE OWNER IMMEDIATELY WHEN CONFLICTS BETWEEN DRAWINGS AND ACTUAL CONDITIONS ARE DISCOVERED.
 - THE CONTRACTOR'S ATTENTION IS CALLED TO THE FACT THAT THERE MAY BE SOME AREAS OF POSSIBLE UTILITY CONFLICTS. IT SHALL BE THE CONTRACTOR'S RESPONSIBILITY TO LOCATE AND PROTECT ANY AND ALL EXISTING UTILITIES ON THIS PROJECT. THE CONTRACTOR SHALL REPAIR ALL DAMAGE TO EXISTING UTILITIES AT NO ADDITIONAL COST TO THE OWNER.
 - THE OWNER AND THE CONTRACTOR WILL COORDINATE ON THE FINAL BOUNDARIES OF THE CONTRACTOR'S CONSTRUCTION LAYDOWN/STAGING AREA AND CONTRACTOR'S ACCESS FROM THE STAGING AREA TO GOOD HOMES ROAD AT THE PRE-CONSTRUCTION MEETING. THE CONSTRUCTION LAYDOWN/STAGING AREA AND THE CONTRACTOR'S ACCESS ROAD TO THE MAIN ROAD SHALL BE GRADED TO EXISTING GRADES, SEEDED AND MULCHED AS REQUIRED UPON COMPLETION OF THE PROJECT PER THE SPECIFICATIONS.
 - QUANTITY AND LOCATION OF SILT FENCE MAY VARY DUE TO CONSTRUCTION SEQUENCE. CONTRACTOR SHALL HAVE EROSION AND SEDIMENTATION CONTROLS IN PLACE DURING ALL CONSTRUCTION ACTIVITIES TO THE SATISFACTION OF THE ENGINEER.

LEGEND	
	APPROXIMATE PROPERTY BOUNDARY
	CONTOURS - EXISTING
	DRAINAGE PIPE - EXISTING
	CHAIN LINK FENCE
	FENCE - WOOD
	GUARDRAIL
	LAYDOWN/STAGING AREA
	APPROXIMATE LIMITS OF CONSTRUCTION
	ASPHALT - EXISTING
	CONCRETE - EXISTING
	C-1 APPROXIMATE CPT LOCATION
	B-1 APPROXIMATE SPT LOCATION
	SURVEY CONTROL POINT

ISSUED FOR BID
DATE: 3/20/18

G:\PROJECT\Orange\09216054.01 - Site Improvements\Const Drawings\05401DEMO.dwg Mar 20, 2018 - 10:50am Layout Name: DEMOLITION AND EROSION CONTROL PLAN By: 43824kc

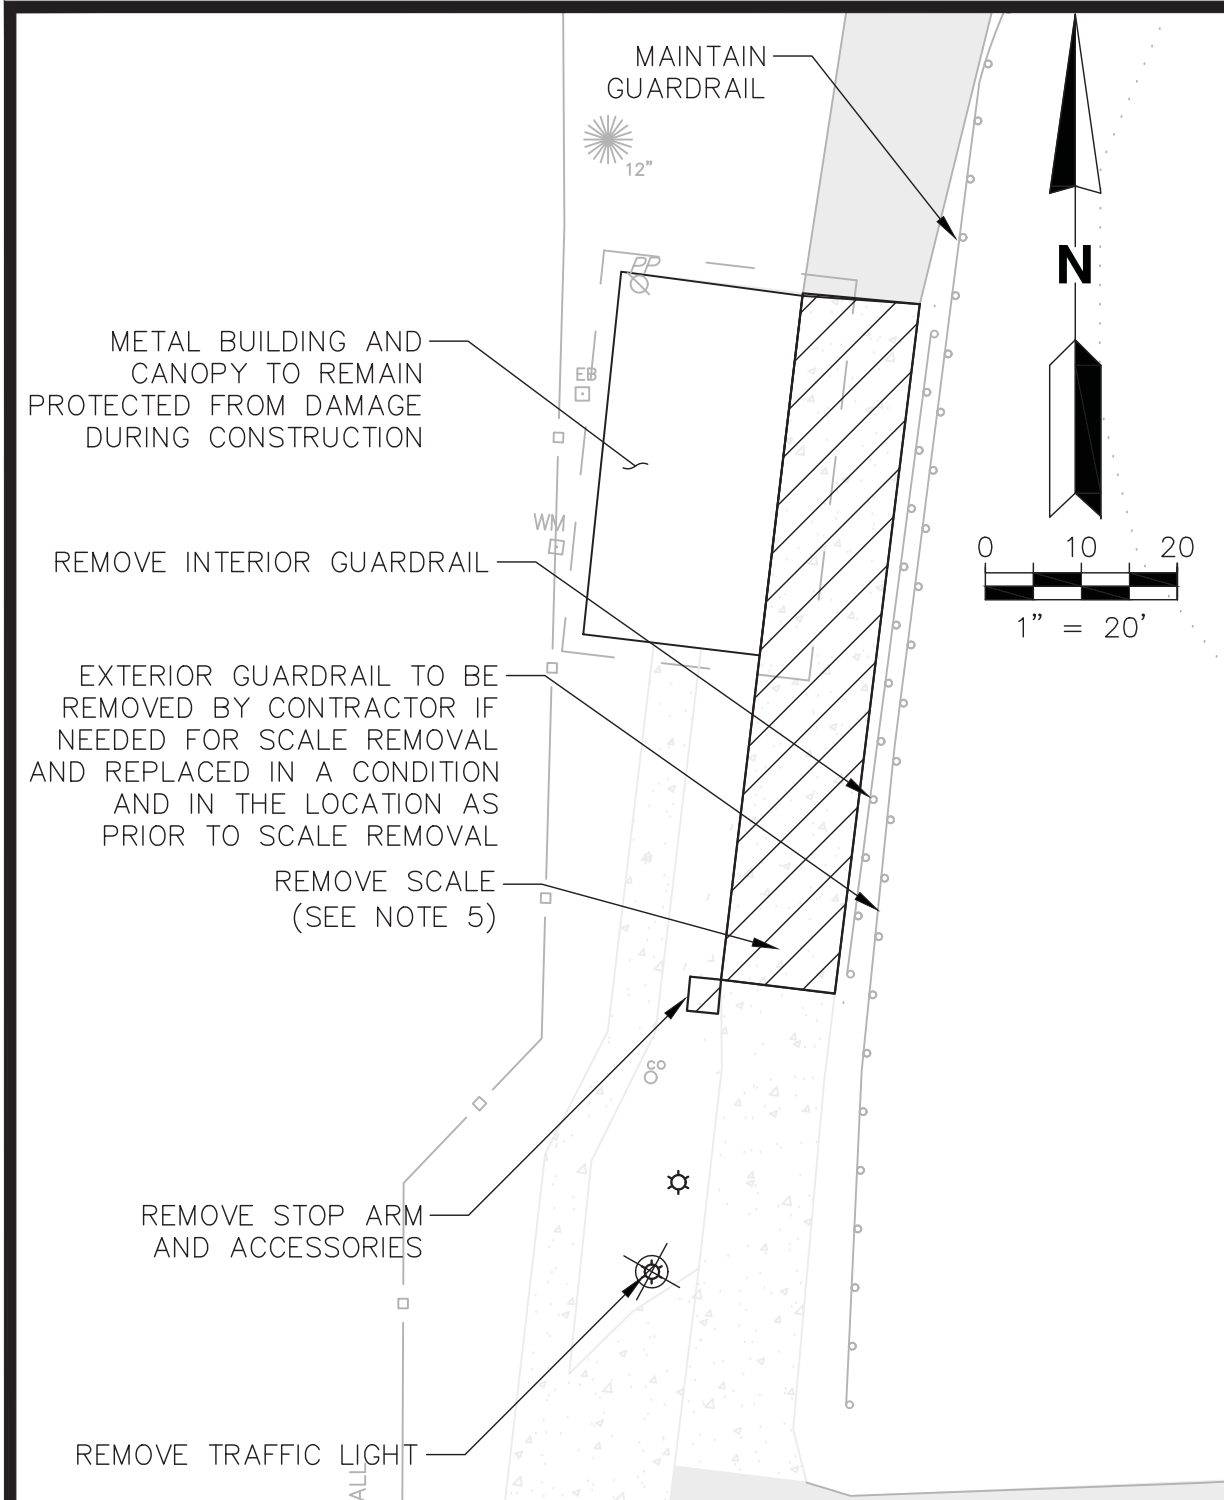


SCALE DEMOLITION DETAIL

SCALE: 1"=20'

NOTES:

1. FINAL GRADES, MATERIALS, AND SODDING REQUIREMENTS AFTER DEMOLITION SHALL BE COMPLETED PER SHEET 6 AND SPECIFICATIONS.
2. IT SHALL BE THE CONTRACTOR'S RESPONSIBILITY TO COLLECT ALL REQUIRED INFORMATION NECESSARY FOR THE PROPOSED DEMOLITION OF STRUCTURES AND PROTECTION OF THE EXISTING STRUCTURES AND UTILITIES. STRUCTURES, UTILITIES, ROADS, BUILDING MATERIALS, DIMENSIONS, ETC. SHOWN ARE APPROXIMATE REPRESENTATIONS OF EXISTING SITE CONDITIONS. THE INFORMATION COLLECTED BY THE CONTRACTOR (DURING A SITE AND STRUCTURE INVESTIGATION, REVIEW OF APPLICABLE DRAWINGS, ETC.) SHALL BE USED BY THE CONTRACTOR TO VERIFY SITE CONDITIONS AND TO CREATE A DEMOLITION WORK-PLAN. THE WORK-PLAN SHALL INCLUDE, BUT IS NOT LIMITED TO, THE FOLLOWING INFORMATION:
 - A. PHYSICAL COMPONENTS AND EXTENTS OF STRUCTURES ABOVE/BELOW GROUND.
 - B. TECHNIQUE AND METHOD OF DEMOLITION TO BE ADOPTED.
 - C. PERSONNEL REQUIRED FOR DEMOLITION.
 - D. EQUIPMENT REQUIRED FOR DEMOLITION (SIZE, WEIGHT, AND METHOD OF MOVEMENT AROUND SITE).
 - E. PROPOSED ACCESS AND EGRESS TO THE DEMOLITION SITE, STRUCTURES, AND ANY ADJOINING PROPERTIES AFFECTED BY THE WORK (INCLUDES EMERGENCY ACCESS AND EGRESS).
 - F. NATURE, EXTENT AND LOCATION OF PUBLIC PROTECTION DURING DEMOLITION (EG. FENCING, BARRICADES, SCAFFOLDING, NETS, SIGNAGE, ETC.).
 - G. UTILITY LOCATION/PROTECTION BEFORE/DURING DEMOLITION TO INCLUDE ARRANGEMENTS FOR ISOLATION/DISCONNECTION OF SERVICES AS REQUIRED. LOCATIONS, ELEVATIONS, AND DIMENSIONS OF EXISTING UTILITIES, STRUCTURES AND OTHER FEATURES ARE SHOWN ACCORDING TO THE BEST INFORMATION AVAILABLE AT THE TIME OF PREPARATION

- OF THESE PLANS AND SERVE AS NOTICE TO THE CONTRACTOR THAT UNDERGROUND UTILITIES EXIST. THE CONTRACTOR'S ATTENTION IS CALLED TO THE FACT THAT THERE MAY BE SOME AREAS OF POSSIBLE UTILITY CONFLICTS. IT SHALL BE THE CONTRACTOR'S RESPONSIBILITY TO LOCATE AND PROTECT ANY AND ALL EXISTING UTILITIES ON THIS PROJECT THAT ARE TO BE REUSED/UNAFFECTED. THE CONTRACTOR SHALL REPAIR ALL DAMAGE TO EXISTING UTILITIES AT NO ADDITIONAL COST THAT ARE NOT SCHEDULED FOR DEMOLITION/REMOVAL.
- H. LOCATION/PROTECTION OF OTHER FEATURES AFFECTING CONTRACTOR PRIOR TO DEMOLITION. THE CONTRACTOR SHALL NOTIFY THE OWNER IMMEDIATELY WHEN CONFLICTS BETWEEN DRAWINGS AND ACTUAL CONDITIONS ARE DISCOVERED.
 - I. TYPE OF PERSONAL PROTECTIVE EQUIPMENT (PPE) REQUIRED FOR PERSONNEL INVOLVED IN THE DEMOLITION PROJECT.
 - J. PROPOSED METHOD OF HANDLING DEMOLITION DEBRIS.
 - K. DEMOLITION DEBRIS DISPOSAL SHALL BE IN ACCORDANCE WITH THE SPECIFICATIONS.
3. MAINTENANCE AND PROTECTION OF TRAFFIC CONTROL DURING CONSTRUCTION SHALL BE TO THE STANDARDS OF APPLICATION AS FOUND IN THE "MANUAL OF TRAFFIC CONTROL AND PRACTICES" STATE OF FLORIDA DOT AND THE DIRECTIVES OF THE OWNER THE CONTRACT SPECIFICATIONS.
 4. MATERIALS RESULTING FROM DEMOLITION ACTIVITIES SUCH AS RUBBISH, SCRAP PIECES, EQUIPMENT, EXCESS SOILS, ETC. (DEMOLITION DEBRIS) SHALL BE DISPOSED OF IN ACCORDANCE WITH THE SPECIFICATIONS.
 5. REMOVE EXISTING SCALE AFTER THE PROPOSED SCALE AND SCALE HOUSE ARE INSTALLED AND FUNCTIONING. DEMOLITION AND ROADWAY CONSTRUCTION OVER THE EXISTING SCALE SHALL OCCUR OUTSIDE OF FACILITY OPERATING HOURS.

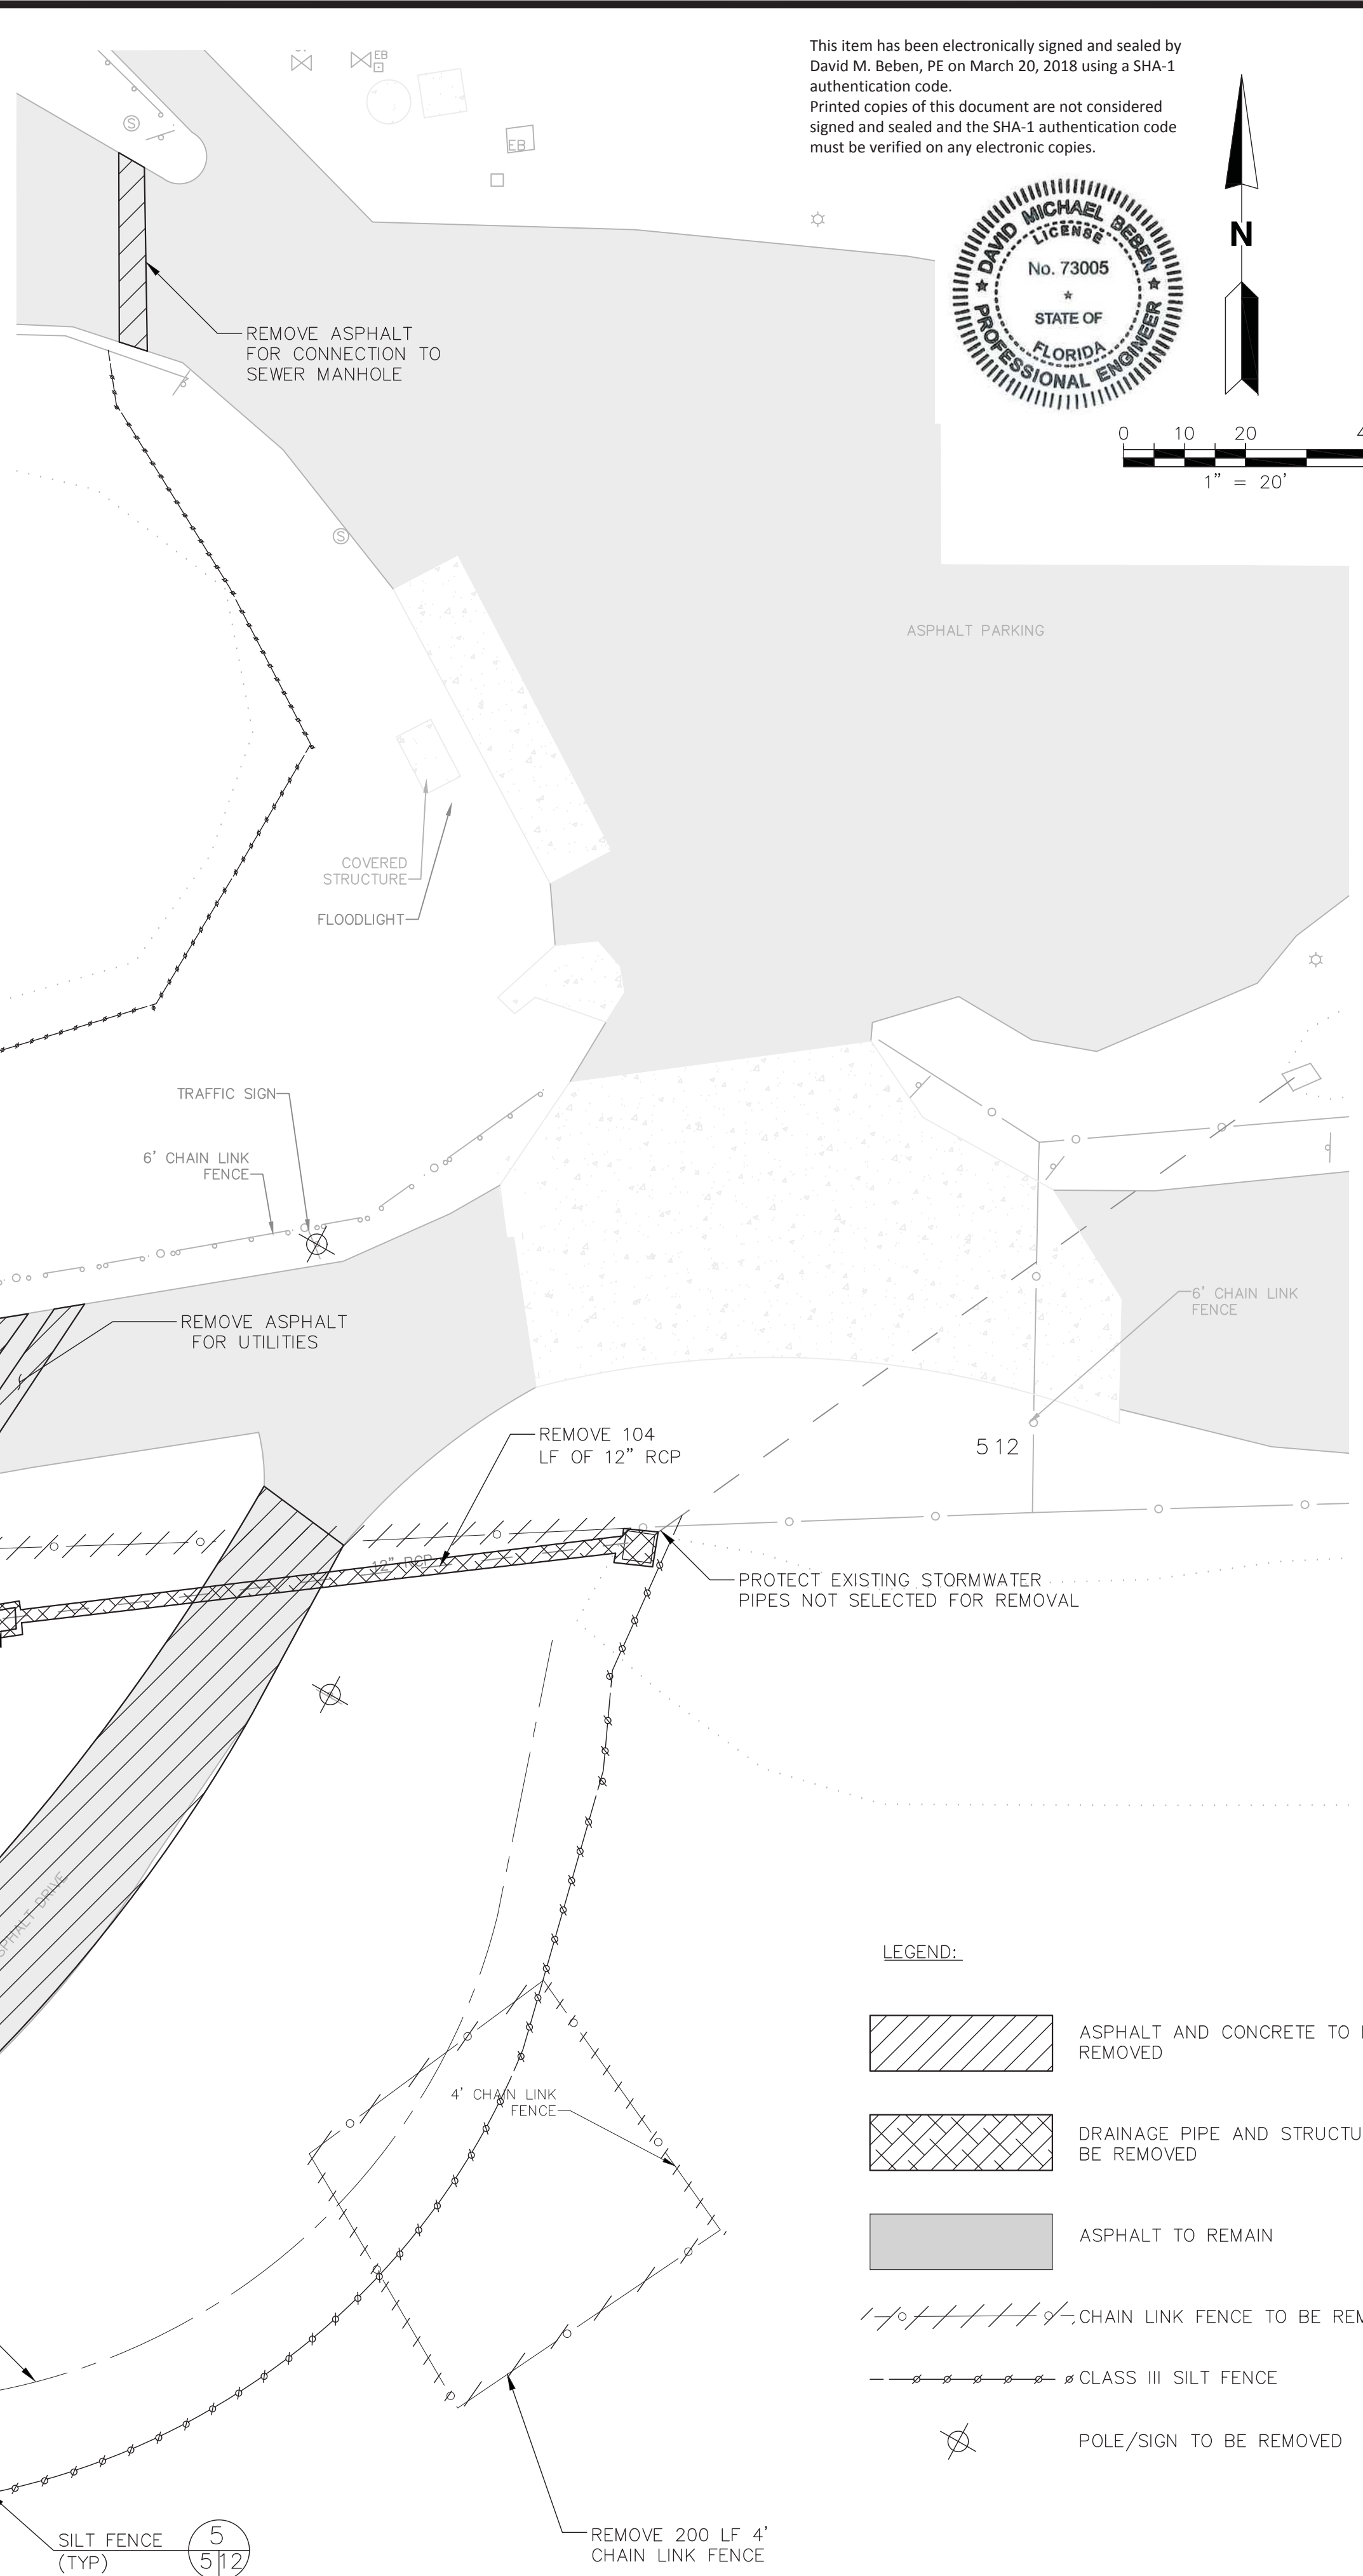

LEGEND:

	ASPHALT AND CONCRETE TO BE REMOVED
	DRAINAGE PIPE AND STRUCTURE TO BE REMOVED
	ASPHALT TO REMAIN
	CHAIN LINK FENCE TO BE REMOVED
	CLASS III SILT FENCE
	POLE/SIGN TO BE REMOVED

ISSUED FOR BID

DATE: 3/20/18

David Beben
PE No. 73005
Florida
Digitally signed by David Beben PE No. 73005
Date: 2018.03.20 14:04:10 -0400



CHK. BY	DESCRIPTION	DATE	REV

SHEET TITLE: **DEMOLITION AND EROSION CONTROL PLAN**
PROJECT TITLE: **PORTER TRANSFER STATION SITE IMPROVEMENTS**

CLIENT: **ORANGE COUNTY SOLID WASTE DIVISION ORLANDO, FLORIDA**


SCS ENGINEERS
STEARNS, CONRAD AND SCHMIDT
CONSULTING ENGINEERS
5850 SOUTH SEMORAN BLVD, ORLANDO, FLORIDA 32822
PH (407) 204-3231 FAX NO. (813) 623-6757
FLORIDA CERTIFICATE OF AUTHORIZATION NO. 00004892
REG. NO. 09216054.01 DWM: BT: KKC C/A: RW: BT: SAT / CAR
ISS: 8/18 APP: 8/18 SRF

CADD FILE: 05401DEMO
DATE: MARCH 2018
SCALE: AS SHOWN
DRAWING NO. **5**
SHEET 5 of 34

G:\PROJECT\Orange\09216054.01 Porter TS\Item 3 - Site Improvements\Const Drawings\05401SITE.dwg Mar 20, 2018 - 10:51am Layout Name: NEW HHWF AND SCALE SITE PLAN By: 4382kkc

MATCH LINE "A" - "A" THIS SHEET


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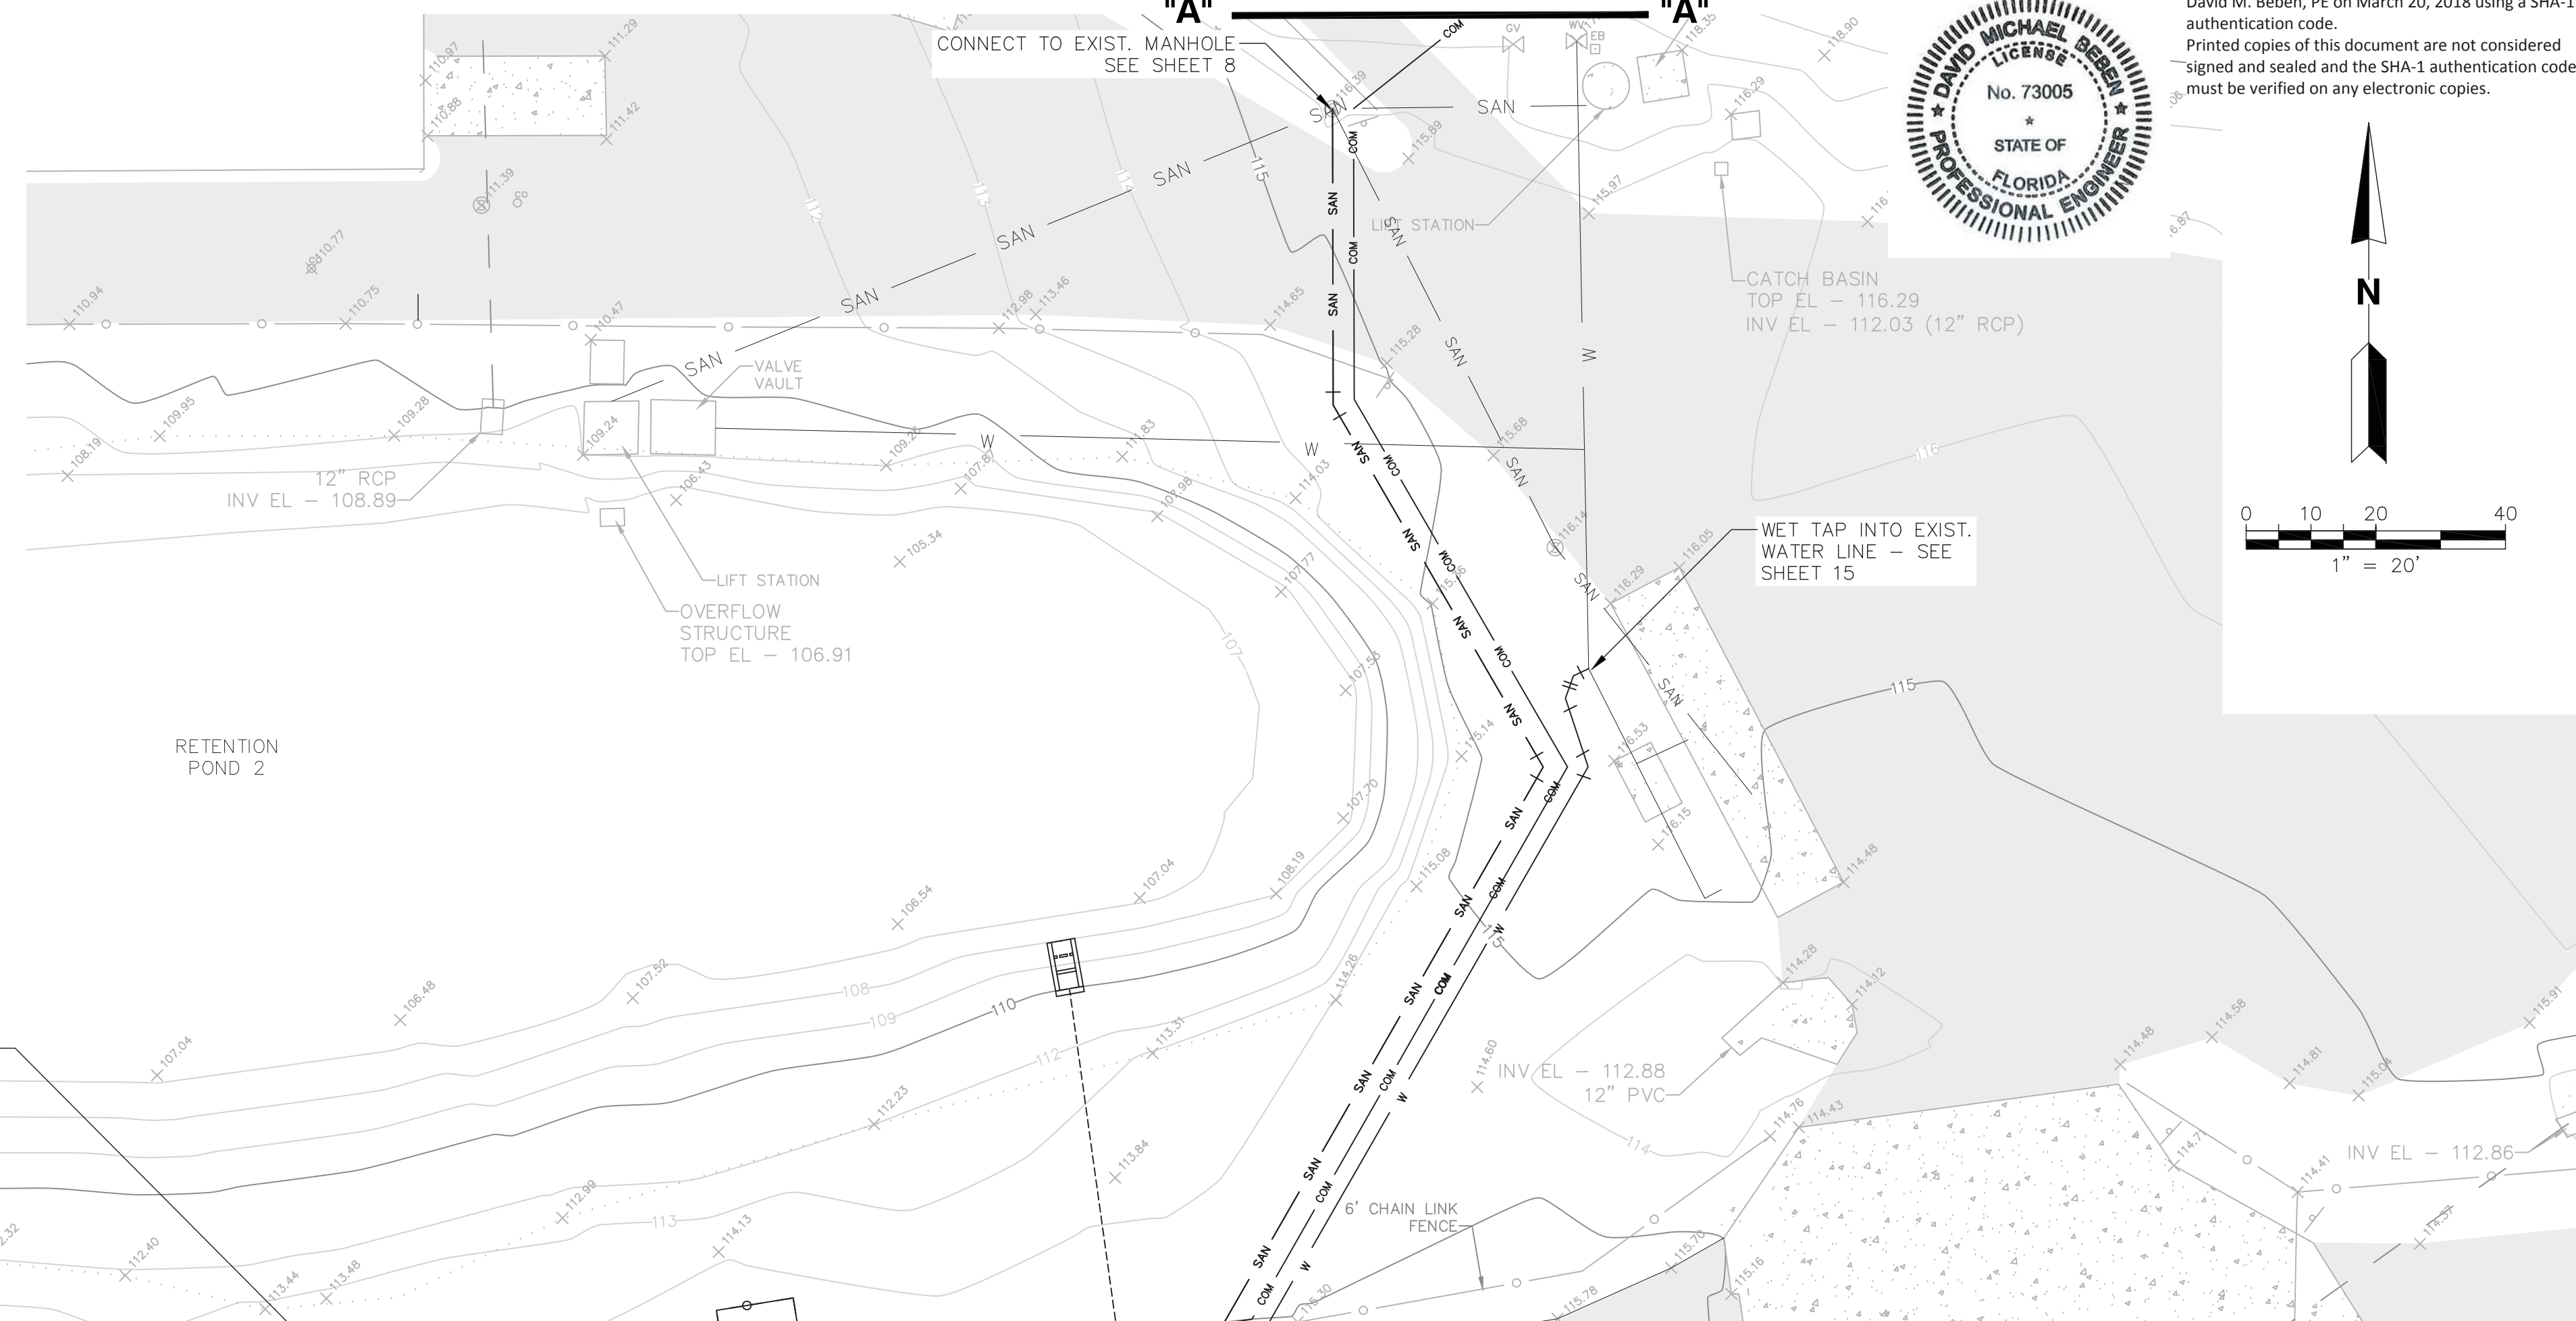
David Beben
PE No. 73005
Florida
Digitally signed by David Beben PE No. 73005
Date: 2018.03.20 14:07:28 -0400

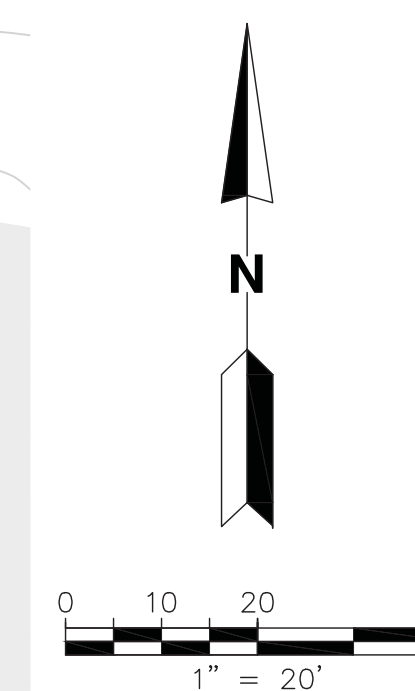CHK. BY	DESCRIPTION	DATE	REV

EXISTING SCALE REHABILITATION DETAIL
SEE EXISTING CONDITIONS PLAN FOR LOCATION



"A" ————— "A"

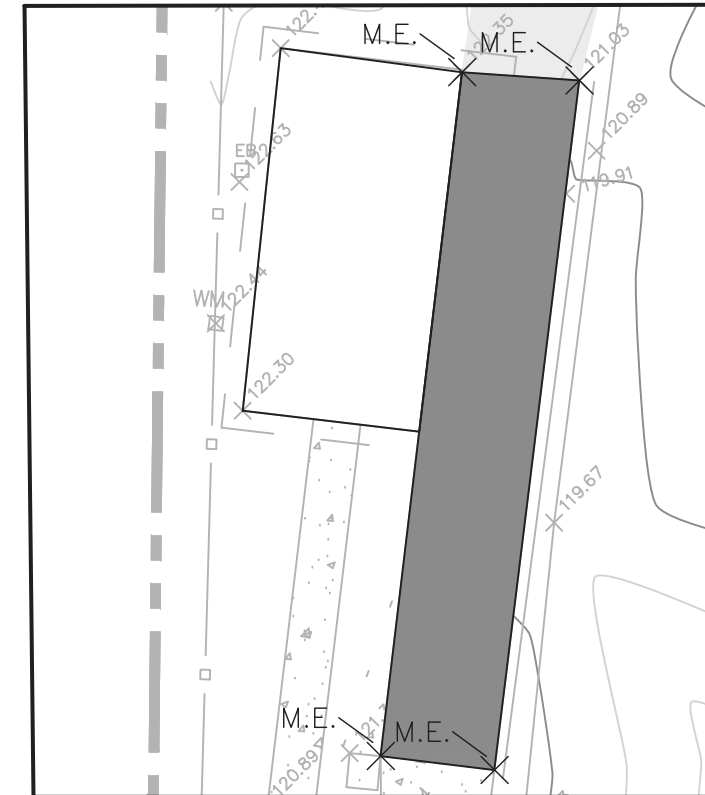


RETENTION POND 2

CO-LOCATE COM LINE WITH ELECTRICAL TO SCALE HOUSE, SECURITY CAMERA, AND UNATTENDED SCALE TERMINAL

LIGHT POLE WITH CAMERA
CONTINUOUS WITH POWER

LEGEND

	ASPHALT - EXISTING
	ASPHALT - PROPOSED
	CONCRETE - EXISTING
	CONCRETE - PROPOSED
	UNLOADING AREA
	CONTOURS - EXISTING
	CHAIN LINK FENCE - EXISTING
	CHAIN LINK FENCE - REINSTALLED
	COMMUNICATIONS LINE - PROPOSED
	DRAINAGE PIPE - EXISTING
	DRAINAGE PIPE - PROPOSED
	ELECTRIC LINE - EXISTING
	ELECTRIC LINE - PROPOSED
	GUARDRAIL - EXISTING
	GUARDRAIL - PROPOSED
	SANITARY SEWER LINE - EXISTING
	SANITARY SEWER LINE - PROPOSED
	SPOT ELEVATIONS - EXISTING
	SPOT ELEVATIONS - PROPOSED
	WATER LINE - EXISTING
	WATER LINE - PROPOSED
	WOOD FENCE - EXISTING
	UTILITY CLEAN OUT
	END WALL WITH BAFFLES
	DRAINAGE FLOW ARROW
	LIGHT POLE - PROPOSED
	M.E. MATCH EXISTING ELEVATION
	FFE FINISHED FLOOR ELEVATION

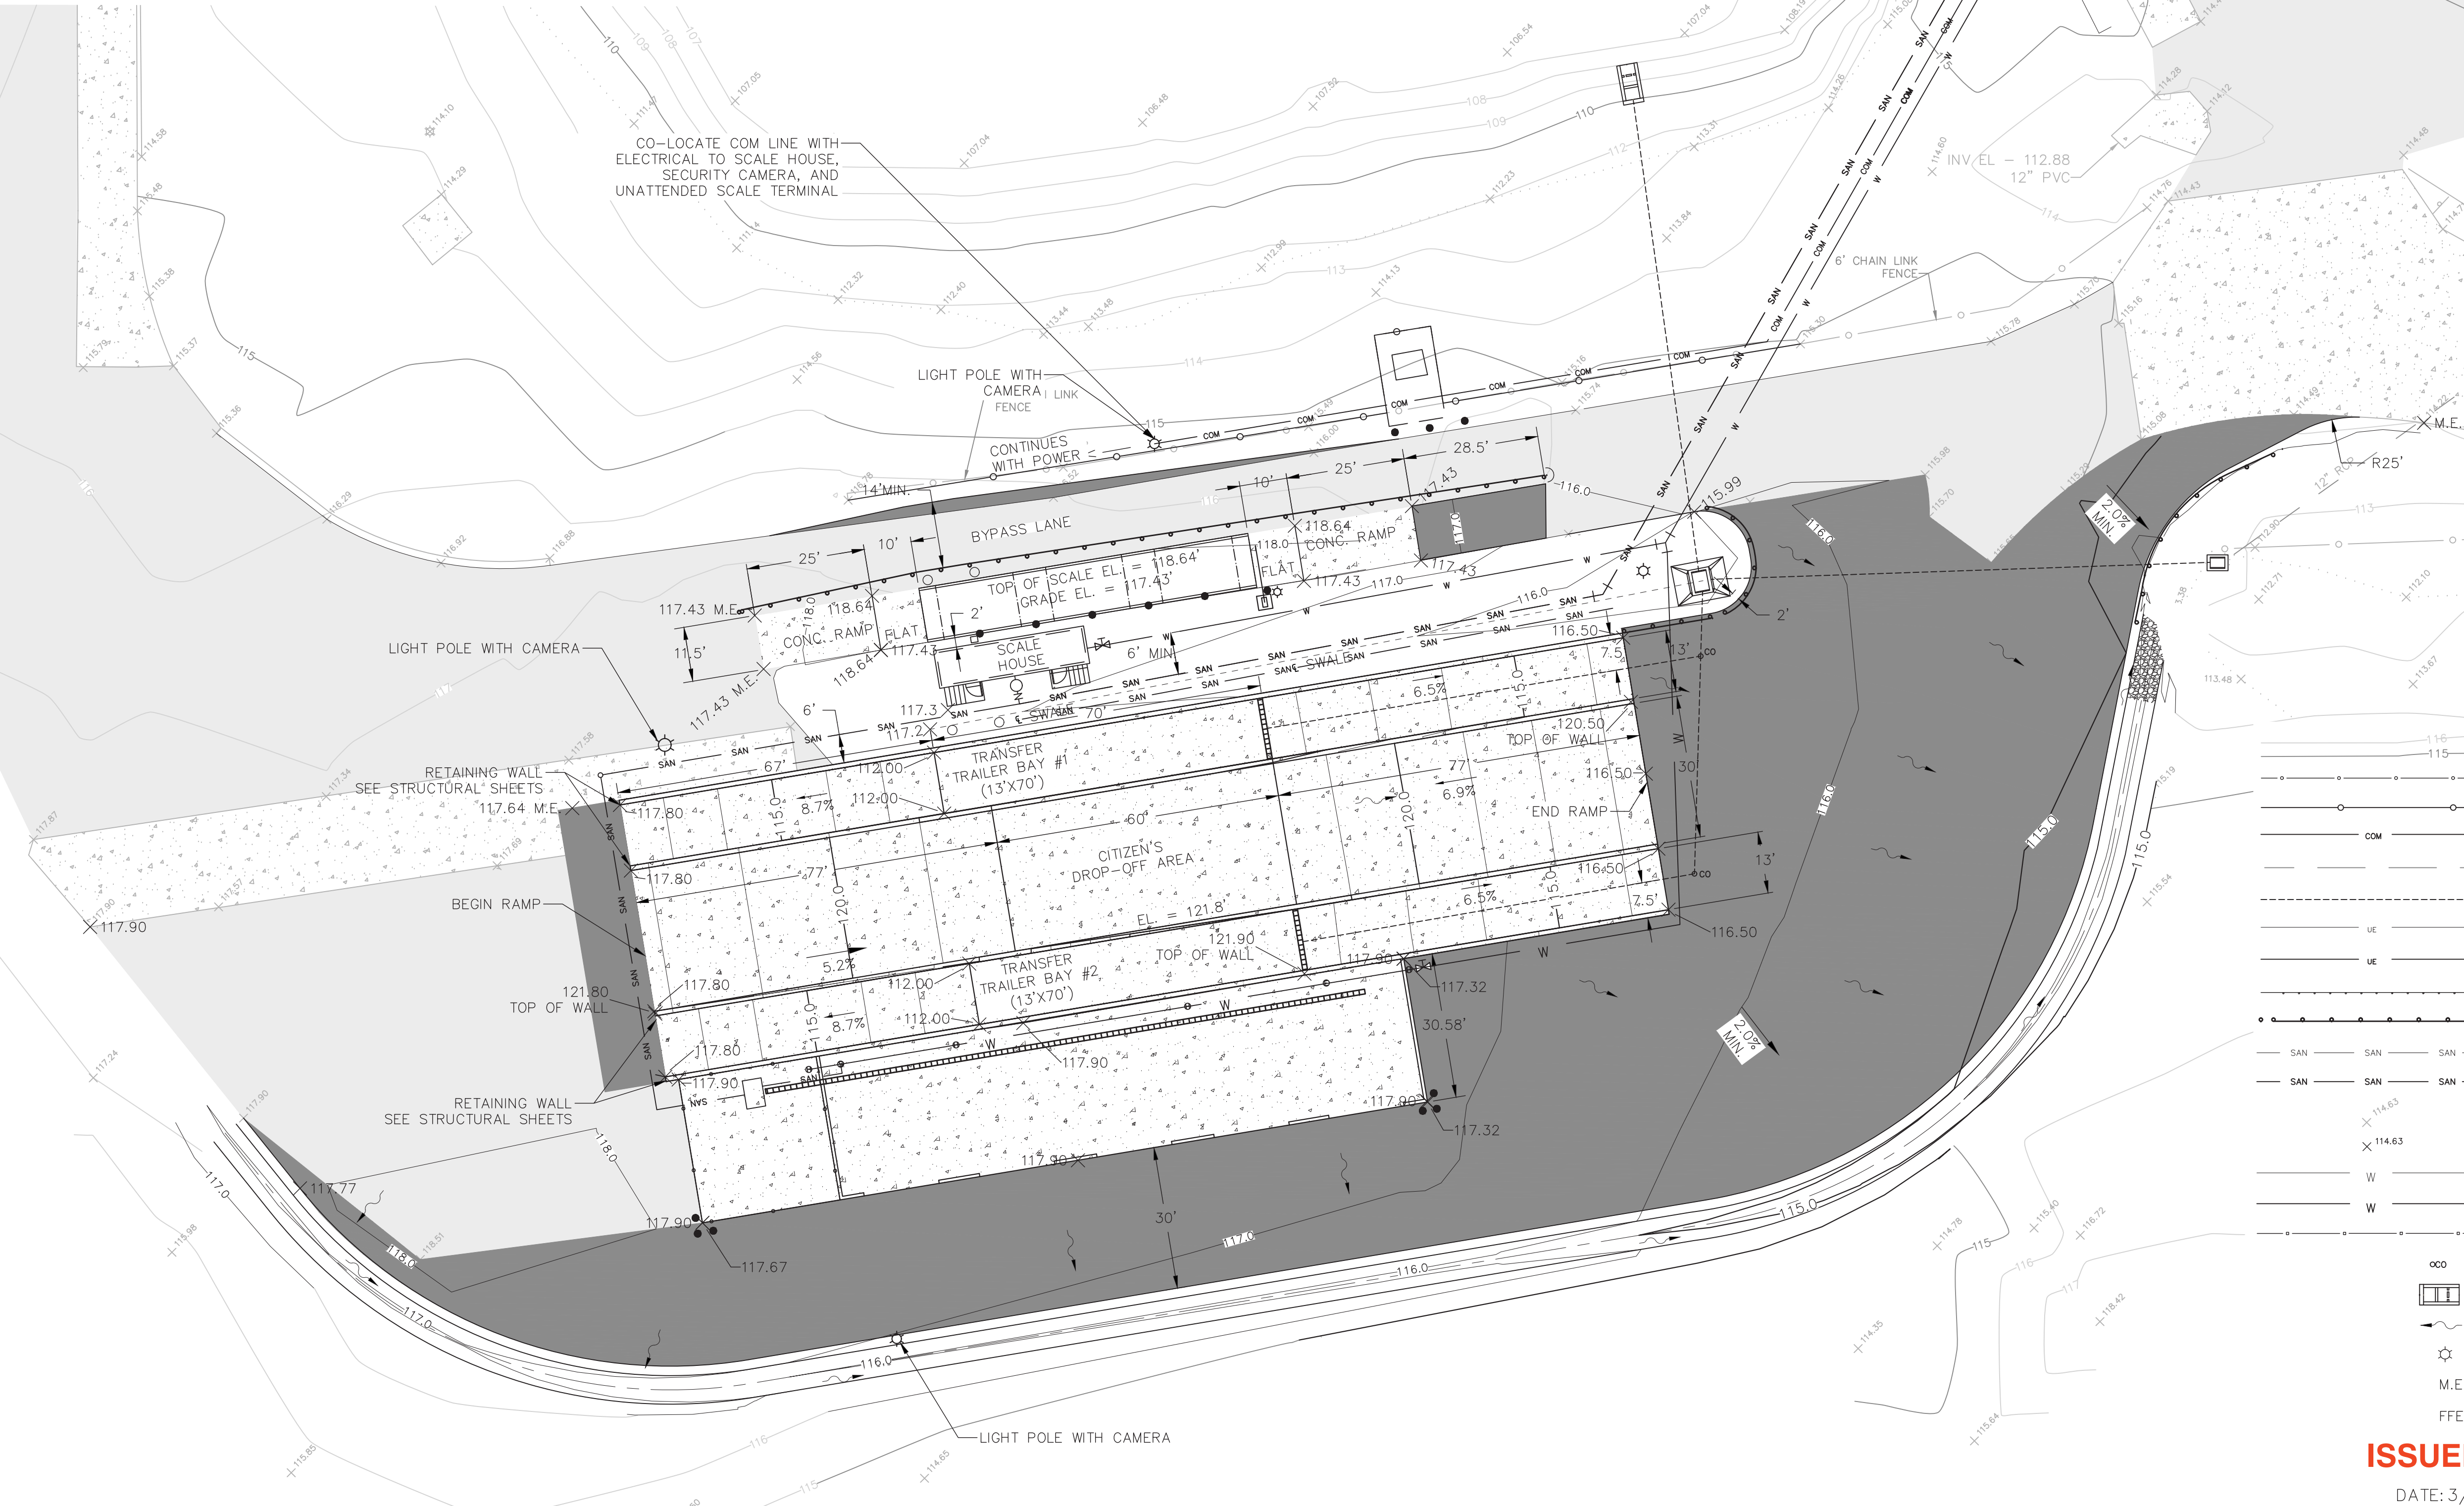

SHEET TITLE
NEW HHWF AND SCALE SITE PLAN
PROJECT TITLE
**PORTER TRANSFER STATION
SITE IMPROVEMENTS**



CLIENT
**ORANGE COUNTY
SOLID WASTE DIVISION
ORLANDO, FLORIDA**

SCS ENGINEERS
STEARNS, CONRAD AND SCHMIDT
CONSULTING ENGINEERS
5850 SOUTH SEMORAN BLVD, ORLANDO, FLORIDA 32822
PH (407) 204-3231 FAX NO. (813) 623-6757
FLORIDA CERTIFICATE OF AUTHORIZATION NO. 00004892
PROJ. NO. 09216054.01 DWN. BY: KKC C/A BY: JAR
ISS. BY: DMB GRC. BY: SRF APP. BY: SRF


CADD FILE: 05401SITE
DATE: MARCH 2018
SCALE: AS SHOWN
DRAWING NO. **7**
SHEET 7 of 34

ISSUED FOR BID
DATE: 3/20/18

G:\PROJECT\Orange\09216054.01 - Site Improvements\Const Drawings\05401UTILITY.dwg Mar 20, 2018 - 10:51am Layout Name: UTILITY PROFILE By: 4382kcc

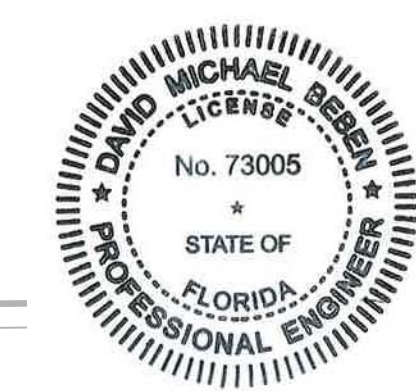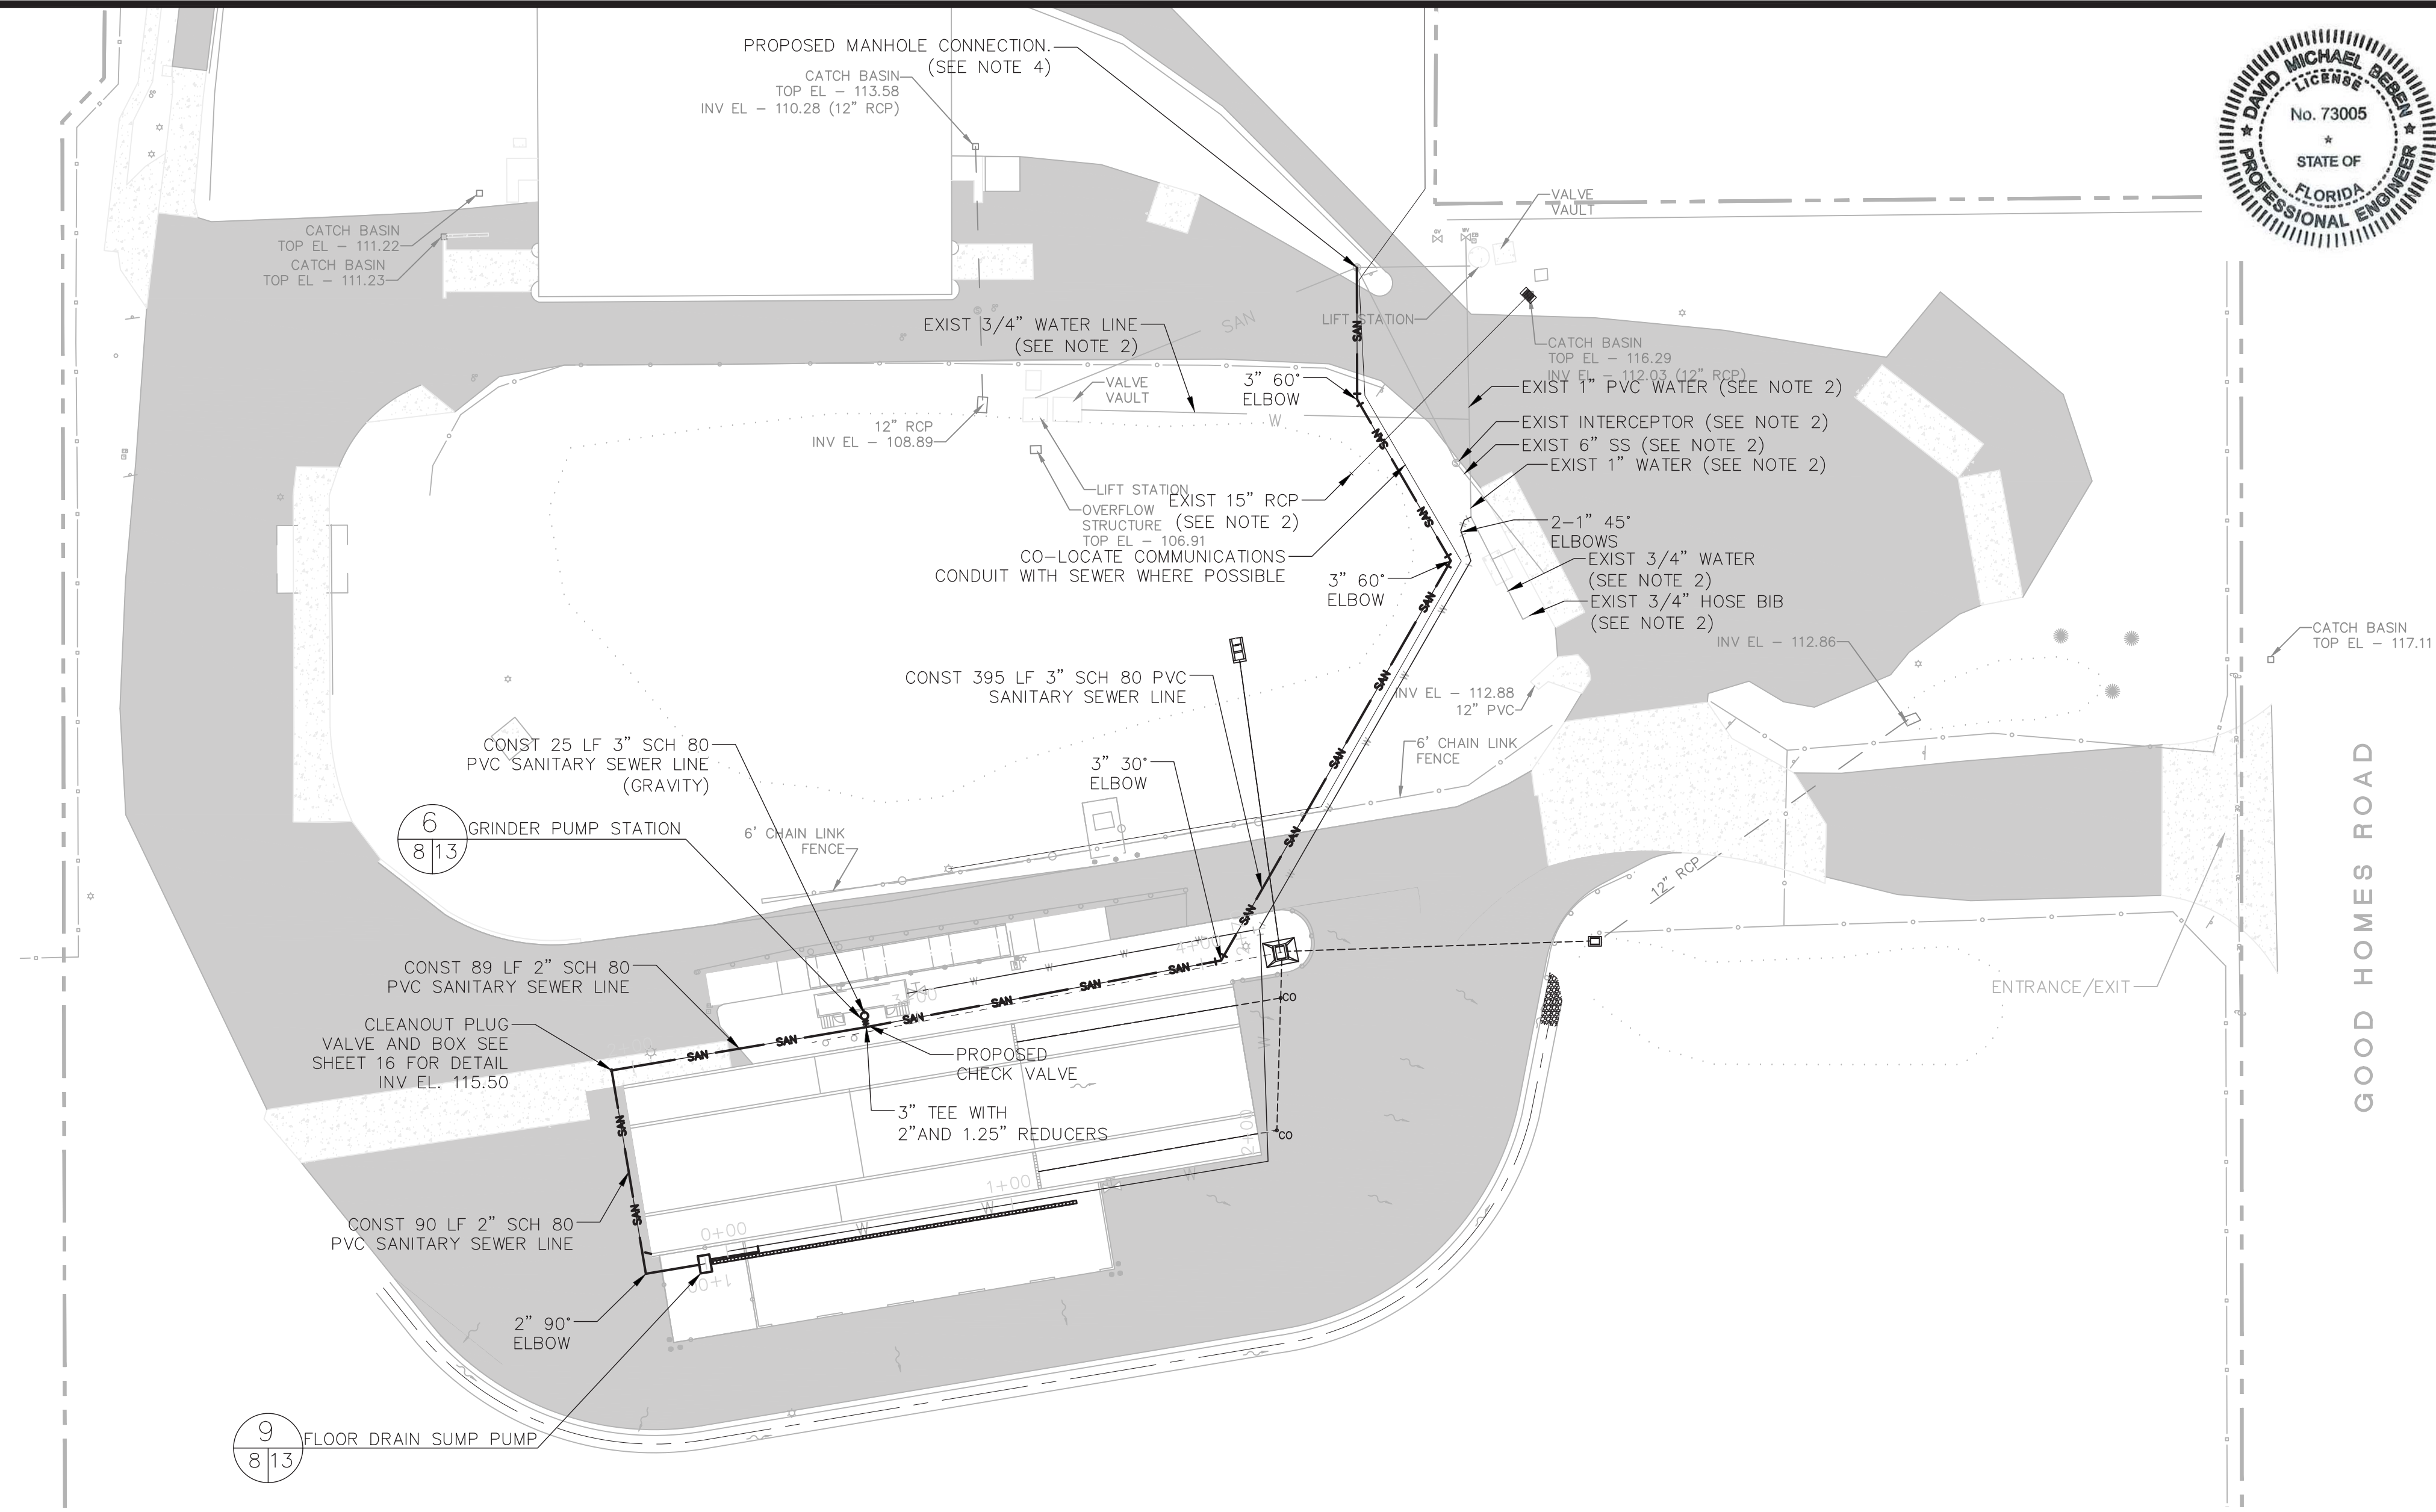

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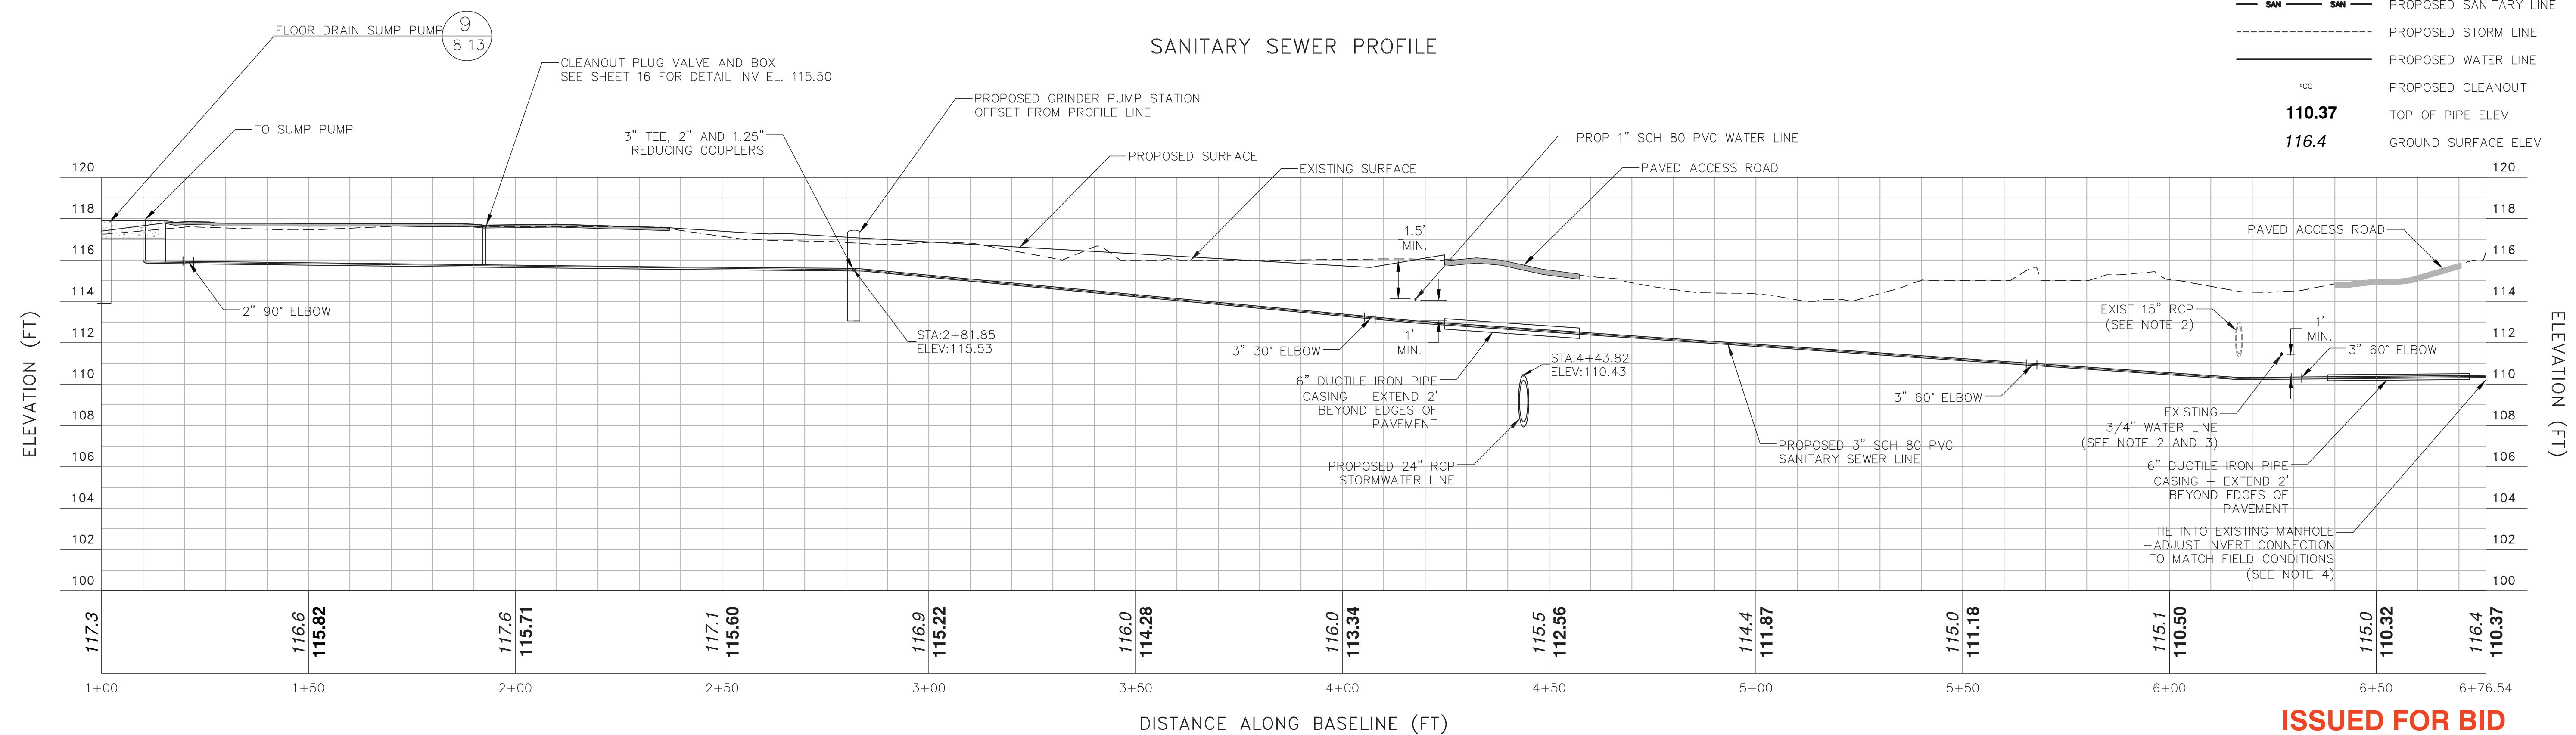


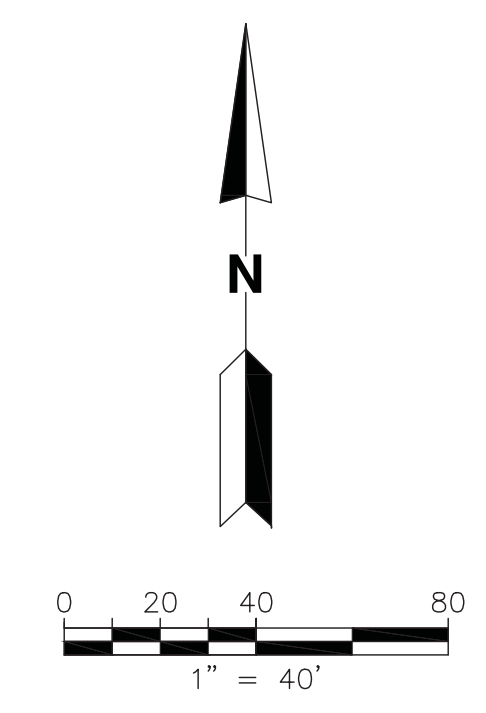- UTILITY NOTES:**
1. THE CONTRACTOR IS RESPONSIBLE FOR LOCATING ALL EXISTING UTILITIES PRIOR TO CONSTRUCTION. UTILITIES SHOWN ARE FOR REFERENCE ONLY AND MAY NOT BE A COMPLETE AND ACCURATE DEPICTION OF ALL UTILITY INFRASTRUCTURE AT THE TIME CONSTRUCTION BEGINS.
 2. DERIVED FROM ORANGE COUNTY PUBLIC UTILITIES RECORD DRAWING - PROJECT NUMBER 90036.03 SHEET 6 OF 6 - PRODUCED BY BLOUNT, SIKES AND ASSOCIATES DATED 6-19-92.
 3. NO SUBSURFACE UTILITIES WERE LOCATED. THE DESIGN ASSUMES 3 FEET OF COVER. CONFIRM ALL UTILITY LOCATIONS.
 4. CONTRACTOR SHALL EMPTY MANHOLE PRIOR TO CONNECTION. REFER TO FOREGAIN TO GRAVITY SEWER CONNECTION DETAIL ON SHEET 15.

LEGEND

- SAN — SAN — PROPOSED SANITARY LINE
- - - - - PROPOSED STORM LINE
- W — W — PROPOSED WATER LINE
- C — C — PROPOSED CLEANOUT
- T — T — TOP OF PIPE ELEV
- G — G — GROUND SURFACE ELEV

SANITARY SEWER PROFILE



ISSUED FOR BID

DATE: 3/20/18

David Beben PE
No. 73005
Florida
Digitally signed by David Beben PE No. 73005
Date: 2018.03.20 14:08:19 -0400

CHK. BY	DESCRIPTION	DATE	REV

SHEET TITLE
SANITARY SEWER PLAN AND PROFILE


PROJECT TITLE
PORTER TRANSFER STATION SITE IMPROVEMENTS

CLIENT
ORANGE COUNTY SOLID WASTE DIVISION ORLANDO, FLORIDA


SCS ENGINEERS
STEARNS, CONRAD AND SCHMIDT
CONSULTING ENGINEERS
5850 SOUTH SEMORAN BLVD, ORLANDO, FLORIDA 32822
PH (407) 204-3231 FAX NO. (813) 923-6757
FLORIDA CERTIFICATE OF AUTHORIZATION NO. 00004892
REG. NO. 09216054.01 DWM BY: KKC C/A BY: SRF
DATE: 03/20/18

CADD FILE: 05401UTILITY
DATE: MARCH 2018
SCALE: AS SHOWN
DRAWING NO. **8**
SHEET **8** of **34**

G:\PROJECT\Orange\09216054.01 - Site Improvements\Const Drawings\05401\UTILITY.dwg Mar 20, 2018 - 10:51am Layout Name: UTILITY PROFILE (2) By: 4382kcc

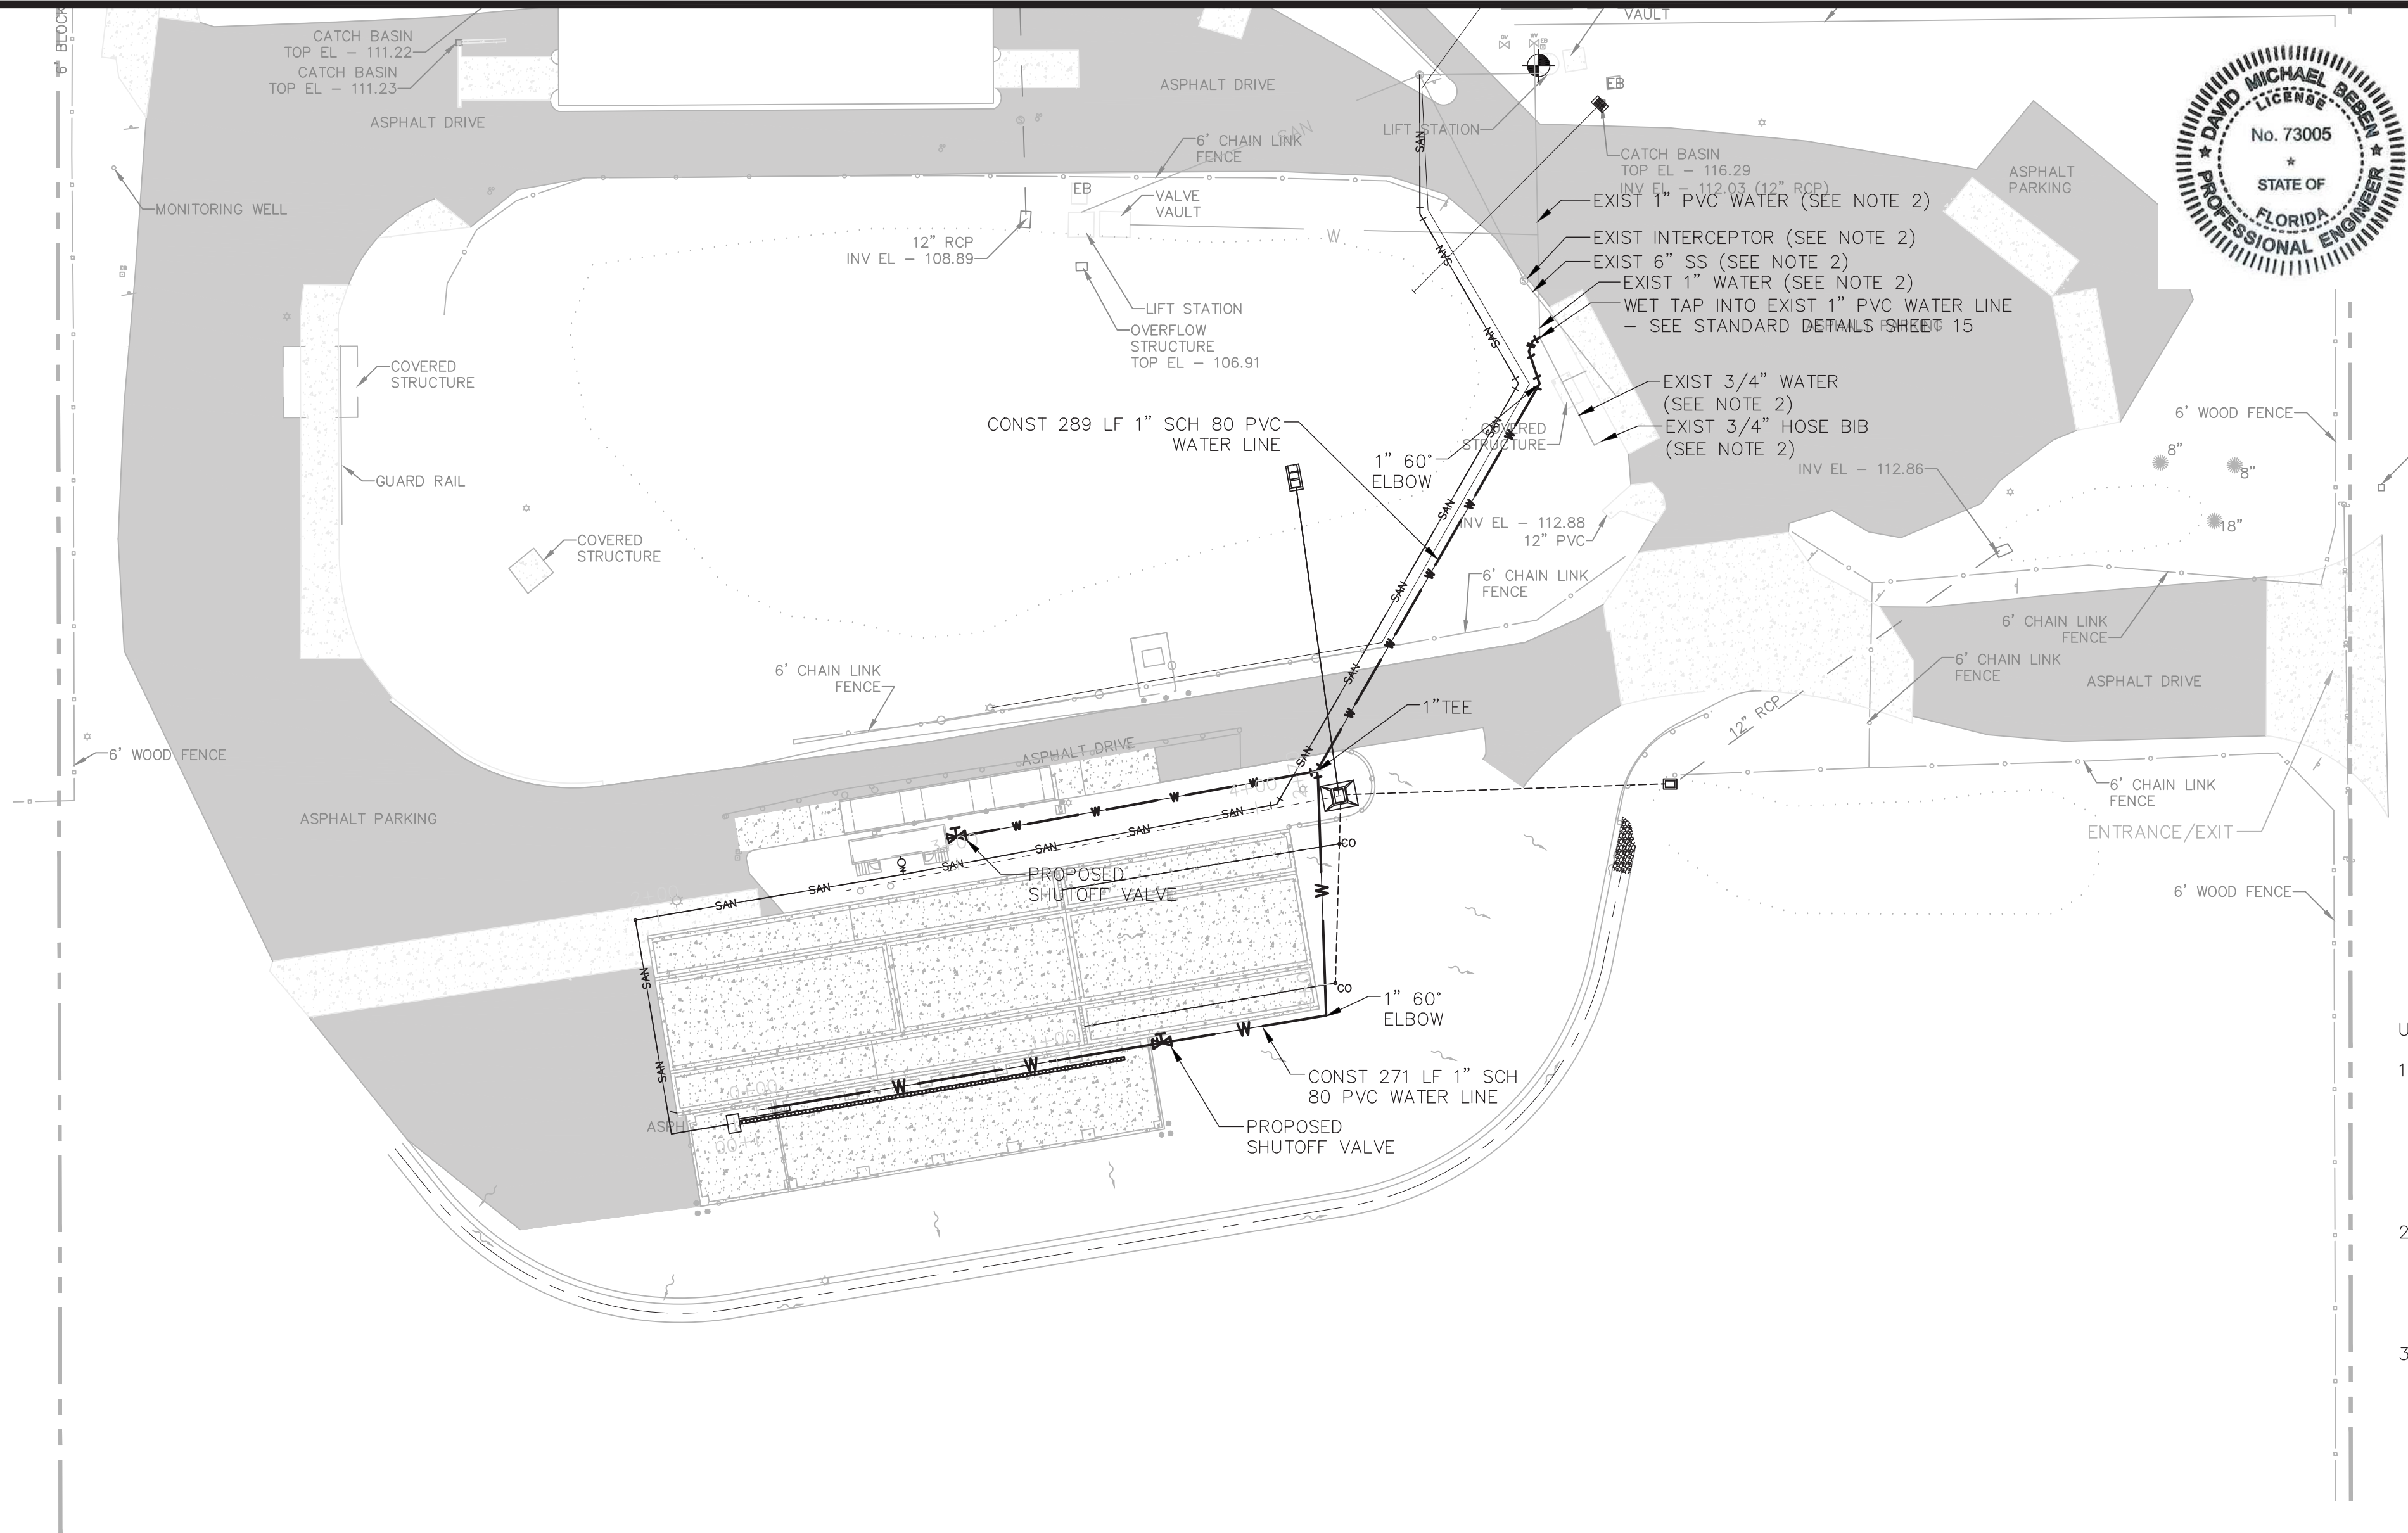

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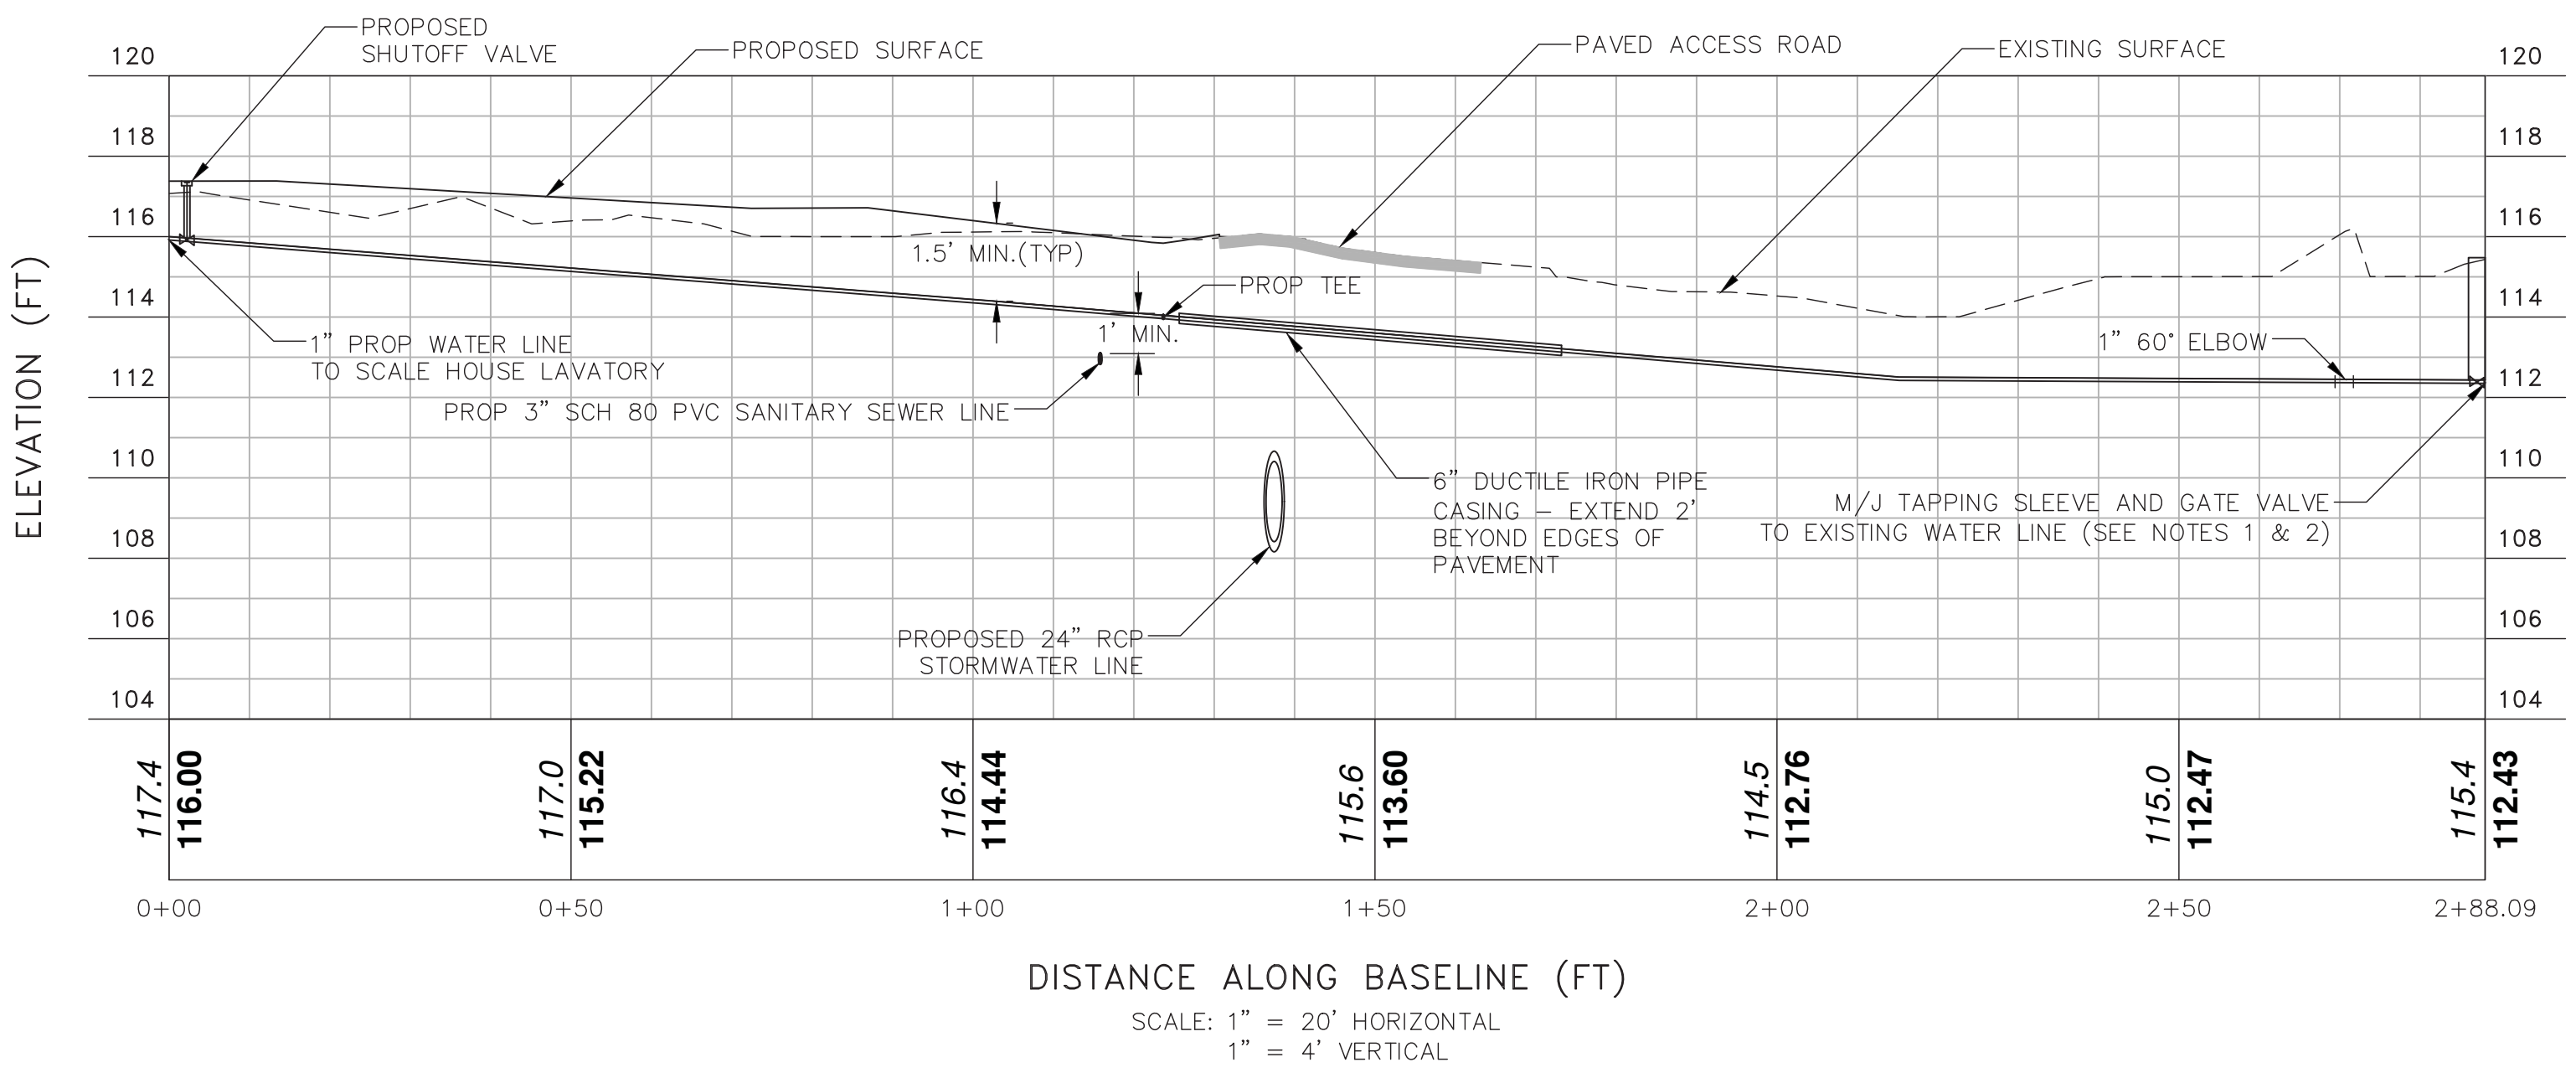


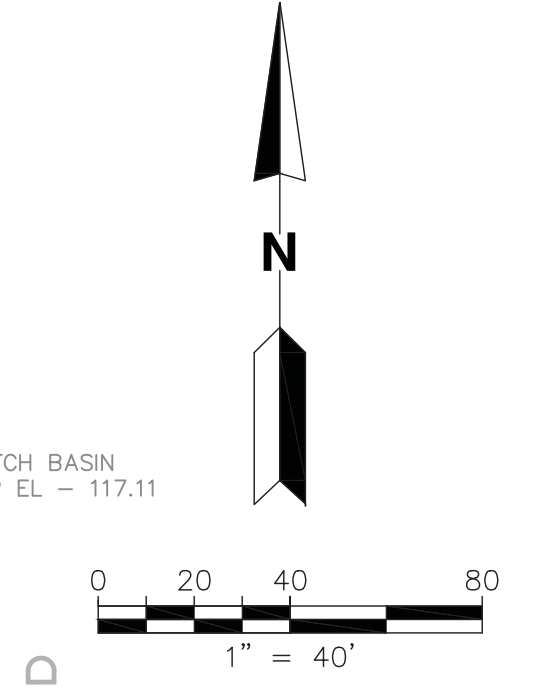- UTILITY NOTES:
1. THE CONTRACTOR IS RESPONSIBLE FOR LOCATING ALL EXISTING UTILITIES PRIOR TO CONSTRUCTION. UTILITIES SHOWN ARE FOR REFERENCE ONLY AND MAY NOT BE A COMPLETE AND ACCURATE DEPICTION OF ALL UTILITY INFRASTRUCTURE AT THE TIME CONSTRUCTION BEGINS.
 2. DERIVED FROM ORANGE COUNTY PUBLIC UTILITIES RECORD DRAWING -PROJECT NUMBER 90036.03 SHEET 6 OF 6 - PRODUCED BY BLOUNT, SIKES AND ASSOCIATES DATED 6-19-92.
 3. NO SUBSURFACE UTILITIES WERE LOCATED. THE DESIGN ASSUMES 3 FEET OF COVER. CONFIRM ALL UTILITY LOCATIONS.


LEGEND

— COM —	PROPOSED COMMUNICATIONS LINE
— SAN —	PROPOSED SANITARY LINE
- - -	PROPOSED STORM LINE
— W —	PROPOSED WATER LINE
— C —	PROPOSED DRAINAGE CLEANOUT
113.93	TOP OF PIPE ELEV
116.5	GROUND SURFACE ELEV

WATER LINE PROFILE



PROP HHW WATER PROFILE

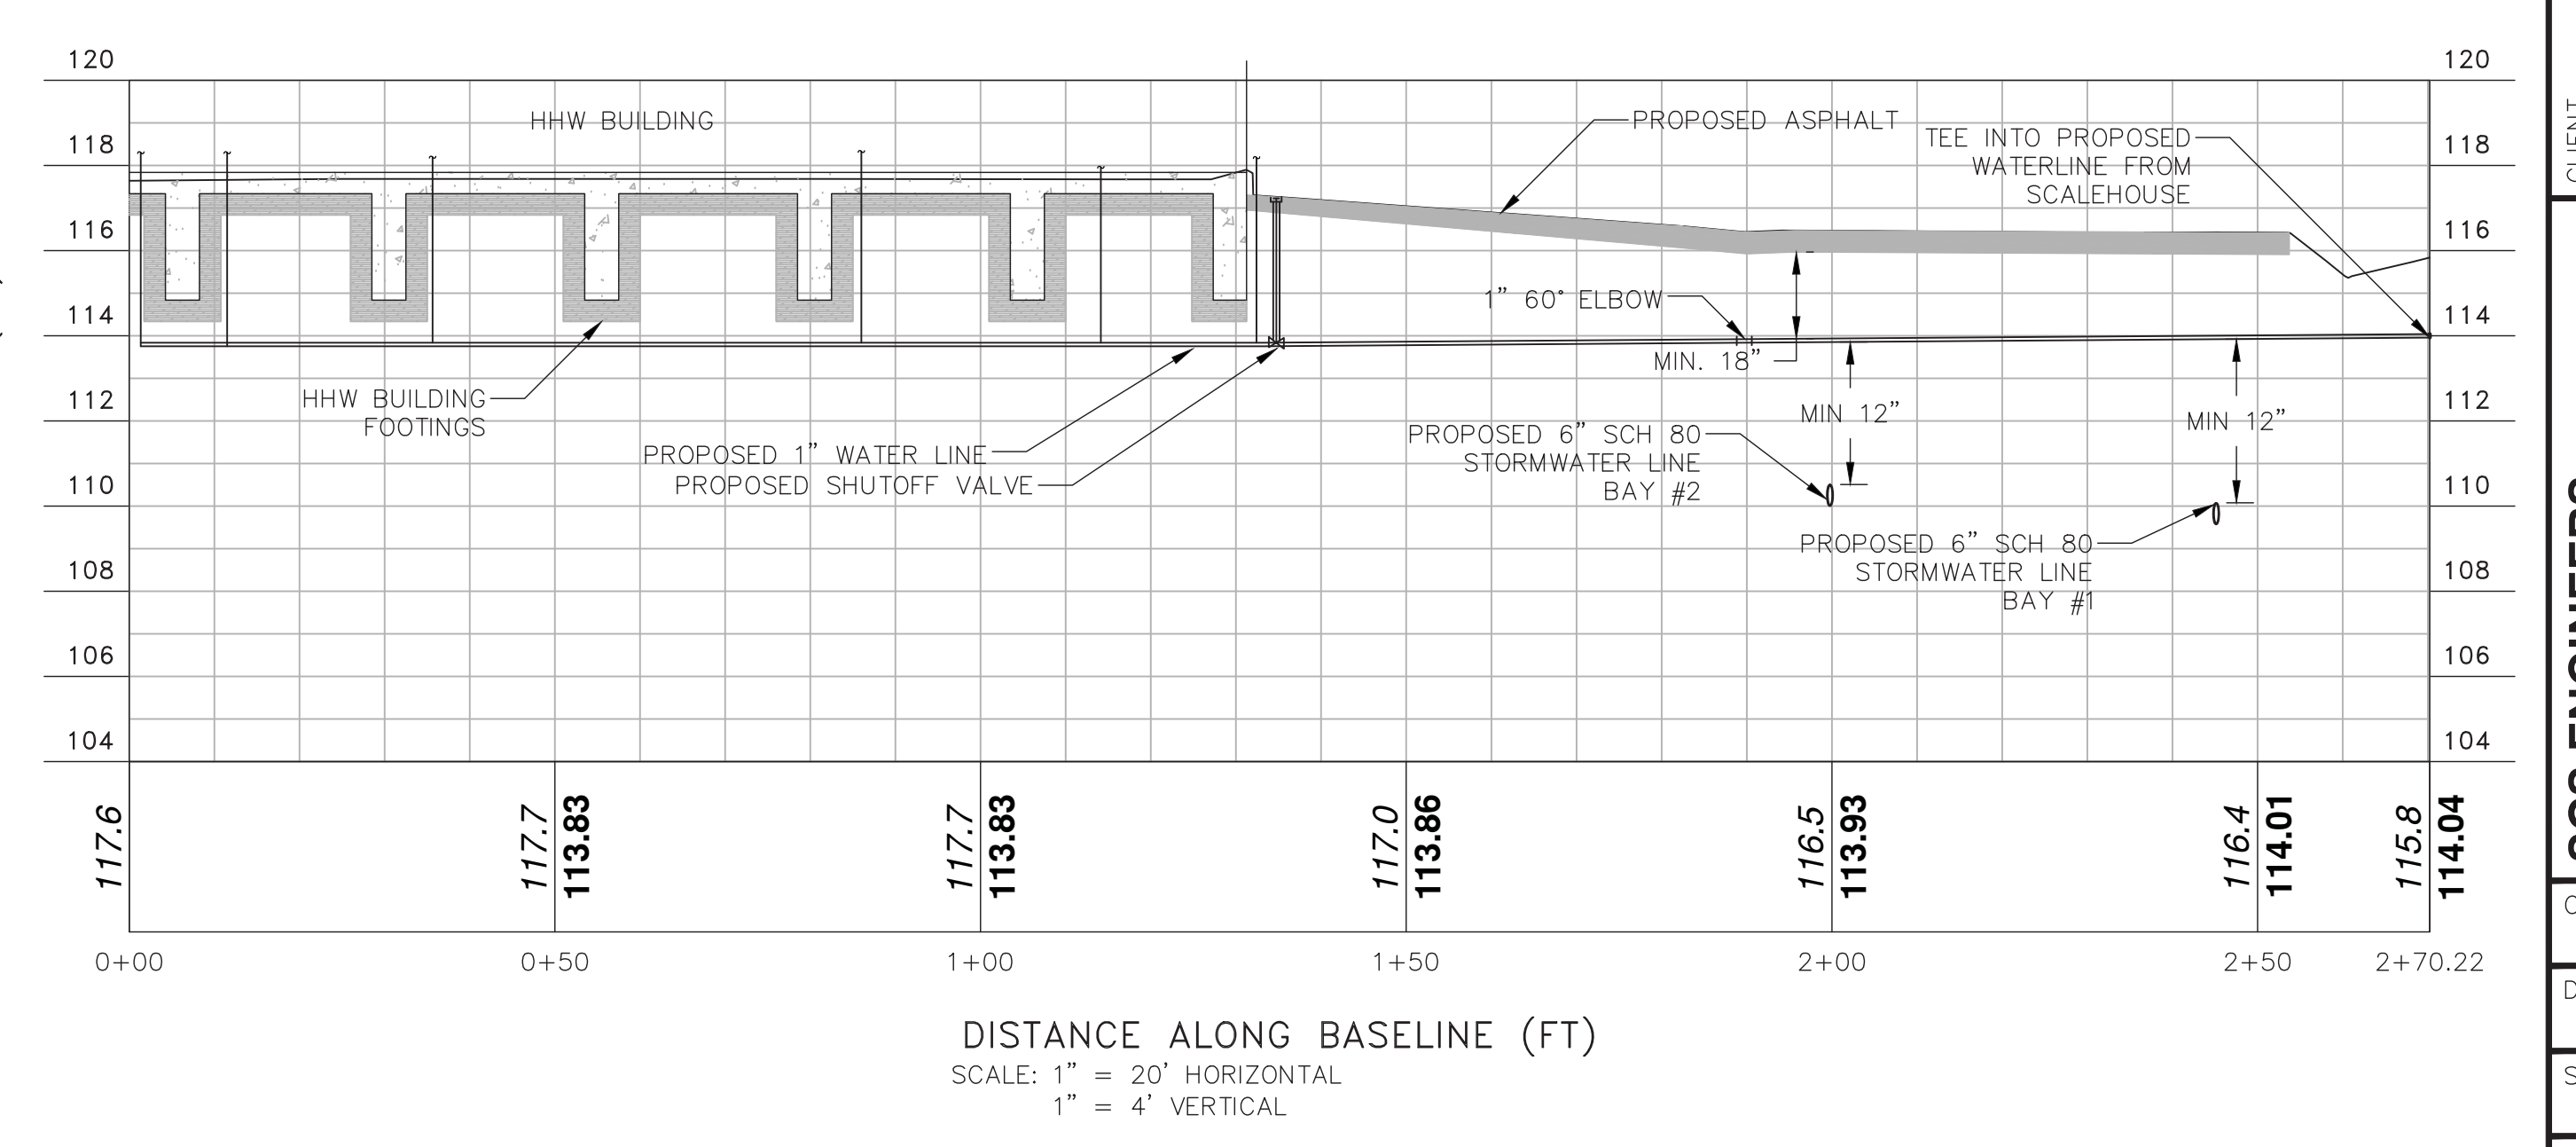

David Beben
PE No. 73005
Florida
Digitally signed by David Beben PE No. 73005
Date: 2018.03.20 14:09:50 -0400

CHK. BY	DESCRIPTION	DATE	REV

SHEET TITLE: **WATER PLAN AND PROFILE**
PROJECT TITLE: **PORTER TRANSFER STATION SITE IMPROVEMENTS**

CLIENT: **ORANGE COUNTY SOLID WASTE DIVISION ORLANDO, FLORIDA**

SCS ENGINEERS
STEARNS, CONRAD AND SCHMIDT
CONSULTING ENGINEERS
5850 SOUTH SEMORAN BLVD, ORLANDO, FLORIDA 32822
PH (407) 204-3231 FAX NO. (813) 623-6757
FLORIDA CERTIFICATE OF AUTHORIZATION NO. 00004892
REG. NO. 09216054.01 DWM: KKC C/A: SRF BY: SRF
DATE: 03/20/18

CADD FILE: 05401UTILITY
DATE: MARCH 2018

SCALE: AS SHOWN
DRAWING NO.


9
SHEET 9 of 34

ISSUED FOR BID
DATE: 3/20/18


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David Beben
 PE No. 73005
 Florida
 Digitally signed by David Beben PE No. 73005
 Date: 2018.03.20 14:11:16 -0400
 DAVID M. BEBEN, PE
 LICENSE NO. 73005



SECTION A
 SCALE: 1"=10'
 VERTICAL EXAGGERATION: 1:3

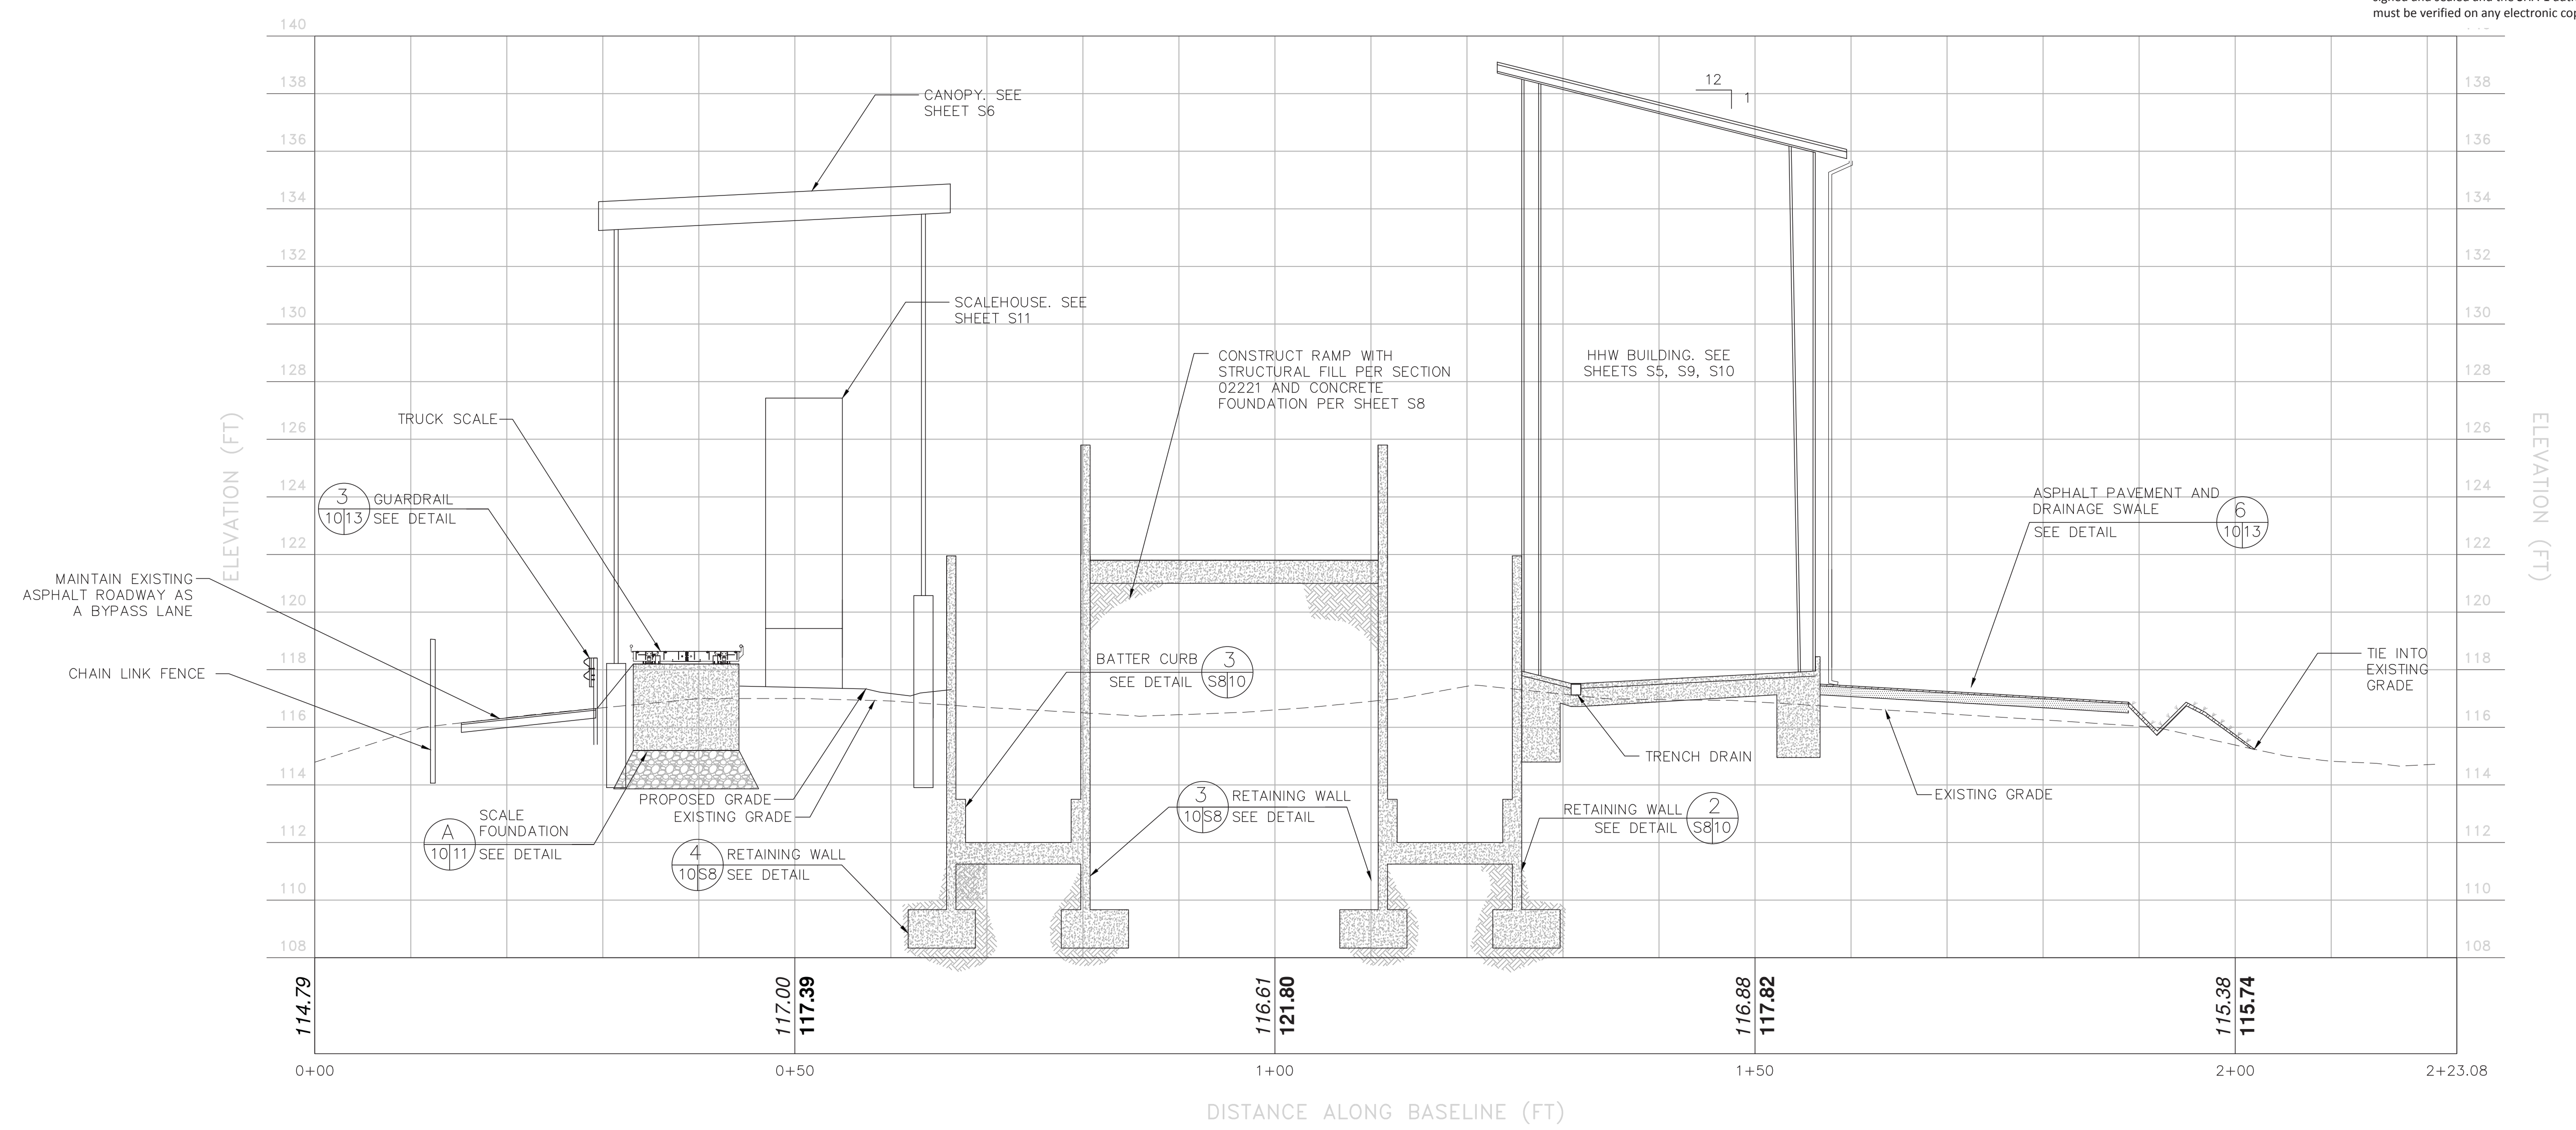

SECTION B
 SCALE: 1"=10'
 VERTICAL EXAGGERATION: 1:3

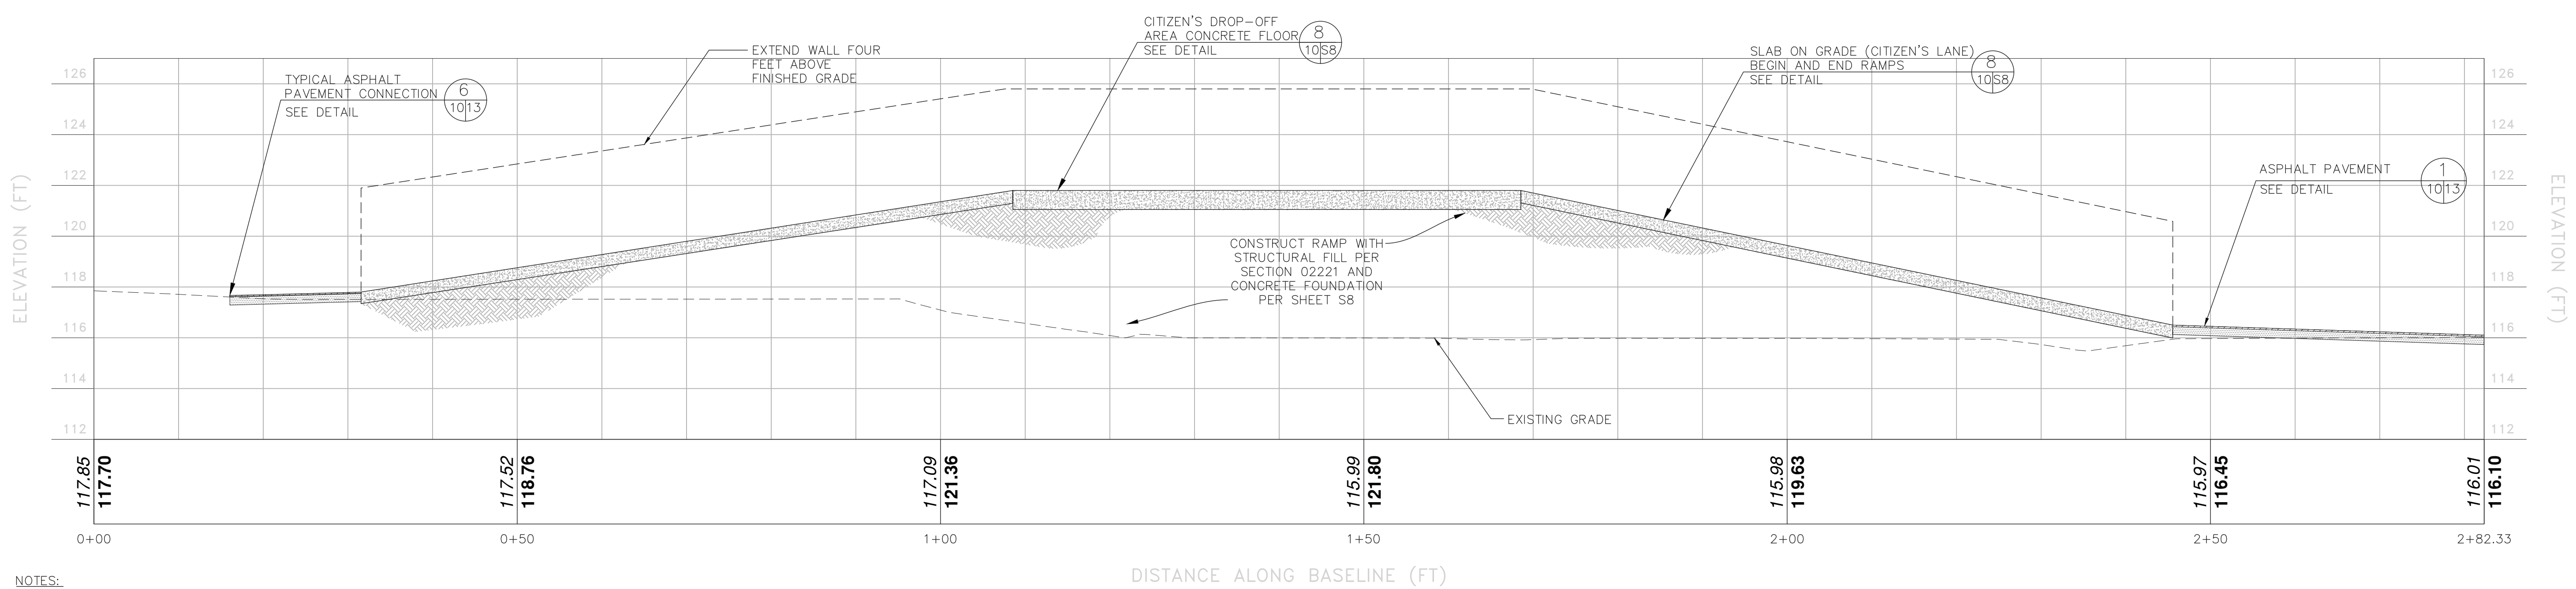- NOTES:**
1. REINFORCEMENT IS NOT SHOWN FOR CLARITY SEE STRUCTURAL DRAWINGS.
 2. RETAINING WALLS ARE NOT SHOWN FOR CLARITY SEE SHEET S8.

SHEET TITLE
NEW HHW AND SCALE SECTIONS
 PROJECT TITLE
PORTER TRANSFER STATION SITE IMPROVEMENTS

CLIENT
ORANGE COUNTY SOLID WASTE DIVISION
ORLANDO, FLORIDA

SCS ENGINEERS
 STEARNS, CONRAD AND SCHMIDT
 CONSULTING ENGINEERS
 5850 SOUTH SEMORAN BLVD, ORLANDO, FLORIDA 32822
 PH (407) 204-3231 FAX NO. (813) 623-6757
 FLORIDA CERTIFICATE OF AUTHORIZATION NO. 00004892
 PROJ. NO. 09216054.01
 DWN. BY: KKC
 CHK. BY: SRF
 APP. BY: SRF

CADD FILE:
 05401SECT
 DATE:
 MARCH 2018
 SCALE:
 AS SHOWN

DRAWING NO.
10
 SHEET 10 of 34


ISSUED FOR BID
 DATE: 3/20/18

G:\PROJECT\Orange\09216054.01\Porter TS\Item 3 - Site Improvements\05401SECT.dwg Mar 20, 2018 - 1:23pm Layout Name: NEW HHW AND SCALE SECTIONS By: 4382kkc


G:\PROJECT\Orange\09216054.01 Porter TS\Item 3 - Site Improvements\Const Drawings\05401SCALE DET1.dwg Mar 20, 2018 - 10:52am Layout Name: SCALE FOUNDATION DETAILS - 1 By: 4382kcc

David Beben
PE No. 73005
Florida
Digitally signed by David Beben PE No. 73005 Florida Date: 2018.03.20 14:13:43 -0400


CHK. BY	
DESCRIPTION	
DATE	
REV	

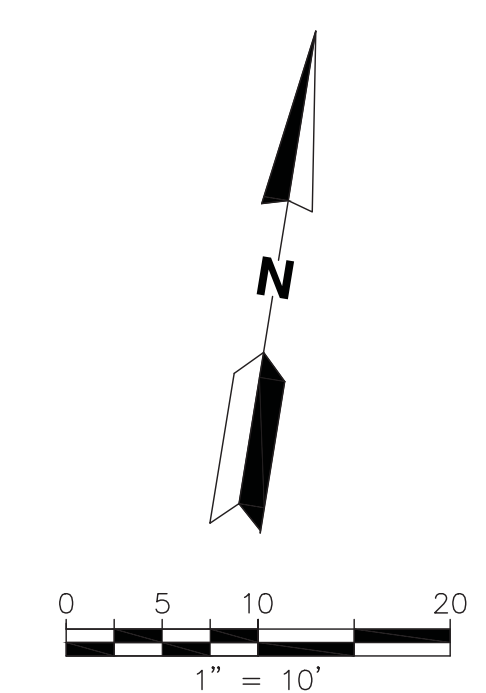


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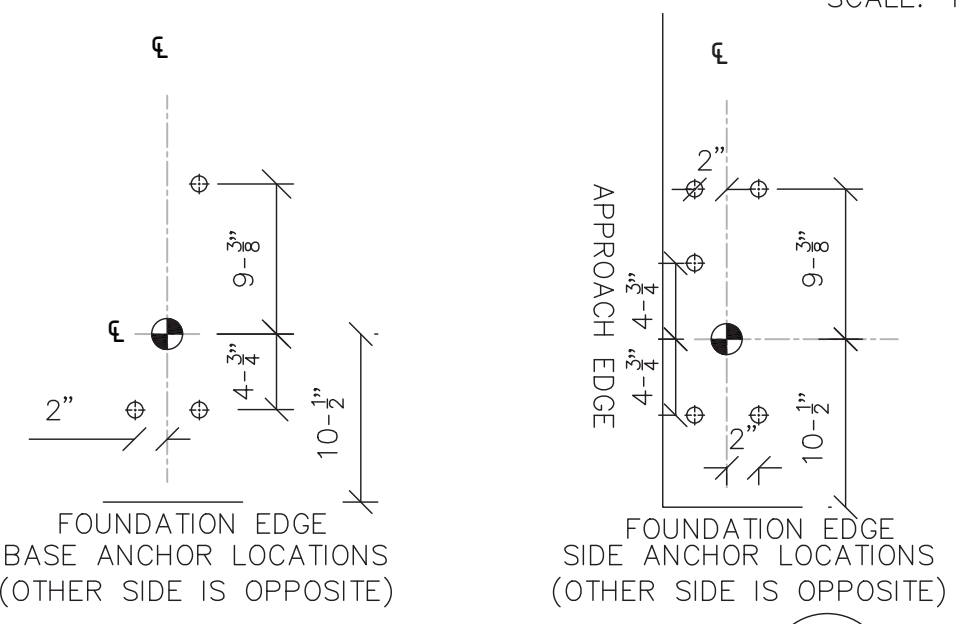
TRUCK SCALE FOUNDATION DETAIL 1
SCALE: 1" = 10'

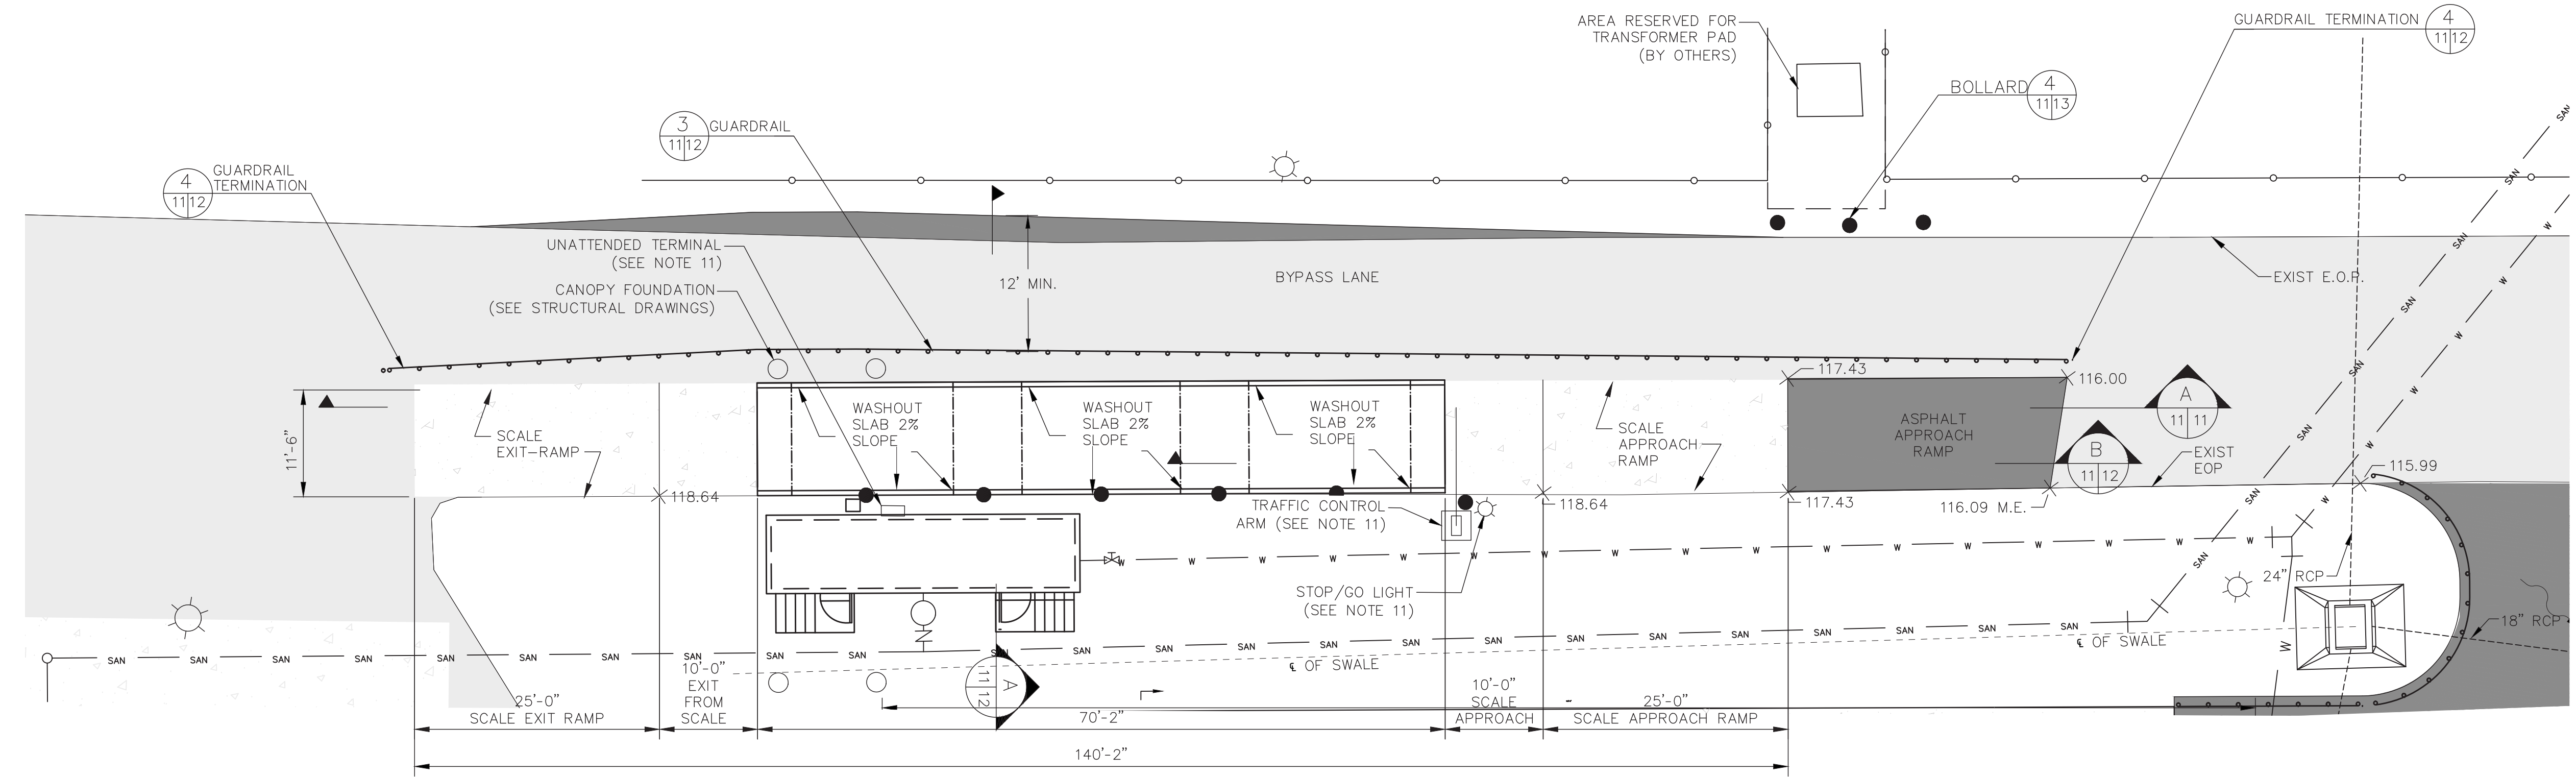


TRUCK SCALE FOUNDATION PLAN VIEW 2
SCALE: 1" = 10'

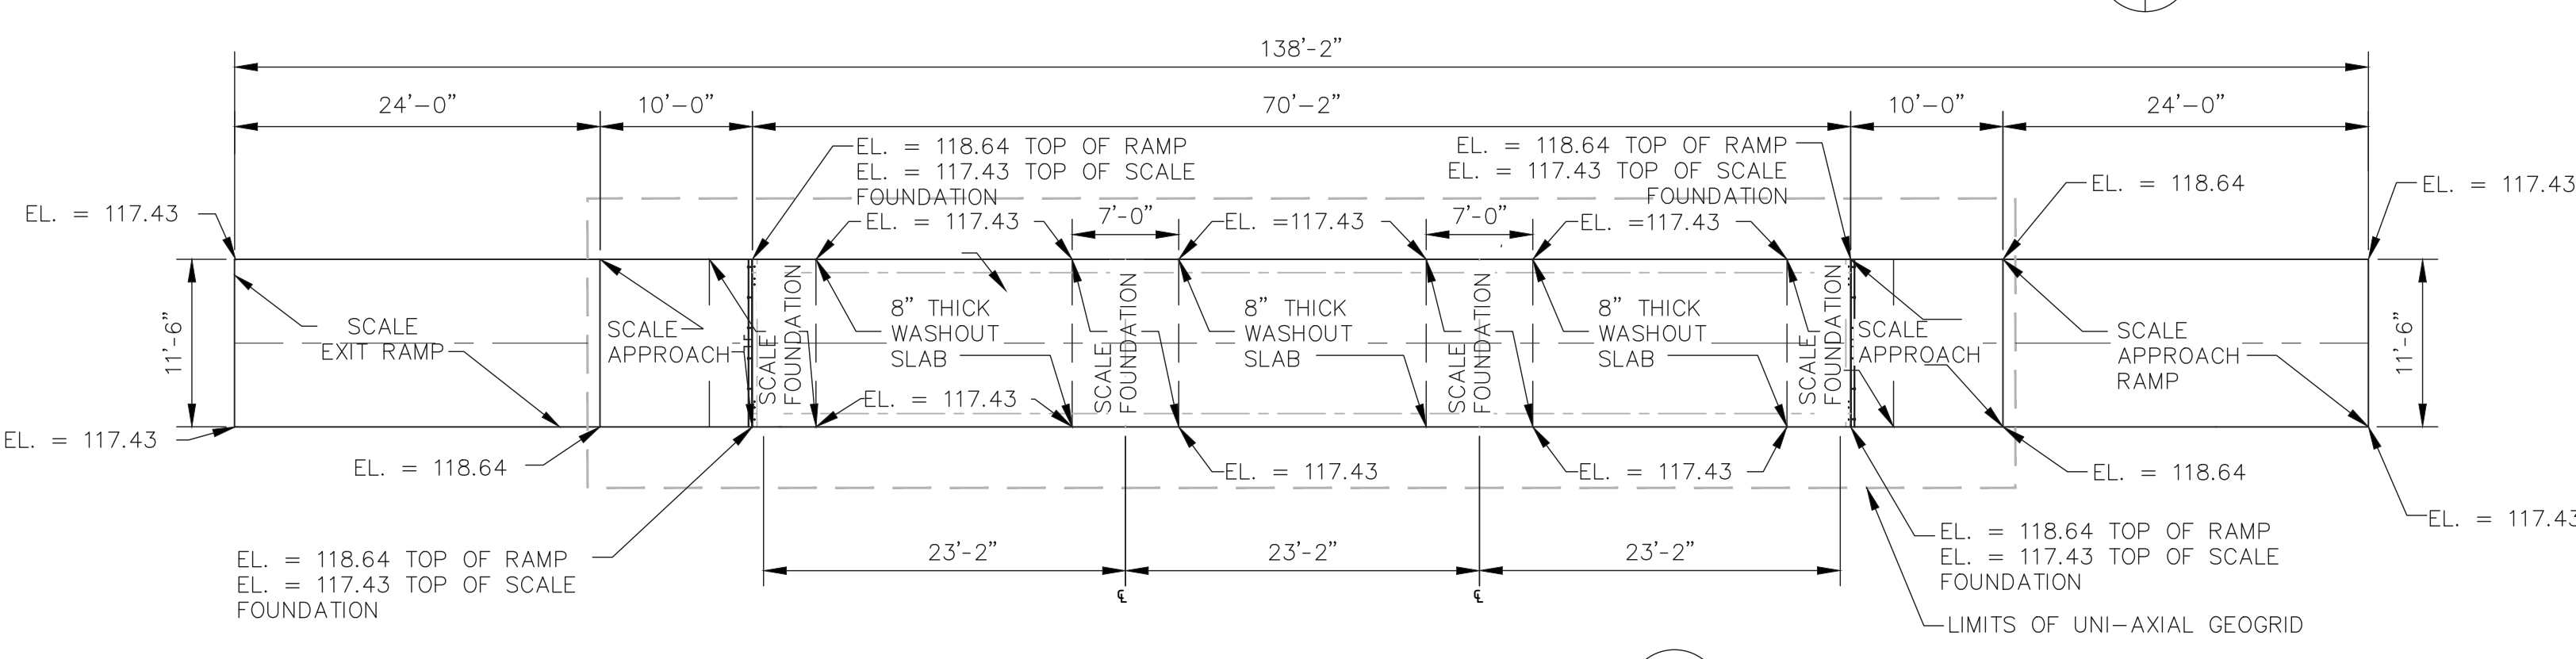


TRUCK SCALE FOUNDATION PLAN VIEW 3
SCALE: 1" = 6'

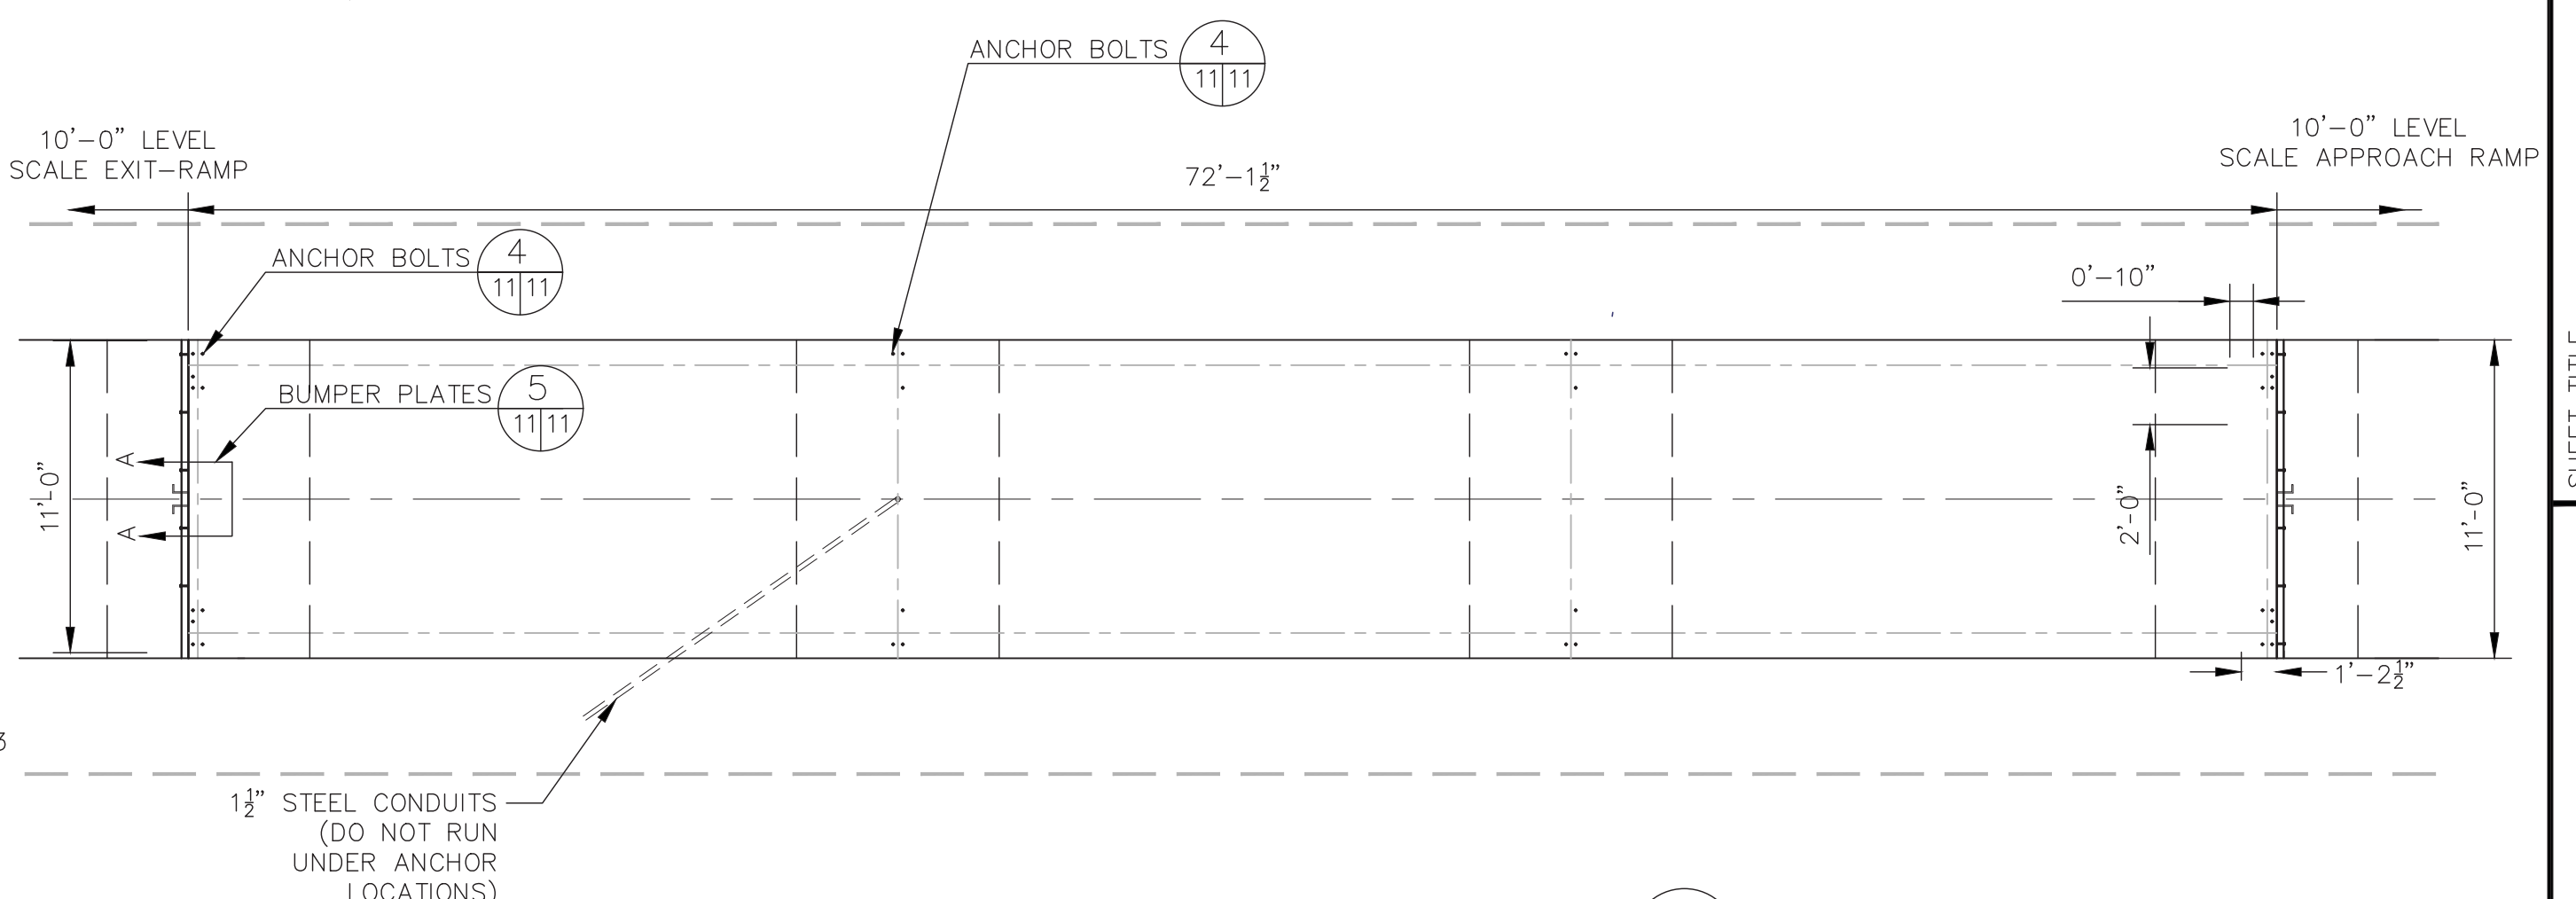

ANCHOR BOLTS 4
NTS

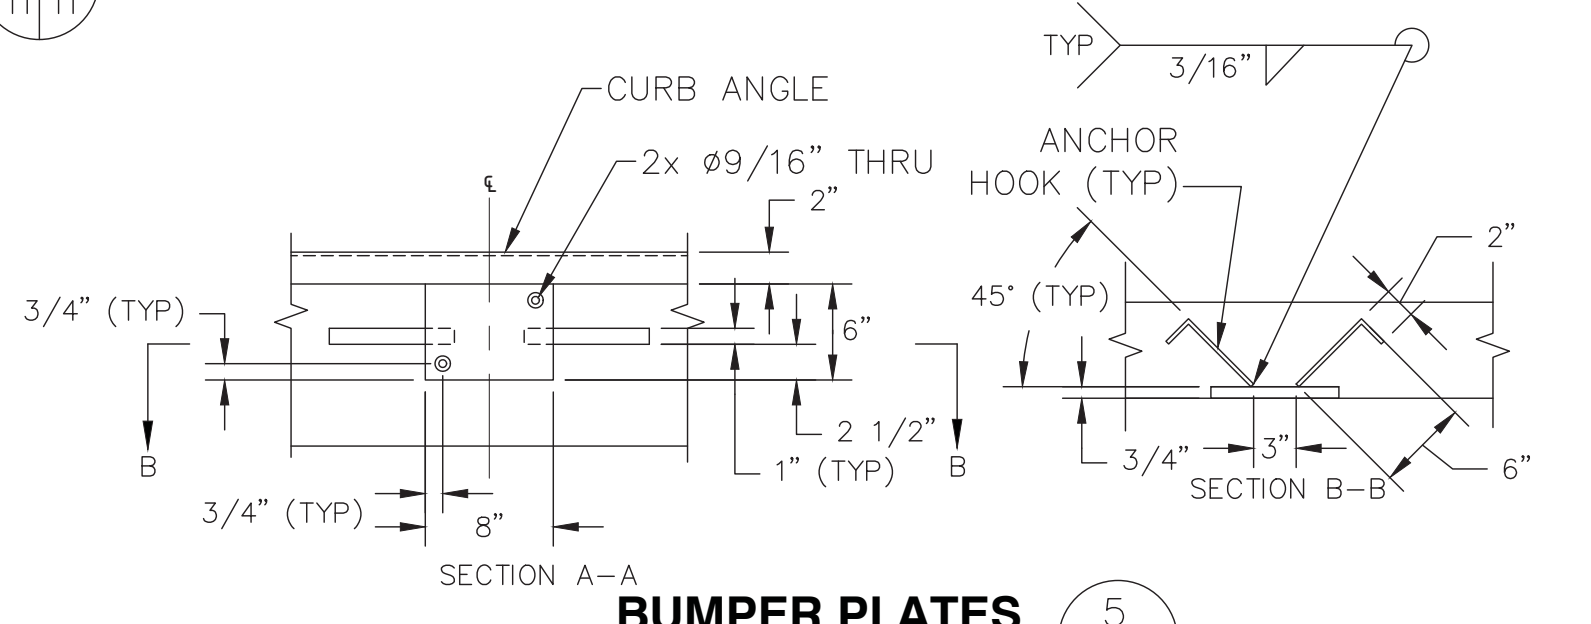

BUMPER PLATES 5
NTS

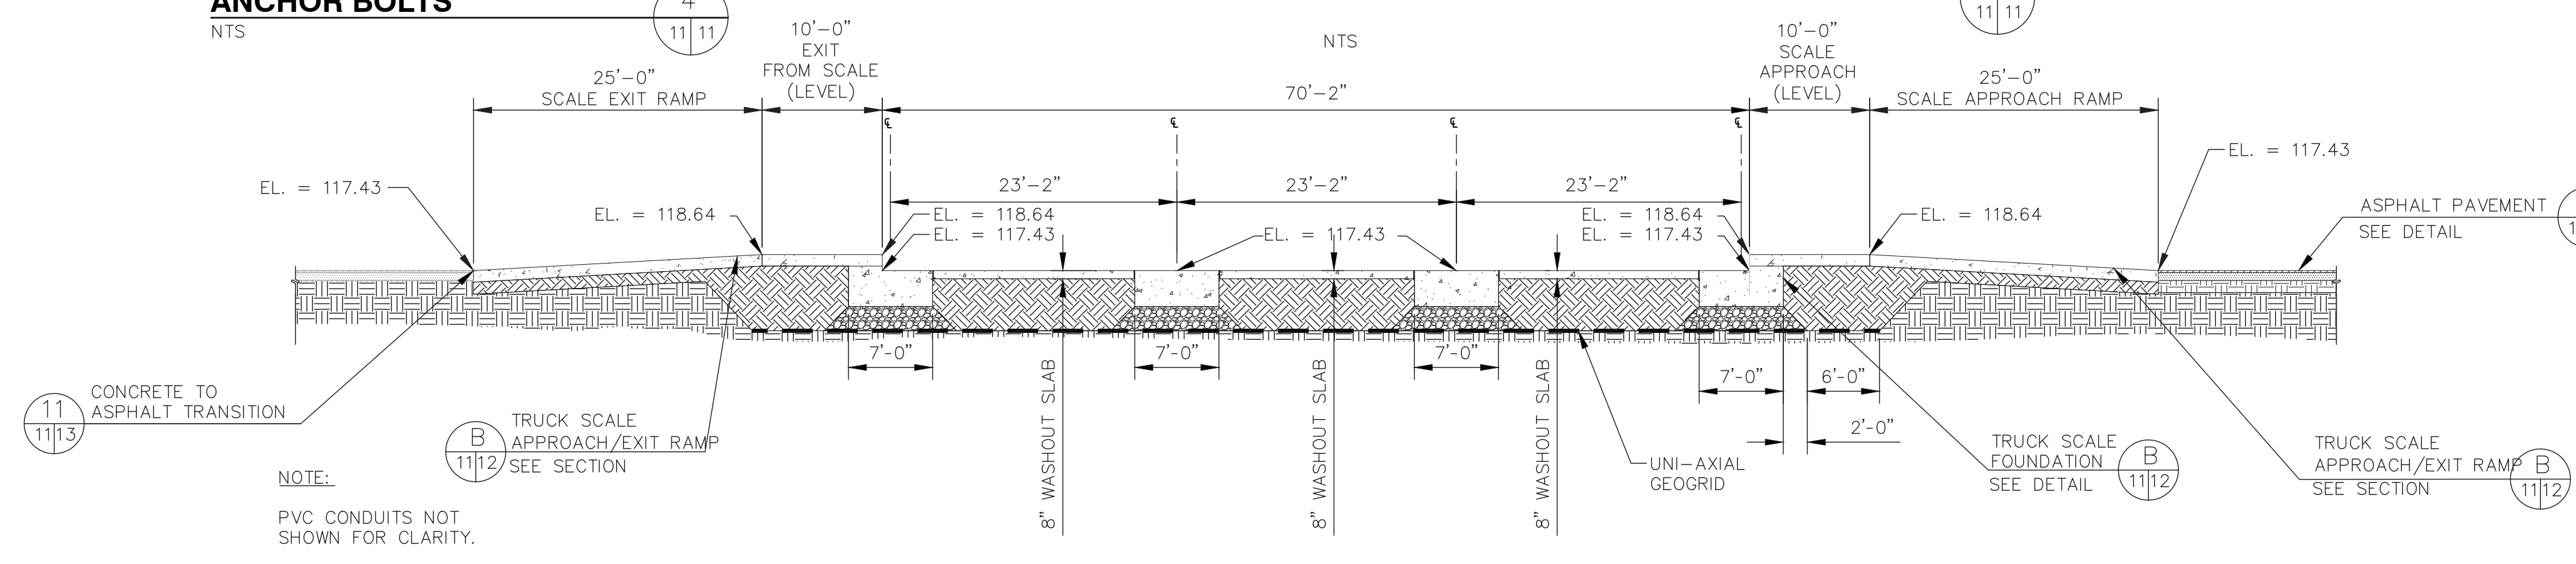

TRUCK SCALE FOUNDATION SECTION A
SCALE: 1" = 10'

- NOTES:**
- ALL CONSTRUCTION MUST BE IN STRICT ACCORDANCE WITH THE CURRENT EDITION OF THE FLORIDA BUILDING CODE, AND THE SUPPLEMENT AS WELL AS WITH ALL OTHER APPLICABLE CODES, AMENDMENTS, ETC. SEE STRUCTURAL SHEETS FOR MATERIAL, TESTING, AND QUALITY CONTROL REQUIREMENTS.
 - REFERENCED CODE VERSIONS SHALL BE THOSE REFERENCED IN THE CURRENT EDITION OF THE FLORIDA BUILDING CODE AND APPLICABLE SUPPLEMENTS.
 - CONCRETE FOR SCALE RAMPS, SCALE FOUNDATION AND SCALE WASHOUT SLABS SHALL HAVE A MINIMUM COMPRESSIVE STRENGTH OF 4,000 PSI AT 28 DAYS. ALL CONCRETE SHALL BE PRODUCED, PLACED, AND CURED IN ACCORDANCE WITH ACI 301 AND ACI 318. CONCRETE CONSTRUCTION TOLERANCES SHALL BE IN ACCORDANCE WITH ACI 117.
 - ALL STEEL REINFORCING FOR CONCRETE SHALL BE FREE OF EXCESSIVE RUST, ALL DIRT, SCALE, OIL, ETC. AND SHALL BE AT MINIMUM, ASTM A615 GR. 60 & 40 DEFORMED REINFORCING STEEL. REBAR MINIMUM DEPTH OF COVER SHOULD BE IN ACCORDANCE WITH LATEST ACI BUILDING CODE REQUIREMENTS FOR STRUCTURAL CONCRETE (ACI 318-SECTION 77) UNLESS OTHERWISE SPECIFIED.
 - ALL REINFORCING STEEL SHALL BE WELL SECURED IN PLACE PRIOR TO PLACING OF CONCRETE.
 - DIMENSIONS FROM FACE OF CONCRETE TO STEEL (CLR.) ARE TO FACE OF REINFORCING BARS.
 - PROVIDE THE MINIMUM PROTECTIVE COVERING OF CONCRETE UNLESS OTHERWISE NOTED. BELOW GRADE OR EXPOSED TO WEATHER:
UNFORMED, CAST IN PLACE 3" CLEAR, OR
FORMED, CAST IN PLACE 2" CLEAR.
 - PROJECTING CORNERS SHALL BE FORMED WITH A 3/4" CHAMFER UNLESS OTHERWISE NOTED.
 - SCALE FOUNDATION, RAMPS AND WASHOUT SLABS DESIGNED PER REQUIREMENTS OF SCALE MANUFACTURER.
 - BASEPLATE ANCHORS TO BE SUPPLIED BY SCALE MANUFACTURER. USE BASEPLATES AS TEMPLATES TO LOCATE EXPANSION BOLTS DURING SCALE INSTALLATION.
 - REFER TO SPECIFICATION SECTION 10880 FOR UNATTENDED SCALE, TERMINAL, TRAFFIC ARM, AND STOP/GO LIGHT INFORMATION. NOTE: FIBER OPTIC LINE NOT SHOWN FOR CLARITY.

SCALE FOUNDATION DETAILS - 1

**PORTER TRANSFER STATION
SITE IMPROVEMENTS**

**ORANGE COUNTY
SOLID WASTE DIVISION
ORLANDO, FLORIDA**

CLIENT

SCS ENGINEERS
STEARNS, CONRAD AND SCHMIDT
CONSULTING ENGINEERS
5850 SOUTH SEMORAN BLVD, ORLANDO, FLORIDA 32822
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FLORIDA CERTIFICATE OF AUTHORIZATION NO. 00004892












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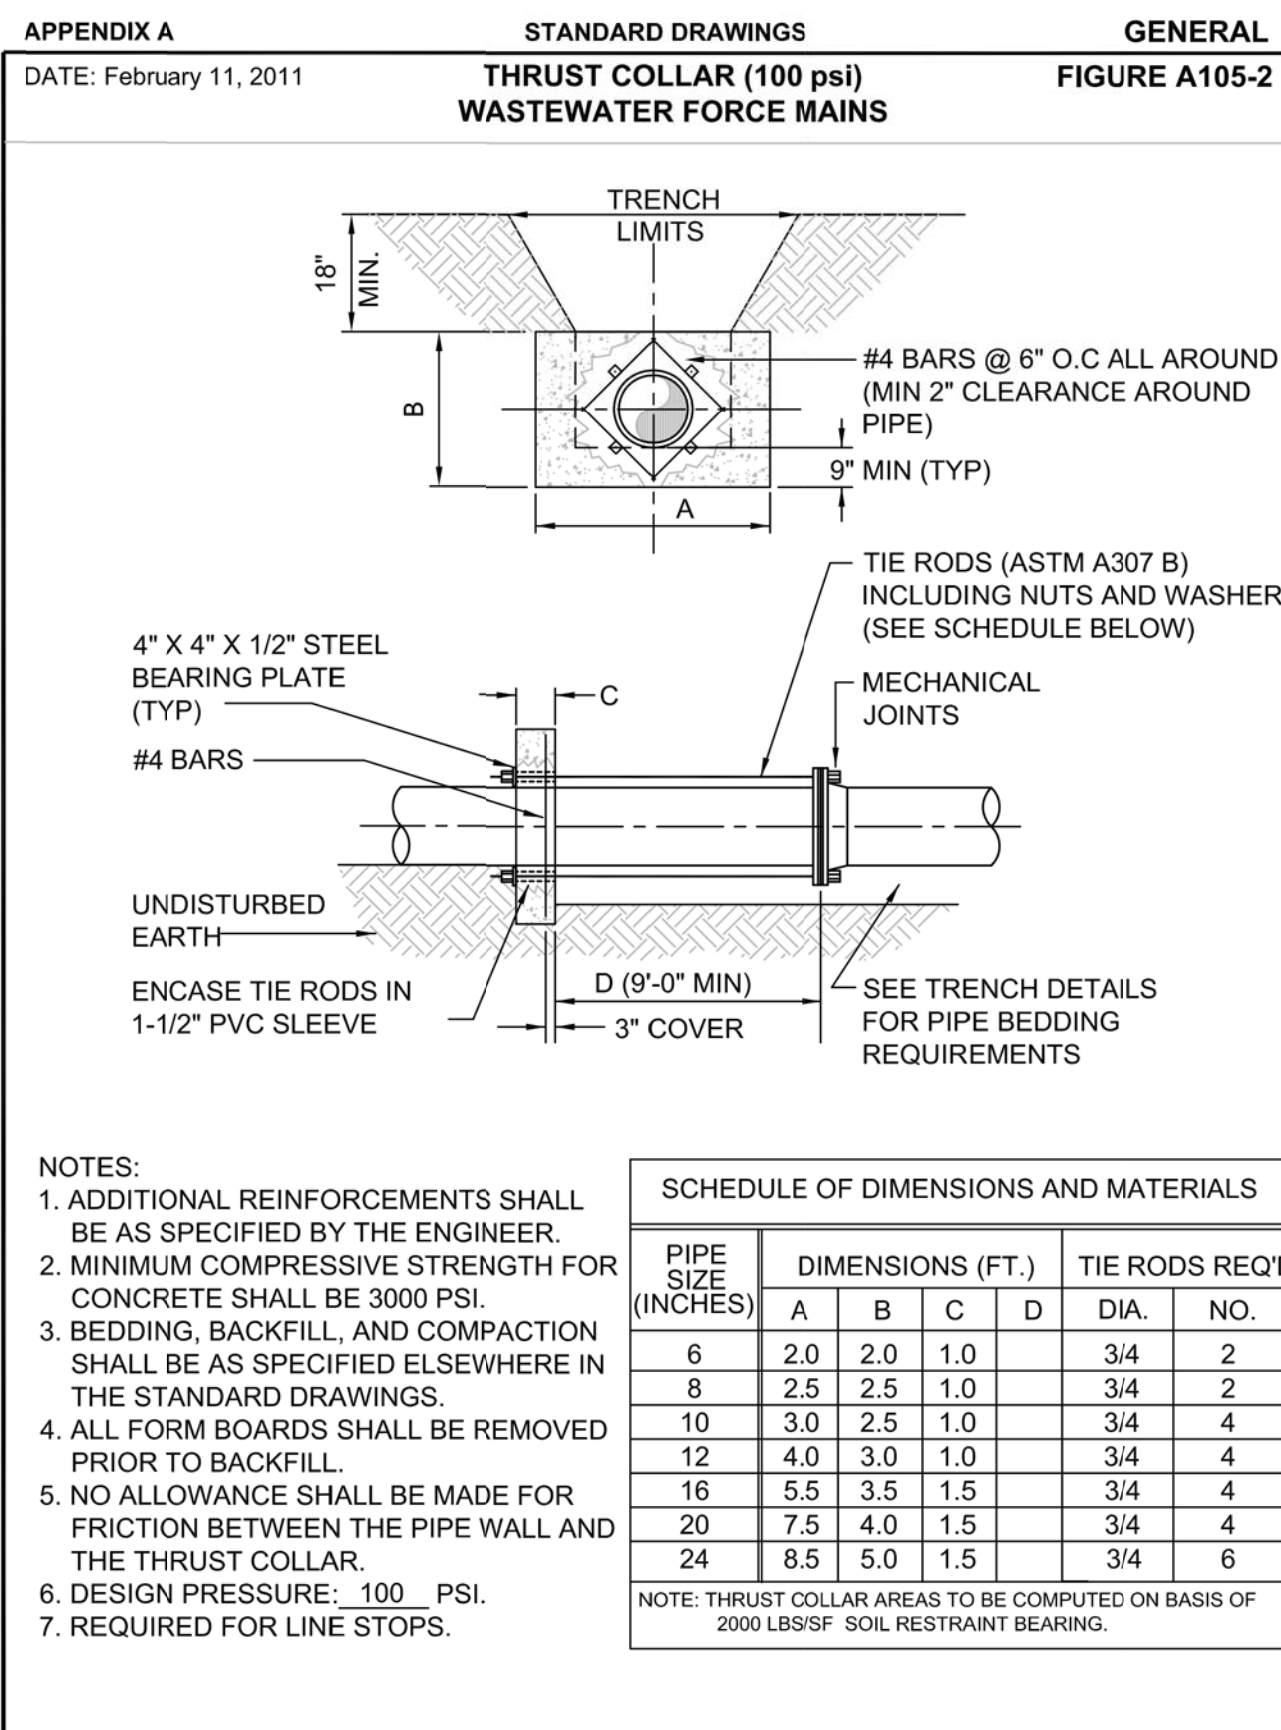
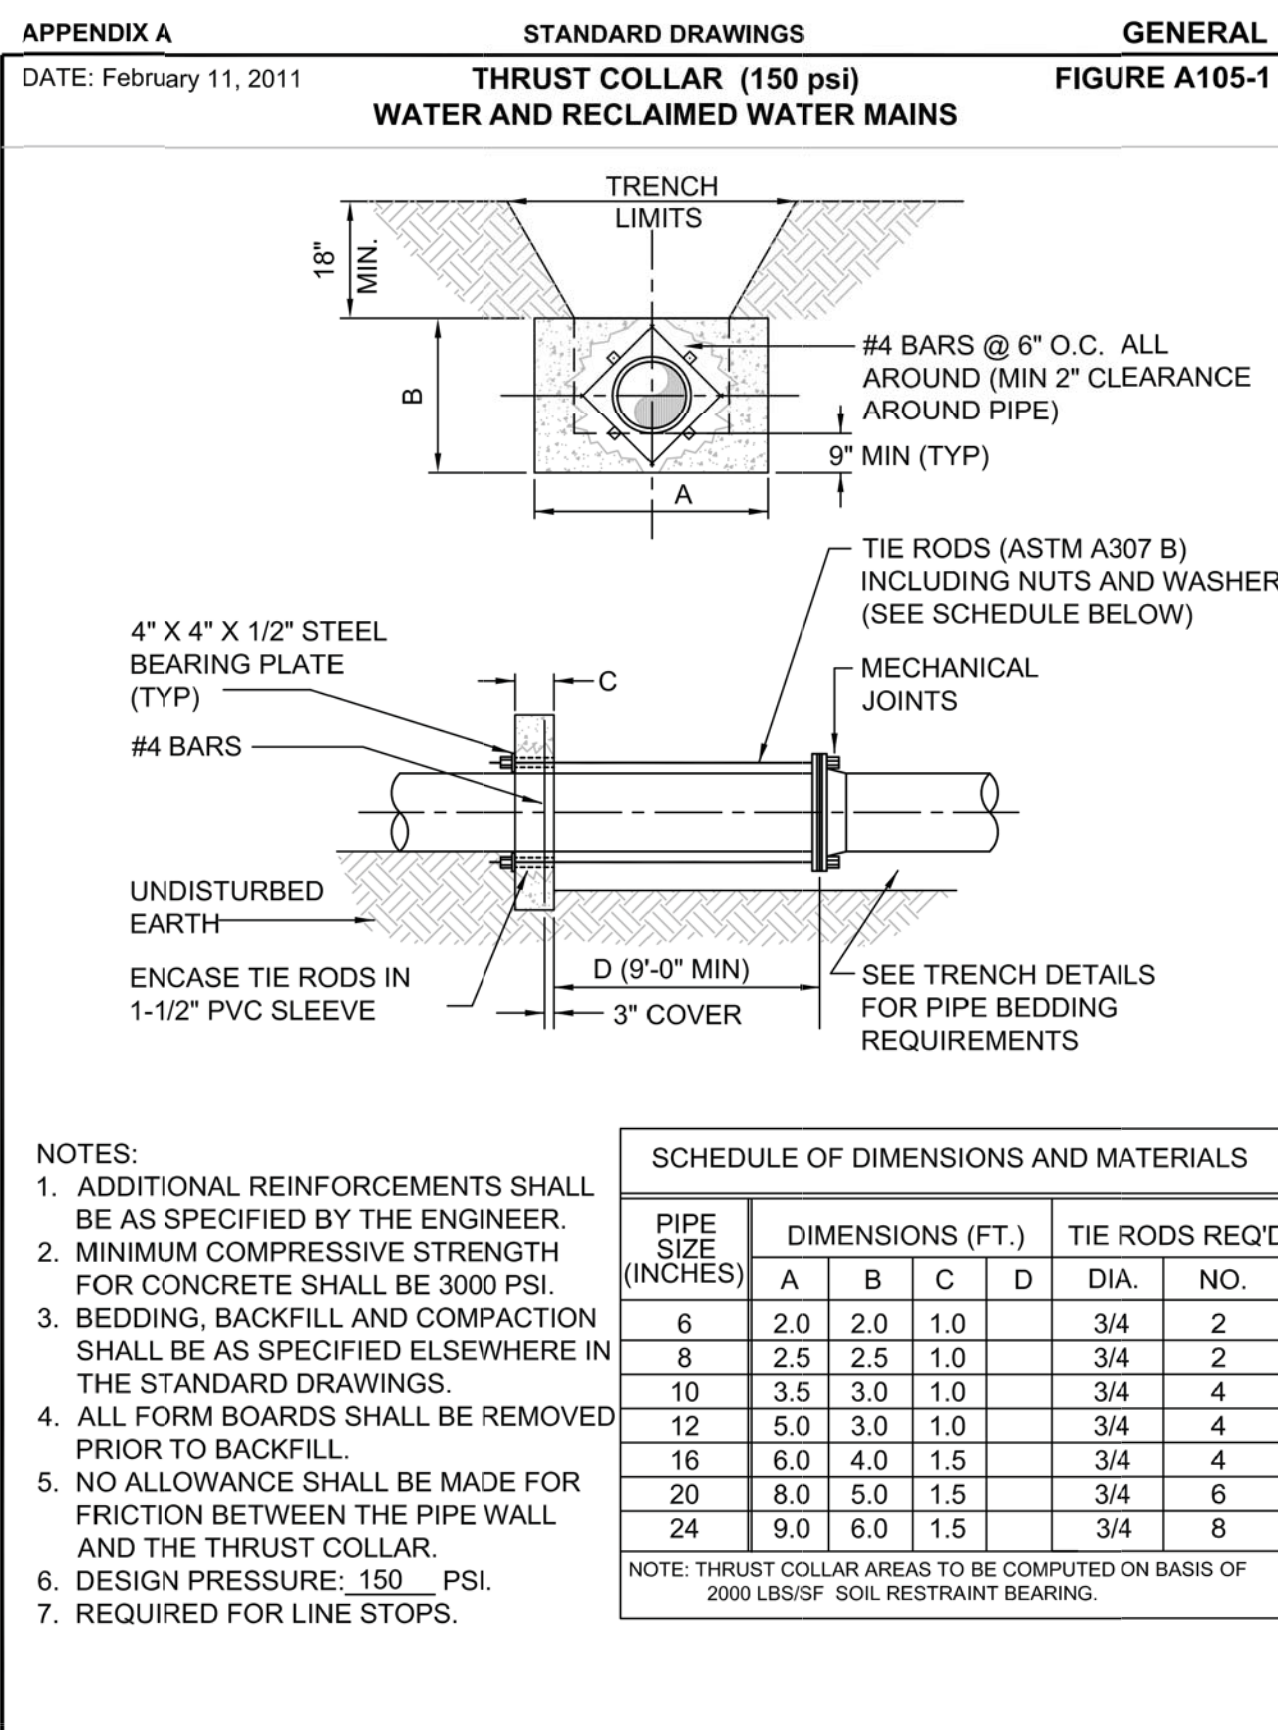
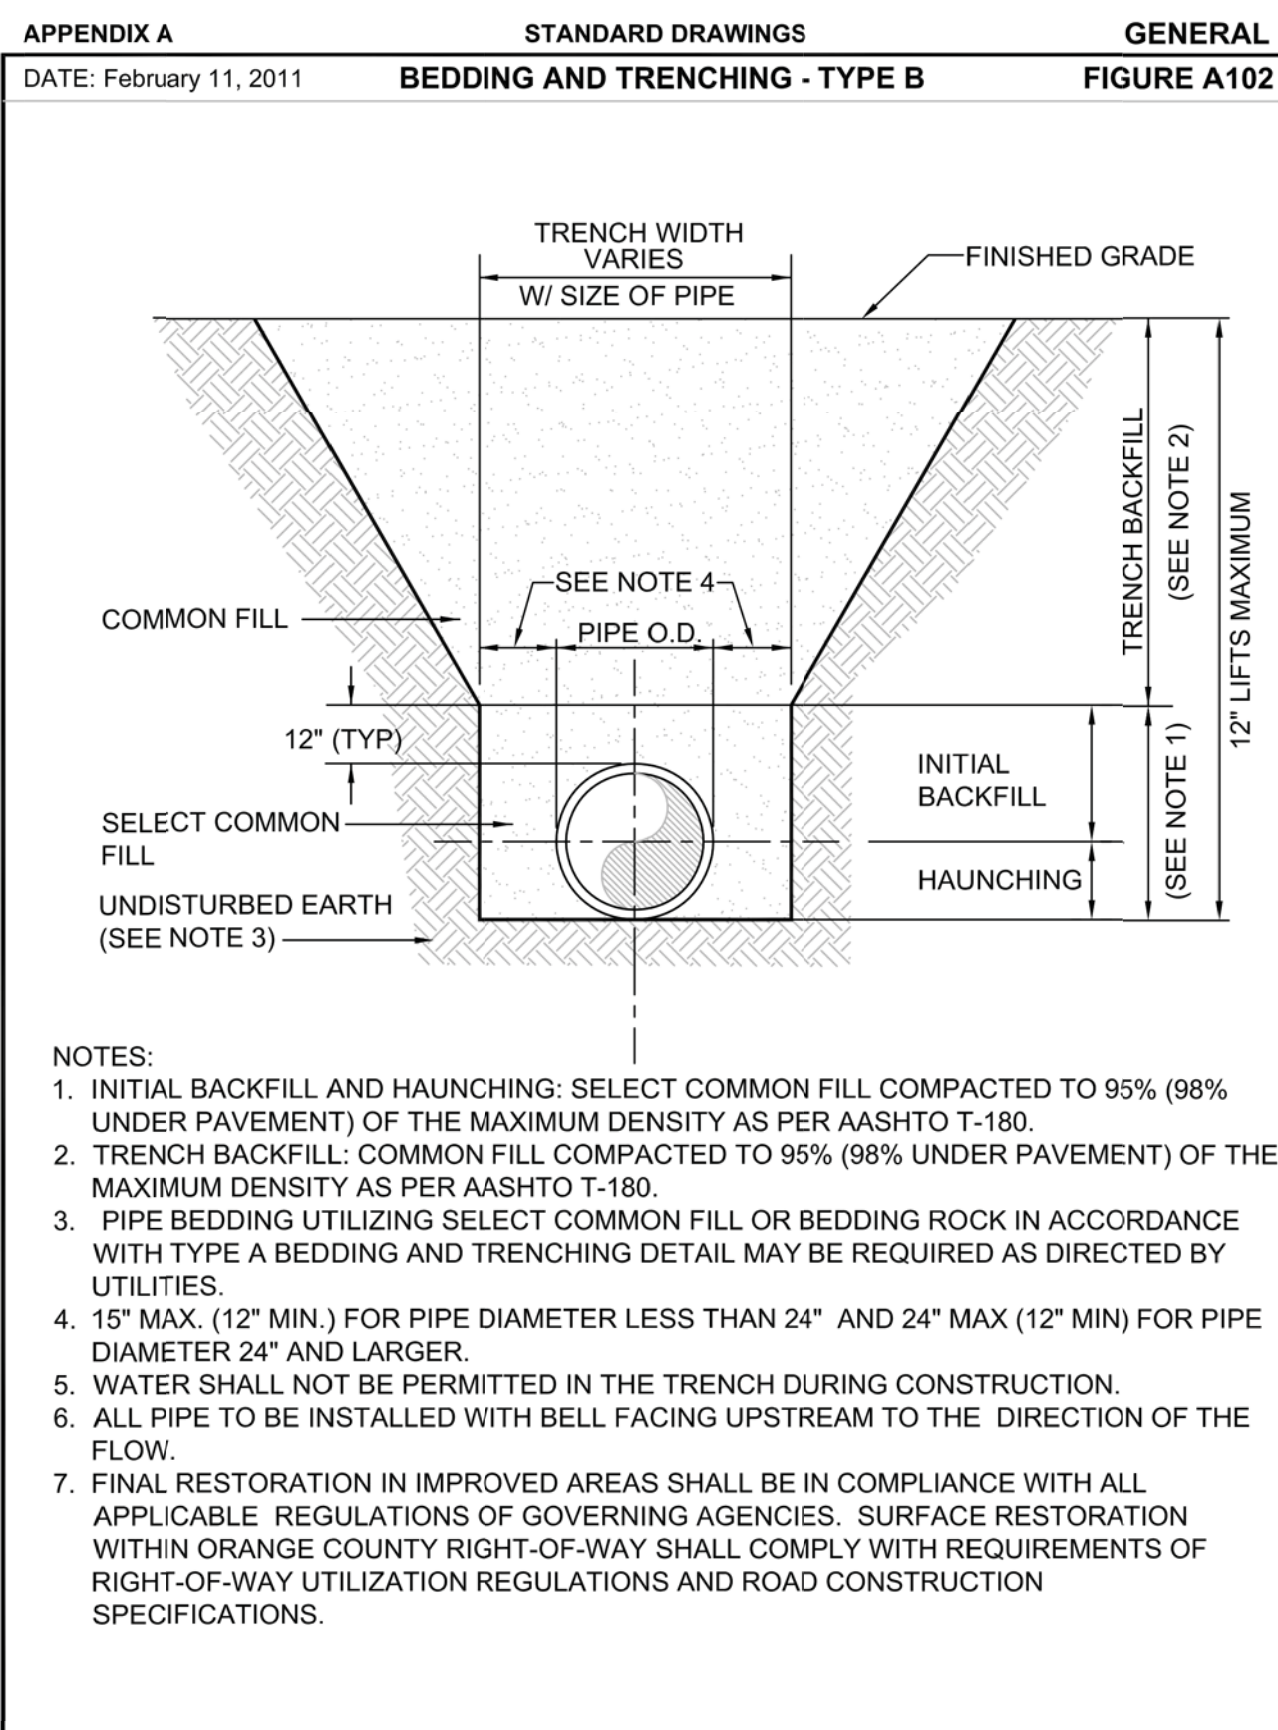
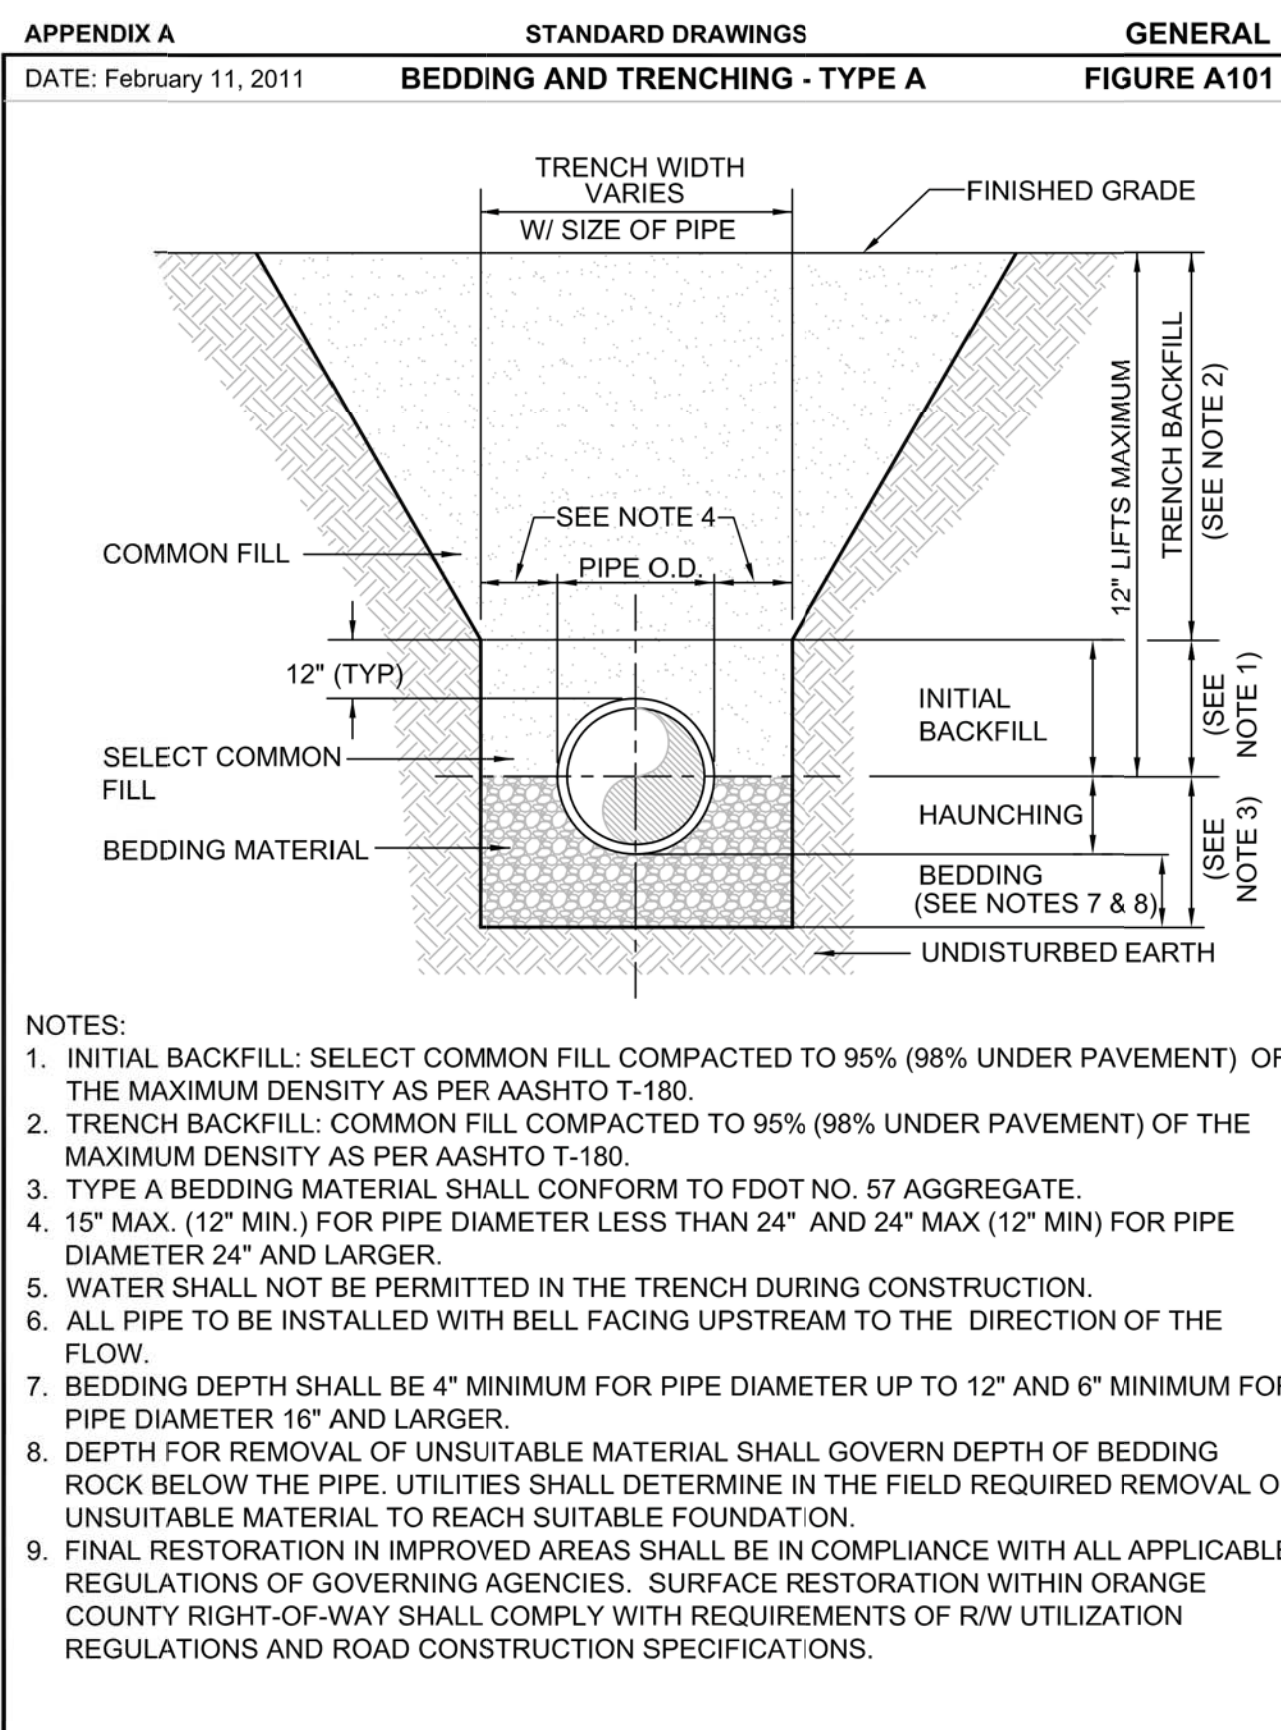
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PROJECT TITLE
PORTER TRANSFER STATION SITE IMPROVEMENTS

CLIENT
ORANGE COUNTY SOLID WASTE DIVISION ORLANDO, FLORIDA

SCS ENGINEERS
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CHK. BY: SRF
APP. BY: SRF
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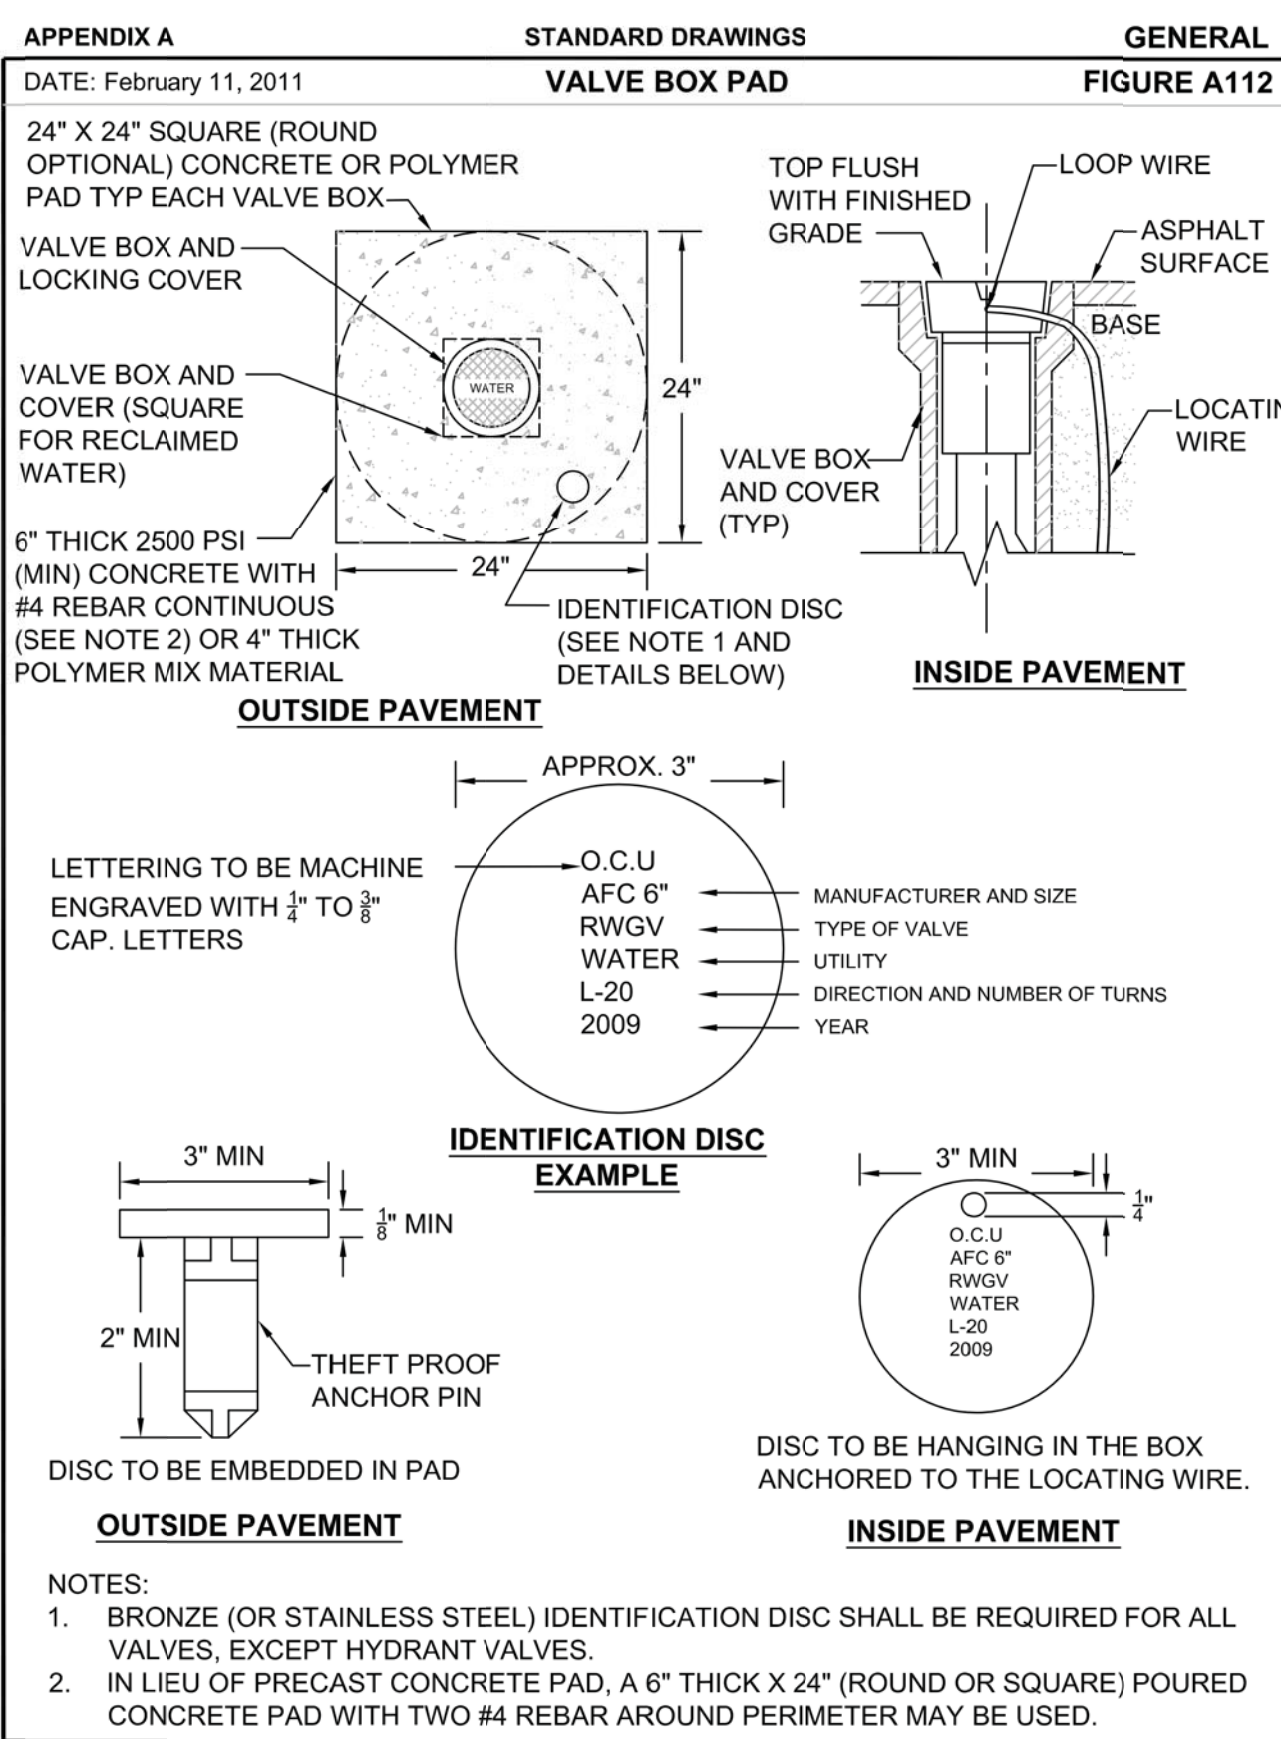
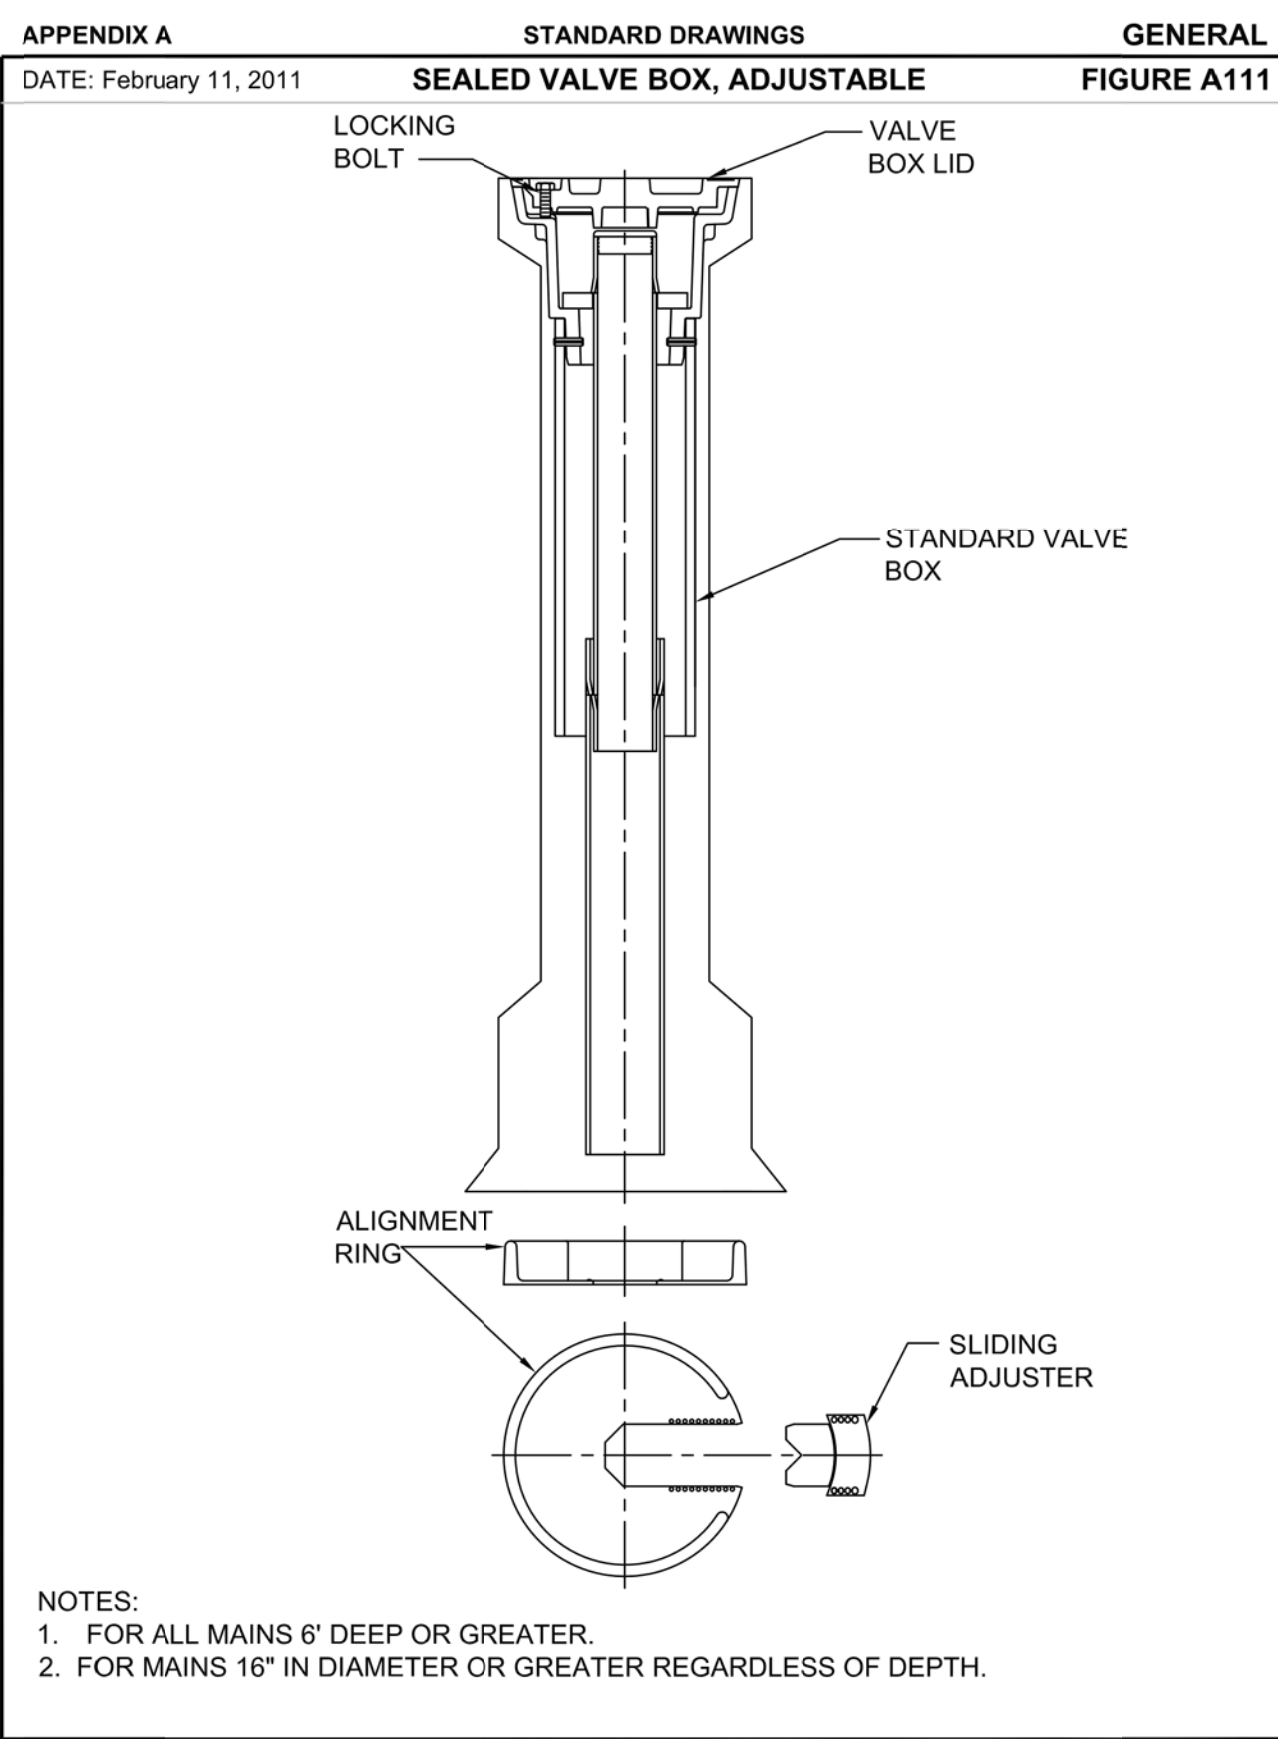
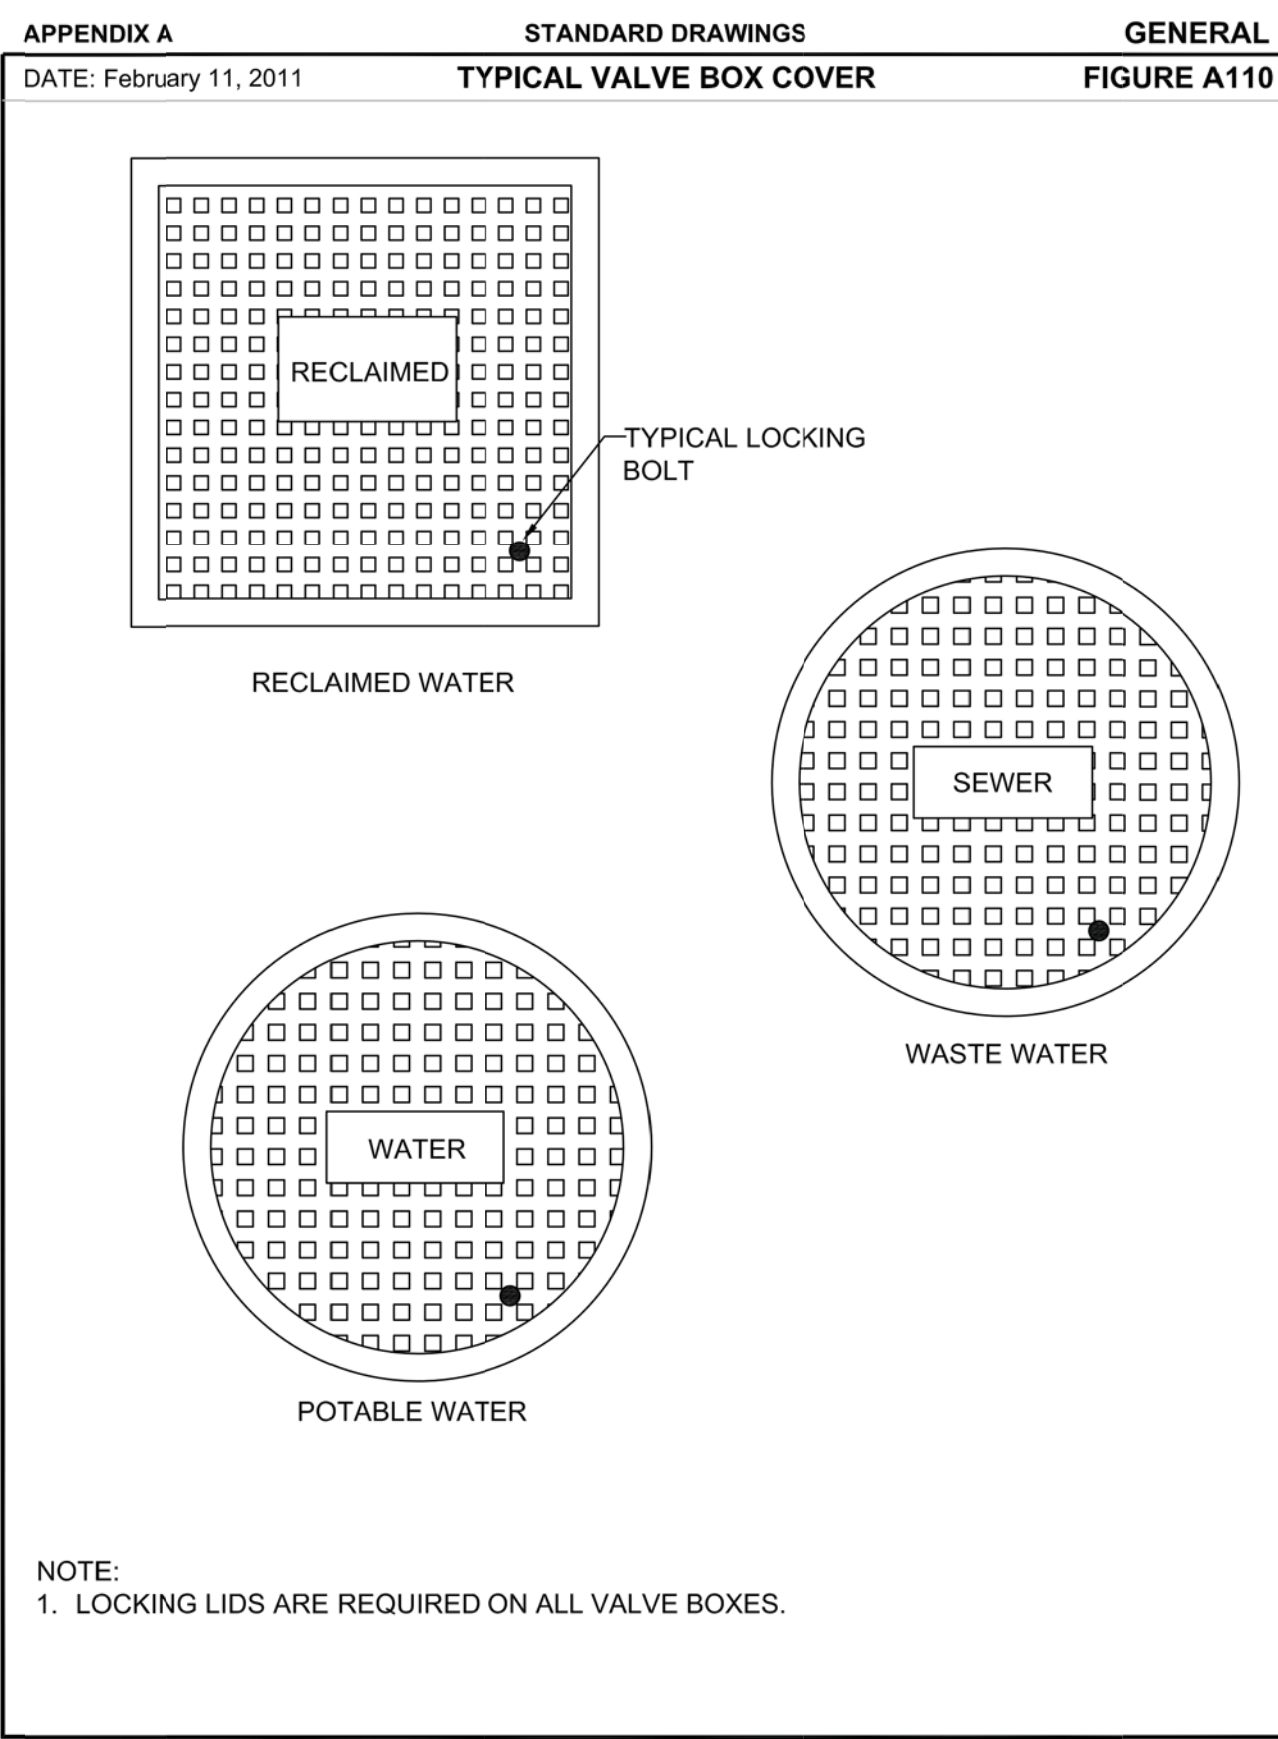
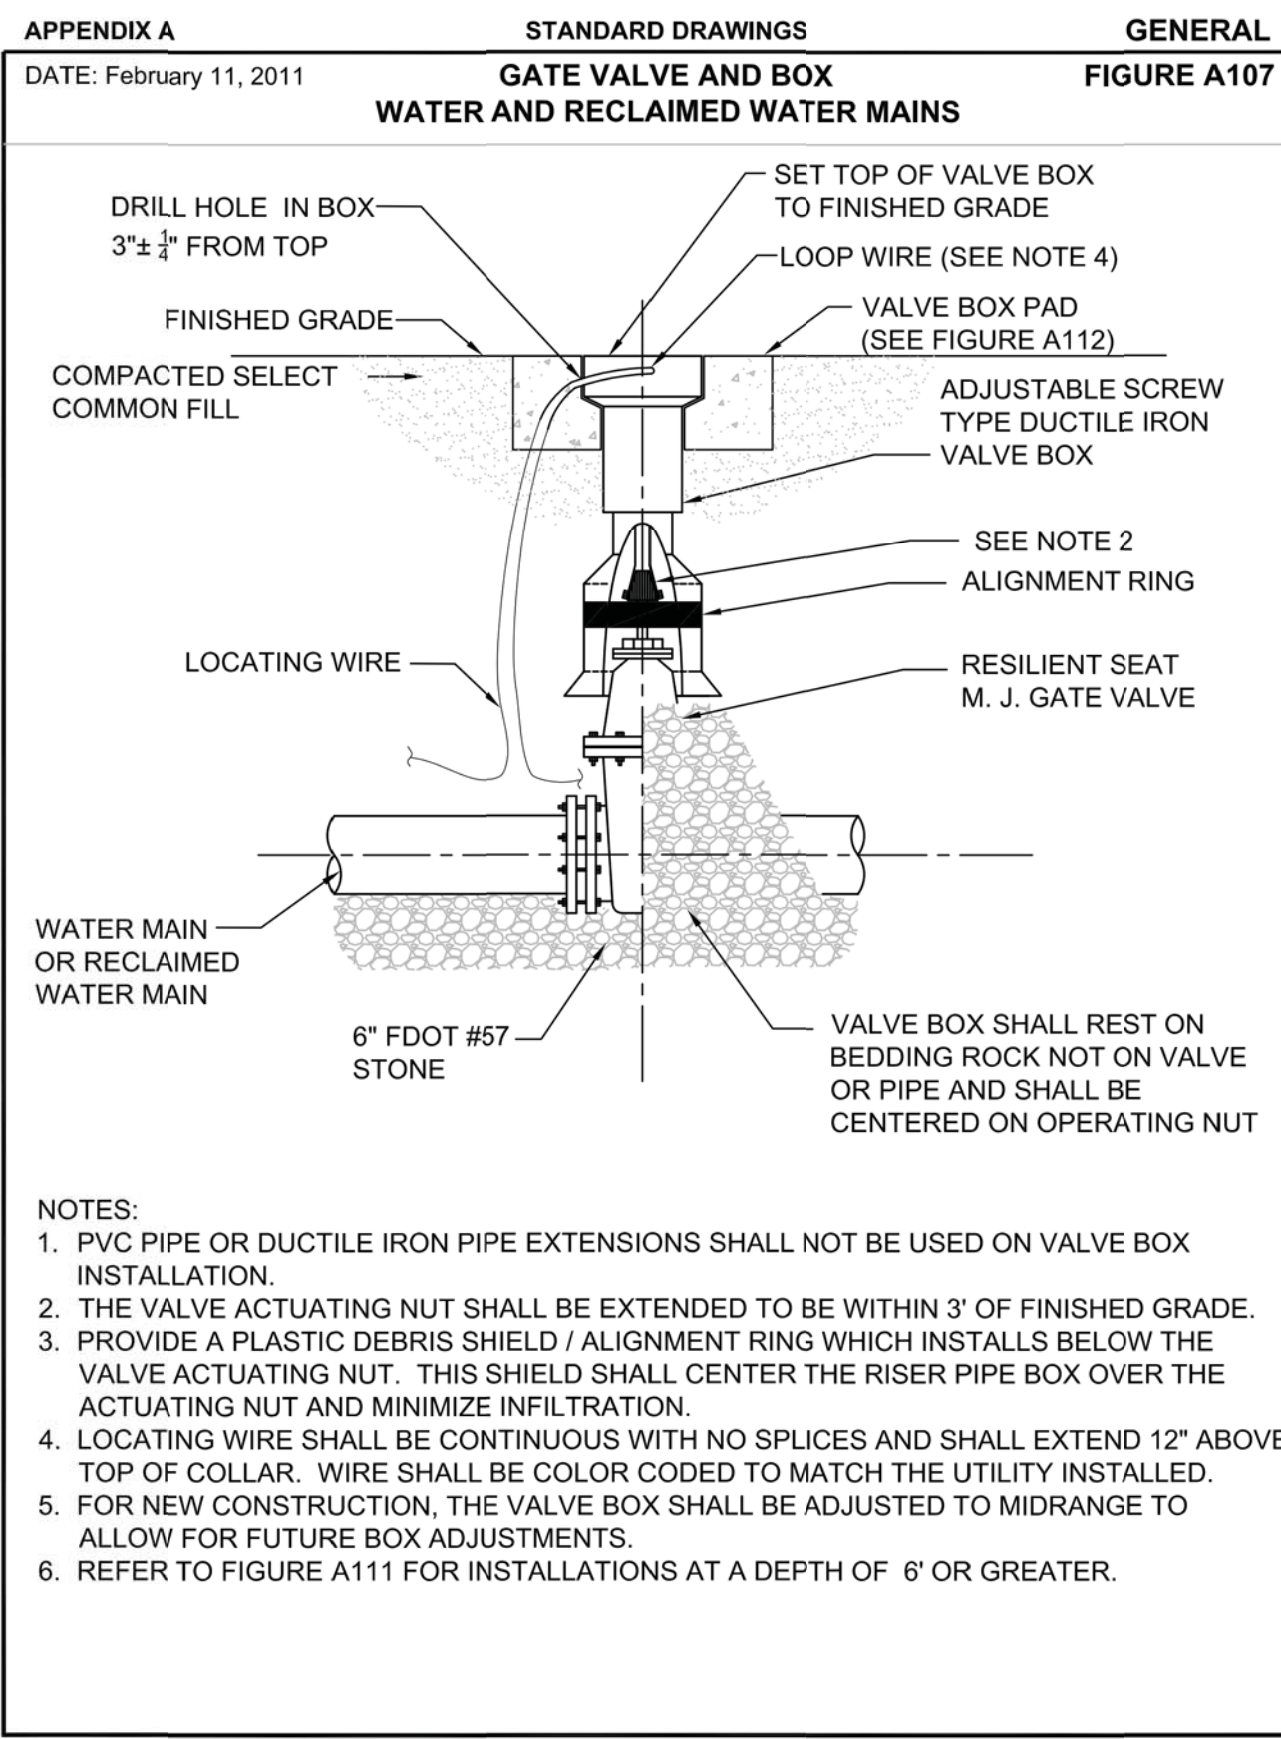
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DETAILS - 2

ORANGE COUNTY SOLID WASTE DIVISION ORLANDO, FLORIDA

PORTER TRANSFER STATION SITE IMPROVEMENTS

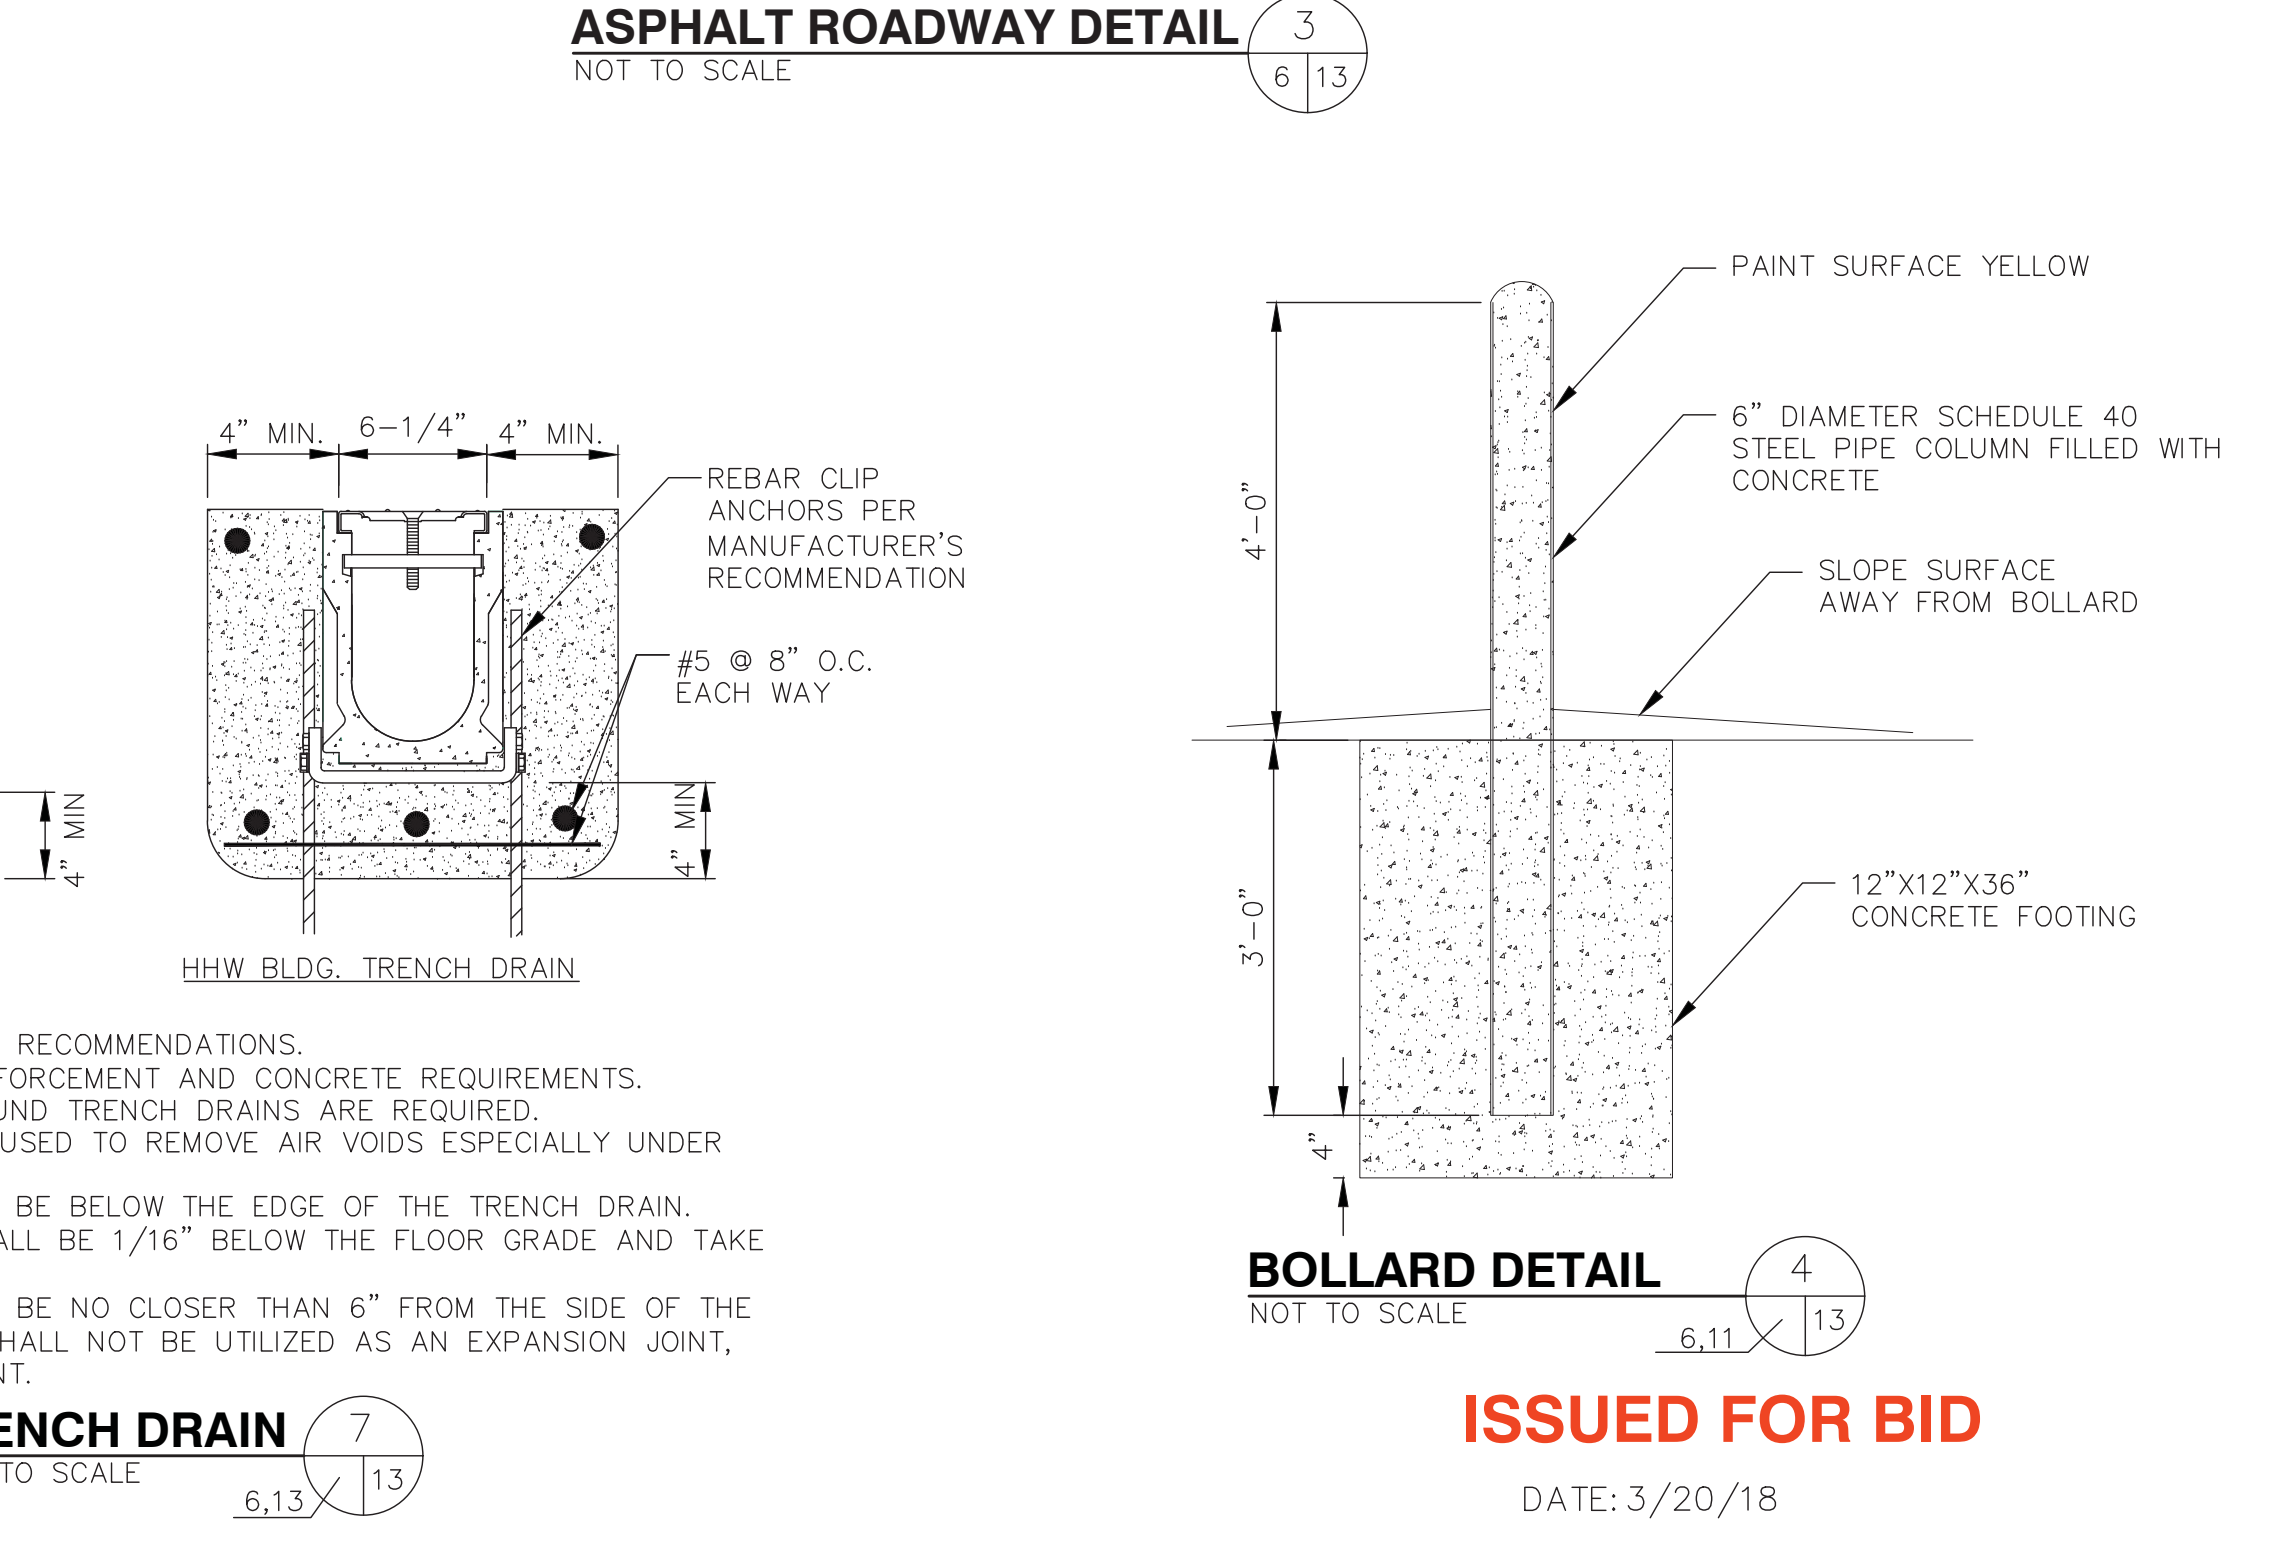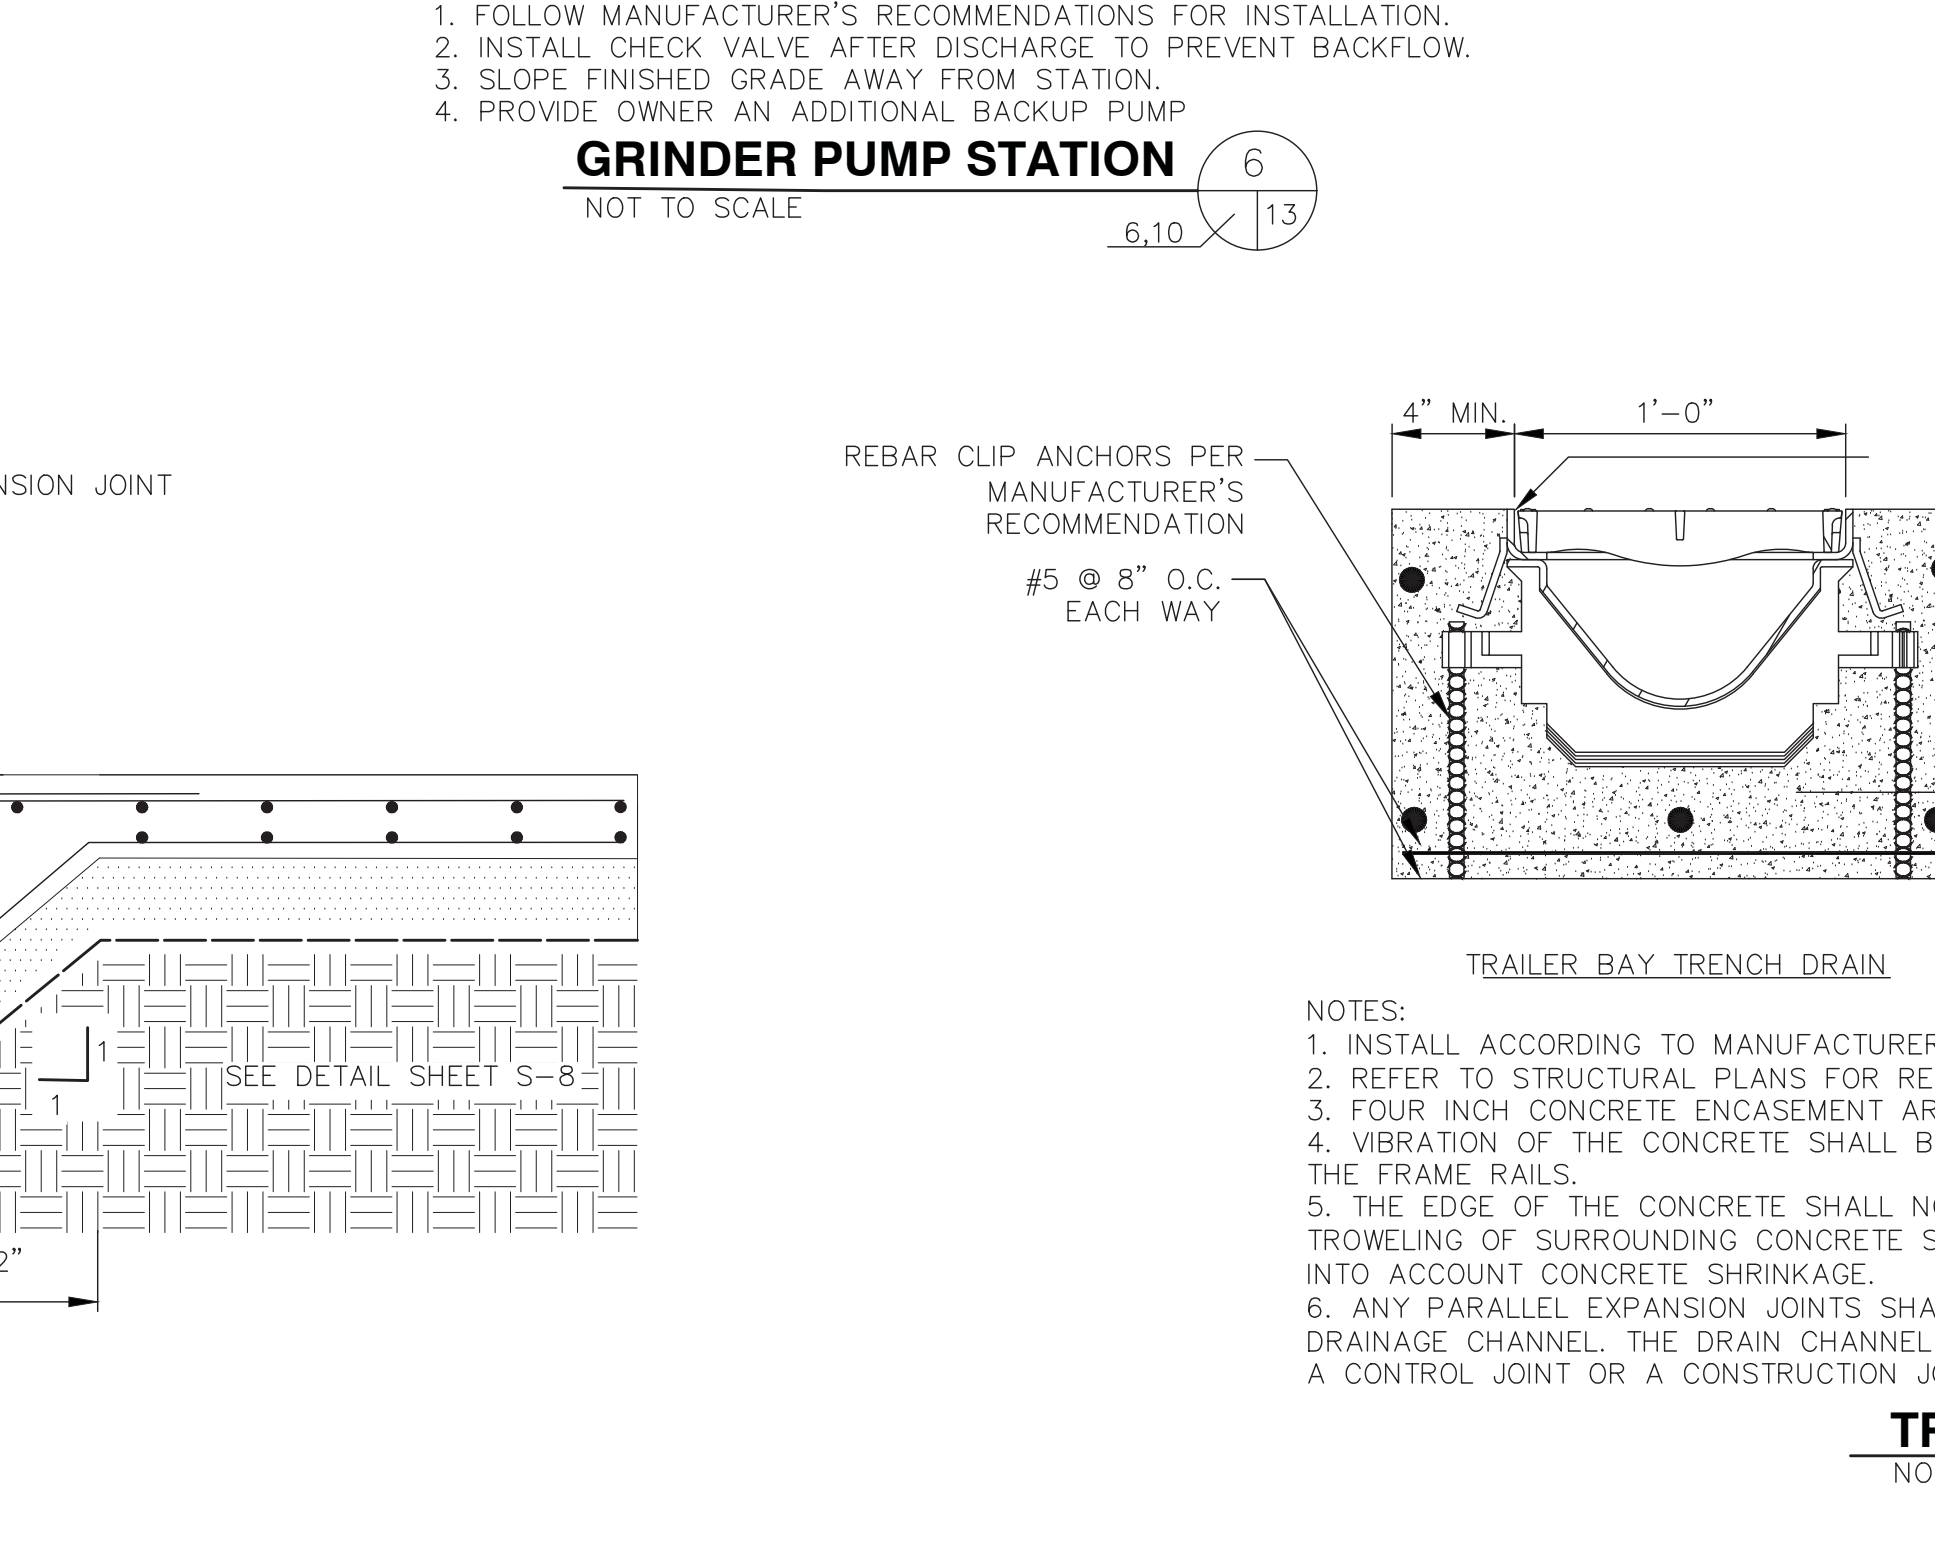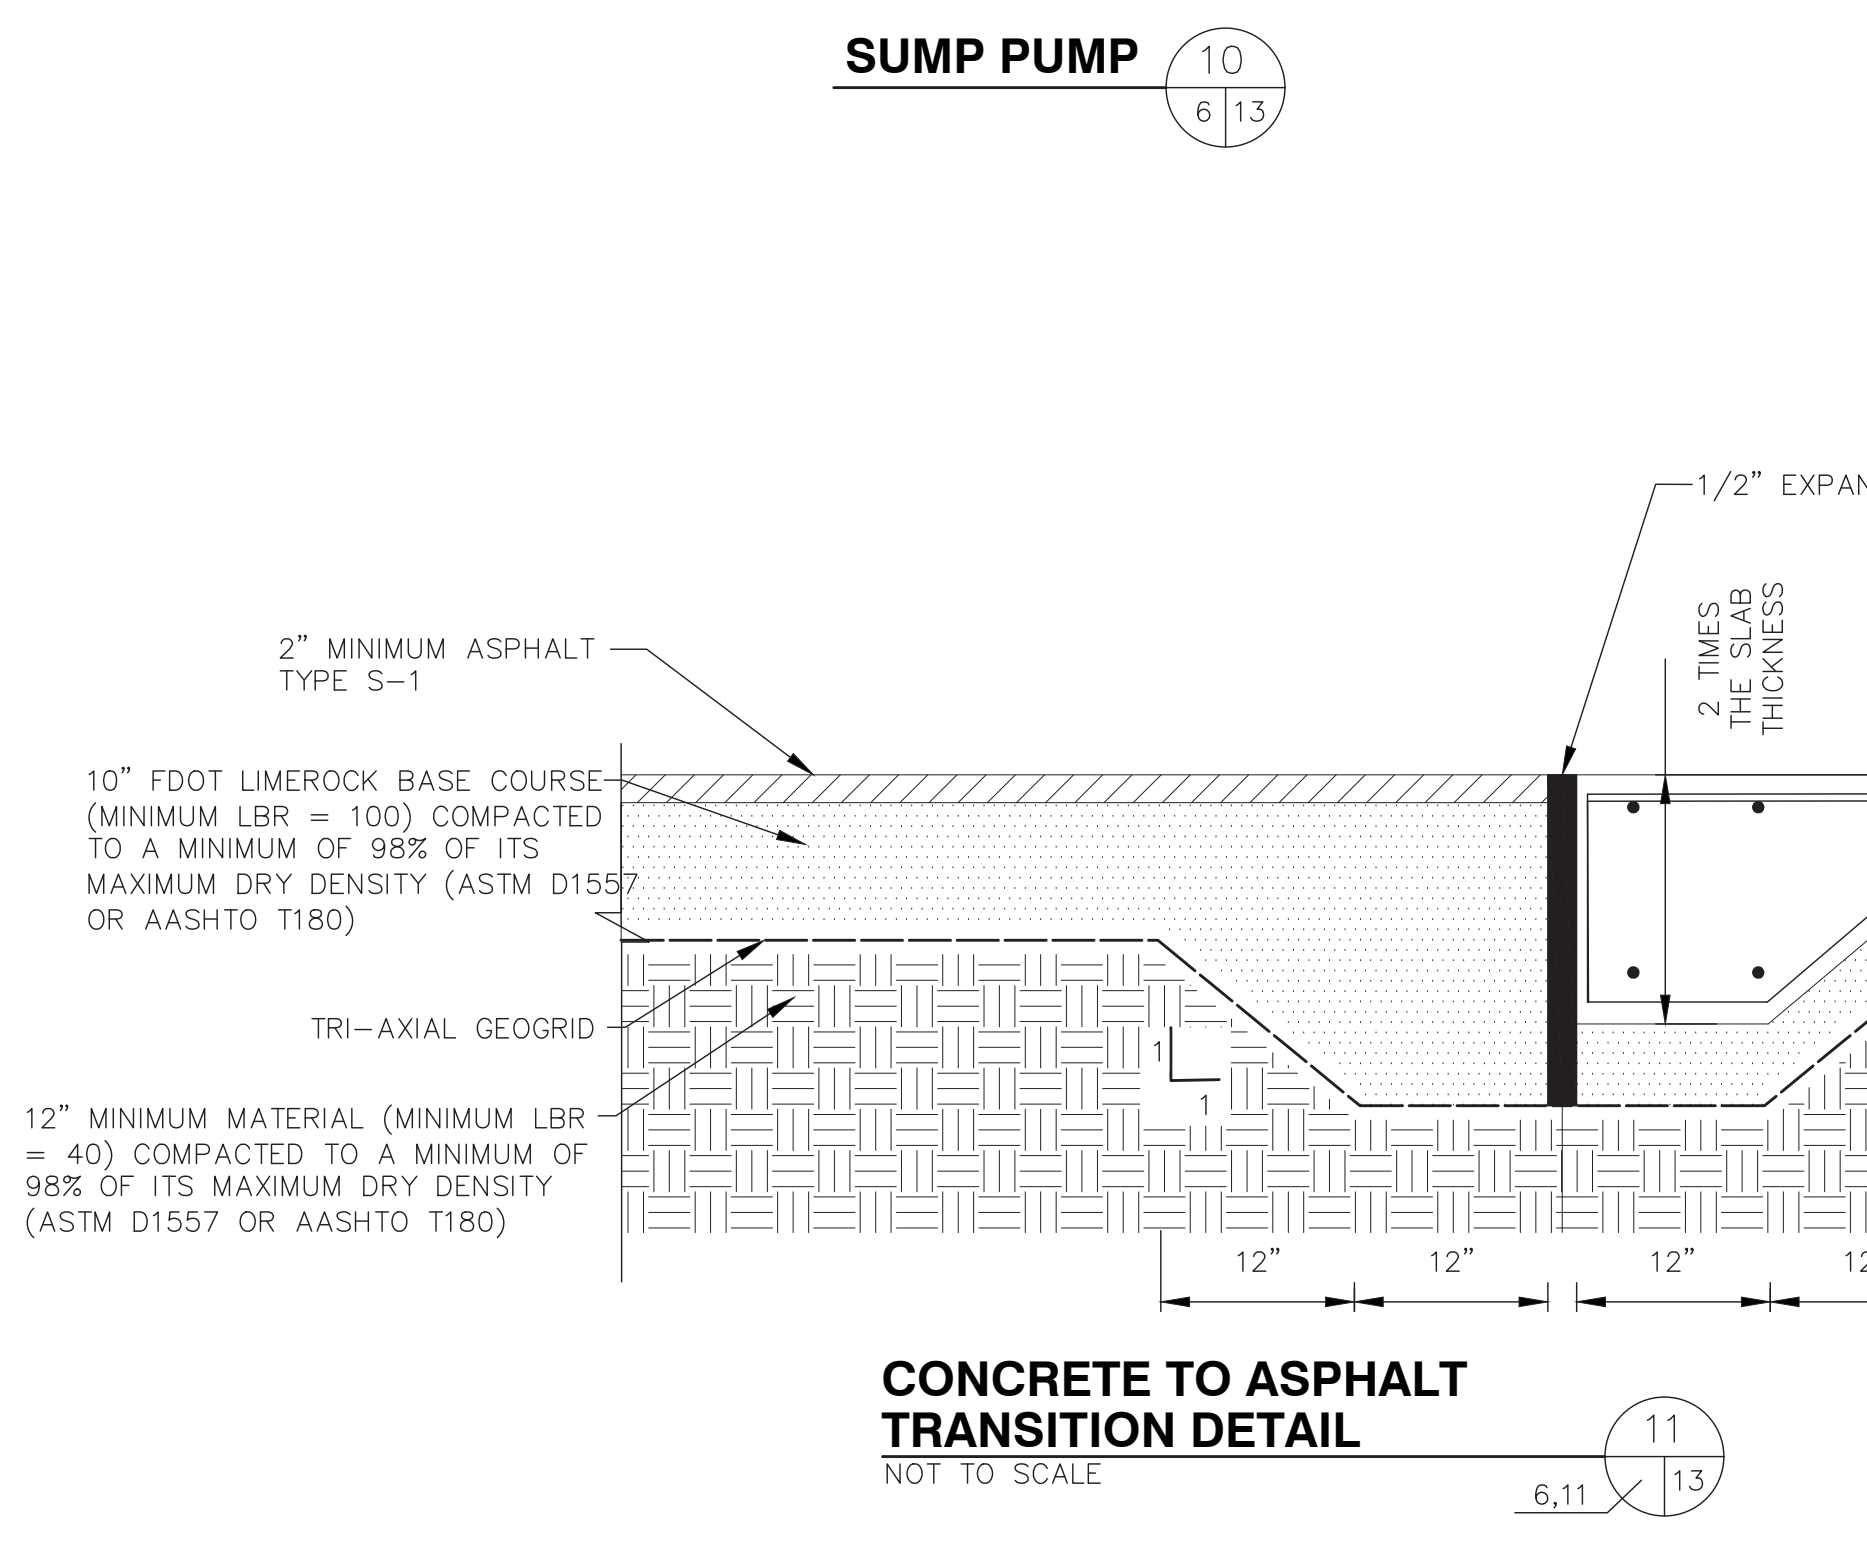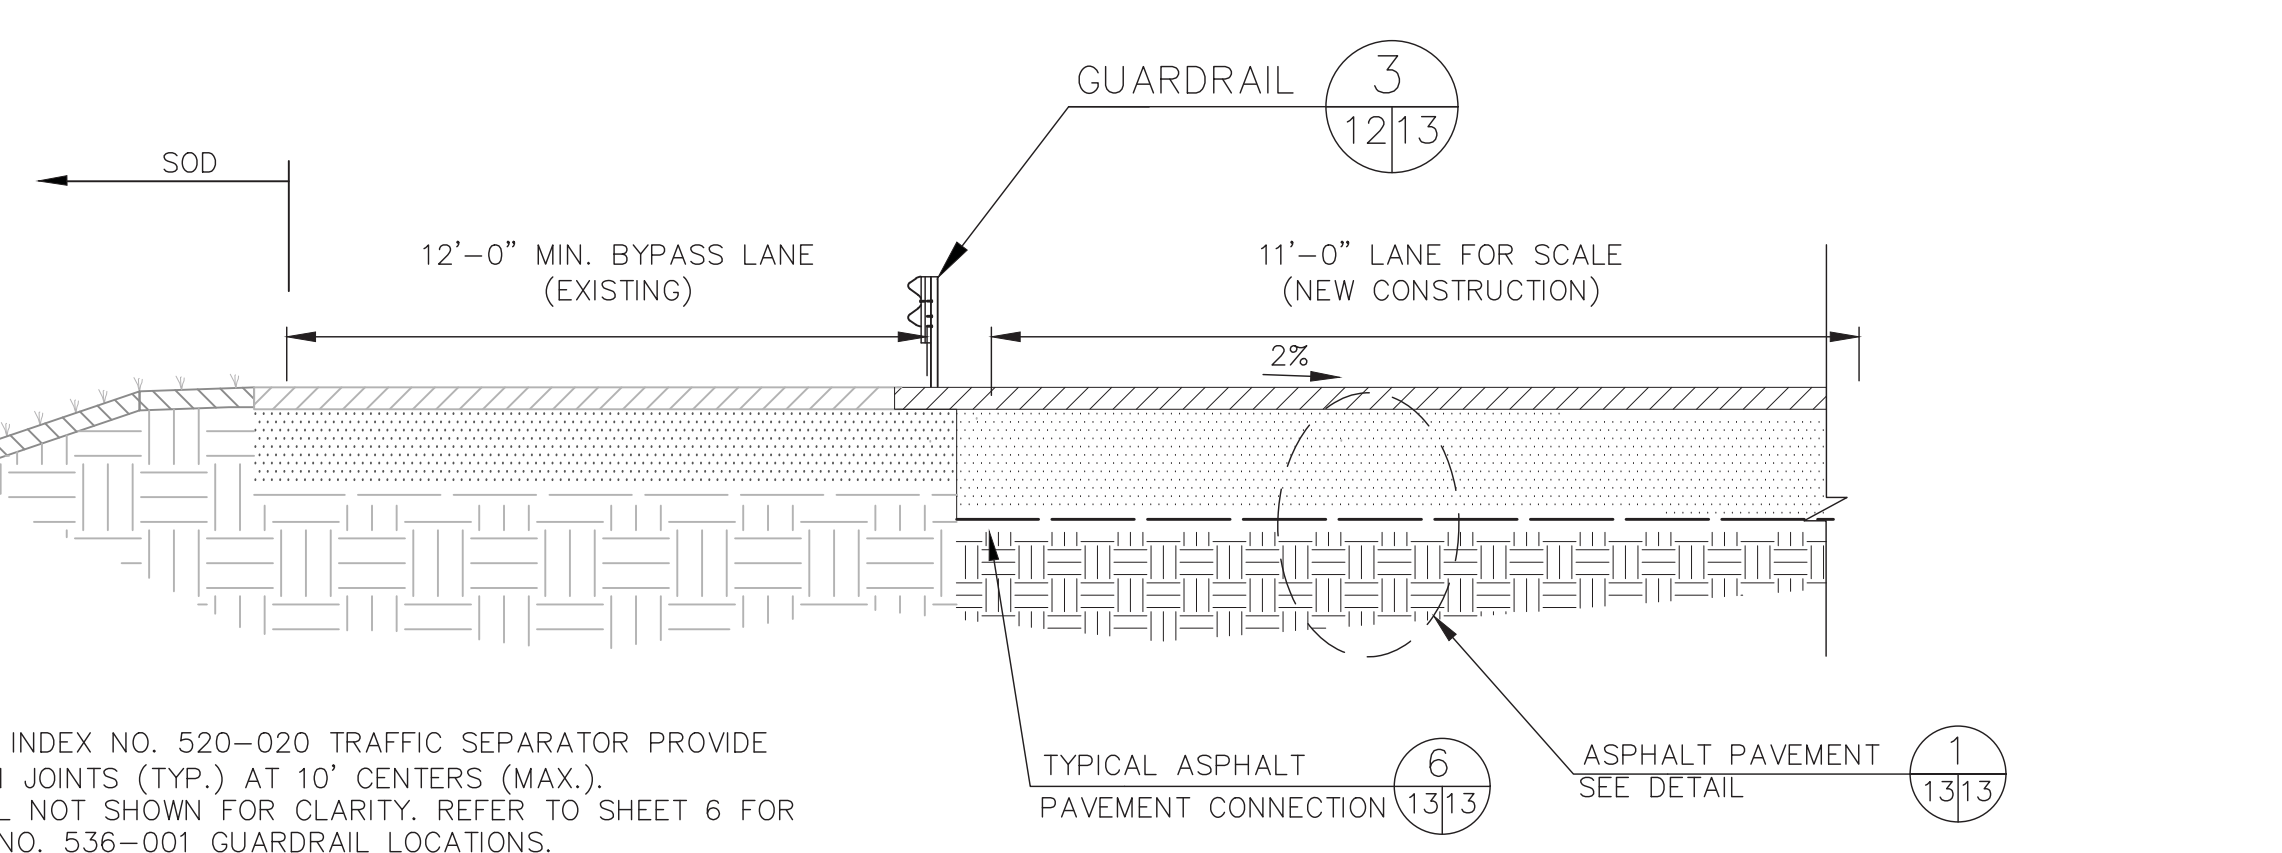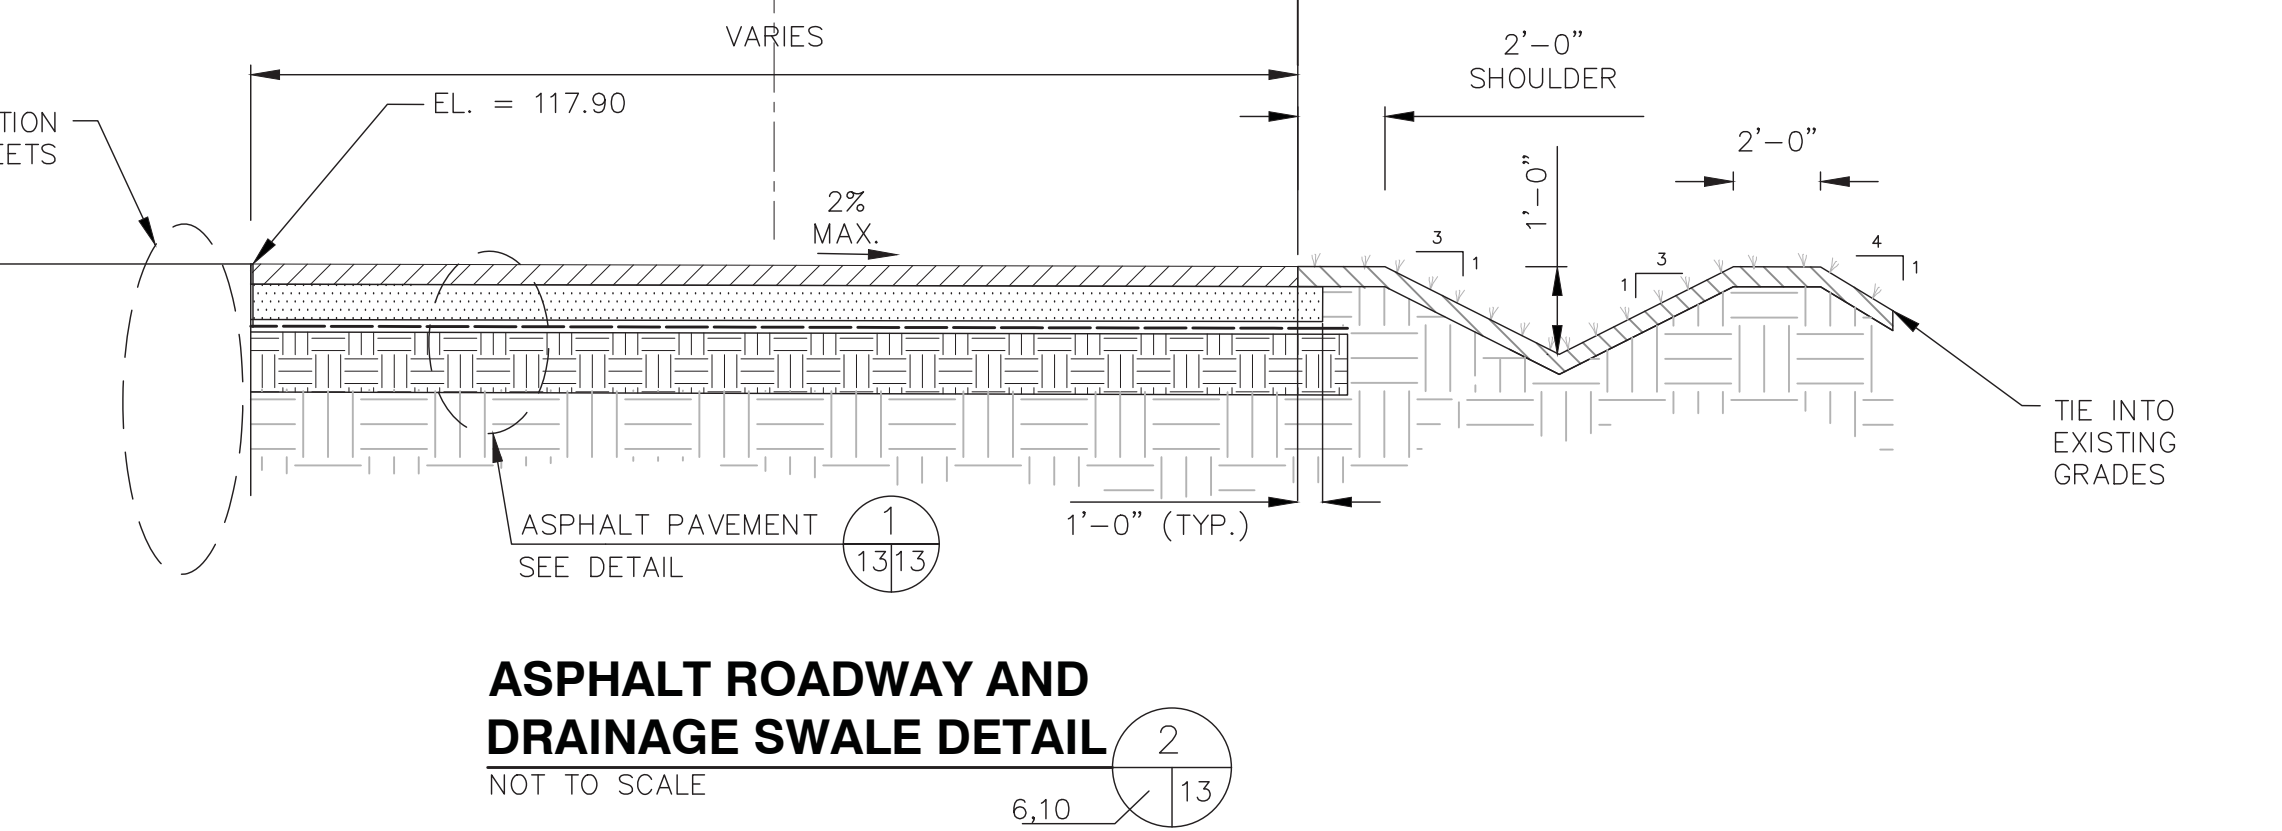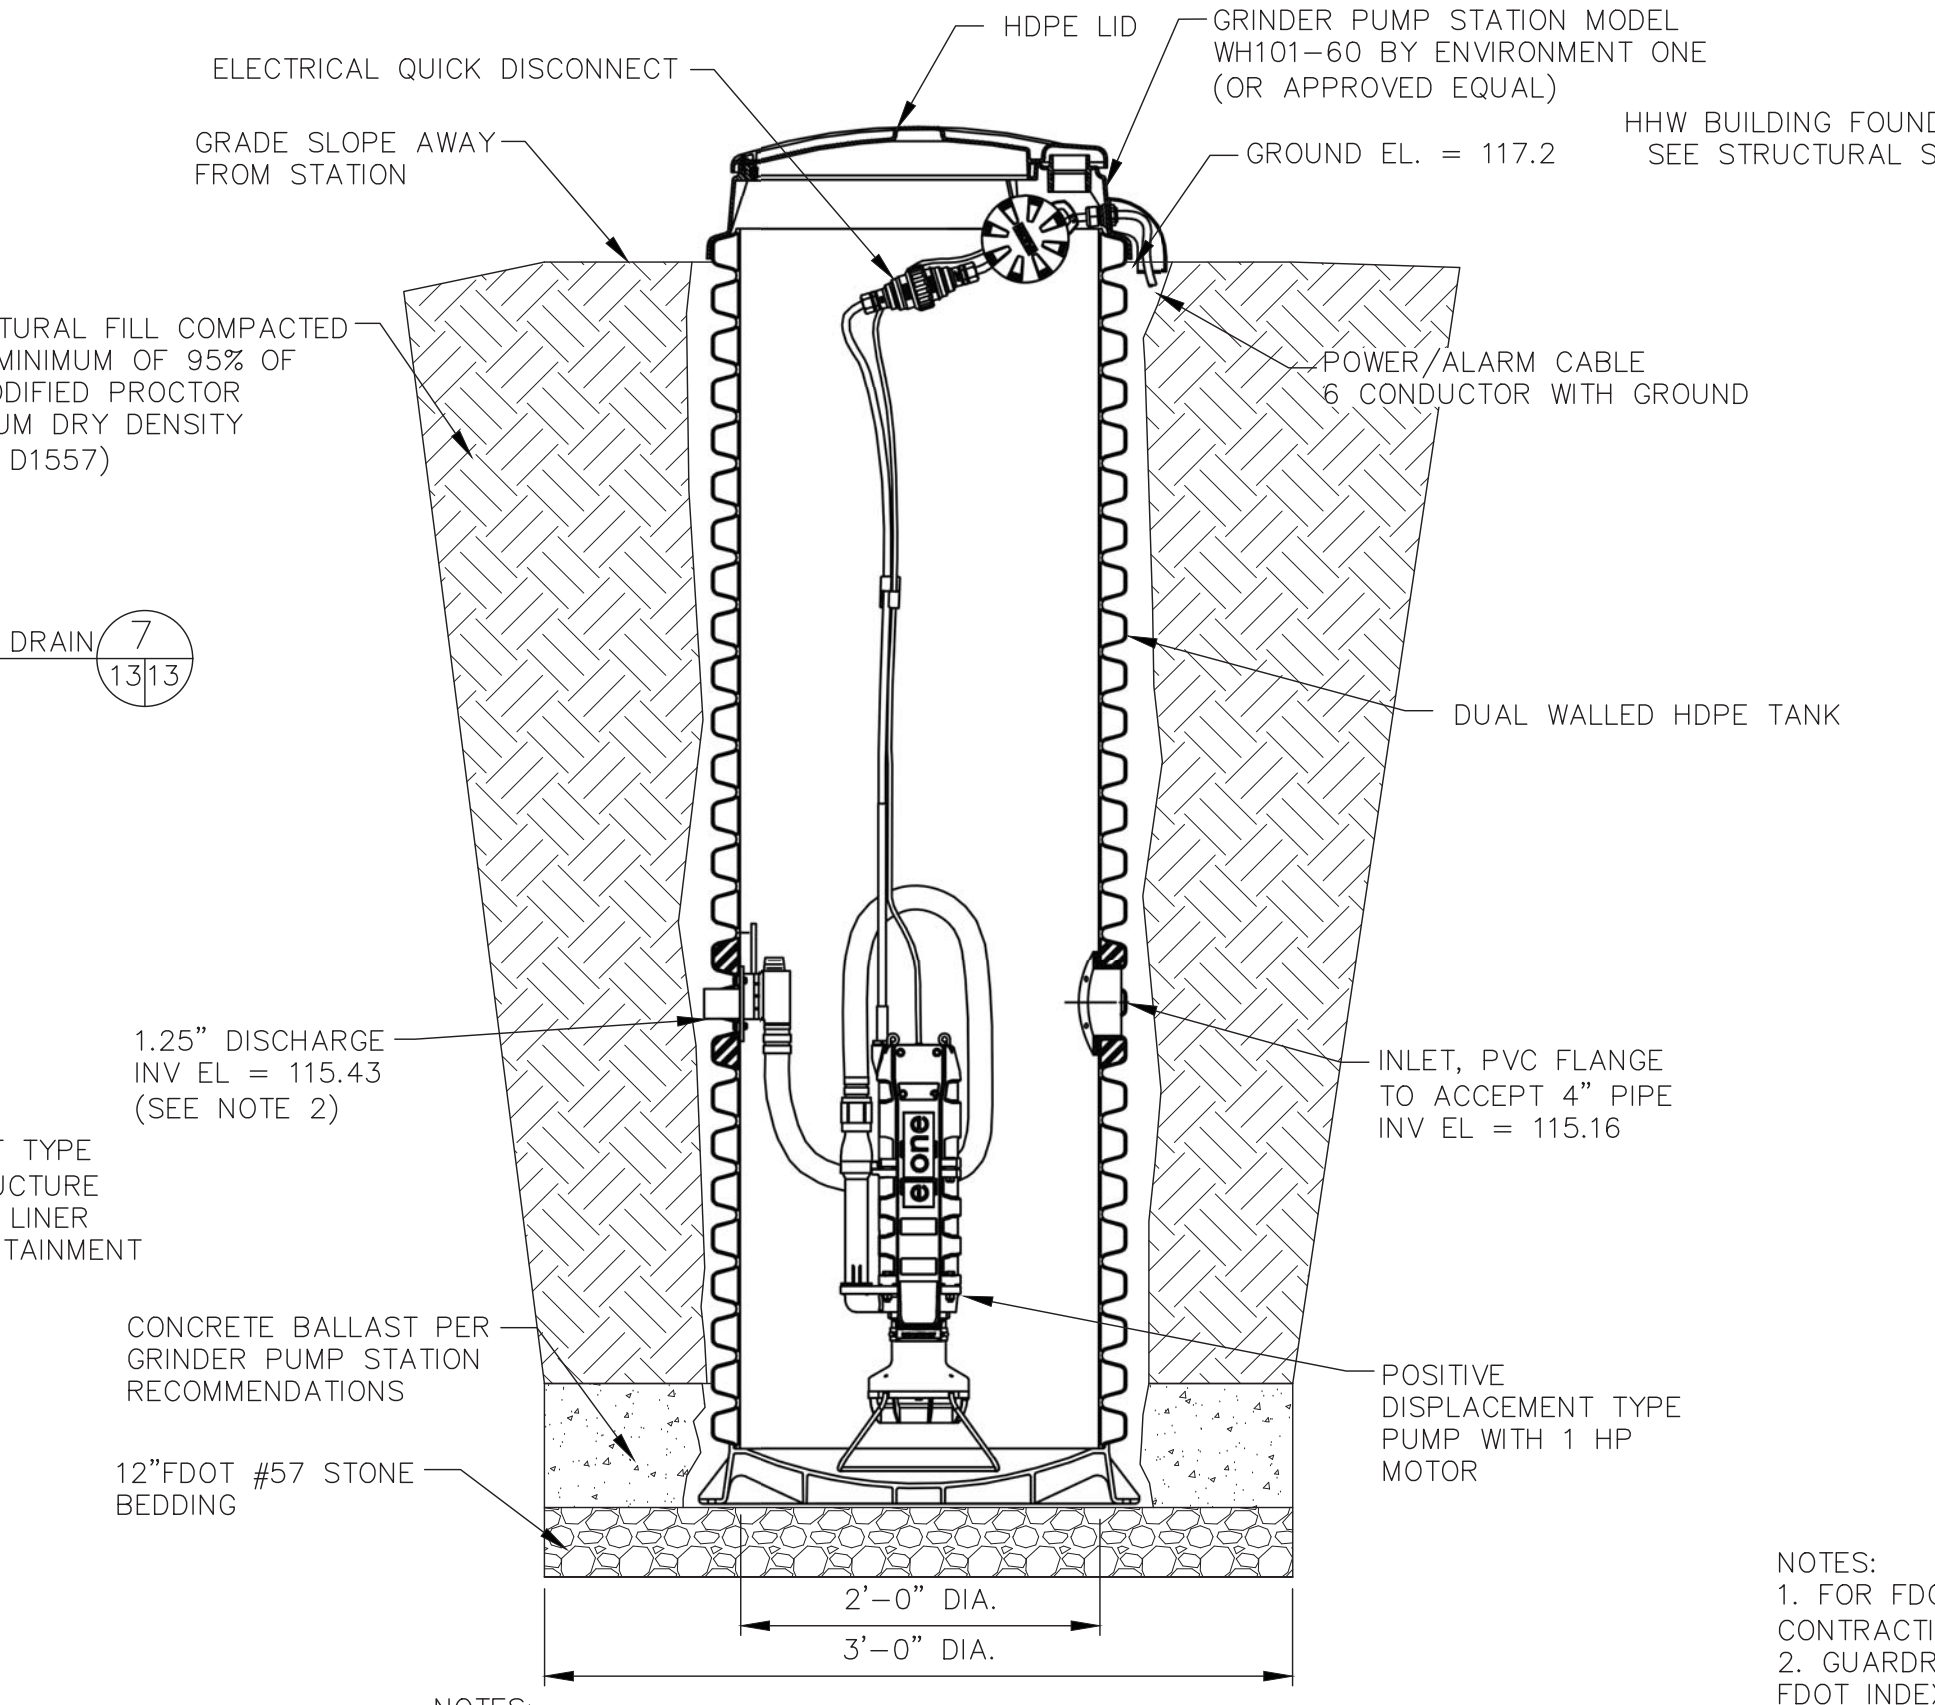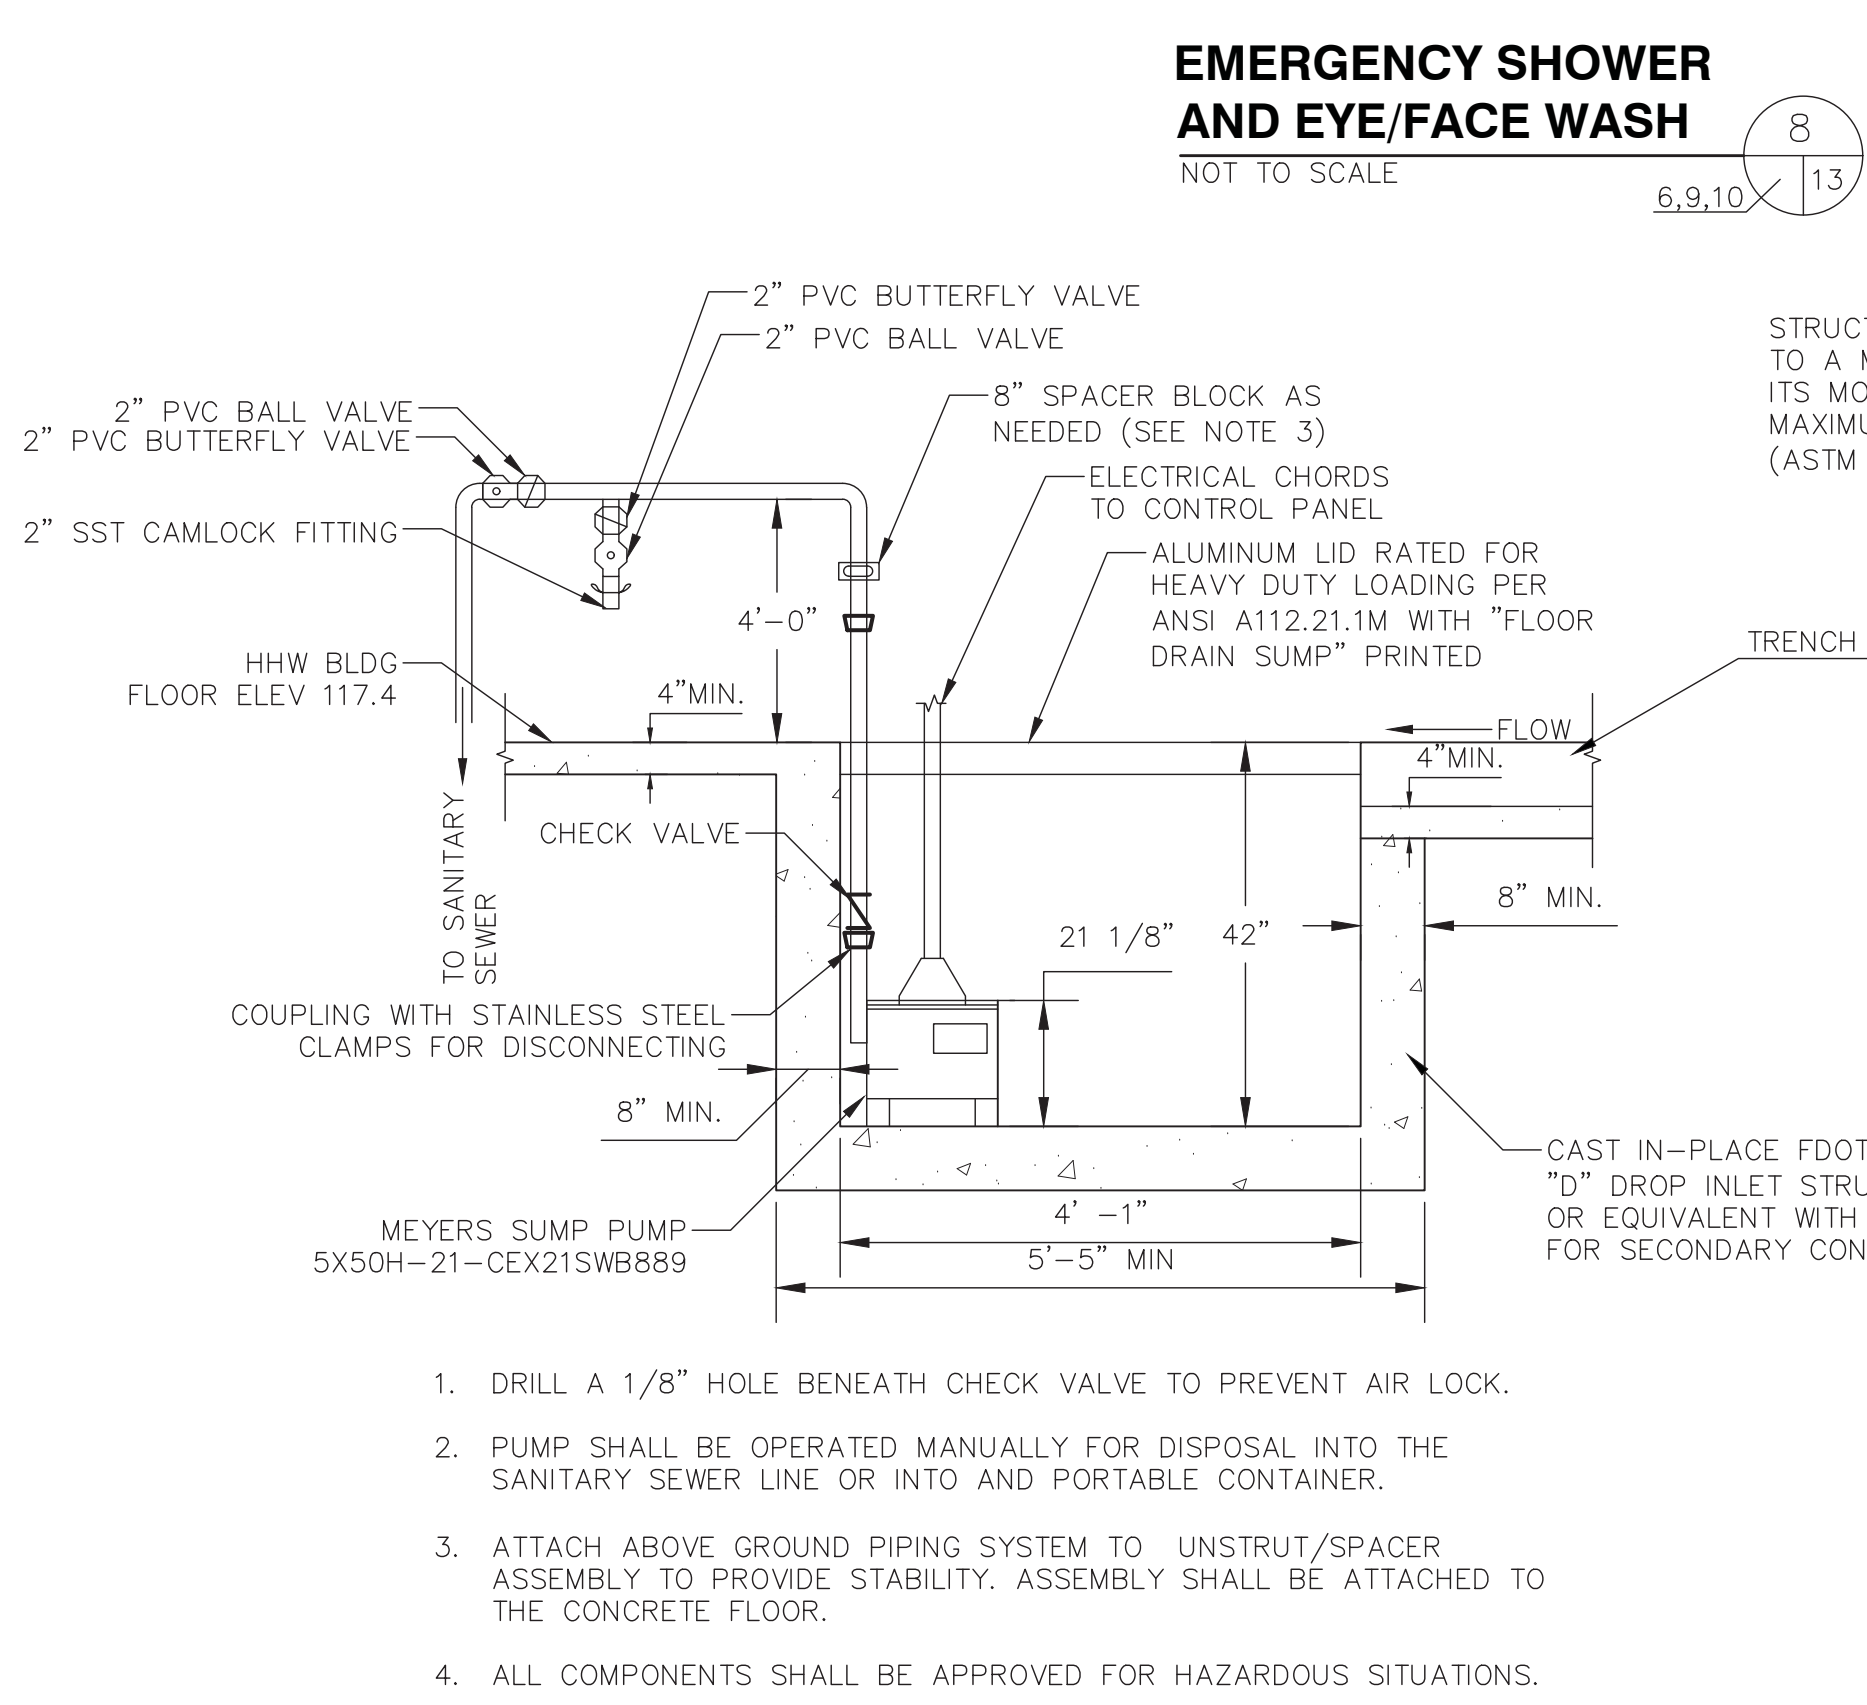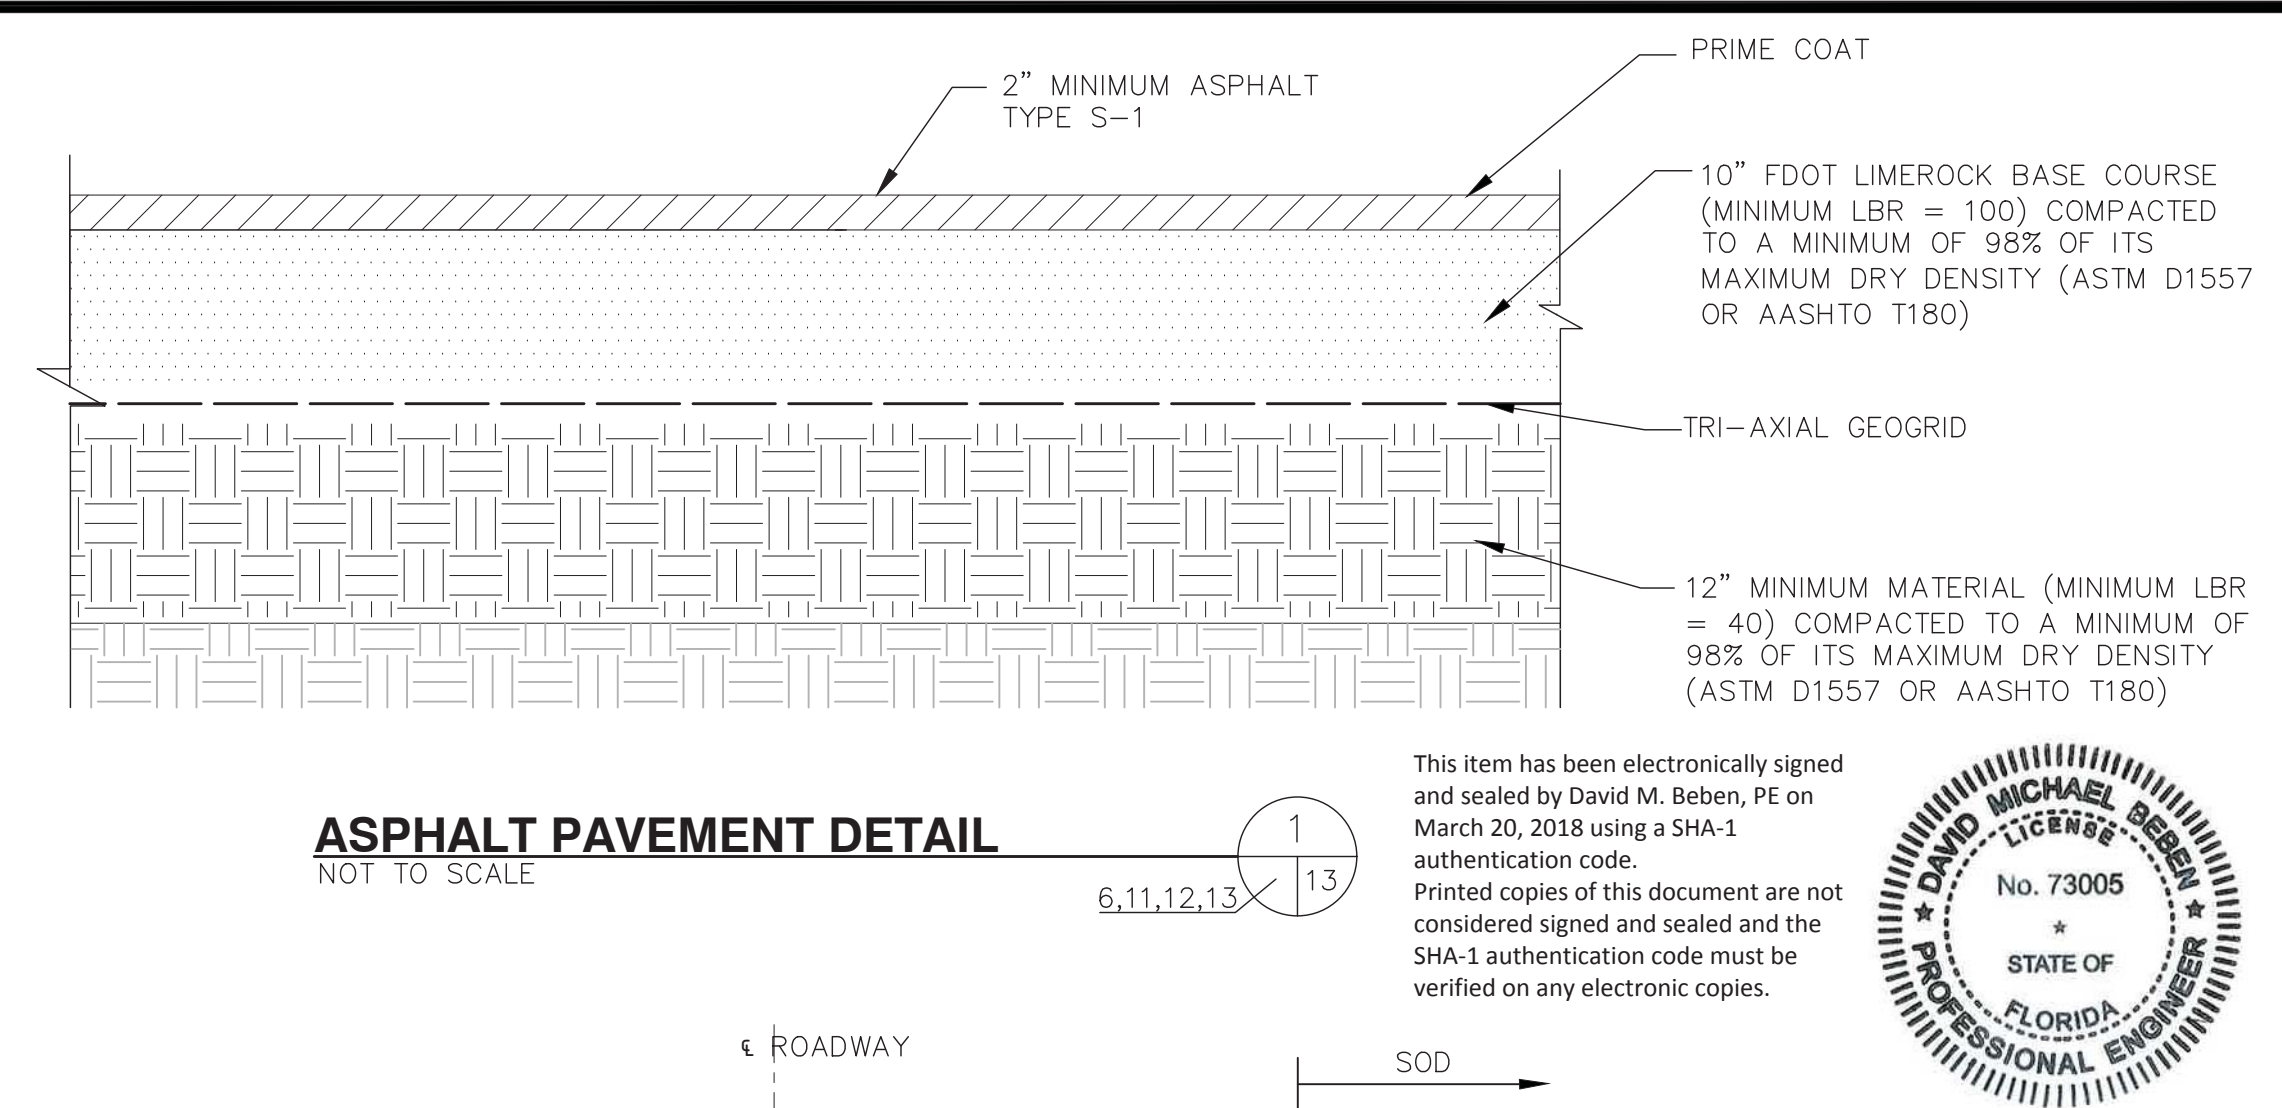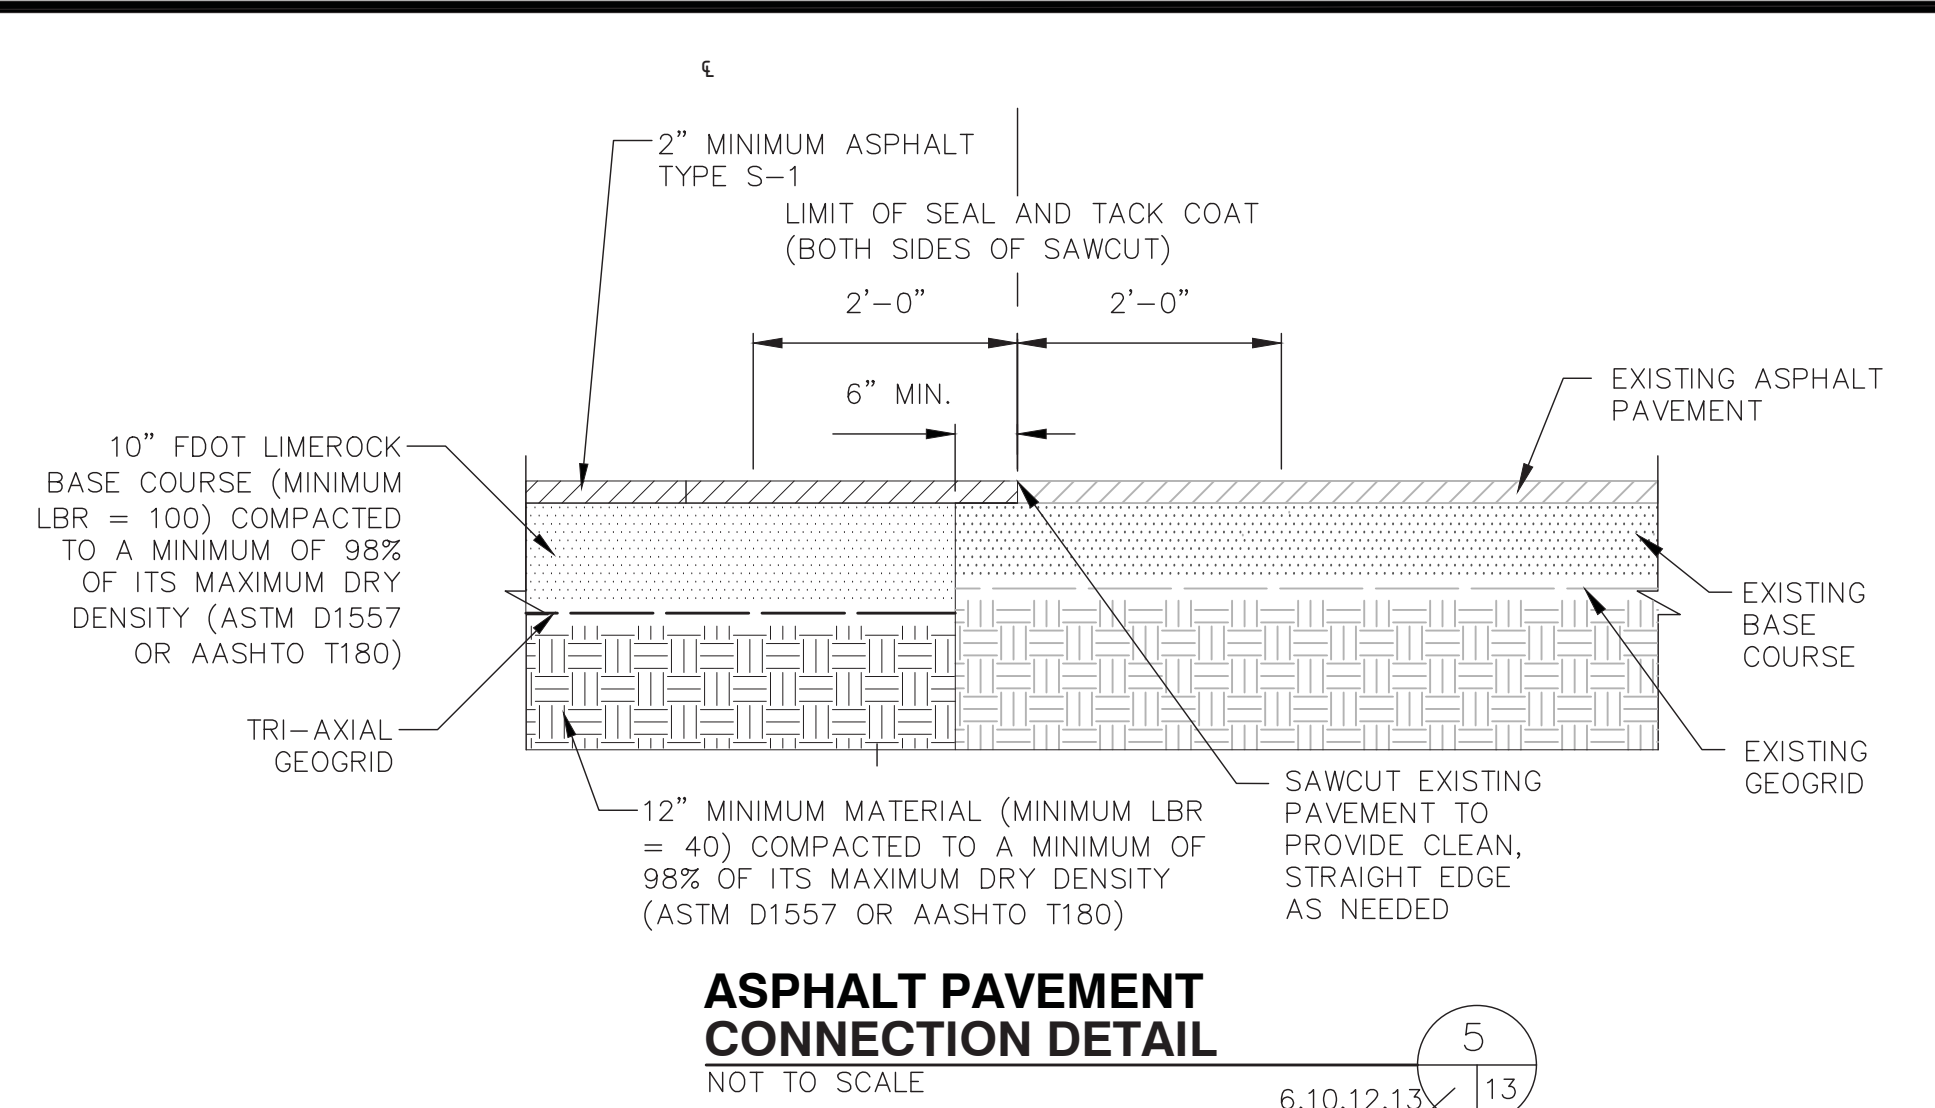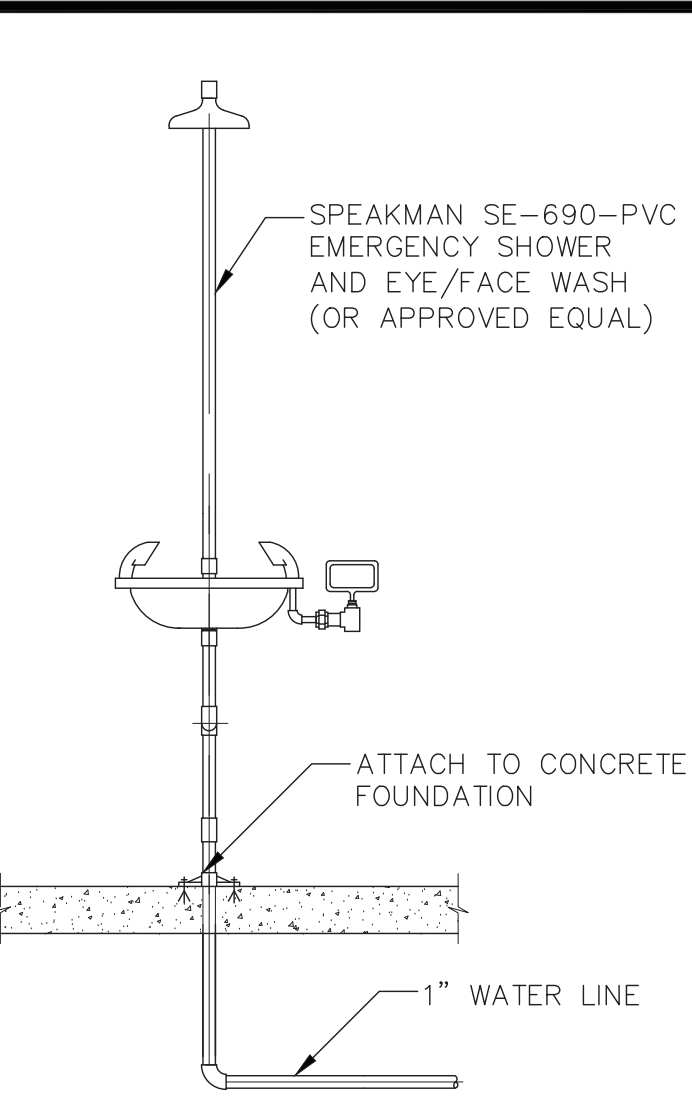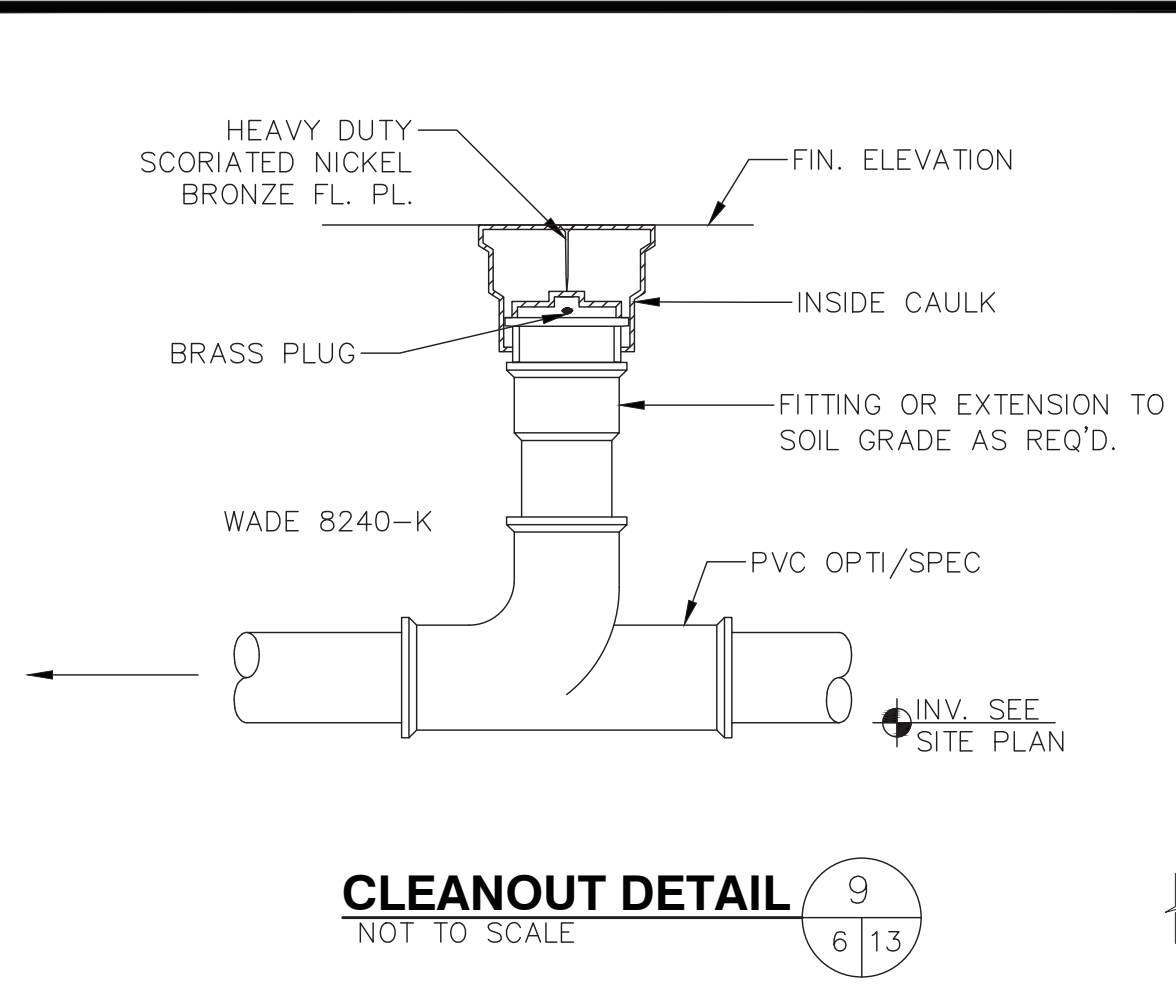

UTILITIES GENERAL NOTES:

- THE CONTRACTOR SHALL EXERCISE EXTREME CAUTION WHEN EXCAVATING IN PROXIMITY OF WATER MAINS, WASTEWATER FORCE MAINS, GRAVITY MAINS AND RECLAIMED WATER MAINS. MAIN LOCATIONS SHOWN ON PLANS MAY NOT BE EXACT. THE CONTRACTOR IS RESPONSIBLE FOR FIELD VERIFYING EXISTING UTILITY LOCATIONS.
- SHOULD A PIPE EMERGENCY OCCUR, THE CONTRACTOR SHALL IMMEDIATELY NOTIFY THE ORANGE COUNTY UTILITIES (OCU) DISPATCH OPERATOR (407-836-2777) AND THE OCU INSPECTOR.
- THE CONTRACTOR SHALL NOTIFY THE OCU CONSTRUCTION DIVISION AT LEAST SEVEN DAYS PRIOR TO THE COMMENCEMENT OF THE CONSTRUCTION PROJECT, AND AT LEAST 48 HOURS PRIOR TO ANY UTILITIES CONSTRUCTION BY CALLING (407) 254-9798.
- THE MATERIALS, PRODUCTS, AND CONSTRUCTION OF ALL UTILITIES CONNECTING TO THE OCU SYSTEM SHALL BE IN CONFORMANCE WITH THE OCU STANDARDS AND CONSTRUCTION

SPECIFICATIONS MANUAL.

- ALL OCU MAINS AND FACILITIES WITHIN THE LIMITS OF THE PROJECT SHALL BE SUPPORTED AND PROTECTED AGAINST DAMAGE DURING CONSTRUCTION.
- THE CONTRACTOR, AT THE CONTRACTORS EXPENSE, SHALL IMMEDIATELY REPAIR ALL DAMAGES TO OCU MAINS AND FACILITIES. IF THE REPAIR IS NOT MADE IN A TIMELY MANNER AS DETERMINED BY OCU, OCU MAY PERFORM REQUIRED REPAIRS AND CLEANUP. THE CONTRACTOR WILL BE CHARGED FOR ALL EXPENSES ASSOCIATED WITH THE REPAIR.
- THE CONTRACTOR SHALL ADJUST ALL EXISTING OCU MAINS AND FACILITIES IN CONFLICT WITH THE NEW GRADE, NEW OR ALTERED ROADWAYS, SIDEWALKS, DRIVEWAYS, OR STORMWATER IMPROVEMENTS. OCU FACILITIES TO BE ADJUSTED INCLUDE BUT ARE NOT LIMITED TO PIPELINES, PUMP STATIONS, VALVE BOXES, AIR RELEASE VALVES, FIRE HYDRANTS, MANHOLE COVERS, AND METERS.
- ONLY OCU SHALL OPERATE OCU WATER, WASTEWATER, AND RECLAIMED WATER VALVES. THE CONTRACTOR SHALL COORDINATE VALVE OPERATION WITH THE OCU INSPECTOR. FOR OPERATION OF MAINS NOT OWNED BY OCU, IT IS THE CONTRACTOR'S RESPONSIBILITY TO

COORDINATE WITH THE APPROPRIATE UTILITY REPRESENTATIVE.

- CONSTRUCTION ACTIVITIES SHALL NOT CAUSE INTERRUPTIONS IN WATER, WASTEWATER, OR RECLAIMED WATER SERVICE. THE CONTRACTOR SHALL COORDINATE PRE-APPROVED INTERRUPTIONS OF SERVICE WITH THE OCU INSPECTOR 7 WORKING DAYS IN ADVANCE.
- THE CONTRACTOR SHALL PROVIDE FOR BYPASSING AND/OR HAULING WASTEWATER DURING APPROVED INTERRUPTIONS OF WASTEWATER FLOWS AND CONNECTIONS. THE CONTRACTOR SHALL SUBMIT A BYPASS PLAN SIGNED AND SEALED BY A PROFESSIONAL ENGINEER TO OCU DEVELOPMENT ENGINEERING FOR APPROVAL PRIOR TO IMPLEMENTATION BY CONTRACTOR.
- ALL VALVES INSTALLED AS PART OF THIS CONSTRUCTION PROJECT SHALL REMAIN CLOSED DURING CONSTRUCTION. KEEP VALVES ON ALL WET TAPS CLOSED UNTIL CLEARED BY FDEP. DO NOT CONNECT NEWLY CONSTRUCTED WATER MAINS TO ANY EXISTING WATER MAINS UNLESS CLEARED BY FDEP AND OCU.
- THE CONTRACTOR SHALL PROVIDE A JUMPER ASSEMBLY WITH A BACKFLOW PREVENTER FOR MAKING TEMPORARY CONNECTIONS TO AN EXISTING POTABLE WATER SOURCE IN ORDER TO CHLORINATE AND FLUSH NEW WATER CONNECTIONS TO RECLAIMED WATER OF FORCEMAIN

- FOR PVC PIPE THAT WILL BE OWNED AND MAINTAINED BY OCU, NO PIPE BENDING IS ALLOWED. THE MAXIMUM ALLOWABLE TOLERANCE FOR JOINT DEFLECTION IS 0.75 DEGREES (3-INCHES PER JOINT PER 20FT STICK OF PIPE.) ALIGNMENT CHANGE SHALL BE MADE ONLY WITH SLEEVES AND FITTINGS.
- FOR NON-PVC PIPE THAT WILL BE OWNED AND MAINTAINED BY OCU, LONG RADIUS CURVES, EITHER HORIZONTAL OR VERTICAL, MAY BE INSTALLED WITH STANDARD PIPE BY DEFLECTIONS AT THE JOINTS. MAXIMUM DEFLECTIONS AT THE PIPE JOINTS, FITTINGS AND LAYING RADIUS FIR THE VARIOUS PIPE LENGTHS SHALL NOT EXCEED 75% OF THE PIPE MANUFACTURER'S RECOMMENDATION.



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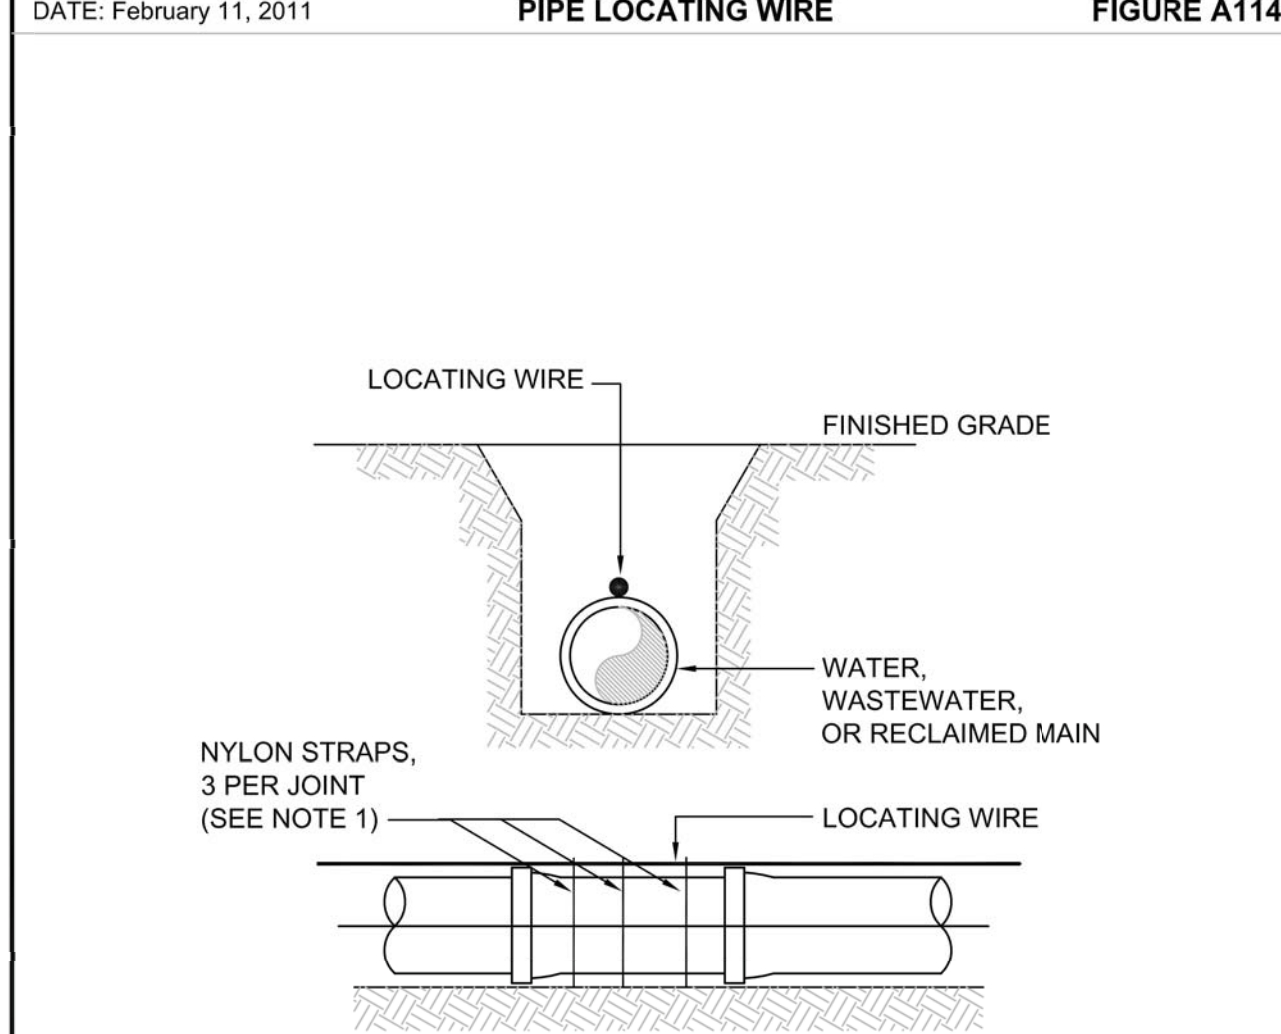
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 SHEET 14 of 34

APPENDIX A STANDARD DRAWINGS GENERAL
CHAIN LINK FENCE FIGURE A406



- NOTES:
1. TRUSS BARS ARE REQUIRED FOR EACH GATE SECTION AND THE FIRST SPAN ON EACH SIDE OF A CORNER POST ONLY.
2. PROVIDE CHAIN AND LOCK FOR SECURING GATE.
3. FENCING AND POSTS SHALL BE BLACK, VINYL CLAD.

APPENDIX A STANDARD DRAWINGS GENERAL
PIPE LOCATING WIRE FIGURE A114

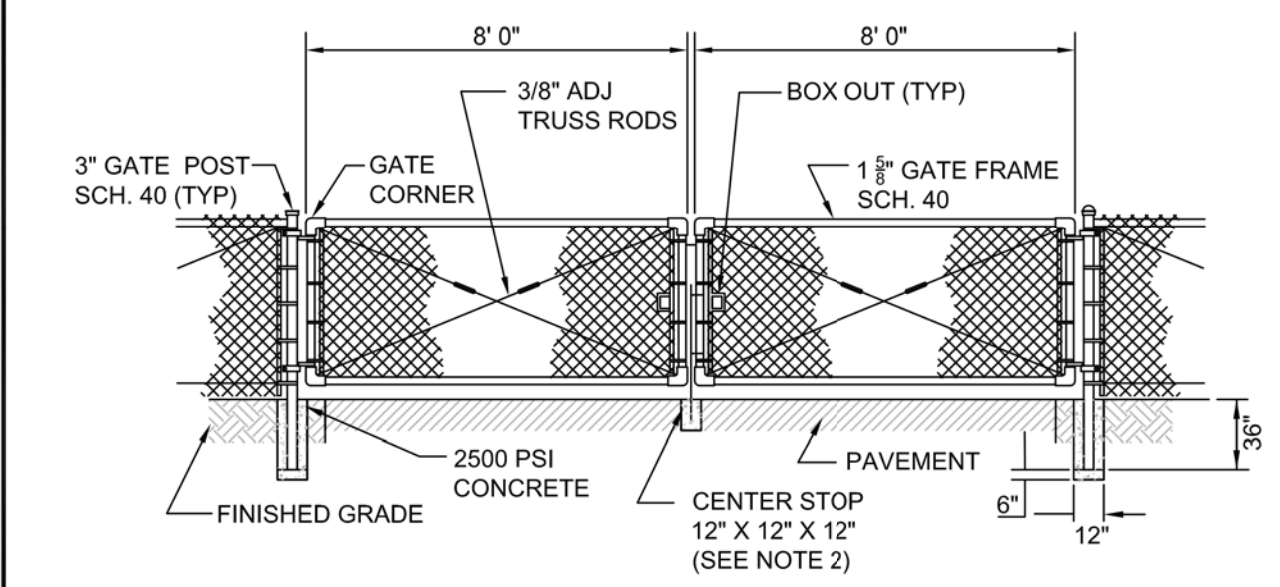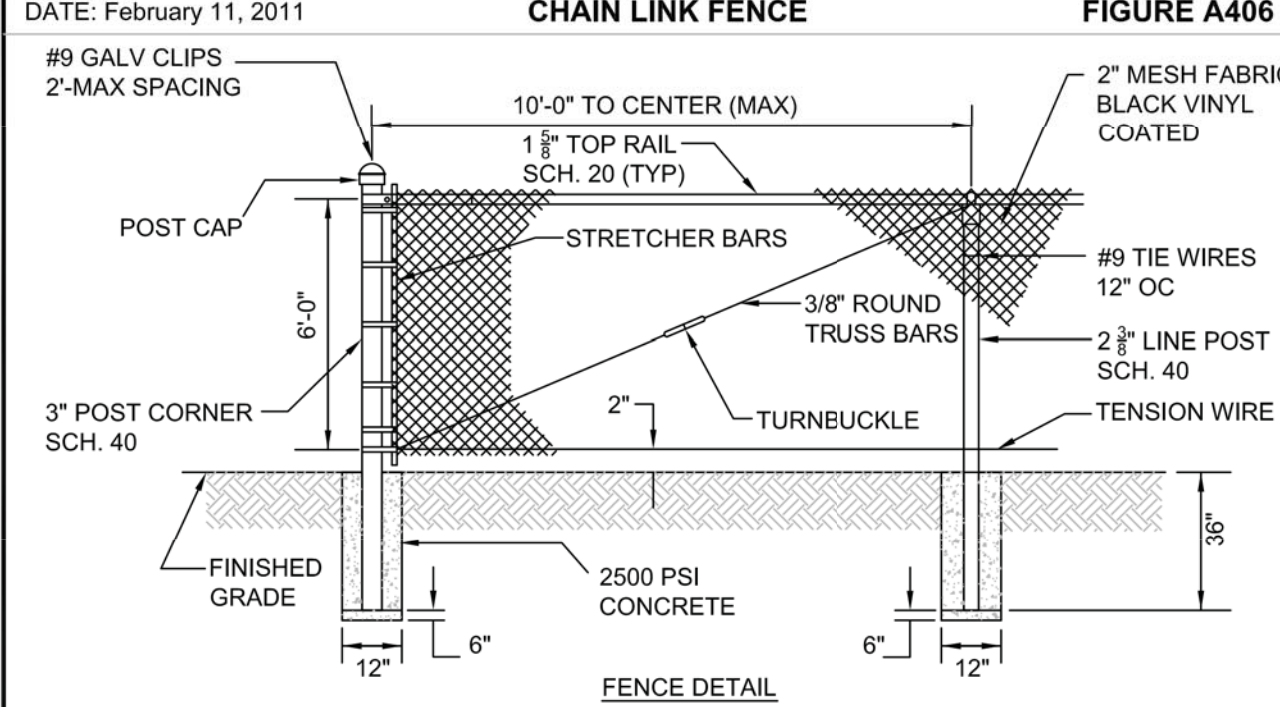


- NOTES:
1. ALL PIPE SHALL REQUIRE INSULATED LOCATING WIRE (10 GAUGE SOLID COPPER) CAPABLE OF DETECTION BY A CABLE LOCATOR AND SHALL BE WRAPPED WITH NYLON STRAPS TO TOP CENTERLINE OF THE PIPE.
2. LOCATING WIRE SHALL BE CONTINUOUS INSIDE VALVE BOXES AND SHALL EXTEND 12" ABOVE TOP OF COLLAR.
3. WIRE INSULATION SHALL BE COLOR CODED FOR THE TYPE OF PIPE BEING INSTALLED.

APPENDIX A STANDARD DRAWINGS GENERAL
SEPARATION REQUIREMENTS FOR WATER, WASTEWATER AND RECLAIMED WATER MAINS FIGURE A116

PROPOSED UTILITY	HORIZONTAL & VERTICAL SEPARATION REQUIREMENTS							
	POTABLE WATER		RECLAIMED WATER		WASTEWATER (GRAVITY & FM)		STORM SEWER	
	HORIZ	VERT	HORIZ	VERT	HORIZ	VERT	HORIZ	VERT
POTABLE WATER	3' NOTE 1	12"	3' NOTE 1 & 3	12" NOTE 3	6' NOTE 3	12" NOTE 3	3' NOTE 1 & 3	12'/18" NOTE 2 & 3
RECLAIMED WATER	3' NOTE 1 & 3	12" NOTE 3	3' NOTE 1	12"	3' NOTE 1	12"	3' NOTE 1	12'/18" NOTE 2
WASTEWATER (GRAVITY AND FM)	6' NOTE 3	12" NOTE 3	3' NOTE 1	12"	3' NOTE 1	12"	3' NOTE 1	12'/18" NOTE 2
RIGHT OF WAY	3' NOTE 1	N/A	3' NOTE 1	N/A	3' NOTE 1	N/A	N/A	N/A

- NOTES:
1. THIS SEPARATION REQUIREMENT IS TO PROVIDE ACCESSIBILITY FOR CONSTRUCTION AND MAINTENANCE. THREE FEET OF HORIZONTAL SEPARATION IS THE MINIMUM FOR PIPES WITH THREE FEET OF COVER. FOR PIPES INSTALLED AT GREATER DEPTHS, PROVIDE AN ADDITIONAL FOOT OF SEPARATION FOR EACH ADDITIONAL FOOT OF DEPTH.
2. THE 18-INCH SEPARATION REQUIREMENT APPLIES WHEN THE STORM PIPE CROSSES ABOVE THE OCU MAIN, AND WHEN THE STORM PIPE HAS A DIAMETER EQUAL TO OR GREATER THAN 24 INCHES. OTHERWISE, THE REQUIRED SEPARATION IS 12 INCHES.
3. THIS SEPARATION REQUIREMENT COMPLIES WITH MINIMUM FDEP SEPARATION REQUIREMENTS OUTLINED IN 62-555.314, FAC. VARIANCES FROM THE FDEP REQUIREMENTS MUST COMPLY WITH 62-555.314(5), FAC AND MUST BE APPROVED INDIVIDUALLY BY BOTH FDEP AND OCU.
4. DISTANCES GIVEN ARE FROM OUTSIDE OF PIPE TO OUTSIDE OF PIPE.
5. NO WATER PIPE SHALL PASS THROUGH OR COME IN CONTACT WITH ANY PART OF SANITARY OR STORM WATER MANHOLE OR STRUCTURE.

APPENDIX A STANDARD DRAWINGS GENERAL
MJ TAPPING SLEEVE AND GATE VALVE ASSEMBLY FOR WATER AND RECLAIMED WATER FIGURE A121-1

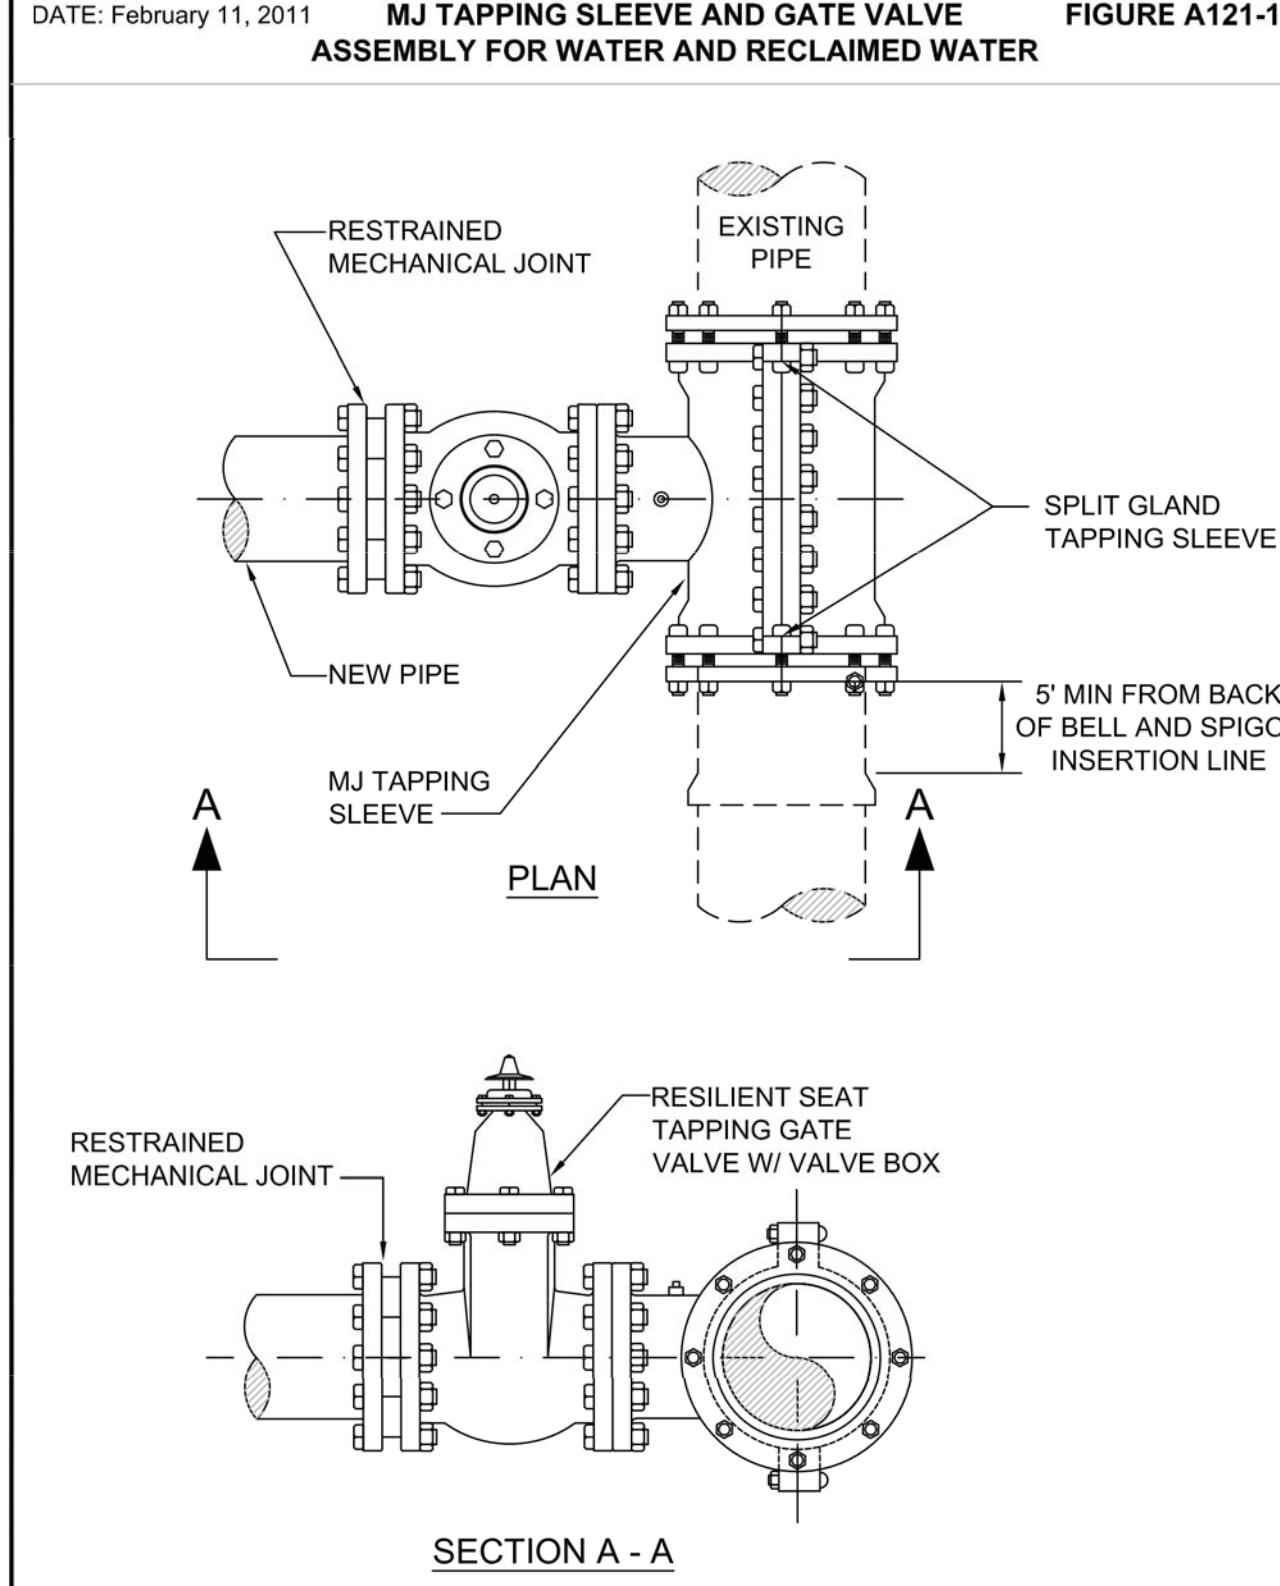



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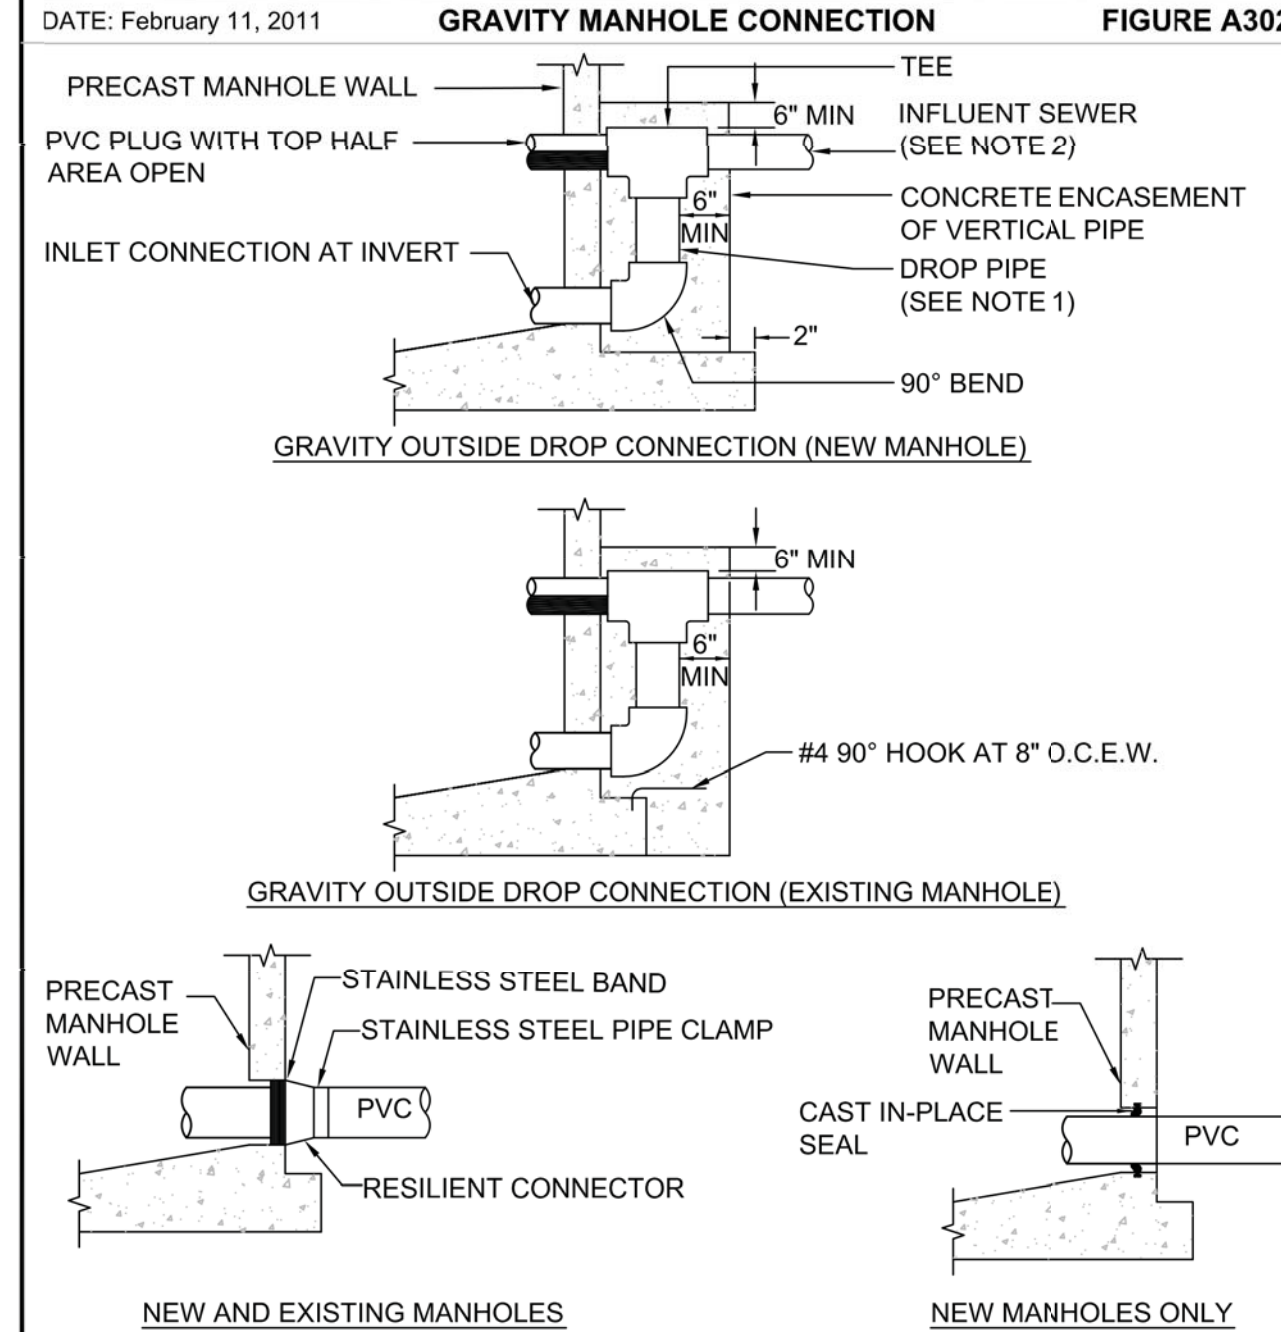
**PORTER TRANSFER STATION
SITE IMPROVEMENTS**

APPENDIX A STANDARD DRAWINGS GENERAL
MJ TAPPING SLEEVE AND GATE VALVE WITH PLUG VALVE FOR WASTEWATER FIGURE A121-2




- NOTES:
1. PLUG VALVES GREATER THAN 4" SHALL BE GEAR ACTUATED.
2. PLUG VALVE TO BE INSTALLED VERTICALLY, AND TAPPING GATE VALVE TO BE INSTALLED HORIZONTALLY AND ABANDONED IN THE OPEN POSITION.

APPENDIX A STANDARD DRAWINGS GENERAL
GRAVITY MANHOLE CONNECTION FIGURE A302

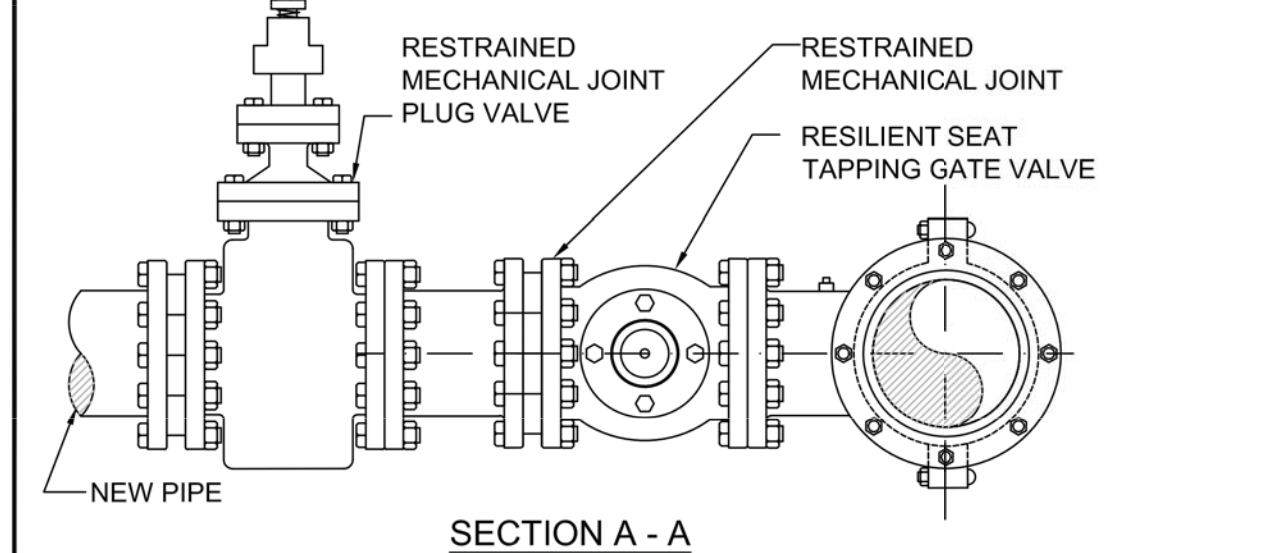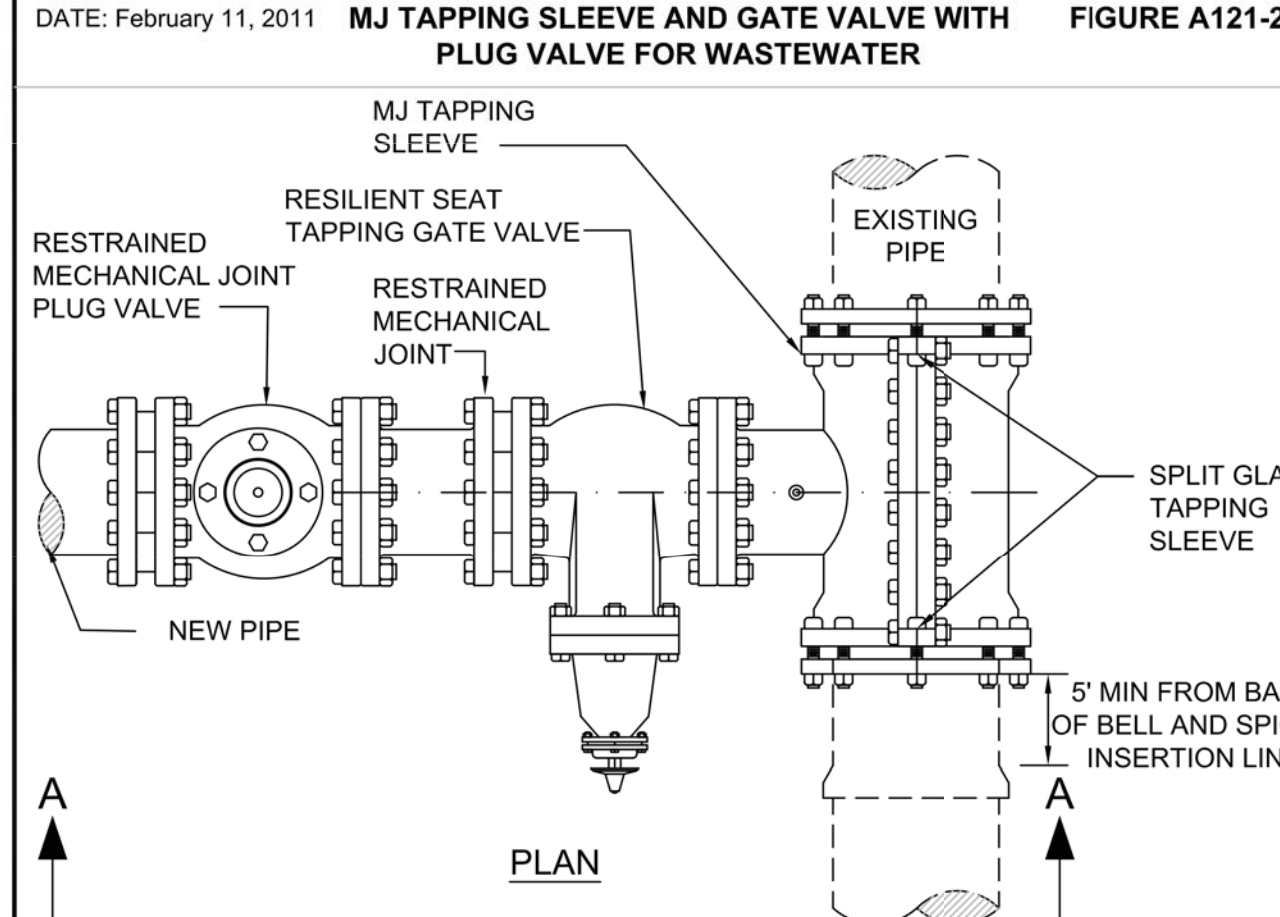


- NOTES:
1. DROP PIPE AND FITTINGS SHALL BE OF EQUAL SIZE AND MATERIAL AS THE INFLUENT SEWER.
2. AN OUTSIDE DROP CONNECTION SHALL BE REQUIRED FOR ALL INFLUENT LINES WHICH HAVE AN INVERT 2' OR MORE ABOVE THE MANHOLE INVERT.
3. CONTRACTOR TO COORDINATE THE PRESENCE OF UTILITIES INSPECTOR DURING CORING AND CONNECTIONS TO EXISTING MANHOLES.

APPENDIX A STANDARD DRAWINGS GENERAL
FORCE MAIN TO GRAVITY SEWER CONNECTION FIGURE A306

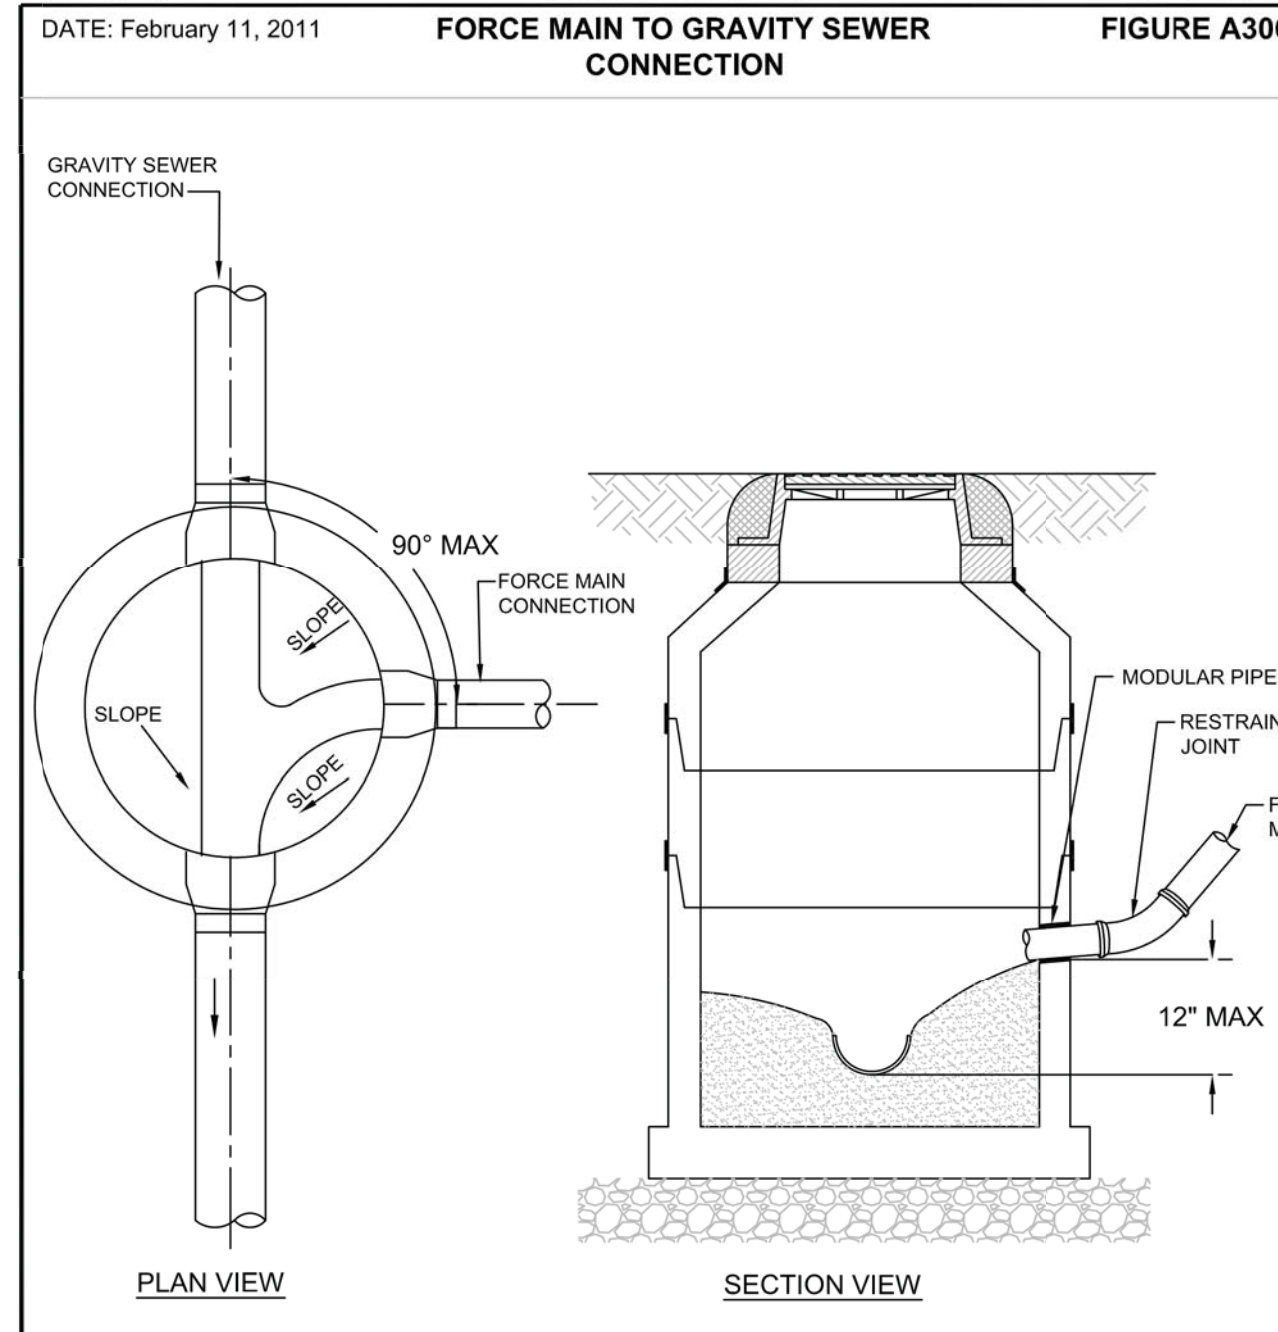

- NOTES:
1. FORCE MAIN ORIENTED TO FACILITATE FLOW AND SHALL ENTER MANHOLE WITHIN 1' ABOVE INVERT OF THE EFFLUENT PIPE.
2. BENCH AS REQUIRED FOR NEW FORCE MAIN.
3. MANHOLE RECEIVING FORCE MAIN AND NEXT MANHOLE SHALL BE LINED. FOR CONNECTIONS TO EXISTING MANHOLES, MANHOLE RECEIVING FORCE MAIN AND NEXT MANHOLE SHALL BE COATED OR LINED PER APPENDIX D.
4. CONTRACTOR TO COORDINATE THE PRESENCE OF UTILITIES INSPECTOR DURING CORING AND CONNECTIONS TO EXISTING MANHOLES.

APPENDIX A STANDARD DRAWINGS GENERAL
HOSE BIBB FIGURE A408

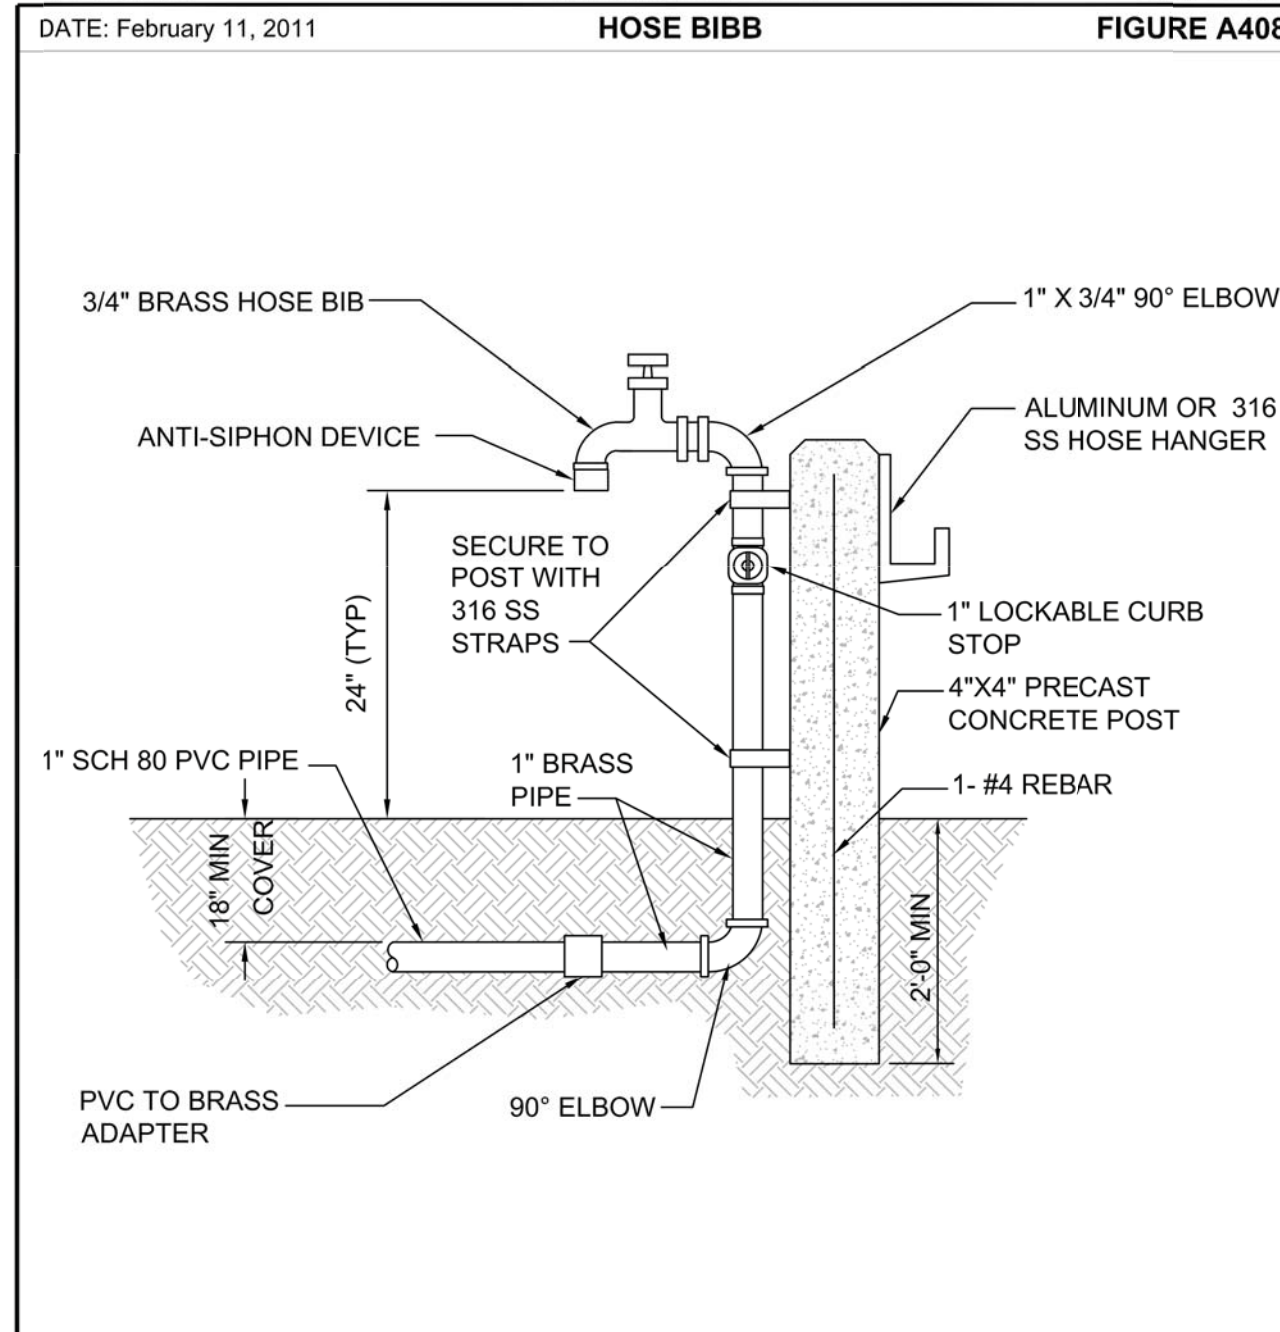

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**ORANGE COUNTY
SOLID WASTE DIVISION
ORLANDO, FLORIDA**

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DATE: 03/20/18 DES. BY: SRF APP. BY: SRF

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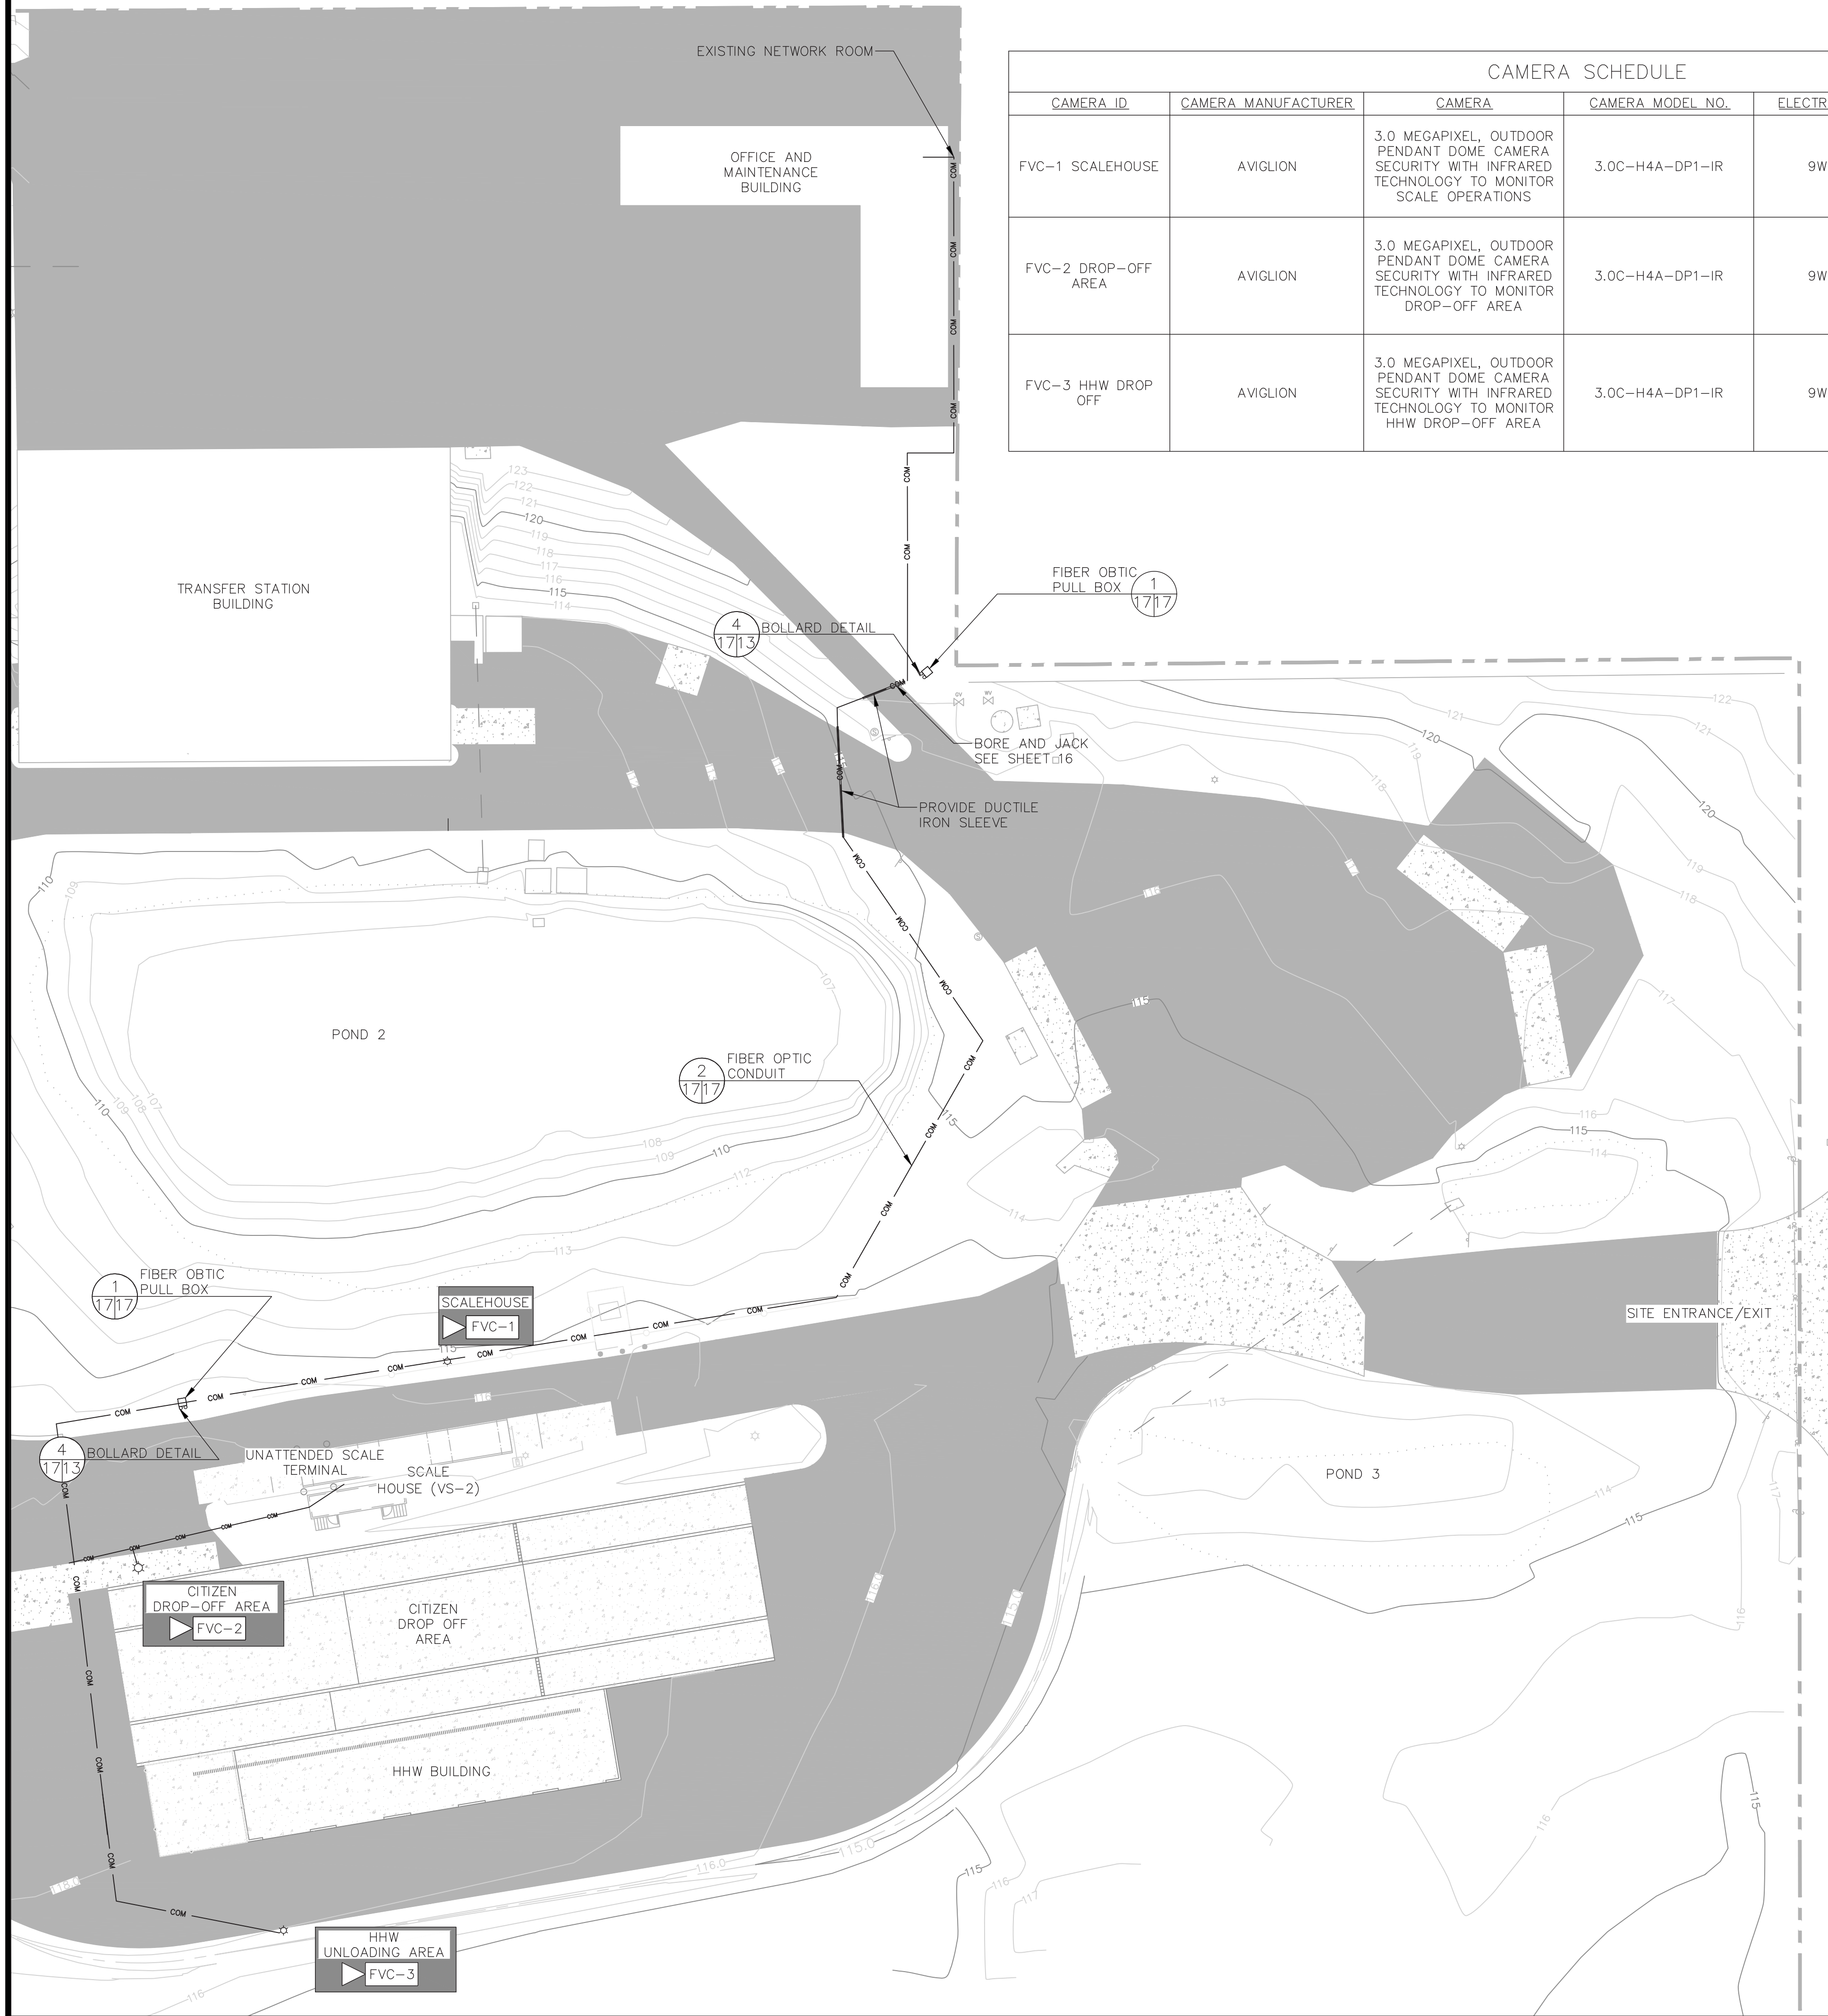
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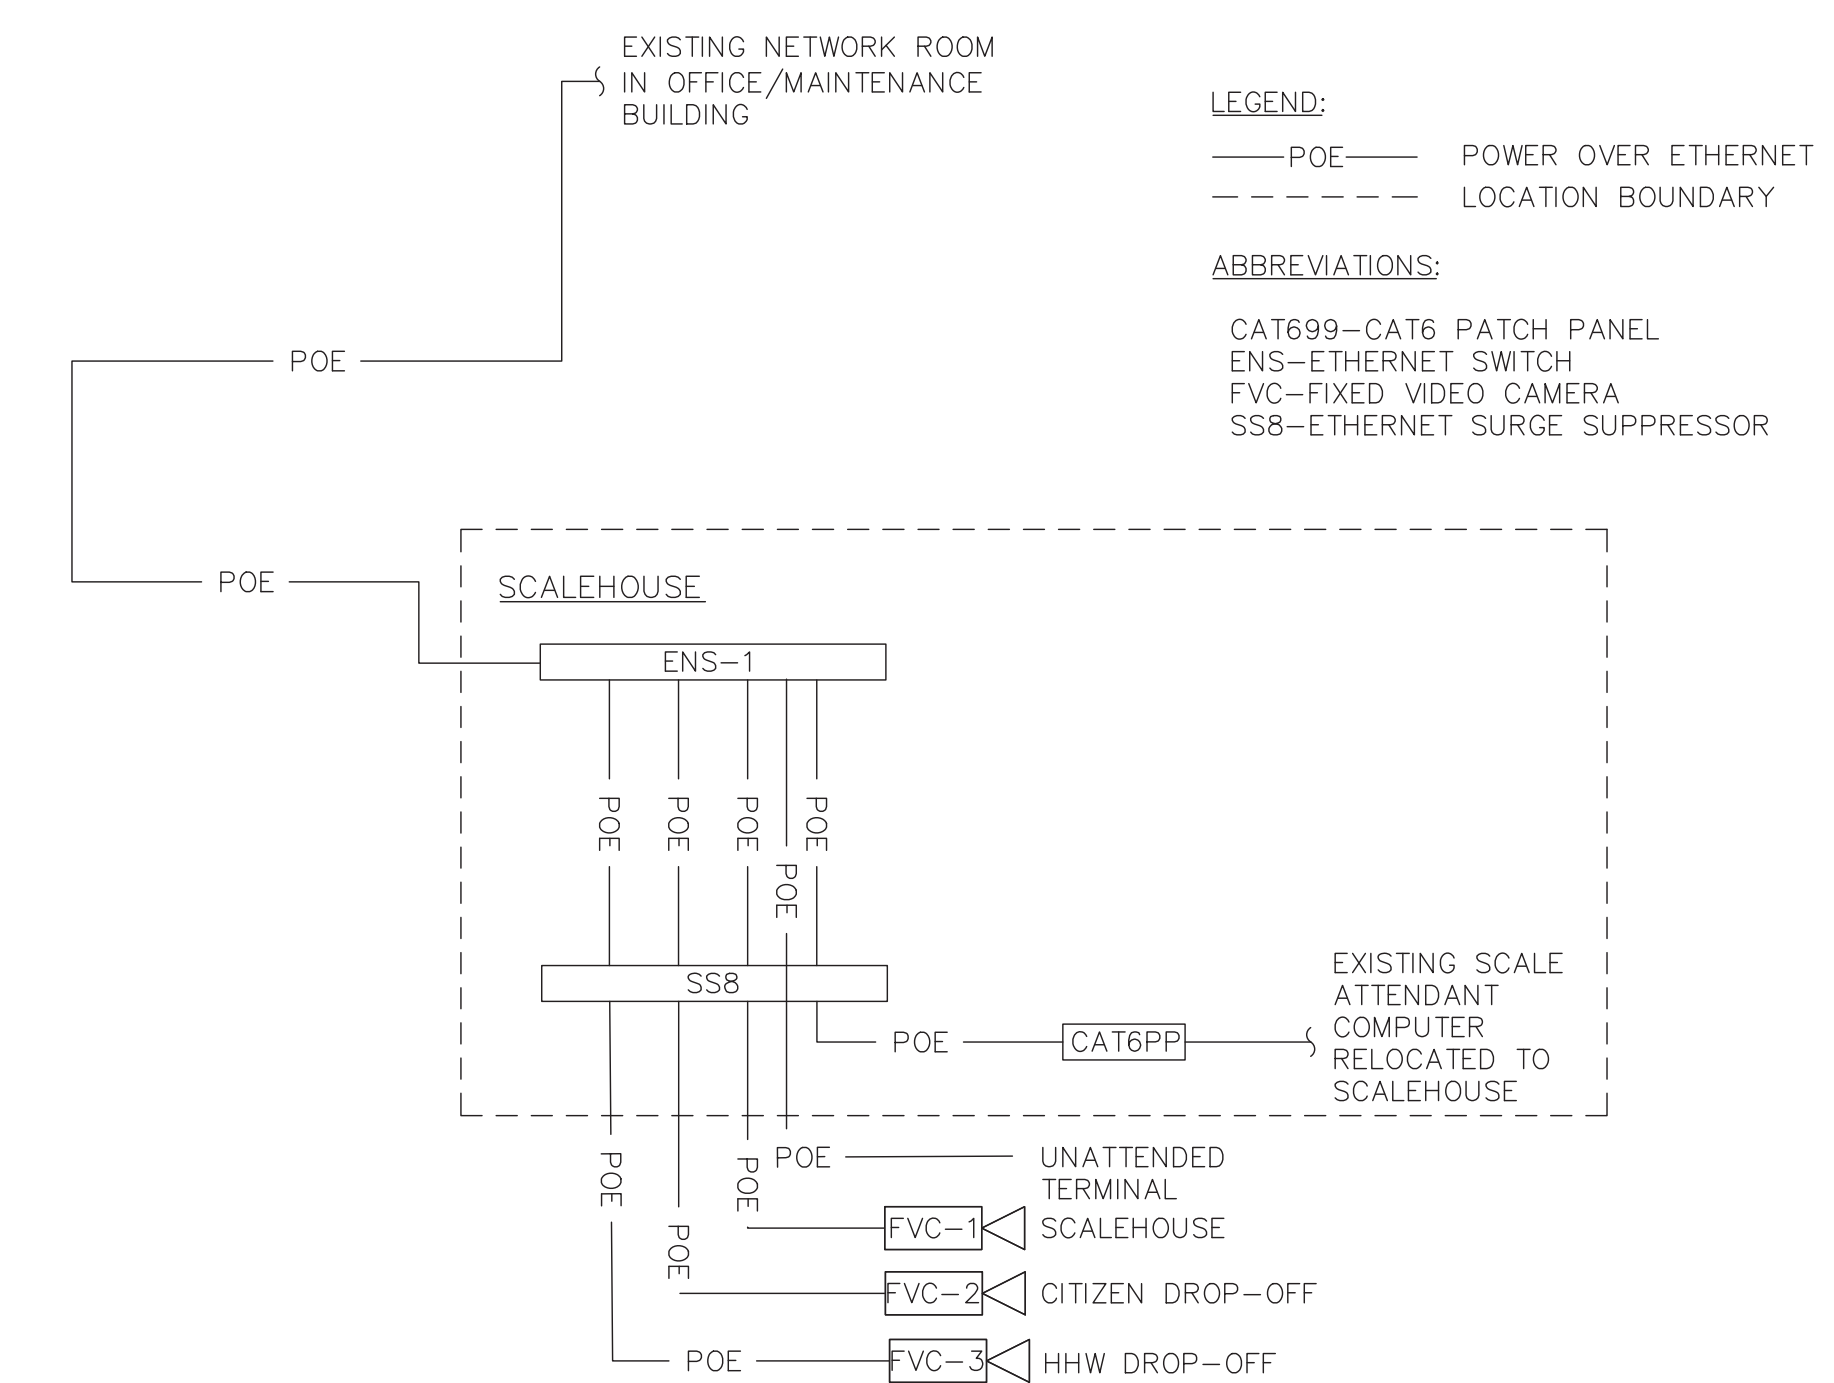
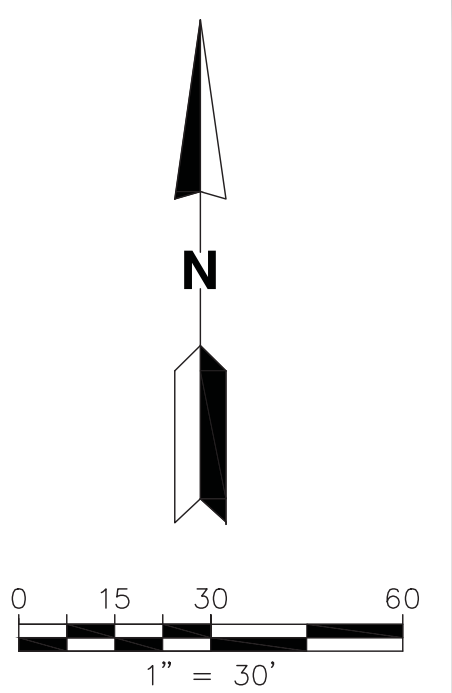
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CAMERA SCHEDULE					
CAMERA ID	CAMERA MANUFACTURER	CAMERA	CAMERA MODEL NO.	ELECTRICAL	MOUNTING DETAILS
FVC-1 SCALEHOUSE	AVIGLION	3.0 MEGAPIXEL, OUTDOOR PENDANT DOME CAMERA SECURITY WITH INFRARED TECHNOLOGY TO MONITOR SCALE OPERATIONS	3.0C-H4A-DP1-IR	9W	ATTACH TO NEW LIGHT POLE. MOUNT 12 FEET ABOVE FINISHED GRADE WITH MOUNTING BRACKET (H4-MT-POLE1), H4A-MT-NPTA PENDANT NPT MOUNT, WALL ARM MOUNT (H4A-M-WALL)
FVC-2 DROP-OFF AREA	AVIGLION	3.0 MEGAPIXEL, OUTDOOR PENDANT DOME CAMERA SECURITY WITH INFRARED TECHNOLOGY TO MONITOR DROP-OFF AREA	3.0C-H4A-DP1-IR	9W	ATTACH TO NEW LIGHT POLE. MOUNT 14 FEET ABOVE FINISHED GRADE TO MONITOR DROP-OFF AREA, WITH MOUNTING BRACKET (H4-MT-POLE1), H4A-MT-NPTA PENDANT NPT MOUNT, WALL ARM MOUNT (H4A-M-WALL)
FVC-3 HHW DROP OFF	AVIGLION	3.0 MEGAPIXEL, OUTDOOR PENDANT DOME CAMERA SECURITY WITH INFRARED TECHNOLOGY TO MONITOR HHW DROP-OFF AREA	3.0C-H4A-DP1-IR	9W	ATTACH TO NEW LIGHT POLE. MOUNT 12 FEET ABOVE FINISHED GRADE TO MONITOR BRACKET (H4-MT-POLE1), H4A-MT-NPTA PENDANT NPT MOUNT, WALL ARM MOUNT (H4A-M-WALL)

NOTES:


- THE CONTRACTOR OR SUBCONTRACTOR SHALL HAVE PRIOR EXPERIENCE WITH THIS VIDEO MANAGEMENT SYSTEM. THE COUNTY STANDARD IS AVIGLON IP CAMERAS AND AN AVIGLON NVR (NETWORK DEPENDENT).
- EACH CAMERA WILL BE FED BY INDIVIDUAL POWER OTHER ETHERNET (POE) CABLES FROM THE ELECTRICAL/SERVER ROOM IN THE EXISTING OFFICE/MAINTENANCE BUILDING.
- INSTALL CUB-IT CABINET INSIDE SCALEHOUSE TO INCLUDE VIDEO RECORDING EQUIPMENT, FIBER NETWORK SWITCHES, AND GROUNDING BAR.
- SYSTEMS SHALL CONFORM WITH ORANGE COUNTY INFORMATION TECHNOLOGY STANDARDS, MOST RECENT VERSION.
- A REGISTERED COMMUNICATIONS SYSTEM DESIGNER (RCDD) SHALL SUBMIT THE FOLLOWING TO THE ENGINEER AND ORANGE COUNTY INFORMATION SYSTEMS AND SERVICES DIVISION 30 DAYS PRIOR TO INSTALLATION OF THE COMMUNICATIONS SYSTEMS:
 - EQUIPMENT.
 - CONSTRUCTION METHODS.
 - TESTING AND QUALITY CONTROL PROCEDURES.
 - SITE LAYOUT.
 - MANUFACTURERS' INSTALLATION, OPERATION AND MAINTENANCE MANUALS.
- SUBMIT AN AS-BUILT BLOCK DIAGRAM, CONDUIT LAYOUT, AND NETWORK TEST RESULTS TO THE ENGINEER AND ORANGE COUNTY INFORMATION SYSTEMS AND SERVICES DIVISION FOR REVIEW FOLLOWING INSTALLATION AND START-UP.




LEGEND:
 — POE — POWER OVER ETHERNET
 - - - - - LOCATION BOUNDARY

ABBREVIATIONS:
 CAT699-CAT6 PATCH PANEL
 ENS-ETHERNET SWITCH
 FVC-FIXED VIDEO CAMERA
 SS8-ETHERNET SURGE SUPPRESSOR

SITE BLOCK DIAGRAM

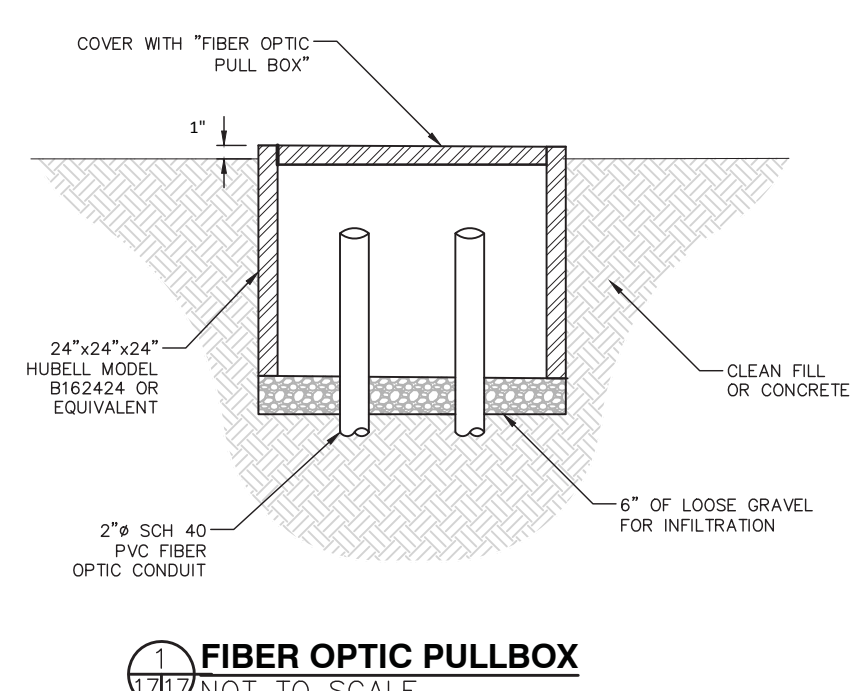

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 DATE: 3/20/18

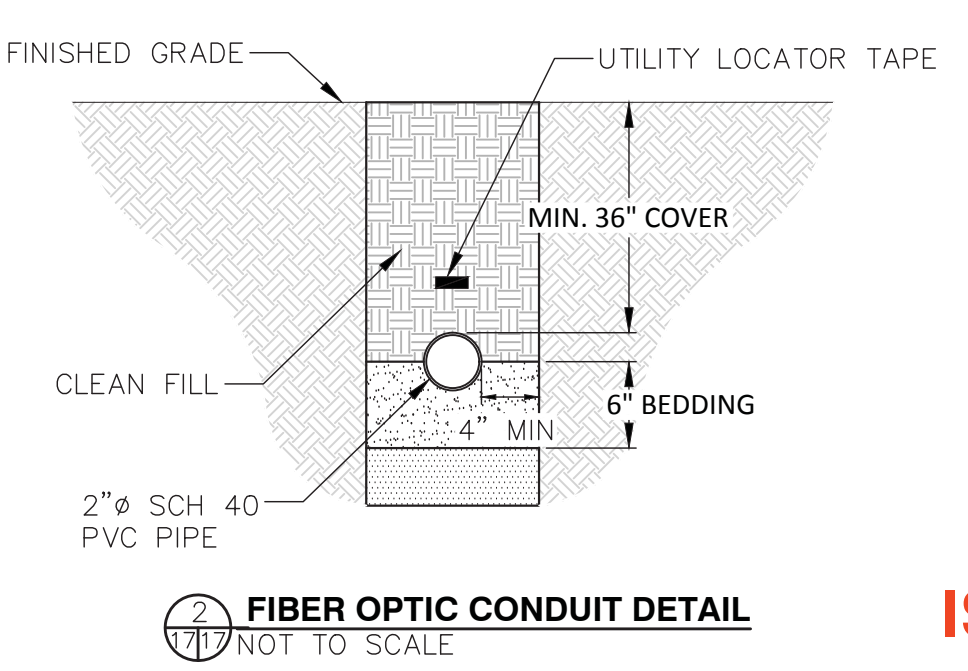David Beben PE No. 73005 Florida Digitally signed by David Beben PE No. 73005 Florida Date: 2018.03.20 14:45:09 -0400	
CHK. BY	
DESCRIPTION	
DATE	
REV	
COMMUNICATIONS PLAN PORTER TRANSFER STATION SITE IMPROVEMENTS	
SHEET TITLE COMMUNICATIONS PLAN	
PROJECT TITLE PORTER TRANSFER STATION SITE IMPROVEMENTS	
CLIENT ORANGE COUNTY SOLID WASTE DIVISION ORLANDO, FLORIDA	
SCS ENGINEERS STEARNS, CONRAD AND SCHMIDT CONSULTING ENGINEERS 5850 SOUTH SEMORAN BLVD, ORLANDO, FLORIDA 32822 PH (407) 204-3231 FAX NO. (813) 623-4757 FLORIDA CERTIFICATE OF AUTHORIZATION NO. 00004892 REG. NO. 09216054.01 DWM BY: KKC C/A BY: SAT/CAJ DES. BY: SRF CHK. BY: SRF APP. BY: SRF	
CADD FILE: 05401COMM	
DATE: MARCH 2018	
SCALE: AS SHOWN	
DRAWING NO. 18	
SHEET 18 of 34	

DEFERRED SUBMITTAL (WHEN ITEMS ARE REQUIRED BY PROJECT SCOPE):

- A. STEEL STAIRS - REFER TO NOTE K OF STRUCTURAL STEEL NOTES.
- B. COLD FORMED STEEL FRAMING - REFER TO NOTE D OF COLD FORMED STEEL FRAMING NOTES.
- C. HANDRAILS SHALL BE DESIGNED BY FABRICATOR'S SPECIALTY ENGINEER. SHOP DRAWINGS AND CALCULATIONS SHALL BE SUBMITTED FOR REVIEW AND MUST BE SIGNED, DATED AND SEALED BY A STRUCTURAL ENGINEER REGISTERED IN FLORIDA.
- D. ALUMINUM AWNINGS, WALKWAY CANOPIES AND THEIR FOUNDATIONS SHALL BE DESIGNED BY THE ALUMINUM CANOPY MANUFACTURER SPECIALTY ENGINEER. SHOP DRAWINGS AND CALCULATIONS SHALL BE SUBMITTED FOR REVIEW AND MUST BE SIGNED, DATED AND SEALED BY AN ENGINEER REGISTERED IN FLORIDA.
- E. PROVIDE ENGINEERING SUBMITTAL SIGNED, DATED AND SEALED FOR ALL MECHANICAL, ELECTRICAL, AND PLUMBING SUPPORT OR ATTACHMENTS NOT INCLUDED WITHIN THE CONSTRUCTION DOCUMENTS THAT REQUIRE ANYTHING OTHER THAN STANDARD MANUFACTURER'S STANDARD HARDWARE OR ARE EXPOSED TO WIND LOADS. EXAMPLES OF ITEMS BUT NOT LIMITED TO ARE KITCHEN HOOD EXHAUST FAN, ROOF EXHAUST FAN, AND GRAVITY VENTS.

SHOP DRAWINGS

- A. THE GENERAL CONTRACTOR SHALL SUBMIT FOR ENGINEER REVIEW SHOP DRAWINGS FOR THE FOLLOWING ITEMS:
 STRUCTURAL STEEL (**)
 REINFORCING STEEL
 ROOF METAL DECK
 CONCRETE MIX DESIGN
 COLD FORMED METAL FRAMING (*)
 STEEL STAIRS (*)
 SLAB ON GRADE CONTROL JOINTS PLAN

ITEMS MARKED (*) SHALL HAVE SHOP DRAWINGS SEALED BY A PROFESSIONAL ENGINEER REGISTERED IN THE STATE OF FLORIDA.

ITEMS MARKED (**) THE SHOP DRAWINGS FOR ALL STEEL CONNECTIONS AS INDICATED IN THE CONSTRUCTION DOCUMENTS SHALL BE PREPARED UNDER THE DIRECT SUPERVISION OF A PROFESSIONAL ENGINEER, REGISTERED IN THE STATE THAT THE PROJECT IS LOCATED, EMPLOYED BY THE FABRICATOR. THE SHOP DRAWINGS SHALL SHOW COMPLETE DETAILS OF THE ASSEMBLED JOINT WITH ALL BOLTS AND WELDS REQUIRED. WHERE THE CONNECTIONS ARE DETAILED IN THE CONSTRUCTION DOCUMENTS BY THE ENGINEER OF RECORD OR WHERE PRE-DESIGNED CONNECTIONS ARE TAKEN DIRECTLY FROM TABLES IN THE AISC MANUAL, CALCULATIONS NEED NOT BE SUBMITTED PROVIDED THE JOB DESIGN CONNECTIONS PRECISELY MATCH THOSE ASSUMED IN THE TABLE, ALL STEEL SHOP DRAWINGS AND THE DESIGN CALCULATIONS FOR THE CONNECTIONS THAT ARE NOT DESIGNED BY THE ENGINEER OF RECORD SHALL BE SIGNED AND SEALED BY THE FABRICATOR'S REGISTERED PROFESSIONAL ENGINEER. SHOP DRAWINGS SUBMITTED THAT ARE NOT IN COMPLIANCE WITH THE ABOVE REQUIREMENTS WILL NOT BE APPROVED.



FL CERTIFICATE OF AUTHORIZATION #29116
 235 S. MAITLAND AVE
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 MAITLAND FL 32751
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 WWW.PREMIER-STRUCTURAL.COM

Kharl Rodriguez

Digitally signed by Kharl Rodriguez
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 serialNumber=36rhx83kxpbr8c6n
 pqyx8lgkcl6, c=US, st=Florida,
 l=Maitland, o=Kharl A. Rodriguez,
 P.E., cn=Kharl Rodriguez
 Date: 2018.03.19 20:23:57 -04'00'


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CHK. BY		DESCRIPTION		DATE		REV	
SHEET TITLE				STRUCTURAL GENERAL NOTES			
PROJECT TITLE				PORTER TRANSFER STATION SITE IMPROVEMENTS			
CLIENT				ORANGE COUNTY SOLID WASTE DIVISION ORLANDO, FLORIDA			
SCS ENGINEERS		STEARN, CONRAD AND SCHMIDT		CONSULTING ENGINEERS		4041 PARK OAKS BLVD, SUITE 100, TAMPA, FL 33610 PH (813) 621-0080 FAX NO. (813) 623-6757 FLORIDA CERTIFICATE OF AUTHORIZATION NO. 00004892	
PROJ. NO. 08216054.01	DWN. BY: SZF	O/A. BY: KAR	CHK. BY: KAR	APP. BY: KAR			
CADD FILE:							
DATE: MARCH 2018							
SCALE: AS SHOWN							
DRAWING NO. S3							
SHEET 20 of 34							

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STRUCTURAL ABBREVIATIONS

ABBREV.	ABBREVIATION	LT. WT.	LIGHT WEIGHT
ADD.	ADDITIVE	LG.	LONG
ADD'L	ADDITIONAL	LLH	LONG LEG HORIZONTAL
ALT.	ALTERNATE/ALTERNATIVE	LLV	LONG LEG VERTICAL
ALUM.	ALUMINUM	MID.	MIDDLE
A.C.I.	AMERICAN CONCRETE INSTITUTE	MFR.	MANUFACTURE/MANUFACTURER
A.I.S.C.	AMERICAN INSTITUTE OF STEEL CONSTRUCTION	M.B.	MASONRY BEAM, MACHINE BOLT
A.I.S.I.	AMERICAN IRON AND STEEL INSTITUTE	M.O.	MASONRY OPENING
A.S.T.M.	AMERICAN SOCIETY OF TESTING MATERIALS	MATL.	MATERIAL
A.W.S.	AMERICAN WELDING SOCIETY	MAX.	MAXIMUM
A.B.	ANCHOR BOLTS	MECH.	MECHANICAL
ARCH.	ARCHITECTURE/ARCHITECTURAL	MIN.	MINIMUM
ASPH.	ASPHALT	MISC.	MISCELLANEOUS
B.P.	BASE PLATE	MPH.	MILES PER HOUR
BM.	BEAM	MTL.	METAL
BRG.	BEARING	N.S.	NEAR SIDE
B.M.	BENCH MARK	N.I.C.	NOT IN CONTRACT
BIT.	BITUMINOUS, BITUMASTIC	N.T.S.	NOT TO SCALE
BLK.	BLOCK	NO., #	NUMBER
B/	BOTTOM OF	O.C.	ON CENTER
BLDG.	BUILDING	OPNG.	OPENING
B.U.	BUILT-UP	O.F.	OUTSIDE FACE
BTWN	BETWEEN	O.D.	OUTSIDE DIAMETER
BOT	BOTTOM	PEN	PENETRATION
CIP	CAST IN PLACE	PCF	POUNDS PER CUBIC FEET
C.I.	CAST-IRON	PAR.	PARALLEL
C.S.	CAST-STEEL	P.J.F.	PREMOLDED BITUMINOUS JOINT FILLER
CTR	CENTER	PLY.	PLYWOOD
CLR.	CLEAR/CLEARANCE	PLF.	POUNDS PER LINEAR FOOT
COL.	COLUMN	P.S.F.	POUNDS PER SQUARE FOOT
CONC.	CONCRETE	P.S.I.	POUNDS PER SQUARE INCH
C.B.	CONCRETE BEAM	P.C.	PRECAST CONCRETE
CC	CONCRETE COLUMN	PREFAB.	PREFABRICATED
C.M.	CONCRETE MASONRY	P.T.	PRESSURE TREATED
CMU	CONCRETE MASONRY UNIT	REF.	REFERENCE
COORD.	COORDINATE	REINF.	REINFORCING
CONT.	CONTINUOUS	R.C.P.	REINFORCED CONCRETE PIPE
CONN.	CONNECTION	REQD.	REQUIRED
CONST.	CONSTRUCTION	R.W.	RETAINING WALL
C.J.	CONSTRUCTION/CONTRACTION JOINT	R.D.	ROOF DRAIN
C.F.	CUBIC FEET (FOOT)	SCHED.	SCHEDULE
C.Y.	CUBIC YARD	SPC.	SPACE/SPACES
DBA	DEFORMED BAR ANCHOR	SPECS.	SPECIFICATIONS
DEPT.	DEPARTMENT	SQ.	SQUARE
DIM.	DIMENSION	S.S.	STAINLESS STEEL
DIST.	DISTANCE	STD.	STANDARD
DN.	DOWN	STL.	STEEL
DR.	DRAIN	SYM.	SYMMETRICAL
DWG.	DRAWING	STRUCT	STRUCTURAL
DIAG	DIAGONAL	SPCG	SPACING
DTL	DETAIL	SIM	SIMILAR
EA.	EACH	STIFF	STIFFENER
E.E.	EACH END	TEMP.	TEMPERATURE
E.F.	EACH FACE	TENS.	TENSION
E.S.	EACH SIDE	THK.	THICK
E.W.	EACH WAY	THD.	THREAD/THREADED
ELEC.	ELECTRIC/ELECTRICAL	T.B.	TIE BEAM
EL.,ELEV.	ELEVATION, ELEVATOR	TOL.	TOLERANCE
ENGR.	ENGINEER	T&B	TOP AND BOTTOM
EQ. SP.	EQUAL SPACED	T/	TOP OF
EXIST.	EXISTING	TDS.	TURN DOWN SLAB
EXP.	EXPANSION	TYP.	TYPICAL
EXT.	EXTERIOR	TS	TUBE STEEL
F.S.	FAR SIDE	U.N.O.	UNLESS NOTED OTHERWISE
FT.	FEET/FOOT	VERT.	VERTICAL
FDN.	FOUNDATION	VOL.	VOLUME
FIN.	FINISH	WF.	WALL FOOTING
FIN. GR.	FINISH GRADE	WFE.	WALL FOOTING EXTENSION
F.F.	FINISHED FLOOR	WP.	WATERPROOF
FLR.	FLOOR	W.S.	WELDED STUD
F.D.	FLOOR DRAIN	W.W.F.	WELDED WIRE FABRIC
FTG.	FOOTING	W.H.	WEEP HOLE
F.P.	FULL PENETRATION WELD	WT.	WEIGHT, STRUCTURAL TEE SECTION
GA.	GAGE/GAUGE	W	WIDE FLANGE SECTION
GALV.	GALVANIZED	W/	WITH
G.C.	GENERAL CONTRACTOR	W/O	WITHOUT
GEN.	GENERAL	WD.	WOOD
G.S.	GALVANIZED STEEL	W.P.	WORKING POINT
G.L.	GRID LINE	@	AT
HORZ.	HORIZONTAL	#	POUNDS
HSA	HEADED STUD ANCHOR	K	KIP (1,000 LBS)
HT.	HEIGHT	;	PLUS OR MINUS
H.S.B.	HIGH STRENGTH BOLT	W	WIDE FLANGE
IN.	INCH	C	CHANNEL
I.D.	INSIDE DIAMETER	L	ANGLE
INT.	INTERIOR	TS	TUBE STEEL
INV.	INVERT	WT	TEE SECTION
I.F.	INSIDE FACE	CL	CENTER LINE
JT.	JOINT	PL	PLATE
JST.	JOIST	~	DIAMETER
KWY.	KEYWAY	&	AND
LDG.	LANDING	Sp	SECTION MODULUS
LGTH.	LENGTH	Ip	MOMENT OF INERTIA



a (ft)	Vult (mph)	A (SF)	ZONE 1 (psf)	ZONE 2 (psf)	ZONE 3 (psf)	ZONE 4 (psf)	ZONE 5 (psf)
5'-0"	140	<10	10.0 -47.2	10.0 -74.1	10.0 -74.1	32.3 -32.3	32.3 -59.1
5'-0"	140	20	10.0 -44.5	10.0 -70.0	10.0 -70.0	32.3 -32.3	32.3 -59.1
5'-0"	140	50	10.0 -41.0	10.0 -65.5	10.0 -65.5	29.7 -30.6	29.7 -52.3
5'-0"	140	100	10.0 -38.4	10.0 -61.8	10.0 -61.8	27.8 -26.3	27.8 -47.2
5'-0"	140	200	10.0 -35.8	10.0 -58.1	10.0 -58.1	25.8 -28.0	25.8 -42.0
5'-0"	140	>500	10.0 -32.3	10.0 -53.2	10.0 -53.2	23.3 -26.3	23.3 -35.2

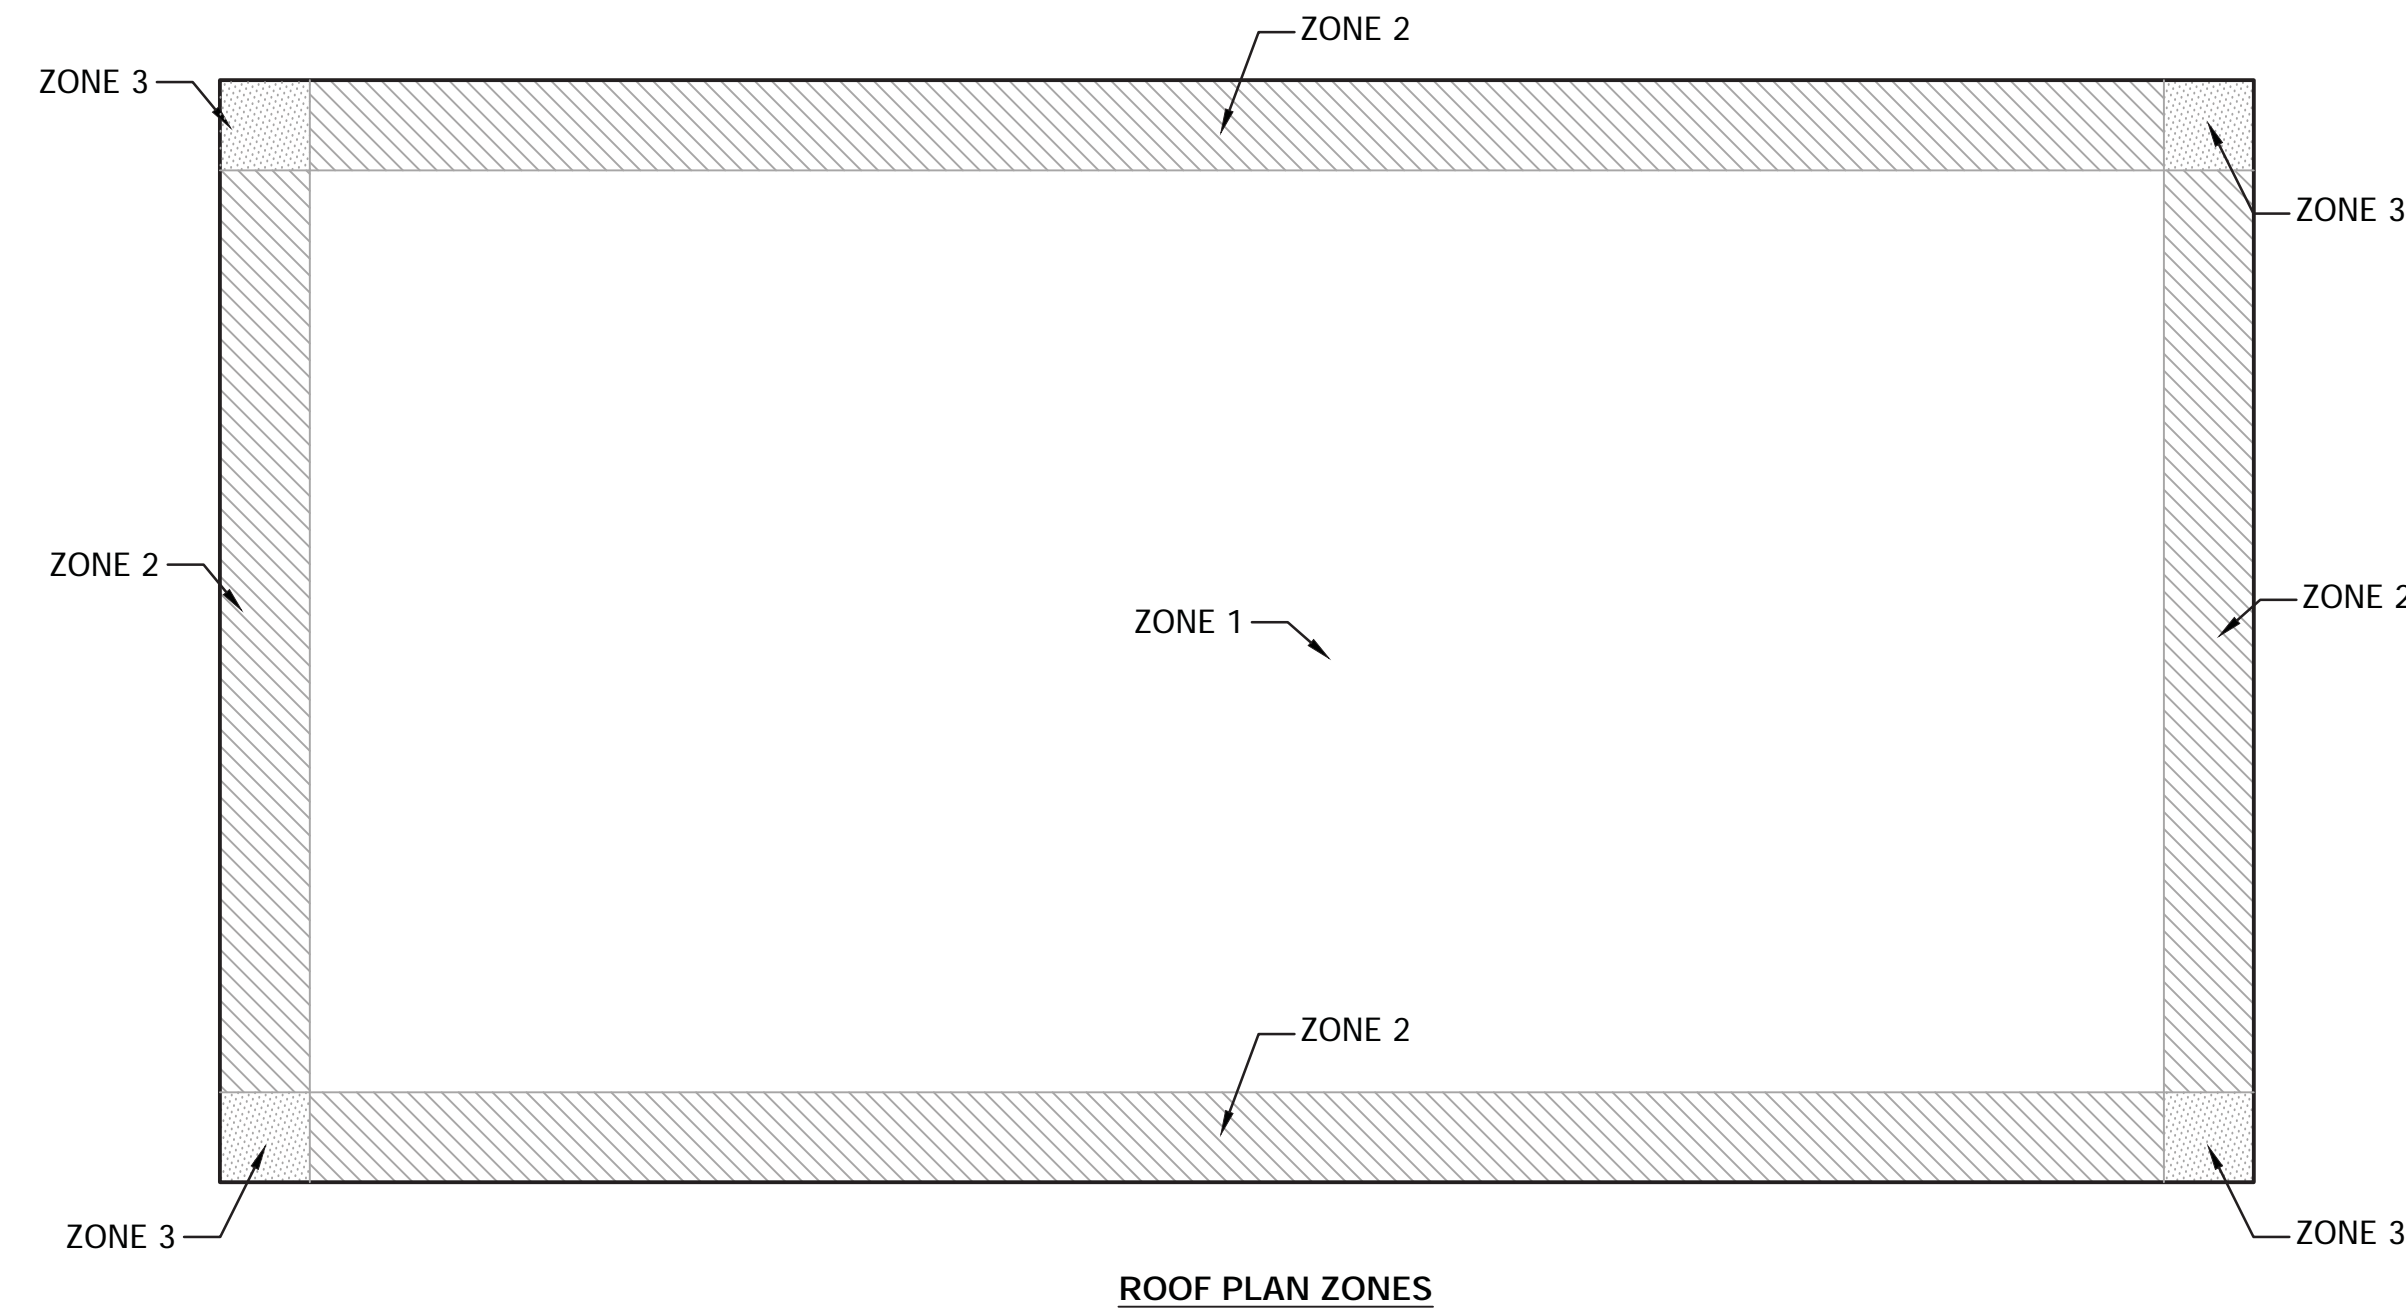Values shown above are gross value allowable stress design (ASD) pressures.



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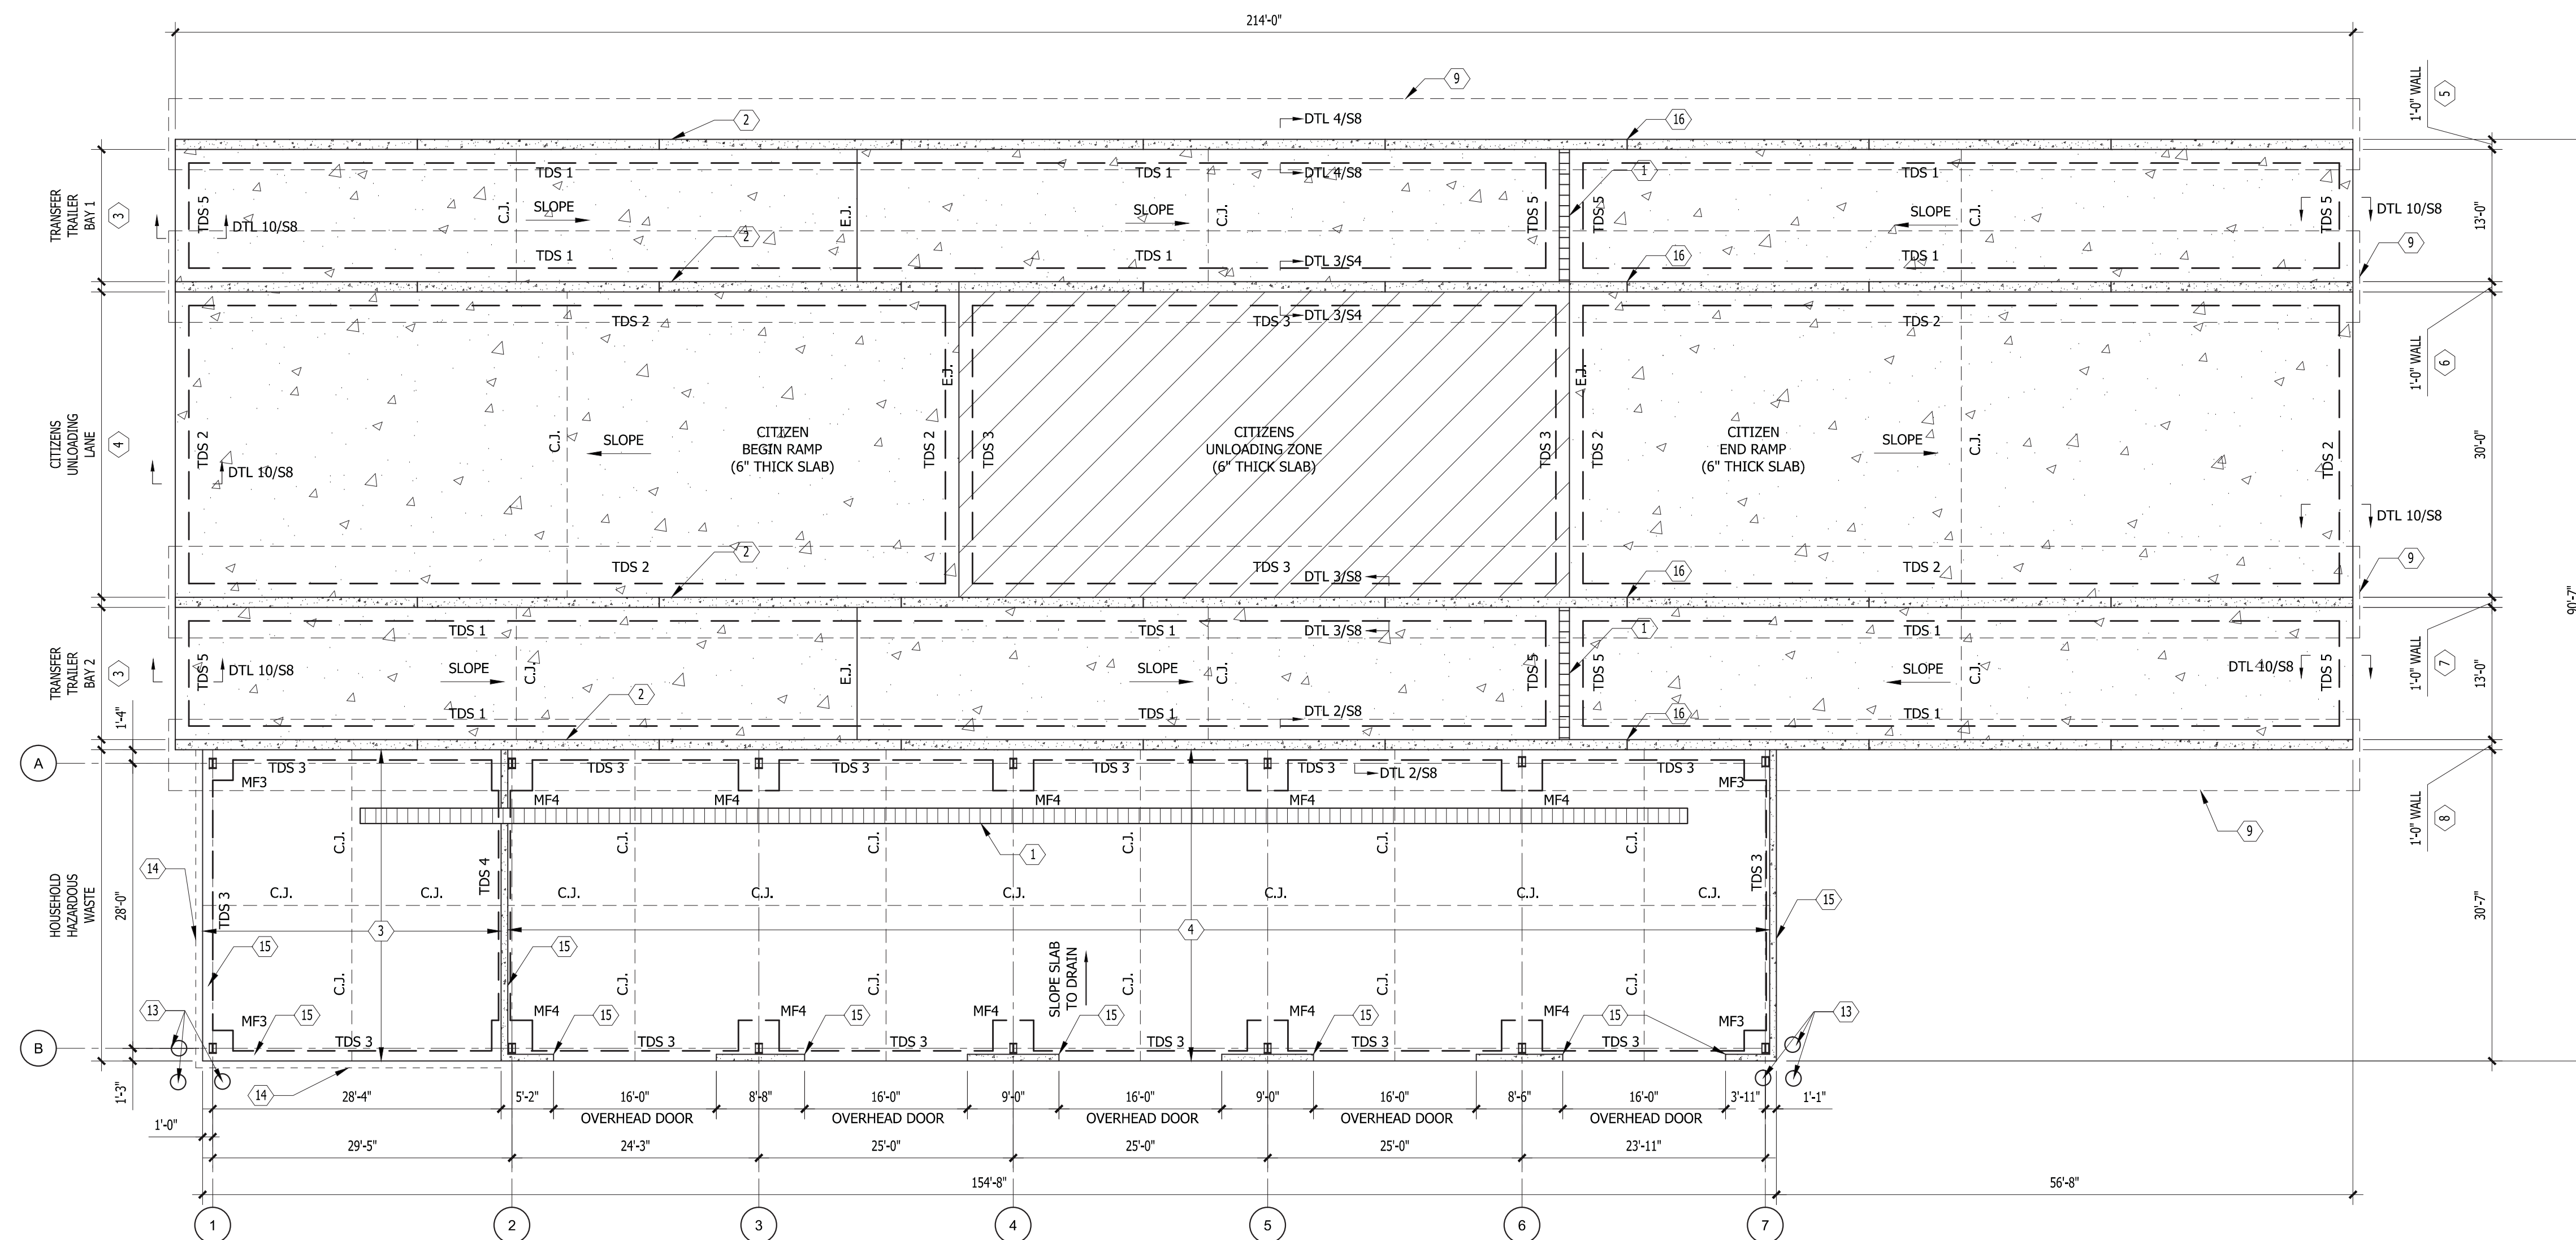
Khari Rodriguez
 Digitally signed by Khari Rodriguez
 DN: serialNumber=36rhx83kxpbr8c6npqyx8lgkcl6, c=US, st=Florida, l=Maitland, o=Khari A. Rodriguez, P.E., cn=Khari Rodriguez
 Date: 2018.03.19 20:24:25 -04'00'

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CHK. BY		DESCRIPTION		DATE		REV	
STRUCTURAL GENERAL NOTES		PORTER TRANSFER STATION SITE IMPROVEMENTS					
ORANGE COUNTY SOLID WASTE DIVISION		ORLANDO, FLORIDA					
CLIENT: SCS ENGINEERS STEARNS, CONRAD AND SCHMIDT CONSULTING ENGINEERS 4041 PARK OAKS BLVD, SUITE 100, TAMPA, FL 33610 PH (813) 621-0080 FAX NO. (813) 623-6757 FLORIDA CERTIFICATE OF AUTHORIZATION NO. 00004892 PROJ. NO. 09216054.01 DWG. BY: SZF CHK. BY: KAR APP. BY: KAR							
CADD FILE:							
DATE: MARCH 2018							
SCALE: AS SHOWN							
DRAWING NO. S4							
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SHEET 21 of 34							


KHARL A. RODRIGUEZ, PE
LICENSE NO. 60239

P:\Premier\2017\Blue_Martin\Porter\Struct\Drop Off AREA\Ino-9.dwg Mar 19, 2018 - 7:59pm Layout Name: S5 - CITIZEN DROP OFF & NEW HHW FOUNDATIONSLAB PLAN By: PremierStructural 1



NEW HHW AND CITIZEN DROP-OFF FOUNDATION/SLAB PLAN

SCALE: 3/32" = 1'-0"

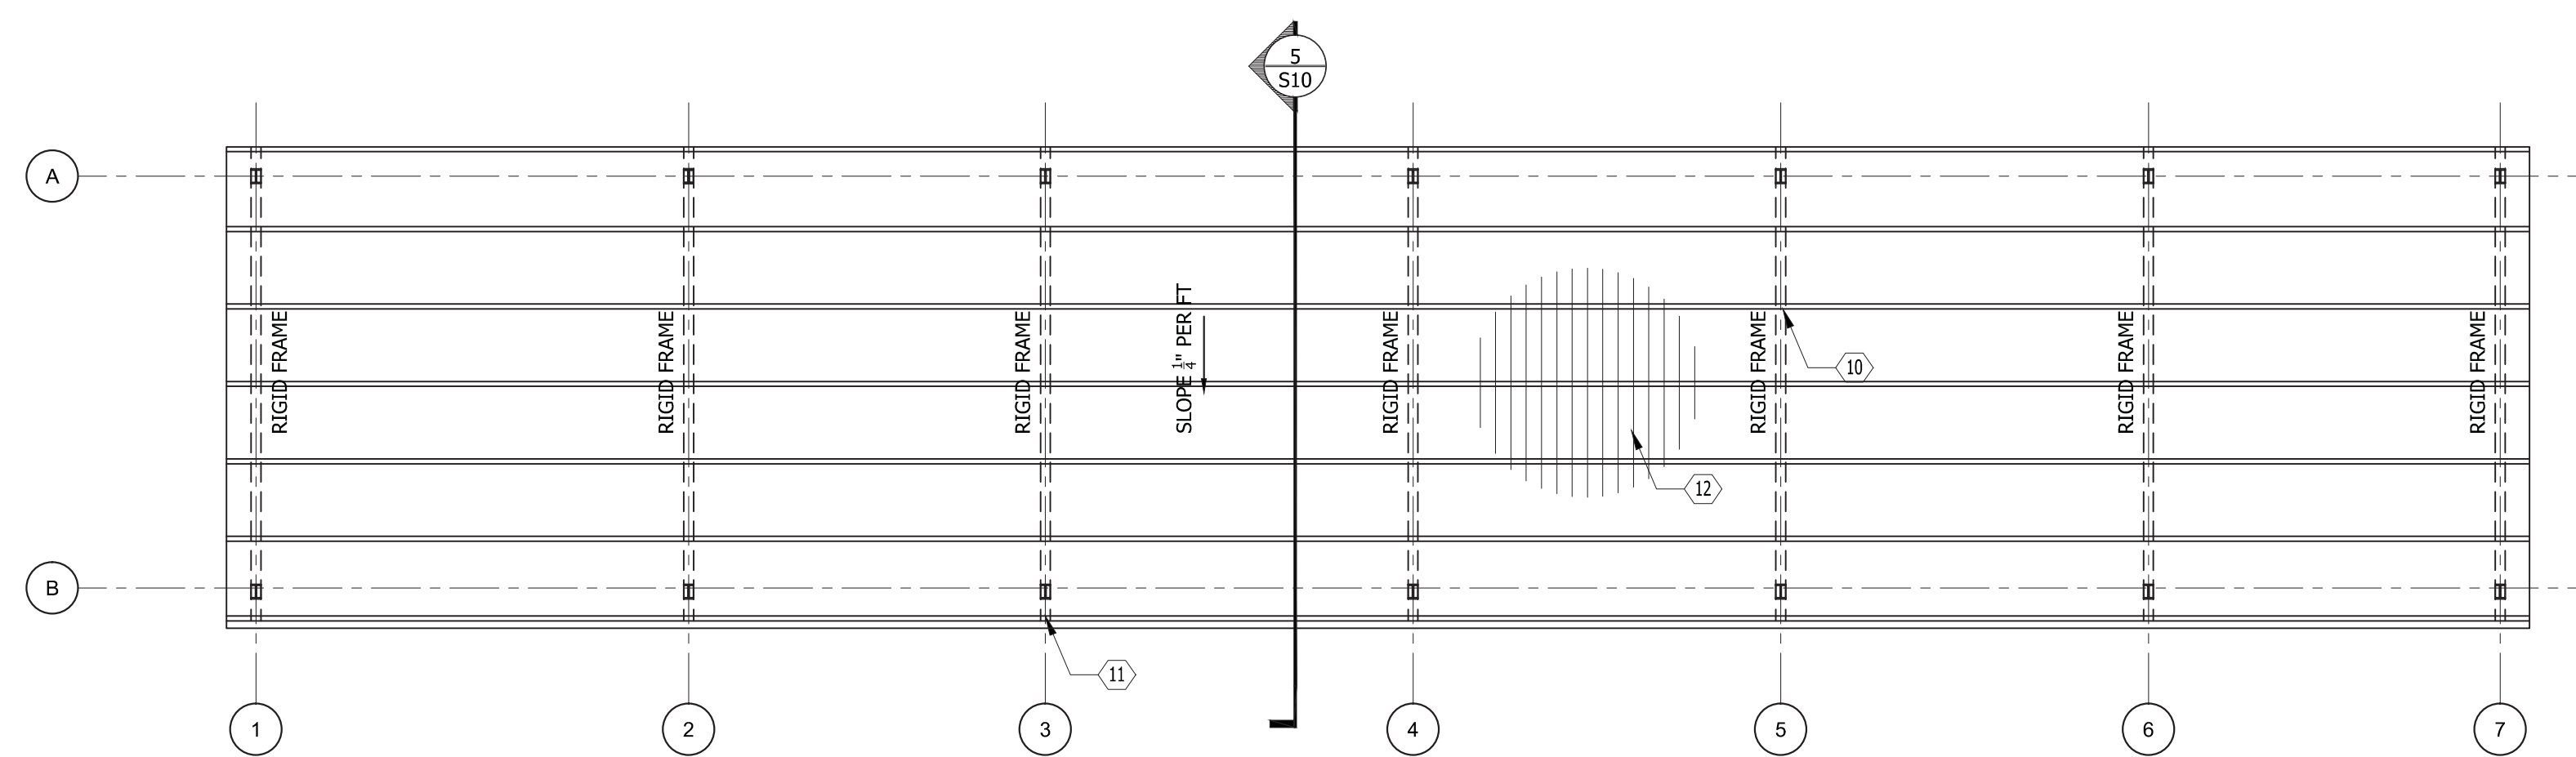

NEW HHW ROOF FRAMING PLAN

SCALE: 3/32" = 1'-0"

MARK	SIZE (L x W x D)	BTM REINF.	TOP REINF.	REMARKS
TDS1	CONT. x 2'-0" x 16'	(3) #5 CONT.	(1) #5 CONT.	---
TDS2	CONT. x 2'-0" x 16'	(3) #5 CONT.	(1) #5 CONT.	---
TDS3	CONT. x 1'-0" x 16'	(2) #5 CONT.	(1) #5 CONT.	---
TDS4	CONT. x 1'-4" x 12"	(3) #5 CONT.	---	---
MF3	3'-0" x 3'-0" x 36"	(3) - #5	(3) - #5	EACH WAY
MF4	4'-0" x 4'-0" x 36"	(4) - #5	(4) - #5	EACH WAY

Khari Rodriguez

Digitally signed by Khari Rodriguez
 DN: serialNumber=36fh83kpb8r8c6np, cn=US, st=Florida, o=Premier Structural Engineering Inc., email=khari@premierstructural.com, c=US, postalCode=33511, streetAddress=235 S. Maitland Ave., matland, fl 32751, telephone=407-227-7416, date=2018.03.19 20:24:53 -0400



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MARK	SIZE (L x W x D)	BTM REINF.	TOP REINF.	REMARKS
TDS1	CONT. x24"x16"	(3) #5 CONT.	(1) #5 CONT.	---
TDS2	CONT. x12"x12"MIN	(2) #5 CONT.	(1) #5 CONT.	---
TDS3	CONT. x12"x12"MIN	(2) #5 CONT.	(1) #5 CONT.	---
TDS4	CONT. x 12' x 12"	(2) - #5	---	CENTERED ON CURB
TDS5	CONT. x12"x16"	(2) #5 CONT.	(1) #5 CONT.	---
MF3	3'-0" x 3'-0" x 36"MIN	(3) - #5	---	EACH WAY
MF4	4'-0" x 4'-0" x 36"MIN	(4) - #5	---	EACH WAY

- CITIZEN DROP-OFF AND HHW BLDG. PLAN NOTES:
- INDICATES EXTENTS OF CITIZEN UNLOADING ZONE. REFERENCE PROPOSED SITE PLAN FOR LOCATION, LAYOUT, ELEVATION AND DIMENSIONS.
 - PROVIDE 1'-6" HIGH BATTER CURB THROUGHOUT THE LENGTH OF TRANSFER TRAILER BAYS 1 AND 2 (BOTH SIDES OF EACH BAY). REFERENCE RETAINING WALL DETAILS FOR BATTER CURB REINFORCEMENT. BATTER CURBS ARE NOT SHOWN ON PLAN (FOR CLARITY).
 - SLAB SLOPES ARE SHOWN POINTING TOWARDS DIRECTION OF LOWER ELEVATION. REFERENCE SHEET 7 FOR SLOPE PERCENTAGES AND SPOT ELEVATIONS.
 - "TDS" INDICATES TURN DOWN SLAB EDGE. REFERENCE DETAILS FOR SLAB EDGE DIMENSIONS AND REINFORCEMENT.
 - UNLESS NOTED OTHERWISE THE TOP OF ALL SHALLOW FOUNDATIONS SHALL BE -2'-0" BELOW ADJACENT GRADE ELEVATION.
 - PROVIDE GEOGRID PER SECTION 2070 BELOW ALL RETAINING WALL AND BUILDING SPREAD FOOTINGS. CONTRACTOR SHALL OVER EXCAVATE BOTTOM OF SPREAD FOOTINGS IN ORDER TO INSTALL GEOGRID AND FDOT #57 STONE AS PER THE GEOTECHNICAL ENGINEER'S RECOMMENDATIONS. REFERENCE PROJECT GEOTECHNICAL REPORT FOR ADDITIONAL GEOGRID REQUIREMENTS INCLUDING BUT NOT LIMITED TO GEOGRID EXTENSIONS BEYOND SPREAD FOOTING AREAS AND MINIMUM LAP GEOGRID REQUIREMENTS.
 - REFERENCE PROJECT GEOTECHNICAL REPORT FOR PROJECT SUBGRADE PREPARATION REQUIREMENTS BENEATH CONCRETE PAVEMENTS AND BUILDING SLABS ON GRADE.
 - PROVIDE MODEL 3100 COMMERCIAL TYPE CHAIN OPERATED OVERHEAD DOORS BY ROLL UP DOORS DIRECT OR EQUIVALENT MANUFACTURER. PROVIDE SPEED BUMP AT OVER DOOR LOCATIONS PER DETAIL 1 ON SHEET S9.
 - PROVIDE WATERSTOP RX BY CETCO OR EQUIVALENT PRODUCT FOR HHW SECONDARY POURS I.E. BETWEEN SLAB TO CURBS AND SLAB TO SPEED BUMPS.

- KEY NOTES
- PROVIDE NEW TRENCH DRAINS REFERENCE SHEET 6 FOR LOCATION AND TYPE.
 - 1'-0" CAST IN PLACE CONCRETE RETAINING WALLS REF: SHEETS 7 AND S8 FOR TOP OF WALL ELEVATIONS.
 - PROVIDE 8" THICK SLAB REINFORCED W/ #5 BARS @ 12" O.C. TOP AND BOTTOM EACH WAY. PROVIDE TURNED DOWN SLAB EDGE AT PERIMETERS. TOP OF SLAB ELEVATION = 117.90
 - PROVIDE 8" THICK SLAB REINFORCED W/ #5 BARS @ 12" O.C. TOP AND BOTTOM EACH WAY. TOP OF SLAB ELEVATION = 117.90
 - RETAINING WALL "A" REF: DETAIL 4 ON SHEET S8.
 - RETAINING WALL "B" REF: DETAIL 3 ON SHEET S8.
 - RETAINING WALL "C" REF: DETAIL 2 ON SHEET S8.
 - RETAINING WALL FOOTING BELOW. REFERENCE DETAILS ON SHEET S8 FOR SIZE AND REINFORCEMENT.
 - ROOF PURLINS BY PRE-ENGINEERED METAL BUILDING MANUFACTURER.
 - PROVIDE GUTTER ALONG ROOF EDGE AND DOWNSPOUTS AT EACH COLUMN LOCATION.
 - PROVIDE STANDING SEAM METAL ROOF PANELS BY PRE-ENGINEERED METAL BUILDING MANUFACTURER.
 - PROVIDE 6" DIA. CONCRETE FILLED PIPE BOLLARDS AS SHOWN. SEE TYP. PIPE BOLLARD DETAIL 4 ON SHEET 13.
 - PROVIDE CHAIN LINK FENCE W/ 10FT SWING GATES. REFERENCE SHEETS 6 AND 16.
 - PROVIDE 8" WIDE x 6" TALL CONTAINMENT CURB PER DETAILS 2 AND 3 ON SHEET S9.
 - PROVIDE CONSTRUCTION/CONTRACT JOINTS PER DETAILS ON SHEET S9.

CLIENT	ORANGE COUNTY SOLID WASTE DIVISION ORLANDO, FLORIDA
PROJECT TITLE	PORTER TRANSFER STATION SITE IMPROVEMENTS
SHEET TITLE	CITIZEN DROP OFF / NEW HHW FOUNDATION, SLAB AND ROOF PLANS
DATE	MARCH 2018
SCALE	AS SHOWN
DRAWING NO.	S5
SHEET	22 of 34

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P:\Premier\2017\Blue Marlin\Porter\Struct\DROP OFF AREA\Yord054016EN DETAILS\10_13_2017.dwg Mar 19, 2018 - 8:00pm Layout Name: S7 - RETAINING WALL REINFORCEMENT By: PremierStructural 1



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Kharl Rodriguez


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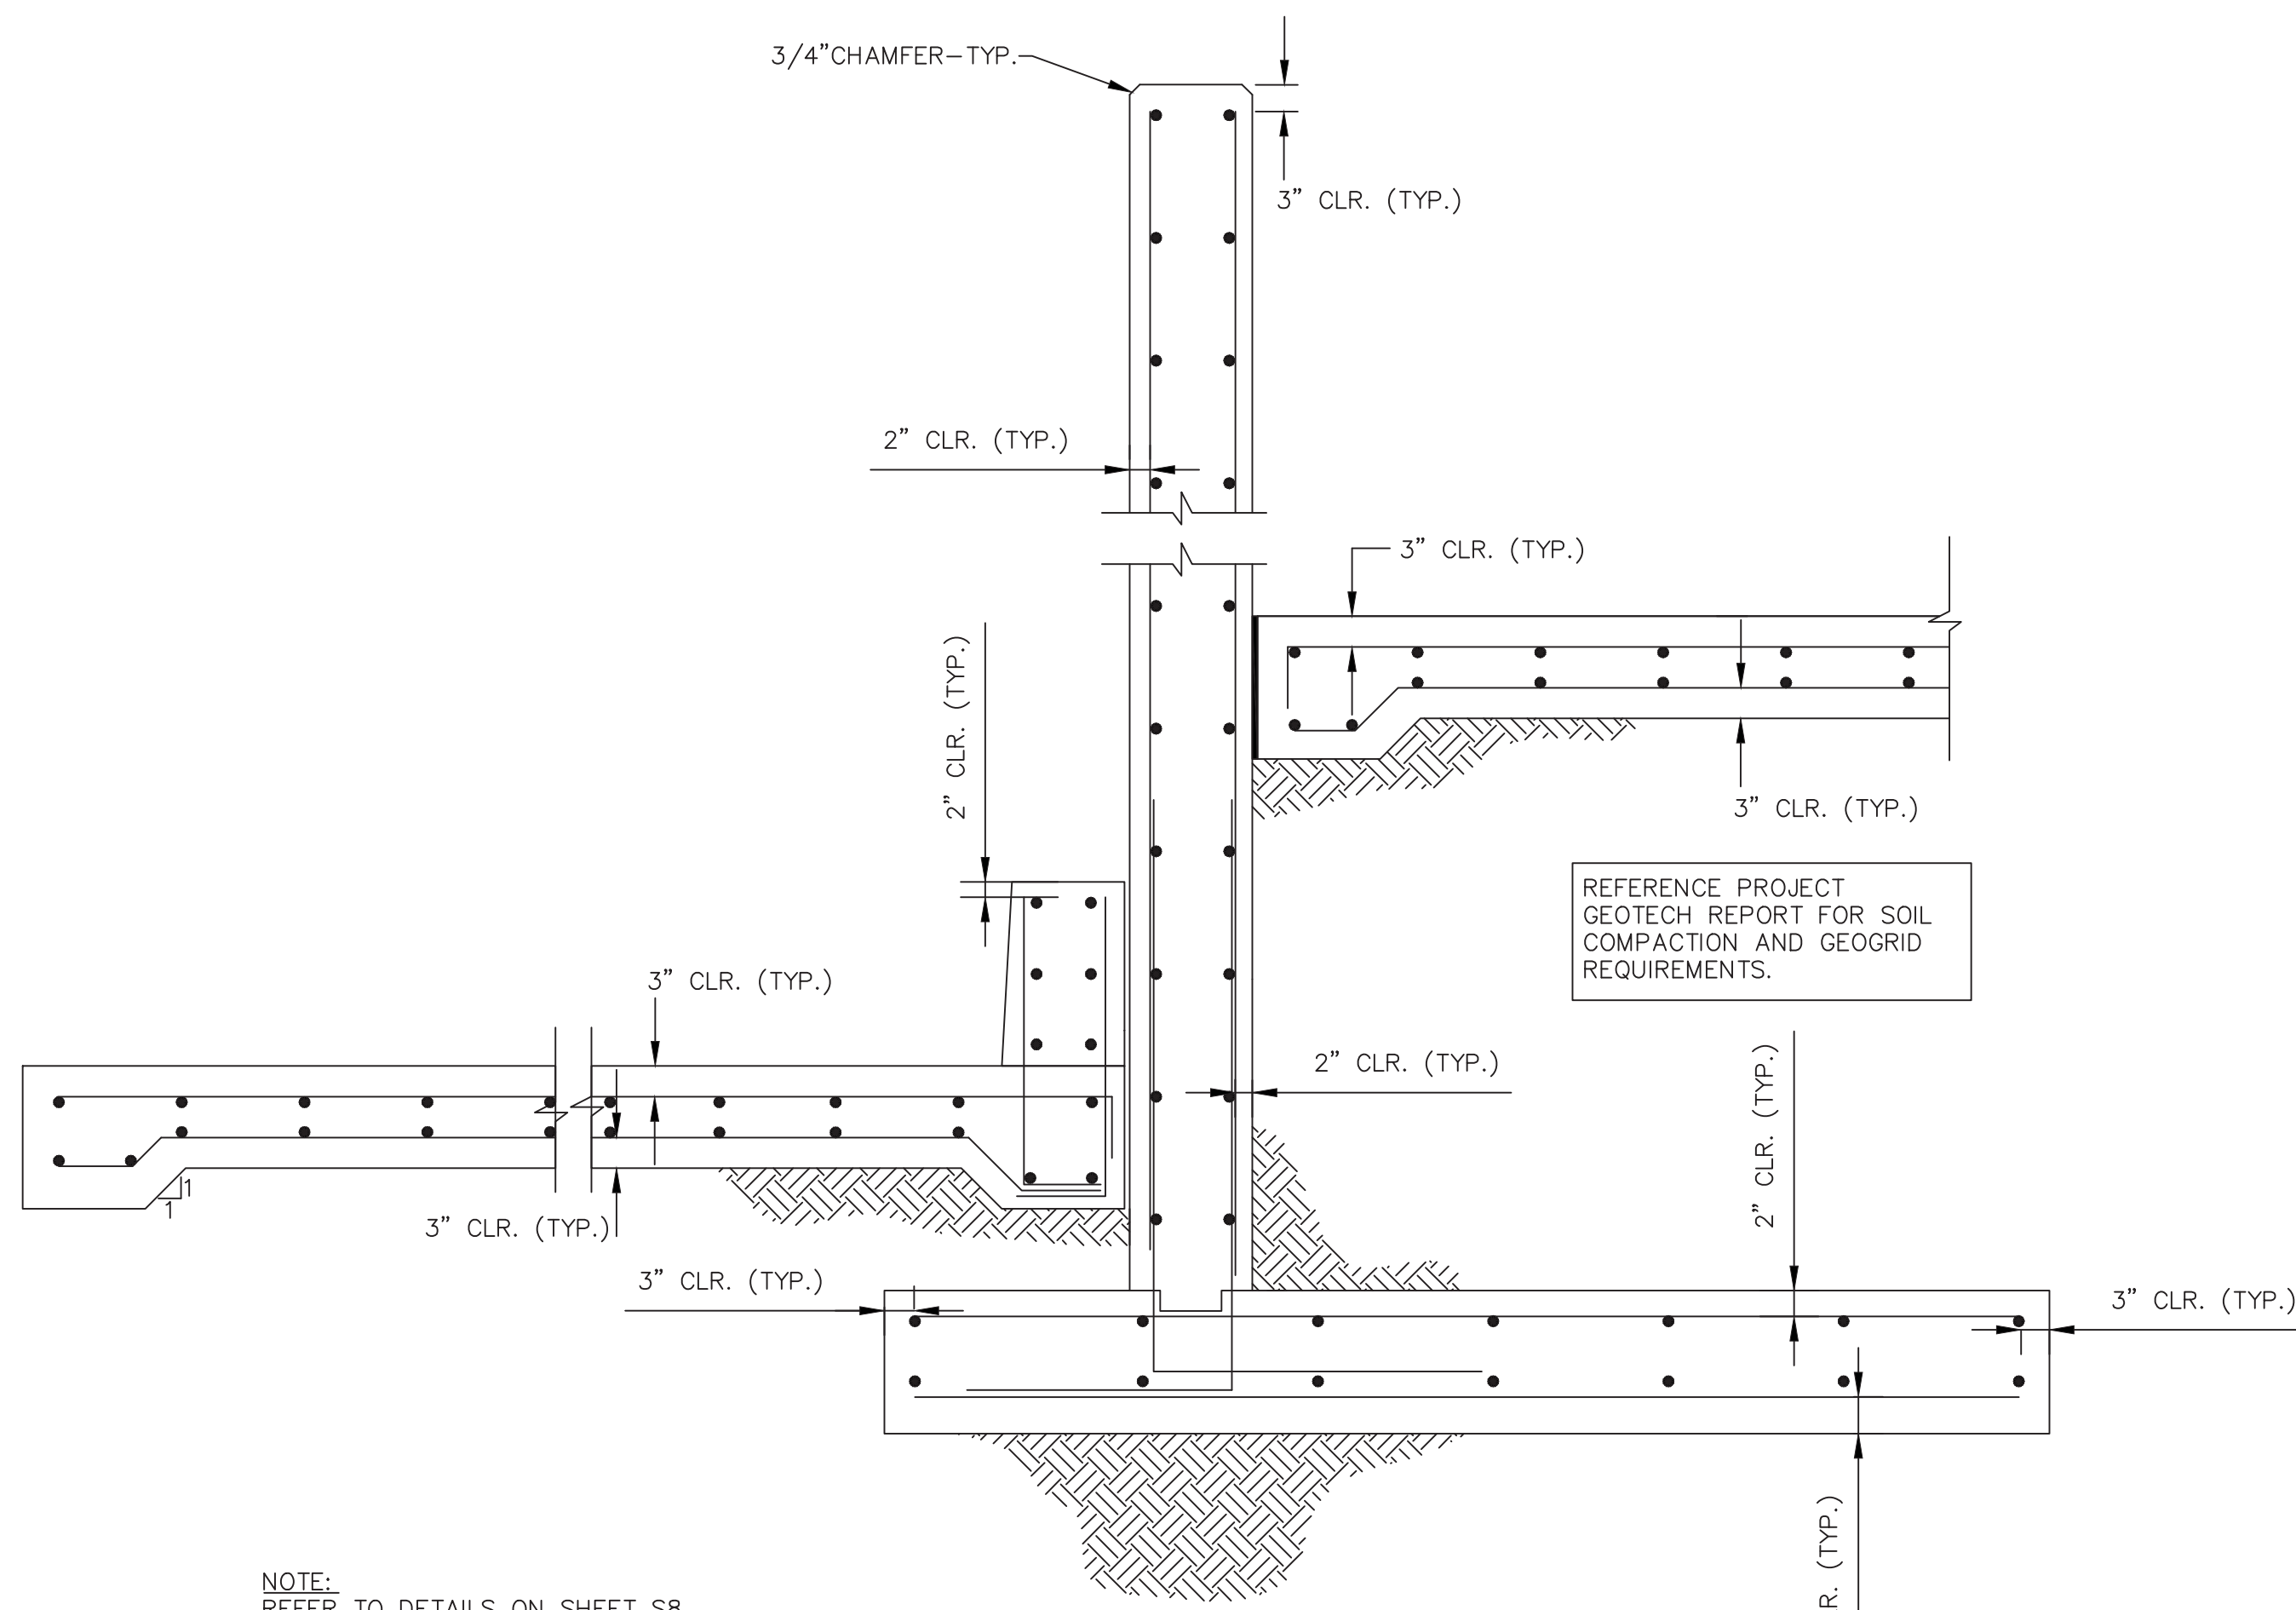
SHEET TITLE
RETAINING WALL REINFORCEMENT
 PROJECT TITLE
PORTER TRANSFER STATION SITE IMPROVEMENTS

CLIENT
ORANGE COUNTY SOLID WASTE DIVISION
ORLANDO, FLORIDA

SCS ENGINEERS
 STEARNS, CONRAD AND SCHMIDT
 CONSULTING ENGINEERS
 4041 PARK OAKS BLVD, SUITE 100, TAMPA, FL 33610
 PH (813) 621-0080 FAX NO. (813) 623-6757
 FLORIDA CERTIFICATE OF AUTHORIZATION NO. 00004892
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 DESIGNED BY: KJR APP. BY: KJR
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 SCALE: AS SHOWN
 DRAWING NO. **S7**
 SHEET X of 34



TYPICAL RETAINING AND REINFORCEMENT
 SCALE: 3/4" = 1'-0"

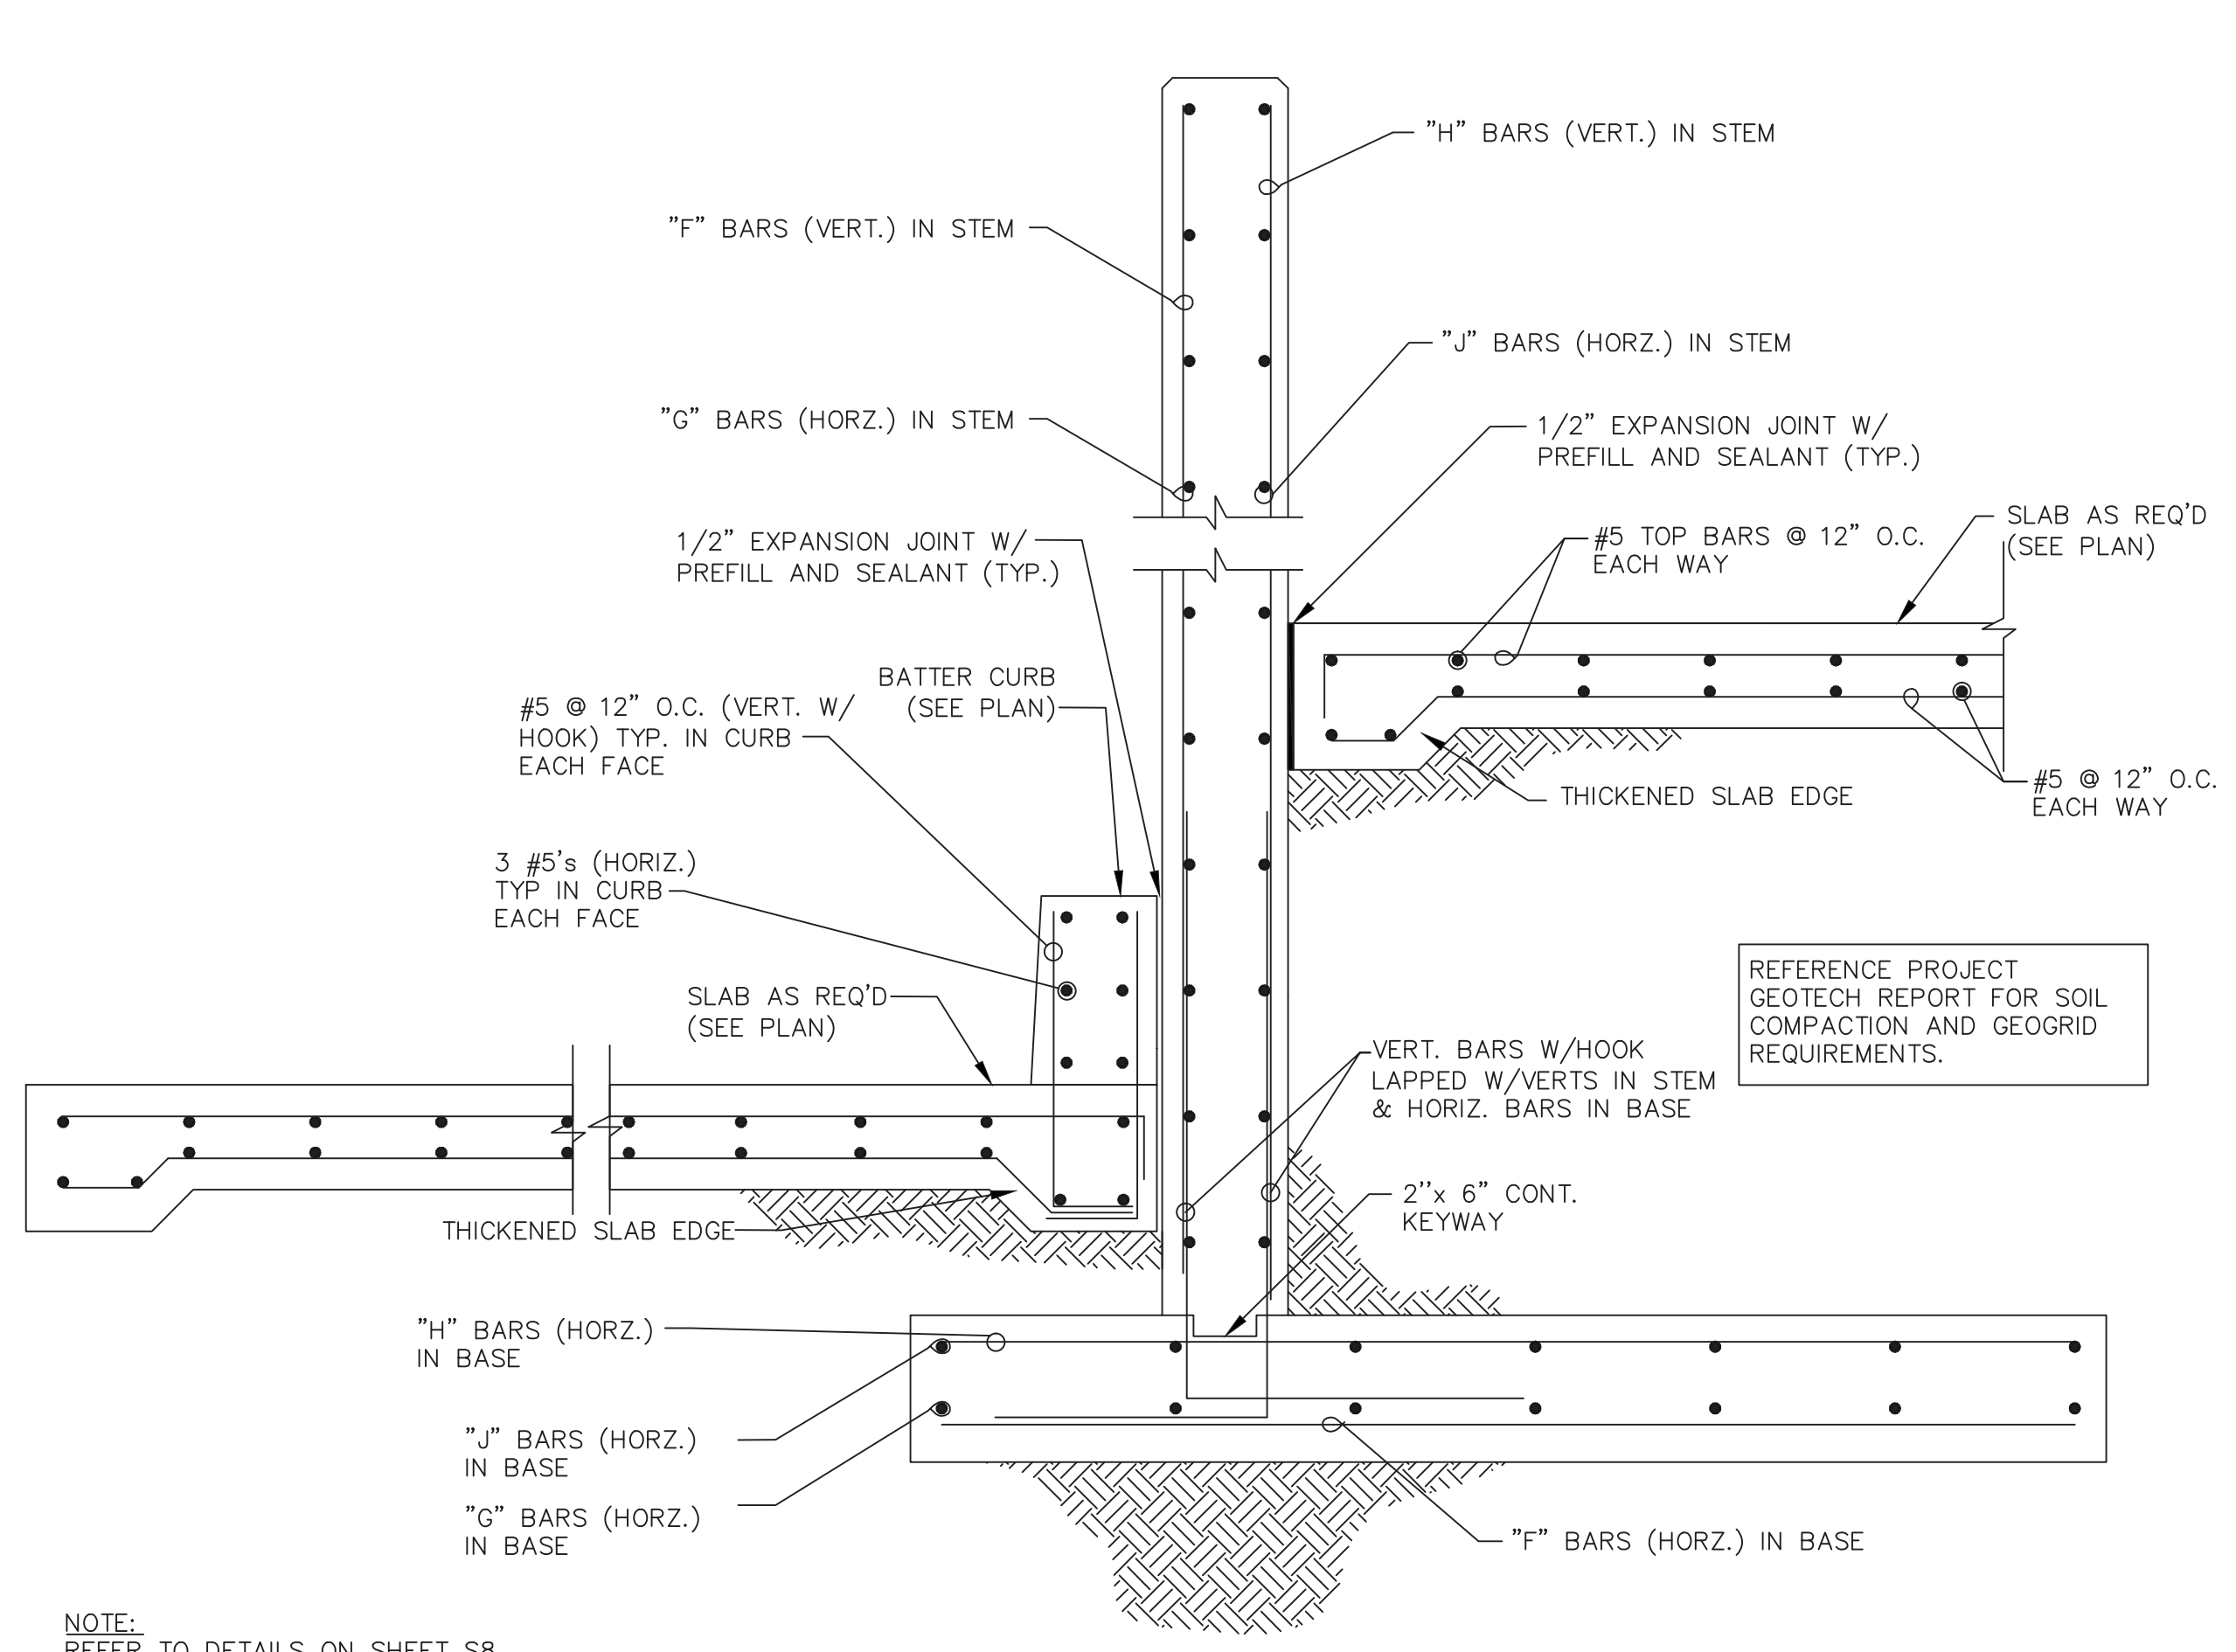

TYPICAL RETAINING WALL AND SLAB
 SCALE: 3/4" = 1'-0"

NOTE:
 REFER TO DETAILS ON SHEET S8 FOR RETAINING WALL TYPES AND DIMENSIONS.

NOTE:
 REFER TO DETAILS ON SHEET S8 FOR RETAINING WALL TYPES AND DIMENSIONS.


REFERENCE PROJECT GEOTECH REPORT FOR SOIL COMPACTION AND GEOGRID REQUIREMENTS.

REFERENCE PROJECT GEOTECH REPORT FOR SOIL COMPACTION AND GEOGRID REQUIREMENTS.


REINFORCING STEEL SCHEDULE FOR TYPICAL 30' - 0" SECTION OF RETAINING WALL

TYPE	LOCATION	RETAINING WALL TYPE (SEE PLAN)		
		TYPE "A"	TYPE "B"	TYPE "C"
"A2" BARS	KEY	N/A	N/A	N/A
"F" BARS	STEM	#5's @12"	#5's @12"	#5's @12"
"G" BARS	BASE	#5's @12"	#6's @12"	#5's @12"
	STEM	#5's @14"	#5's @14"	#5's @14"
"H" BARS	BASE	#5's @14"	#5's @14"	#5's @14"
	STEM	#5's @12"	#8's @12"	#7's @12"
"J" BARS	BASE	#5's @12"	#6's @12"	#5's @12"
	STEM	#5's @14"	#5's @14"	#5's @14"

- RETAINING WALL DESIGN NOTES:
- ALL CONSTRUCTION MUST BE IN STRICT ACCORDANCE WITH THE 2014 EDITION OF THE FLORIDA BUILDING CODE AS WELL AS WITH ALL OTHER APPLICABLE CODES, AMENDMENTS, ETC. REFERENCED CODE VERSIONS SHALL BE THOSE REFERENCED IN THE CURRENT EDITION OF THE FLORIDA BUILDING CODE AND APPLICABLE SUPPLEMENTS.
 - CONCRETE FOR RETAINING WALL SHALL HAVE A MINIMUM COMPRESSIVE STRENGTH OF 5,500 PSI AT 28 DAYS. ALL CONCRETE SHALL BE PRODUCED, PLACED, AND CURED IN ACCORDANCE WITH ACI 301 AND ACI 318. CONCRETE CONSTRUCTION TOLERANCES SHALL BE IN ACCORDANCE WITH ACI 117.
 - ALL STEEL REINFORCING FOR CONCRETE SHALL BE FREE OF EXCESSIVE RUST, ALL DIRT, SCALE, OIL, ETC. AND SHALL BE IN CONFORMANCE WITH ASTM A615 GRADE 60 BARS AND SHALL BE DETAILED PER ACI 315. THE SPACINGS SHOWN ARE THE MAXIMUM VALUES ALLOWED BY DESIGN. THESE VALUES SHALL BE USED FOR THE ENTIRE LENGTH OF THE RETAINING WALL TABULATED AT EQUAL SPACINGS.
 - DIMENSIONS FROM FACE OF CONCRETE TO STEEL (CLR.) ARE TO FACE OF BARS.
 - ALL REINFORCING STEEL SHALL BE WELL SECURED IN PLACE PRIOR TO PLACING OF CONCRETE.
 - PROJECTING CORNERS SHALL BE FORMED WITH A 3/4" CHAMFER UNLESS OTHERWISE NOTED.
 - DESIGN IS BASED UPON THE ENGINEERING EVALUATION AND RECOMMENDATIONS CONTAINED IN THE GEOTECHNICAL EXPLORATION REPORT FOR PORTER TRANSFER STATION IMPROVEMENTS BY BLUE MARLIN ENGINEERING, LLC, DATED AUGUST 31, 2017, BME PROJECT NO. 17-109. INFORMATION FROM SAID REPORT CONTAINED, BUT WAS NOT LIMITED TO THE FOLLOWING: SAFE ALLOWABLE SOIL BEARING PRESSURE OF 2,000 PSF AND MINIMUM SIZE CRITERIA.

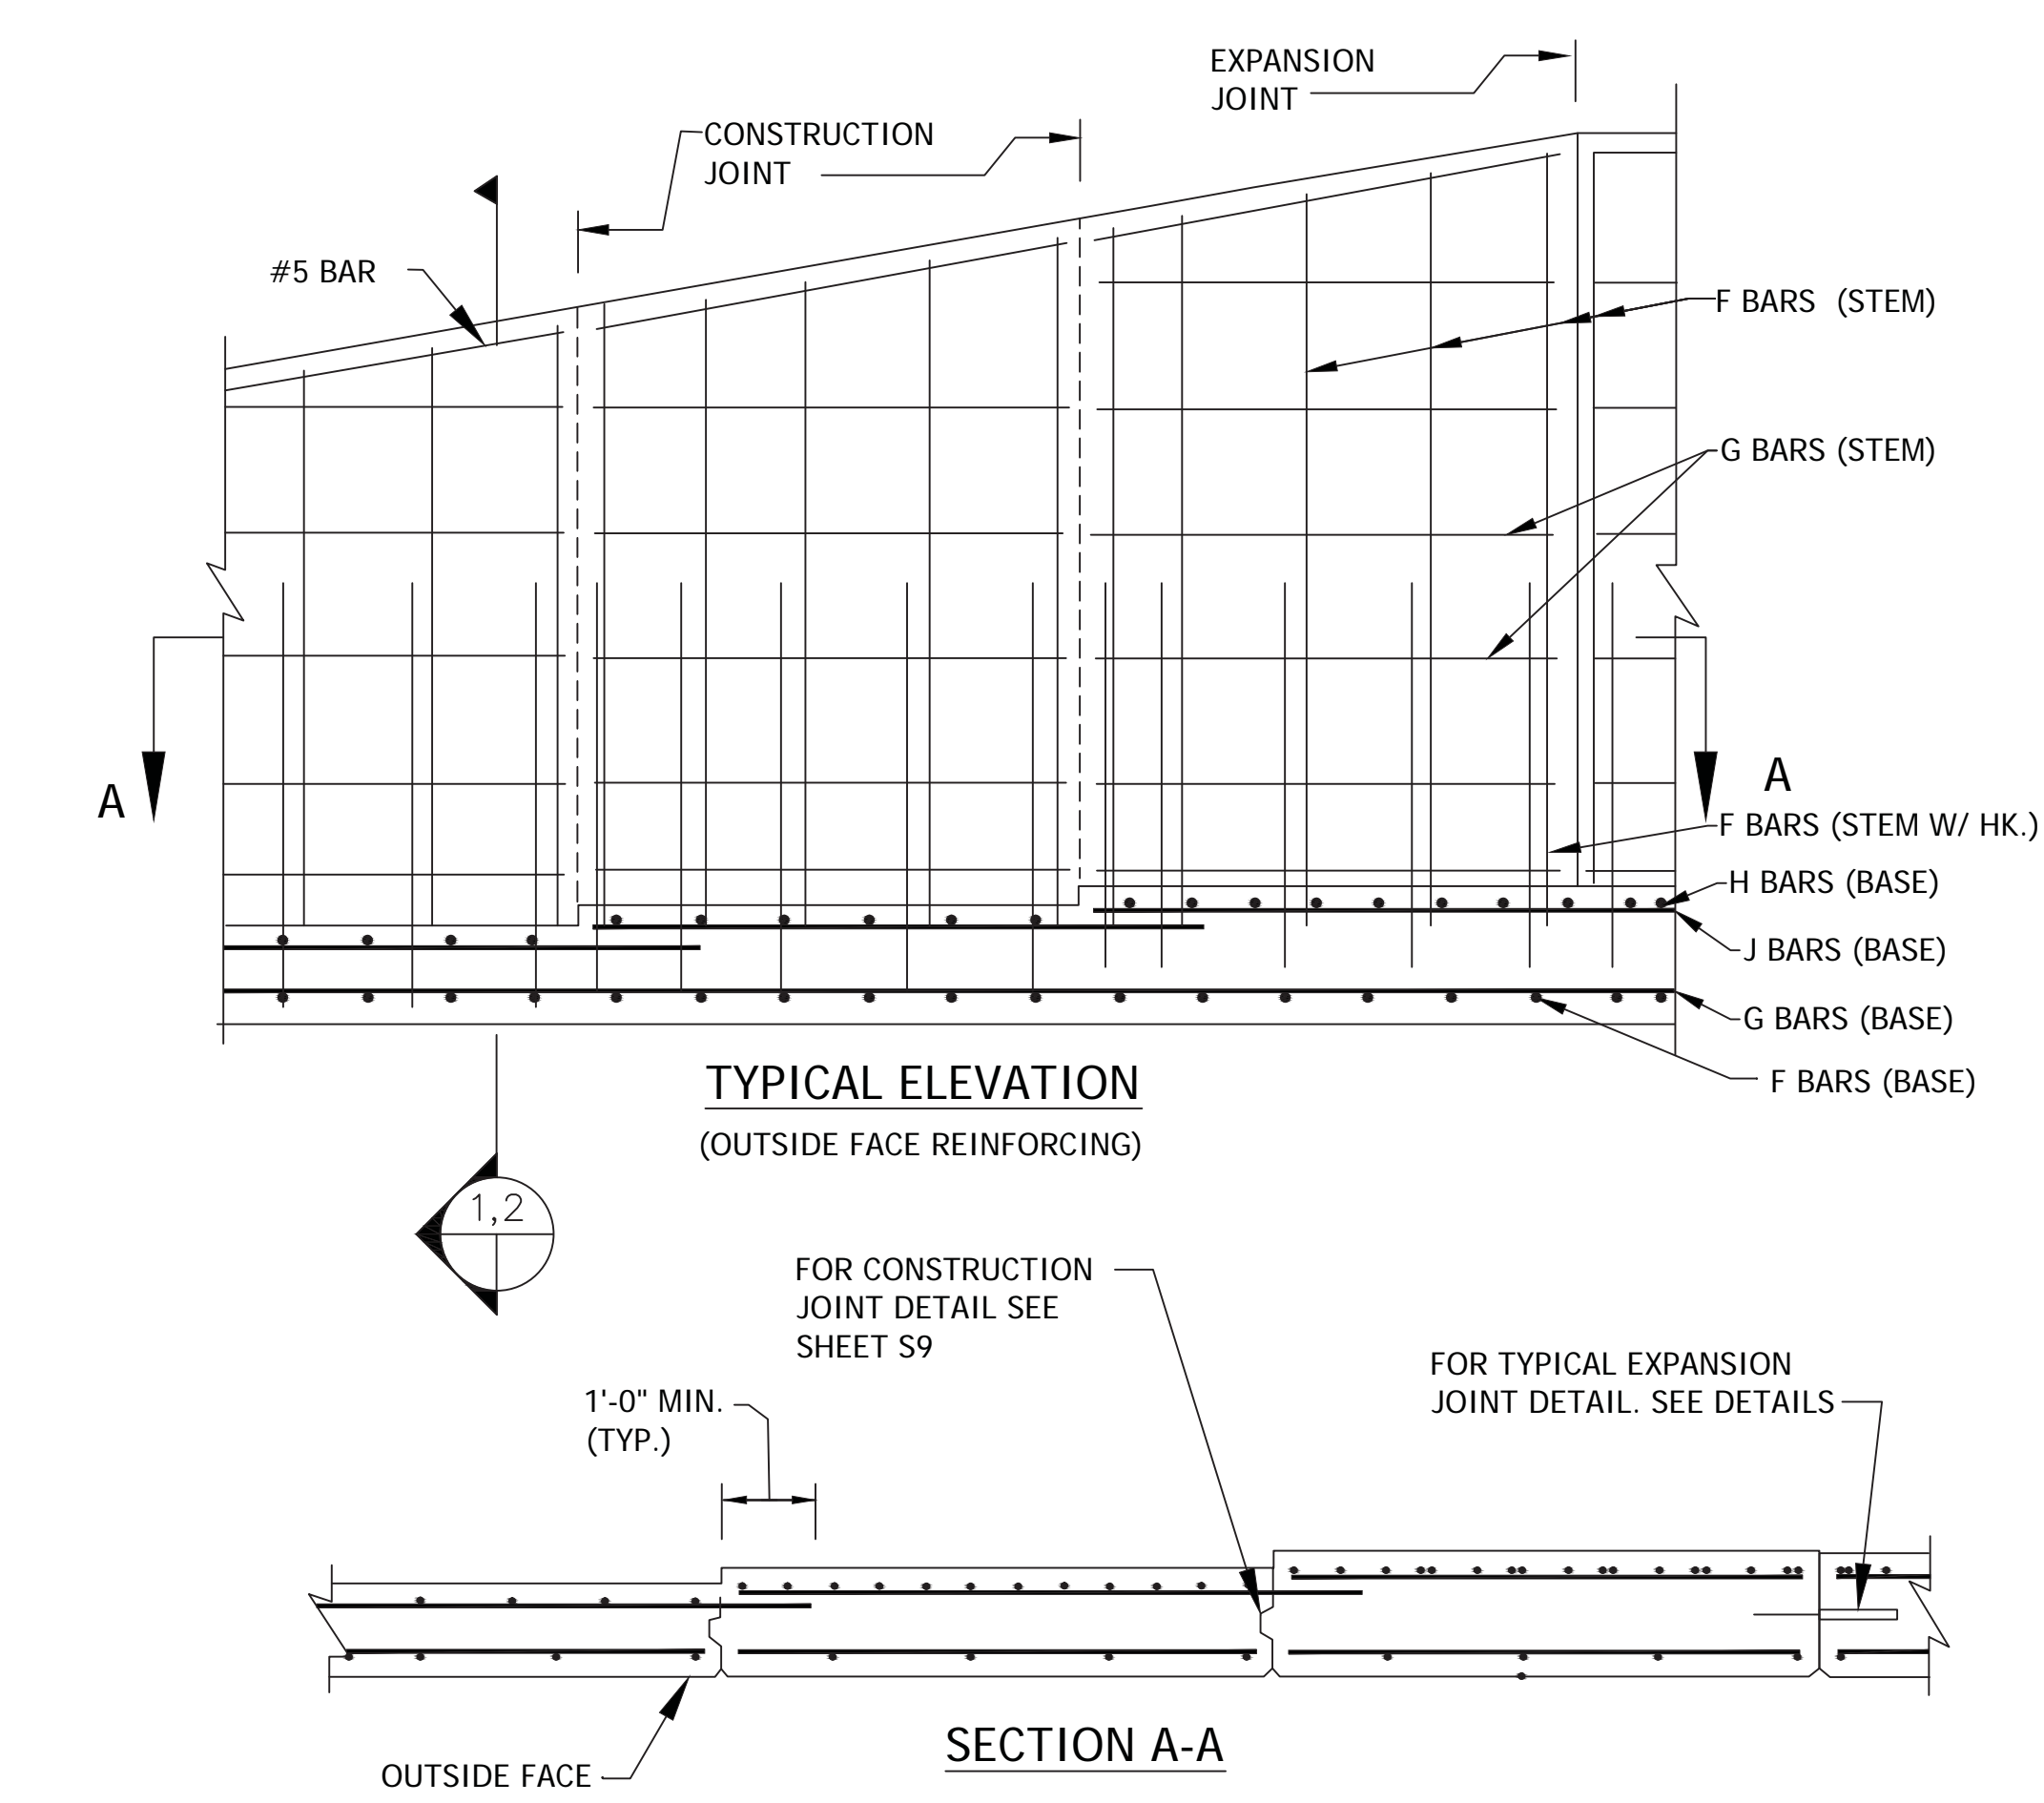


TYPICAL ELEVATION (OUTSIDE FACE REINFORCING)











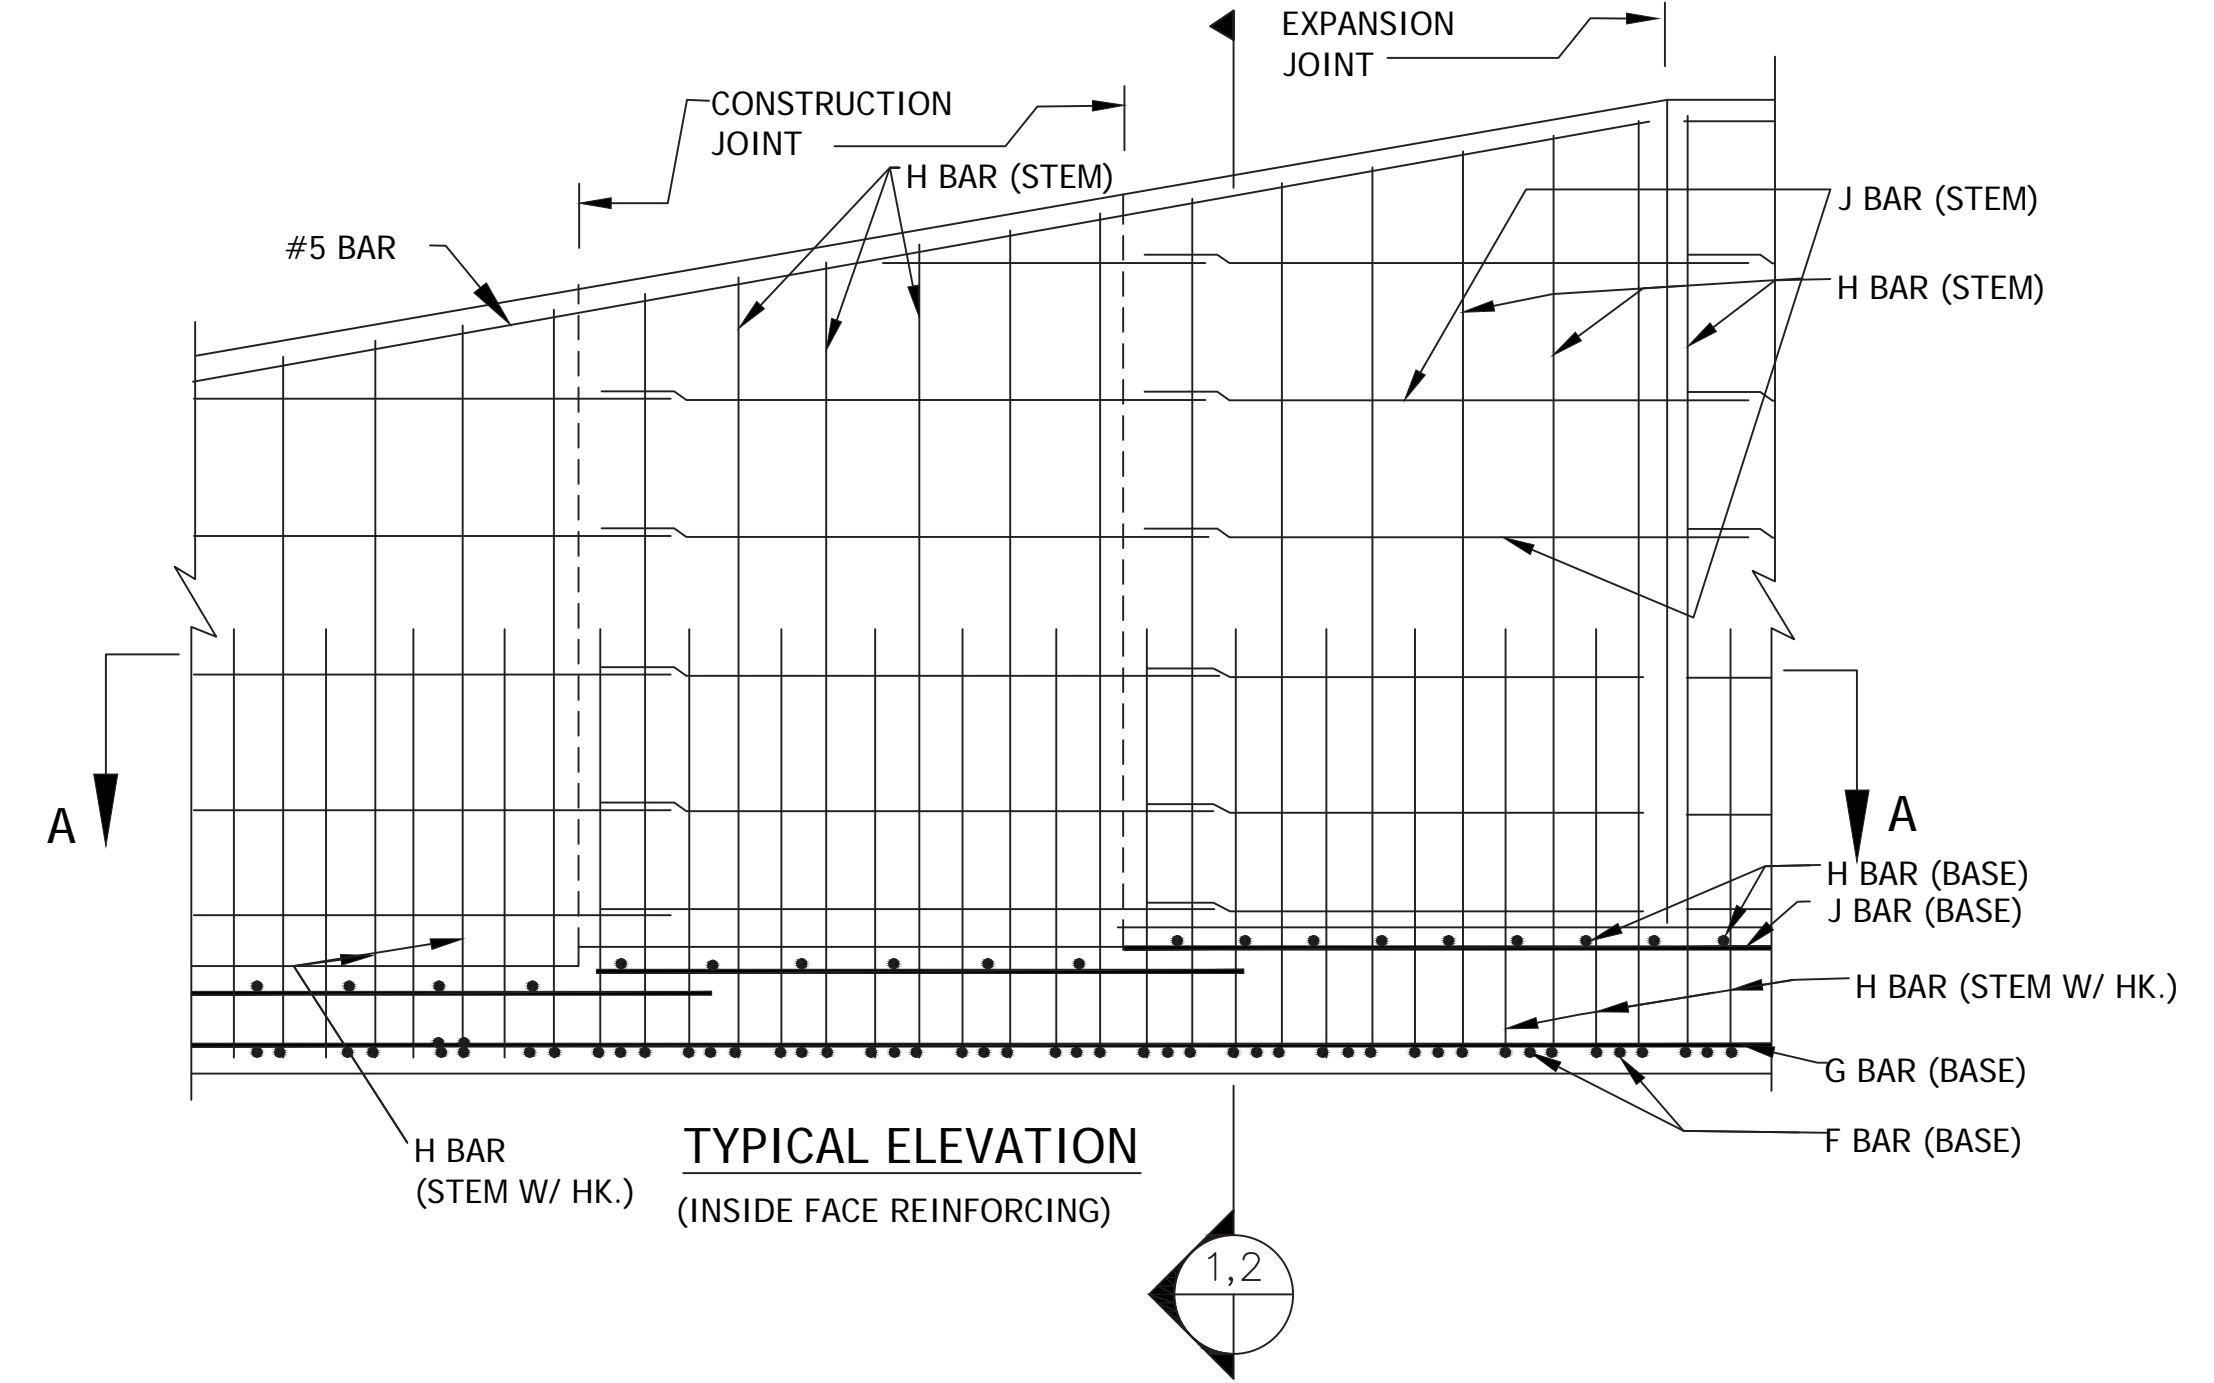


TYPICAL ELEVATION (INSIDE FACE REINFORCING)

- NOTES:
- REINFORCEMENT FOR BATTER CURB IS NOT SHOWN FOR CLARITY SEE DETAIL 1 THIS SHEET.
 - REINFORCEMENT FOR TRANSFER TRAILER FLOOR IS NOT SHOWN FOR CLARITY.
 - REINFORCEMENT FOR CITIZEN'S UNLOADING ZONE FLOOR IS NOT SHOWN FOR CLARITY.
 - REFERENCE SHEET S9 FOR JOINTS REQUIRED IN CONCRETE RETAINING WALLS.

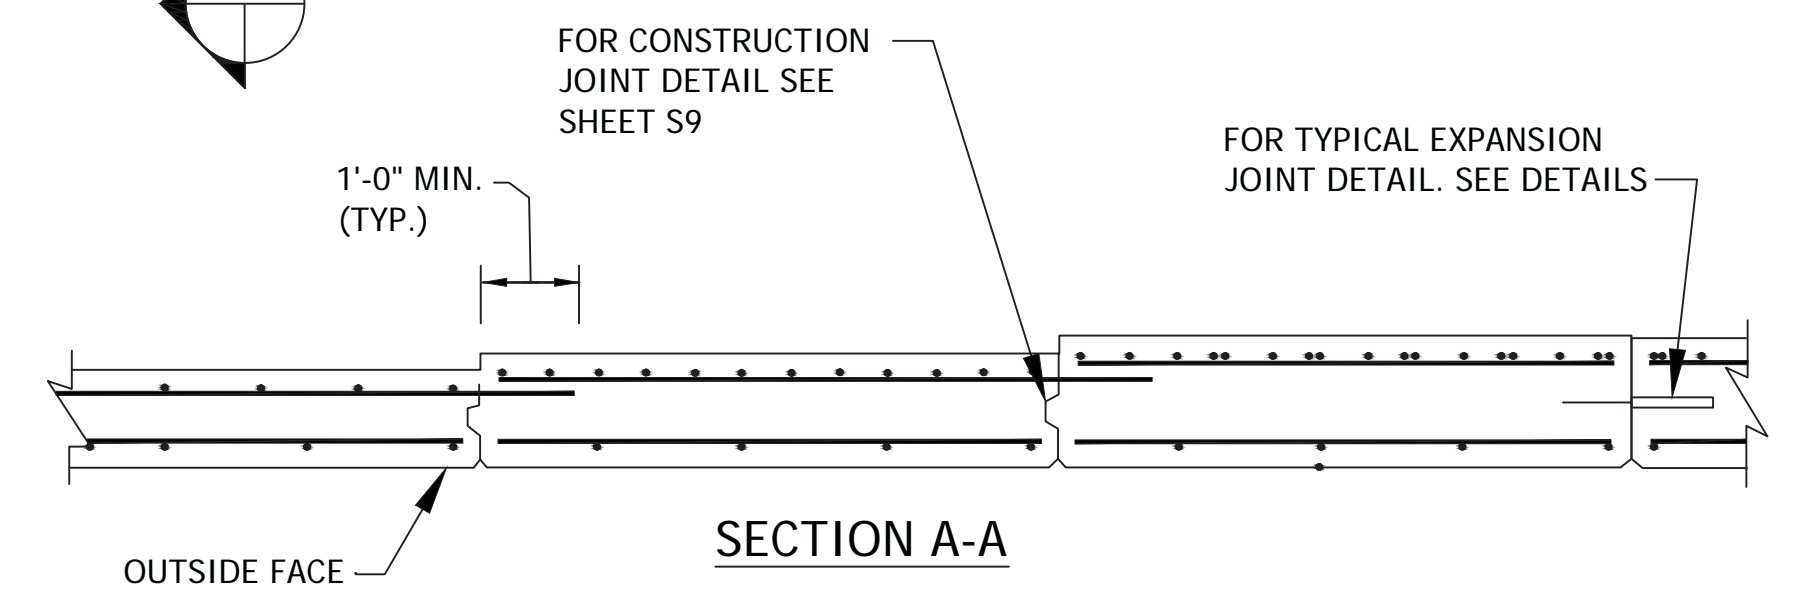

TYPICAL RETAINING WALL REINFORCEMENT DETAIL
 NOT TO SCALE

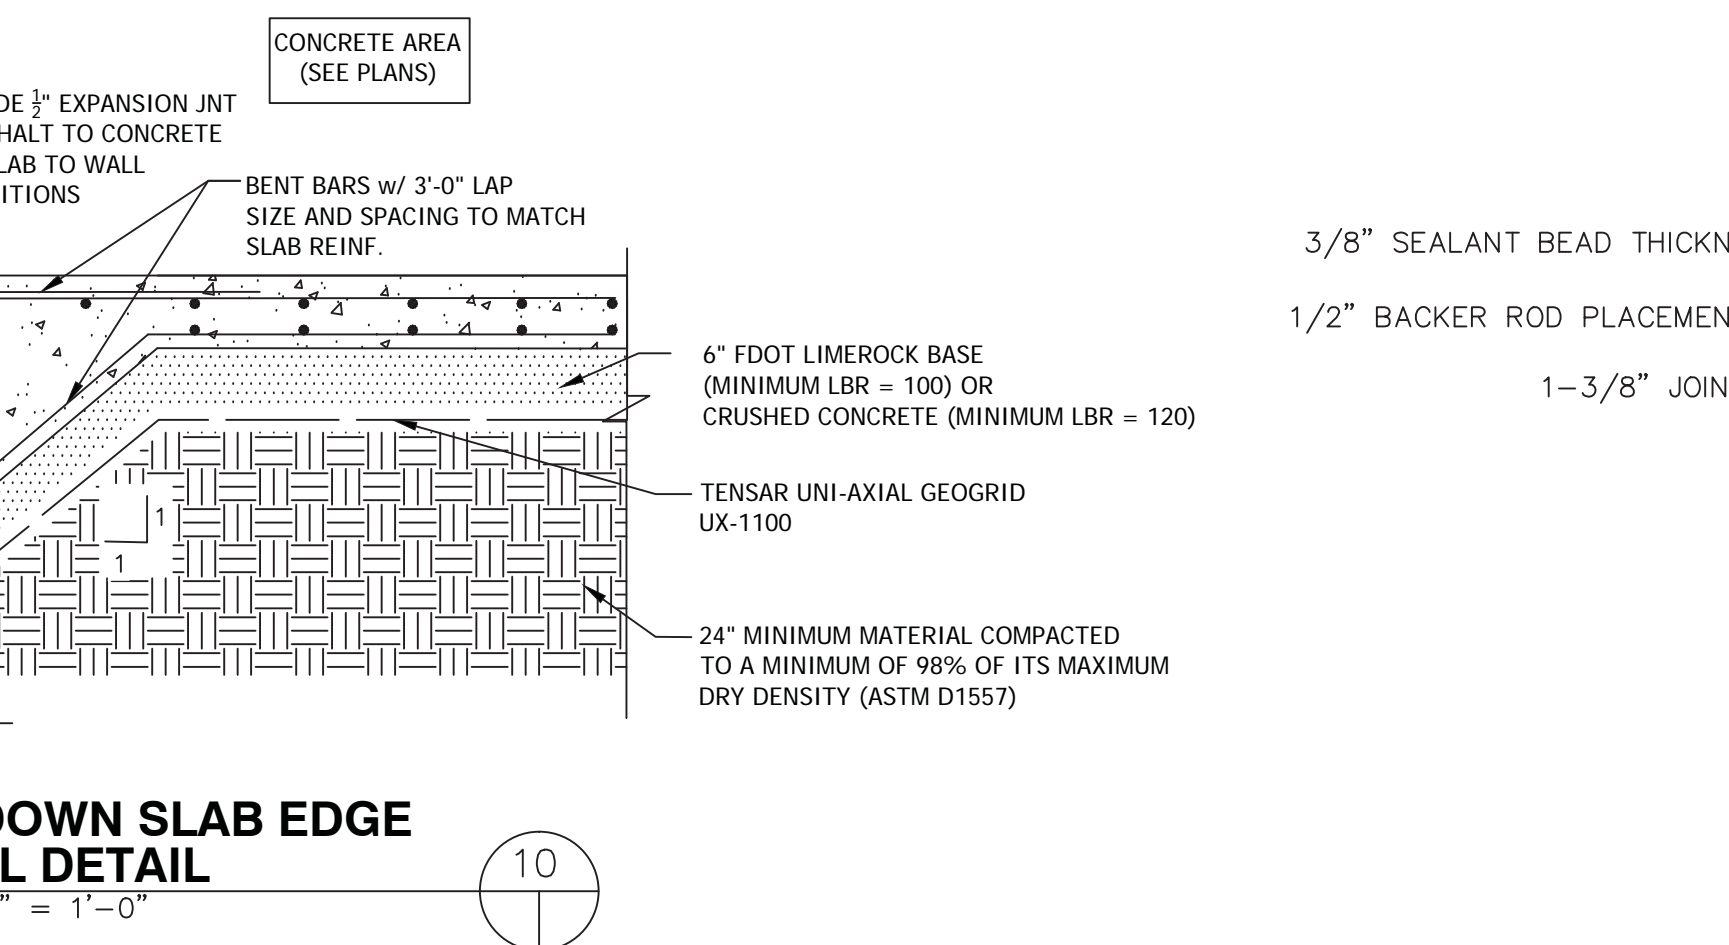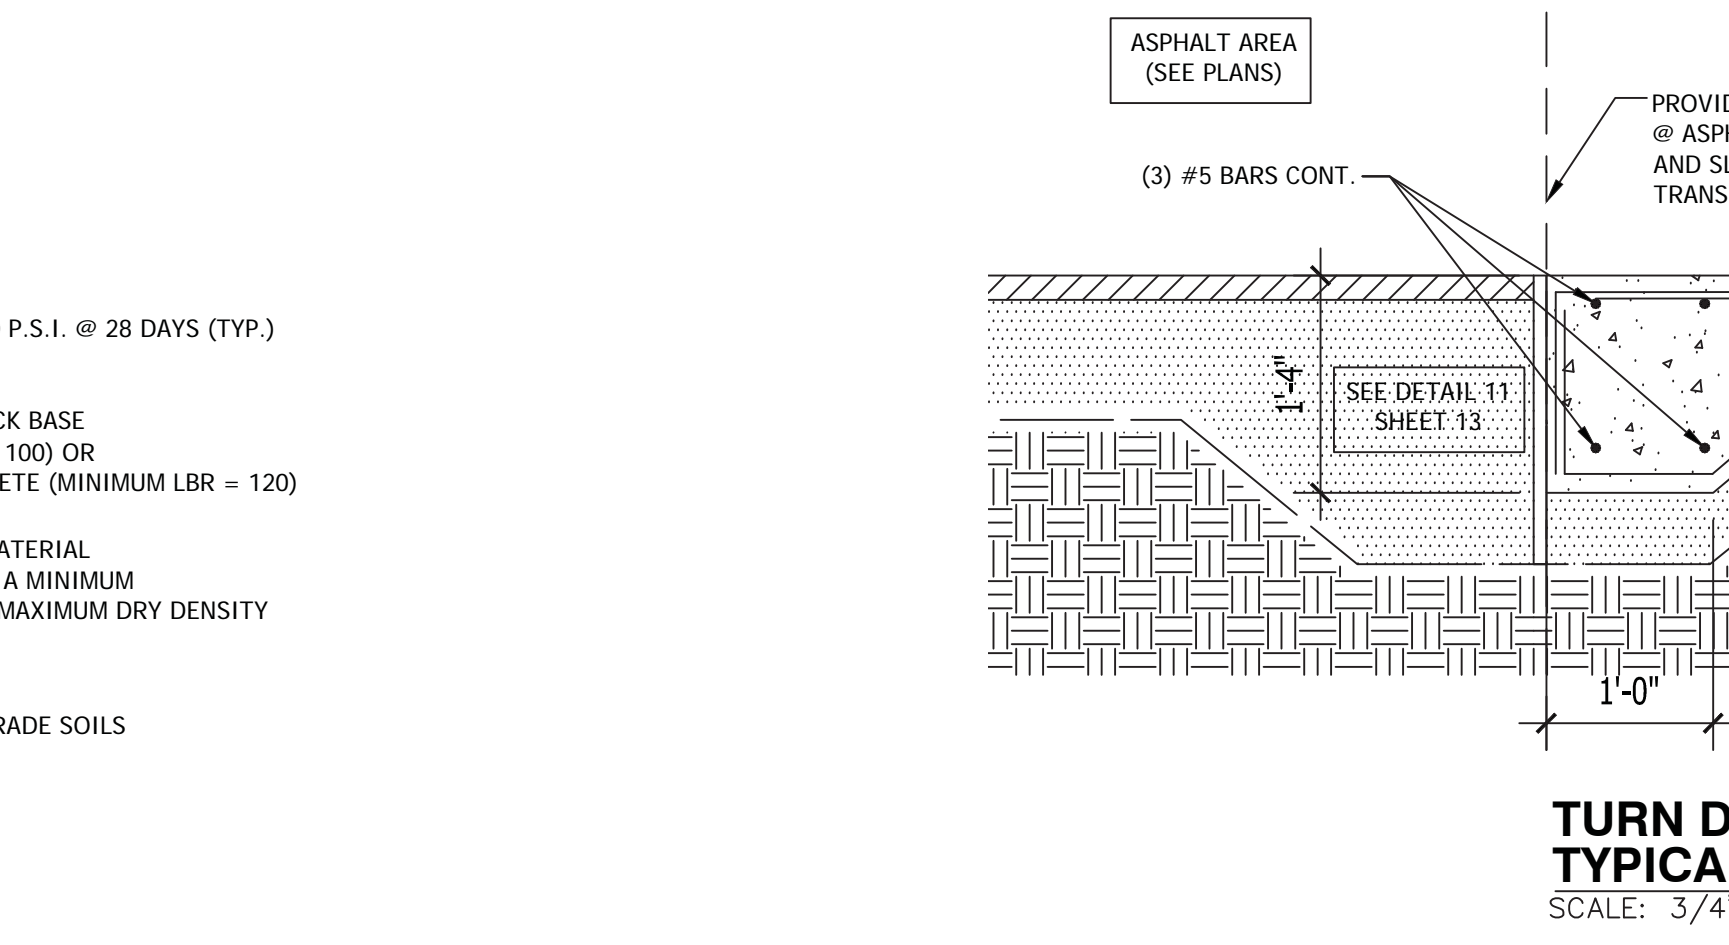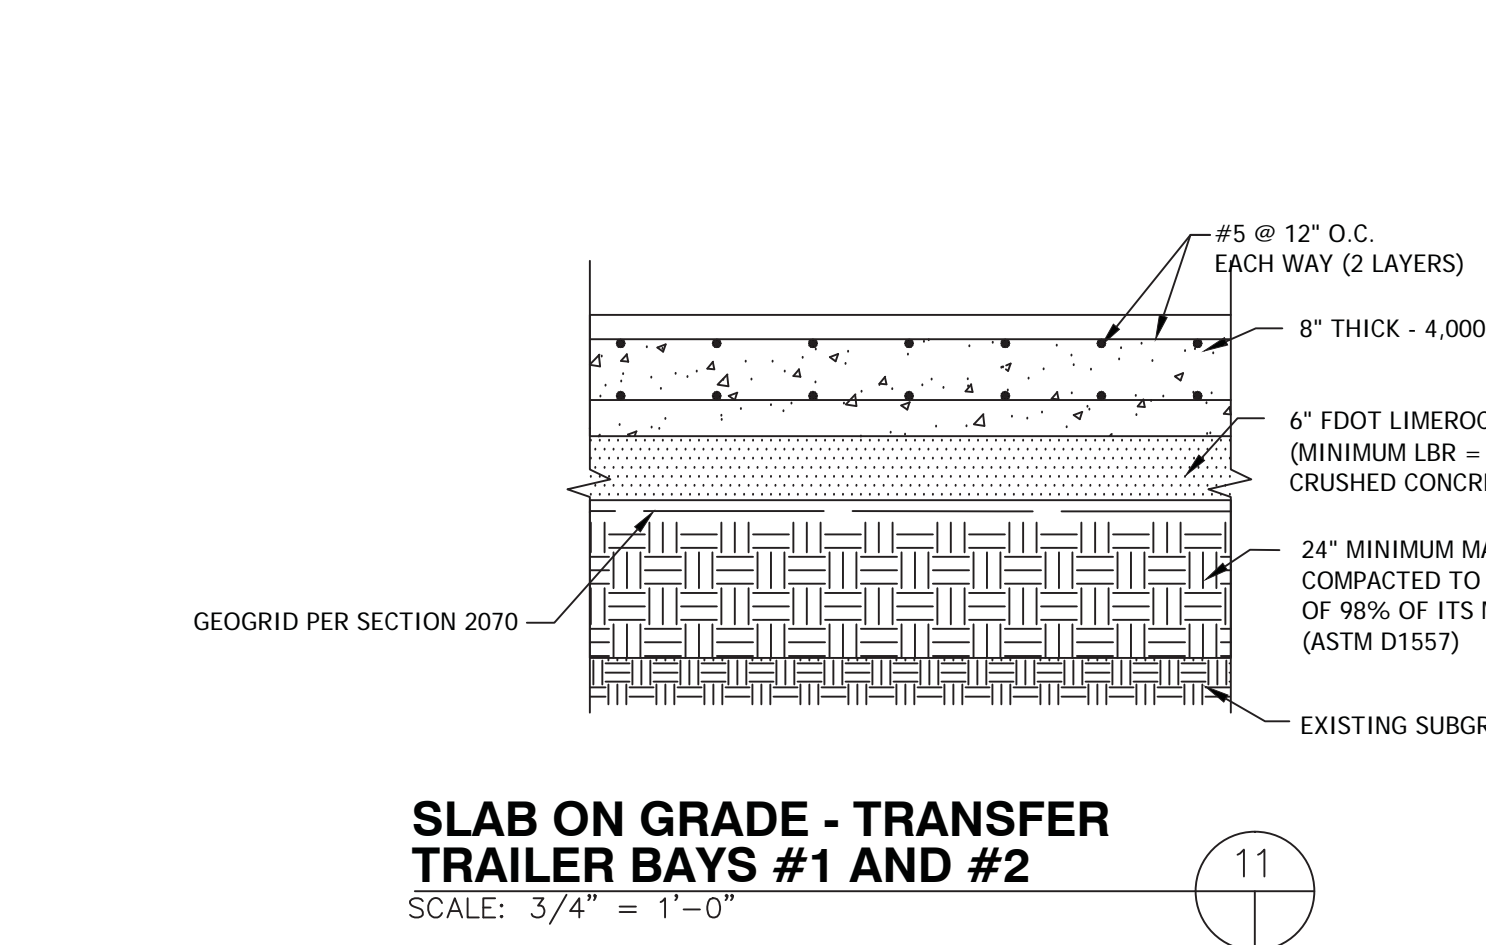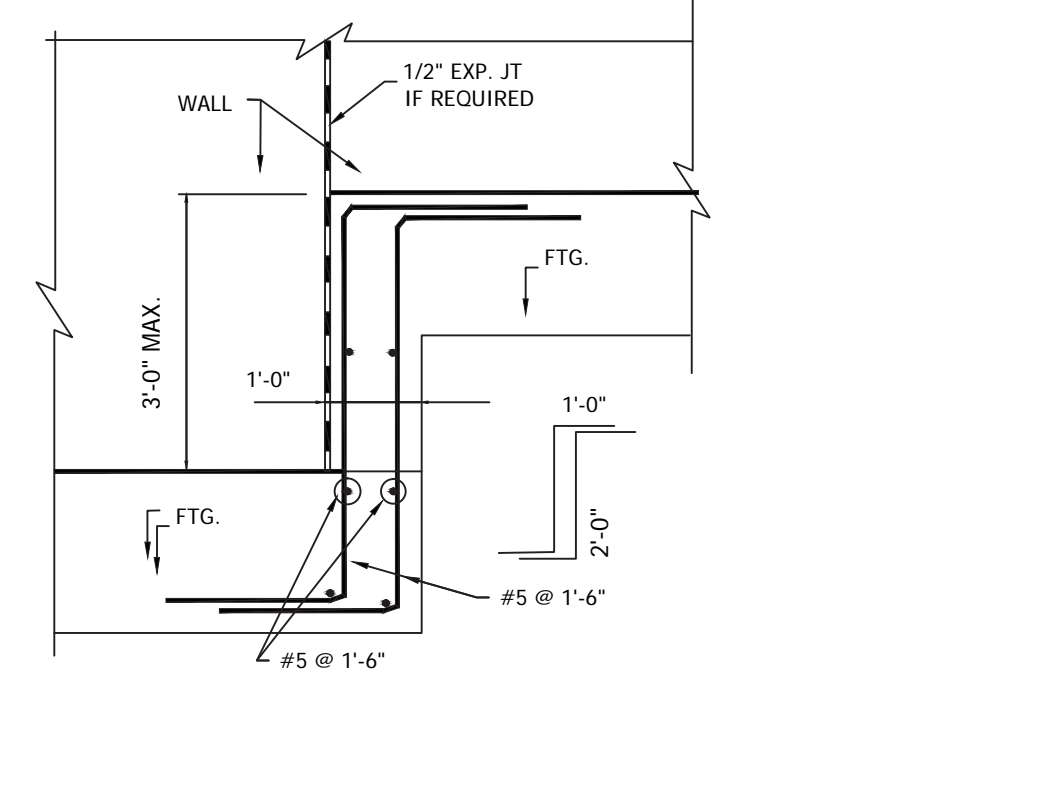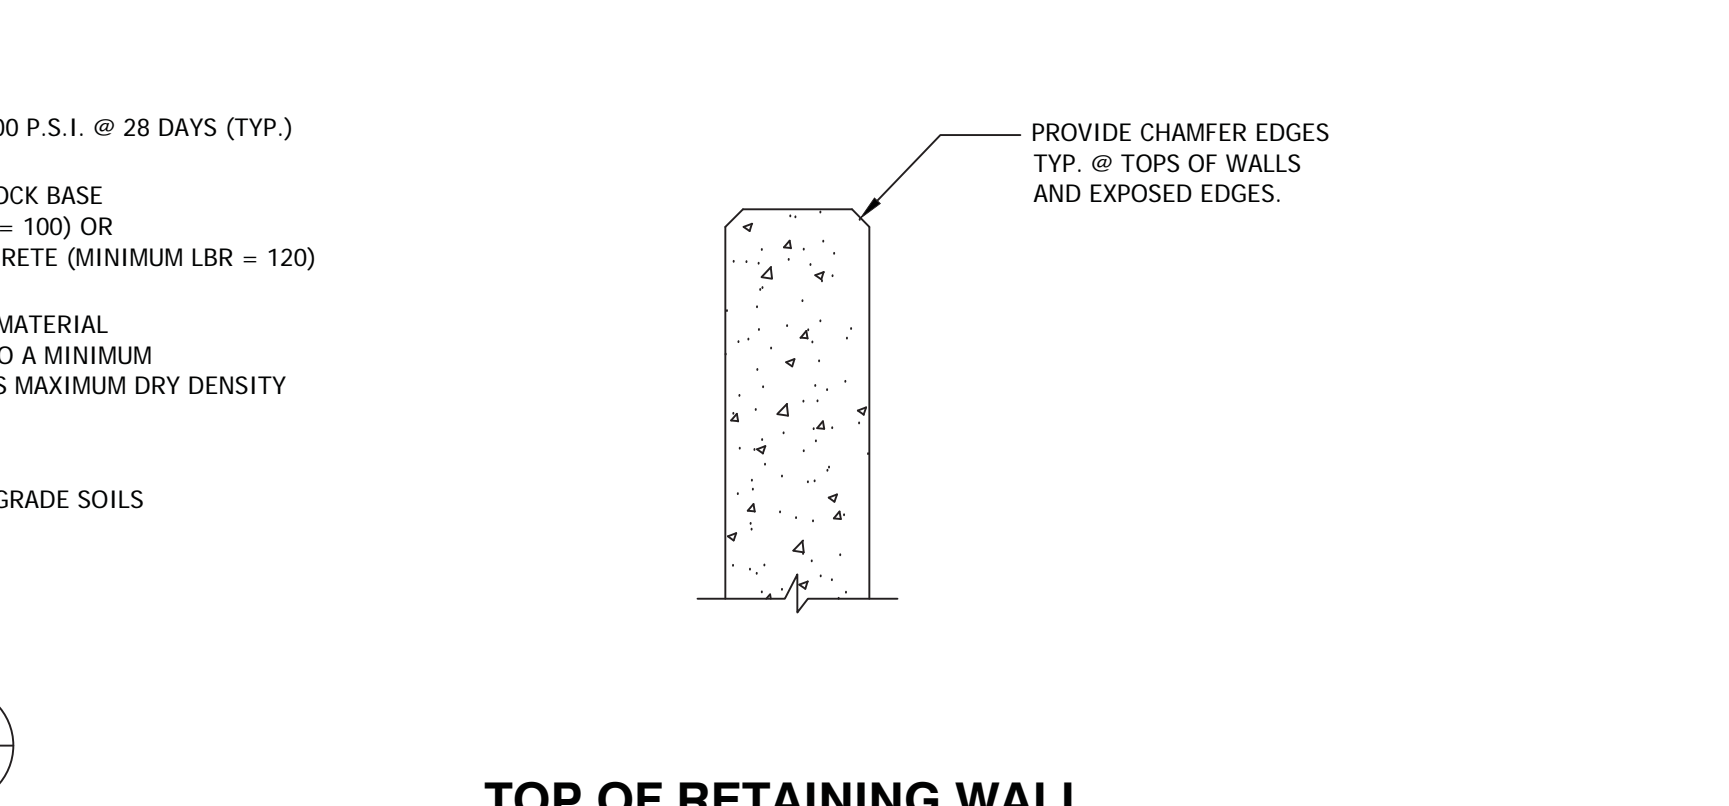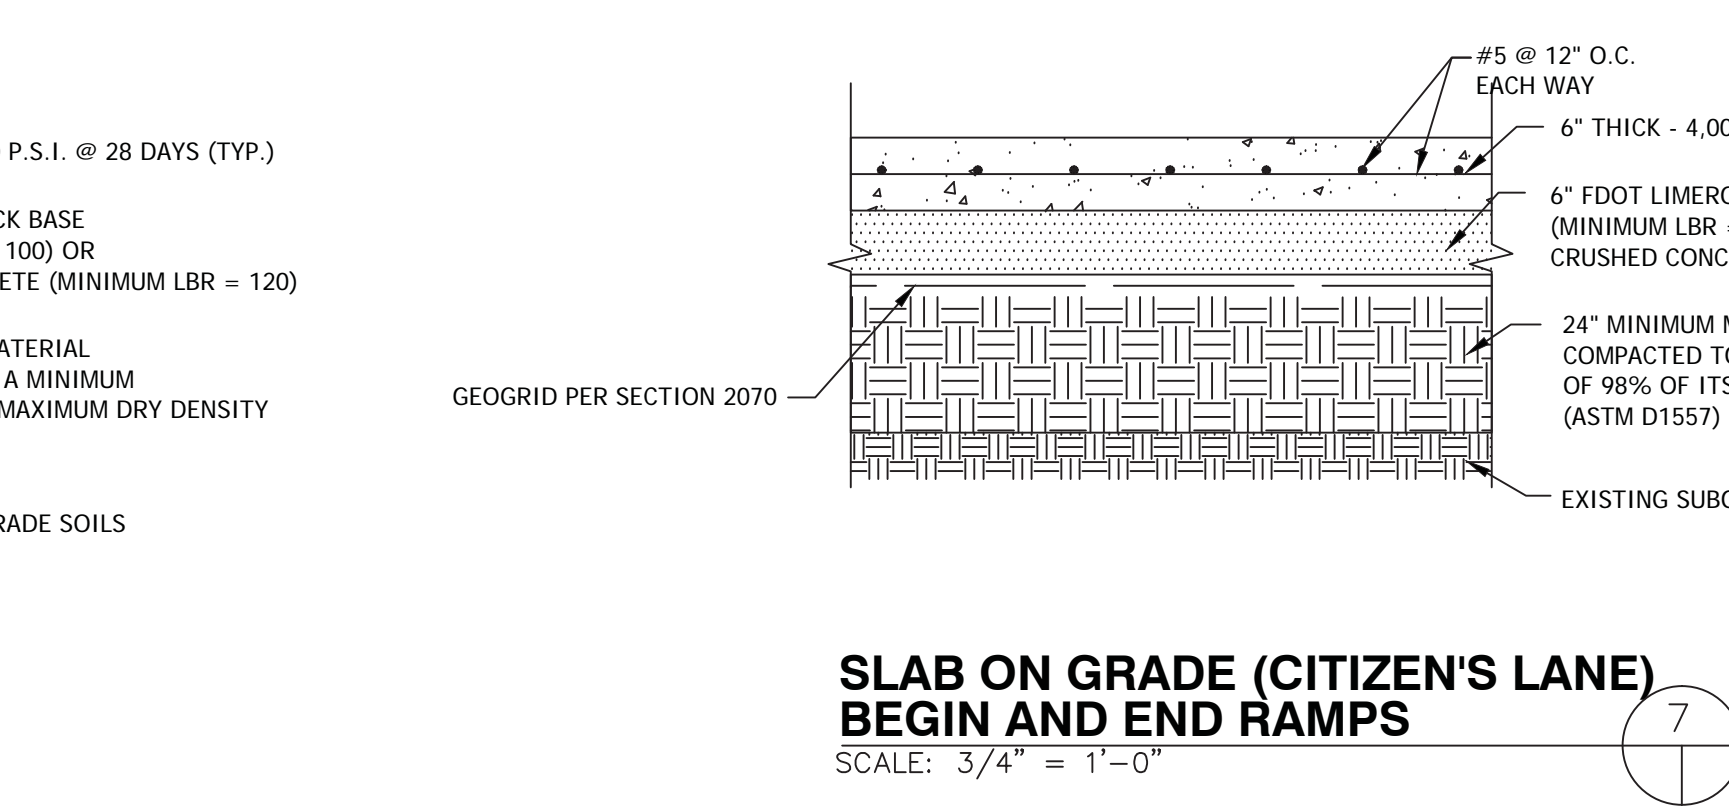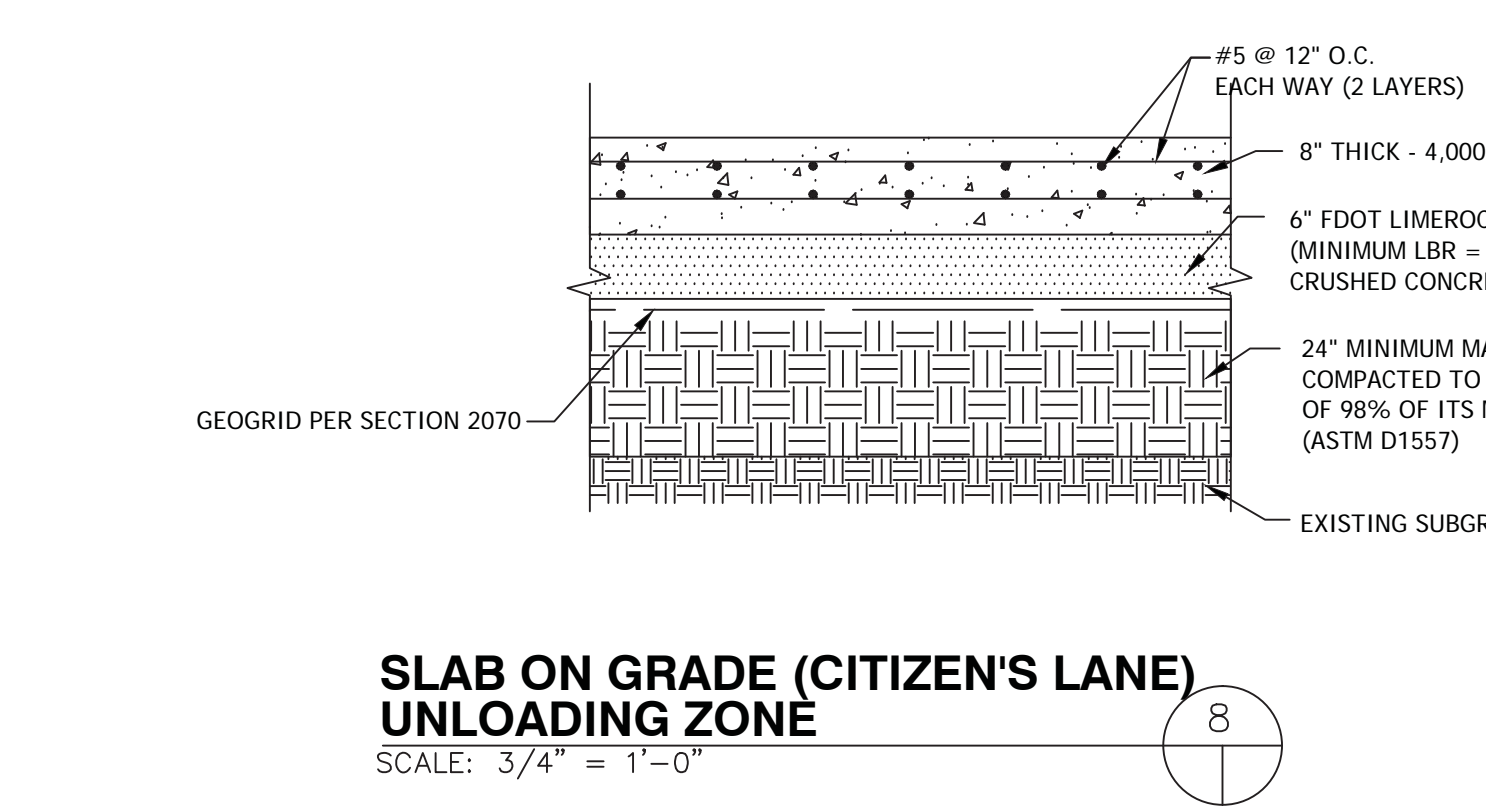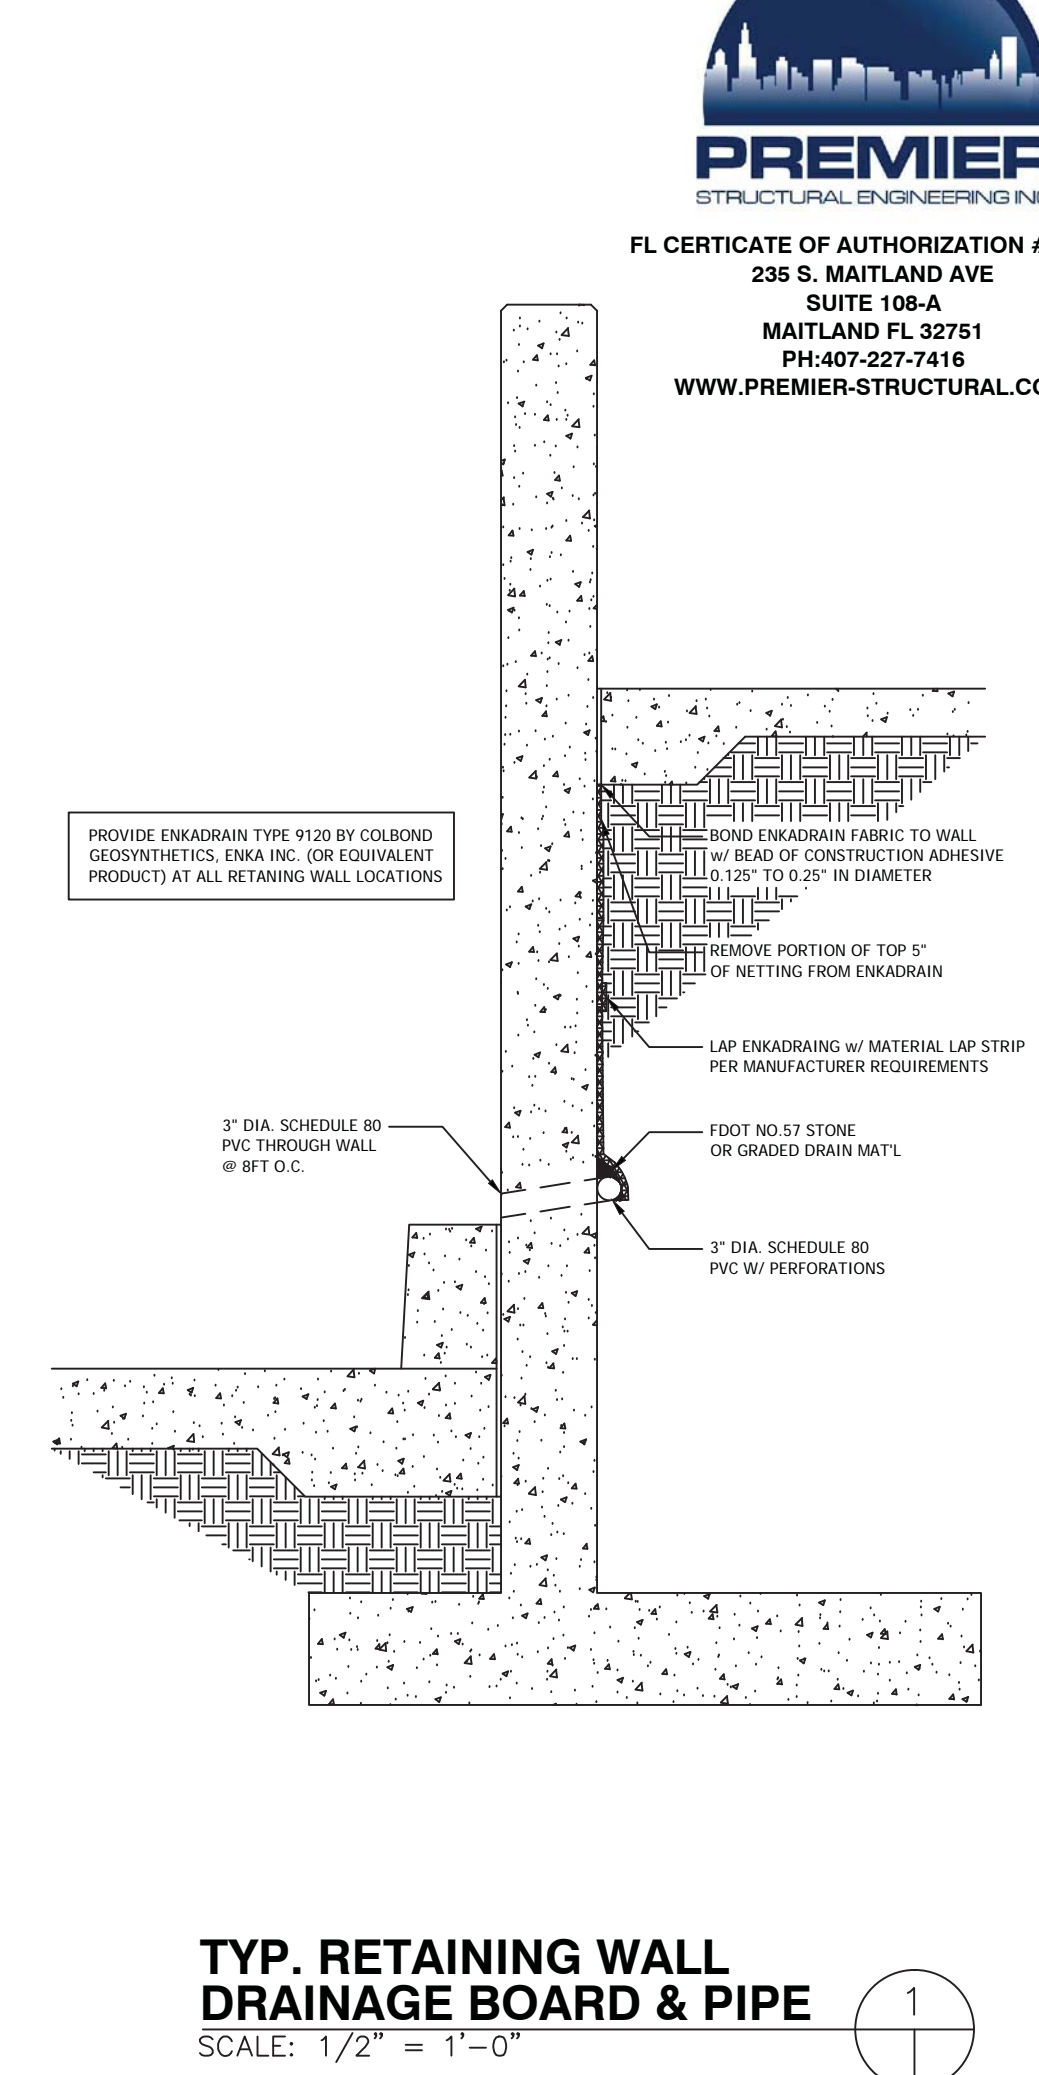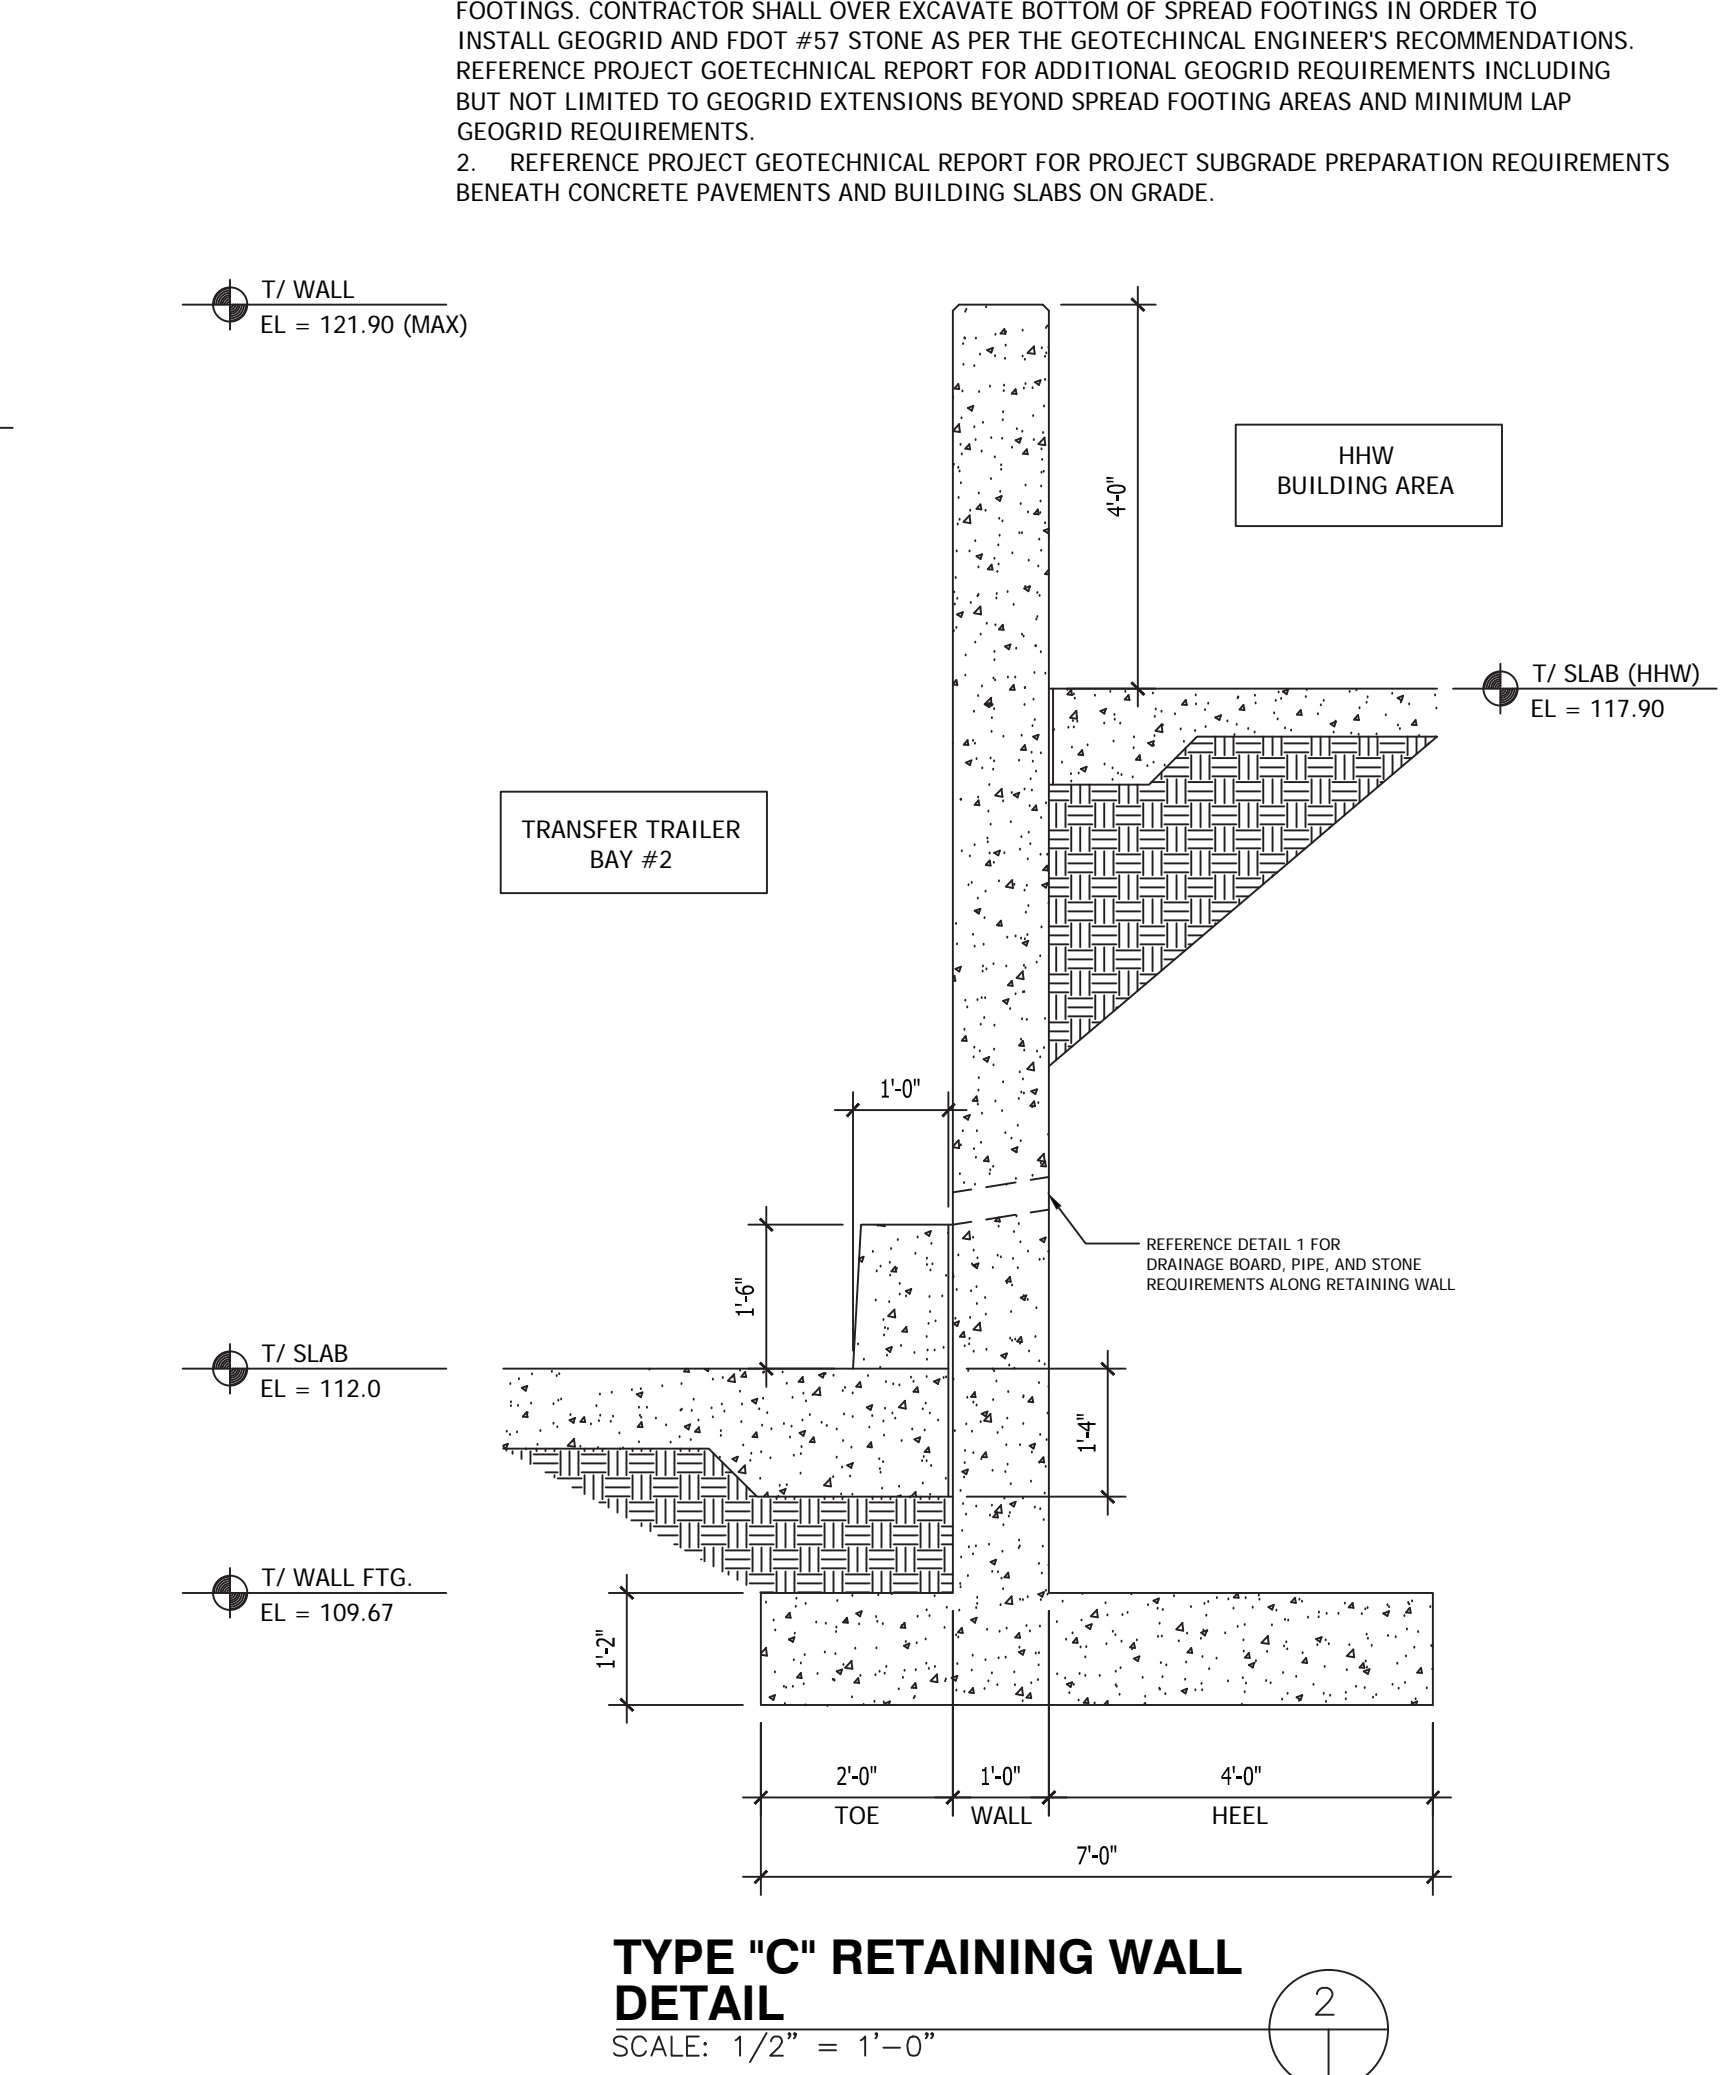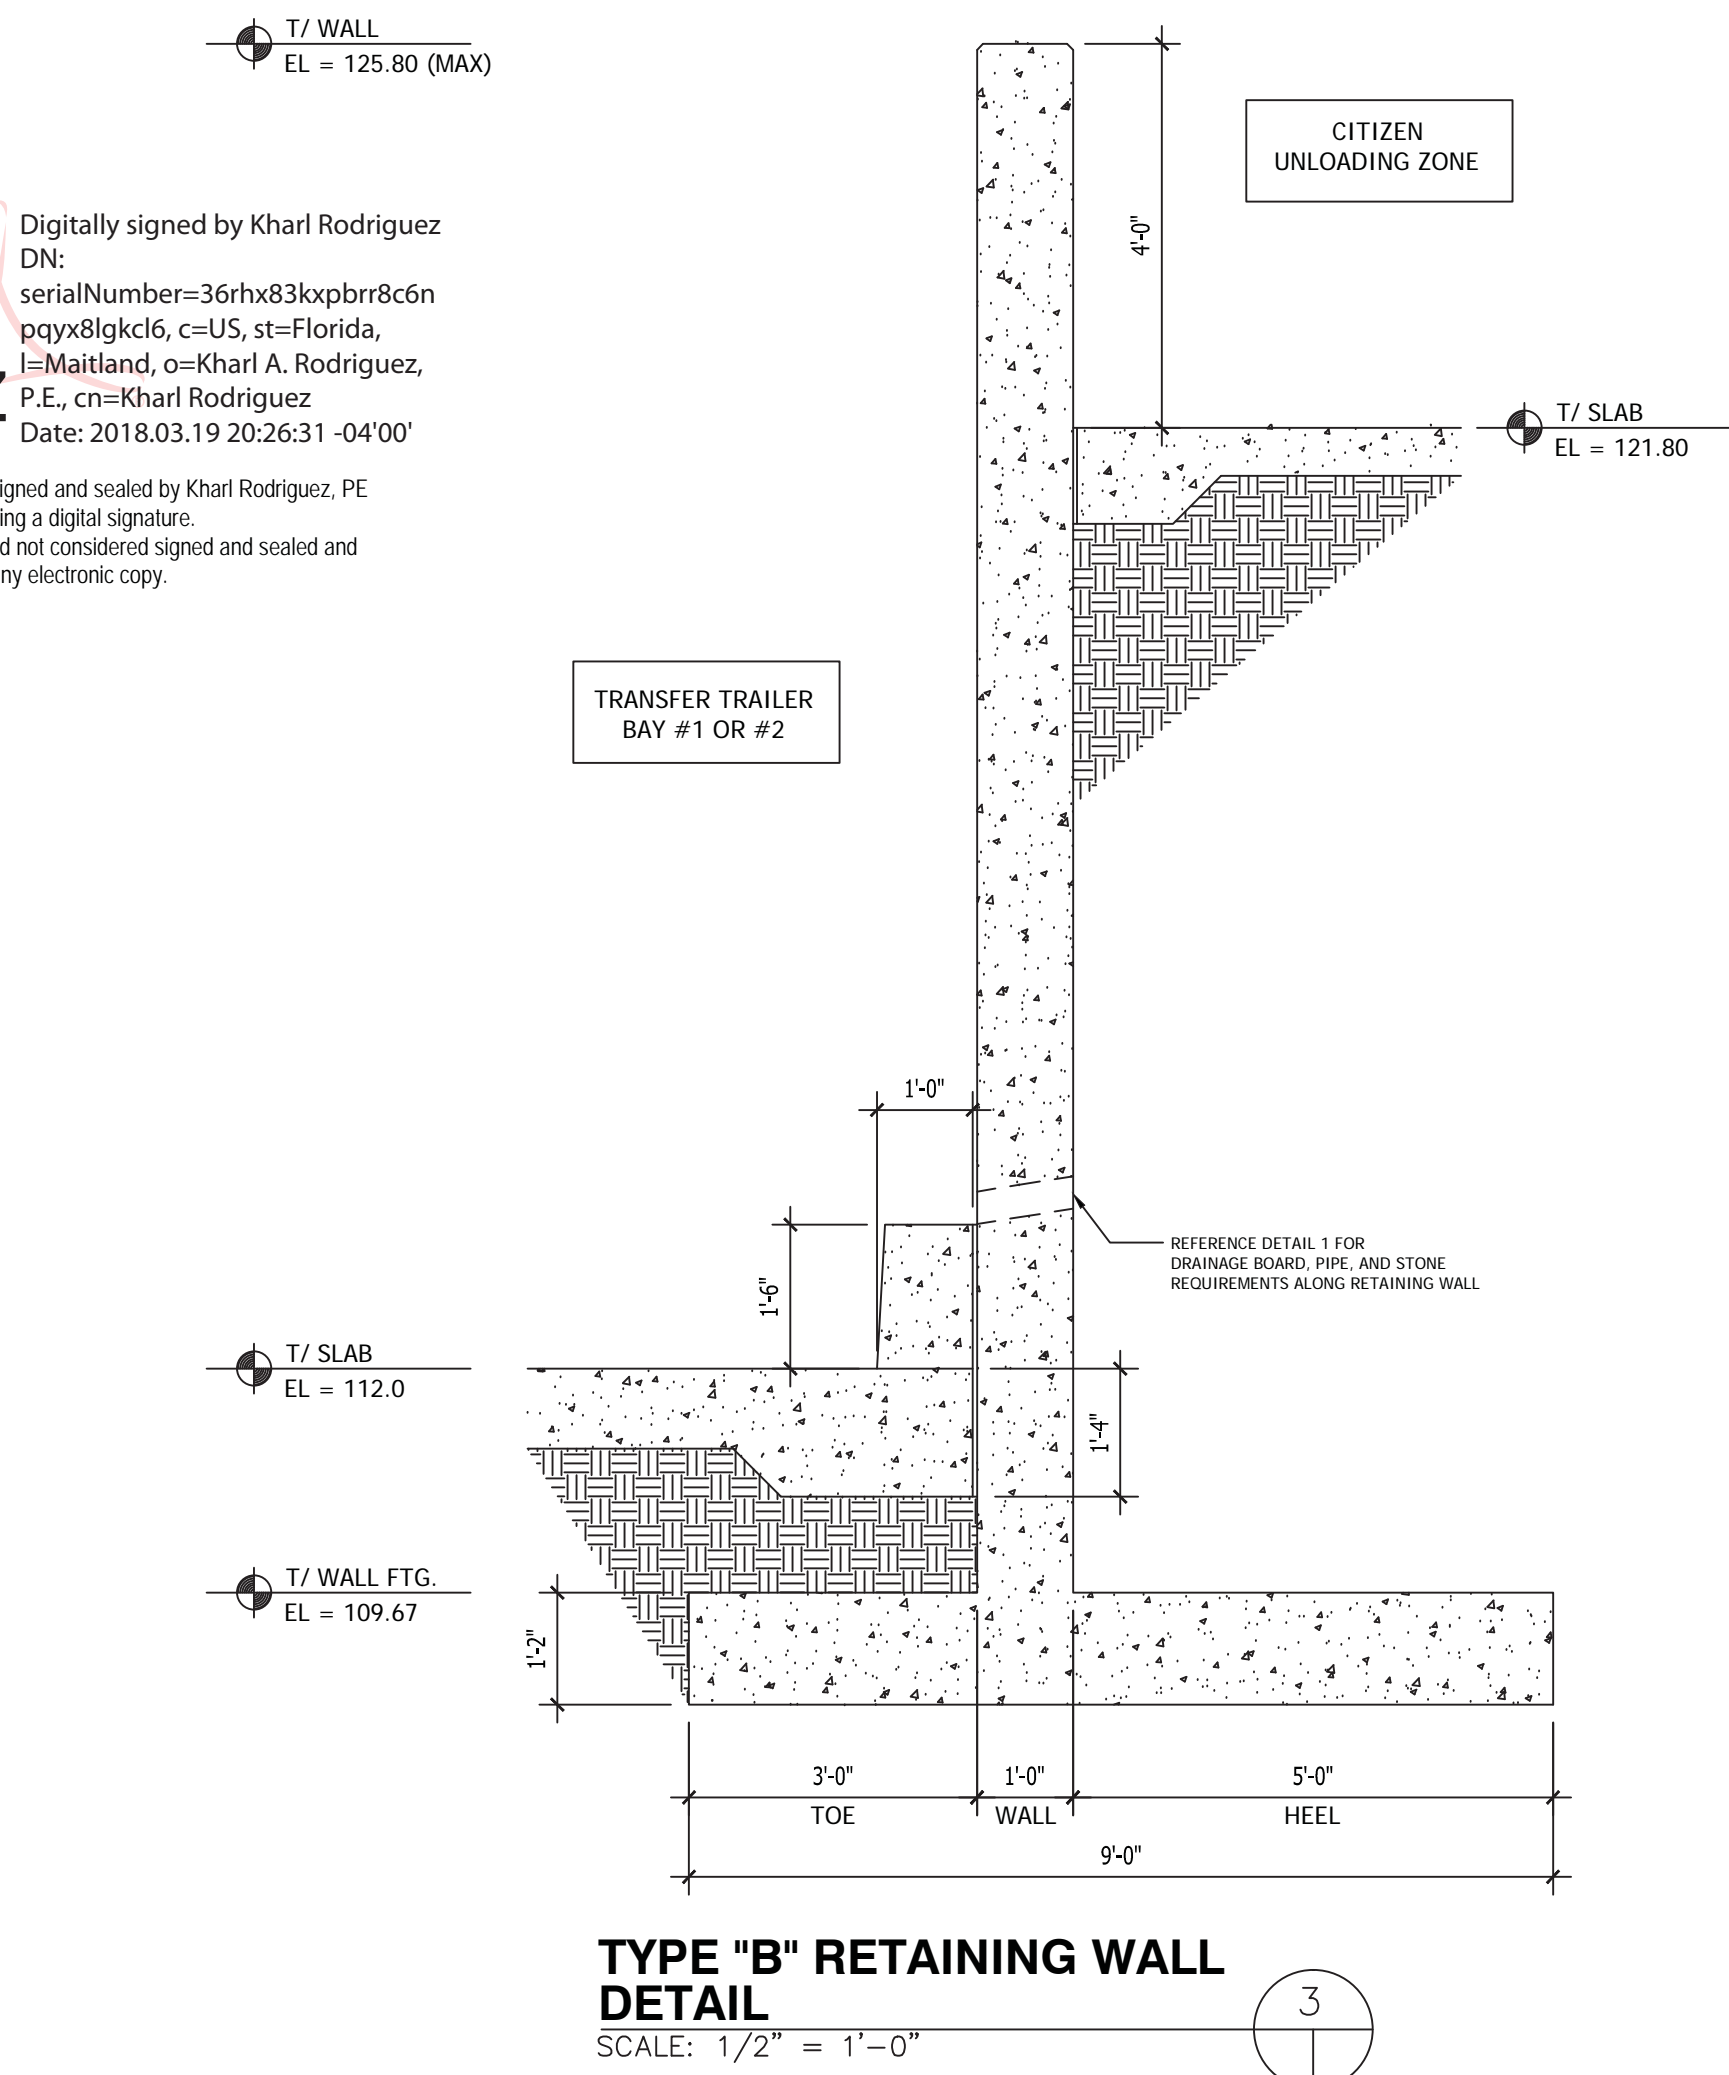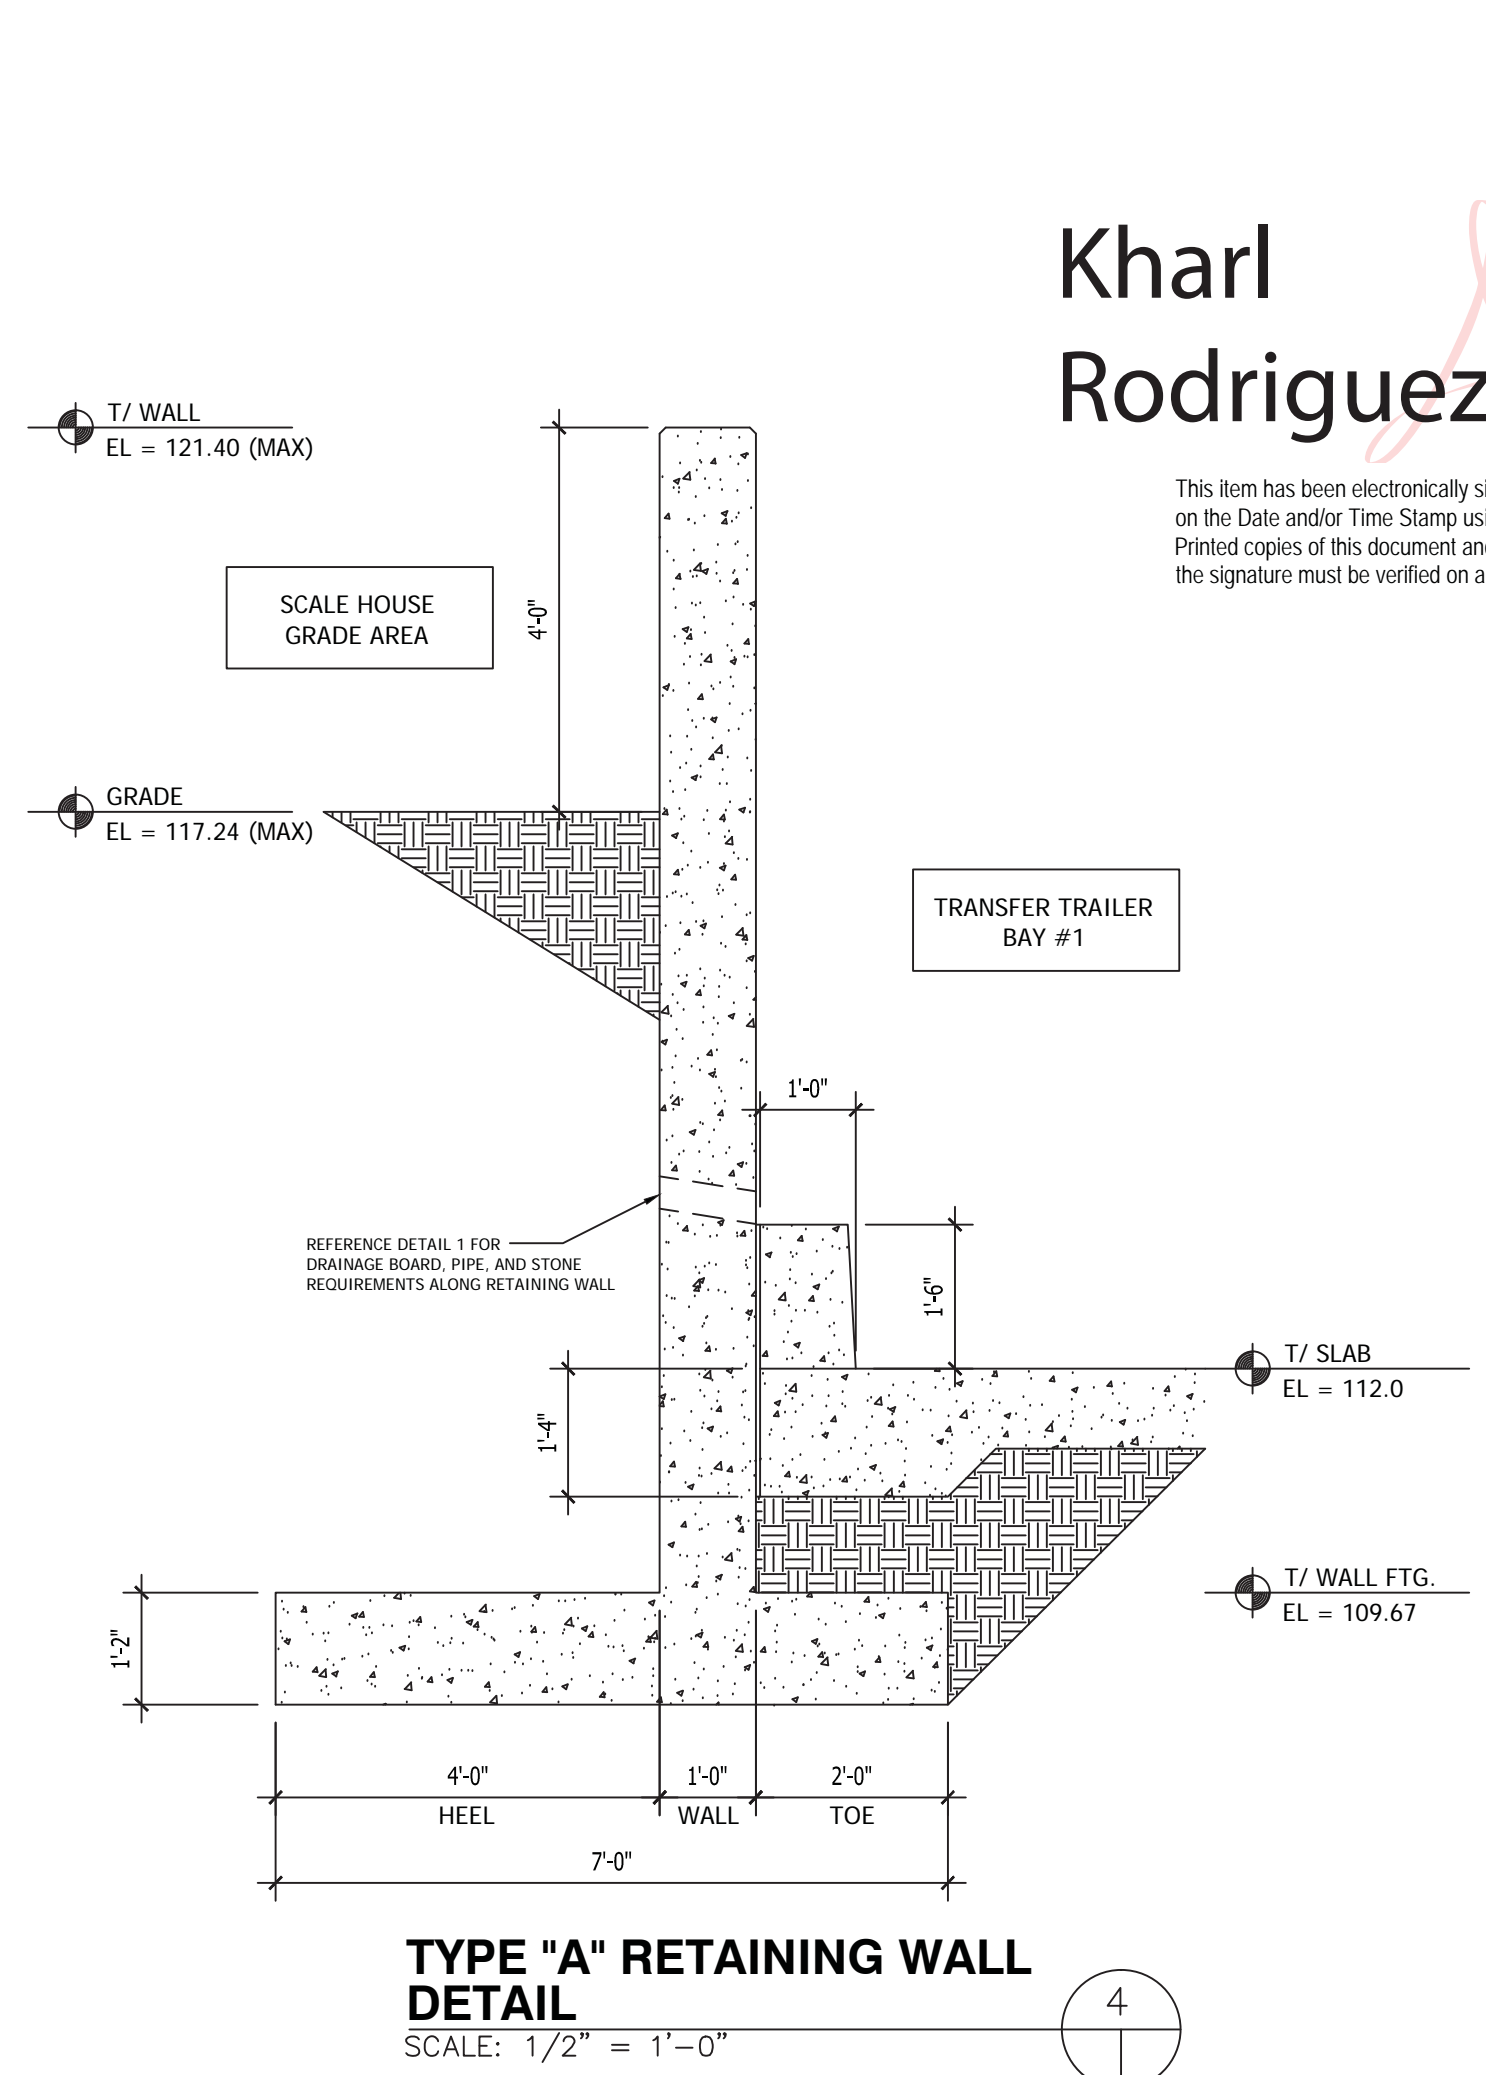

CONTRACT NOTE:
1. PROVIDE GEOGRID PER SECTION 2070 BELOW ALL RETAINING WALL AND BUILDING SPREAD FOOTINGS. CONTRACTOR SHALL OVER EXCAVATE BOTTOM OF SPREAD FOOTINGS IN ORDER TO INSTALL GEOGRID AND FDOT #57 STONE AS PER THE GEOTECHNICAL ENGINEER'S RECOMMENDATIONS. REFERENCE PROJECT GEOTECHNICAL REPORT FOR ADDITIONAL GEOGRID REQUIREMENTS INCLUDING BUT NOT LIMITED TO GEOGRID EXTENSIONS BEYOND SPREAD FOOTING AREAS AND MINIMUM LAP GEOGRID REQUIREMENTS.
2. REFERENCE PROJECT GEOTECHNICAL REPORT FOR PROJECT SUBGRADE PREPARATION REQUIREMENTS BENEATH CONCRETE PAVEMENTS AND BUILDING SLABS ON GRADE.

PREMIER STRUCTURAL ENGINEERING INC.
235 S. MAITLAND AVE
SUITE 108-A
MAITLAND FL 32751
PH:407-227-7416
WWW.PREMIER-STRUCTURAL.COM

FL CERTIFICATE OF AUTHORIZATION #29116
KHARL A. RODRIGUEZ, PE
LICENSE NO. 60239

CHK. BY	DESCRIPTION	DATE	REV

RETAINING WALL SECTIONS & DETAILS
PORTER TRANSFER STATION
SITE IMPROVEMENTS

ORANGE COUNTY
SOLID WASTE DIVISION
ORLANDO, FLORIDA


SCS ENGINEERS
STEARNS, CONRAD AND SCHMIDT
CONSULTING ENGINEERS
4041 PARK OAKS BLVD, SUITE 100, TAMPA, FL 33610
PH (813) 651-0080 FAX NO. (813) 623-6757
FLORIDA CERTIFICATE OF AUTHORIZATION NO. 00004892
REG. NO. 09276054-01
DWN. BY: SZF
CHK. BY: KAR
APP. BY: KAR

CADD FILE:
DATE: MARCH 2018
SCALE: AS SHOWN
DRAWING NO. S8
SHEET 25 of 34

ISSUED FOR BIDDING


CONCRETE WALL JOINT NOTES

ALL RETAINING WALLS SHALL HAVE CONSTRUCTION JOINTS OR CONTRACTION JOINTS SPACED AT NOT MORE THAN 30'-0" APART AS SHOWN. CONTRACTION JOINTS MAY BE SUBSTITUTED FOR CONSTRUCTION JOINTS FOR WALL POURS LONGER THAN 30'-0" EXPANSION JOINTS SHALL BE PROVIDED AT INTERVALS NOT EXCEEDING 90'-0". FOOTING MAY BE CONTINUOUS WITH NO JOINTS (EXCEPT AT FOOTING STEP LOCATIONS).

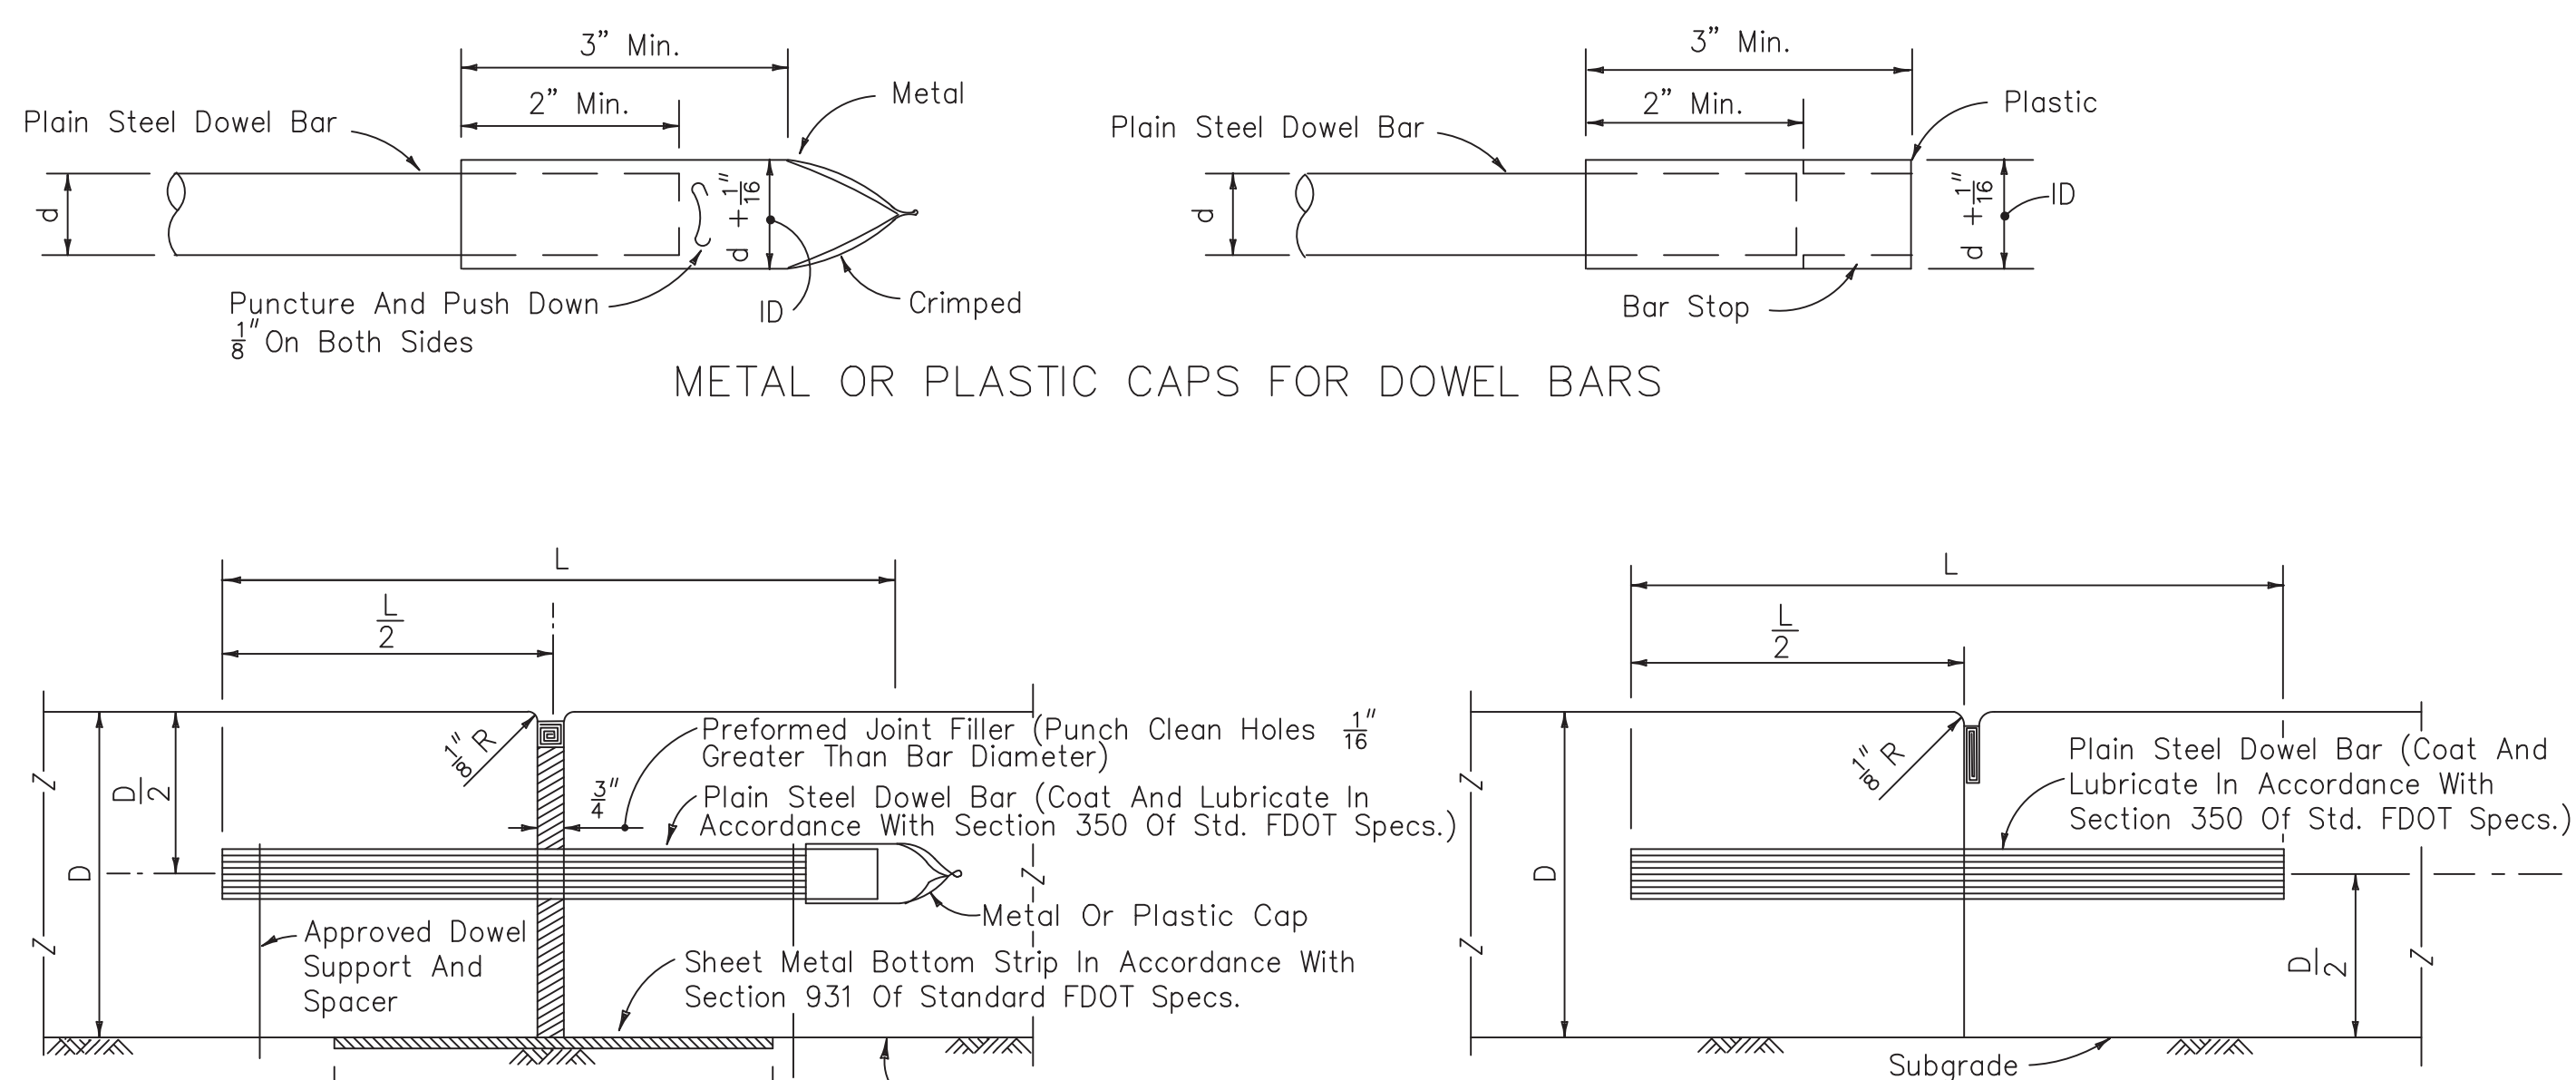

Note: Expansion joints to be placed on approaches to bridges, at street intersections and other locations indicated in detail plans.

TRANSVERSE EXPANSION JOINT

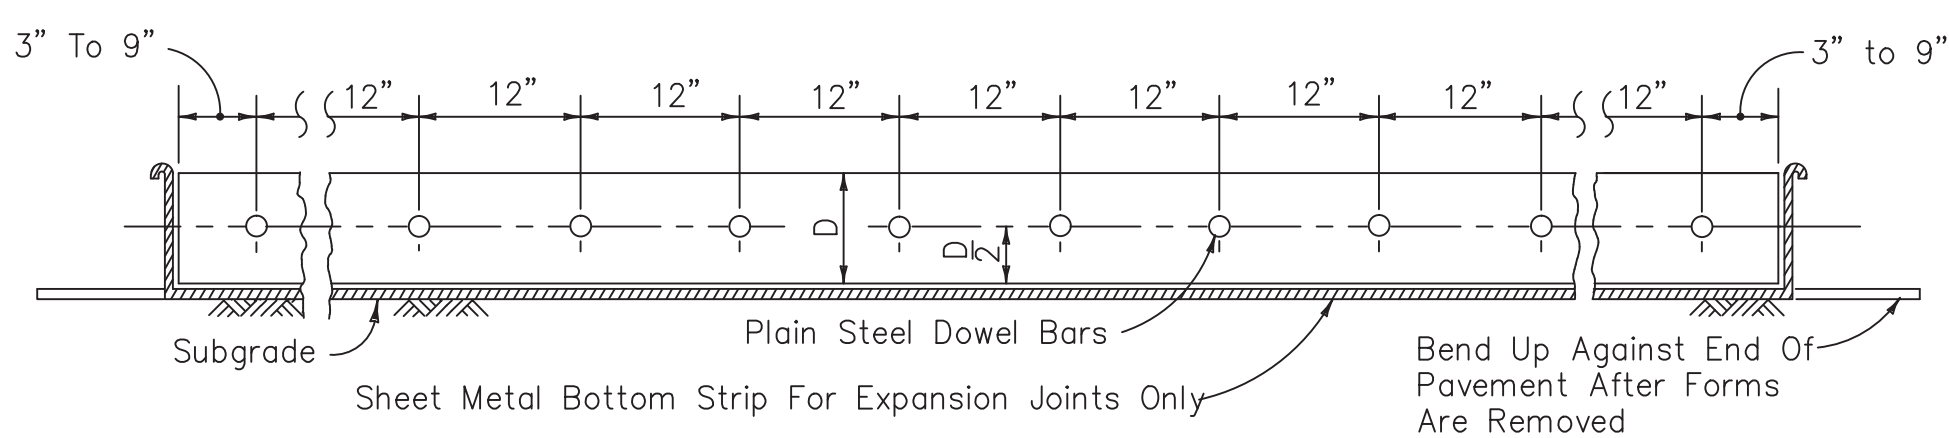


DOWEL BAR LAYOUT

DOWELS (LENGTH 18")	
Pavement Thickness "D"	Diameter
6"	3/4"
7"	1"
8"	1 1/4"
9"	1 1/2"
10"	1 3/4"
11"	1 3/4"
12"	1 3/4"

TRANSVERSE JOINTS ARE TO BE SPACED AT A MAXIMUM OF 20'. DOWELS ARE REQUIRED AT ALL TRANSVERSE JOINTS UNLESS OTHERWISE NOTED IN PLANS.

TRANSVERSE JOINTS






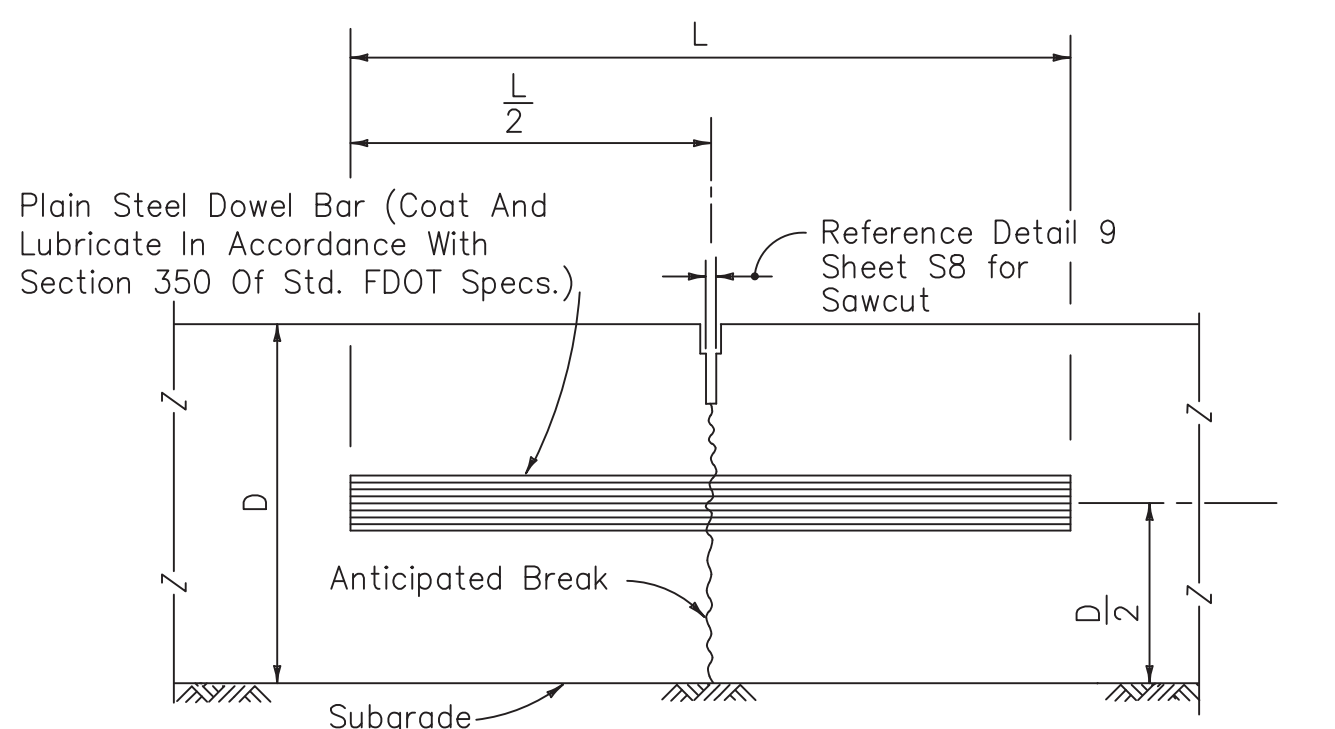


TRANSVERSE CONTRACTION JOINT, SAWED METHOD

Khari Rodriguez

Digitally signed by Khari Rodriguez
DN: serialNumber=36rhx83kxpbr8c6npxy8lgkcl6, c=US, st=Florida, l=Maitland, o=Khari A. Rodriguez, P.E., cn=Khari Rodriguez
Date: 2018.03.19 20:26:59 -04'00'

This item has been electronically signed and sealed by Khari Rodriguez, P.E. on the Date and/or Time Stamp using a digital signature. Printed copies of this document and not considered signed and sealed and the signature must be verified on any electronic copy.

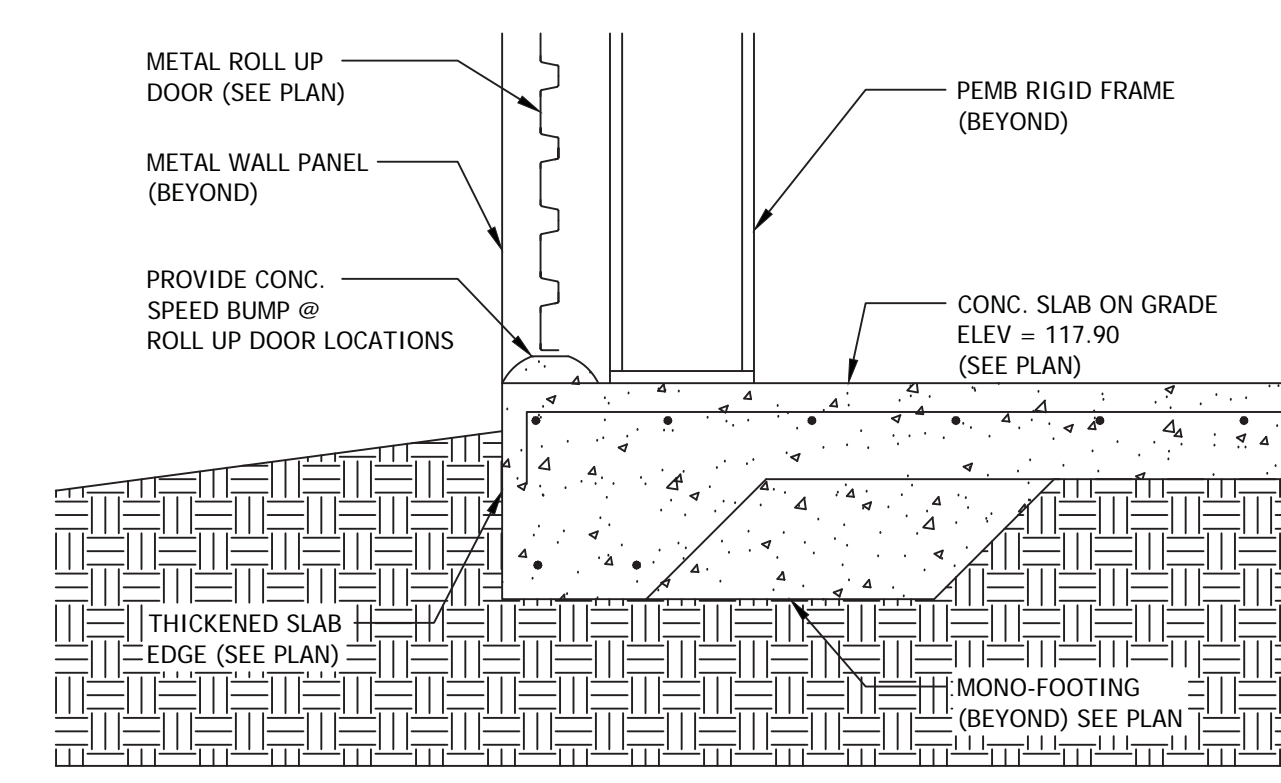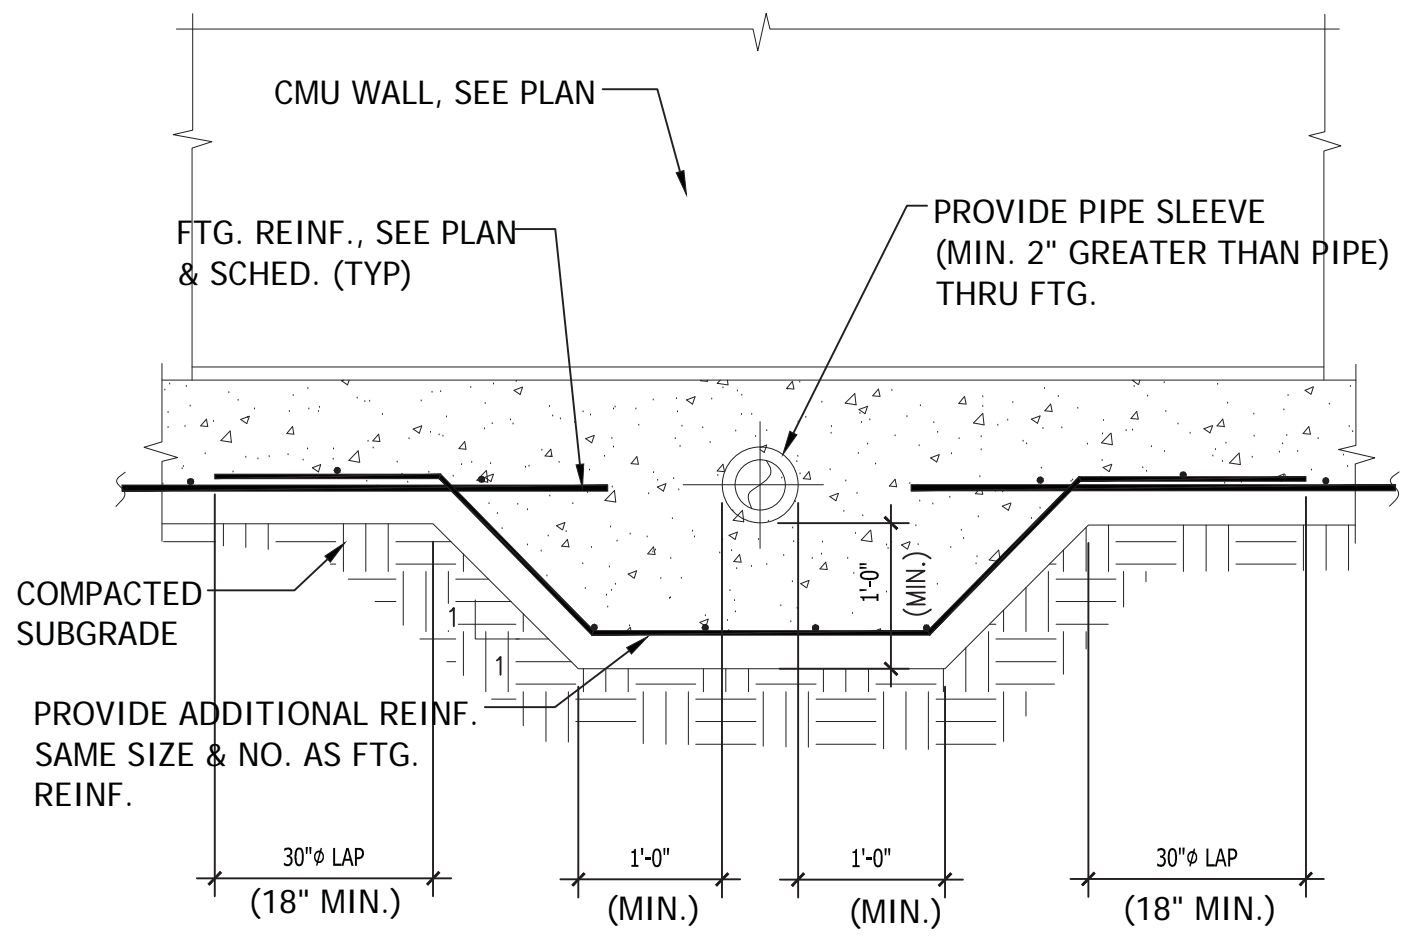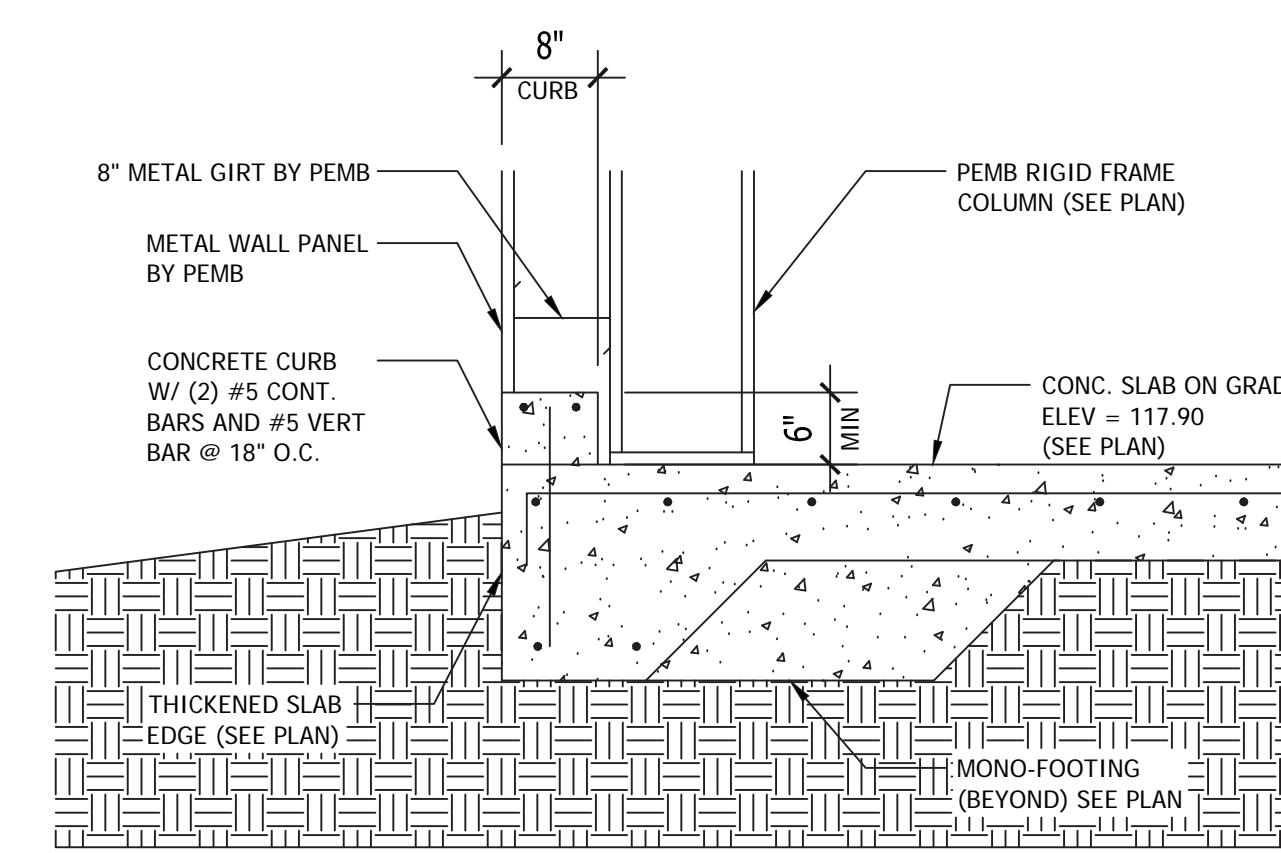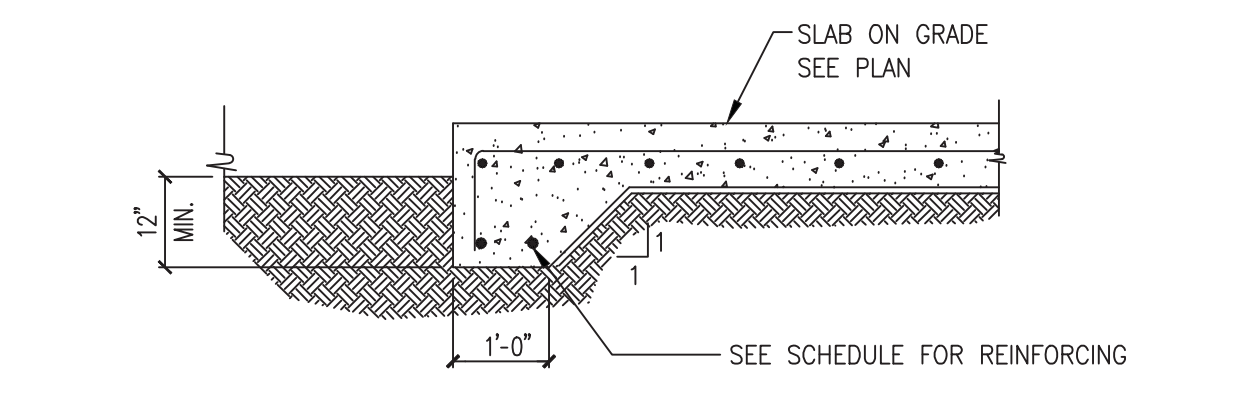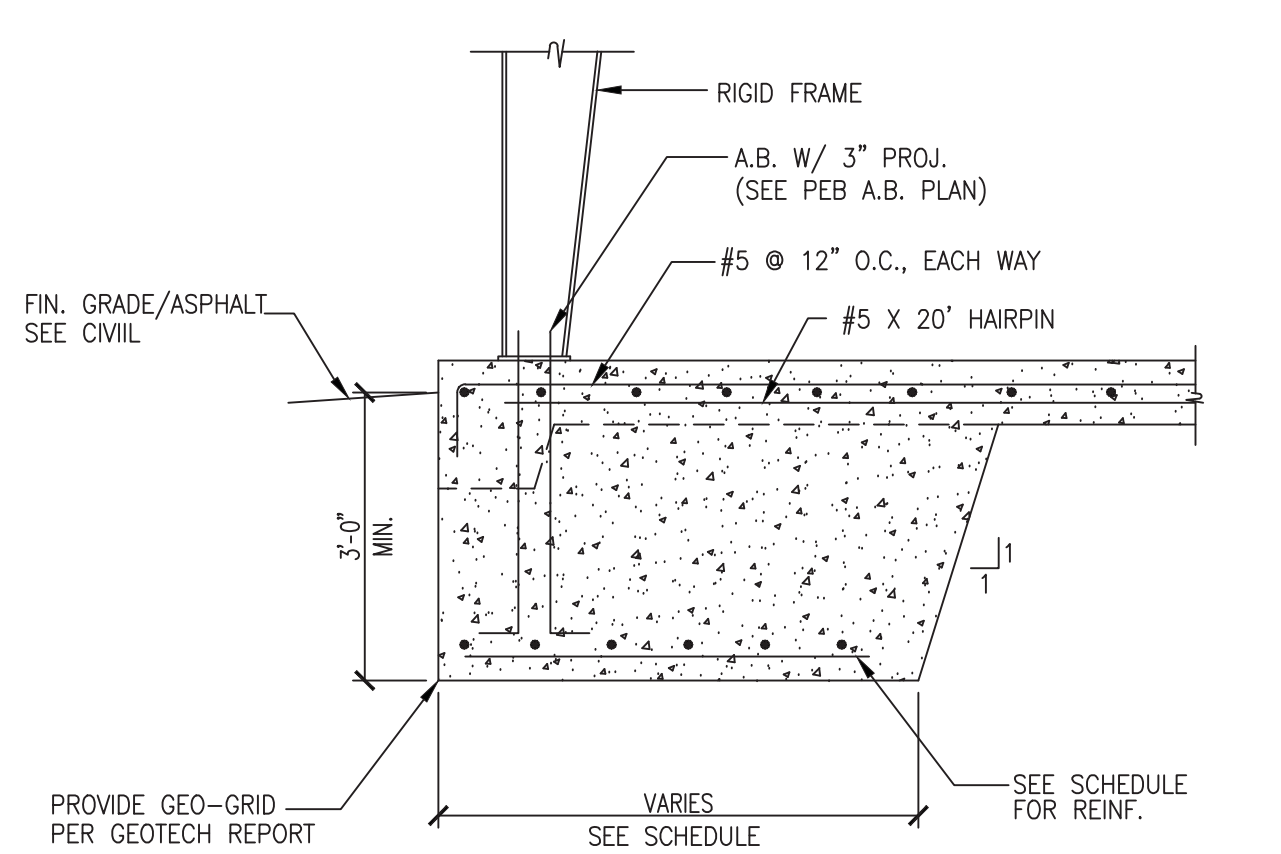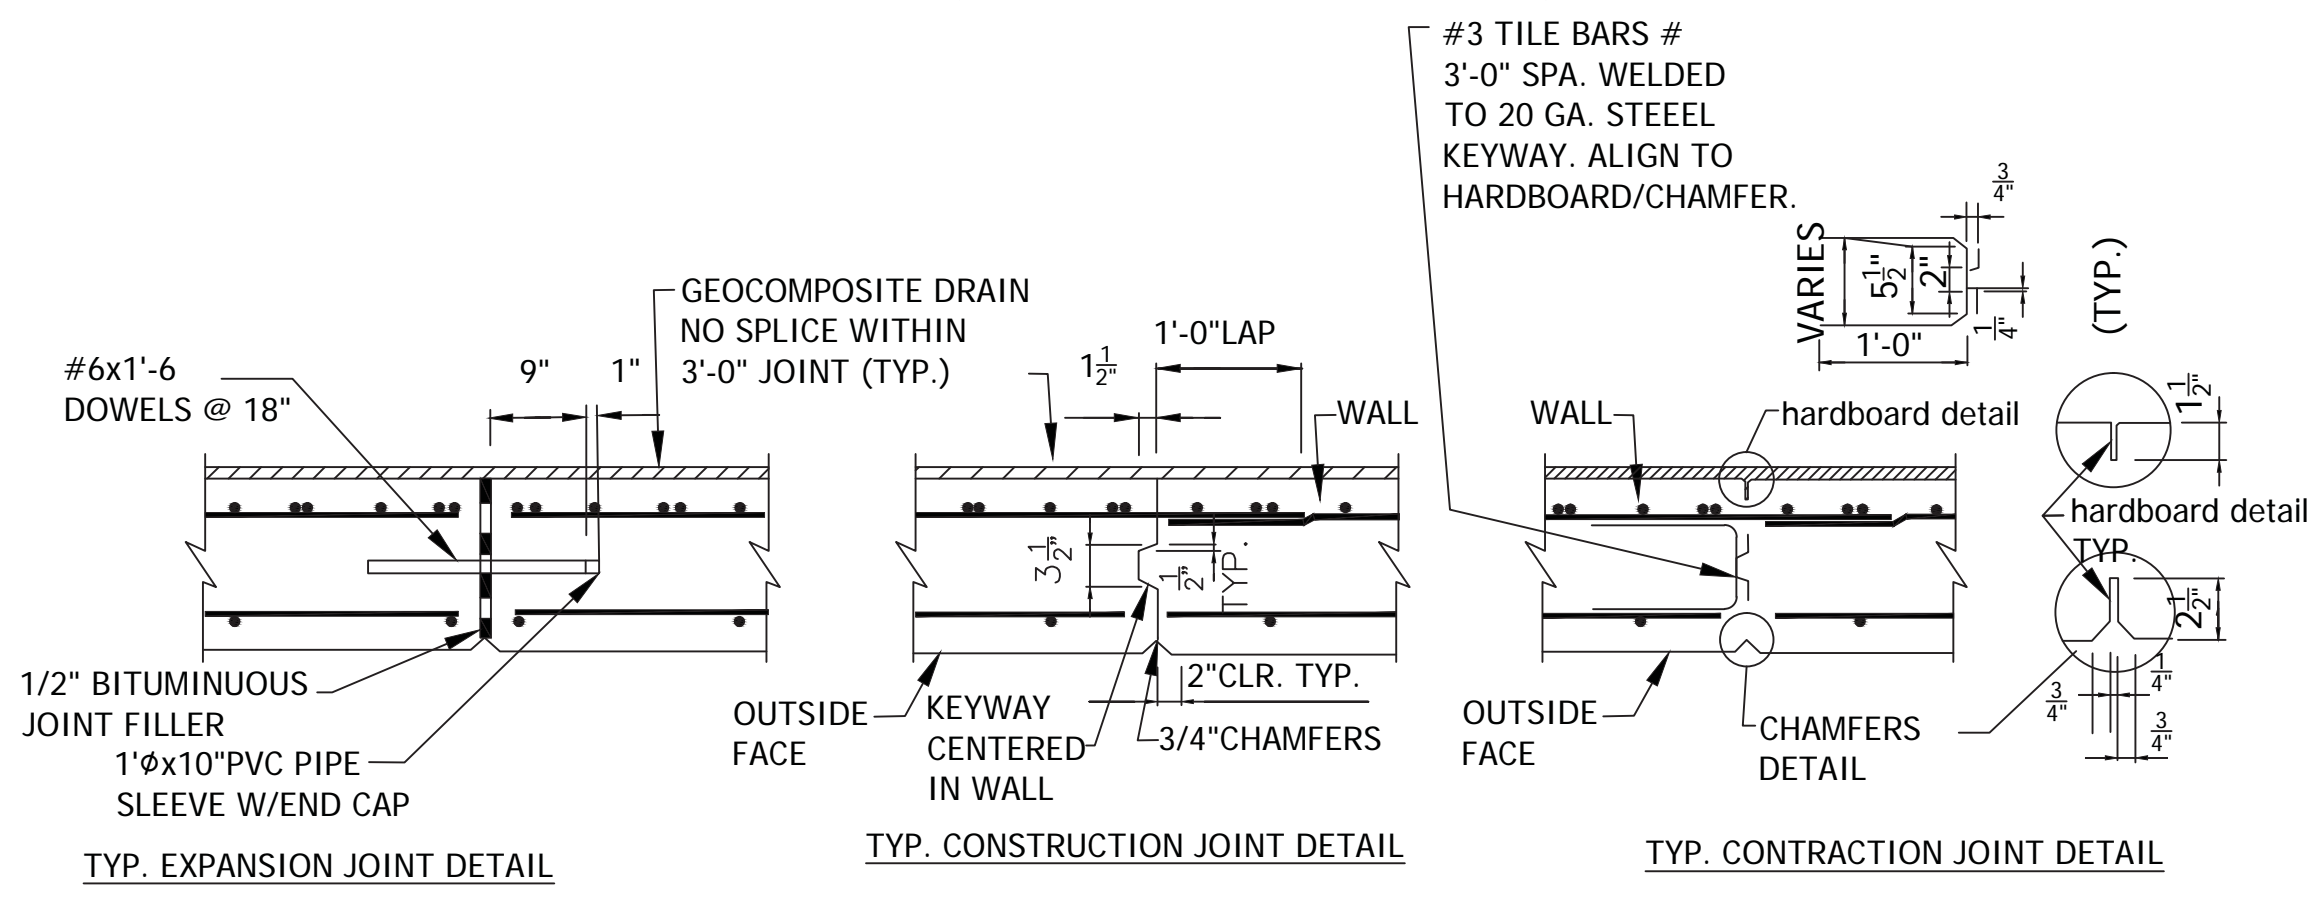

CHK. BY	DESCRIPTION	DATE	REV

SHEET TITLE
STRUCTURAL DETAILS

PROJECT TITLE
PORTER TRANSFER STATION SITE IMPROVEMENTS

CLIENT
ORANGE COUNTY SOLID WASTE DIVISION ORLANDO, FLORIDA

CADD FILE:
SCS ENGINEERS
STEARNS, CONRAD AND SCHMIDT
CONSULTING ENGINEERS
4041 PARK OAKS BLVD. SUITE 100, TAMPA, FL 33610
PH (813) 651-0080 FAX NO. (813) 623-6757
FLORIDA CERTIFICATE OF AUTHORIZATION NO. 00004892
REG. NO. 09276054.01
DWN. BY: SZF
CHK. BY: KAR
APP. BY: KAR

DATE:
MARCH 2018

SCALE:
AS SHOWN

DRAWING NO.

ISSUED FOR BIDDING

S9






SHEET 26 of 34

Khari Rodriguez
 Digitally signed by Khari Rodriguez
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CHK. BY	
DESCRIPTION	
DATE	
REV	



SHEET TITLE
HHW SECTIONS AND DETAILS
 PROJECT TITLE
PORTER TRANSFER STATION SITE IMPROVEMENTS


CLIENT
ORANGE COUNTY SOLID WASTE DIVISION
ORLANDO, FLORIDA

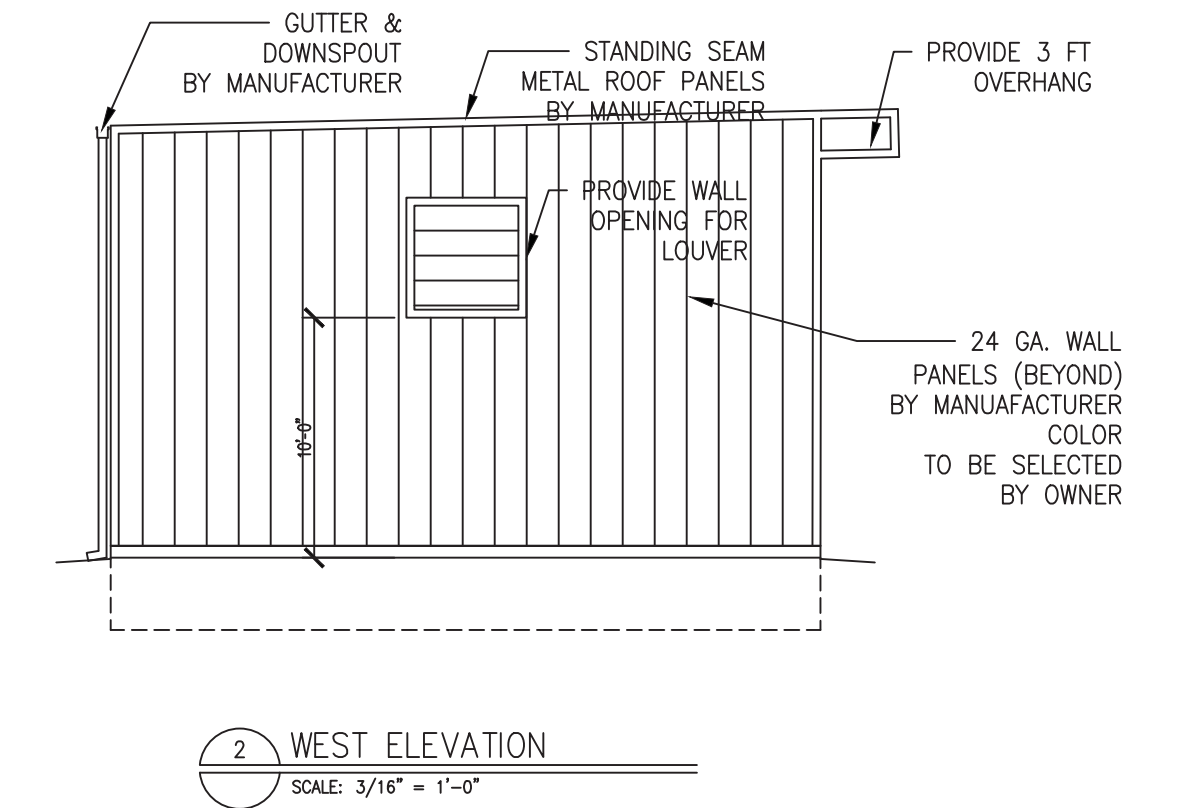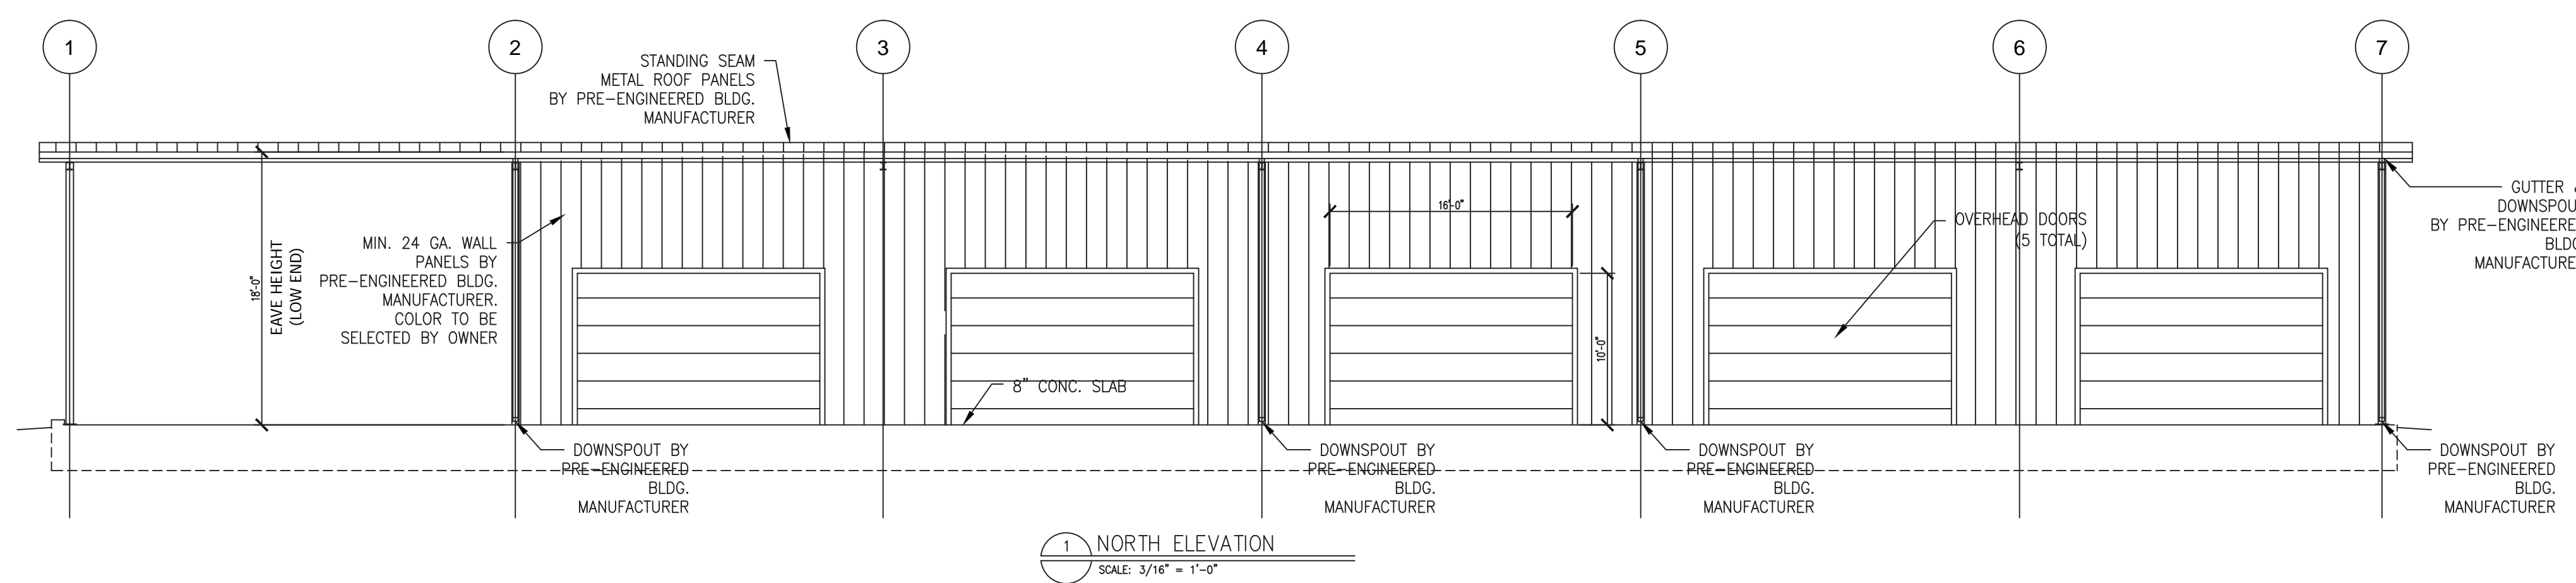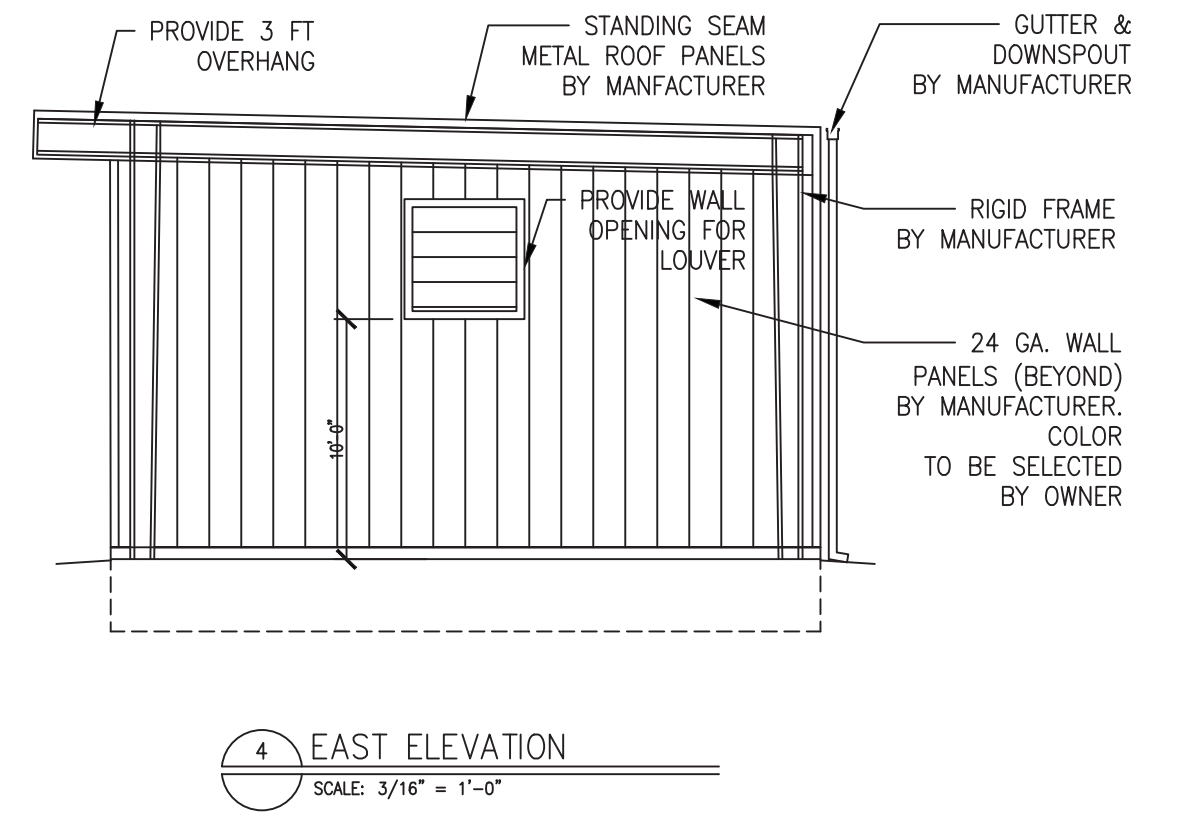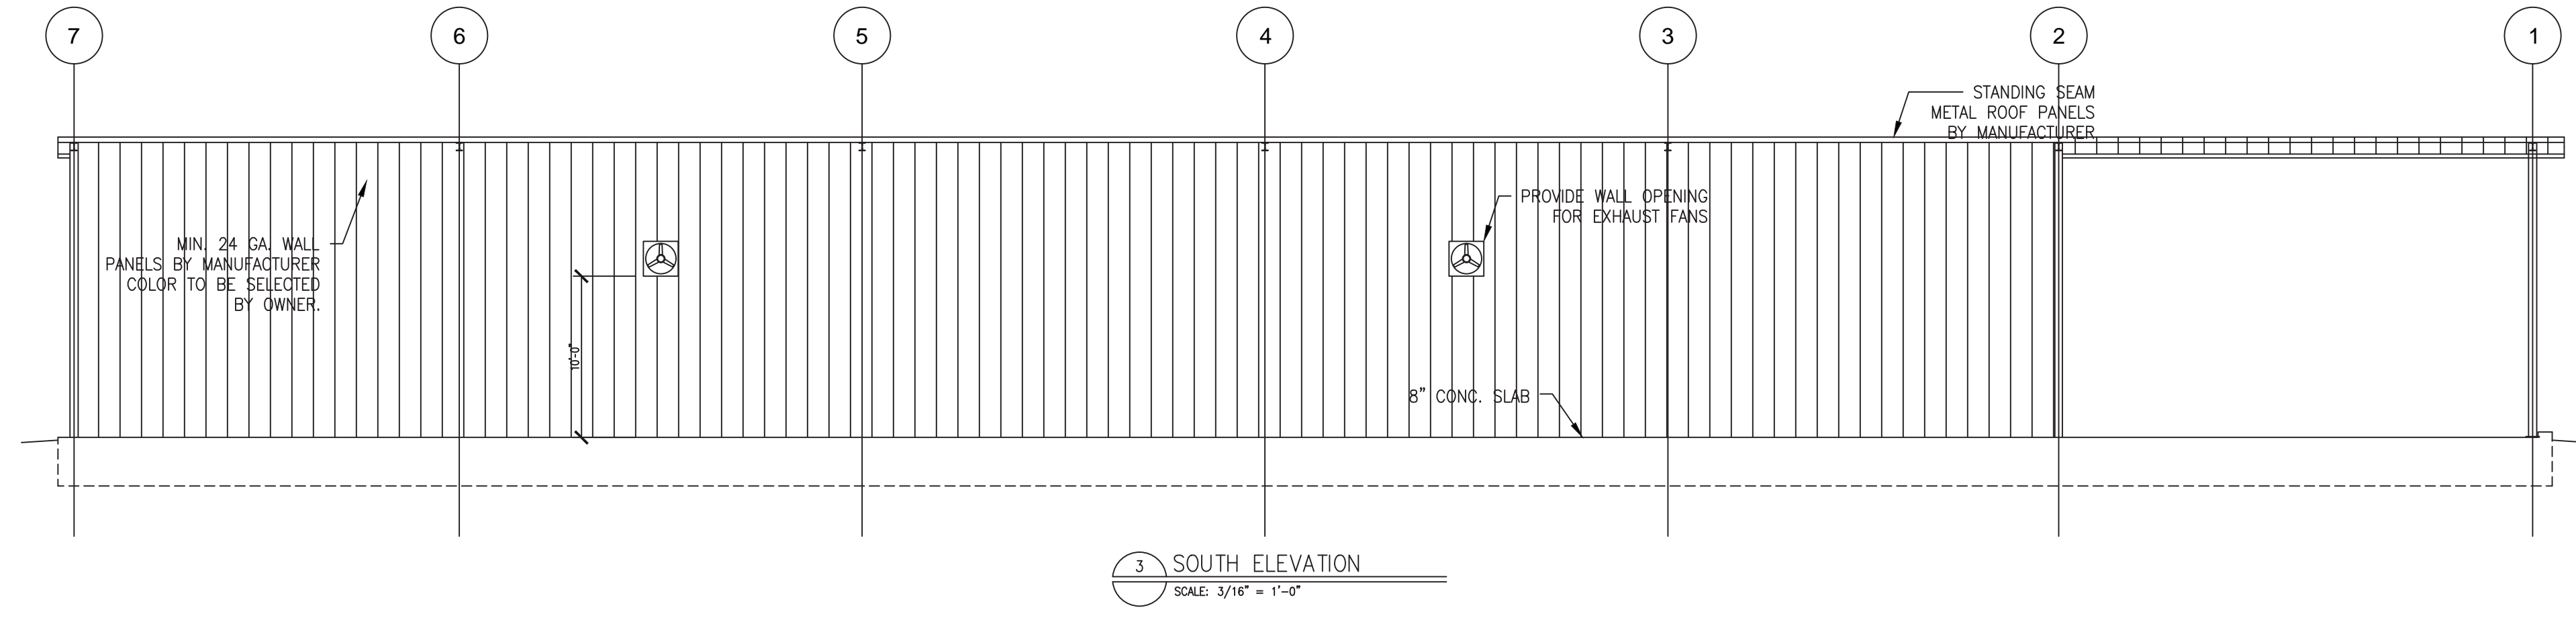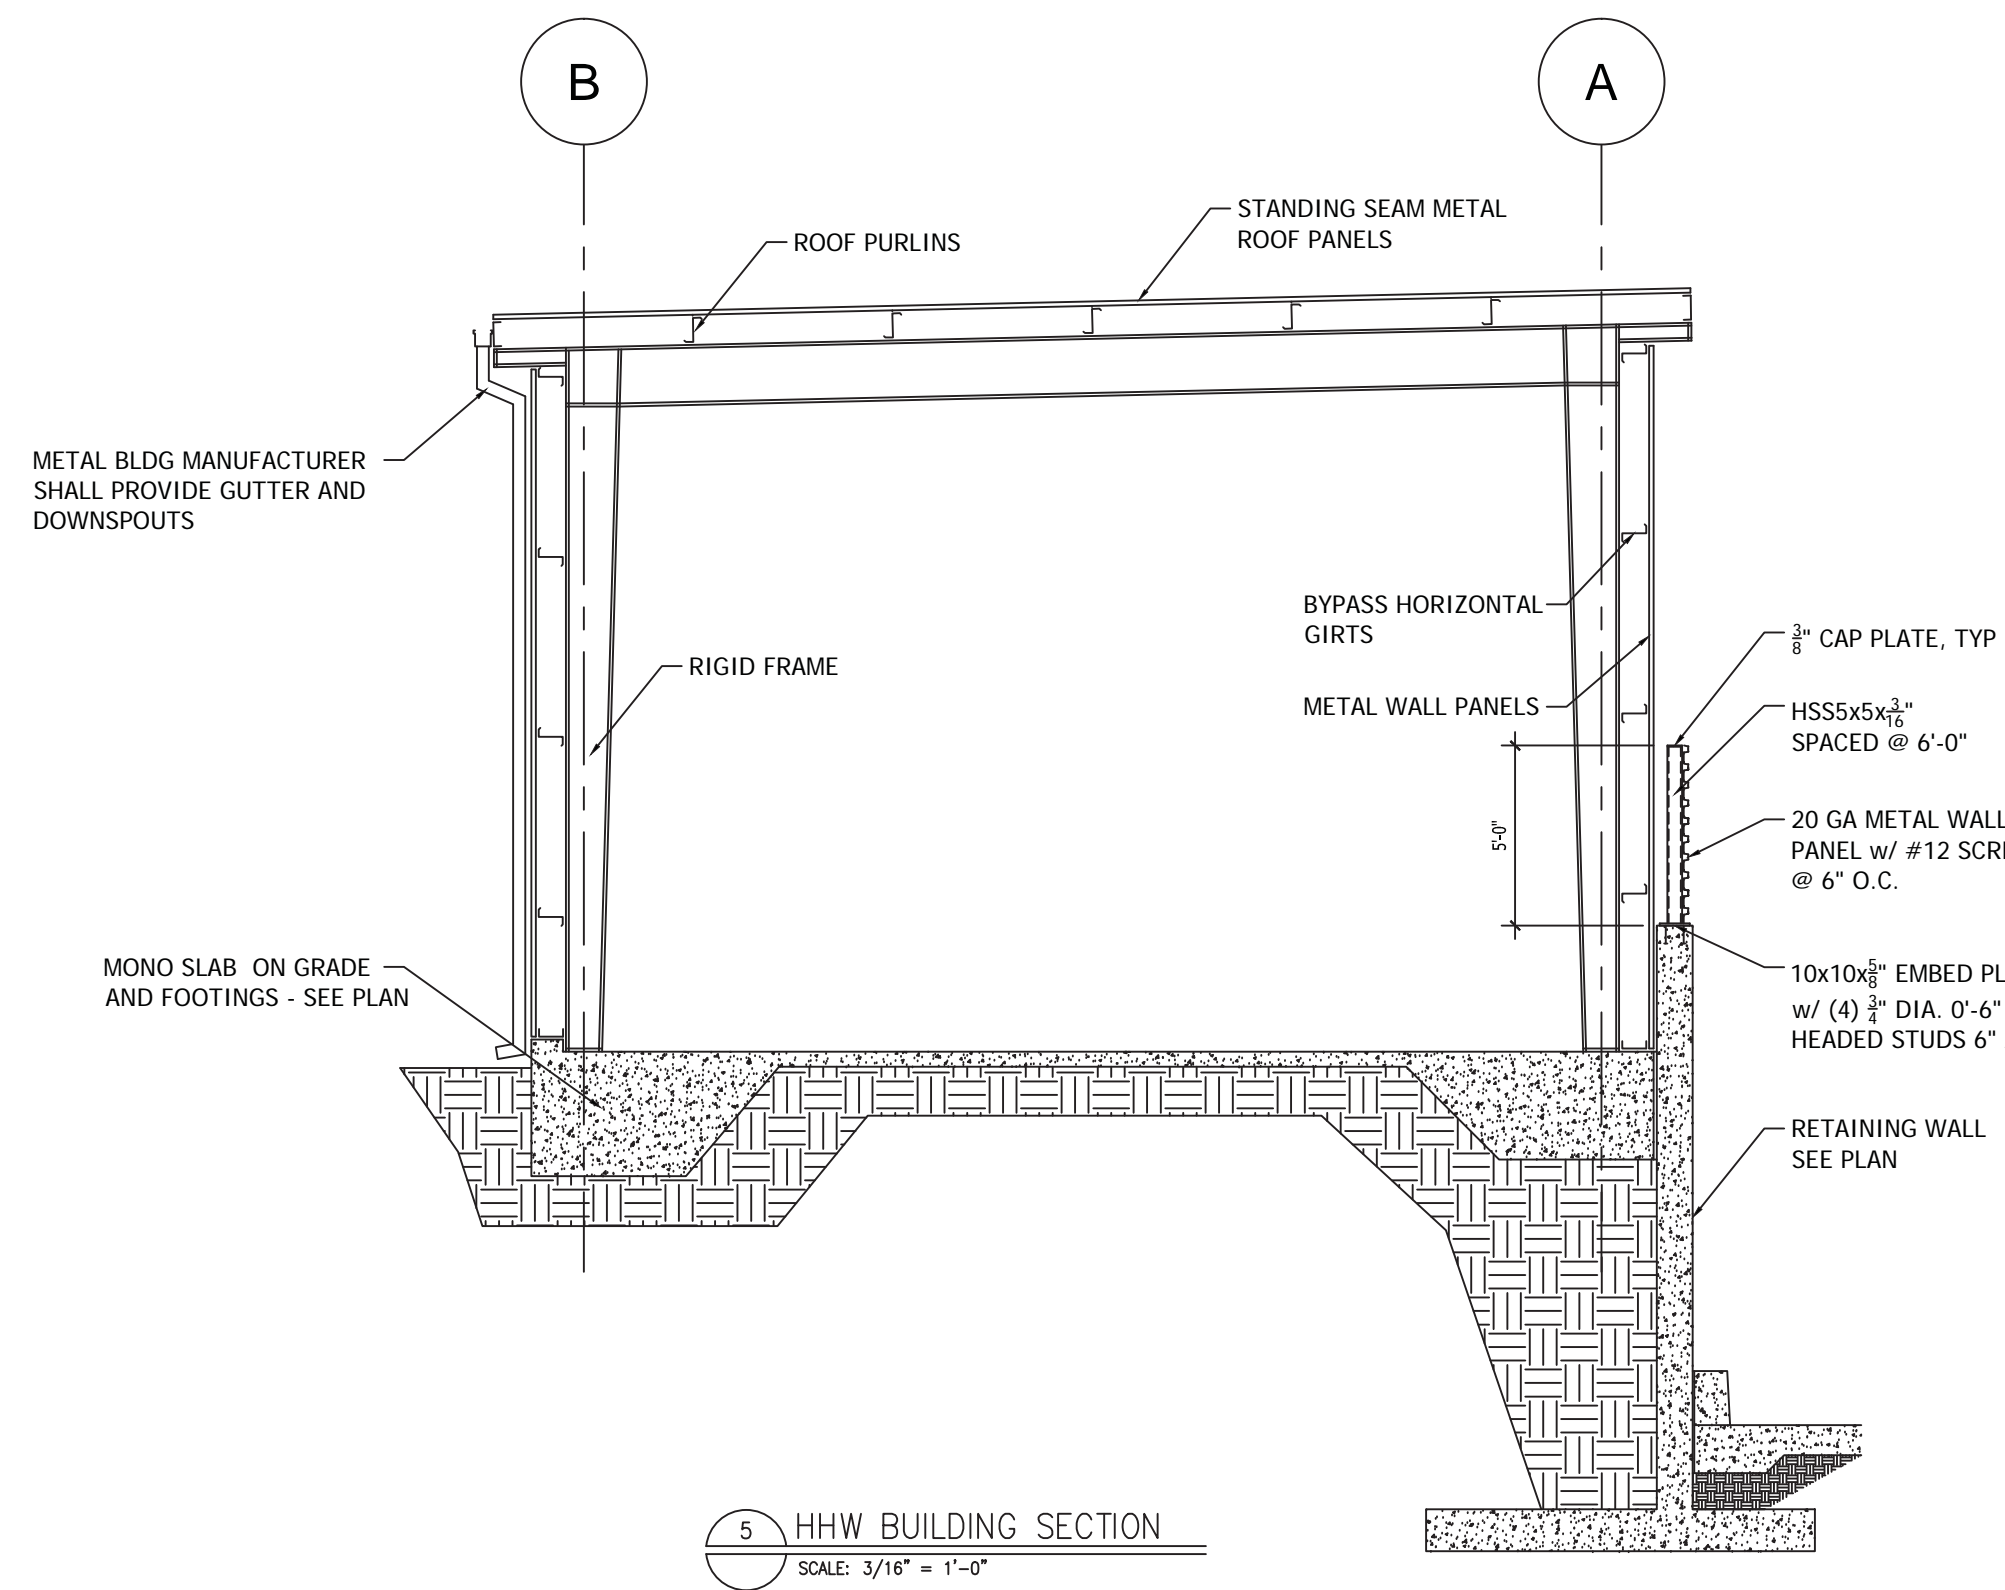SCS ENGINEERS
 STEARNS, CONRAD AND SCHMIDT
 CONSULTING ENGINEERS
 4041 PARK OAKS BLVD, SUITE 100, TAMPA, FL 33610
 PH (813) 651-0080 FAX NO. (813) 623-6757
 FLORIDA CERTIFICATE OF AUTHORIZATION NO. 00004892
 PROJ. NO. 09/216/054.01
 DWG. BY: SZF
 CHK. BY: KAR
 APP. BY: KAR

CADD FILE:
 DATE: MARCH 2018
 SCALE: AS SHOWN
 DRAWING NO.


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S10
 SHEET 27 of 34

P:\Premier\2017\Blue_Martin\Porter\Struct\DROP_OFF_AREA_Vind-9.dwg Mar 19, 2018 - 8:00pm Layout Name: S11 - SCALE HOUSE ELEVATIONS AND SECTIONS By: PremierStructural 1

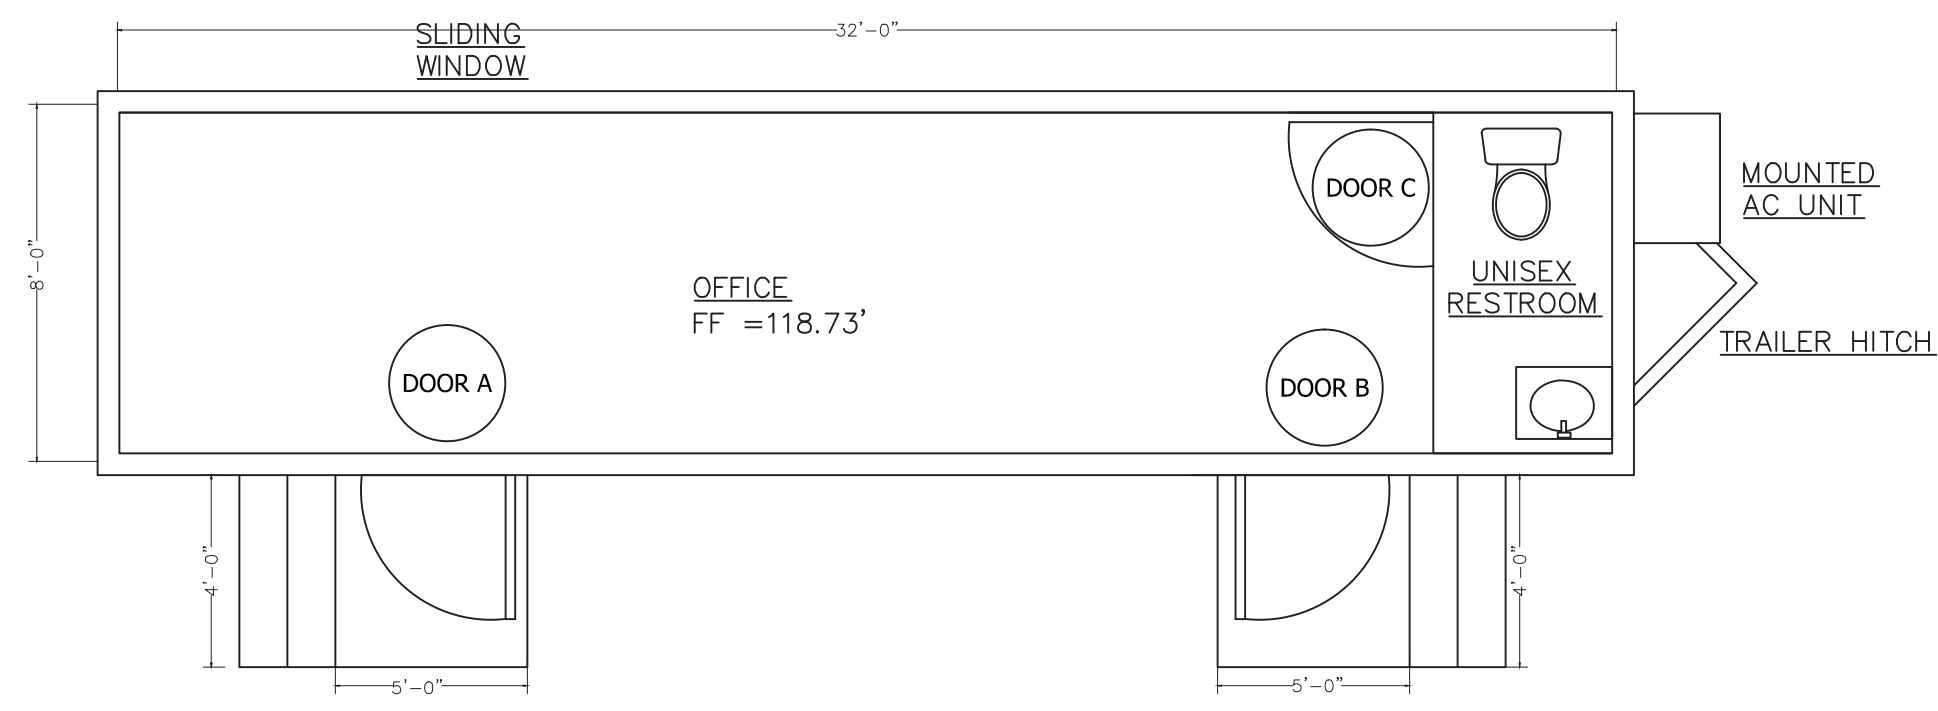


SCALEHOUSE FLOOR PLAN


- CONTRACTOR SHALL BE RESPONSIBLE FOR OBTAINING COUNTY PERMITS NECESSARY FOR CONSTRUCTION AND OCCUPANCY OF THE OFFICE TRAILER.
- MANUFACTURER TO FURNISH AND INSTALL A PREFABRICATED, CODE COMPLIANT MODULAR BUILDING INCLUDING, BUT NOT LIMITED TO THE FOLLOWING:
 - ELECTRICAL
 - FOUNDATION DESIGN AND PLACEMENT, INSTALLATION, AND ANCHORING.
 - UNLOADING, PLACEMENT, INSTALLATION, AND ANCHORING.
 - PLUMBING AND PIPING.
 - HVAC.
 - INTERIOR FINISHES.
 - INTERIOR FLUORESCENT LIGHTING.
 - CORRUGATED METAL SIDING AND COLOR AS APPROVED BY OWNER.
 - ALL ALUMINUM FRAME WINDOWS, DUAL GLAZED, TINTED, FIXED TYPE.
 - A SCALE FOUNDATION DESIGN SHALL BE SUBMITTED FOR APPROVAL BY THE OWNER AND ENGINEER. IT SHALL MEET OR EXCEED THE FOUNDATION SHOWN.
 - ALL DOOR HARDWARE SHALL BE 630 FINISH WITH MORTISE LOCKSETS.
 - USE ALUMINUM OR TREATED LUMBER FOR DECKING AND STAIRS.
 - INSTALL BLINDS ON ALL WINDOWS.
 - THE CENTERLINE OF THE SLIDING WINDOW OPENING SHALL BE 8FT FROM THE END OF THE TRUCK SCALE.

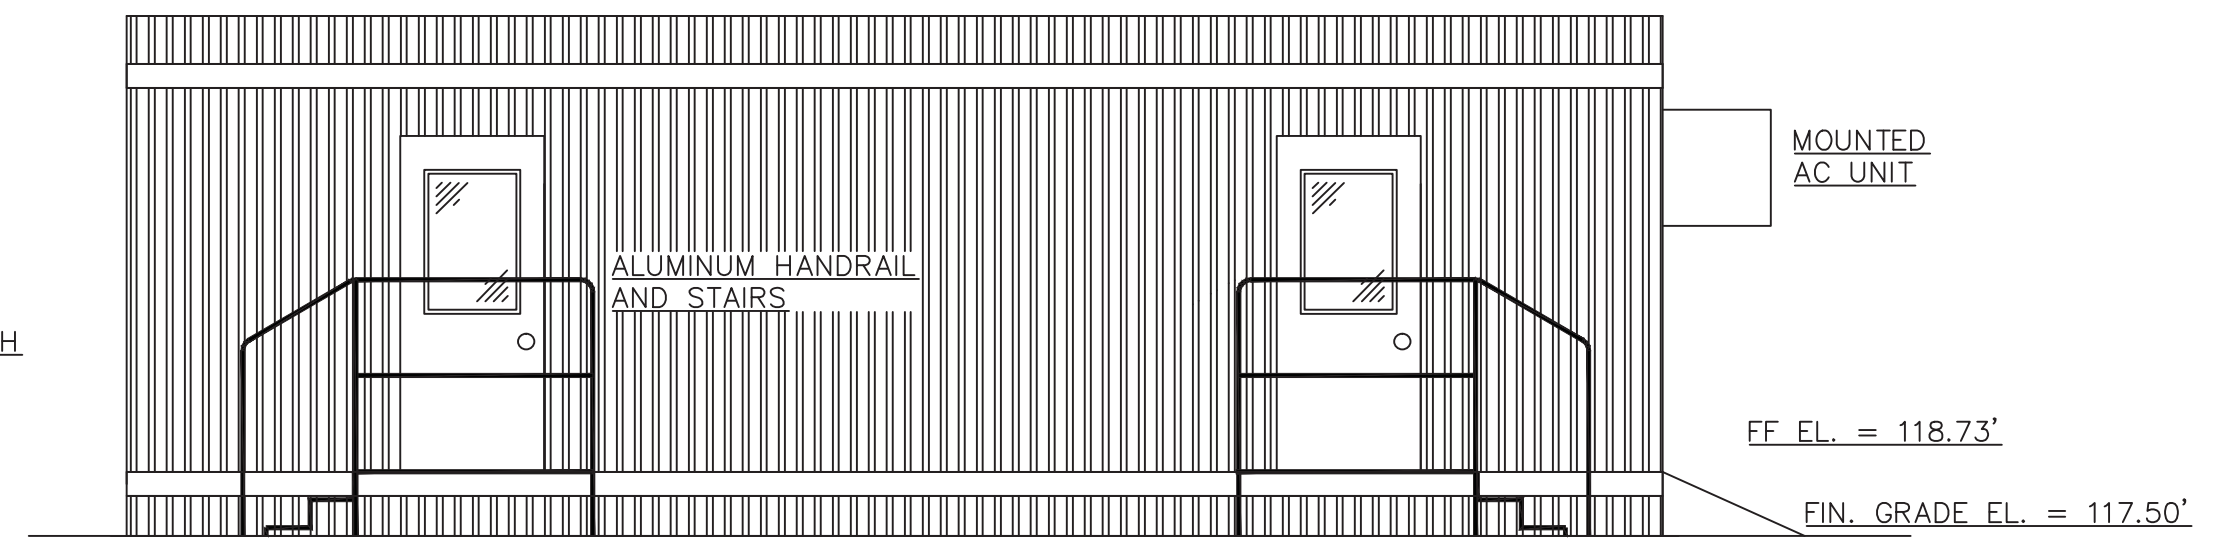

SOUTH ELEVATION

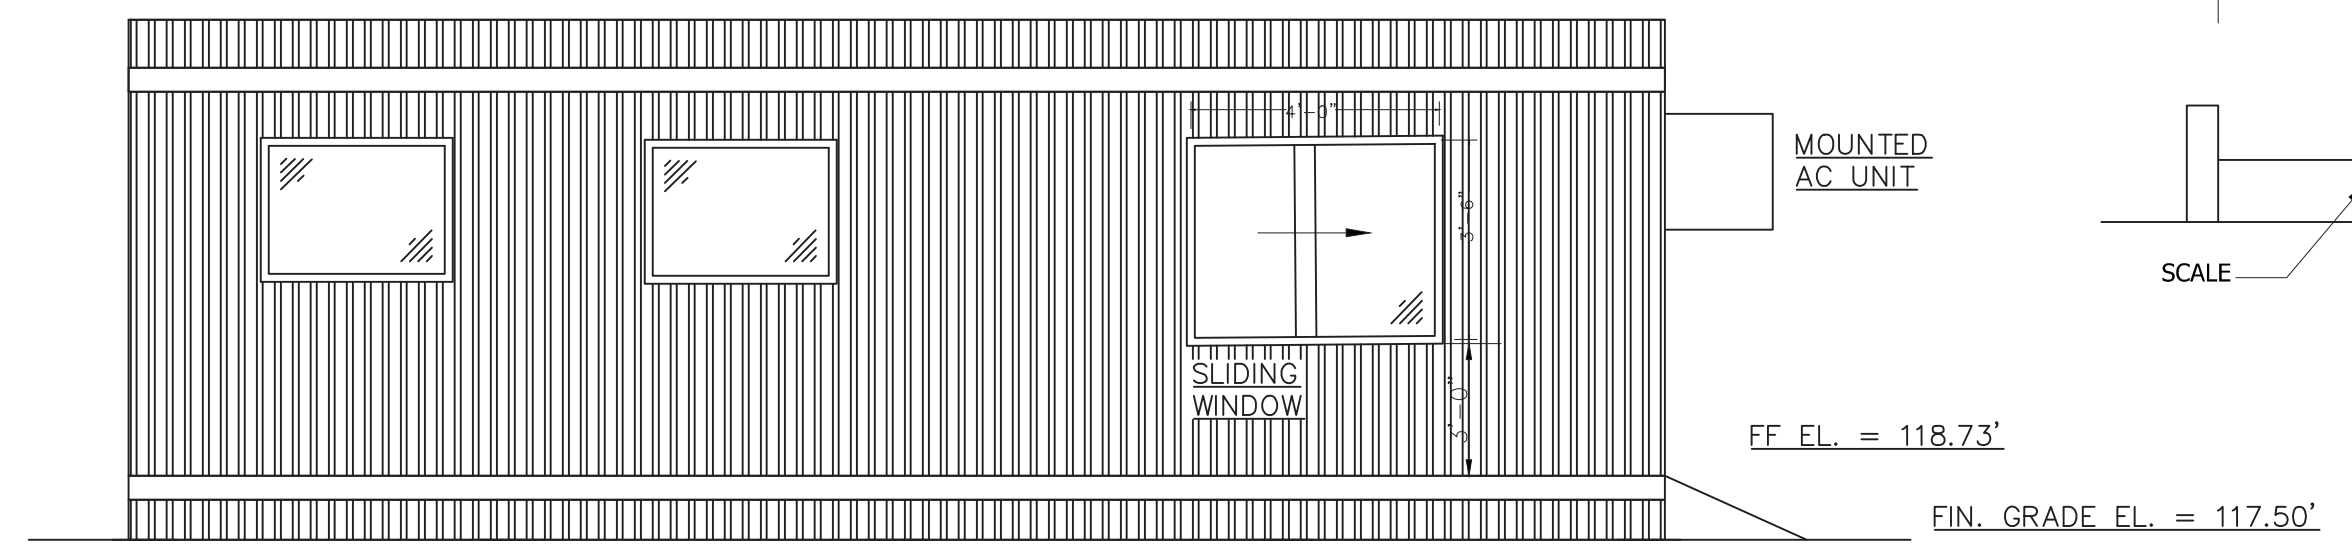

NORTH ELEVATION

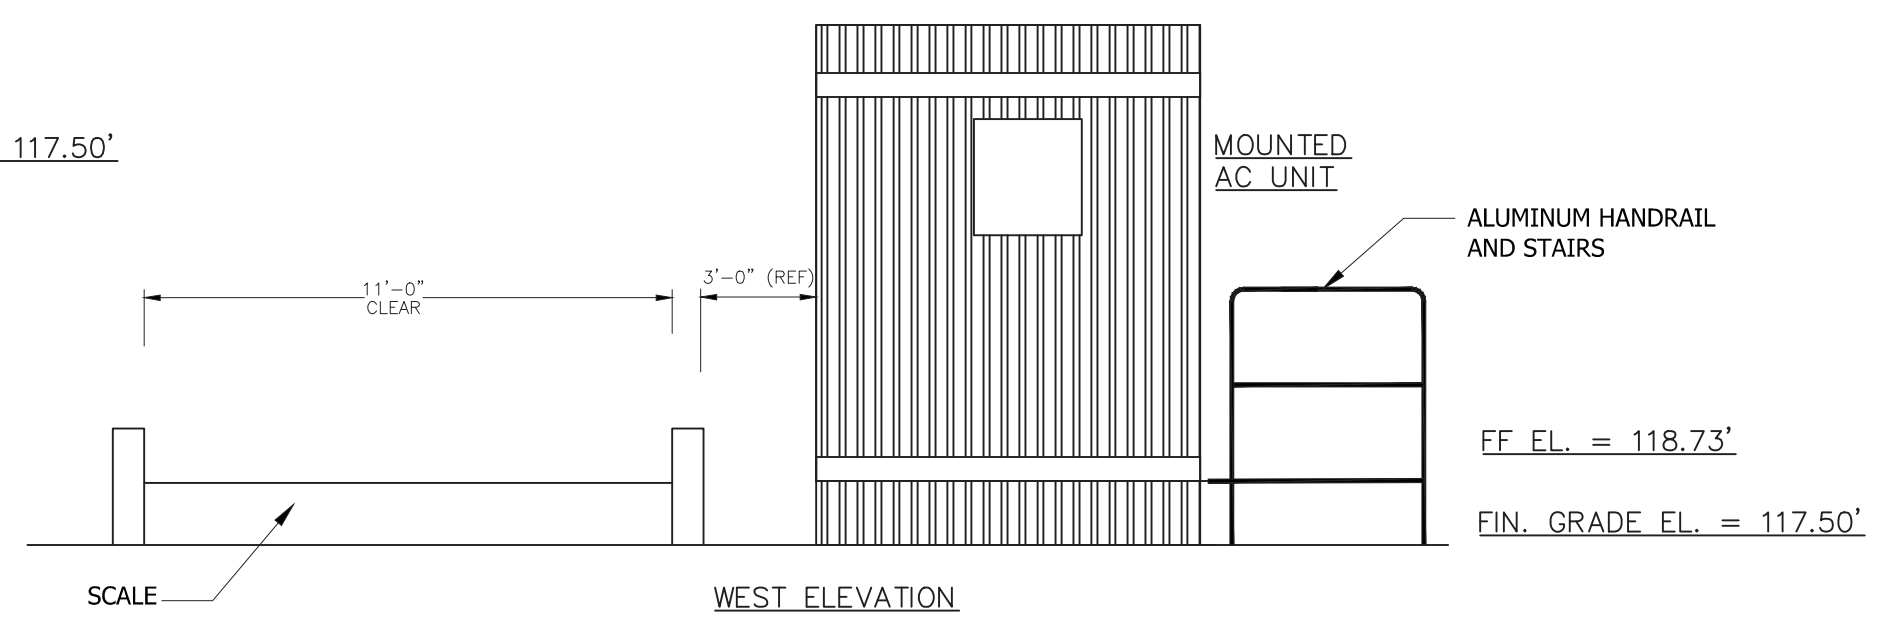

WEST ELEVATION

Khari Rodriguez
 Digitally signed by Khari Rodriguez
 DN: serialNumber=36rhx83kpbrr8c6np
 qyx8lgkcl6, c=US, st=Florida,
 l=Maitland, o=Khari A. Rodriguez,
 P.E., cn=Khari Rodriguez
 Date: 2018.03.19 20:27:56 -04'00'

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REV	DATE	DESCRIPTION	CHK. BY

SHEET TITLE: SCALE HOUSE ELEVATIONS AND SECTIONS
 PROJECT TITLE: PORTER TRANSFER STATION SITE IMPROVEMENTS


CLIENT: ORANGE COUNTY SOLID WASTE DIVISION
 ORLANDO, FLORIDA

DESCRIPTION	WALLS				BASE	FLOOR	CEILING/HEIGHT ABOVE FINISHED FLOOR
	NORTH	SOUTH	EAST	WEST			
	OFFICE	PAINTED GYPSUM WALLBOARD	PAINTED GYPSUM WALLBOARD	PAINTED GYPSUM WALLBOARD			
RESTROOM	PAINTED GYPSUM WALLBOARD	PAINTED GYPSUM WALLBOARD	PAINTED GYPSUM WALLBOARD	PAINTED GYPSUM WALLBOARD	4" RUBBER	VINYL TILES	8'-0" MIN.

DOORS	SIZE			TYPE	MATERIAL	FINISHED	HDW ASNI FUNCTION	REMARKS
	WIDTH	HEIGHT	THICKNESS					
OFFICE	3'-0"	7'-0"	1 3/4"	HG	HM	PAINTED	F13	WITH AUTO CLOSER
OFFICE	3'-0"	7'-0"	1-3/4"	F	HM	PAINTED	F13	WITH AUTO CLOSER
RESTROOM	3'-0"	7'-0"	1-3/4"	F	WOOD	PAINTED	F19	

MARK NO.	LOCATION	TYPE	CFM	S.P. DROP IN. WC	STATIC EFF. %	MOTOR			UNIT ILLUSTRATED	REMARKS
						HP	VOLTS	PH		
EF-1 THRU EF-2	NORTH WALL OF HHW BLDG.	SIDE-WALL PROPELLER	3,869 CFM	0.30	---	1/2	UNK.	1	GREENHECK SCE-20-320-A51	DIRECT DRIVE, WALL HOUSING WITH INLET GUARD, BACKDRAFT DAMPER, 45° WEATHERHOOD

GREENHECK SCE-20-320-A51 FAN DETAIL OR APPROVED EQUAL

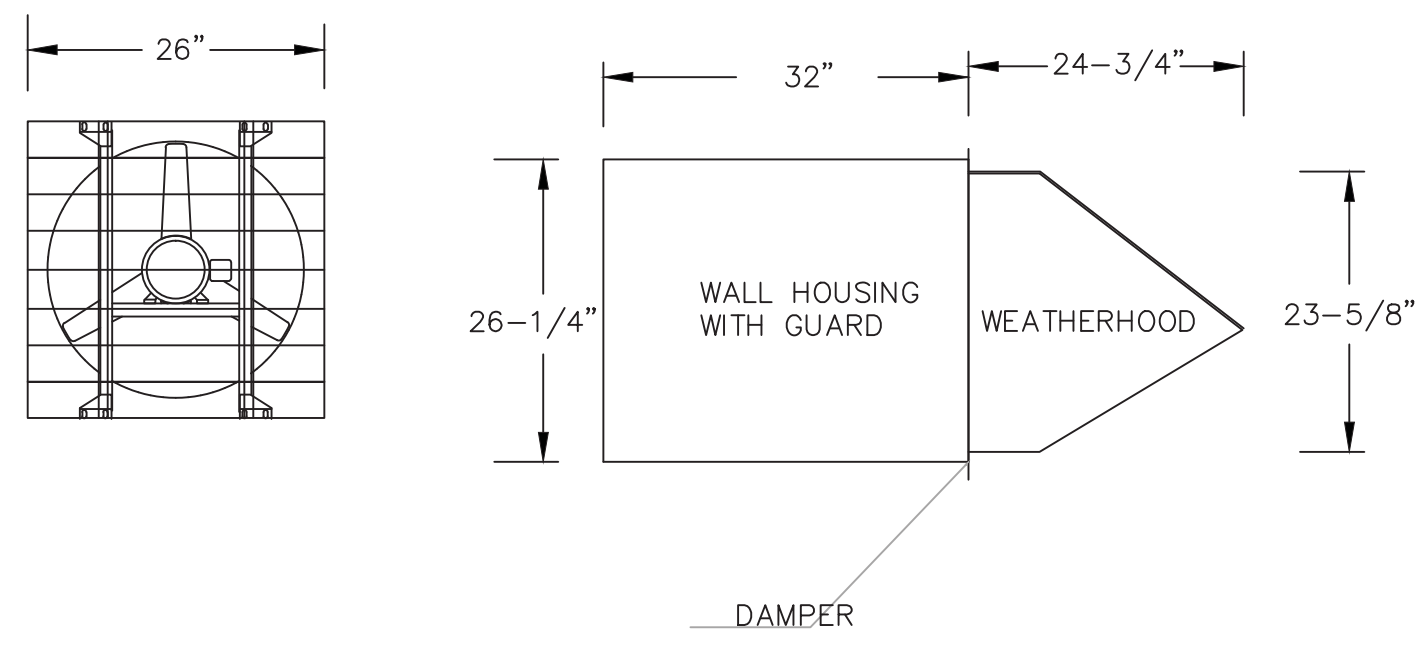

DESIGN CALCULATIONS AND ASSUMPTIONS:
 - ALLOW FOR EIGHT AIR CHANGES PER HOUR.
 - HHW BUILDING VOLUME: 58,000 CUBIC FEET.
 - MIN. FAN SIZE = (58,000 CUB. FT./AIR CHANGE)(8 AIR CHANGES PER HOUR)/(60 MIN/HR)/(2 FANS) = 3,867 CFM/FAN

ISSUED FOR BIDDING

CLIENT: SCS ENGINEERS
 STEARNS, CONRAD AND SCHMIDT
 CONSULTING ENGINEERS
 4041 PARK OAKS BLVD, SUITE 100, TAMPA, FL 33610
 PH (813) 621-0880 FAX NO. (813) 623-6767
 FLORIDA CERTIFICATE OF AUTHORIZATION NO. 00004882
 REG. NO. 09216054.01
 DATE: 03/19/18
 DRAWN BY: KAR
 CHECKED BY: KAR
 APP. BY: KAR

CADD FILE:
 DATE: MARCH 2018
 SCALE: AS SHOWN
 DRAWING NO. S11
 SHEET 28 of 34

Overhead Door Corporation
 2501 South State Hwy 121, Suite 200
 Lewisville, TX 75067

SCOPE:
 This NOA is being issued under the applicable rules and regulations governing the use of construction materials. The documentation submitted has been reviewed and accepted by Miami-Dade County RER-Product Control Section to be used in Miami-Dade County and other areas where allowed by the Authority Having Jurisdiction (AHJ).
 This NOA shall not be valid after the expiration date stated below. The Miami-Dade County Product Control Section (in Miami-Dade County) and/or the AHJ (in areas other than Miami-Dade County) reserve the right to have this product or material tested for quality assurance purposes. If this product or material fails to perform in the accepted manner, the manufacturer will incur the expense of such testing and the AHJ may immediately revoke, modify, or suspend the use of such product or material within their jurisdiction. RER reserves the right to revoke this acceptance, if it is determined by Miami-Dade County Product Control Section that this product or material fails to meet the requirements of the applicable building code.

This product is approved as described herein, and has been designed to comply with the Florida Building Code, including the High Velocity Hurricane Zone.

DESCRIPTION: Series 610/611/620/621 Steel Rolling Door up to 16'-0" Wide
APPROVAL DOCUMENT: Drawing No. 308125, titled "Series 610/620 Rolling Service Door 16' Dade County", sheets 1 and 2 of 2, dated 09/05/2003 and 10/10/2003, with revision H dated 05/03/2013, prepared by Overhead Door Corporation, signed and sealed by Mark A. Sawicki, P.E. on 12/17/2015, hearing the Miami-Dade County Product Control revision stamp with the Notice of Acceptance number and expiration date by the Miami-Dade County Product Control Section.

MISSILE IMPACT RATING: Large and Small Missile Impact Resistant
LABELING: A permanent label with the manufacturer's name or logo, Lewistown, PA, model/series number, the positive and negative design pressure rating, indicate impact rated if applicable, installation instruction drawing reference number, approval number (NOA), the applicable test standards, and the statement reading "Miami-Dade County Product Control Approved" is to be located on the door's side track, bottom angle, or inner surface of a panel.


RENEWAL of this NOA shall be considered after a renewal application has been filed and there has been no change in the applicable building code negatively affecting the performance of this product.

TERMINATION of this NOA will occur after the expiration date or if there has been an revision or change in the materials, use, and/or manufacture of the product or process. Misuse of this NOA as an endorsement of any product, for sales, advertising or any other purposes shall automatically terminate this NOA. Failure to comply with any section of this NOA shall be cause for termination and removal of NOA.

ADVERTISEMENT: The NOA number preceded by the words Miami-Dade County, Florida, and followed by the expiration date may be displayed in advertising literature. If any portion of the NOA is displayed, then it shall be done in its entirety.

INSPECTION: A copy of this entire NOA shall be provided to the user by the manufacturer or its distributors and shall be available for inspection at the job site at the request of the Building Official.
 This NOA revises NOA # 13-1121.06 and consists of this page 1 and evidence pages E-1 and E-2, as well as approval document mentioned above.
 The submitted documentation was reviewed by Carlos M. Utrera, P.E.

NOA No. 15-1228.05
 Expiration Date: September 16, 2019
 Approval Date: April 21, 2016
 Page 1

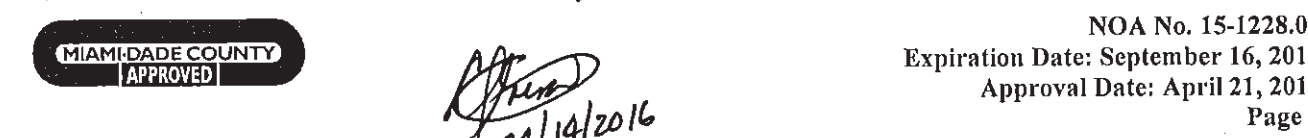

Overhead Door Corporation
NOTICE OF ACCEPTANCE: EVIDENCE SUBMITTED

- A. DRAWINGS**
 1. Drawing No. 308125, titled "Series 610/620 Rolling Service Door 16' Dade County", sheets 1 and 2 of 2, dated 09/05/2003 and 10/10/2003, with revision H dated 05/03/2013, prepared by Overhead Door Corporation, signed and sealed by Mark A. Sawicki, P.E. on 12/17/2015.
- B. TESTS "Submitted under NOA # 13-1121.06"**
 1. Test reports on 1) Uniform Static Air Pressure Test, Loading per FBC TAS 202-94
 2) Large Missile Impact Test per FBC, TAS 201-94
 3) Cyclic Wind Pressure Loading per FBC, TAS 203-94
 4) Forced Entry Resistance Test per FBC, TAS 202-94
 5) Tensile Test per ASTM E 8.
 along with marked-up drawings and installation diagram of a Series 610 Series rolling garage door, prepared by Architectural Testing, Inc. Test Report No. C8189.01-109-18, dated 10/10/2013, signed and sealed by Michael D. Stremmel, P.E.
 2. Test report on Salt Fog Spray Test per ASTM B-117 of G90 and G40 galvanized steel with prime coat samples, prepared by Environmental Testing Laboratory, Inc. Test Report No. 12732, dated 06/22/2013 and signed by Brady Richard.
 "Submitted under NOA # 05-1003.24"
 3. Test report on Salt Spray Fog Test per ASTM B-117 of G30, G40 & G90 samples, prepared by Environmental Testing Laboratory, Test Report No. ETL-9100550287, dated 03/13/2006 and signed by B. Richard.
 "Submitted under NOA # 03-1015.01"
 4. Test report on Uniform Static Air Pressure Test per FBC, TAS 202, Large Missile Impact Test per FBC, TAS 201, Cyclic Wind Pressure Test per FBC, TAS 203 and Tensile Test per ASTM E8 of a 16' x 10' steel roll-up service door", prepared by Architectural Testing, Inc., Test Report No. ATI 01-43464.02, dated 09/05/2003 signed and sealed by L. G. Krupke, P.E.
- C. CALCULATIONS "Submitted under NOA # 13-1121.06"**
 1. Wall fastener calculations prepared by Overhead Door Corporation, dated 10/31/2013, signed and sealed by Mark A. Sawicki, P.E.
 "Submitted under NOA # 05-1003.24"
 2. Calculations for Dade County Product Approval of 22, 20 & 18 Gauge Rolling Garage Door, prepared by Overhead Door Corporation on sheet 2 of 3, signed and sealed by LeRoy G. Krupke, P.E. on 09/16/2005.

Carlos M. Utrera, P.E.
 Product Control Examiner
 NOA No. 15-1228.05
 Expiration Date: September 16, 2019
 Approval Date: April 21, 2016



E-1

Overhead Door Corporation
NOTICE OF ACCEPTANCE: EVIDENCE SUBMITTED

- D. QUALITY ASSURANCE**
 1. Miami-Dade Department of Regulatory and Economic Resources (RER)
- E. MATERIAL CERTIFICATIONS**
 1. None.
- F. STATEMENTS**
 1. Statement letter of code conformance to the 5th edition (2014) FBC issued by Overhead Door Corporation, dated 12/15/2015, signed and sealed by Mark A. Sawicki, P.E.
 "Submitted under NOA # 13-1121.06"
 2. Statement letter of code conformance to FBC 2010 and no financial interest prepared by Overhead Door Corporation, dated 10/31/2013, signed and sealed by Mark A. Sawicki, P.E.

Carlos M. Utrera, P.E.
 Product Control Examiner
 NOA No. 15-1228.05
 Expiration Date: September 16, 2019
 Approval Date: April 21, 2016

E-2

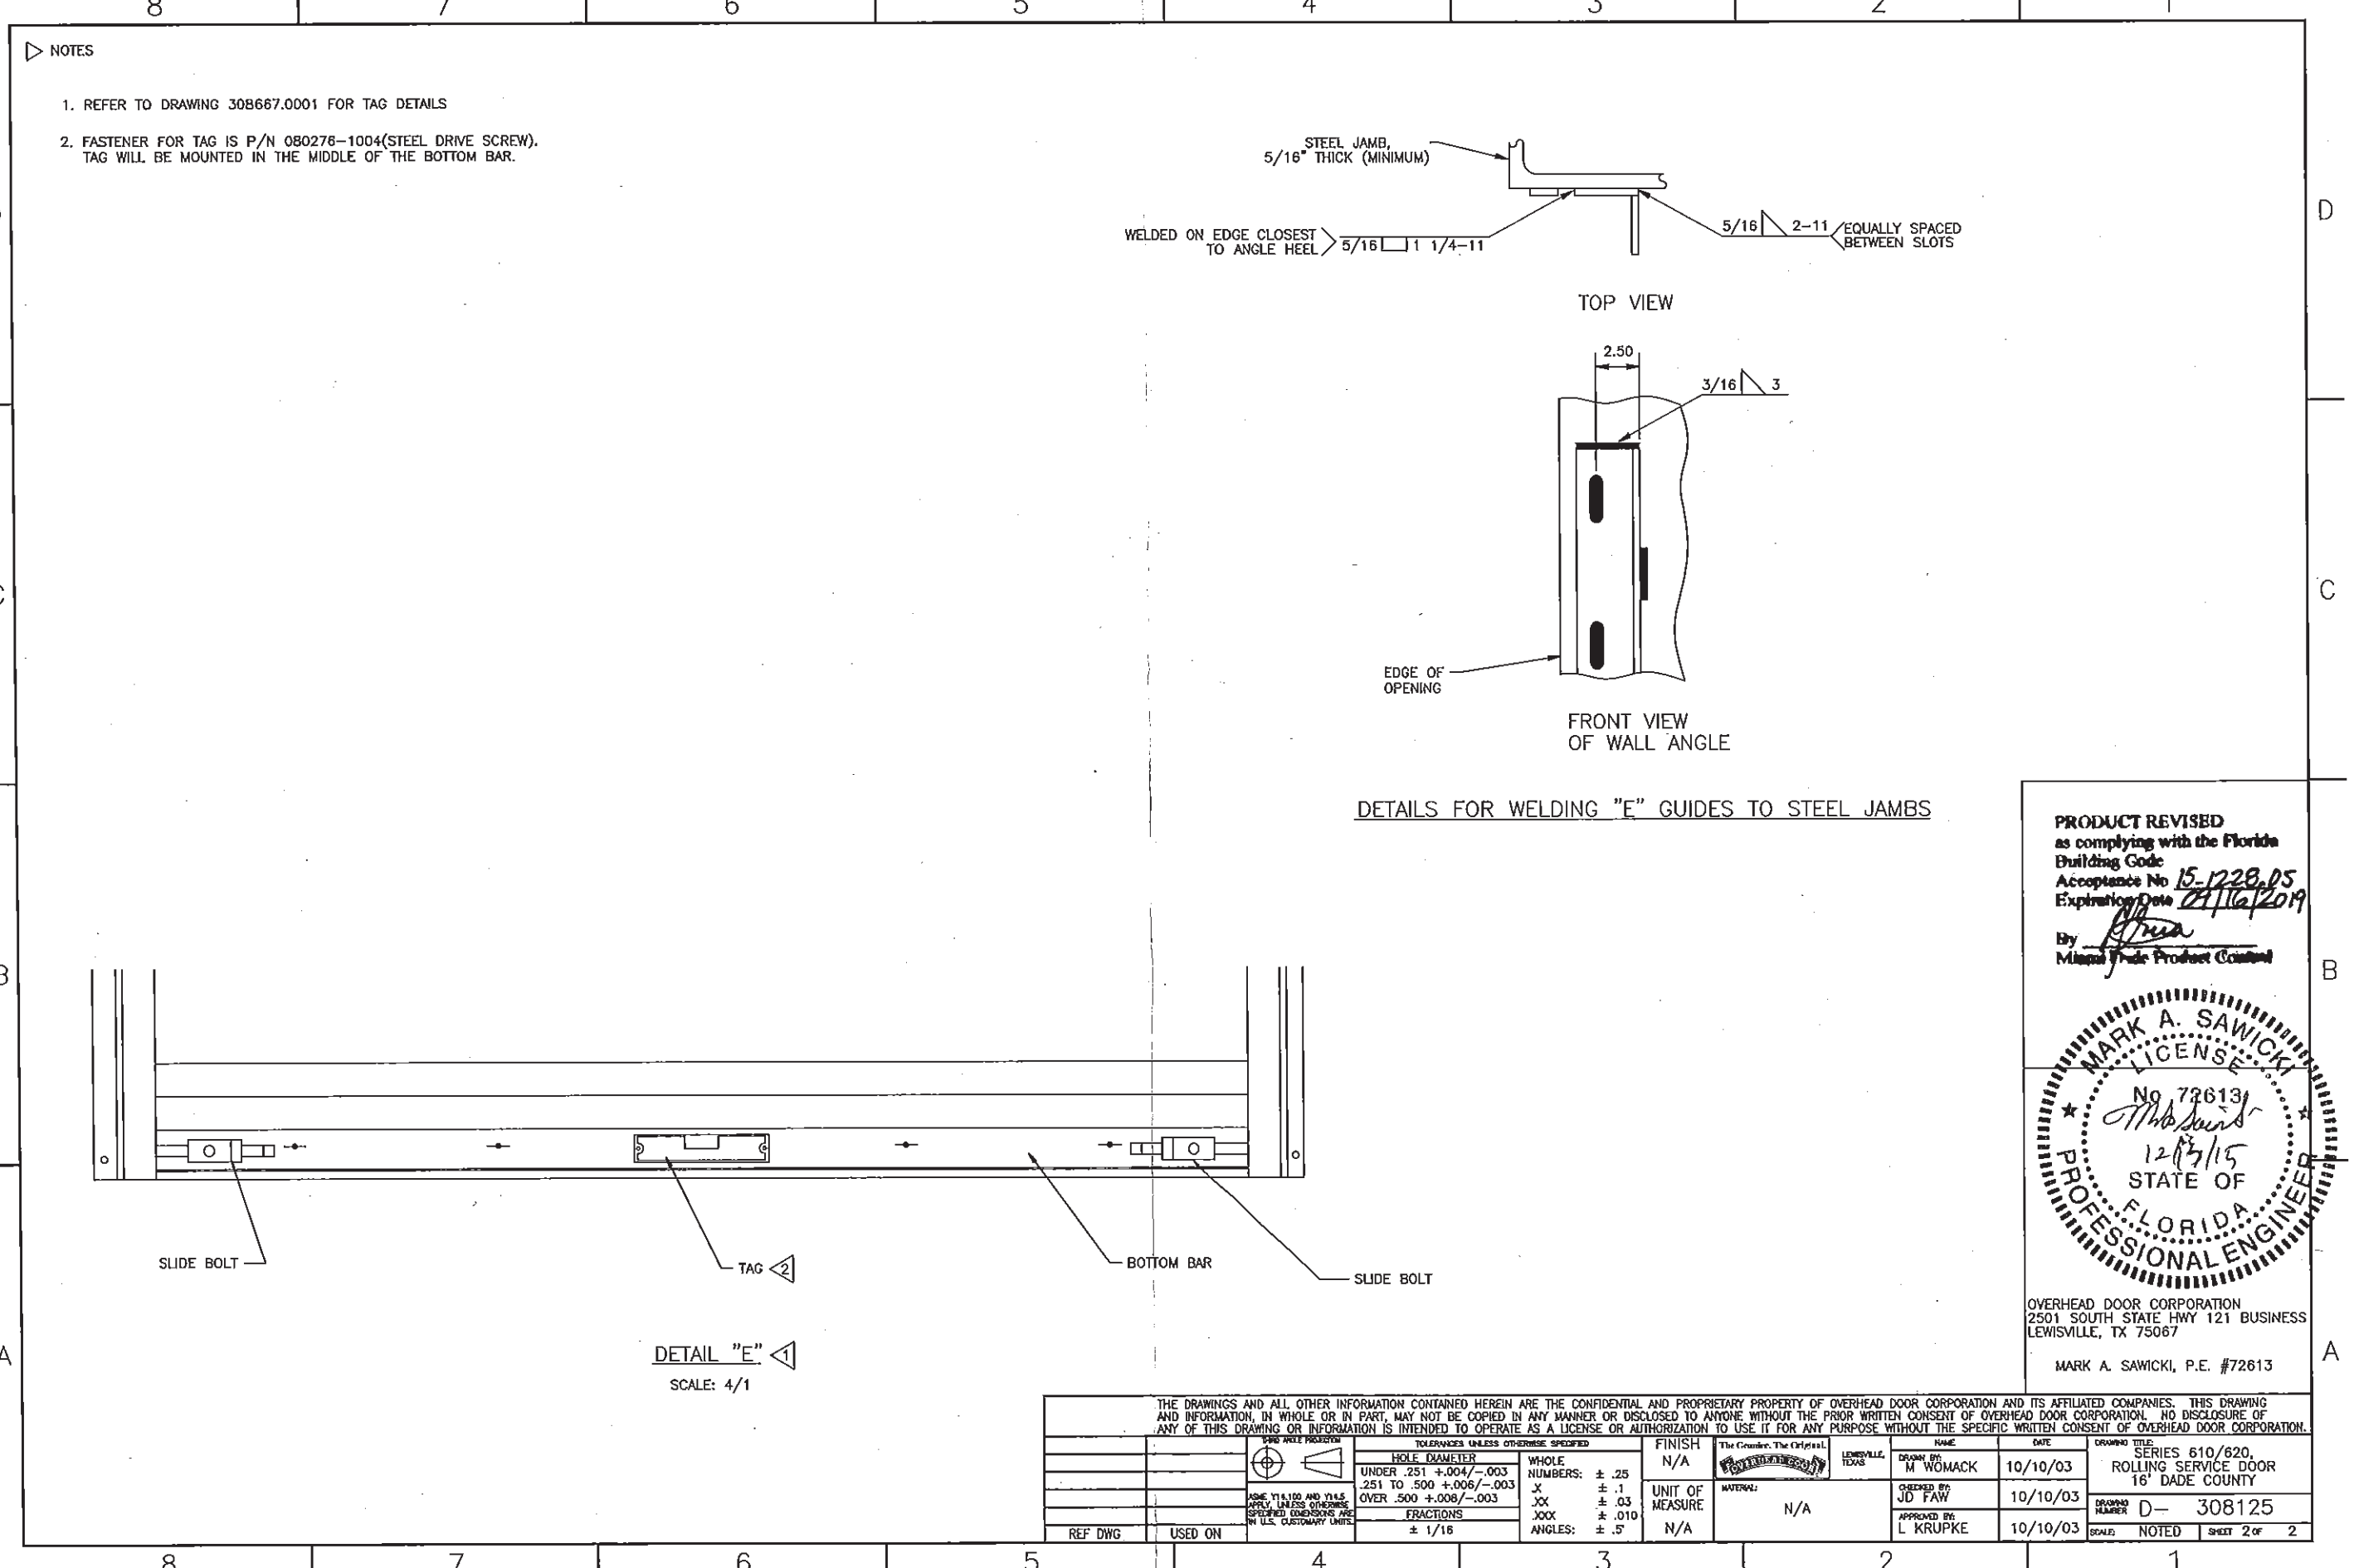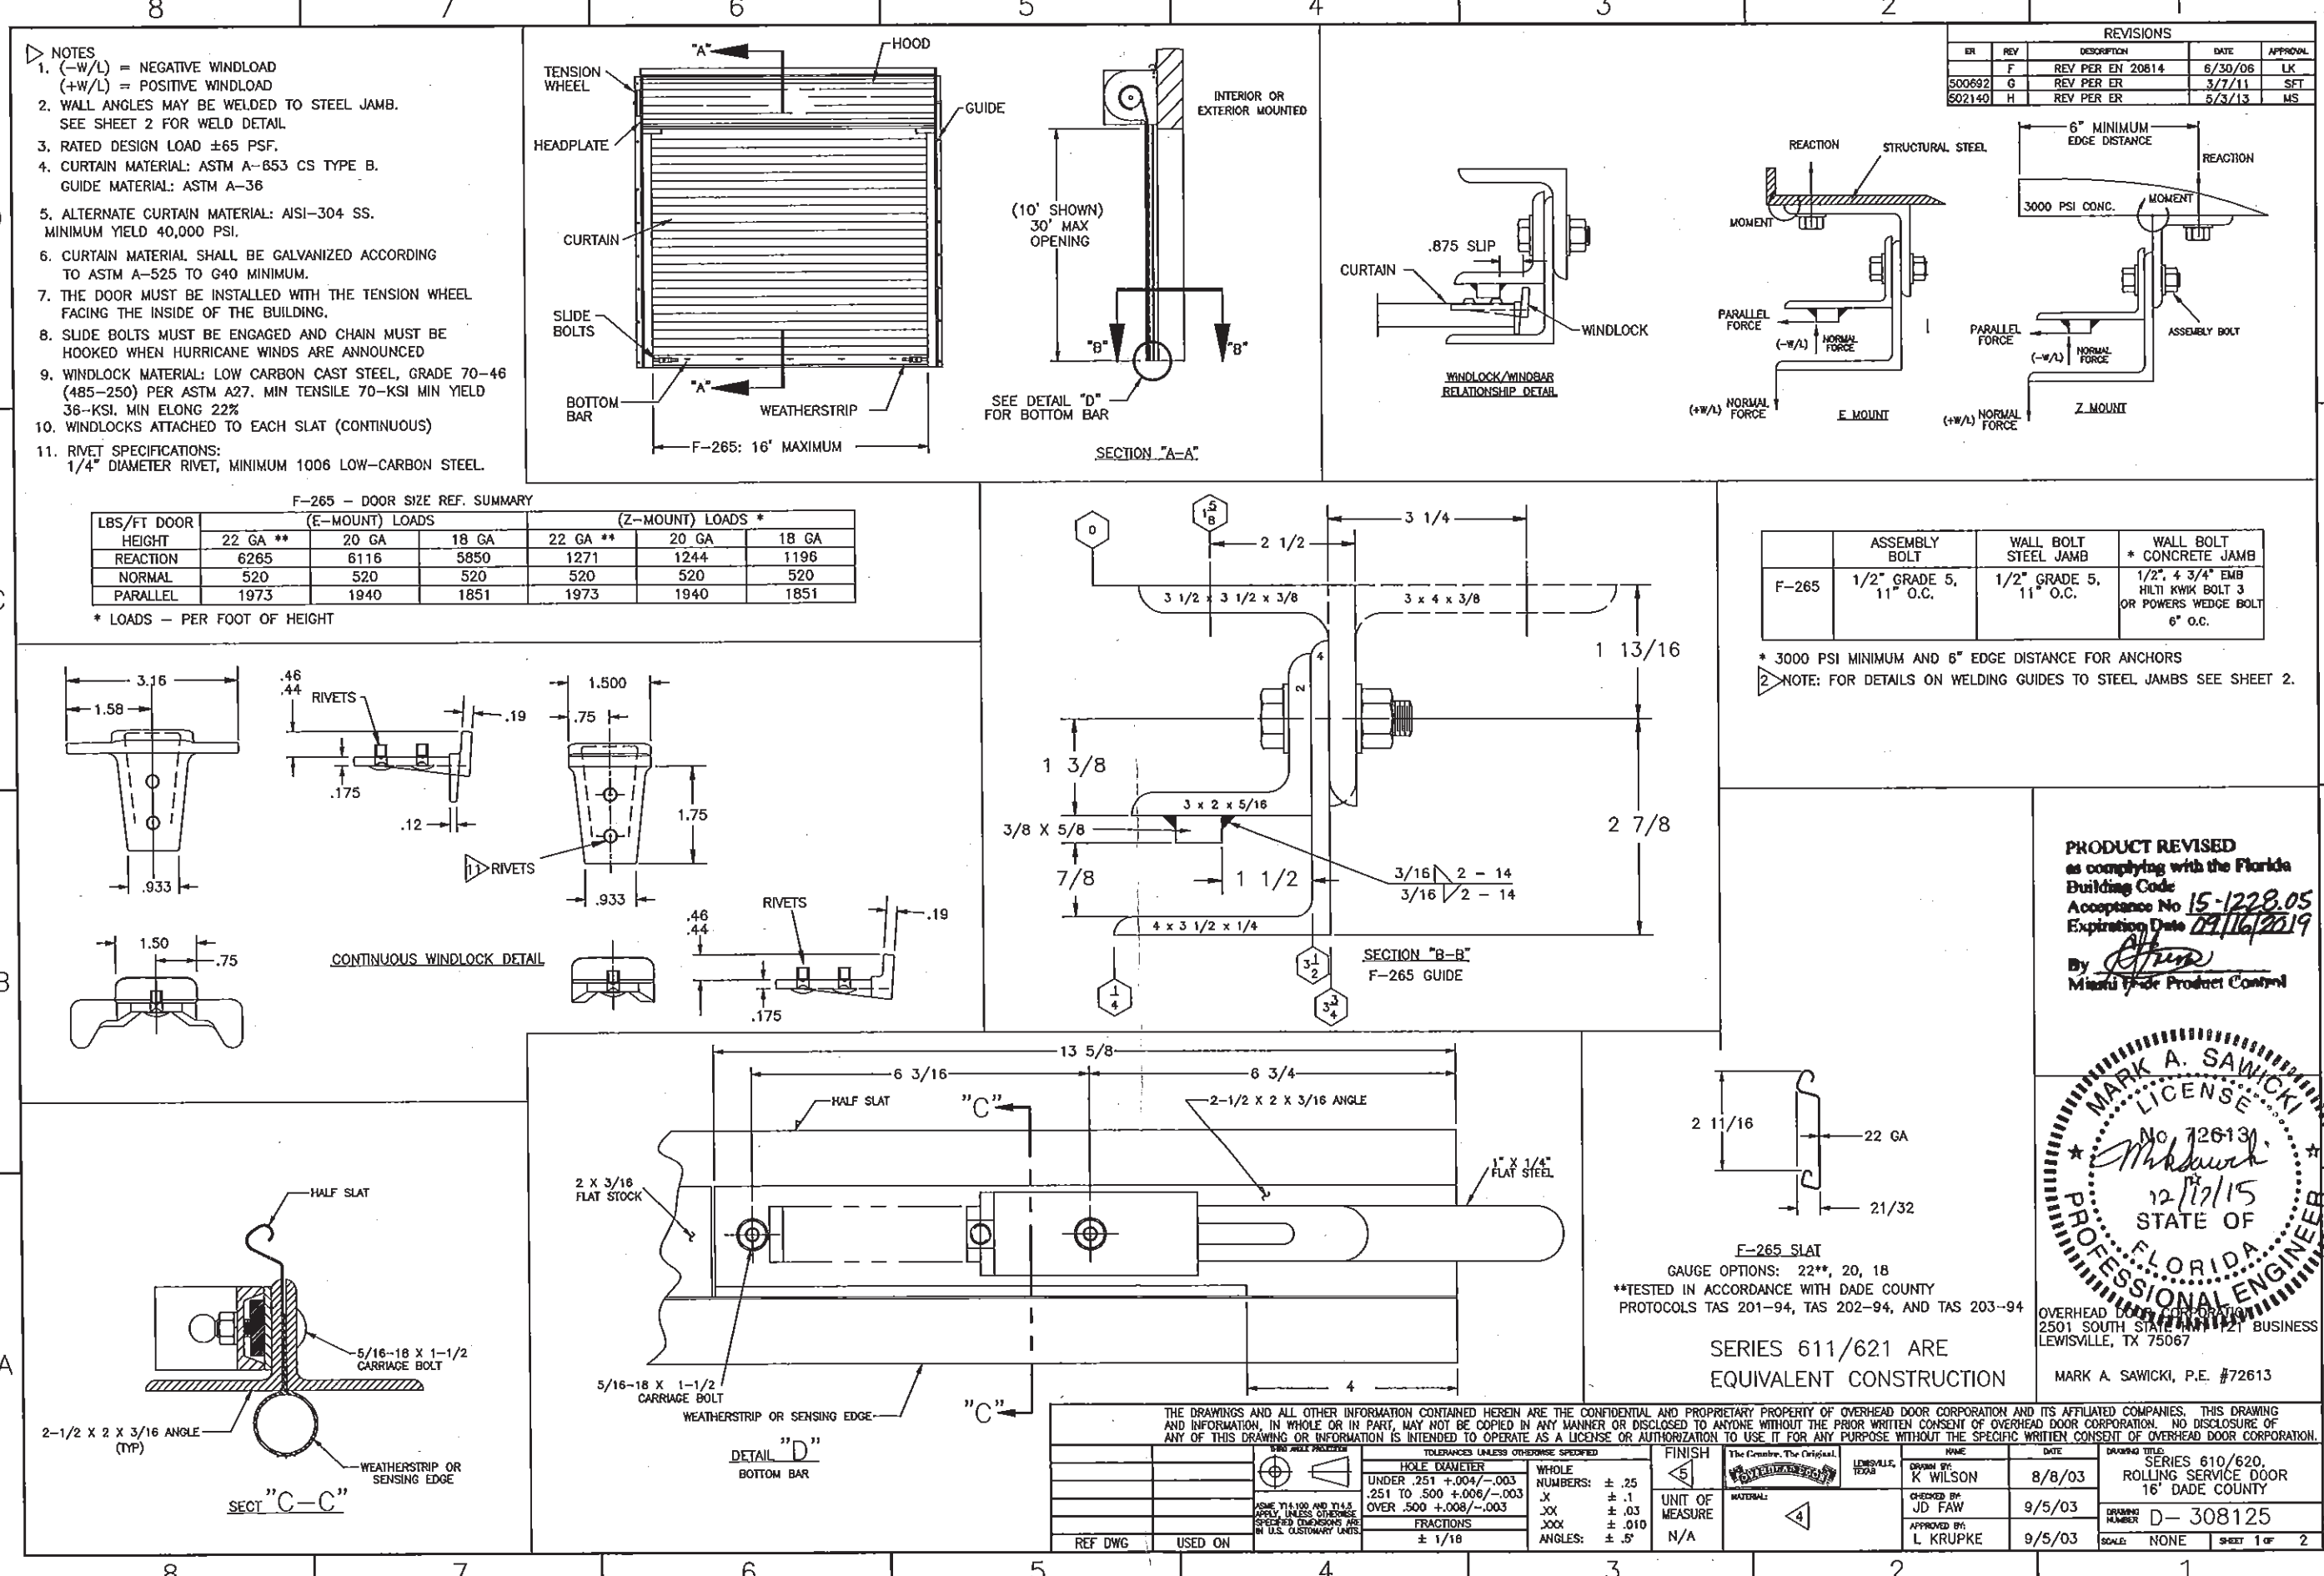

Digitally signed by Khari Rodriguez
 DN: serialNumber=36rhx83kpbrr8c6n, pgx8lglc6, c=US, st=Florida, l=Maitland, o=Khari A. Rodriguez, P.E., cn=Khari Rodriguez
 Date: 2018.03.19 20:28:24 -0400

This item has been electronically signed and sealed by Khari Rodriguez, PE on the Date and/or Time Stamp using a digital signature. Printed copies of this document and not considered signed and sealed and the signature must be verified on any electronic copy.

ORANGE COUNTY SOLID WASTE DIVISION
ORLANDO, FLORIDA

SCS ENGINEERS
 STEARNS, CONRAD AND SCHMIDT
 CONSULTING ENGINEERS
 4041 PARK OAKS BLVD., SUITE 100, TAMPA, FL 33610
 PH (813) 621-0880 FAX NO. (813) 623-6767
 FLORIDA CERTIFICATE OF AUTHORIZATION NO. 00004882
 REG. NO. 15533 DATE 03/21/05 EXPIRES 03/21/15
 OWNER: K&R APP. BY: K&R
 DESIGN: K&R CHECKED: K&R

PORTER TRANSFER STATION
SITE IMPROVEMENTS

HHW ROLL-UP DOOR (NOA)

PROJECT TITLE

CLIENT

CADD FILE:

DATE: MARCH 2018

SCALE: AS SHOWN

DRAWING NO. S12

SHEET 29 of 34

ISSUED FOR BIDDING

P:\Premier\2017\Blue Marin\Porter\Struct\DROP OFF AREA.rvt - 8:00pm Layout Name: S13 - CANOPY ELEVATIONS AND DETAILS By: PremierStructural 1


Khari Rodriguez
 Digitally signed by Khari Rodriguez
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 Date: 2018.03.19 20:28:48 -04'00'

This item has been electronically signed and sealed by Khari Rodriguez, PE on the Date and/or Time Stamp using a digital signature. Printed copies of this document and not considered signed and sealed and the signature must be verified on any electronic copy.




FL CERTIFICATE OF AUTHORIZATION #29116
 235 S. MAITLAND AVE
 SUITE 108-A
 MAITLAND FL 32751
 PH: 407-227-7416
 WWW.PREMIER-STRUCTURAL.COM


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DATE:	
REV:	
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PROJECT TITLE:	PORTER TRANSFER STATION SITE IMPROVEMENTS
CLIENT:	ORANGE COUNTY SOLID WASTE DIVISION ORLANDO, FLORIDA
DESIGNED BY:	SCS ENGINEERS
DRAWN BY:	CONRAD AND SCHMIDT
CHK. BY:	CONRAD AND SCHMIDT
APP. BY:	KAR
CADD FILE:	
DATE:	MARCH 2018
SCALE:	AS SHOWN
DRAWING NO.:	S13
SHEET	30 of 34

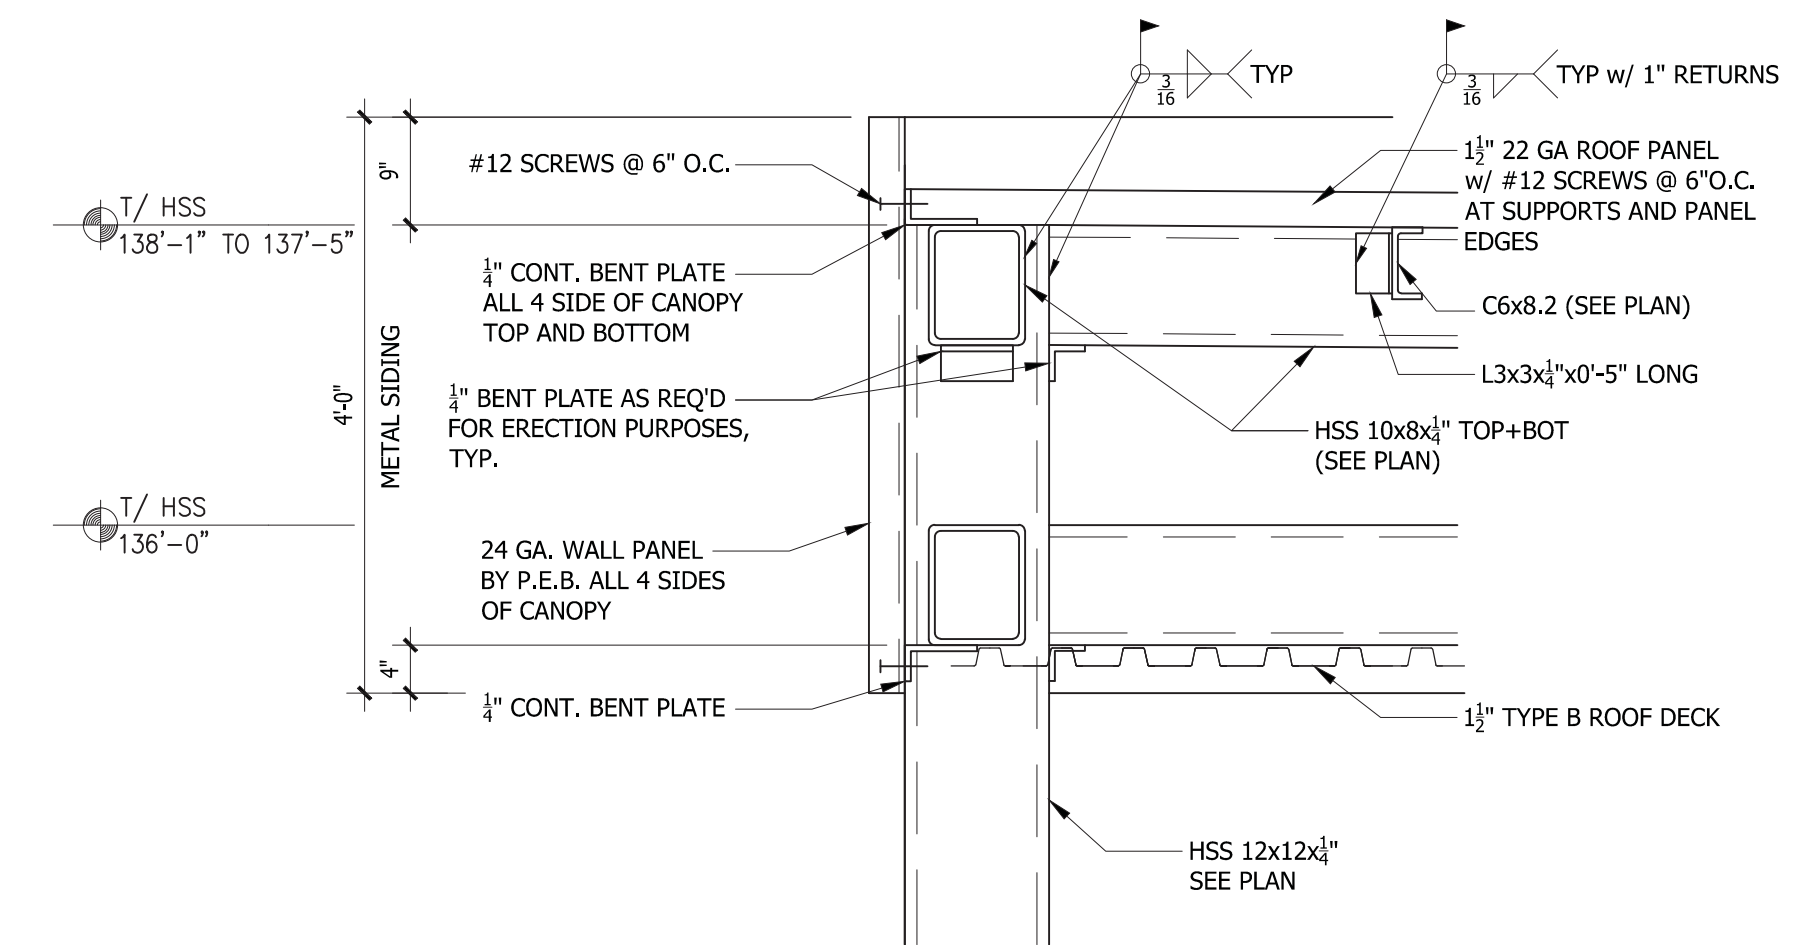


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 SCALE: 3/4" = 1'-0"

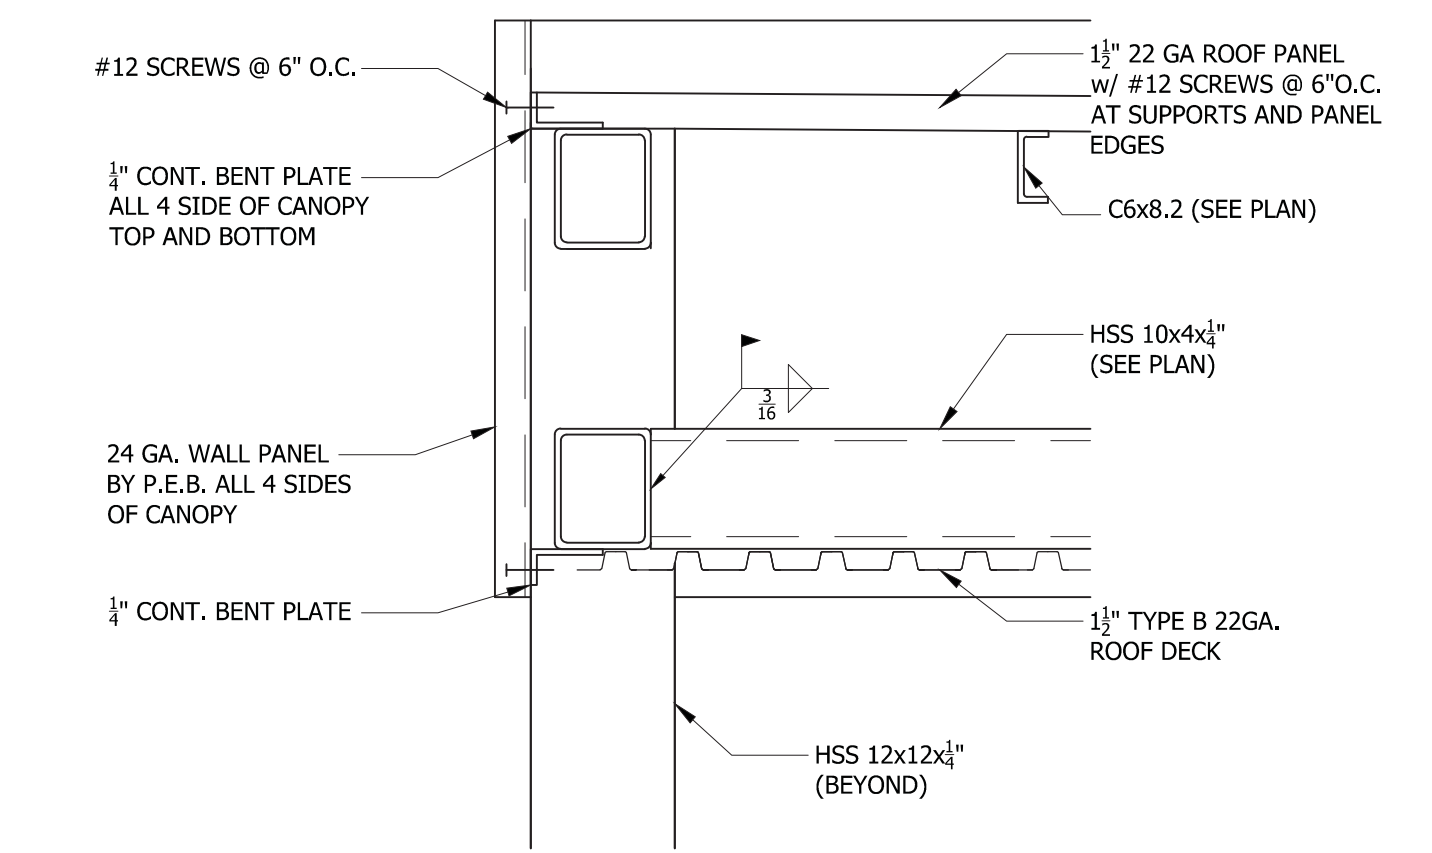


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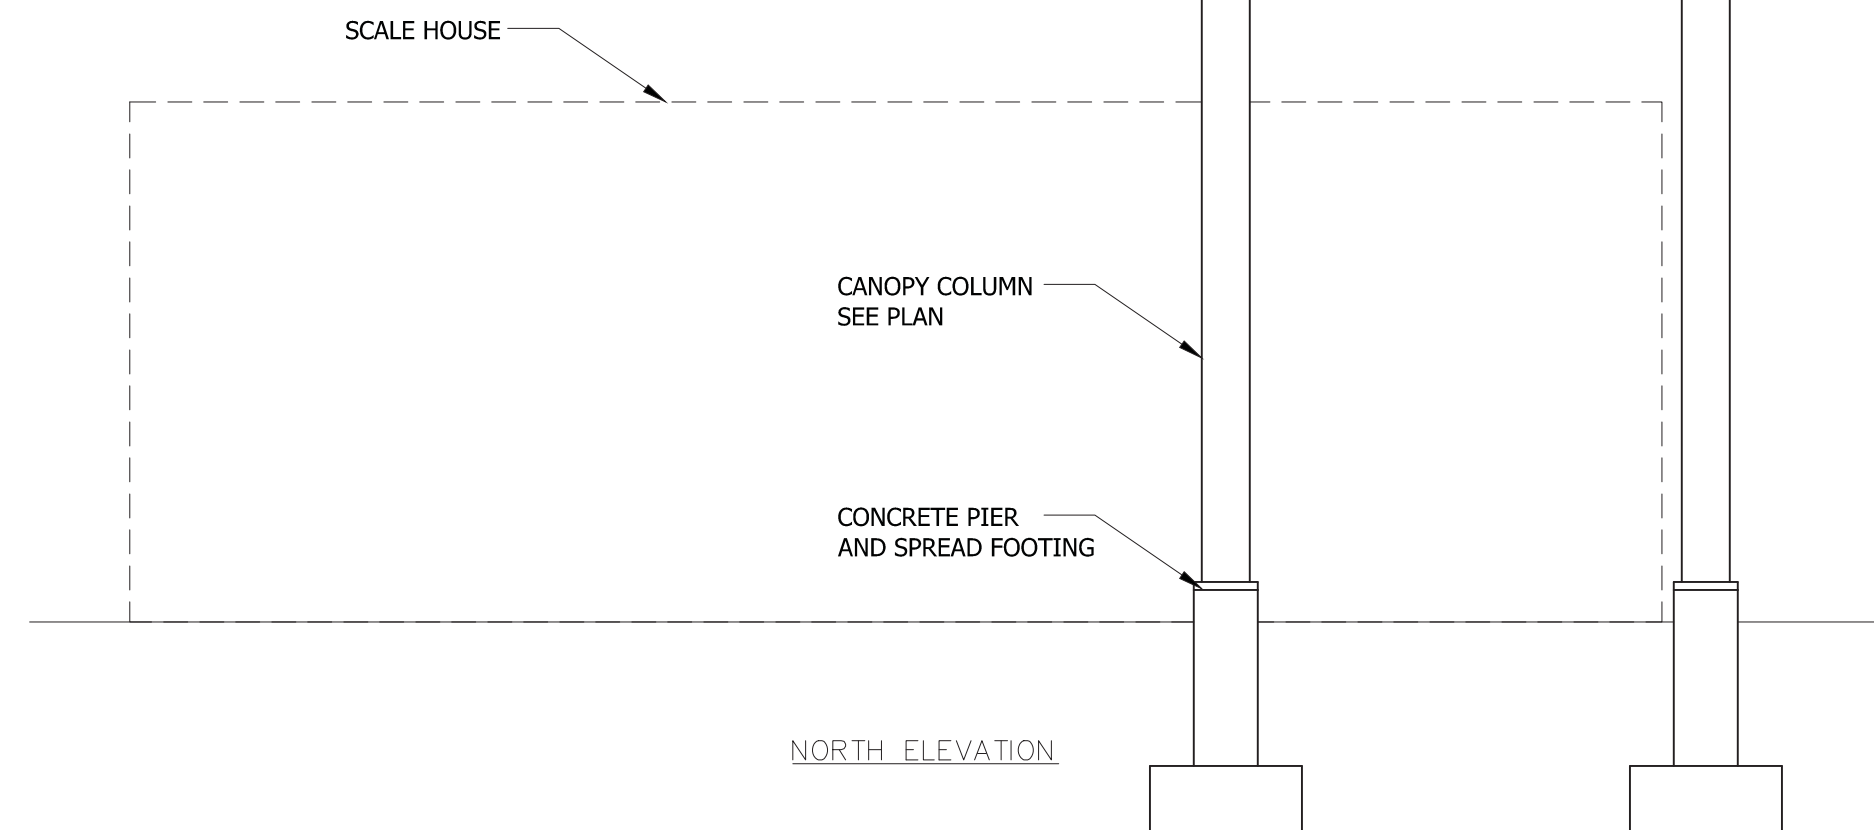
HSS COLUMN BASE PLATE DETAIL
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CANOPY COLUMN AND PIER DETAIL
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SCALE HOUSE CANOPY WEST ELEVATION
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SCALE HOUSE CANOPY NORTH ELEVATION
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ISSUED FOR BIDDING

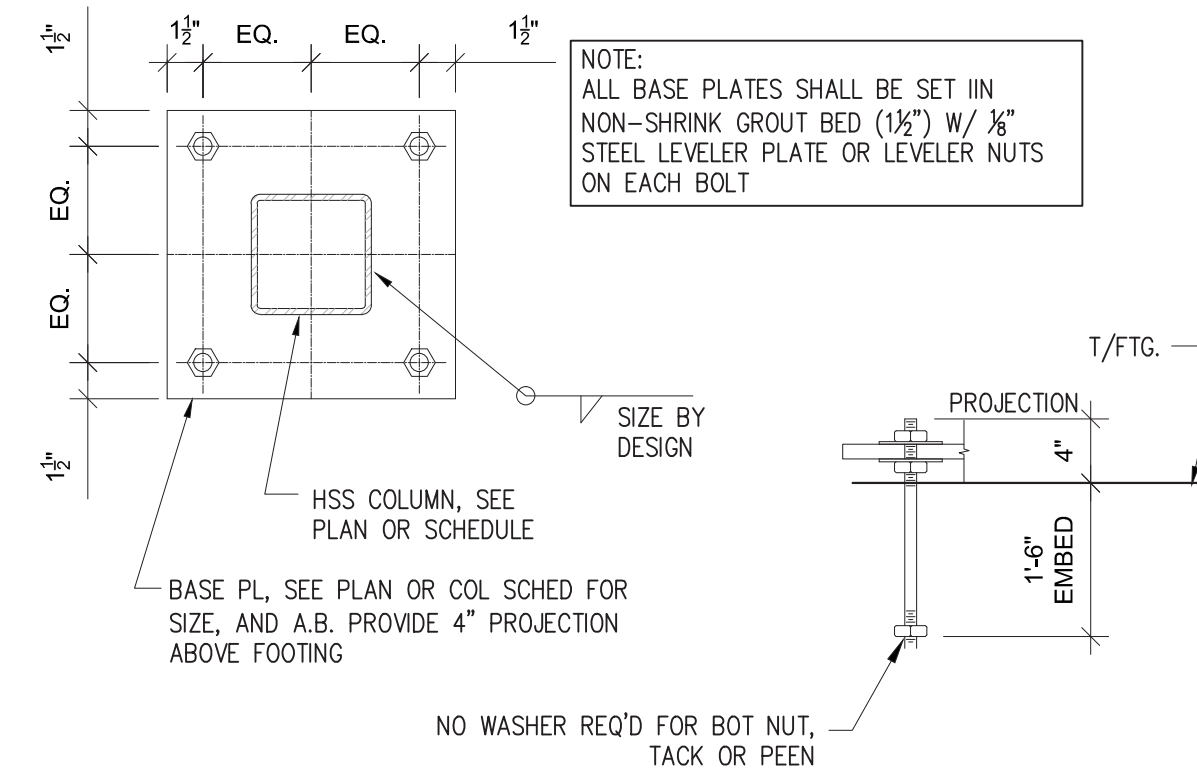

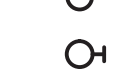




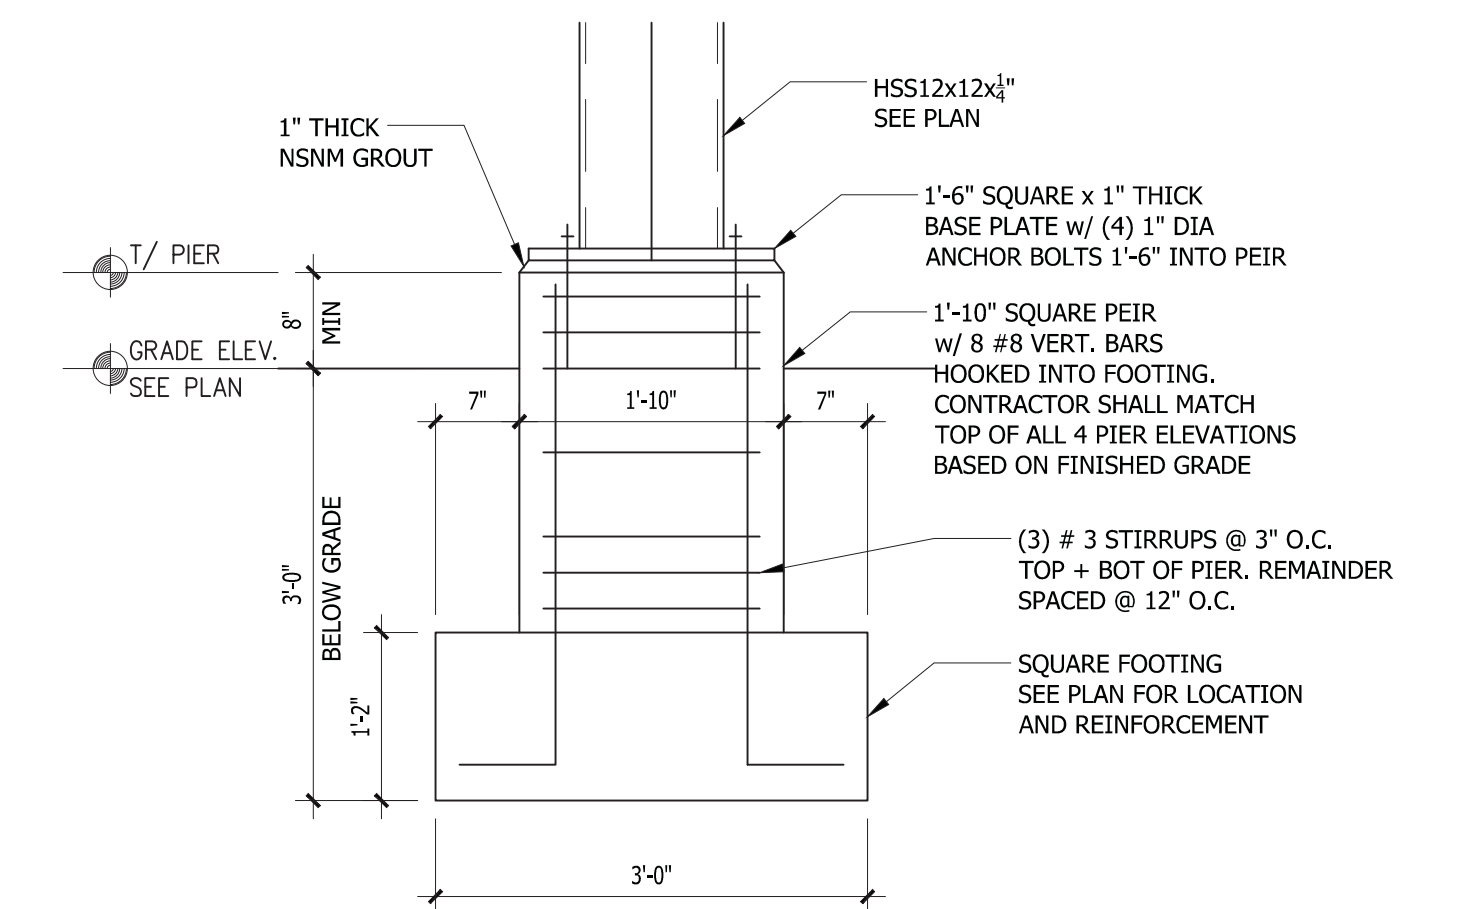



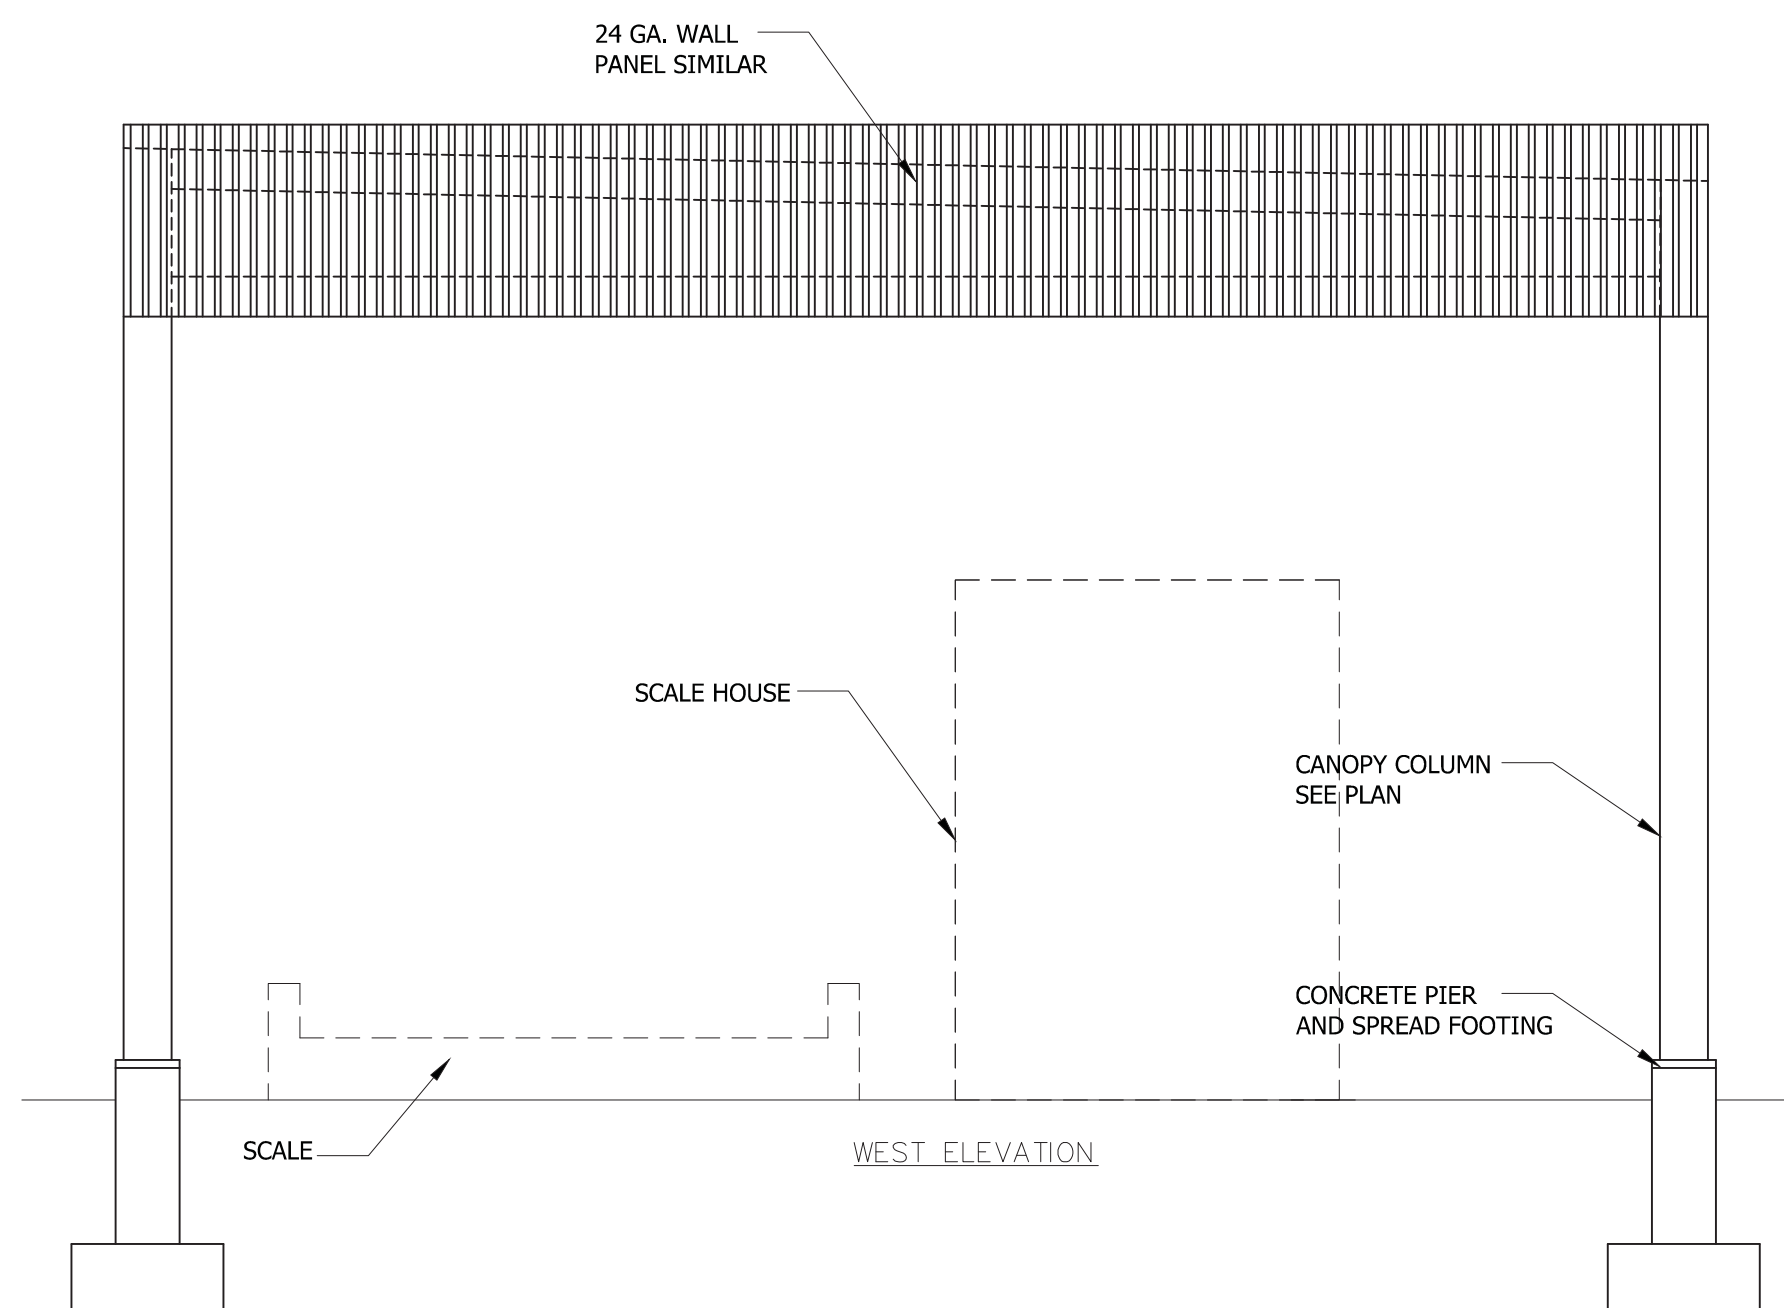

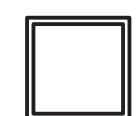














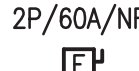

















LIGHTING FIXTURE SCHEDULE							
FIXTURE TYPE	FIXTURE DESCRIPTION	LAMPS		MANUFACTURER		VOLTS	REMARKS
		QTY	TYPE	NAME	CATALOG #		
A	LED AREA LIGHT, DIE CAST ALUMINUM HOUSING, TYPE 4 DISTRIBUTION, CONSTANT LIGHT OUTPUT DRIVER, FLAT TEMPERED GLASS LENS, GRAY FINISH 37 FOOT OVERALL DIRECT BURIED PRE-CAST CONCRETE POLE, RATED FOR 180MPH AT 5 EPA, GRAY COLOR, WITH SINGLE FIXTURE POLE TOP MOUNTING BRACKET	-	183W LED 4000K	PHILIPS (OR EQUAL) PRE-CAST SPECIALTIES (OR EQUAL) UNITED LTG STANDARDS (OR EQUAL)	RVM190W112LED4K-LE4-UNIV-CLO-GY3 POLE - TYPE I-0 37 FT MOUNTING BRACKET - SB-19	240	MOUNTING HEIGHT 30' AFG VERIFY FIXTURE AND POLE COLOR WITH OWNER.
B	4' STANDARD INDUSTRIAL LED FIXTURE, DIE FORMED CODE-GAUGE STEEL WITH WHITE ENAMEL FINISH, 12" WIDE REFLECTOR, NON-DIMMING DRIVER	-	52W LED 4000K	H.E.WILLIAMS (OR EQUAL)	80-4-L63/840-DRV-120	120	MOUNTING HEIGHT APPROX. 16' AFF.

ELECTRICAL GENERAL NOTES

- ALL WORK SHALL BE PERFORMED IN ACCORDANCE WITH FLORIDA BUILDING CODE 6th EDITION (2017 FBC), THE 2014 NATIONAL ELECTRICAL CODE (NEC), ALL APPLICABLE LOCAL, COUNTY, AND STATE CODES AND STANDARDS, ALL REQUIREMENTS OF THE SERVING ELECTRIC UTILITY AND THE AMERICANS WITH DISABILITIES ACT (ADA).
- COORDINATE WITH OTHER TRADES FOR EXACT LOCATIONS OF ALL MOTORS AND OTHER EQUIPMENT TO BE INSTALLED AND/OR WIRED UNDER THIS DIVISION BUT FURNISHED UNDER ANOTHER DIVISION OF THE SPECIFICATIONS.
- ALL BRANCH CIRCUITS FOR 120 VOLT, 20 AMP CIRCUITS EXCEEDING EIGHTY FEET IN LENGTH SHALL BE INCREASED IN SIZE AS REQUIRED TO ALLOW FOR VOLTAGE DROP LOSSES.
- PACK ALL SLEEVES FOR CONDUITS PASSING THROUGH FIRE RATED WALLS AND FLOOR SLABS WITH FIRE RESISTANT MATERIALS. ALL PENETRATIONS SHALL BE UL RATED.
- ALL EMPTY CONDUITS (EC) SHALL BE PROVIDED WITH NYLON PULL WIRES.
- TYPE AC CABLE AND ELECTRICAL NON-METALLIC TUBING SHALL NOT BE PERMITTED. TYPE MC CABLE IS PERMITTED AS LONG AS IT IS ACCEPTABLE TO THE LOCAL AUTHORITY HAVING JURISDICTION (AHJ).
- COORDINATE THE REQUIRED SIZE OF ALL CIRCUIT BREAKERS FEEDING EQUIPMENT (I.E. MOTORS, HVAC, KITCHEN EQUIPMENT, SPECIAL PURPOSE OUTLETS, OWNER FURNISHED EQUIPMENT, ETC.) WITH APPROVED EQUIPMENT SHOP DRAWINGS AND OWNER REPRESENTATIVES PRIOR TO ORDERING PANELBOARDS. BREAKERS SHALL BE SIZED PER THE NEC, THE EQUIPMENT NAME PLATE AND MANUFACTURER'S RECOMMENDATIONS.
- THE POWER COMPANY SHALL BE CONTACTED WITHIN 10 DAYS OF THE AWARD OF THE CONTRACT BY THE CONTRACTOR TO VERIFY THE ACTUAL AVAILABLE SHORT CIRCUIT FAULT CURRENT (SCC) AT THE TRANSFORMER SECONDARY BUSHINGS. THE CONTRACTOR SHALL PROVIDE ELECTRICAL DISTRIBUTION AND UTILIZATION EQUIPMENT AND PANELBOARDS WHICH HAVE AIC/WITHSTAND RATINGS GREATER THAN THE AVAILABLE SCC.
- ALL CONDUITS IN OR UNDER SLAB OR UNDERGROUND SHALL BE PVC SCHEDULE 40 UNLESS OTHERWISE NOTED.
- ALL CONDUITS ABOVE SLAB, WHETHER EXPOSED OR CONCEALED, SHALL BE EMT, IMC, OR RIGID GALVANIZED STEEL.
- FLEXIBLE METAL RACEWAYS SHALL NOT EXCEED 6' IN LENGTH.
- "LIQUID-TIGHT" TYPE FLEXIBLE WEATHERPROOF RACEWAYS SHALL HAVE A METALLIC INTERIOR AND NOT EXCEED 6' IN LENGTH.
- ALL BOXES, PLASTER RINGS, EXTENSION RINGS, AND BOX COVERS SHALL BE METAL.
- ALL CONDUITS SHALL BE PARALLEL AND PERPENDICULAR TO STRUCTURAL MEMBERS.
- ALL BENDS SHALL BE MADE IN CONDUIT USING PROPER EQUIPMENT AND MEET NATIONAL ELECTRICAL CODE (NEC) REQUIREMENTS.
- ALL WIRE, INCLUDING BUT NOT LIMITED TO FEEDERS AND BRANCH CIRCUIT WIRING, SHALL BE COPPER - #12 AWG THWN MINIMUM EXCEPT FOR LOW-VOLTAGE WIRING FOR COMMUNICATIONS SYSTEMS, WHICH MAY BE SMALLER.
- ALL BREAKERS SHALL BE "FULL SIZE". NO TANDEM, PIGGY BACK, TWIN, OR HALF SIZE BREAKERS WILL BE ACCEPTED.
- ALL DEVICES SHALL BE COMMERCIAL OR SPECIFICATION GRADE.
- ELECTRICAL CONTRACTOR SHALL BE RESPONSIBLE FOR TEMPORARY POWER AND TEMPORARY LIGHTING DURING CONSTRUCTION. TEMPORARY POWER SHALL PROVIDE ADEQUATE POWER FOR NORMAL CONSTRUCTION USE. TEMPORARY LIGHTING SHALL PROVIDE ADEQUATE LIGHT SO THAT THE INDIVIDUAL TRADES WORK CAN BE COMPLETED.
- ALL ELECTRICAL EQUIPMENT SHALL BE UL LISTED.
- A GREEN INSULATED COPPER GROUND CONDUCTOR SHALL BE INSTALLED IN ALL RACEWAYS.
- GROUNDING SYSTEM SHALL BE IN ACCORDANCE WITH NEC ARTICLE 250 AND APPLICABLE REQUIREMENTS OF IEEE STANDARDS 142 AND 241.
- TEST RESISTANCE TO GROUND (EARTHING CONNECTION) WITH RESISTANCE TESTER SUBSEQUENT TO FINAL INSTALLATION. WHERE TEST INDICATES RESISTANCE TO GROUND IS OVER 5 OHMS, TAKE APPROPRIATE ACTION TO REDUCE RESISTANCE TO 5 OHMS OR LESS BY DRIVING ADDITIONAL PROPERLY SPACED GROUND RODS AND TREATING SOIL IN PROXIMITY OF GROUND RODS WITH COMMON SALT, COPPER SULFATE OR MAGNESIUM SULFATE. RETEST TO DEMONSTRATE COMPLIANCE.
- CONDUCTORS ARE SIZED FOR VOLTAGE DROP PER N.E.C. ARTICLES 210.19(A) NOTE 4, 215.2(A)(1)NOTE 2 AND THE 2017 F.B.C. ENERGY CONSERVATION CODE C405.6.3. ELECTRICAL CONTRACTOR SHALL PERFORM VOLTAGE DROP CALCULATIONS IN ACCORDANCE WITH N.E.C. ARTICLES 210.19(A)(1)NOTE 4, 215.2(A)NOTE 2 AND THE 2017 F.B.C. ENERGY CONSERVATION CODE C405.6.3 ON ANY CIRCUITS THAT ARE INSTALLED THAT DIFFER FROM THE DESIGN SHOWN IN THESE PLANS. FEEDER CONDUCTORS AND BRANCH CIRCUIT CONDUCTORS SHALL EACH BE SIZED FOR A MAXIMUM VOLTAGE DROP OF 3% AND A COMBINED MAXIMUM VOLTAGE DROP OF 5% TOTAL.
- THE CONTRACTOR SHALL PROVIDE A COMPLETE ELECTRICAL SHOP DRAWING SUBMITTAL TO THE ENGINEER FOR REVIEW AND APPROVAL. THE ELECTRICAL SUBMITTAL SHALL INCLUDE ALL ELECTRICAL PANELS, MDP'S, BREAKERS, DISCONNECTS, DEVICES, RECEPTACLES, CONDUIT, RACEWAYS, LIGHT FIXTURES, POLES, SWITCHES, OCCUPANCY SENSORS, PULL BOXES, WIRING, ETC. CONTRACTOR SHALL NOT ORDER ANY ELECTRICAL EQUIPMENT UNTIL THIS SUBMITTAL IS REVIEWED AND ACCEPTED BY THE ENGINEER OF RECORD. CONTRACTOR SHALL SUBMIT THE SHOP DRAWINGS AS ONE COMPLETE SUBMITTAL AND SHALL NOT PIECE-MEAL THE SUBMITTAL SPREAD OUT OVER THE COURSE OF DAYS AND WEEKS. FAILURE TO SUBMIT A COMPLETE ELECTRICAL SHOP DRAWING SUBMITTAL SHALL RESULT IN AN IMMEDIATE REJECTION OF THE SHOP DRAWING SUBMITTAL.


ELECTRICAL SYMBOL LIST

(SOME SYMBOLS MAY NOT BE USED ON THIS PROJECT.)


	RECESSED LIGHT FIXTURE
	CEILING MOUNTED LIGHT FIXTURE
	DOWNLIGHT
	WALL MOUNTED LIGHT FIXTURE
	CEILING MOUNTED EXIT LIGHT. ARROW INDICATES DIRECTIONAL ARROW ON FIXTURE, SHADED AREA INDICATES FACE OF FIXTURE.
	WALL OR END MOUNTED EXIT LIGHT
	EMERGENCY FIXTURE
	PHOTOCELL
	SINGLE POLE SWITCH, SUBSCRIPT LETTER INDICATES FIXTURE CONTROLLED. (3 = 3 WAY, 4 = 4 WAY, K = KEY OPERATED) MOUNTED 48" AFF
	20A, 2 POLE, 125V GROUNDED DUPLEX RECEPTACLE. 18" AFF UNLESS OTHERWISE NOTED. G = GROUND FAULT INTERRUPTER
	20A, 2 POLE, 125V GROUNDED QUAD RECEPTACLE.
	20A, 2 POLE, 125V GROUNDED DUPLEX RECEPTACLE. MOUNTED ABOVE COUNTERTOP UNLESS OTHERWISE NOTED.
	240V RECEPTACLE.
	TELEPHONE WALL OUTLET 18" AFF UNLESS OTHERWISE NOTED. PROVIDE 1" EC TO ACCESSIBLE CEILING SPACE.
	TELEPHONE AND DATA DUPLEX WALL OUTLET 18" AFF UNLESS OTHERWISE NOTED. PROVIDE 1" EC TO ACCESSIBLE CEILING SPACE.
	DATA DUPLEX WALL OUTLET 18" AFF UNLESS OTHERWISE NOTED. PROVIDE 1" EC TO ACCESSIBLE CEILING SPACE.
	TELEVISION OUTLET WITH 1" EC TO TTB. 18" AFF UNLESS OTHERWISE NOTED.
	CEILING MOUNTED JUNCTION BOX
	WALL MOUNTED JUNCTION BOX
	CONNECTION TO EQUIPMENT
	PUSHBUTTON
	MOTOR HORSEPOWER RATED TOGGLE SWITCH BY DIVISION 15
	NONFUSED DISCONNECT SWITCH. NUMBERS INDICATE SWITCH SIZE.
	FUSED DISCONNECT SWITCH. FUSES SIZED AS SHOWN ON DRAWINGS.
	MOTOR
	PANELBOARD
	FIRE ALARM/SECURITY CONTROL PANEL
	INTERCOM
	SECURITY DOOR CONTACT
	TELEPHONE TERMINAL BOARD (TTB)
	FIRE ALARM STROBE LIGHT, MOUNTED 80" AFF
	FIRE ALARM MANUAL PULL STATION, MOUNTED 48" AFF
	FIRE ALARM HORN WITH STROBE LIGHT, MOUNTED 80" AFF
	SPRINKLER FLOW SWITCH
	SPRINKLER TAMPER SWITCH
	KEY LOCK BOX
	HEAT DETECTOR
	DUCT SMOKE DETECTOR
	SMOKE DETECTOR
	AHU FIRE ALARM SHUTDOWN RELAY
	DOOR ALARM, MAGNETIC SWITCH
	WINDOW ALARM, MAGNETIC SWITCH
	ABOVE FINISH FLOOR
	FINISH FLOOR
	AIR HANDLING UNIT
	EMPTY CONDUIT
	EXHAUST FAN
	ELECTRIC WATER COOLER
	ELECTRIC WATER HEATER
	GROUND FAULT INTERRUPTER
	CONDENSING UNIT
	WEATHERPROOF (NEMA-3R)

CHK. BY		DESCRIPTION		DATE		REV	
SHEET TITLE SYMBOL LIST & GENERAL NOTES				PROJECT TITLE PORTER TRANSFER STATION SITE IMPROVEMENTS			
CLIENT ORANGE COUNTY SOLID WASTE DIVISION				CLIENT ORLANDO, FLORIDA			
							
CADD FILE: E-01		DATE: MARCH 2018		SCALE: AS SHOWN		DRAWING NO. E-01	
SHEET 32		OF 34		ISSUED FOR BIDDING		DATE: 03/19/18	


Digitally signed by Augusto E Bobes
DN: c=US, o=IdenTrust ACES Business Representative, ou=Bobes Associates Consulting Engineers, cn=Augusto E Bobes,
Date: 2018.03.20 16:08:19 -0400

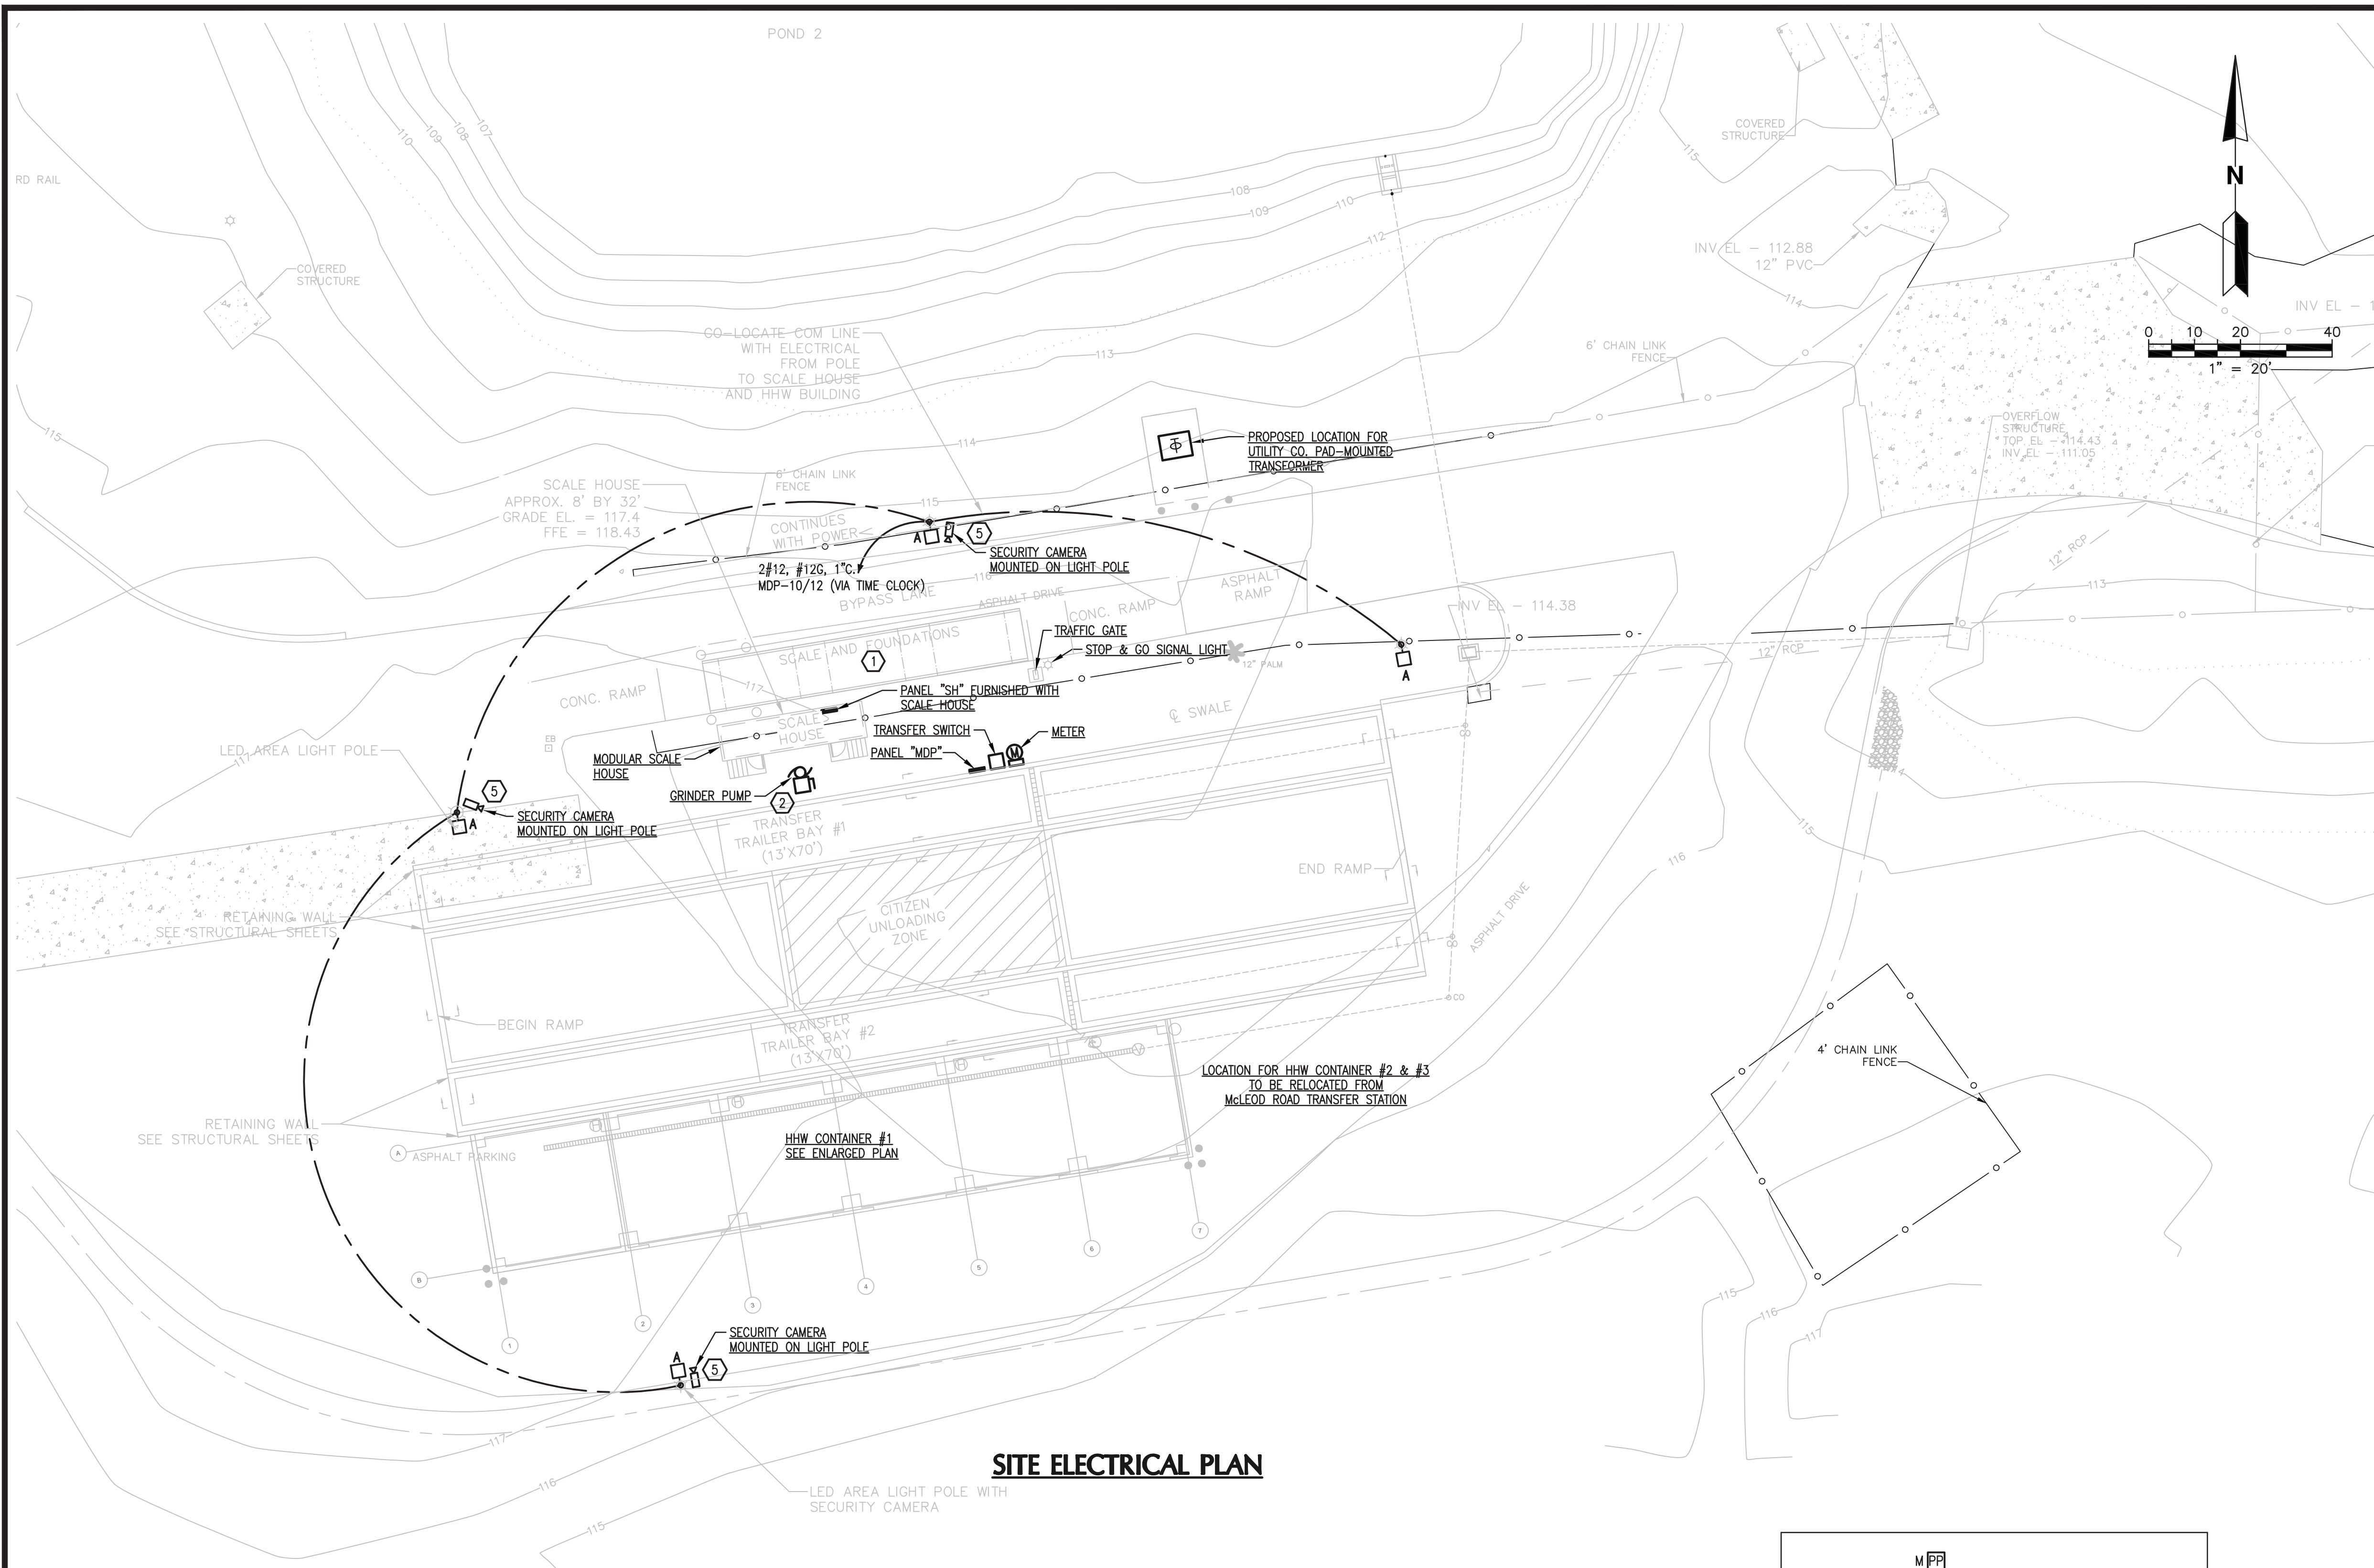

SITE ELECTRICAL PLAN

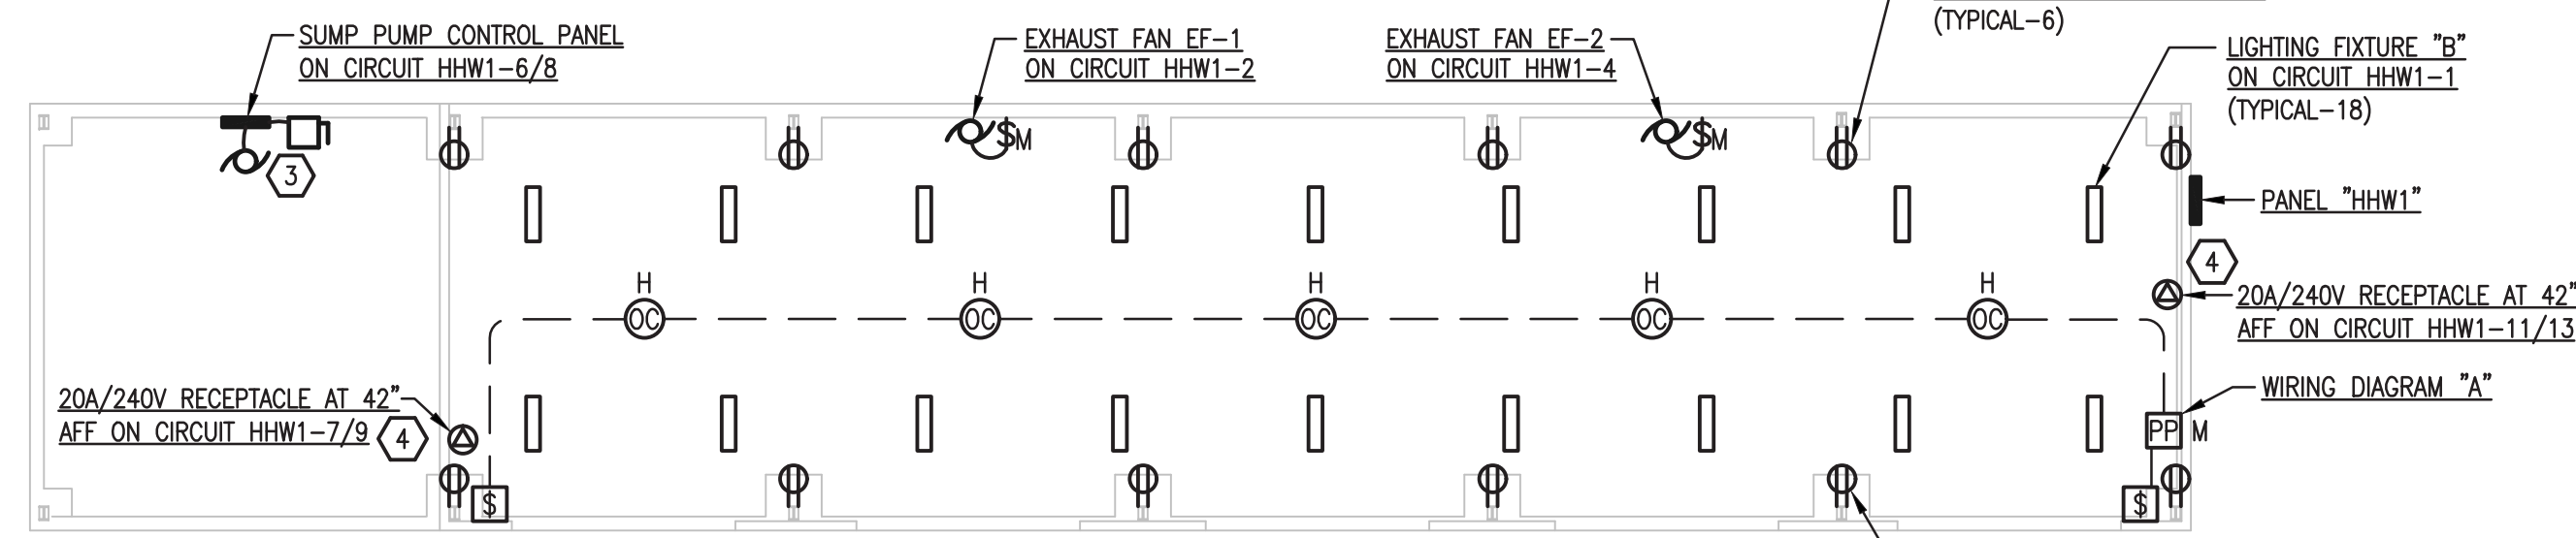

HHW CONTAINER #1 ENLARGED PLAN
N.T.S.

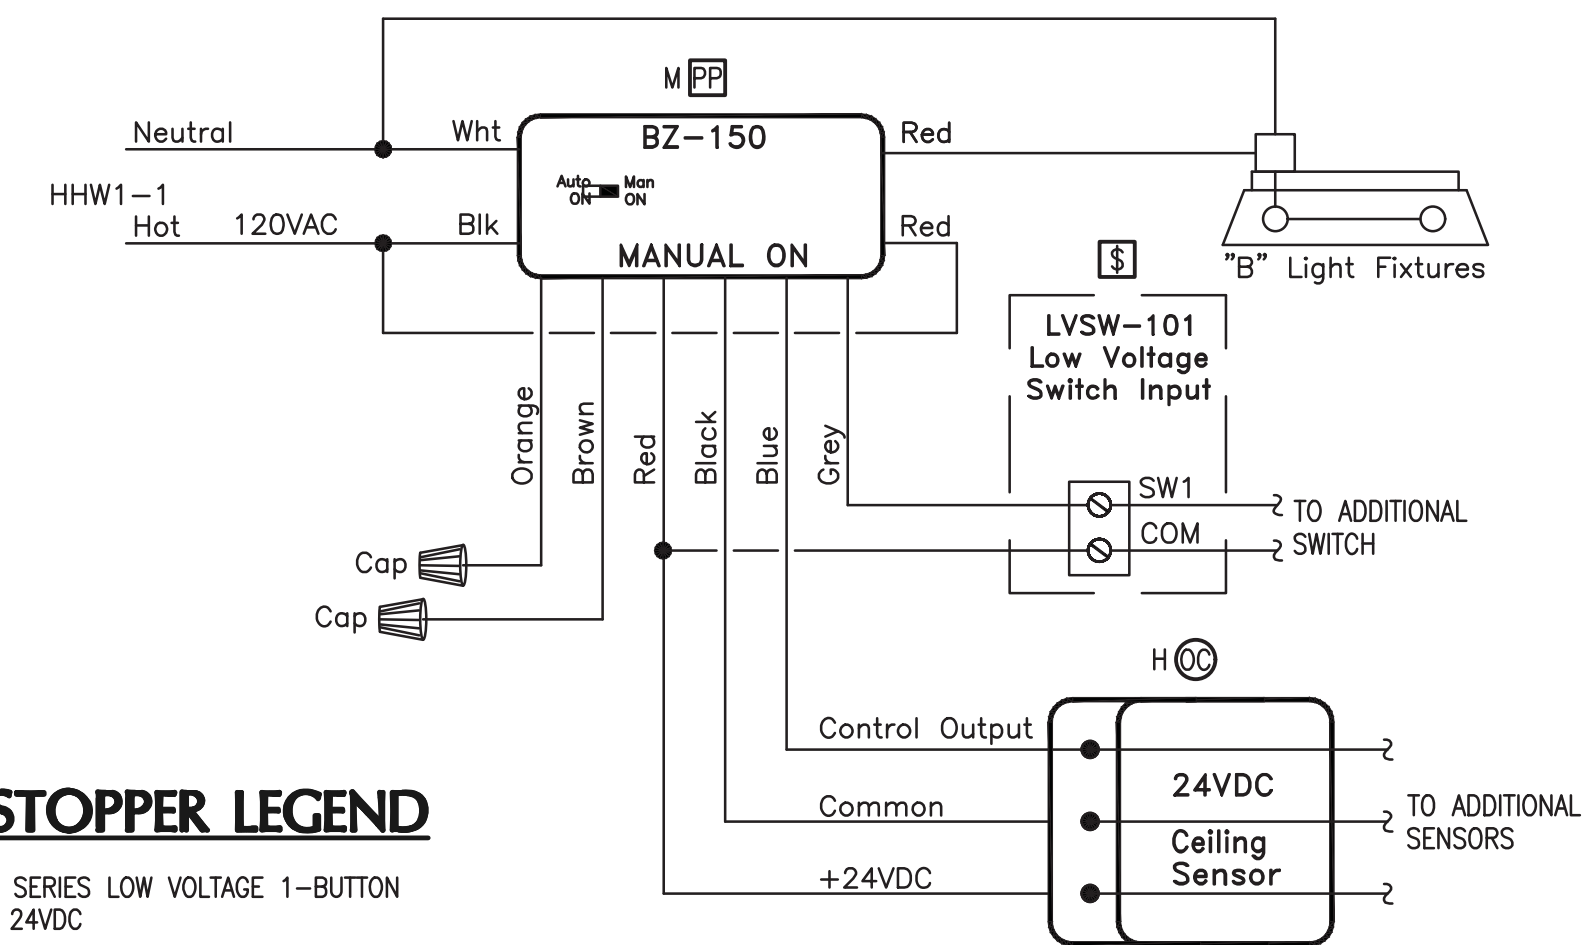

WATTSTOPPER LEGEND

- Ⓢ LVS-101-W, SERIES LOW VOLTAGE 1-BUTTON WALL SWITCH, 24VDC
- Ⓜ HB300B-L3 HIGH BAY PASSIVE INFRARED OCCUPANCY SENSOR, 24VDC
- Ⓜ BZ-150 UNIVERSAL VOLTAGE POWER PACK, AUTO OR MANUAL ON, 24VDC OUTPUT

LIGHTING CONTROL WIRING DIAGRAM "A"

GENERAL NOTES

1. REFER TO COMPLETE GENERAL NOTES ON SHEET E-01.

KEY NOTES

1. PROVIDE POWER FROM PANEL BOARD FURNISHED WITH MODULAR SCALE HOUSE FOR THE FOLLOWING EQUIPMENT:
 1. 120V CIRCUIT FOR THE SCALE INSTRUMENT FED THRU AN AC LINE SURGE PROTECTOR.
 2. 120V CIRCUIT FOR A COMPUTER & MONITOR FED THRU AN AC LINE SURGE PROTECTOR.
 3. 120V CIRCUIT & DATA LINE FOR A SCOREBOARD.
 4. 120V CIRCUIT FOR A STOP & GO SIGNAL LIGHT.
 5. 120V OR 240V CIRCUIT FOR A TRAFFIC GATE.
 6. 120V CIRCUIT FOR BUILDING EXTERIOR LIGHTS FED THRU PHOTOCELL & TIME CLOCK CONTROL.
 PROVIDE A 1 1/2" RIGID CONDUIT WITH 12" ELBOWS FOR CABLE HOME RUN FROM SCALE INSTRUMENT TO SCALE LOAD CELLS.
 PROVIDE A SINGLE POINT GROUND FOR ALL SCALE COMPONENTS FOR LIGHTNING PROTECTION. THE LIGHTNING PROTECTION SYSTEM SHALL BE A METTLER TOLEDO STRIKESHIELD (OR EQUAL).
 BASIS OF DESIGN FOR THIS SCALE SYSTEM IS METTLER TOLEDO POWERCELL PDX. COORDINATE ALL POWER REQUIREMENTS WITH MANUFACTURER'S SHOP DRAWINGS.
2. PROVIDE POWER FOR GRINDER PUMP CONTROL PANEL FROM PANEL "MDP", CIRCUIT 9/11, WITH 3#10 AND 1#10 GND IN 3/4" CONDUIT AND MAKE ALL CONNECTIONS PER MANUFACTURER'S INSTRUCTIONS. INSTALL A 2 POLE, 30 AMP, NEMA3R NON-FUSED DISCONNECT SWITCH FOR LOCAL DISCONNECT.
3. PROVIDE POWER FOR SUMP PUMP CONTROL PANEL FROM PANEL "HHW1", CIRCUIT 6/8, WITH 2#12 AND 1#10 GND IN 3/4" CONDUIT AND MAKE ALL CONNECTIONS PER MANUFACTURER'S INSTRUCTIONS. INSTALL A 2 POLE, 30 AMP, NEMA3R NON-FUSED DISCONNECT SWITCH FOR LOCAL DISCONNECT.
4. VERIFY EXACT RECEPTACLE AMPERAGE AND TYPE TO MEET OWNER'S REQUIREMENTS.
5. FOR SECURITY CAMERA INFORMATION SEE COMMUNICATIONS PLAN SHEET NO. 17.


CHK. BY		DESCRIPTION		DATE		REV	
SHEET TITLE NEW HHWF AND SCALE SITE PLAN				PROJECT TITLE PORTER TRANSFER STATION SITE IMPROVEMENTS			
CLIENT ORANGE COUNTY SOLID WASTE DIVISION				ORLANDO, FLORIDA			
		BOBES ASSOCIATES CONSULTING ENGINEERS 150 CIRCLE DRIVE, WILMINGTON, FL 32791 P. 904.234.2150 F. 904.234.2150 E-MAIL: INFO@BOBESCONS.COM FLORIDA STATE P.E. NUMBER: 5131		DATE: 03/19/18 SCALE: AS SHOWN DRAWING NO. E-02 SHEET 33 OF 34		CADD FILE: E-02 DATE: MARCH 2018 SCALE: AS SHOWN DRAWING NO. E-02 SHEET 33 OF 34	



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 DN: c=US, o=IdenTrust ACES Business Representative, ou=Bobes Associates Consulting Engineers, cn=Augusto E Bobes, o.9.2342.150200300.100.11=AO10
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 Date: 2018.03.20 16:08:55 -0400

ISSUED FOR BIDDING


DATE: 03/19/18

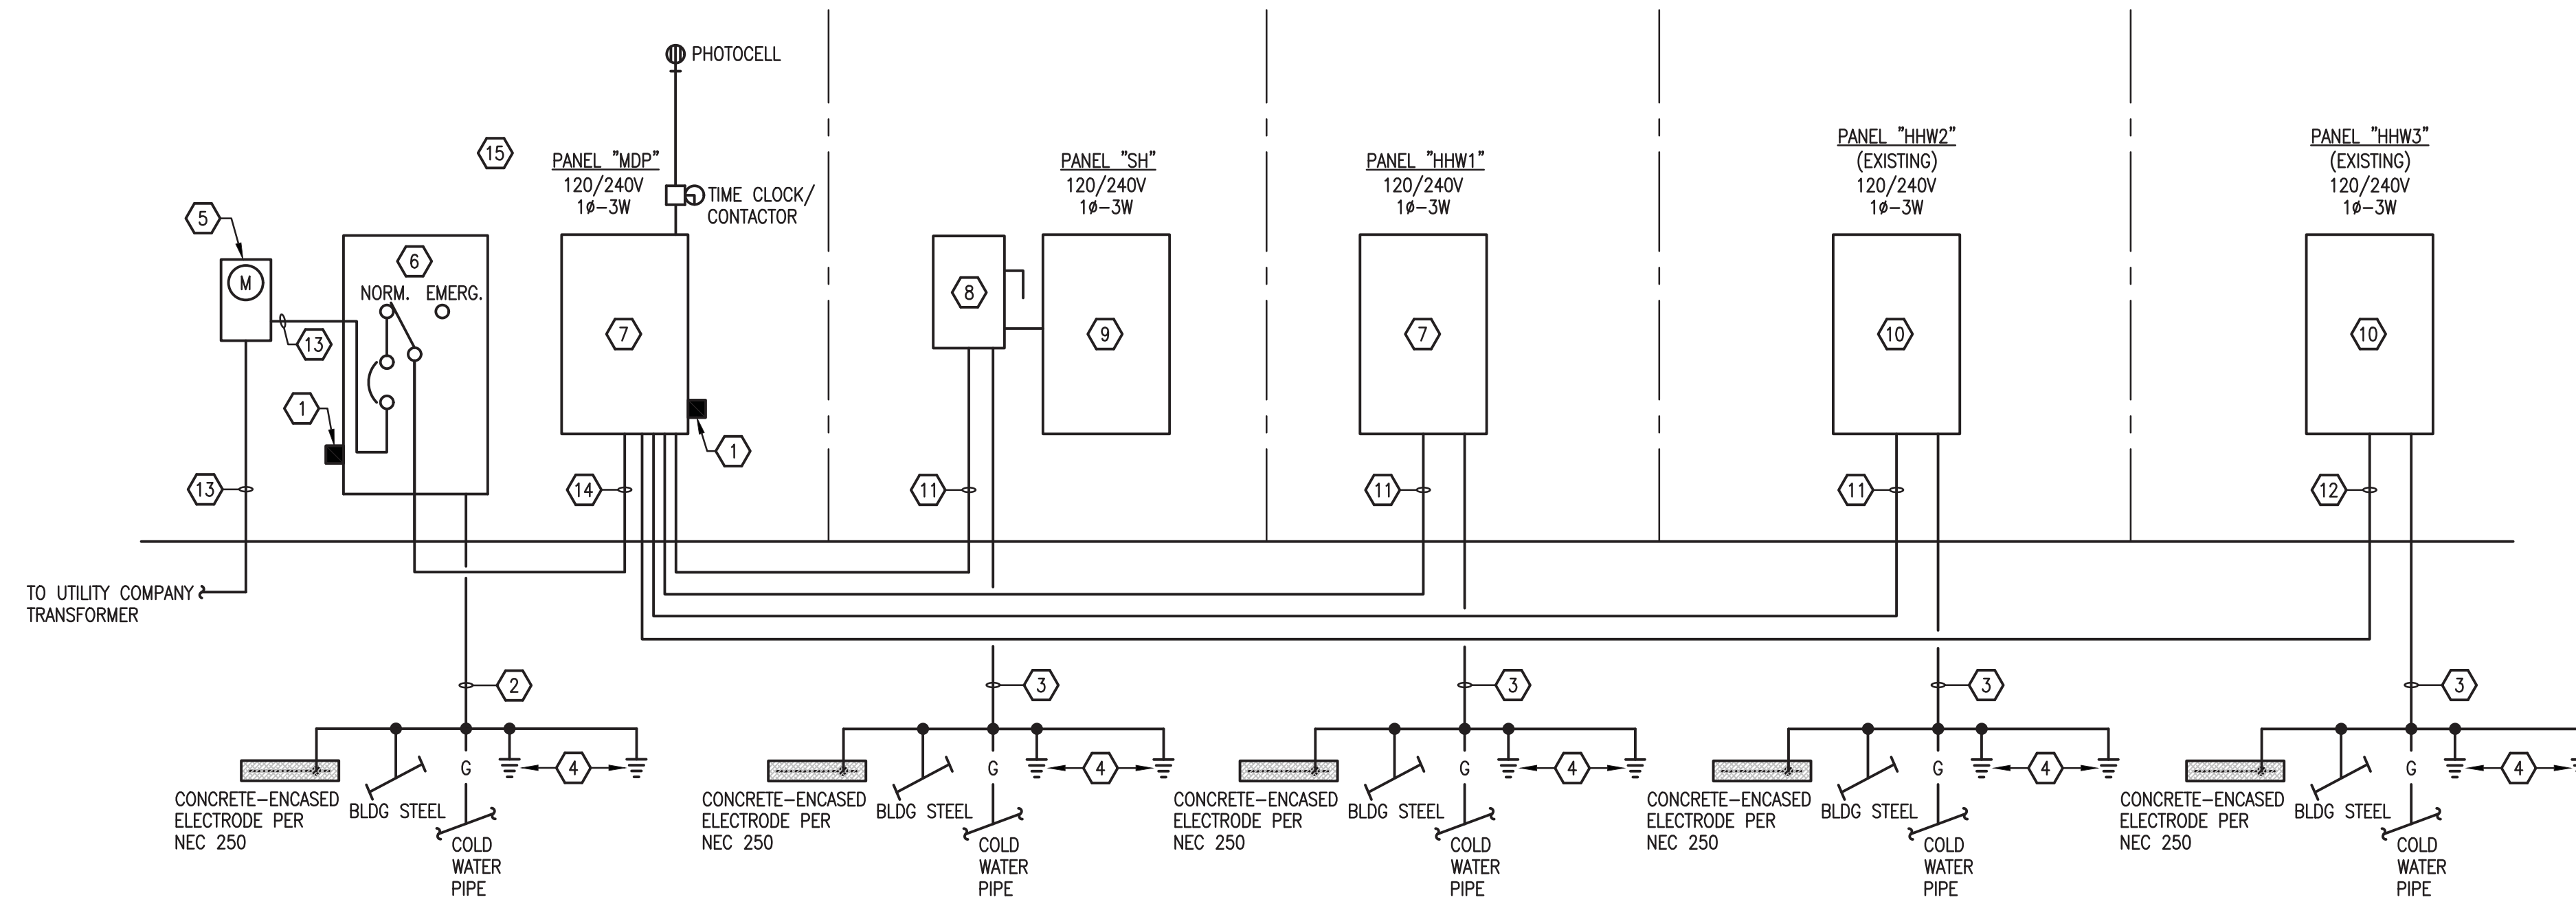

POWER RISER DIAGRAM
NOT TO SCALE

**POWER RISER DIAGRAM
KEY NOTES**


- 1 PROVIDE AND INSTALL LISTED LIGHTNING ARRESTER ON THE SERVICE FEEDERS AND SURGE SUPPRESSION DEVICE ON THE PANEL ACCORDING TO MANUFACTURER'S INSTRUCTIONS.
- 2 #1/0 INSULATED COPPER GROUNDING ELECTRODE CONDUCTOR, INSTALL IN 1/2".
- 3 #8 INSULATED COPPER GROUNDING ELECTRODE CONDUCTOR, INSTALL IN 1/2".
- 4 3/4" x 10'-0" COPPERCLAD GROUND RODS. INSTALL 10'-0" APART AND CONNECT GROUND SYSTEM PER NEC ARTICLE 250. PROVIDE GROUND TEST WELL AT EACH GROUND ROD. REFER TO DETAIL.
- 5 METER AND METER SOCKET, COORDINATE ALL REQUIREMENTS WITH UTILITY COMPANY PRIOR TO BID.
- 6 PORTABLE GENERATOR DOCKING STATION WITH ROTARY TRANSFER SWITCH AND INTEGRAL 400A MAIN CIRCUIT BREAKER, SERVICE ENTRANCE RATED, 400A, 120/240V, 1Ø, 3W, MALE CAMLOCK CONNECTIONS FOR GENERATOR CONNECTION. BASIS OF DESIGN IS TRYSTAR MODEL #GDS-041W-LM-R. PROVIDE ENGRAVED SIGN TO READ "MAIN SERVICE DISCONNECT".
- 7 FOR PANELBOARD INFORMATION SEE PANEL SCHEDULE. VERIFY AIC WITH UTILITY CO. PRIOR TO ORDERING PANEL AND PROVIDE PANEL WITH THE AIC RATING AS REQUIRED.
- 8 PROVIDE AND INSTALL A HEAVY DUTY DISCONNECT SWITCH, 2P, 100A, NEMA 3R, SERVICE ENTRANCE RATED.
- 9 120/240V, 1Ø, 3W, 100 AMP PANEL BOARD TO BE FURNISHED WITH HOUSEHOLD WASTE CONTAINER ON INTERIOR.
- 10 120/240V, 1Ø, 3W, NEMA 3R PANEL BOARD TO BE FURNISHED WITH HOUSEHOLD WASTE CONTAINER ON EXTERIOR.
- 11 1 1/4". - 3Ø3, 1Ø8 GND.
- 12 1". - 3Ø4, 1Ø8 GND.
- 13 3 1/2". - 3Ø600kcmil.
- 14 3 1/2". - 3Ø600kcmil, 1Ø3 GND.
- 15 MOUNT SERVICE ENTRANCE EQUIPMENT AS REQUIRED ON A RACK CONSTRUCTED FROM 4"x4" (MINIMUM) CONCRETE POSTS AND STAINLESS STEEL UNISTRUT CHANNEL.

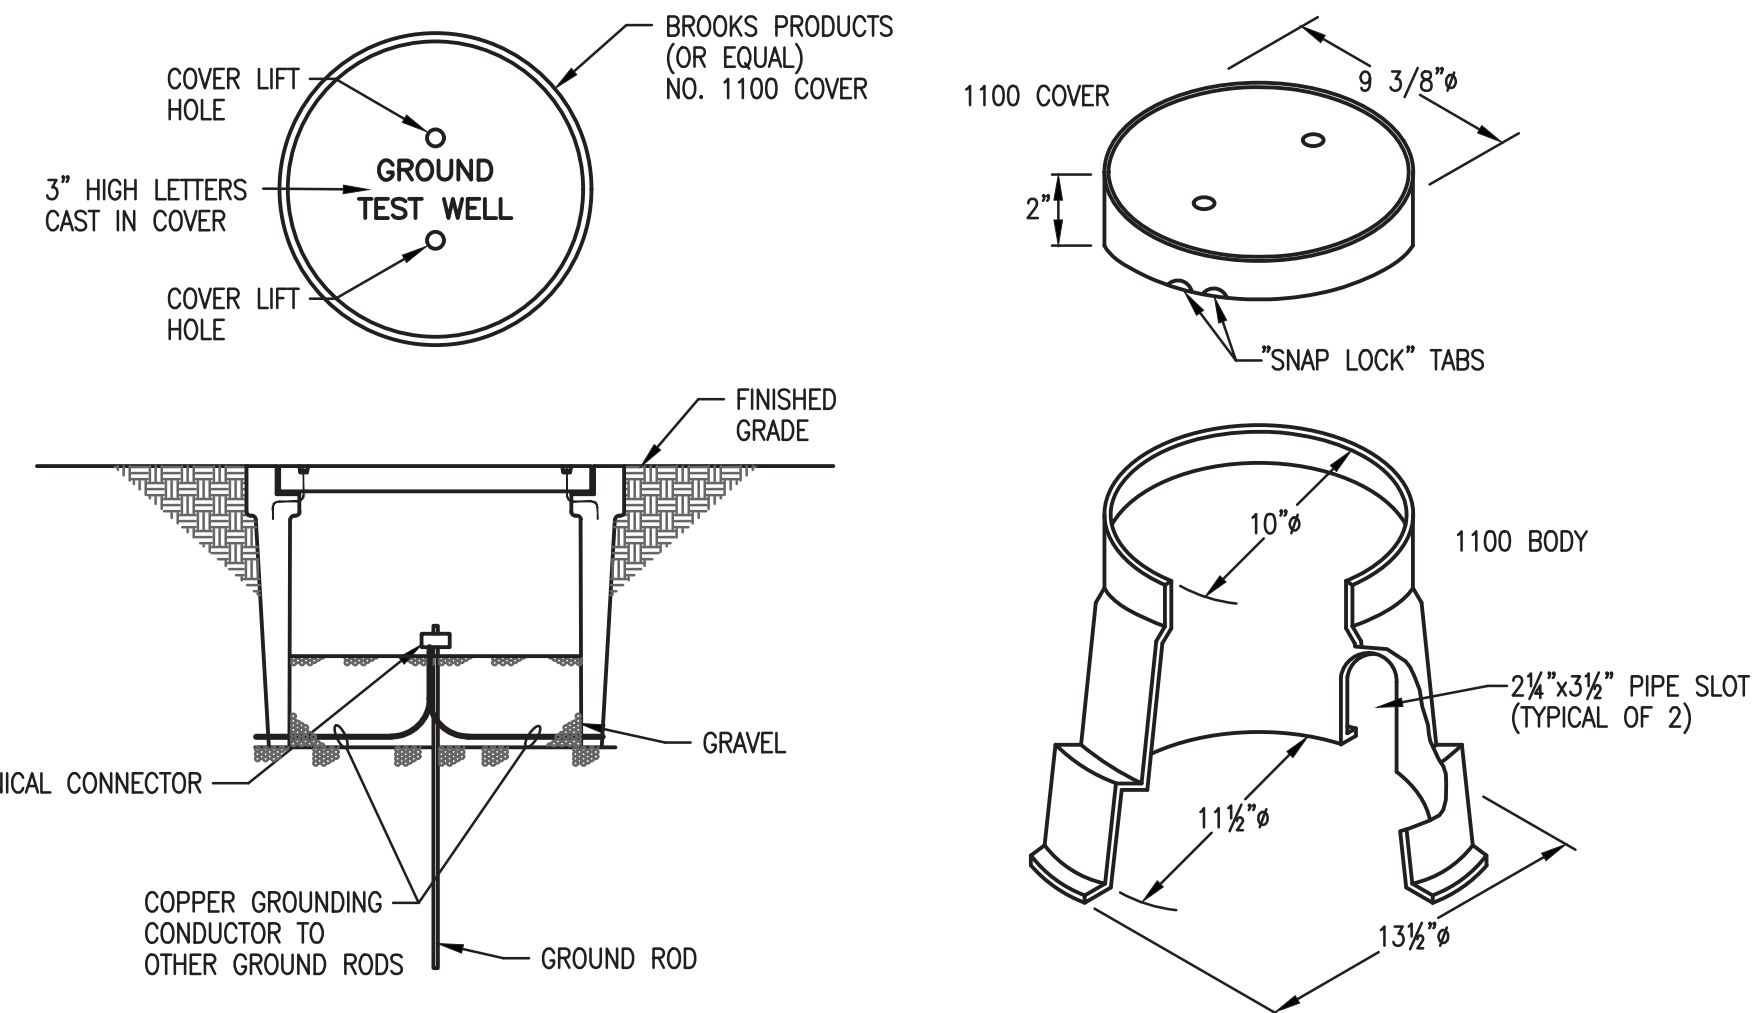

GROUND TEST WELL DETAIL
NOT TO SCALE

PANEL LOCATION: EQUIPMENT RACK		PANEL DESIGNATION: MDP		VOLTAGE: 120/240V, 1Ø, 3W		AIC RATING: 22K													
PANEL FED FROM: UTILITY TRANSFORMER		PANELBOARD RATING: 400A		MANUFACTURER: SQUARE D		MOUNTING: SURFACE													
		MAINS: MAIN LUGS ONLY		STYLE: NQ		NEMA TYPE: 3R													
LOAD DESCRIPTION	WATTS/PHASE	BKR	POLE	CKT	POLE	BKR	WATTS/PHASE	LOAD DESCRIPTION											
SCALE HOUSE PANEL "SH"	9600	100	2	1	2	2	9600	HHW CONTAINER #2 PANEL "HHW2"											
HHW CONTAINER #1 PANEL "HHW1"	7656	100	2	5	6	2	7620	HHW CONTAINER #3 PANEL "HHW3"											
GRINDER PUMP CONTROL PANEL	2880	30	2	9	10	2	366	SITE LIGHTING											
SPACE	X	X	X	13	14	1	240	LIGHTING CONTROL											
SPACE	X	X	X	15	16	X	X	SPACE											
SPACE	X	X	X	17	18	X	X	SPACE											
SPACE	X	X	X	19	20	X	X	SPACE											
SPACE	X	X	X	21	22	X	X	SPACE											
SPACE	X	X	X	23	24	X	X	SPACE											
SPACE	X	X	X	25	26	X	X	SPACE											
SPACE	X	X	X	27	28	2	30	SPD											
SPACE	X	X	X	29	30	-	-	SPACE											
PANELBOARD SUB-TOTALS				20136				19200				16926				16686			
LOAD CALCULATIONS:		CONNECTED LOAD (WATTS)		DEMAND FACTOR		ESTIMATED DEMAND LOAD (WATTS)		NOTES:											
LIGHTING		4308		1.25		5385													
RECEPTACLES (FIRST 10 KW)		2160		1.00		2160													
RECEPTACLES (REMAINDER)		X		0.50		X													
HVAC (WORST CASE)		X		1.00		X													
WATER HEATING		X		1.00		X													
KITCHEN		X		0.65		X													
MISCELLANEOUS		66480		1.00		66480													
PANELBOARD TOTALS:		72948W (304A)				74025W (308A)													

PANEL LOCATION: CONTAINER "HHW1"		PANEL DESIGNATION: HHW1		VOLTAGE: 120/240V, 1Ø, 3W		AIC RATING: 22K													
PANEL FED FROM: PANEL "MDP"		PANELBOARD RATING: 100A		MANUFACTURER: SQUARE D		MOUNTING: SURFACE													
		MAINS: 100A MAIN BREAKER		STYLE: NQ		NEMA TYPE: 3R													
LOAD DESCRIPTION	WATTS/PHASE	BKR	POLE	CKT	POLE	BKR	WATTS/PHASE	LOAD DESCRIPTION											
LIGHTS	936	20	1	1	2	1	20	EXHAUST FAN EF-1											
RECEPTACLES	1080	20	1	3	4	1	20	EXHAUST FAN EF-2											
RECEPTACLES	1080	20	1	5	6	2	15	SUMP PUMP CONTROL PANEL											
RECEPTACLE	1920	20	2	7	8	-	-	SPACE											
RECEPTACLE	1920	20	2	9	10	X	X	SPACE											
RECEPTACLE	1920	20	2	11	12	X	X	SPACE											
SPACE	1920	X	X	13	14	X	X	SPACE											
SPACE	X	X	X	15	16	X	X	SPACE											
SPACE	X	X	X	17	18	X	X	SPACE											
PANELBOARD SUB-TOTALS				5856				4920				1800				1800			
LOAD CALCULATIONS:		CONNECTED LOAD (WATTS)		DEMAND FACTOR		ESTIMATED DEMAND LOAD (WATTS)		NOTES:											
LIGHTING & EXHAUST FANS		3336		1.25		4170													
RECEPTACLES (FIRST 10 KW)		2160		1.00		2160													
RECEPTACLES (REMAINDER)		X		0.50		X													
HVAC (WORST CASE)		X		1.00		X													
WATER HEATING		X		1.00		X													
KITCHEN		X		0.65		X													
MISCELLANEOUS		8880		1.00		8880													
PANELBOARD TOTALS:		14376W (60A)				15210W (63A)													

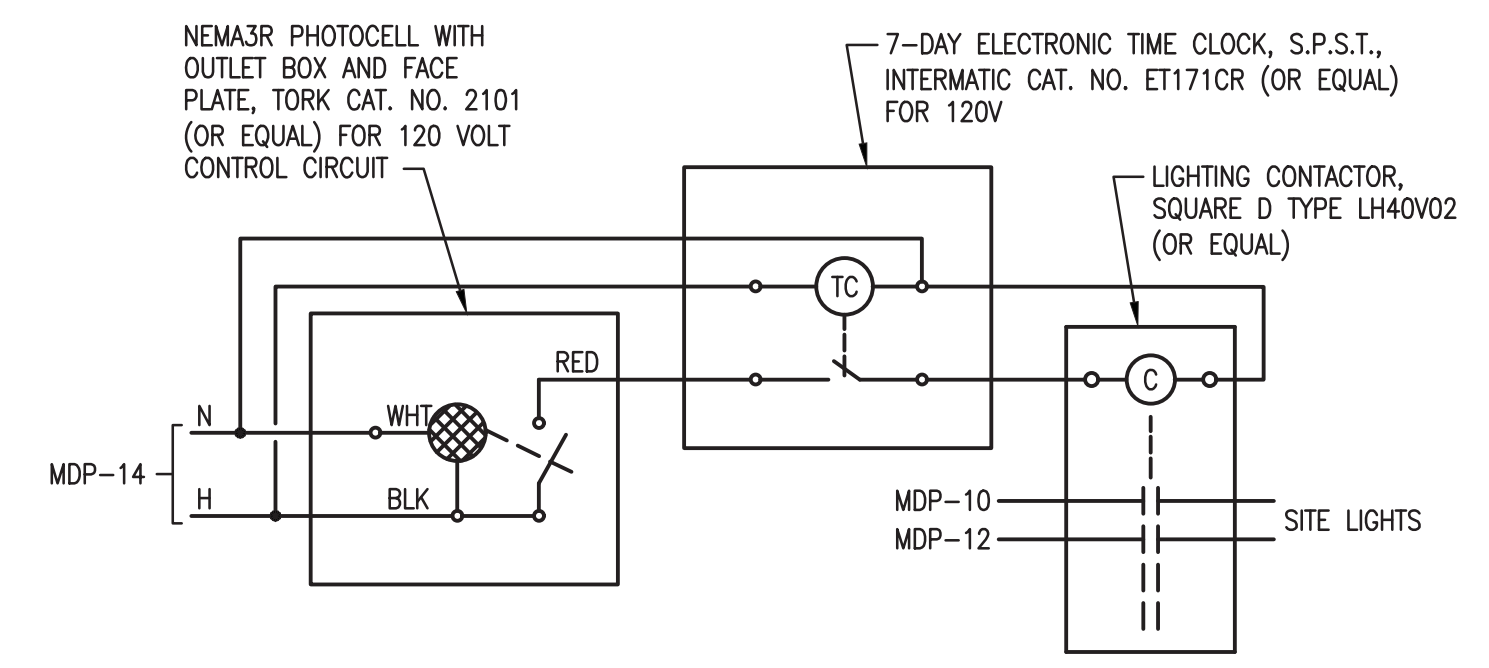

**PHOTOCELL ON / TIME CLOCK OFF
WIRING DIAGRAM**



EXISTING PANEL "HHW2"



EXISTING PANEL "HHW3"



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DN: cn=US, o=IdentTrust ACES
Business Representative,
ou=Bobes Associates Consulting
Engineers, cn=August E Bobes,
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ISSUED FOR BIDDING
DATE: 03/19/18

CADD FILE: E-03
DATE: MARCH 2018
SCALE: AS SHOWN
DRAWING NO. E-03
SHEET 34 of 34

SHEET TITLE: PANEL SCHEDULE & RISER DIAGRAM
PROJECT TITLE: PORTER TRANSFER STATION SITE IMPROVEMENTS

ORANGE COUNTY SOLID WASTE DIVISION
ORLANDO, FLORIDA

CLIENT: BOBES ASSOCIATES CONSULTING ENGINEERS
150 ORCHARD DRIVE, WINTERLAND, FL 32791
E-MAIL: INFO@BOBESCONSULTING.COM
FLORIDA STATE P.E. NUMBER: 0131
DWG. BY: WMC
CHK. BY: WMC
APP. BY: A.B.J.

CHK. BY: [Blank]
DESCRIPTION: [Blank]
DATE: [Blank]
REV: [Blank]

AUGUSTO E. BOBES JR., P.E.
LICENSE NO. 39410