

# ORANGE COUNTY CONVENTION CENTER WEST ENTRANCE IDF ROOM HVAC UPGRADE

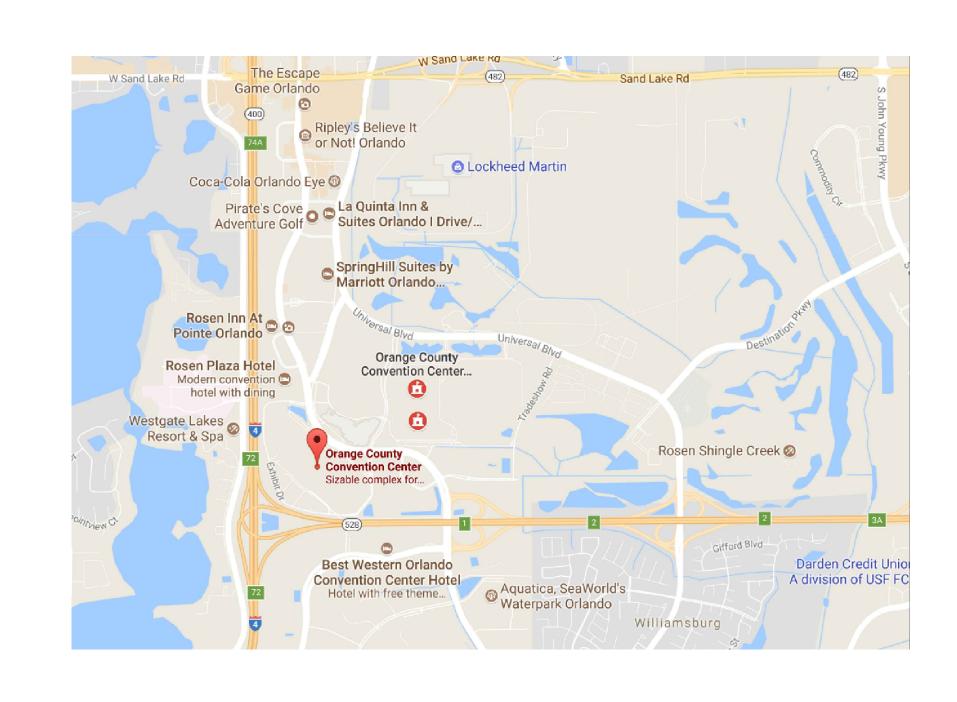


100% DOCUMENTS NOVEMBER 21, 2017



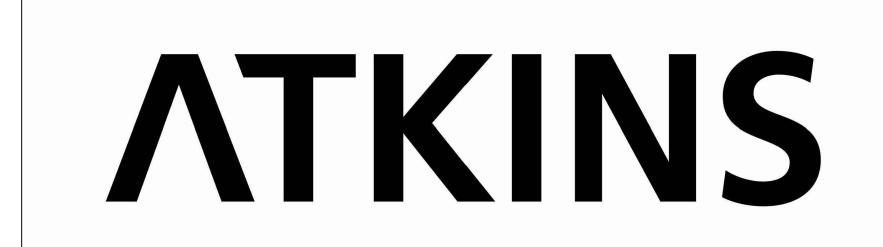

482 SOUTH KELLER ROAD ORLANDO, FLORIDA 32810

| Sheet   |   |            | Sheet  |
|---------|---|------------|--------|
| Number  | Sheet Name                                  | Scale      | Issued |
| MECHAN  |   |            |        |
| M-000   | COVER SHEET AND<br>SHEET INDEX              | No Scale   | Yes    |
| M-001   | HVAC SYMBOLS LEGEND<br>AND GENERAL NOTES    | No Scale   | Yes    |
| M-101   | HVAC DEMOLITION PLAN<br>LEVELS I & III      | 1/4"=1'-0" | Yes    |
| M-102   | HVAC NEW WORK PLAN<br>LEVELS   &            | 1/4"=1'-0" | Yes    |
| M-301   | HVAC DETAILS                                | No Scale   | Yes    |
| M-501   | HVAC SCHEDULES                              | No Scale   | Yes    |
| ELECTRI | CAL SHEETS                                  |            |        |
| E-001   | ELECTRICAL LEGEND<br>SCHEDULES AND ONE-LINE | No Scale   | Yes    |
| E-100   | ELECTRICAL DEMO WORK<br>PLAN LEVEL III      | 1/4"=1'-0" | Yes    |
| E-101   | ELECTRICAL NEW WORK<br>PLAN LEVEL III       | 1/4"=1'-0" | Yes    |

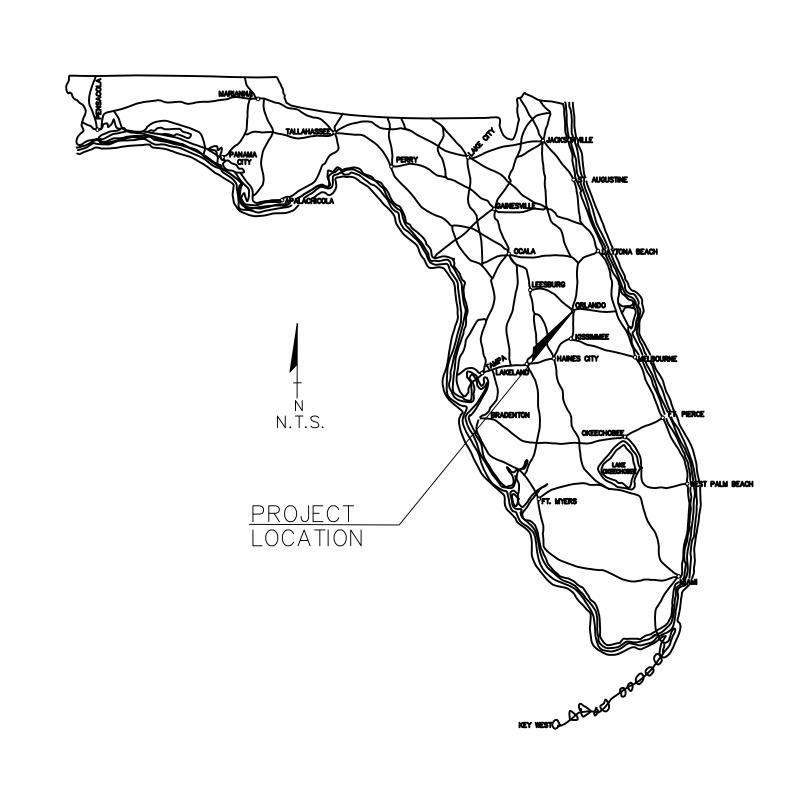

ATKINS

482 SOUTH KELLER ROAD
ORLANDO, FL 32810
PHONE: 407.647.7275 FAX: 407.740.8958

CONSULTANT:

COUNTY
GOVERNMENT
F L O R I D A

PROJECT N

## V CENTER C UPGRADE

ORANGE COUNTY CONVENTION CEEST ENTRANCE IDF ROOM HVAC U

9800 INTERNATIONAL DRIVE ORLANDO, FL 3281

No. Date Description

ISSUE LOG
PROFESSIONAL SEALS:

KELLIE A. RAMOS, P.E. FLORIDA REG NO. 76996

SHEET TITLE:

COVER SHEET AND SHEET INDEX

 SHEET INFORMATION:


 JOB No. 100056524
 Date Issued: November 21, 2017

 Designed By:
 KAR

 Checked By:
 DLH

 QC Review:
 TJF

 Phase:
 1009/ CD

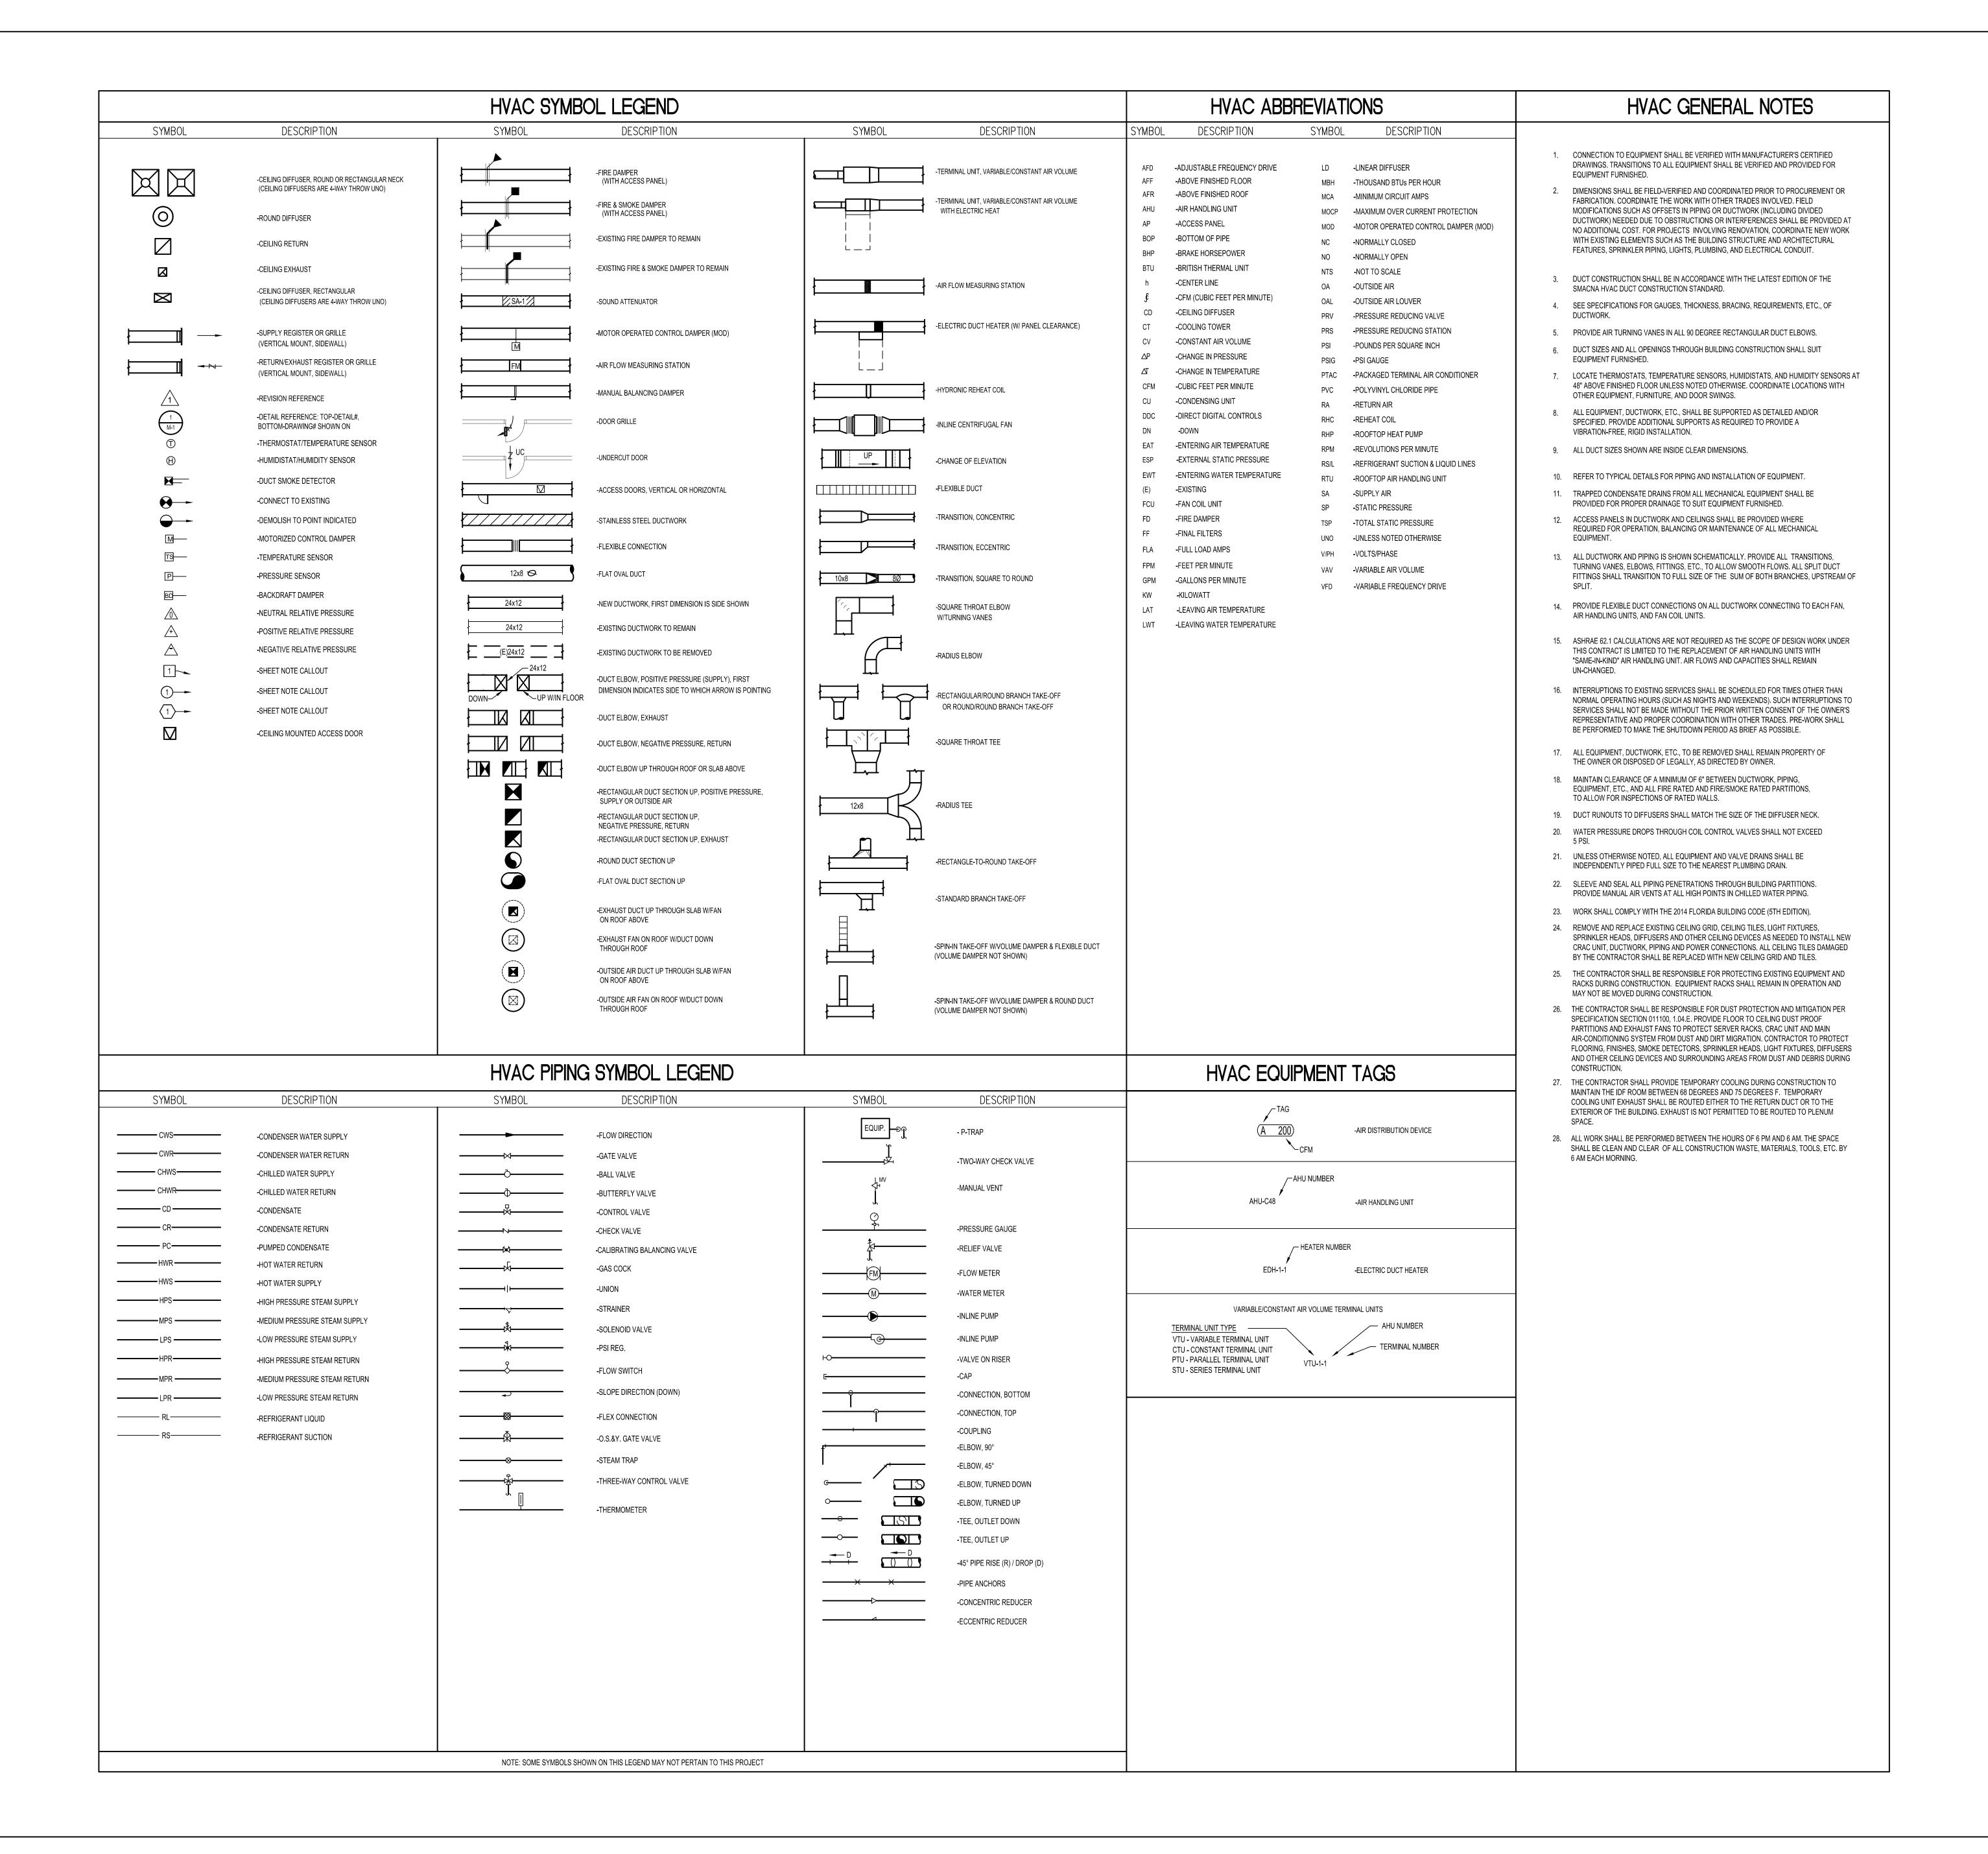

**ATKINS** 

**482 SOUTH KELLER ROAD** ORLANDO, FL 32810 PHONE: 407.647.7275 FAX: 407.740.8958

CONSULTANT:



PROJECT NAME:

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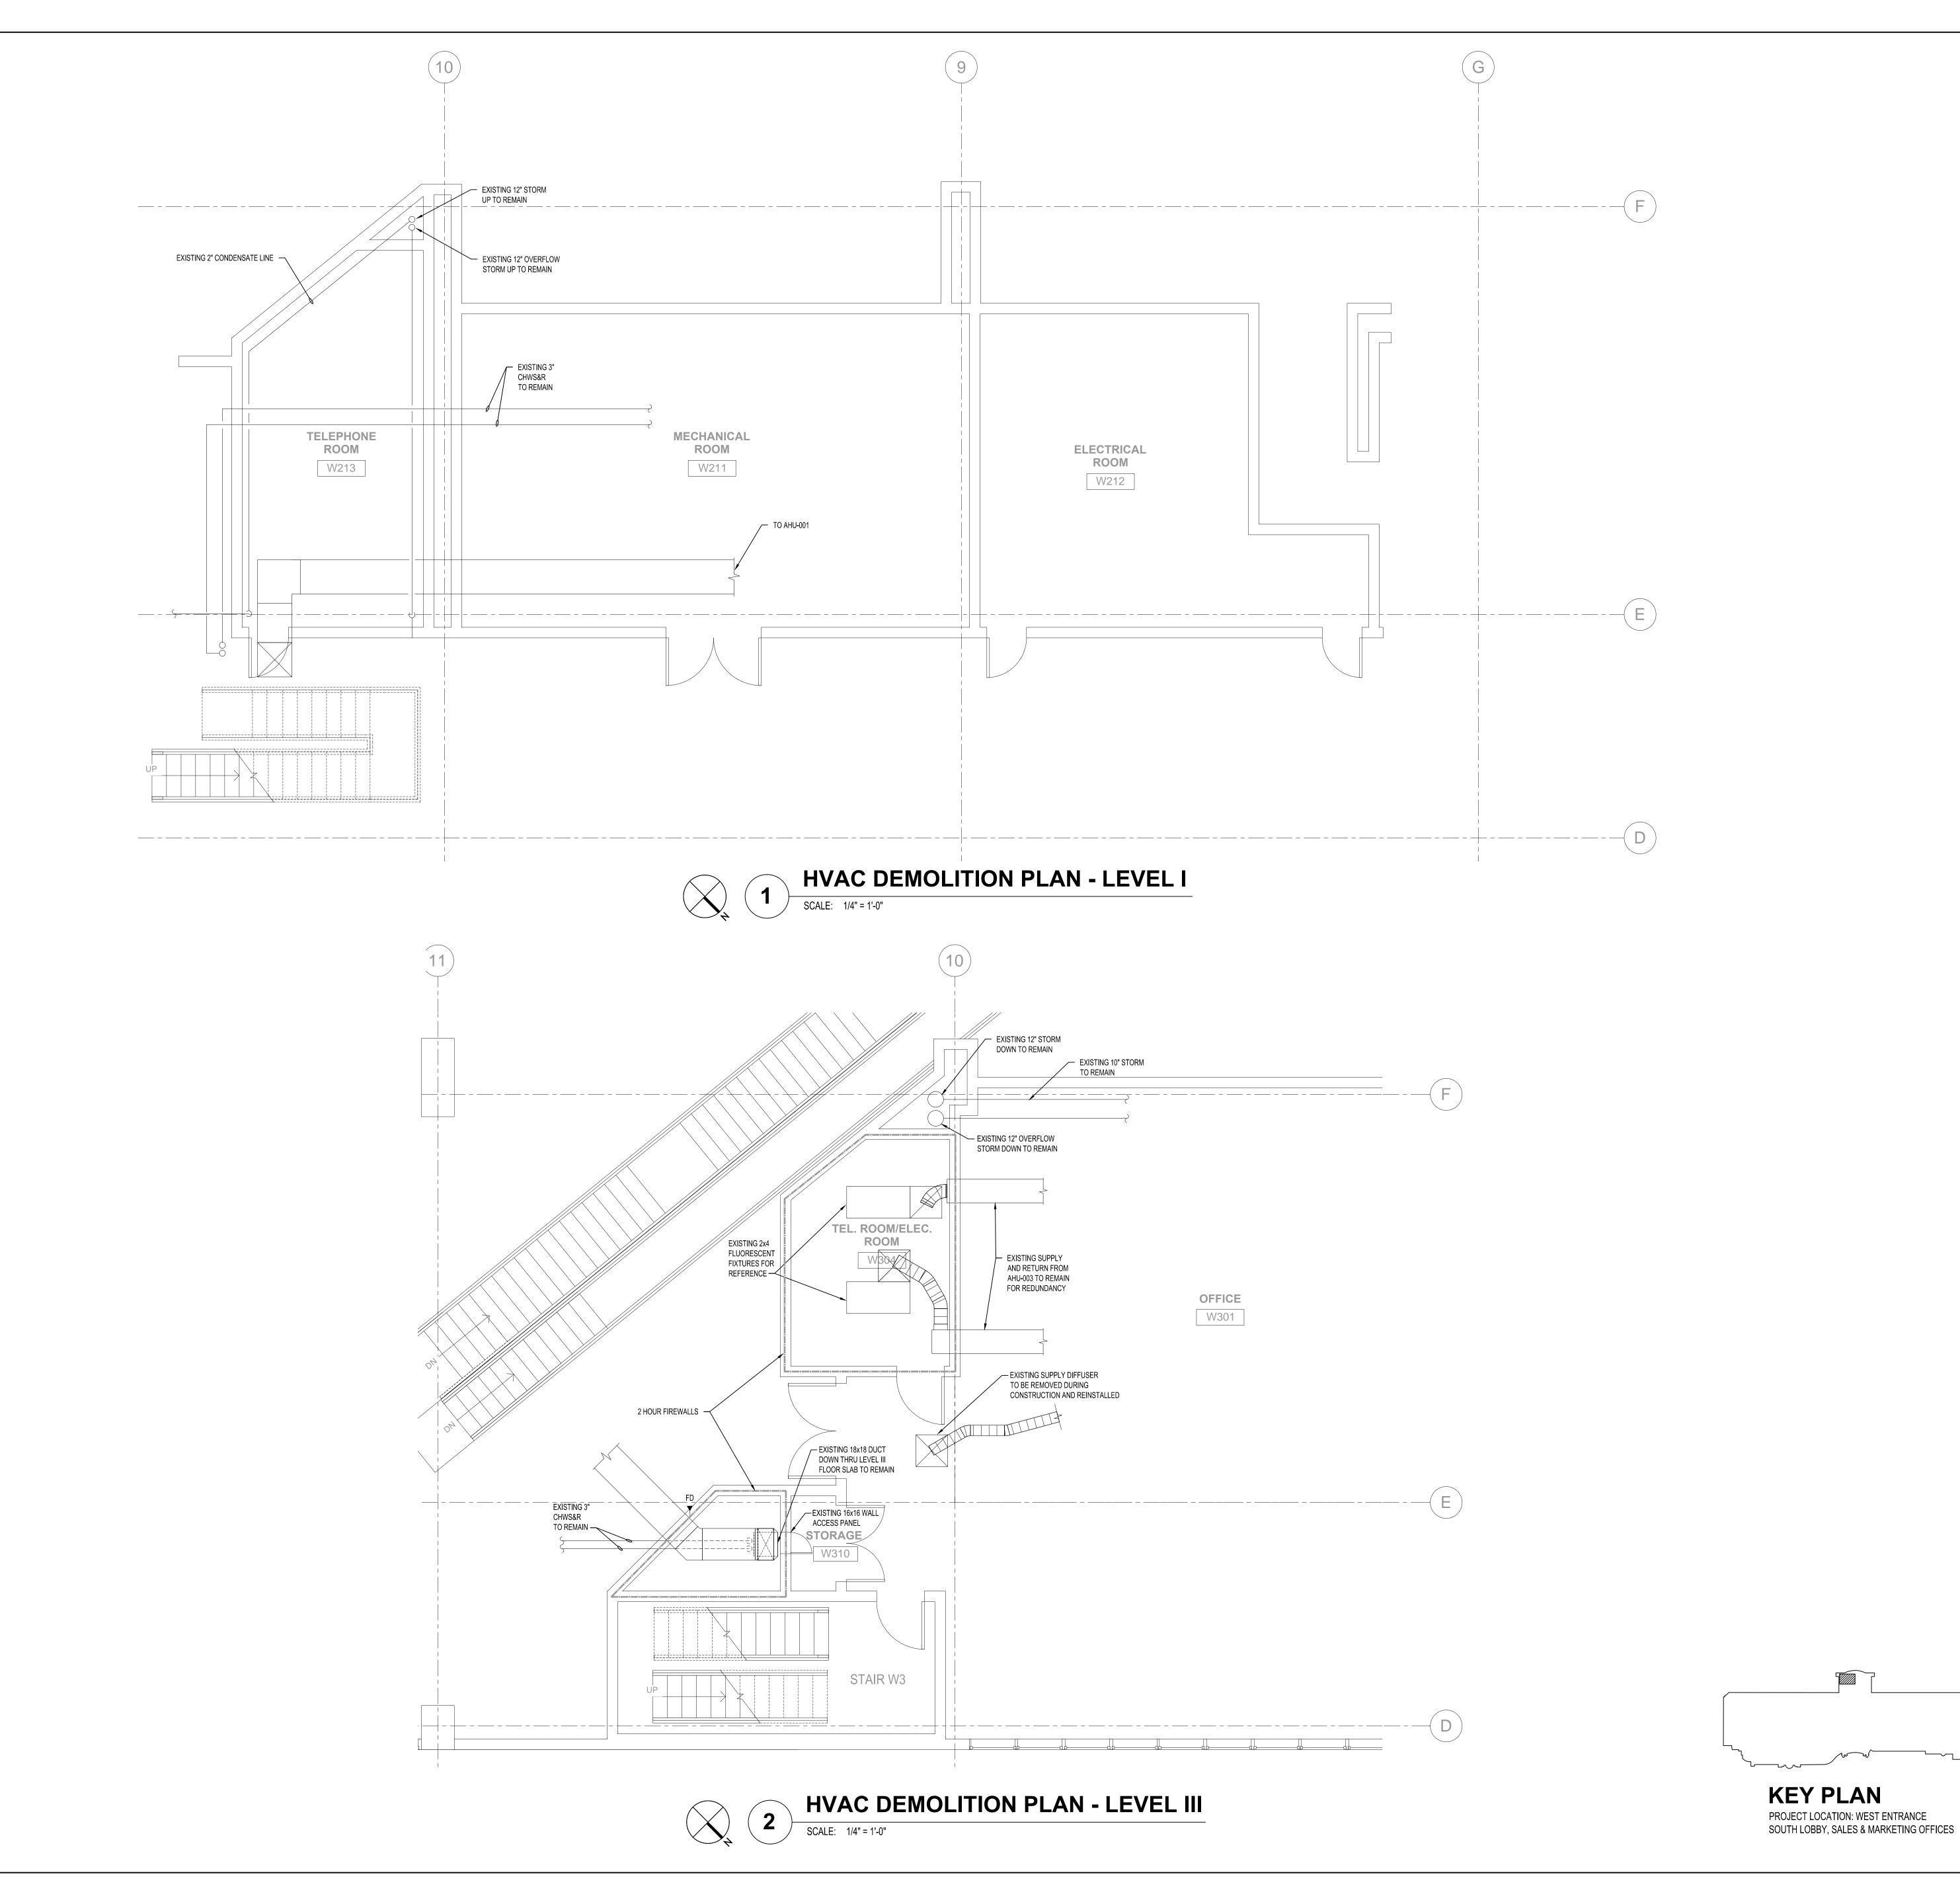
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KELLIE A. RAMOS, P.E. FLORIDA REG NO. 76996

SHEET TITLE:

**HVAC SYMBOLS LEGEND AND GENERAL NOTES** 

| SHEET INFORMAT | TON:    |              |                  |
|----------------|---------|--------------|------------------|
| JOB No. 100(   | 056524  | Date Issued: | November 21, 201 |
| Designed By:   | KAR     | Sheet Numbe  | r:               |
| Checked By:    | DLH     | R A          | 004              |
| QC Review:     | TJF     |              | -001             |
| Phase:         | 100% CD |              |                  |



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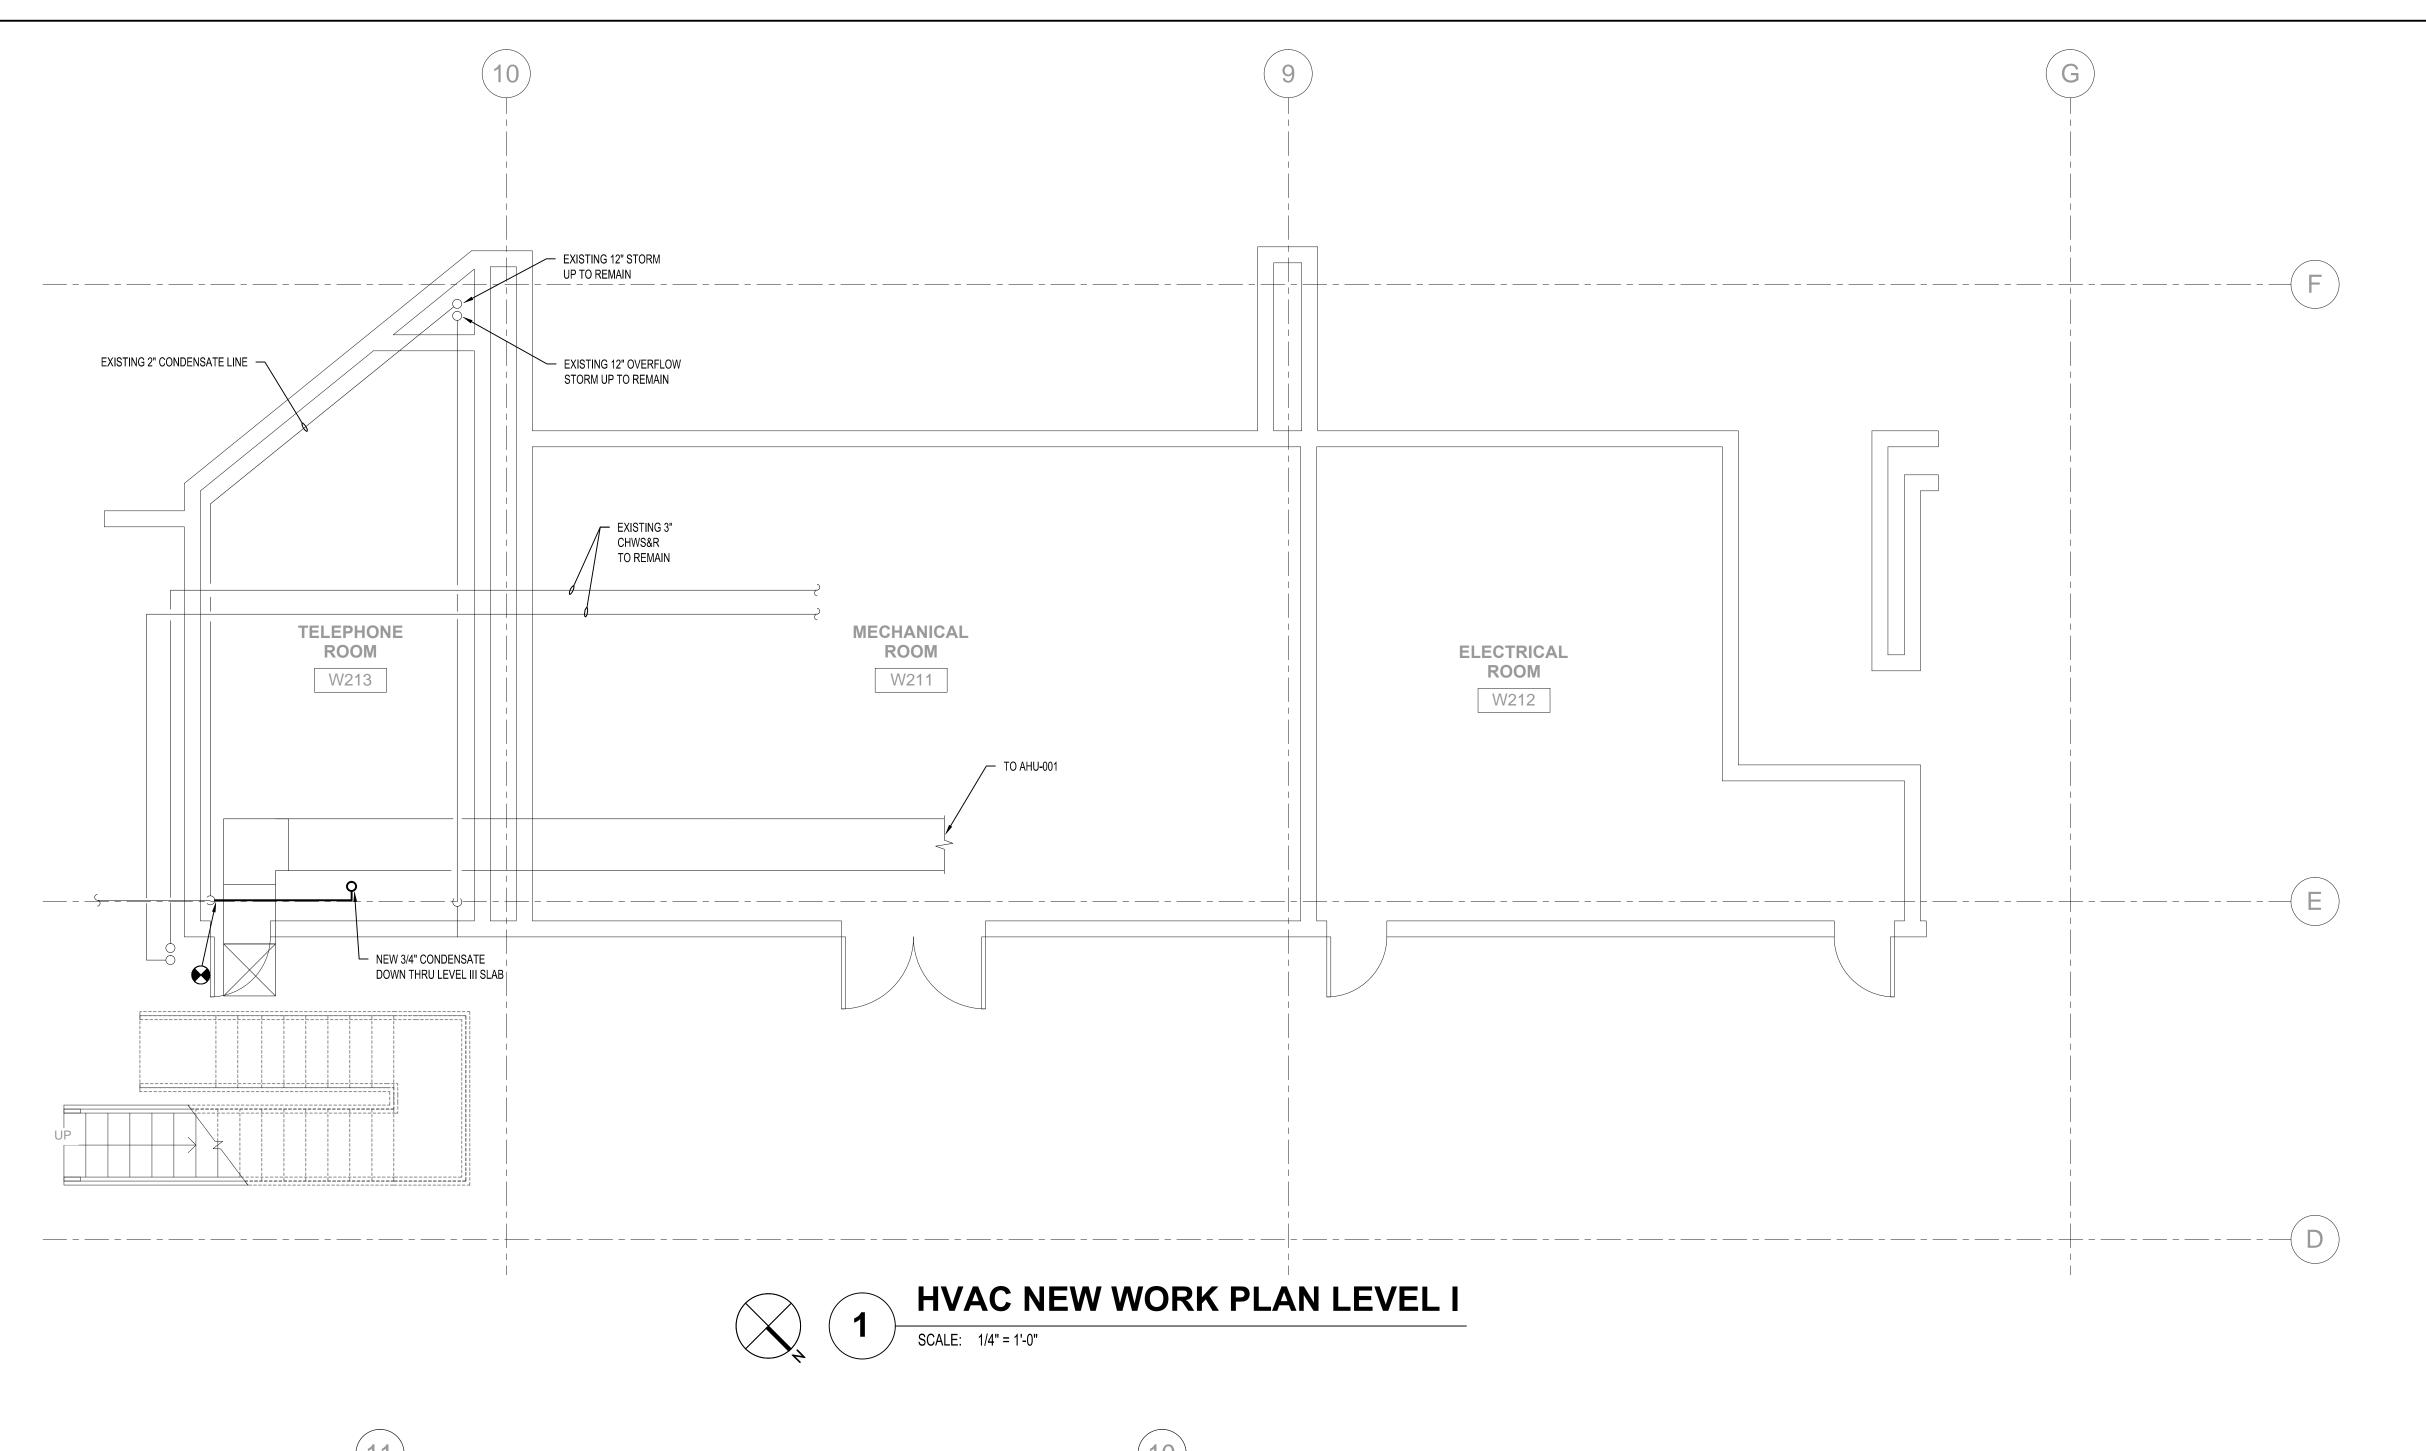
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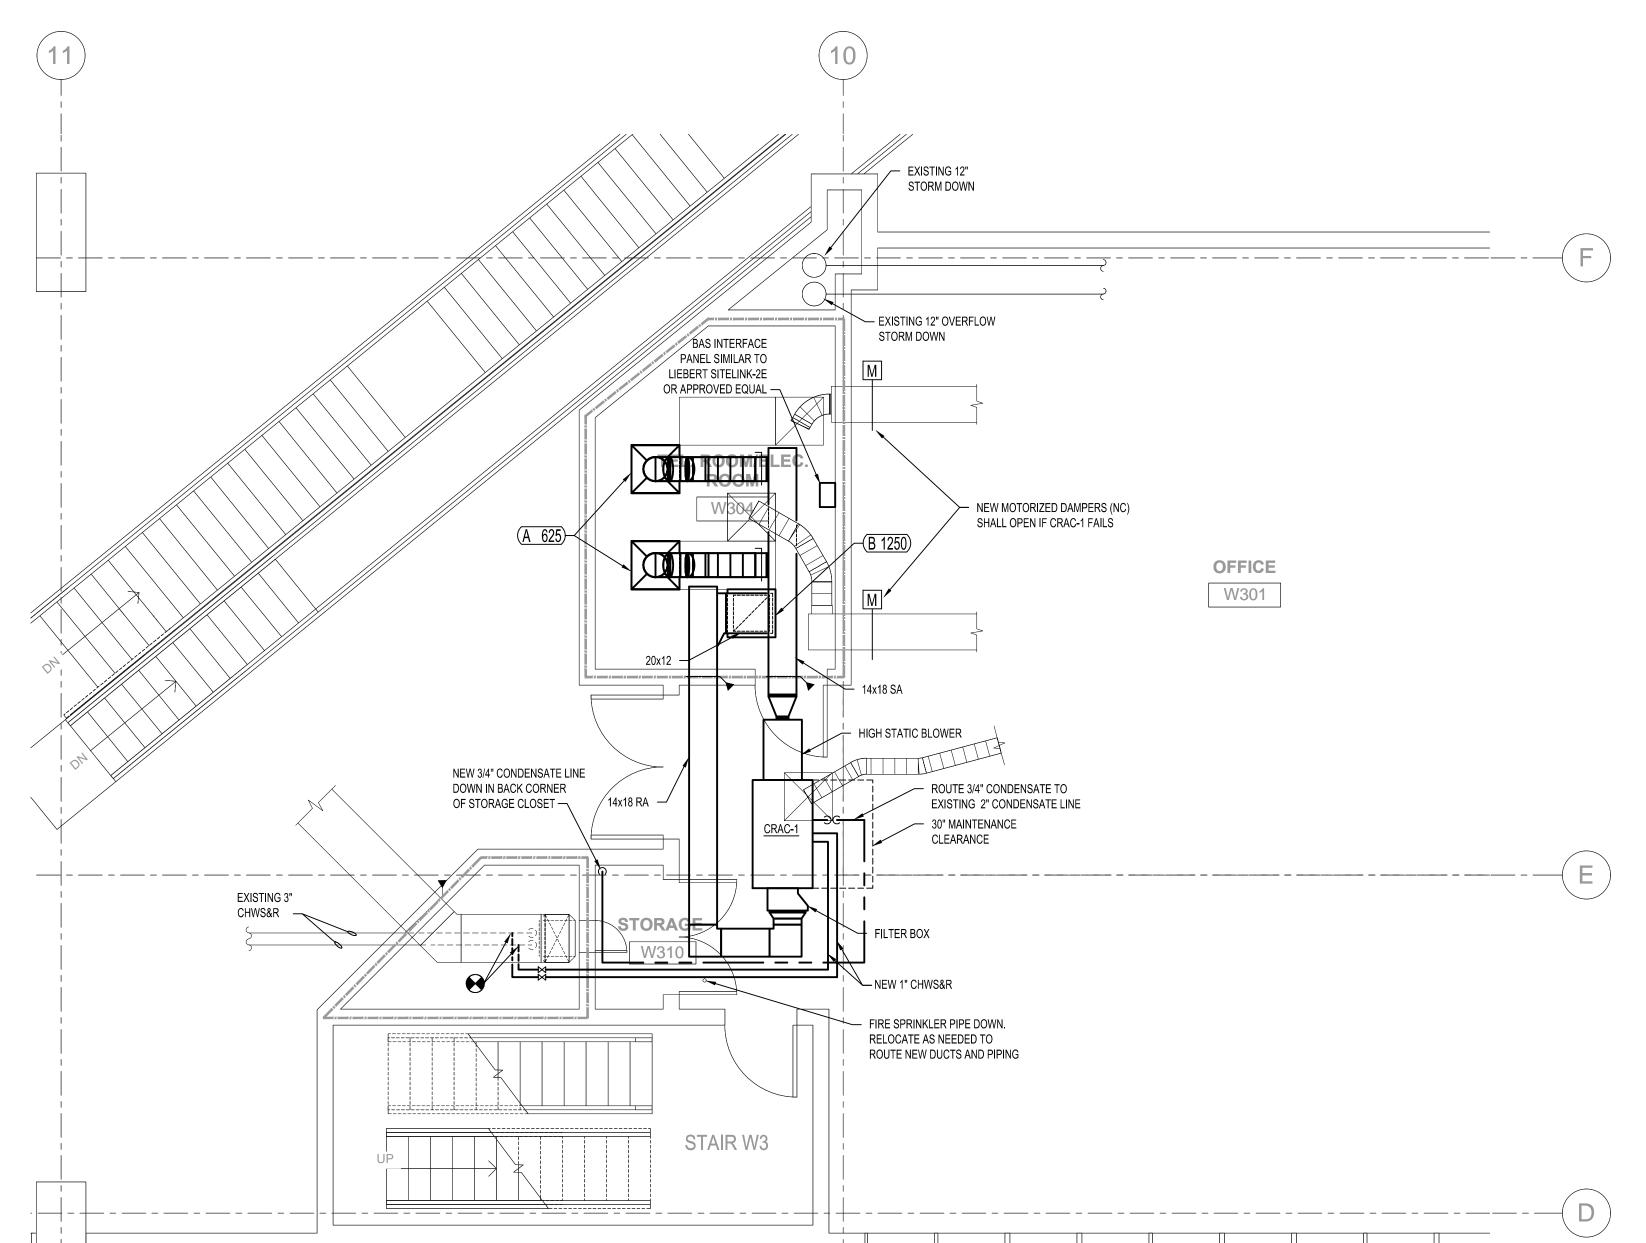
KELLIE A. RAMOS, P.E. FLORIDA REG NO. 76996


SHEET TITLE: **HVAC DEMOLITION PLAN** LEVELS I & III

SHEET INFORMATION:

JOB No. 100056524 Date Issued: November 21, 2017 M-101 TJF Phase: 100% CD





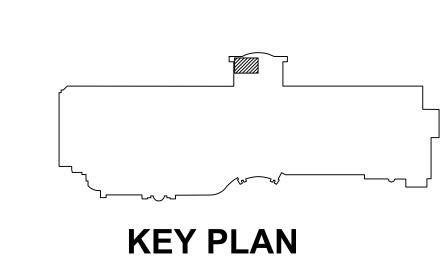

**KEY PLAN** PROJECT LOCATION: WEST ENTRANCE SOUTH LOBBY, SALES & MARKETING OFFICES

**ATKINS** 

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F L O R I D

CONSULTANT:

PROJECT NAME:

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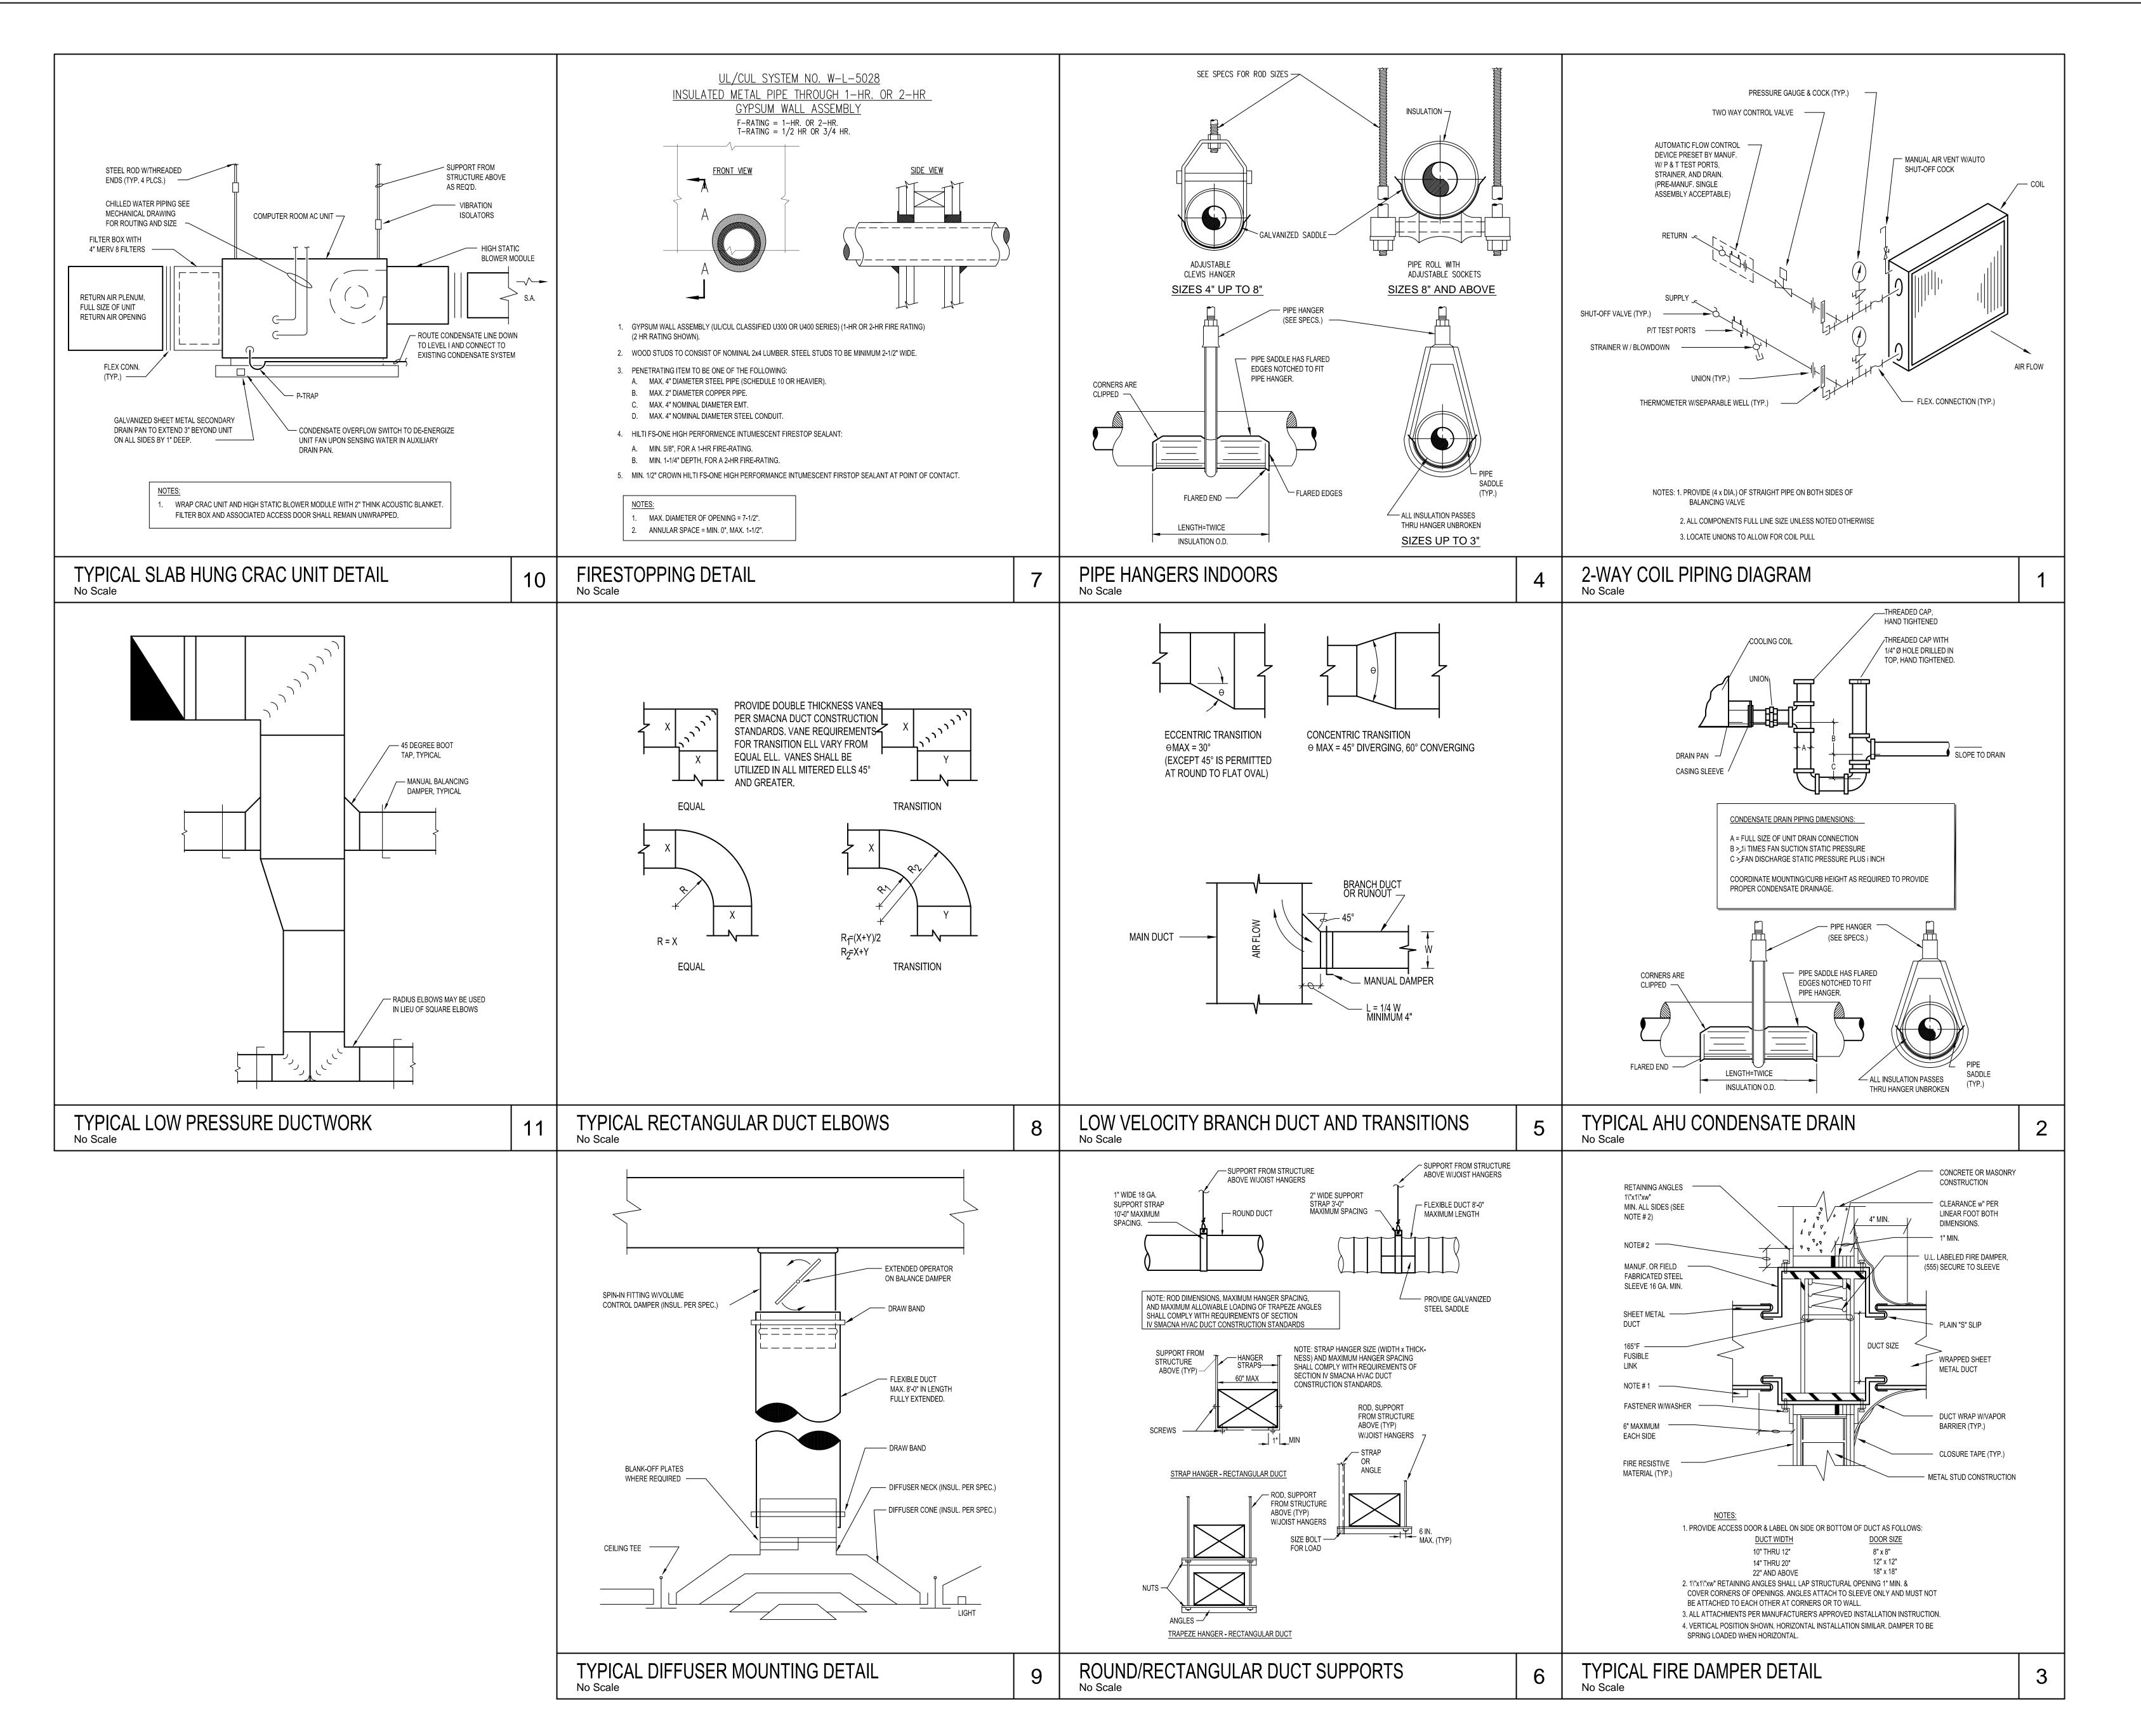
SHEET TITLE: HVAC NEW WORK PLAN LEVELS I & III

KELLIE A. RAMOS, P.E. FLORIDA REG NO. 76996

SHEET INFORMATION: JOB No. 100056524 Date Issued: November 21, 2017

KAR Sheet Number: QC Review: TJF Phase: 100% CD

**HVAC NEW WORK PLAN LEVEL III** 



**ATKINS 482 SOUTH KELLER ROAD** ORLANDO, FL 32810

PHONE: 407.647.7275 FAX: 407.740.8958 CONSULTANT:

LORIDA

PROJECT NAME:

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Description ISSUE LOG PROFESSIONAL SEALS:

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KELLIE A. RAMOS, P.E. FLORIDA REG NO. 76996

**HVAC DETAILS** 

SHEET INFORMATION: JOB No. 100056524 Date Issued: November 21, 2017

SHEET TITLE:

TJF

Checked By: **M-301** QC Review: Phase: 100% CD

|                                  | COMPUTER ROOM UNIT SCHEDULE |             |                        |----------------------------------|-----------------------------|-------------|------------------------|-------------------------|--------------|--------------|---------------|---------------|-----|--------------|------|---------------|-----------------|-------|-----------------|-----|------------|-----------------|------|------|-----|--------|--------------------|
| MARK                             | MODEL<br>NO.                | TYPE        | TOT. COOL<br>CAP (MBH) | SENS. COOL<br>CAP (MBH) | LAT<br>DB(F) | LAT<br>WB(F) | CHW<br>EWT(F) | CHW<br>LWT(F) | GPM | PD<br>FT H20 | ROWS | FINS/<br>INCH | FACE VEL<br>FPM | CFM   | ESP<br>IN. W.G. |     | FAN<br>QTY | VOLTS/<br>PH/HZ | FLA  | WSA  | OPD | WEIGHT | ELECTRIC<br>REHEAT |
| RAC-1                            | MMD40C                      | CHW, DUCTED | 33.9                   | 27.0                    | 54.8         | 52.9         | 44            | 54            | 7.0 | 12.0         | 3    | 14            | 409             | 1,250 | 0.9             | 1.5 | 1          | 460/3/60        | 10.5 | 13.1 | 15  | 315    | 1-STAGE, 7.3 kW    |
| NOTES: UNIT SOUND TECHNICAL DATA |                             |             
MARK

CABINET | 82 | 79 | 75 | 77 | 75 | 74

RETURN DUCT | 69 | 60 | 56 | 56 | 51 | 45 |

CRAC-1 | SUPPLY DUCT | 71 | 67 | 62 | 56 | 53 | 52 |

1. MANUFACTURER: LIEBERT, MINI-MATE 2.

2. PROVIDE UNIT WITH FILTER BOX KIT AND HIGH STATIC BLOWER.

3. COOLING CAPACITY BASED ON ENTERING AIR TEMPERATURE OF 75F AND 50% RH.

4. PROVIDE MERV 8 FILTERS, FACTORY MOUNTED DISCONNECT SWITCH, FACTORY-INSTALLED PRIMARY FLOAT SWITCH, SECONDARY DRAIN PAN WITH SECONDARY FLOAT SWITCH, SUPERVISED SMOKE DETECTOR AND WALL MOUNTED THERMOSTAT.

BASIS OF DESIGN: CONTROLLER: LIEBERT ICOM CMS, INTERFACE PANEL: LIEBERT SITELINK-2E WITH TM115 TRANSFORMER, INTERFACE SOLUTION: SSW-LON-ADPT. CONTRACTOR SHALL COORDINATE THE INTERFACE WITH THE EXISTING BAS SYSTEM FOR MONITORING AND CONTROLLING LIEBERT UNIT POINTS.

6. SMOKE DETECTOR SHALL INTERFACE WITH BUILDING FIRE ALARM SYSTEM (SIMPLEX). CRAC UNIT SHALL SHUTDOWN UPON SIGNAL FROM FIRE ALARM AND UNIT SHALL SEND SIGNAL TO FIRE ALARM THAT SMOKE IS SENSED IN UNIT.

7. WRAP CRAC UNIT AND HIGH STATIC BLOWER BOX WITH A 2" THICK ACOUSTIC BLANKET SIMILAR TO OWENS CORNING SELECT SOUND BLACK. ACOUSTIC BLANKET SHALL

HAVE A MINIMUM NOISE REDUCTION COEFFICIENT OF 85%. FILTER BOX SHALL REMAIN UNWRAPPED FOR ACCESS TO FILTER SECTION.

5. PROVIDE UNIT CONTROLLER AND INTERFACE PANEL WITH TRANSFORMER COMPATIBLE WITH EXISTING HONEYWELL BAS SYSTEM (LONWORKS).

|      |      | AIR I   | DISTI  | RIBUTIO  | ON SCHEDULE  |
|------|------|---|--|--|--|
|      | MARK | CFM   | NECK<br>SIZE   | FACE SIZE<br>LENGTH  | DESCRIPTION  |
| 3 kW | A    | 000-110<br>111-240<br>241-420<br>421-620<br>621-750<br>751-980                          | 6Ø<br>8Ø<br>10Ø<br>12Ø<br>14Ø<br>16Ø                             | 24x24<br>24x24<br>24x24<br>24x24<br>24x24<br>24x24                   | SUPPLY DIFFUSER BASIS OF DESIGN: TITUS TD COLOR: WHITE MATERIAL: ALUMINUM OPPOSED BLADE DAMPERS BACK PAN SIZE: 18x18                       |
|      | В    | 000-110<br>111-220<br>221-350<br>351-530<br>531-730<br>731-970<br>971-1240<br>1241-1540 | 6x6<br>8x8<br>10x10<br>12x12<br>14x14<br>16x16<br>18x18<br>20x20 | 24x24<br>24x24<br>24x24<br>24x24<br>24x24<br>24x24<br>24x24<br>24x24 | RETURN / EXHAUST GRILLE<br>BASIS OF DESIGN: TITUS 50<br>COLOR: WHITE<br>MATERIAL: ALUMINUM<br>OPPOSED BLADE DAMPERS<br>1/2"x1/2"x1/2" GRID |

NOTES:

AIR DISTRIBUTION DEVICES LOCATED WITHIN ACOUSTICAL TILE CEILINGS SHALL BE PROVIDED WITH BORDER TYPE 3 FOR LAY-IN MOUNTING. AIR DISTRIBUTION DEVICES LOCATED WITHIN GYPSUM BOARD CEILINGS OR WALLS SHALL BE PROVIDED WITH BORDER TYPE 1 FOR SURFACE MOUNTING. REFER TO ARCHITECTURAL DOCUMENTS FOR CEILING TYPES.

1541-1880 22x22 24x24


24x24 BASIS OF DESIGN: TITUS 50F

24x24 OPPOSED BLADE DAMPERS: NO

BASIS OF DESIGN: TITUS TDCA-AA

OPPOSED BLADE DAMPERS: NO


. AIR DISTRIBUTION DEVICES LOCATED IN SMALL ROOMS WHERE FULL 24"x24" GRID ARE NOT AVAILABLE SHALL BE PROVIDED WITH SURFACE MOUNTING BORDERS IN LIEU OF LAY-IN. SECURE EACH DEVICE TO CEILING GRID WITH FIELD-FABRICATED SUPPORTS.

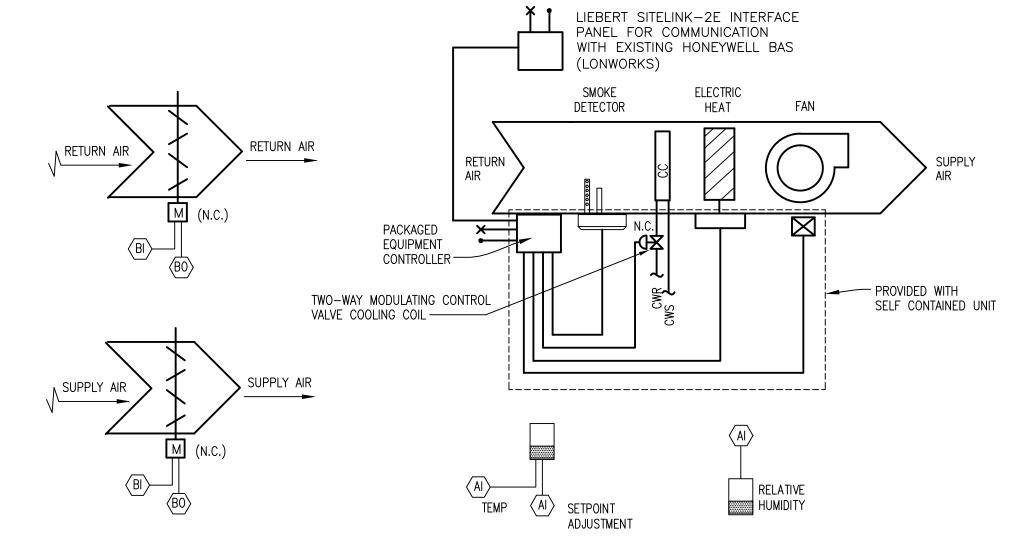

SEQUENCE OF OPERATION

- 1) GENERAL: UNIT PROVIDES HEATING, COOLING & HUMIDITY CONTROL FOR THE IDF ROOM AS SHOWN ON THE DRAWINGS. UNDER NORMAL OPERATING CONDITIONS, THE UNIT SHALL BE CONTROLLED LOCALLY BY THE PACKAGED UNIT MOUNTED CONTROLLERS AND THE BAS SHALL MONITOR ONLY. HOWEVER, EXISTING HONEYWELL BAS SHALL BE CAPABLE OF CONTROLLING UNITS AS DESCRIBED
- 2) OPERATION: BAS SHALL ENABLE THE PACKAGED CONTROLLER WHICH SHALL THEN START & RUN THE UNIT CONTINUOUSLY. CONTROL OF THE UNIT SHALL BE THROUGH THE PACKAGED UNIT MOUNTED CONTROLLER (SEE SPECIFICATIONS).
- 3) TEMPERATURE CONTROL: UNIT MOUNTED CONTROLLER SHALL MODULATE ELECTRIC HEATING COIL & COOLING COIL CONTROL VALVE TO MAINTAIN RETURN AIR HEATING & COOLING SETPOINTS (ADJ).
- 4) HUMIDITY CONTROL: UNIT MOUNTED CONTROLLER SHALL MODULATE COOLING COIL CONTROL VALVE & ELECTRIC HEATING COIL TO MAINTAIN SPACE RELATIVE HUMIDITY BETWEEN 40% AND 60% RH (ADJ). HIGH LIMIT HUMIDITY SENSOR SHALL ENABLE DEHUMIDIFICATION MODE WHEN DISCHARGE AIR HUMIDITY EXCEEDS 65% (ADJ).
- 5) DEHUMIDIFICATION MODE: THE UNIT CONTROLLER SHALL MODULATE COOLING COIL CONTROL VALVE TO FULL OPEN TO DEHUMIDIFY AND SHALL MODULATE THE HEATING COIL TO MAINTAIN A SUPPLY AIR TEMPERATURE OF 55 F (ADJ).
- 6) BACK-UP COOLING: IF THE UNIT FAILS TO OPERATE OR IF SETPOINTS ARE NOT MAINTAINED, THE BAS SHALL SIGNAL THE SUPPLY AND RETURN MOTORIZED DAMPERS TO OPEN AND SHALL ALARM THE OPERATOR.
- 7) BAS SHALL BE ABLE TO ADJUST SPACE TEMPERATURE & RELATIVE HUMIDITY SETPOINTS THROUGH UNIT MOUNTED CONTROLLER.
- A) BAS SHALL ALARM OPERATOR IF HEATING, COOLING OR RELATIVE HUMIDITY SETPOINTS ARE NOT MAINTAINED.
- B) BAS SHALL MONITOR GENERAL ALARMS OF PACKAGED UNIT CONTROLLER. C) BAS SHALL MONITOR FLOAT SWITCH & SHALL ALARM OPERATOR UPON HIGH WATER LEVEL.

D) BAS SHALL MONITOR SMOKE DETECTOR, ACTIVATION OF THE SMOKE DETECTOR OR ACTIVATION OF THE BUILDING FIRE ALARM SYSTEM SHALL AUTOMATICALLY SHUTDOWN THE CRAC UNIT & SHALL ALARM OPERATOR UPON SMOKE DETECTION.

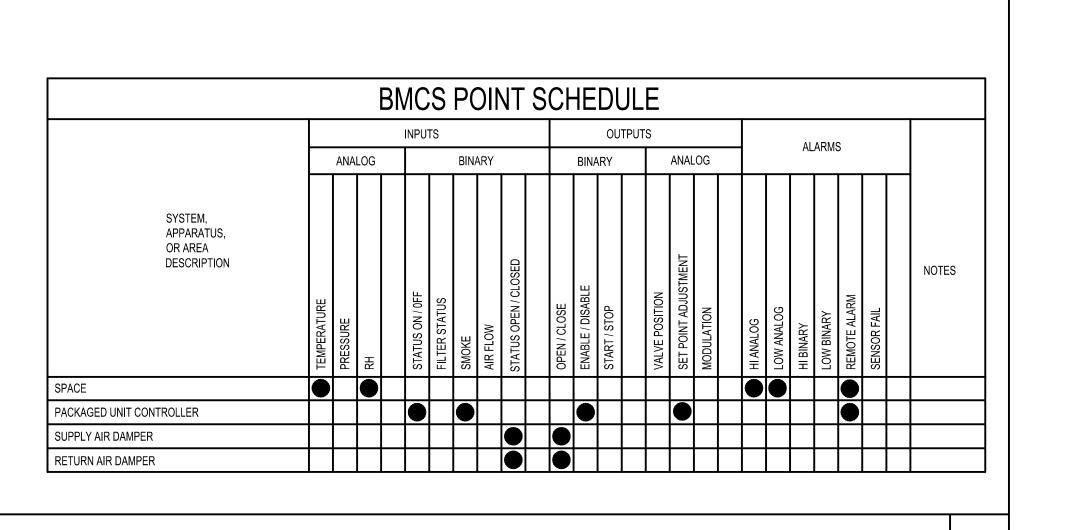

CRAC-1 CONTROL DIAGRAM (SINGLE PATH CONSTANT VOLUME AIR HANDLING UNIT)

**ATKINS 482 SOUTH KELLER ROAD** 

ORLANDO, FL 32810 PHONE: 407.647.7275 FAX: 407.740.8958 CONSULTANT:

F L O R I D A

PROJECT NAME:

## **1**

9 DRIVE

9800

ORA

| lo      | Date         | Description |
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| ROFESS  | IONAL SEALS: |             |
|         |              |             |

KELLIE A. RAMOS, P.E. FLORIDA REG NO. 76996

**HVAC SCHEDULES** 

SHEET INFORMATION: JOB No. 100056524 Date Issued: November 21, 2017

Phase:

DUPLEX RECEPTACLE, 2P, 3W, GROUNDING TYPE, 20A, 125V, NEMA 5-20R. MOUNT 18" A.F.F. U.O.N.

DUPLEX RECEPTACLE - SAME AS ABOVE EXCEPT WITH INTEGRAL GROUND FAULT CIRCUIT INTERRUPTER.

DUPLEX CONVENIENCE RECEPTACLE - SAME AS ABOVE EXCEPT WITH 2-FLAP, SPRING-HINGED, GASKETED AND WEATHERPROOF

DOUBLE DUPLEX RECEPTACLE IN ONE OUTLET BOX, 2P, 3W, GROUNDING TYPE, 20A, 125V, NEMA 5-20R.

BOXES AND FITTINGS

CEILING OR FLOOR MOUNTED JUNCTION BOX

WALL MOUNTED JUNCTION BOX

FLEXIBLE CONNECTION TO EQUIPMENT PULLBOX, SIZED AS INDICATED OR AS REQUIRED BY N.E.C.

<u>SWITCHES</u>

20A, MANUAL MOTOR STARTER TOGGLE SWITCH WITH PILOT LIGHT AND WITHOUT OVERLOADS. 3 = NUMBER OF POLES.

 $\$_{\mathsf{M}}$  20A. MOTOR RATED SWITCH.

NON-FUSED SAFETY SWITCH, 3 = NO. OF POLES, 60 = SWITCH SIZE. 600 V. UNLESS OTHERWISE NOTED.

FUSED SAFETY SWITCH, 3 = NO. OF POLES, 60 = SWITCH SIZE, 50 = FUSES SIZE. 600 V. UNLESS OTHERWISE NOTED.

INDIVIDUALLY MOUNTED ENCLOSED CIRCUIT BREAKER, 3 = NO. OF POLES, 100 = FRAME SIZE, 70 = TRIP RATING. 600 V. UNLESS OTHERWISE NOTED.

<u>LIGHTING</u>

RECESSED, SEMI-RECESSED, SURFACE OR PENDANT MOUNTED CEILING FIXTURE WITH EMERGENCY BATTERY BACK UP OR CONNECTED TO AN EMERGENCY CIRCUIT.

\_ \_ \_ \_ \_ \_ \_ \_ \_ \_ \_

"3M1" SEC A

277/480V, 3-PH, 4W

CW 3.304 (W304)

(S) OCCUPANCY SENSOR.

POWER OR LIGHTING CIRCUIT BREAKERS PANEL RECESSED MOUNTED IN WALL, SIZE AS INDICATED. DASHED LINE INDICATES REQUIRED CLEARANCE.

POWER OR LIGHTING CIRCUIT BREAKERS PANEL SURFACE MOUNTED ON WALL, SIZE AS INDICATED. DASHED LINE INDICATES REQUIRED CLEARANCE.

MOTOR. WHEN SHOWN, NUMBER INSIDE INDICATES HORSEPOWER. MAGNETIC MOTOR STARTER

COMBINATION MAGNETIC MOTOR STARTER AND DISCONNECT

KEYED NOTES

BREAKER TYPE AND AIC RATING.

3RD FLOOR - SALES AND MARKETING OFFICE

(1) PROVIDE NEW 3P, 15A CIRCUIT BREAKER IN EXISTING SPACE. MATCH EXISTING

PROVIDE NEW 1P, 15A CIRCUIT BREAKER IN EXISTING SPACE. MATCH EXISTING BREAKER TYPE AND AIC RATING.

SINGLE CIRCUIT HOMERUN TO PANEL WITH MINIMUN OF 2 #12AWG CIRCUIT WIRES AND 1 #12AWG GROUND WIRE IN A 3/4" CONDUIT, U.O.N.: "A" INDICATES PANEL DESIGNATION, NUMBER INDICATES CIRCUIT DESIGNATION.

MULTIPLE CIRCUITS HOMERUN TO PANEL WITH MINIMUN OF 2 #12AWG WIRES PER CIRCUIT AND 1 #12AWG GROUND WIRE IN A 3/4" CONDUIT, U.O.N.: "A" INDICATES PANEL DESIGNATION, NUMBERS SEPARATED BY COMAS INDICATE INDIVIDUAL CIRCUIT DESIGNATIONS.

FIRE ALARM

SMOKE DETECTOR. "F" DENOTES MOUNTED UNDER RAISED FLOOR.

NOTE: NOT ALL SYMBOLS APPLY TO THE PROJECT.

ABBREVIATIONS

**AMPERES** ABOVE FINISHED FLOOR A.F.F.

A.H.J. **AUTHORITY HAVING JURISDICTION** 

AMPERES INTERRUPTING CAPACITY, SYMMETRICAL A.I.C. C.B. CIRCUIT BREAKER

CKT. CIRCUIT CONDUIT COND., C. DISC. DISCONNECT

**EMERGENCY** EMERG. GROUND FAULT INTERRUPTER

GND, G. GROUND

GALVANIZED RIGID STEEL CONDUIT

HEATING, AIR CONDITIONING, AND REFRIGERATION

HORSE POWER KW **KILOWATT** 

NATIONAL ELECTRICAL CODE

PANELBOARD

POLYVINYL CHLORIDE CONDUIT

SPARE CONDUIT SWITCH

PHASE B

PHASE C

TOTAL CONNECTED LOAD

11.09 KVA

11.09 KVA

33.52 KVA

UNLESS OTHERWISE NOTED

TRANSFORMER

INDICATES WEATHERPROOF EQUIPMENT

**EQUAL TO:** PANEL: 3M1 A (EXISTING) VOLTAGE: MAIN BUS: TYPE: 250A MOUNTING: SURFACE **NEUTRAL**: 100% A.I.C. **EXISTING** MAIN: M.L.O. CAT. NO. PHASE A PHASE B PHASE C POLE TR CKT CKI TR POLE PHASE A PHASE B PHASE C DESCRIPTION DESCRIPTION **KVA** KVA KVA E VAV-1.1 E VAV-1.2 1.00 1.00 E VAV-1.3 E VAV-1.4 1.00 - - 23 24 1.00 **3 15** 25 26 N CRAC-1 3.09 **3.09** - - 29 30 N CTX-1 0.25 E SPACE E SPACE E SPACE SPACE 39 40 41 42 E SPACE CONNECTED LOAD 7.34 7.09 7.09 4.00 CONNECTED LOAD PHASE A 11.34 KVA **DESIGN LOAD:** 33.52 KVA

CURRENT:

40.32 AMPS

GENERAL NOTES

1. THE WORK PRACTICES EMPLOYED ON THIS PROJECT SHALL AT ALL TIMES COMPLY WITH OR EXCEED THE LATEST ADOPTED EDITION OF THE NEC (NATIONAL ELECTRICAL CODE). CONTRACTOR SHALL PROVIDE OR OBTAIN ALL REQUIRED LABOR, MATERIAL, EQUIPMENT, INSURANCE, TOOLS, PERMITS, INSPECTIONS, ETC. TO PERFORM THE PROJECT ELECTRICAL WORK AS PER NEC, LOCAL AGENCIES, AND OWNER REQUIREMENTS.

2. A COPPER EQUIPMENT GROUNDING CONDUCTOR, SIZED AS PER TABLE 250-22 OF THE 2011 OR LATEST ADOPTED NEC. SHALL BE INSTALLED IN EVERY RACEWAY AND EFFECTIVELY TERMINATED AT EACH DEVICE. UNLESS NOTED OTHERWISE, MINIMUM WIRE SIZE FOR PHASE, NEUTRAL AND GROUND SHALL BE #12AWG AND MINIMUM CONDUIT SIZE SHALL BE 3/4".

3. CONDUCTORS #8AWG AND LARGER SHALL BE STRANDED COPPER, #10AWG AND SMALLER SHALL BE SOLID COPPER TYPE THHN/THWN-2 UNLESS NOTED OTHERWISE.

4. PROVIDE JUNCTION BOXES PER NEC REQUIREMENT ACCORDING TO THEIR LOCATION.

5. PROVIDE REQUIRED RACEWAY FOR A/C CONTROLS AS REQUIRED. FIELD COORDINATE WITH OTHER TRADES.

6. CONTRACTOR SHALL BE RESPONSIBLE FOR ANY CUTTING AND PATCHING REQUIRED TO PERFORM THE ELECTRICAL WORK. OWNER SHALL BE NOTIFIED BEFORE STARTING ANY CUTTING AND PATCHING, AND WORK SHALL BE DONE IN SUCH A MANNER THAT WILL NOT AFFECT THE BUILDING STRUCTURE. CONTRACTOR SHALL BE RESPONSIBLE FOR ANY DAMAGE AS A RESULT OF THE CUTTING AND PATCHING AND SHALL PROVIDE A CODE COMPLIANT SOLUTION TO RESTORE THE AFFECTED SYSTEMS AT NO EXTRA CHARGE.

7. COORDINATE FINAL LOCATION OF DEVICES WITH OWNER TO AVOID CONFLICTS WITH CABINETS, ETC.

8. CONTRACTOR SHALL FOLLOW OWNER, NATIONAL AND LOCAL AGENCIES, ETC. SAFETY REGULATIONS PROCEDURES. CONTRACTOR SHALL PROVIDE ADEQUATE EQUIPMENT AND WORKING AREA PROTECTION TO PREVENT INJURIES TO PEOPLE AND DAMAGE TO PROPERTY.

9. FULLY TEST ALL ELECTRICAL SYSTEMS UPON COMPLETION OF WORK.

10. IT IS THE BIDDER'S RESPONSIBILITY TO INSPECT THE PROJECT SITE AND CONSTRUCTION DOCUMENTS PRIOR TO BIDDING. FAILURE TO DO SO SHALL NOT RELIEVE THE CONTRACTOR TO COMPLY AND PERFORM HIS/HER WORK RESPONSIBILITIES UNDER THIS CONTRACT.

11. LABEL PANEL, AND JUNCTION BOXES WITH SOURCE PANEL AND CIRCUIT NUMBER.

12. ALL CIRCUIT BREAKERS SHALL BE BOLT-ON TYPE. CIRCUIT BREAKERS PROTECTING HEATING, AIR CONDITIONING AND REFRIGERATION EQUIPMENT SHALL BE HACR RATED.

13. RUN POWER DISTRIBUTION CONDUITS AND HOME RUNS TO AVOID FIRE RATED WALL PENETRATIONS. IF A FIRE WALL PENETRATION IS REQUIRED, THE CONTRACTOR SHALL USE AND PROVIDE A WALL PENETRATION PROCEDURE AND INSTALLATION APPROVED BY THE A.H.J. FOR THE FIRE RATED WALL TO BE PENETRATED.

14. COORDINATE FINAL CONDUITS LOCATION WITH DUCTWORK.

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CONSULTANT:



PROJECT NAME:

00045

No. Date Description

ISSUE LOG PROFESSIONAL SEALS:

ANGEL E. LORENZO, P.E. FLORIDA REG NO. 31137 SHEET TITLE:

**ELECTRICAL LEGEND SCHEDULES & ONE-LINE** 

SHEET INFORMATION: JOB No. 100056524 Date Issued: November 21, 2017

E-001

Phase: 100% CD

E-100 ELECTRICAL DEMO WORK PLAN LEVEL III



482 SOUTH KELLER ROAD ORLANDO, FL 32810 PHONE: 407.647.7275 FAX: 407.740.8958

CONSULTANT:

KEYED NOTES:

EXISTING RECESSED CAN REFLECTOR LIGHT TO BE REMOVED DURING CONSTRUCTION AND REINSTALLED.

2 EXISTING SMOKE DETECTOR TO BE REMOVED DURING CONSTRUCTION AND REINSTALLED.

EXISTING OCCUPANCY SENSOR TO BE REMOVED DURING CONSTRUCTION AND REINSTALLED.

REFER TO MECHANICAL SHEET M-001 GENERAL NOTES FOR CEILING GRID DEMOLITION REQUIREMENTS AND SCOPE FOR NEW MECHANICAL UNIT INSTALLATION.



PROJECT NAME:

GOVERNMENT F L O R I D A

ANGEL E. LORENZO, P.E. FLORIDA REG NO. 31137

SHEET TITLE:

PROFESSIONAL SEALS:

**ELECTRICAL DEMO WORK PLAN LEVEL III** 

SHEET INFORMATION: JOB No. 100056524 Date Issued: November 21, 2017 E-100

Phase: 100% CD

ELECTRICAL NEW WORK PLAN LEVEL III

KEYED NOTES:

- PROVIDE NEW 3P, 15A CIRCUIT BREAKER IN EXISTING 480/277V, 3PHASE PANEL 3M1-A SPACE 25,27,29. MATCH EXISTING BREAKER TYPE AND 65KAIC RATING.
- 2 PROVIDE 3 #12 + 1 #12 GND IN 3 /4" C.
- CONTRACTOR TO COORDINATE POWER WIRING
  TERMINATIONS FOR UNIT-MOUNTED DISCONNECT
  PROVIDED BY THE HVAC UNIT MANUFACTURER. REFER TO
  HVAC SCHEDULE, SHEET M-501.
- PROVIDE 250 VA, 208/277-120 VOLT, INDUSTRIAL CONTROL TRANSFORMER MODEL #C0250E3A AS MANUFACTURED BY EATON OR APPROVED EQUAL FOR BUILDING AUTOMATION SYSTEMS (BAS) INTERFACE PANEL.
- **5** PROVIDE 2 #12 + 1 #12 GND IN 3 /4" C.

**ATKINS** 

482 SOUTH KELLER ROAD ORLANDO, FL 32810 PHONE: 407.647.7275 FAX: 407.740.8958

CONSULTANT:



PROJECT NAME:

| No.     | Date          | Description |  |
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ANGEL E. LORENZO, P.E. FLORIDA REG NO. 31137

**ELECTRICAL NEW WORK PLAN LEVEL III** 

SHEET INFORMATION: JOB No. 100056524 Date Issued: November 21, 2017

SHEET TITLE:

E-101 Phase: 100% CD