

ORANGE COUNTY GOVERNMENT DIVISION OF BUILDING SAFETY RENOVATION PHASE 1

201 SOUTH ROSALIND AVENUE, ORLANDO, FL 32801

BID DOCUMENTS

September 22, 2017

ORANGE COUNTY GOVERNMENT CAPITAL PROJECTS DIVISION

400 East South Street, Suite 500 Orlando, FL 32801

BOARD OF COUNTY COMMISSIONERS

MAYOR - TERESA JACOBS

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DISTRICT 2 COMMISSIONER - BRYAN NELSON

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DISTRICT 4 COMMISSIONER - JENNIFER THOMPSON


DISTRICT 5 COMMISSIONER - EMILY BONILLA

DISTRICT 6 COMISSIONER - VICTORIA P. SIPLIN



The proposed project scope includes the offices renovation of the first floor for the Orange County Division of Building Safety Offices at the Orange County Administration Building. The renovation will be divided into two projects, Phase 1(these drawings) and Phase 2(near future project). The Phase 1 project includes the demolition of the existing Kitchen and Dining area renovated into Offices, Conference Room and Multi-Purpose Room. The mechanical, plumbing, electrical and technology will be updated according to room modification and required to accommodate the new work and new ceiling. No other exterior work shall be required for this project.

VICINITY MAP

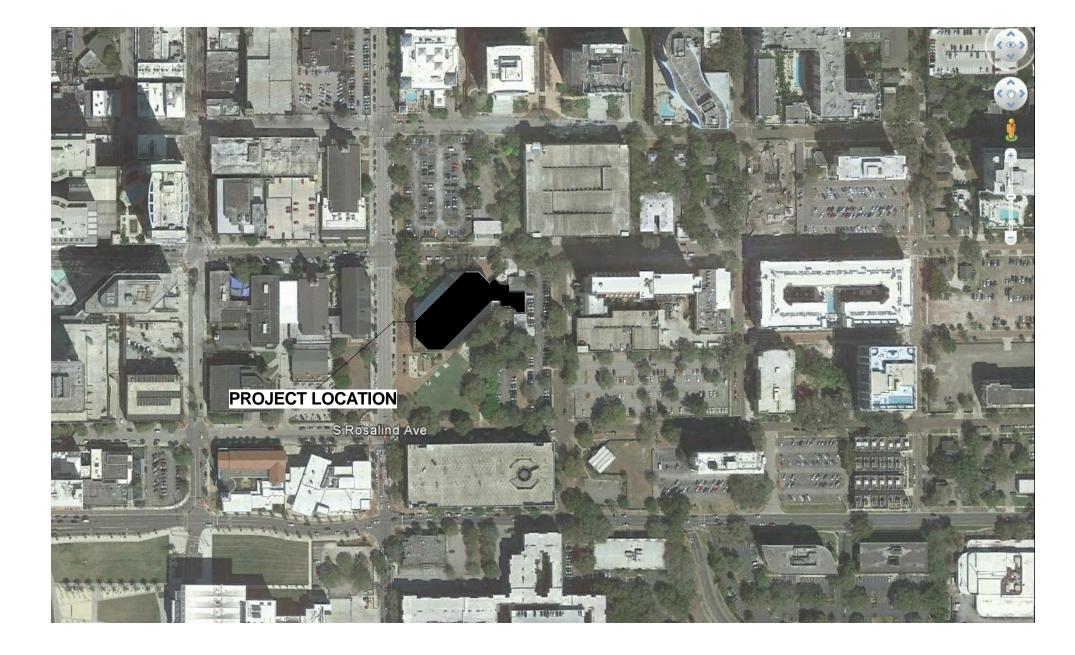




PROJECT DESIGN TEAM

DATE | SUBMISSION / REVISION | NO.

FIRE

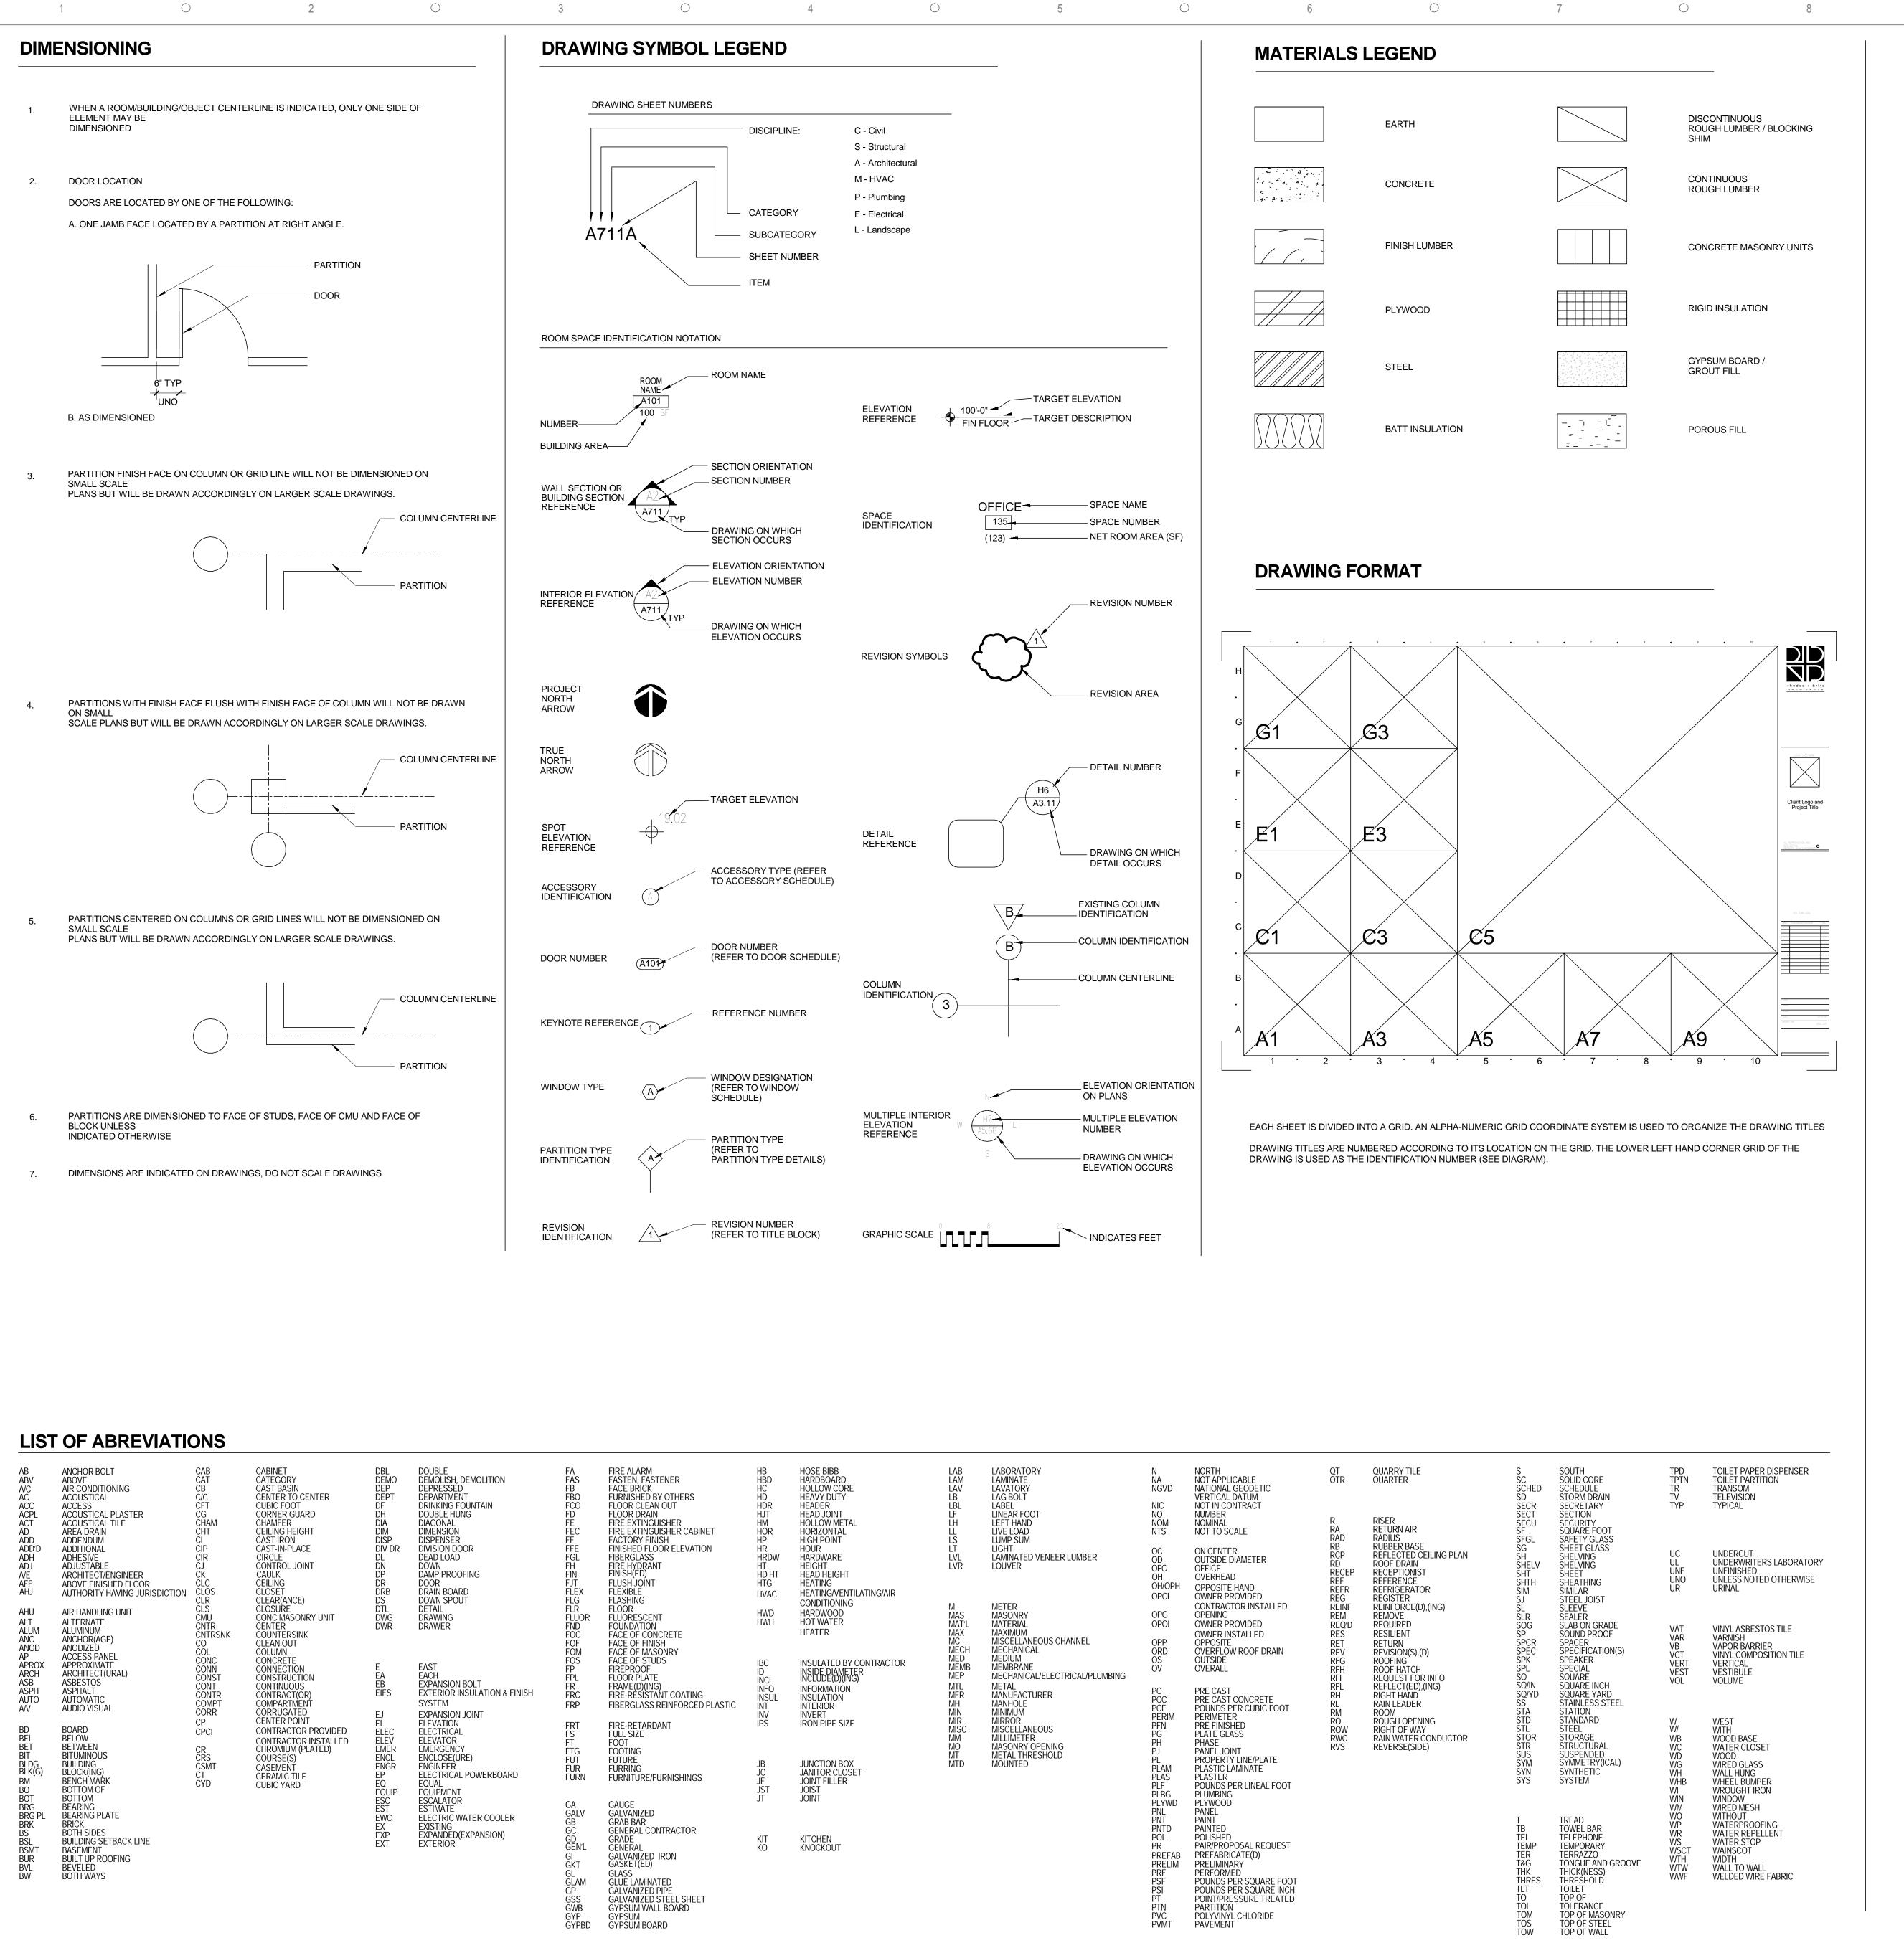

PARTITION POLYVINYL CHLORIDE

PAVEMENT

DRAWING INDEX

GENERAL

REV. NO.	SHEET NAME
G000	COVER SHEET
G001	GENERAL INFORMATION
G011	OVERAL EXISTING FLOOR PLAN FIRST LEVEL
G015	PHASING PLAN
G040	PARTITION TYPES
G101	LIFE SAFETY PLAN FIRST LEVEL
Total Sheets: 6	

ARCHITECTURAL

AD101	DEMOLITION PLAN
AD102	DEMOLITION IMAGES - FLOOR PLAN
AD103	DEMOLITION IMAGES - REFLECTED CEILING PLAN
A101	FLOOR PLAN AND REFLECTED CEILING PLAN
A500	WALL AND CEILING DETAILS
A510	ENLARGED FLOOR PLAN AND ELEVATIONS
A600	FINISH FLOOR PLAN AND EQUIPMENT PLAN
A601	FINISH SCHEDULE AND CASEWORK DETAILS
A710	DOOR AND GLASS WALL SYSTEM - SCHEDULE AND DETAILS

FIRE PROTECTION

FIRST FLOOR SPRINKLER Grand total: 1

PLUMBING

Total Sheets: 9

FIRST FLOOR PLUMBING Total Sheets: 1

MECHANICAL

M100	LEGEND, ABBREVIATIONS AND GENERAL NOTES
M101	PHASE ONE HVAC NEW WORK PLAN
M501	DETAIL SHEET
M601	SCHEDULES
MD101	PHASE ONE HVAC DEMO PLAN
Total Sheets: 5	

ELECTRICAL

LEGEND, ABBREVIATIONS, AND GENERAL NOTES
PHASE ONE POWER NEW WORK PLAN
PHASE ONE POWER DEMO PLAN
PHASE ONE LIGHTING DEMO PLAN
PHASE ONE LIGHTING NEW WORK PLAN
PHASE ONE FIRE ALARM NEW WORK PLAN



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ORANGE COUNTY GOVERNMENT

DIVISION OF BUILDING SAFETY RENOVATION

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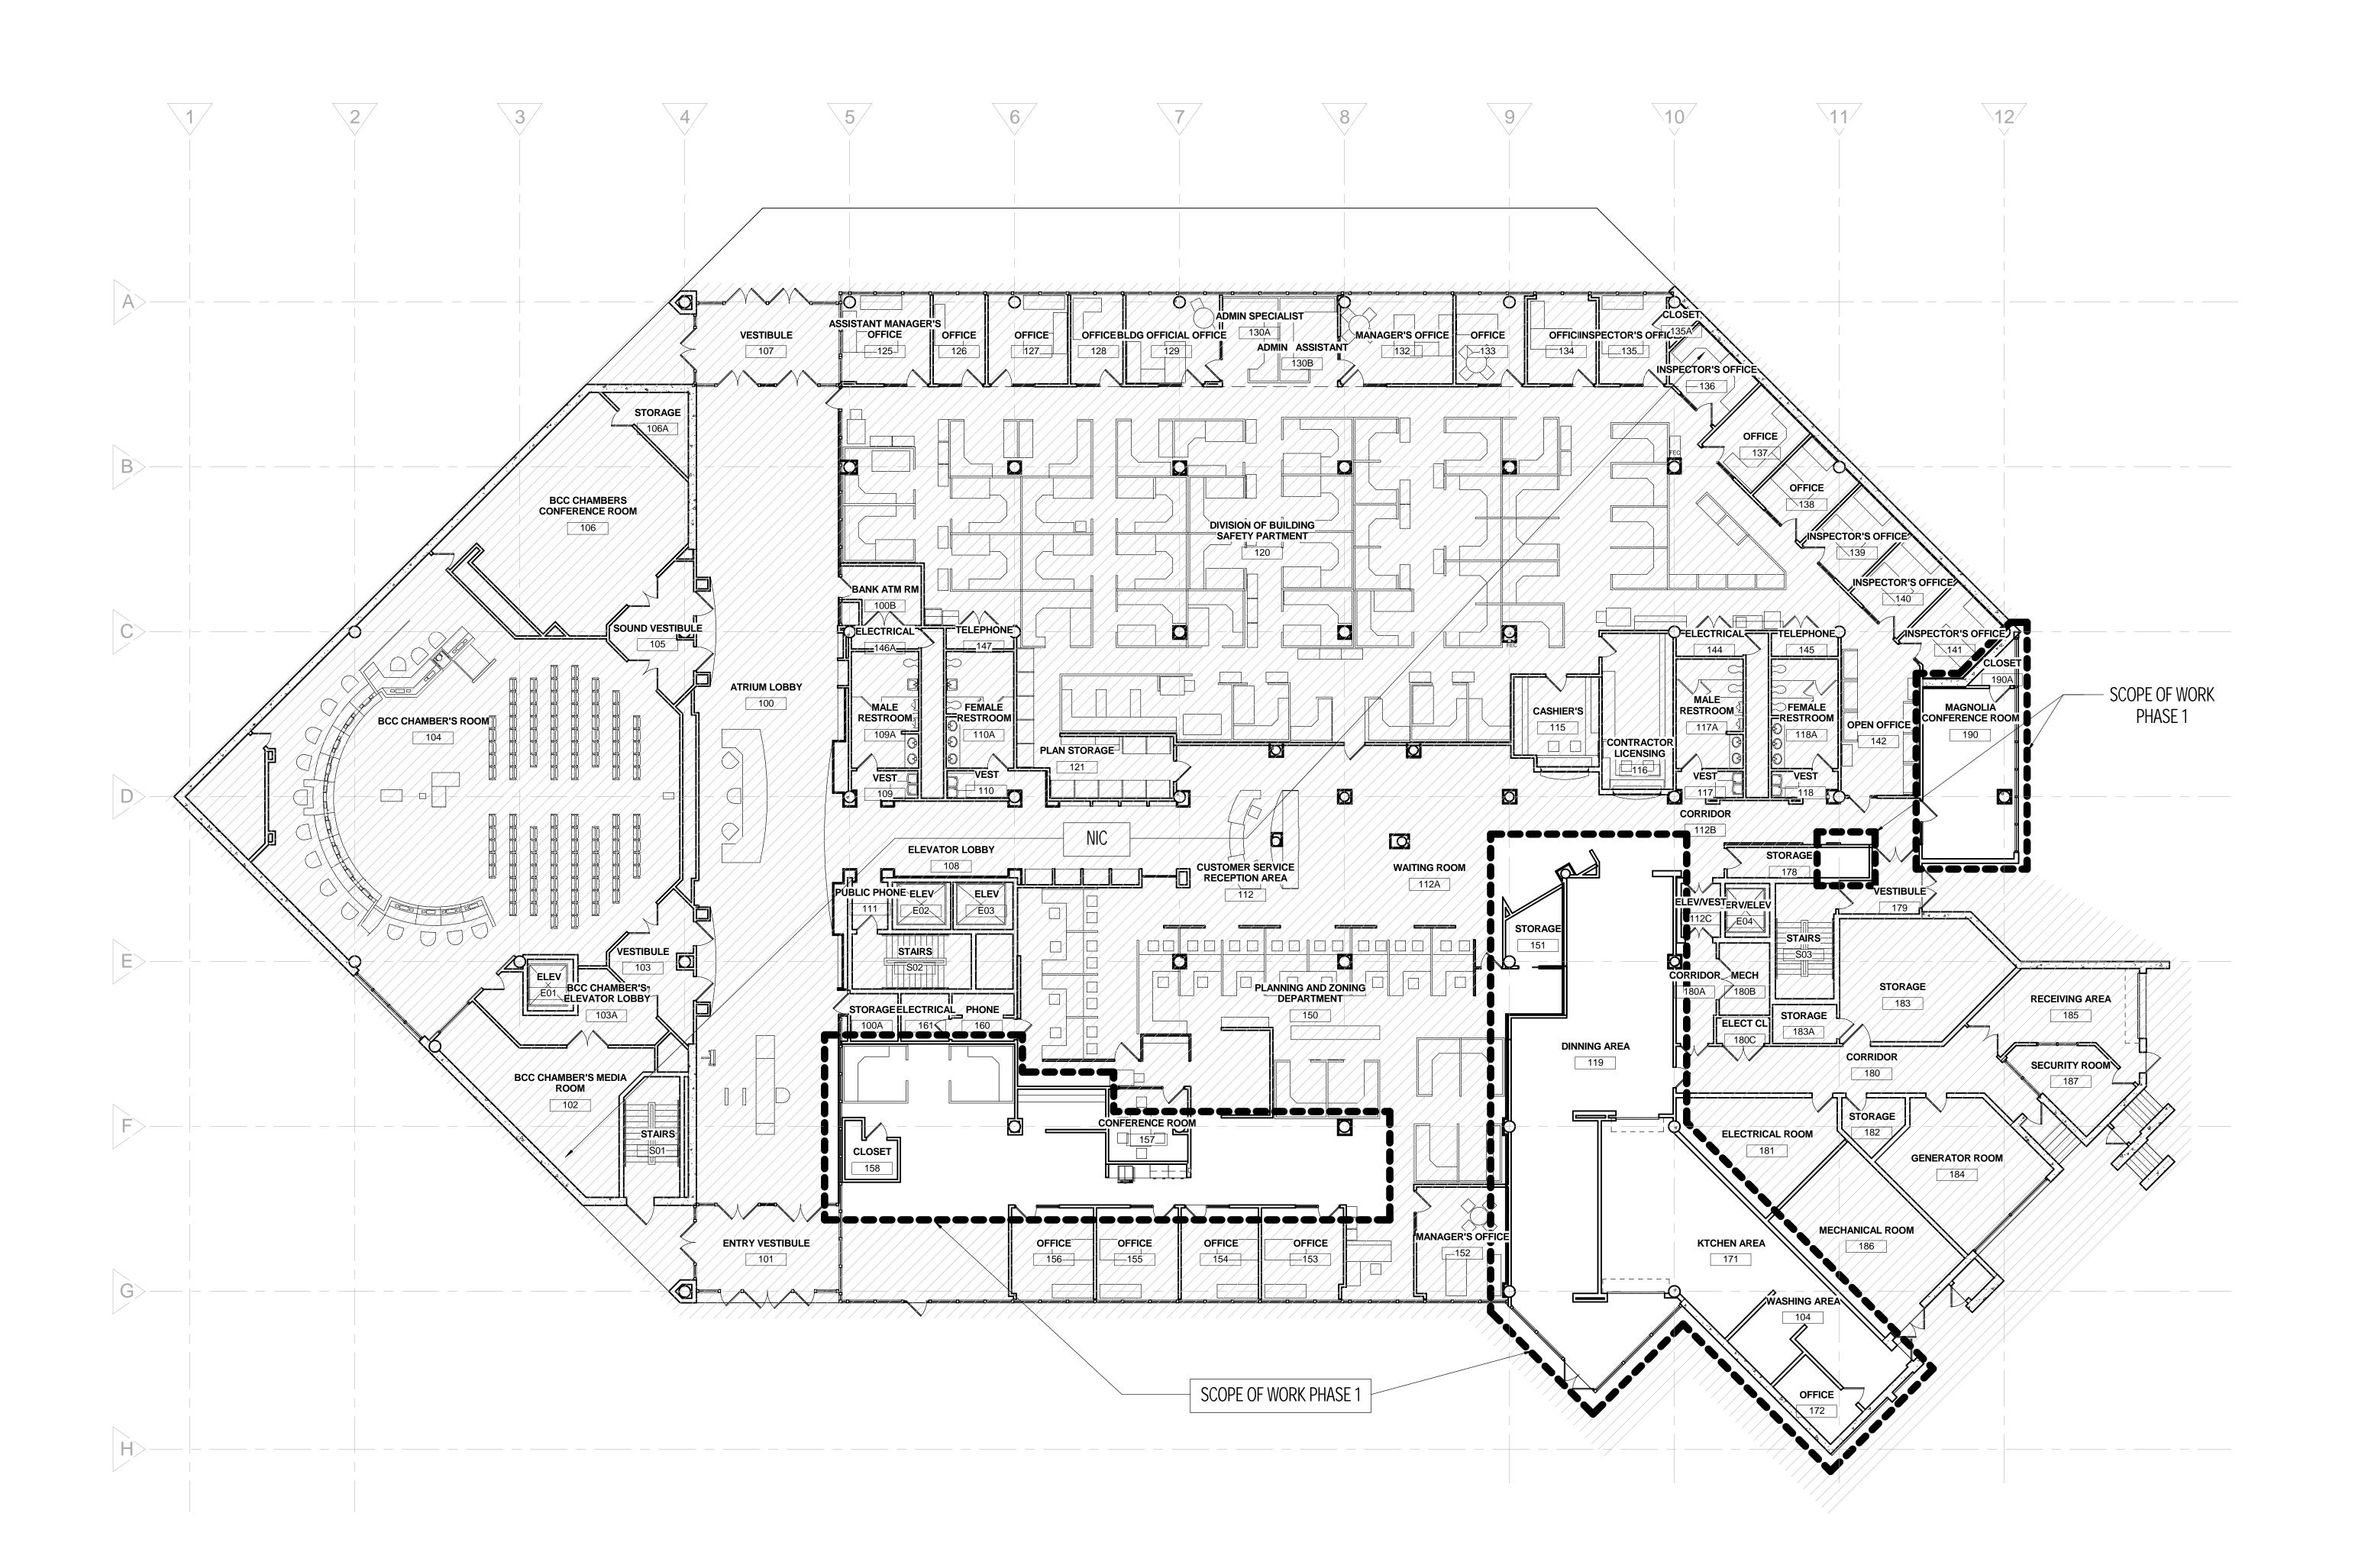
Maximiano Brito, RA, AIA FL Reg. No. AR0015108

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DATE SUBMISSION / REVISION NO.

GENERAL **INFORMATION**

SCALE:	AS INDICATED
DRAWN BY:	AC/MA/LV
CHECK BY:	MB
DATE:	September 22, 2017
PROJECT NUMBER:	15012-0031



rhodes + brito
ARCHITECTS

AA0002809

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BID DOCUMENTS

DATE SUBMISSION / REVISION NO.

OVERAL EXISTING FLOOR PLAN FIRST LEVEL

SCALE: AS INDICATED

DRAWN BY: MA / AC

CHECK BY: AC / MB

DATE: September 22, 2017

PROJECT NUMBER: 15012-0031

G011

EXISTING FLOOR PLAN - FIRST LEVEL


REFERENCE ONLY

SCALE: 3/32" = 1'-0"

TRUE

NORTH

NORTH

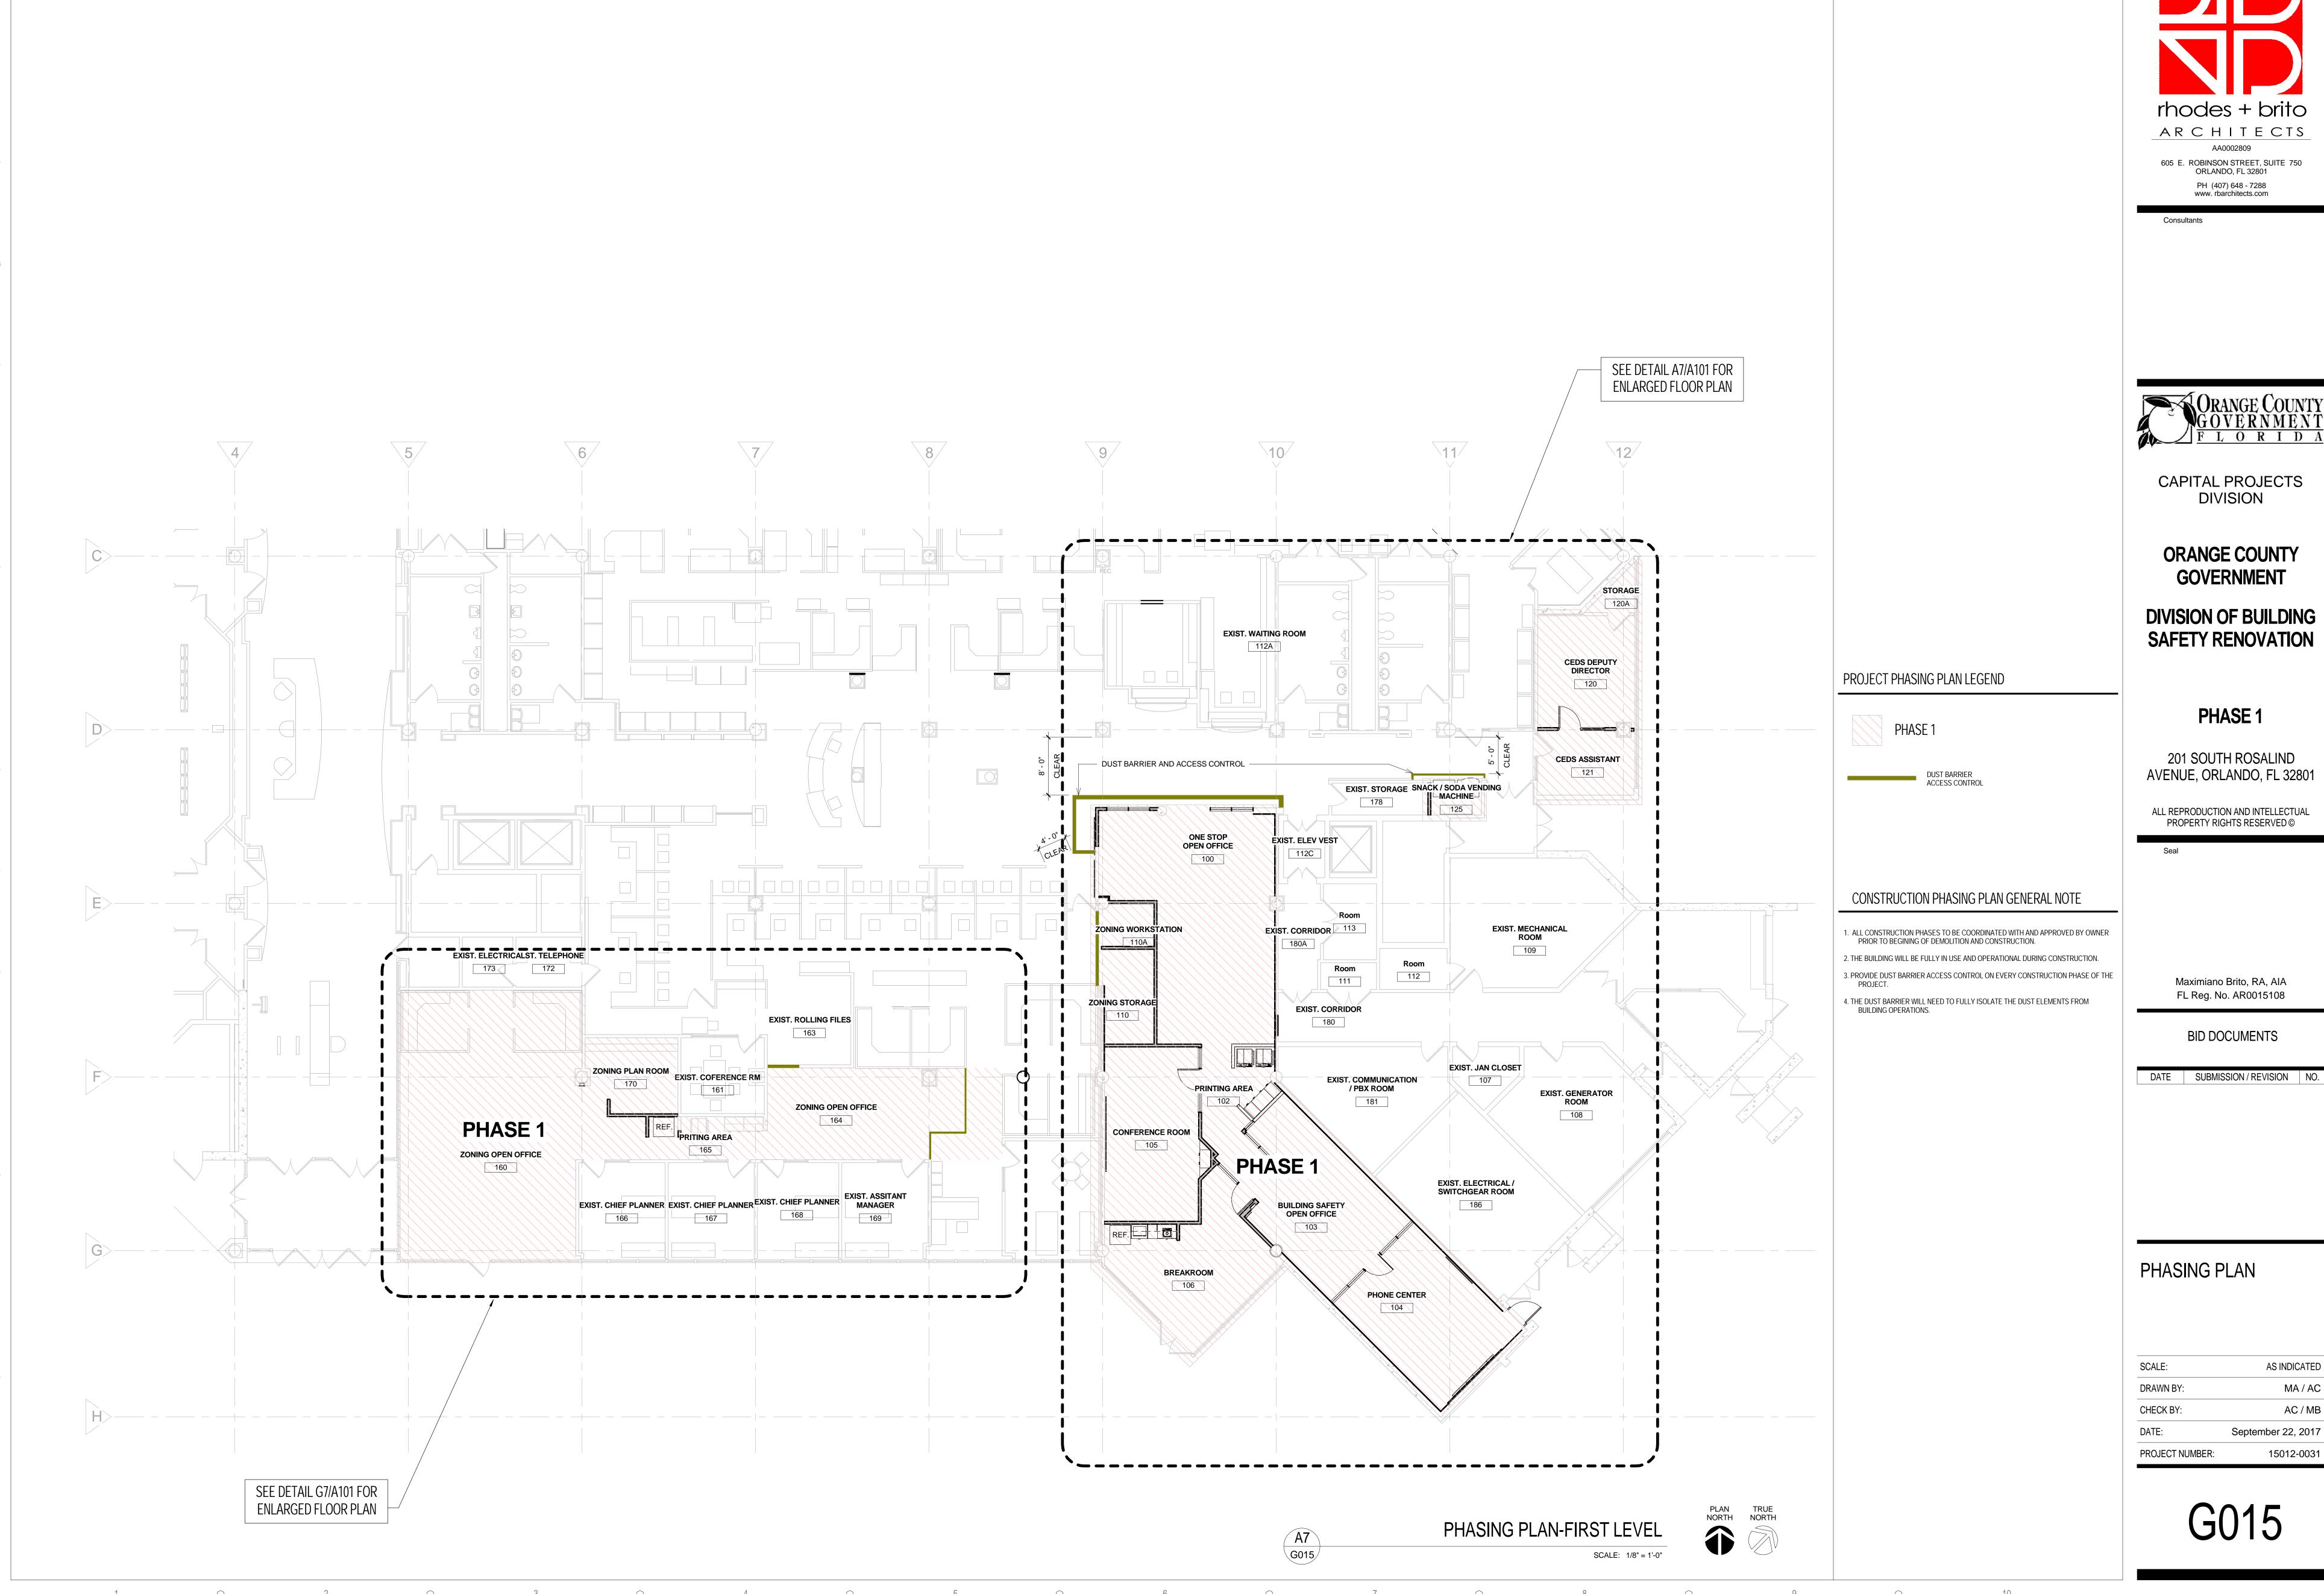

rhodes + brito ARCHITECTS




DIVISION OF BUILDING

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AS INDICATED AC / MB September 22, 2017 15012-0031



GENERAL PARTITION TYPE NOTE

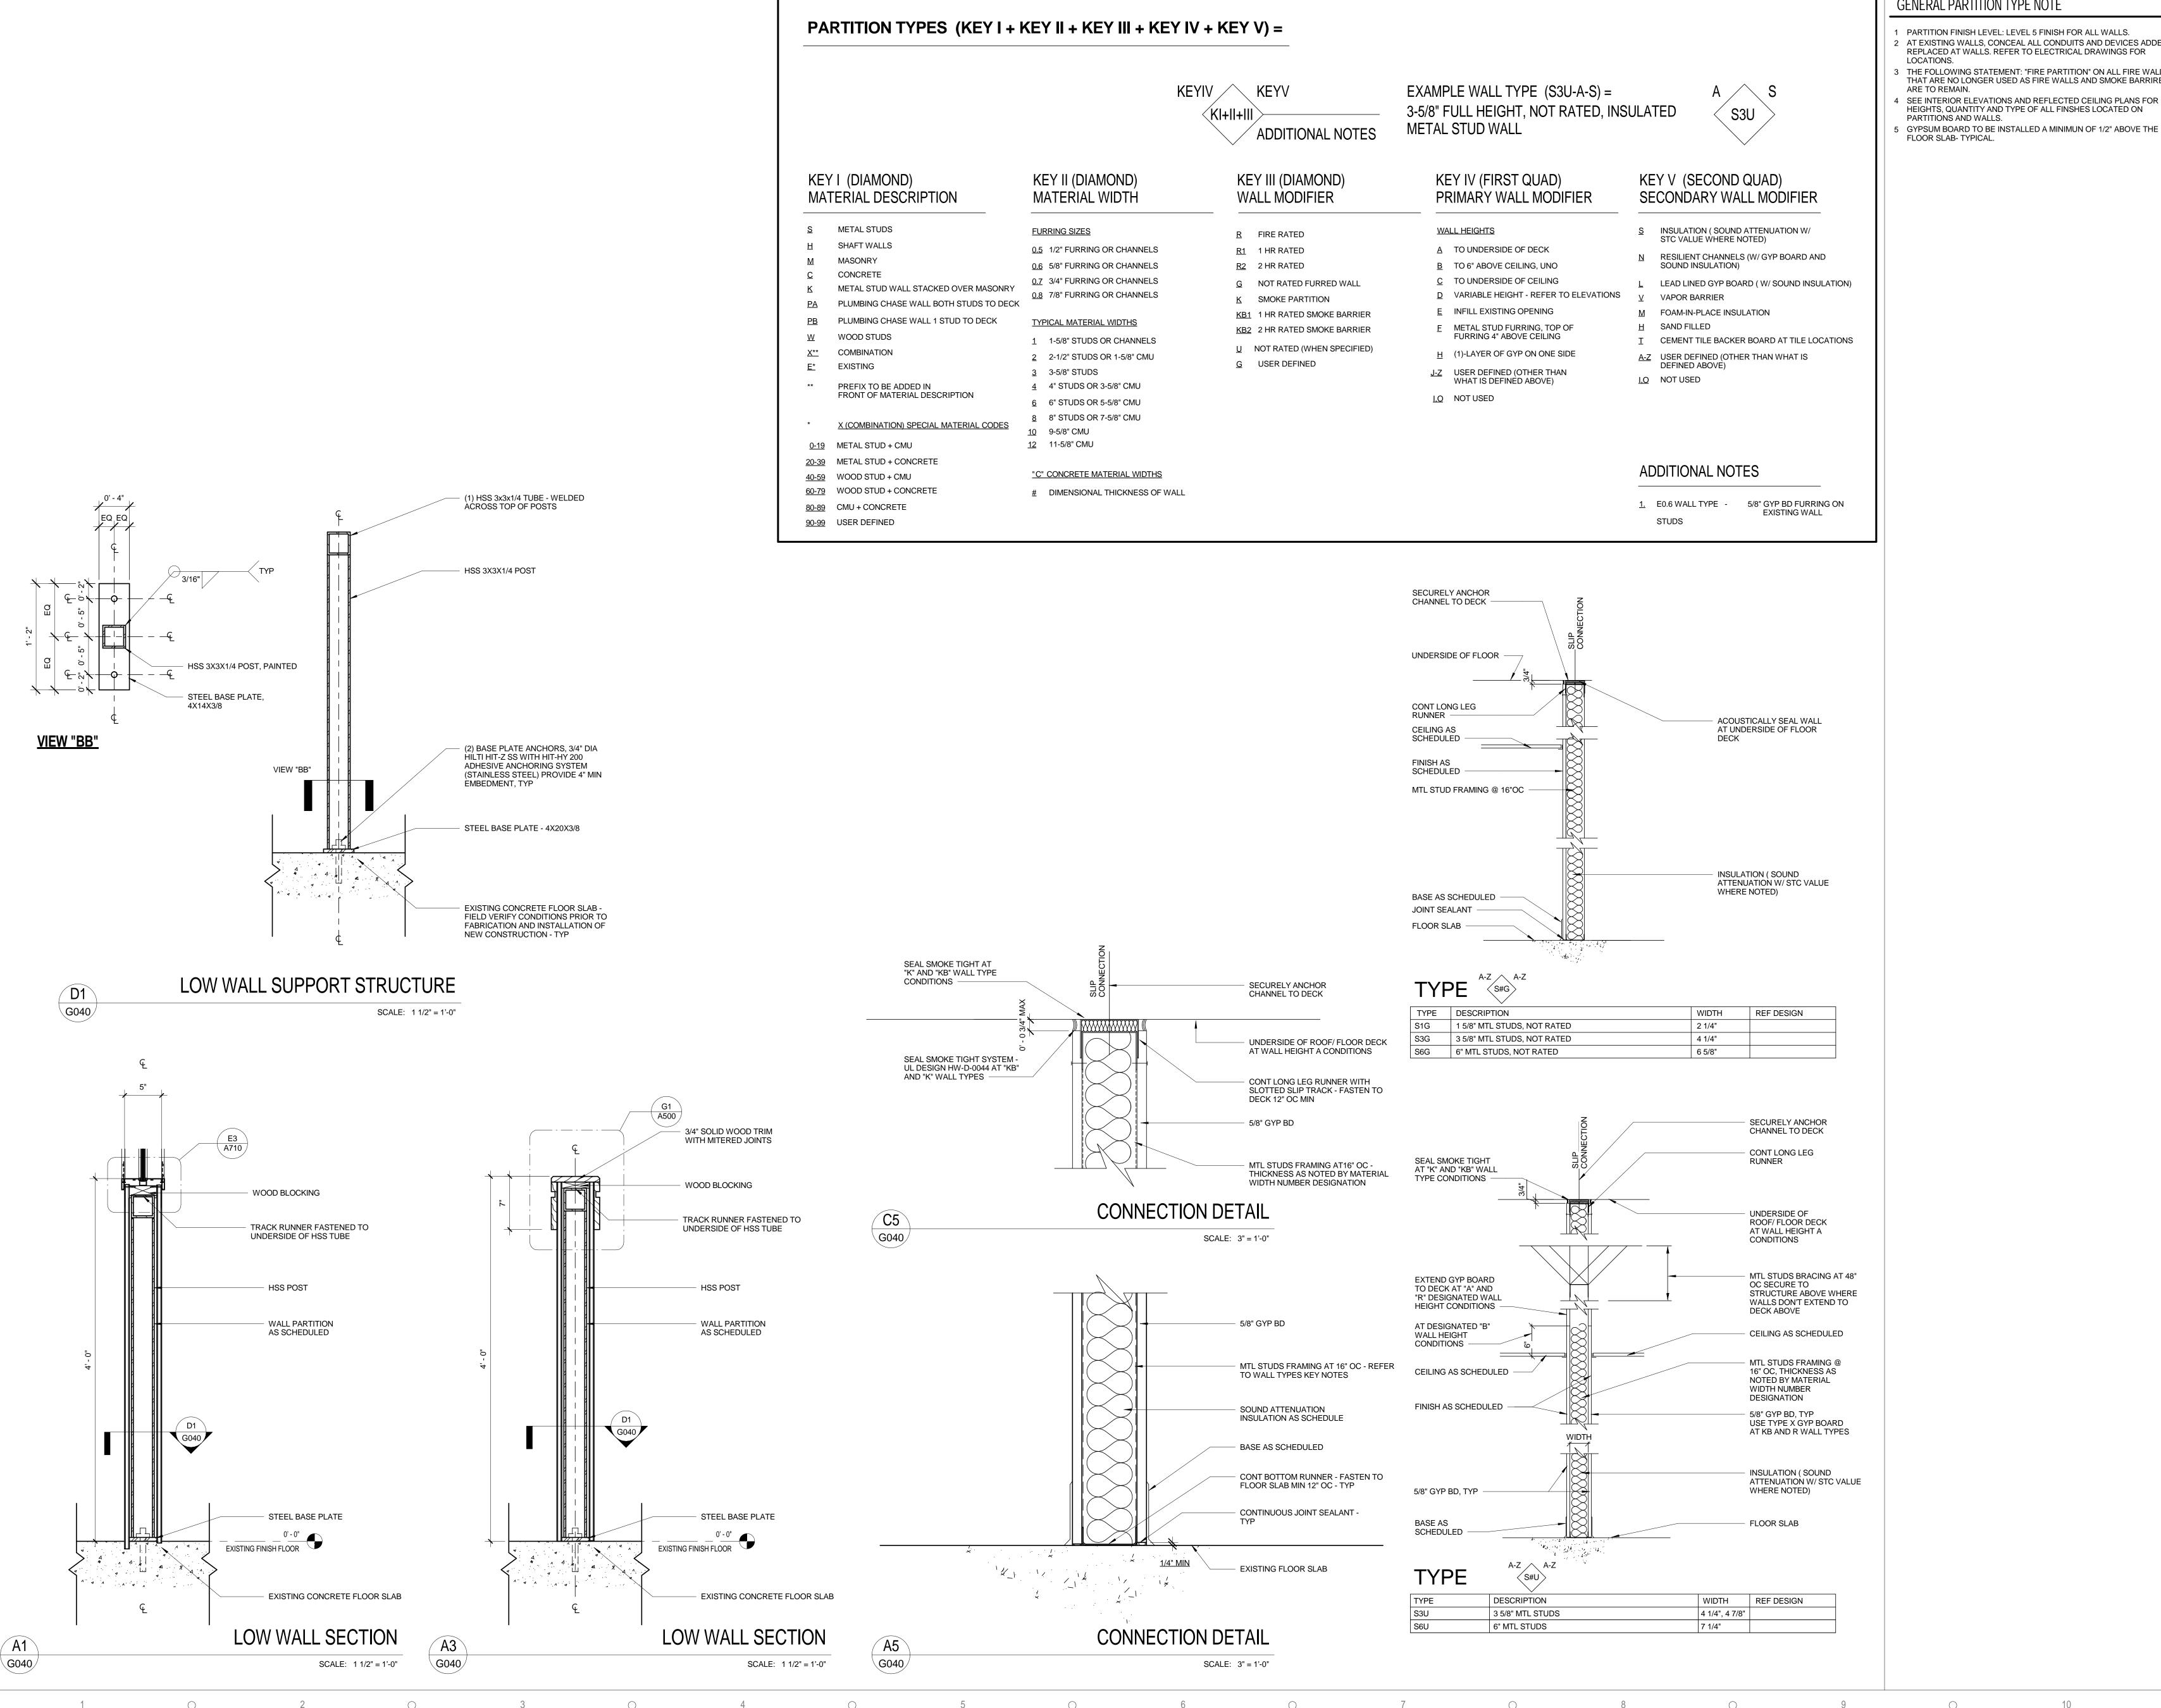PARTITION FINISH LEVEL: LEVEL 5 FINISH FOR ALL WALLS. 2 AT EXISTING WALLS, CONCEAL ALL CONDUITS AND DEVICES ADDED OR REPLACED AT WALLS. REFER TO ELECTRICAL DRAWINGS FOR

THE FOLLOWING STATEMENT: "FIRE PARTITION" ON ALL FIRE WALLS THAT ARE NO LONGER USED AS FIRE WALLS AND SMOKE BARRIRES SEE INTERIOR ELEVATIONS AND REFLECTED CEILING PLANS FOR HEIGHTS, QUANTITY AND TYPE OF ALL FINSHES LOCATED ON



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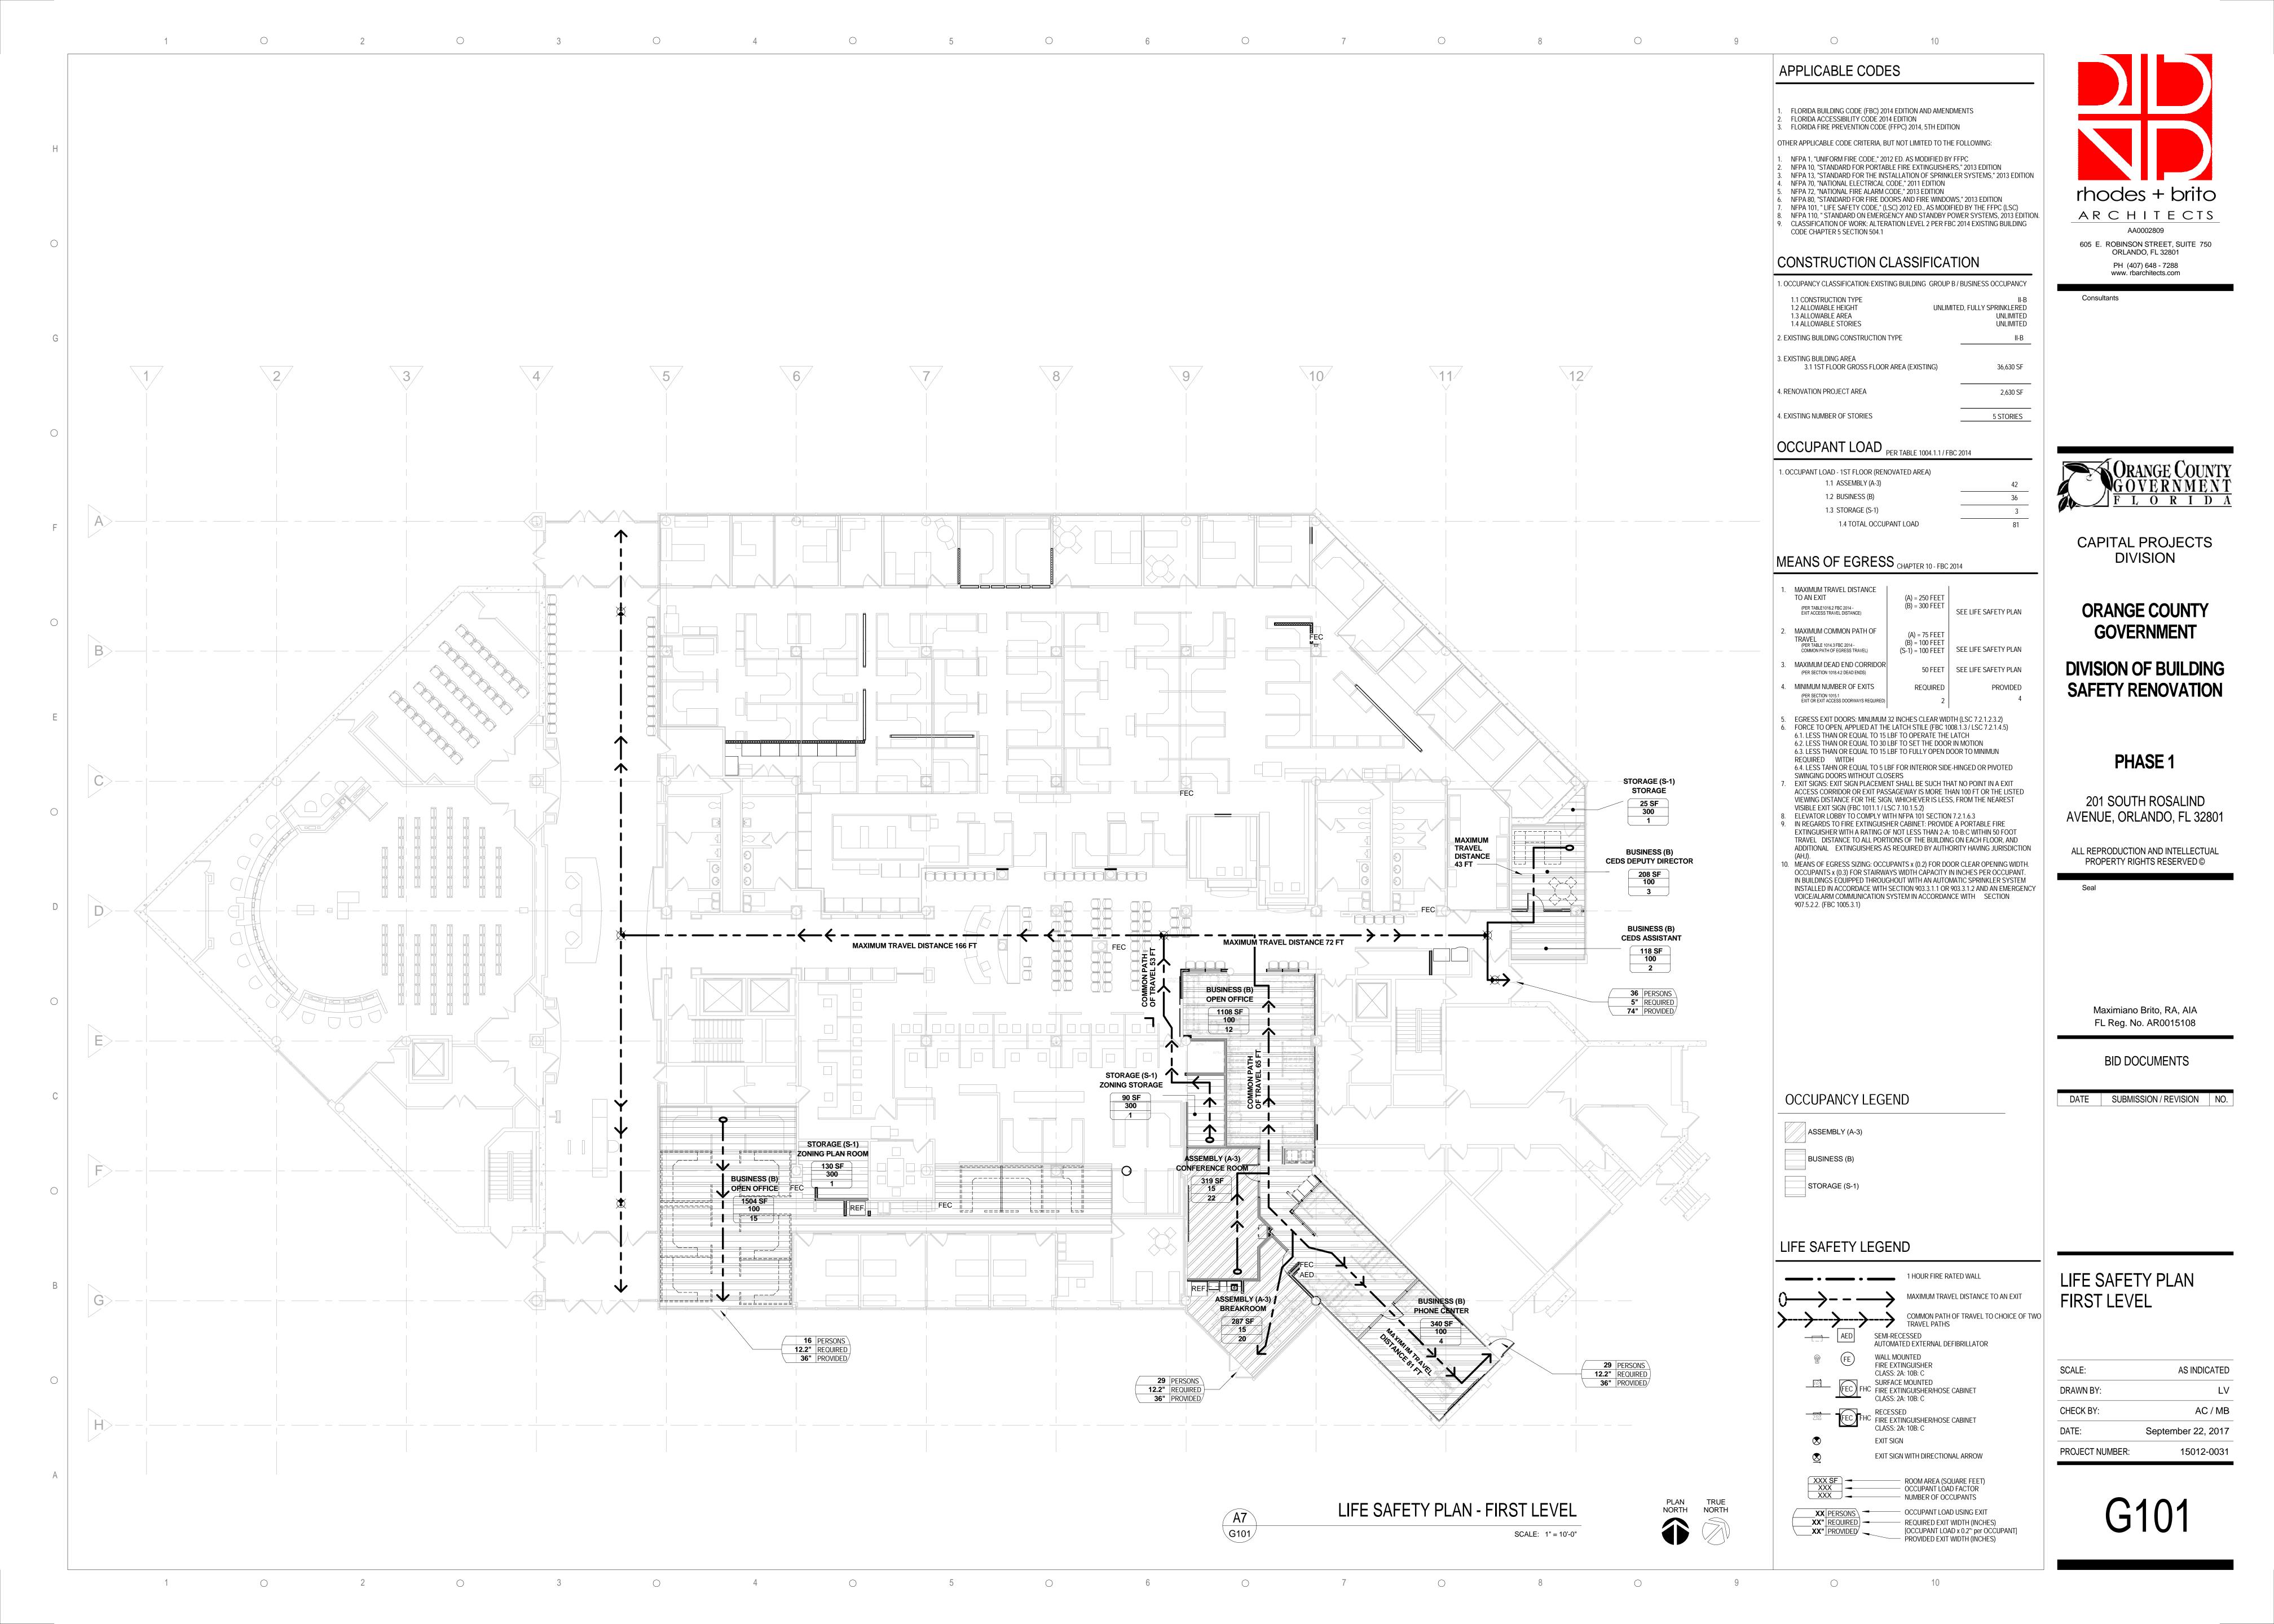
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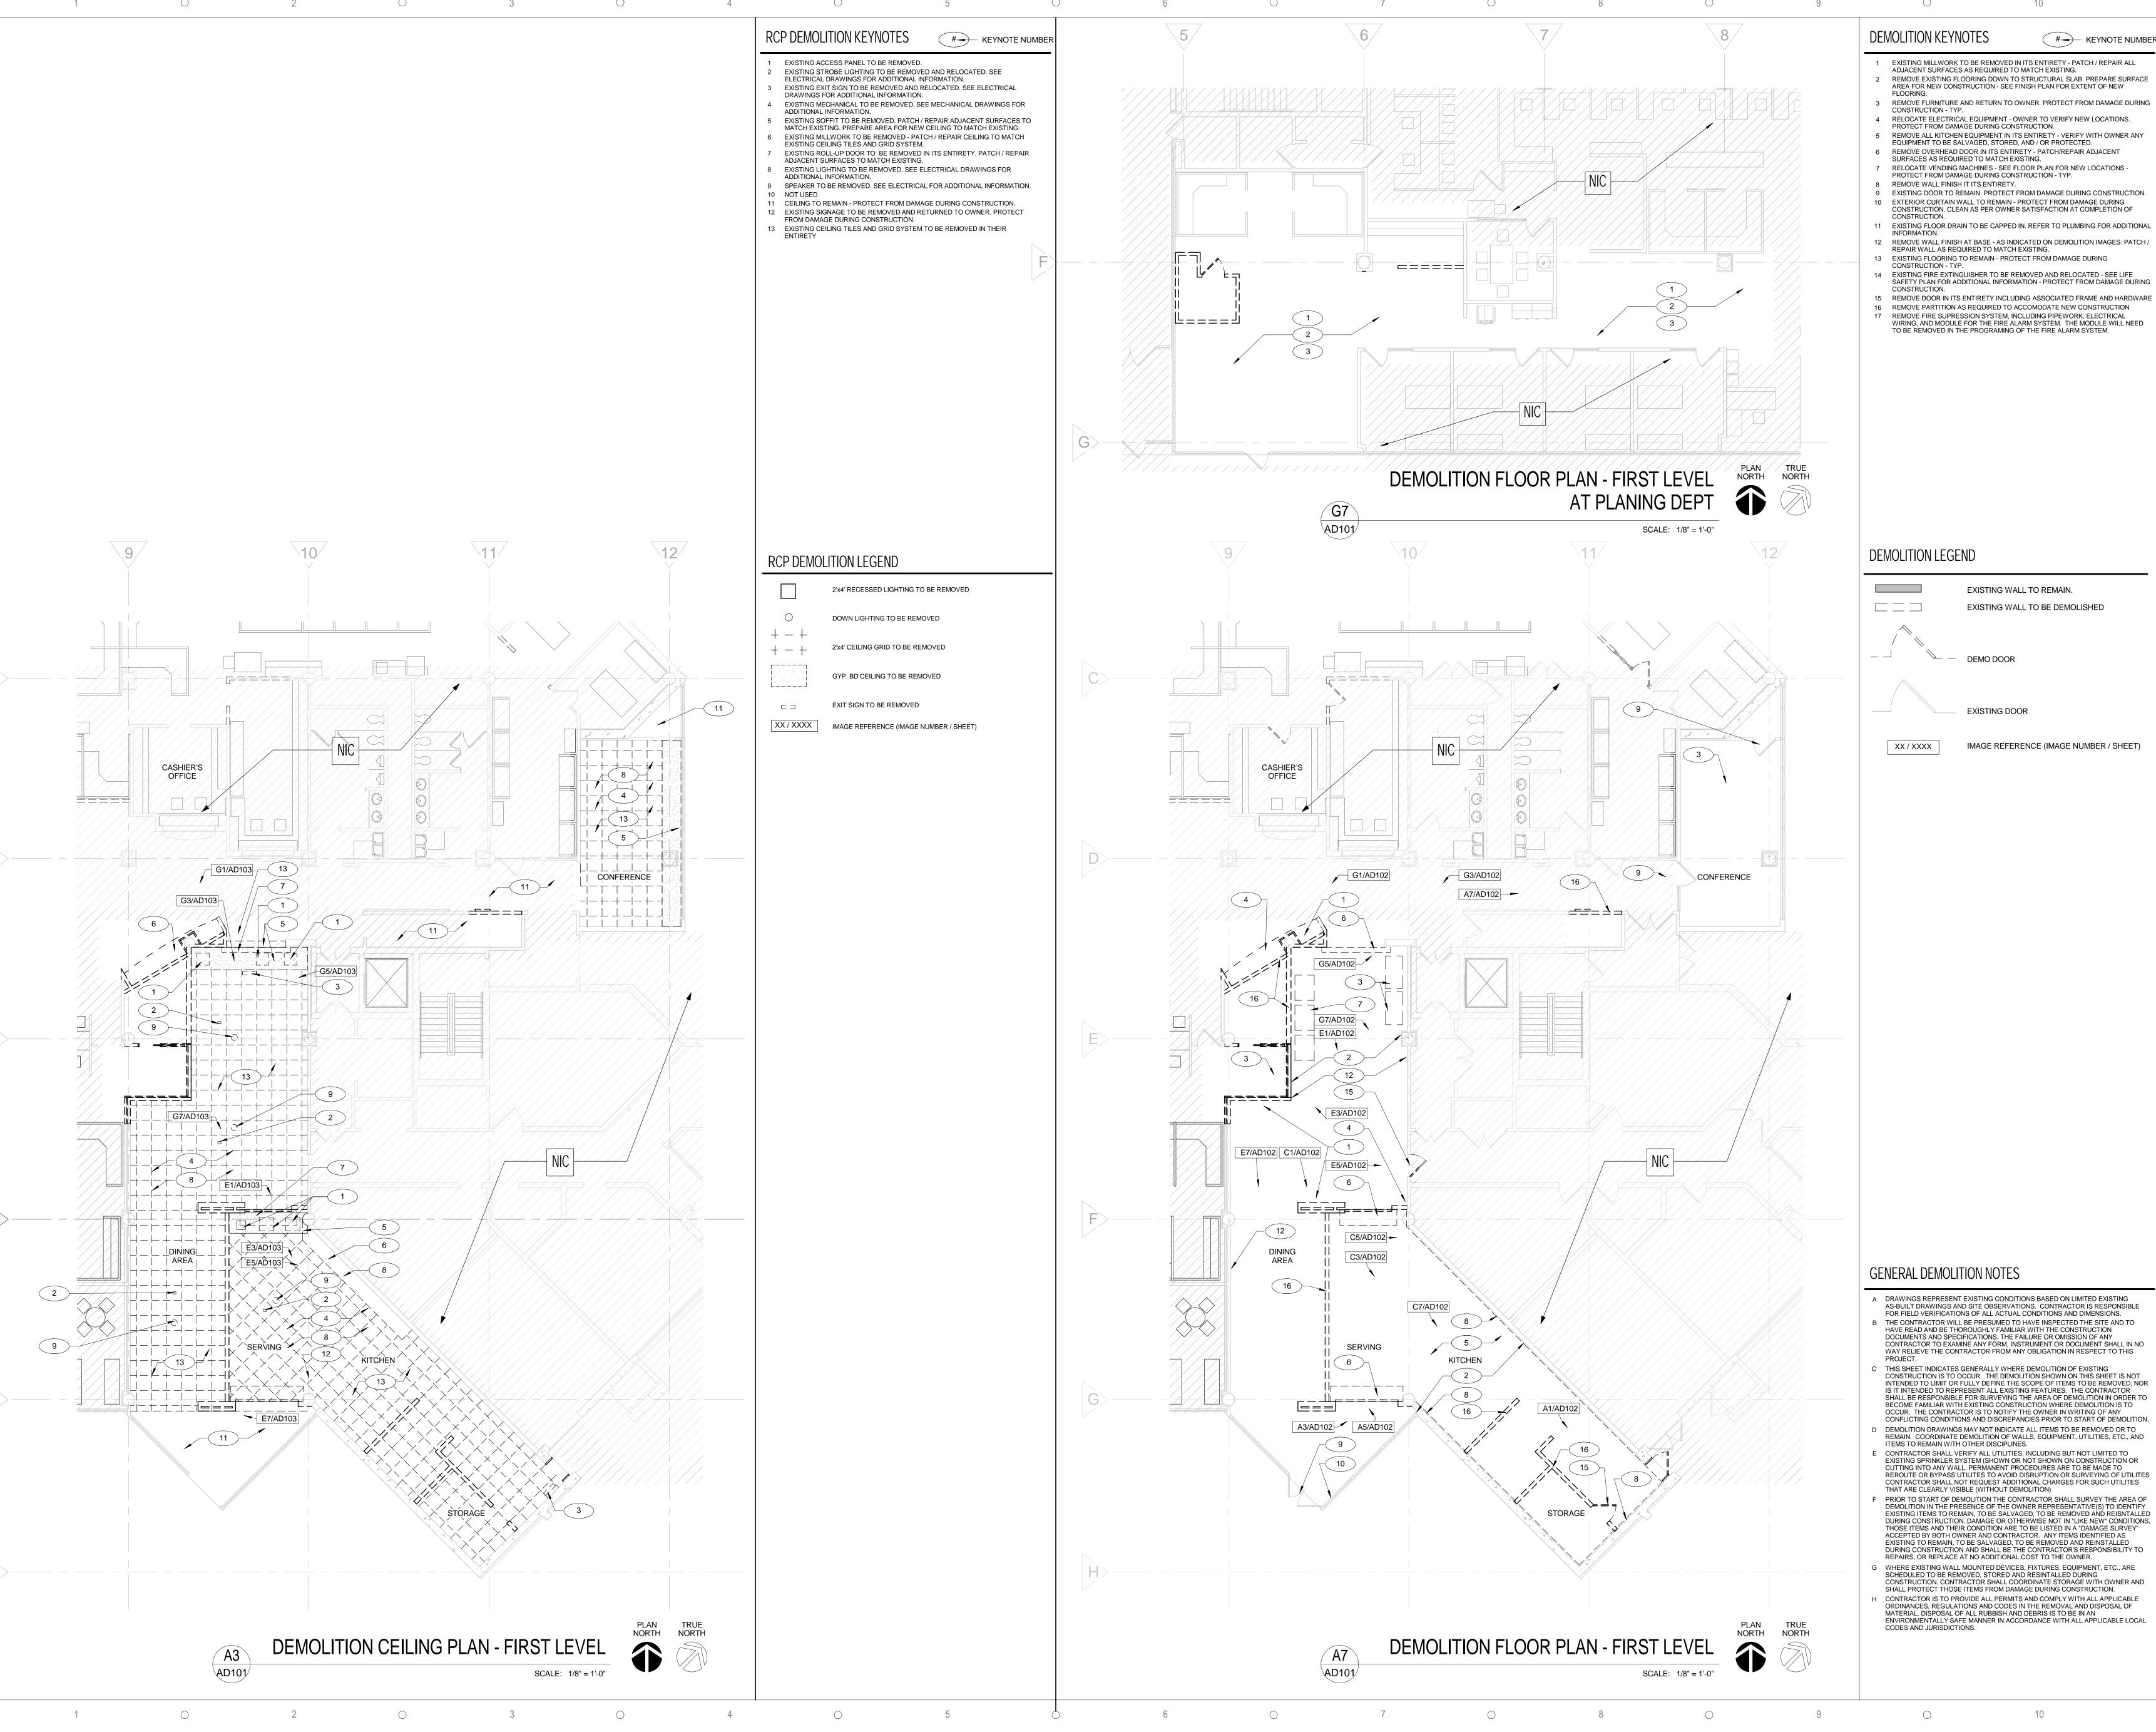
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DATE SUBMISSION / REVISION NO.

PARTITION TYPES

SCALE: AS INDICATED DRAWN BY: MA / AC AC/MB CHECK BY: DATE: September 22, 2017 PROJECT NUMBER: 15012-0031





(# — KEYNOTE NUMBEF

- 1 EXISTING MILLWORK TO BE REMOVED IN ITS ENTIRETY PATCH / REPAIR ALL ADJACENT SURFACES AS REQUIRED TO MATCH EXISTING. REMOVE EXISTING FLOORING DOWN TO STRUCTURAL SLAB. PREPARE SURFACE AREA FOR NEW CONSTRUCTION - SEE FINISH PLAN FOR EXTENT OF NEW
- 3 REMOVE FURNITURE AND RETURN TO OWNER. PROTECT FROM DAMAGE DURING
- REMOVE ALL KITCHEN EQUIPMENT IN ITS ENTIRETY VERIFY WITH OWNER ANY EQUIPMENT TO BE SALVAGED, STORED, AND / OR PROTECTED. 6 REMOVE OVERHEAD DOOR IN ITS ENTIRETY - PATCH/REPAIR ADJACENT
- RELOCATE VENDING MACHINES SEE FLOOR PLAN FOR NEW LOCATIONS -PROTECT FROM DAMAGE DURING CONSTRUCTION - TYP.
- 8 REMOVE WALL FINISH IT ITS ENTIRETY. 9 EXISTING DOOR TO REMAIN. PROTECT FROM DAMAGE DURING CONSTRUCTION.
- 10 EXTERIOR CURTAIN WALL TO REMAIN PROTECT FROM DAMAGE DURING CONSTRUCTION. CLEAN AS PER OWNER SATISFACTION AT COMPLETION OF
- 11 EXISTING FLOOR DRAIN TO BE CAPPED IN. REFER TO PLUMBING FOR ADDITIONAL
- 12 REMOVE WALL FINISH AT BASE AS INDICATED ON DEMOLITION IMAGES. PATCH / REPAIR WALL AS REQUIRED TO MATCH EXISTING. 13 EXISTING FLOORING TO REMAIN - PROTECT FROM DAMAGE DURING
- 14 EXISTING FIRE EXTINGUISHER TO BE REMOVED AND RELOCATED SEE LIFE
- SAFETY PLAN FOR ADDITIONAL INFORMATION PROTECT FROM DAMAGE DURING
- 16 REMOVE PARTITION AS REQUIRED TO ACCOMODATE NEW CONSTRUCTION REMOVE FIRE SUPRESSION SYSTEM, INCLUDING PIPEWORK, ELECTRICAL
- WIRING, AND MODULE FOR THE FIRE ALARM SYSTEM. THE MODULE WILL NEED



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- THIS SHEET INDICATES GENERALLY WHERE DEMOLITION OF EXISTING CONSTRUCTION IS TO OCCUR. THE DEMOLITION SHOWN ON THIS SHEET IS NOT INTENDED TO LIMIT OR FULLY DEFINE THE SCOPE OF ITEMS TO BE REMOVED, NOR IS IT INTENDED TO REPRESENT ALL EXISTING FEATURES. THE CONTRACTOR SHALL BE RESPONSIBLE FOR SURVEYING THE AREA OF DEMOLITION IN ORDER TO BECOME FAMILIAR WITH EXISTING CONSTRUCTION WHERE DEMOLITION IS TO OCCUR. THE CONTRACTOR IS TO NOTIFY THE OWNER IN WRITING OF ANY
- CONFLICTING CONDITIONS AND DISCREPANCIES PRIOR TO START OF DEMOLITION DEMOLITION DRAWINGS MAY NOT INDICATE ALL ITEMS TO BE REMOVED OR TO REMAIN. COORDINATE DEMOLITION OF WALLS, EQUIPMENT, UTILITIES, ETC., AND ITEMS TO REMAIN WITH OTHER DISCIPLINES. E CONTRACTOR SHALL VERIFY ALL UTILITIES, INCLUDING BUT NOT LIMITED TO
- CUTTING INTO ANY WALL. PERMANENT PROCEDURES ARE TO BE MADE TO REROUTE OR BYPASS UTILITES TO AVOID DISRUPTION OR SURVEYING OF UTILITES CONTRACTOR SHALL NOT REQUEST ADDITIONAL CHARGES FOR SUCH UTILITES THAT ARE CLEARLY VISIBLE (WITHOUT DEMOLITION) F PRIOR TO START OF DEMOLITION THE CONTRACTOR SHALL SURVEY THE AREA OF DEMOLITION IN THE PRESENCE OF THE OWNER REPRESENTATIVE(S) TO IDENTIFY EXISTING ITEMS TO REMAIN, TO BE SALVAGED, TO BE REMOVED AND REISNTALLED DURING CONSTRUCTION. DAMAGE OR OTHERWISE NOT IN "LIKE NEW" CONDITIONS. THOSE ITEMS AND THEIR CONDITION ARE TO BE LISTED IN A "DAMAGE SURVEY"
- DURING CONSTRUCTION AND SHALL BE THE CONTRACTOR'S RESPONSIBILITY TO REPAIRS, OR REPLACE AT NO ADDITIONAL COST TO THE OWNER. G WHERE EXISTING WALL MOUNTED DEVICES, FIXTURES, EQUIPMENT, ETC., ARE SCHEDULED TO BE REMOVED, STORED AND RESINTALLED DURING CONSTRUCTION, CONTRACTOR SHALL COORDINATE STORAGE WITH OWNER AND SHALL PROTECT THOSE ITEMS FROM DAMAGE DURING CONSTRUCTION. H CONTRACTOR IS TO PROVIDE ALL PERMITS AND COMPLY WITH ALL APPLICABLE ORDINANCES, REGULATIONS AND CODES IN THE REMOVAL AND DISPOSAL OF

DEMOLITION PLAN

AS INDICATED MA / AC AC / MB CHECK BY: September 22, 2017 15012-0031



E1

5

8



SCALE: 1" = 160'-0"

DEMOLITION IMAGE 06

DEMOLITION IMAGE 10

SCALE: 6" = 1'-0"

SCALE: 3" = 1'-0"


SCALE: 3" = 1'-0"







DEMOLITION IMAGE 04 SCALE: 3" = 1'-0"

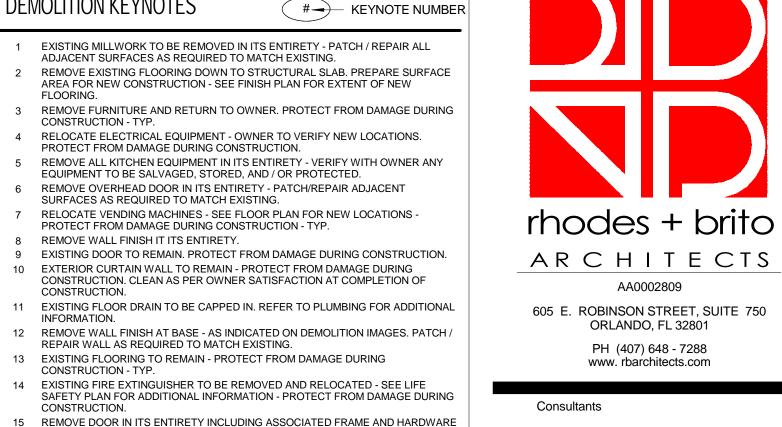

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GENERAL DEMOLITION NOTES

DEMOLITION KEYNOTES

ADJACENT SURFACES AS REQUIRED TO MATCH EXISTING.

EQUIPMENT TO BE SALVAGED, STORED, AND / OR PROTECTED.

13 EXISTING FLOORING TO REMAIN - PROTECT FROM DAMAGE DURING

16 REMOVE PARTITION AS REQUIRED TO ACCOMODATE NEW CONSTRUCTION 7 REMOVE FIRE SUPRESSION SYSTEM, INCLUDING PIPEWORK, ELECTRICAL WIRING, AND MODULE FOR THE FIRE ALARM SYSTEM. THE MODULE WILL NEED


TO BE REMOVED IN THE PROGRAMING OF THE FIRE ALARM SYSTEM.

SURFACES AS REQUIRED TO MATCH EXISTING.

8 REMOVE WALL FINISH IT ITS ENTIRETY.

CONSTRUCTION - TYP.

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AD102

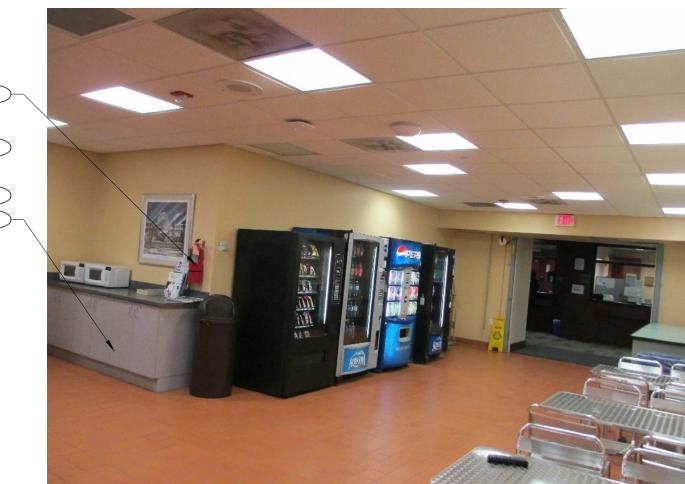E3


AD102

C3

AD102

A3

\AD102

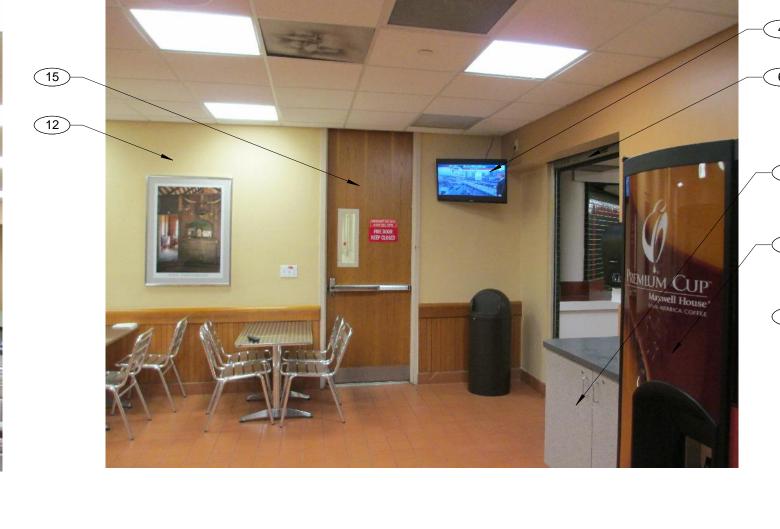



E7 AD102

AD102


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DEMOLITION IMAGE 08 SCALE: 3" = 1'-0"

SCALE: 3" = 1'-0"



AD102

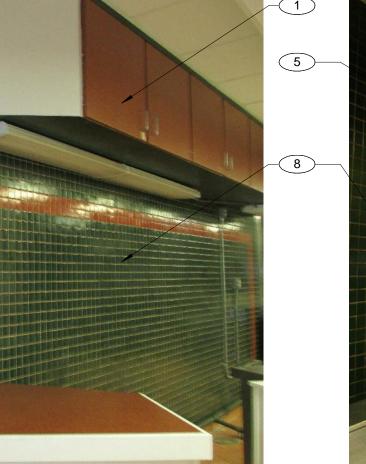


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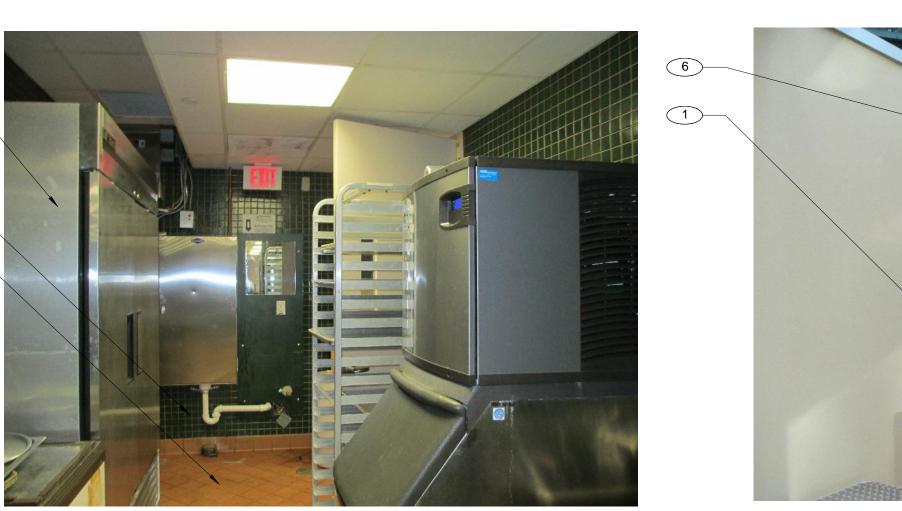
SCALE: 3" = 1'-0"

DEMOLITION IMAGE 07





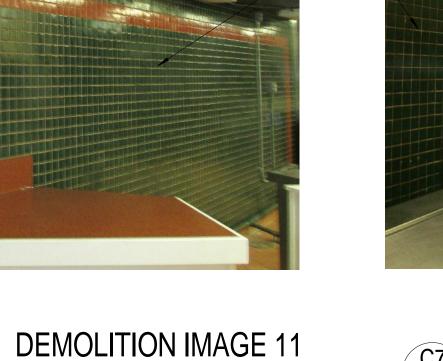



DEMOLITION IMAGE 13

SCALE: 3" = 1'-0"

DEMOLITION IMAGE 09


SCALE: 3" = 1'-0"

DEMOLITION IMAGE 05

SCALE: 3" = 1'-0"





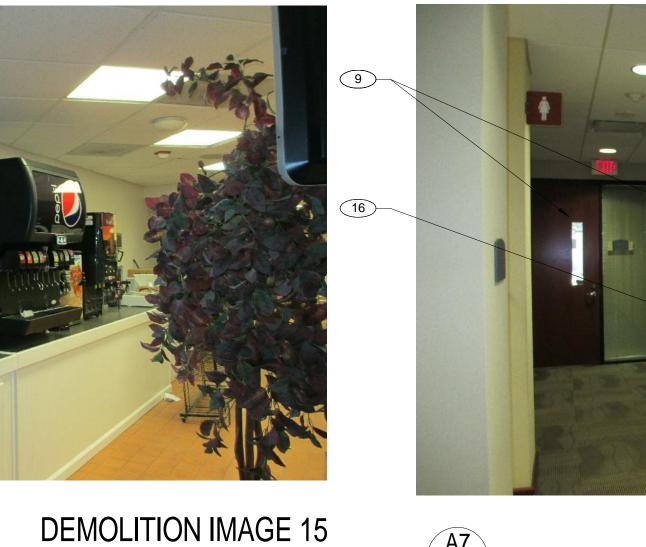

SCALE: 3" = 1'-0"

DEMOLITION IMAGE 16 SCALE: 3" = 1'-0"

AS INDICATED DRAWN BY:

DEMOLITION IMAGES -

FLOOR PLAN

CHECK BY:


PROJECT NUMBER:

DATE:

Checker

15012-0031

September 22, 2017

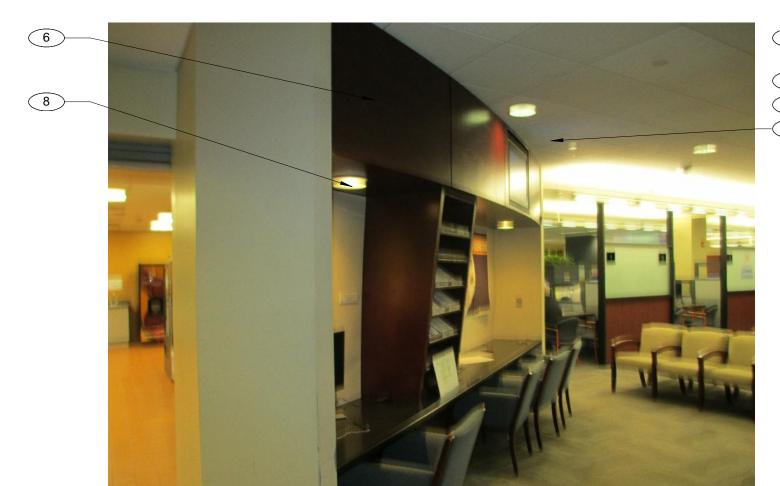

AD103

E1

AD103



DEMOLITION RCP IMAGE 02


SCALE: 1" = 400'-0"

G5

AD103

AD103


O 2 O 3 O 4 O 5 O 9

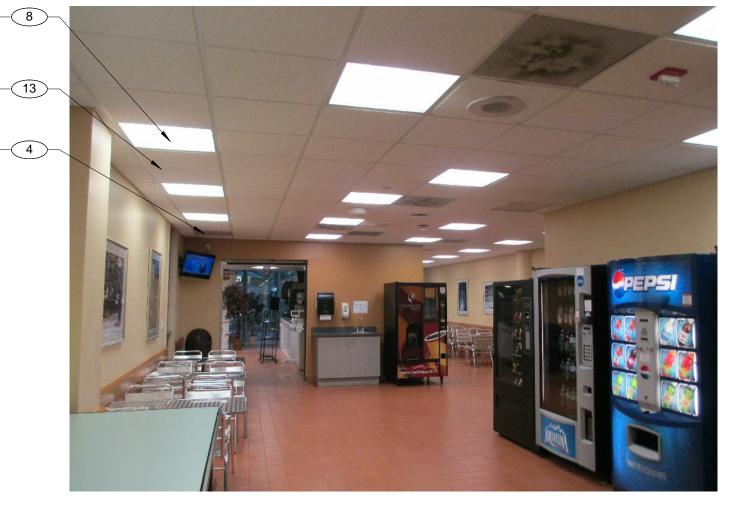

DEMOLITION RCP IMAGE 03

SCALE: 3" = 1'-0"



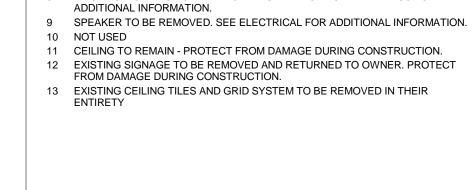

EXISTING CEILING TILES AND GRID SYSTEM.

EXISTING ACCESS PANEL TO BE REMOVED.

EXISTING STROBE LIGHTING TO BE REMOVED AND RELOCATED. SEE ELECTRICAL DRAWINGS FOR ADDITIONAL INFORMATION.


EXISTING EXIT SIGN TO BE REMOVED AND RELOCATED. SEE ELECTRICAL DRAWINGS FOR ADDITIONAL INFORMATION.

EXISTING MECHANICAL TO BE REMOVED. SEE MECHANICAL DRAWINGS FOR ADDITIONAL INFORMATION. EXISTING SOFFIT TO BE REMOVED. PATCH / REPAIR ADJACENT SURFACES TO MATCH EXISTING. PREPARE AREA FOR NEW CEILING TO MATCH EXISTING. EXISTING MILLWORK TO BE REMOVED - PATCH / REPAIR CEILING TO MATCH

EXISTING ROLL-UP DOOR TO BE REMOVED IN ITS ENTIRETY. PATCH / REPAIR ADJACENT SURFACES TO MATCH EXISTING.

EXISTING LIGHTING TO BE REMOVED. SEE ELECTRICAL DRAWINGS FOR

RCP DEMOLITION KEYNOTES

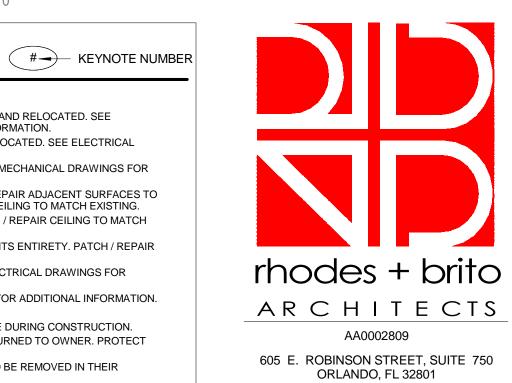

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DEMOLITION IMAGES -

REFLECTED CEILING

DRAWN BY:

CHECK BY:

AS INDICATED

15012-0031

September 22, 2017

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G7

AD103

DEMOLITION RCP IMAGE 08


SCALE: 3" = 1'-0"

SCALE: 3" = 1'-0"

DEMOLITION RCP IMAGE 01

SCALE: 3" = 1'-0"



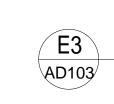

G3

AD103


DEMOLITION RCP IMAGE 06 SCALE: 3" = 1'-0"

SCALE: 3" = 1'-0"


GENERAL DEMOLITION NOTES

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+ KEYNOTE NUMBER

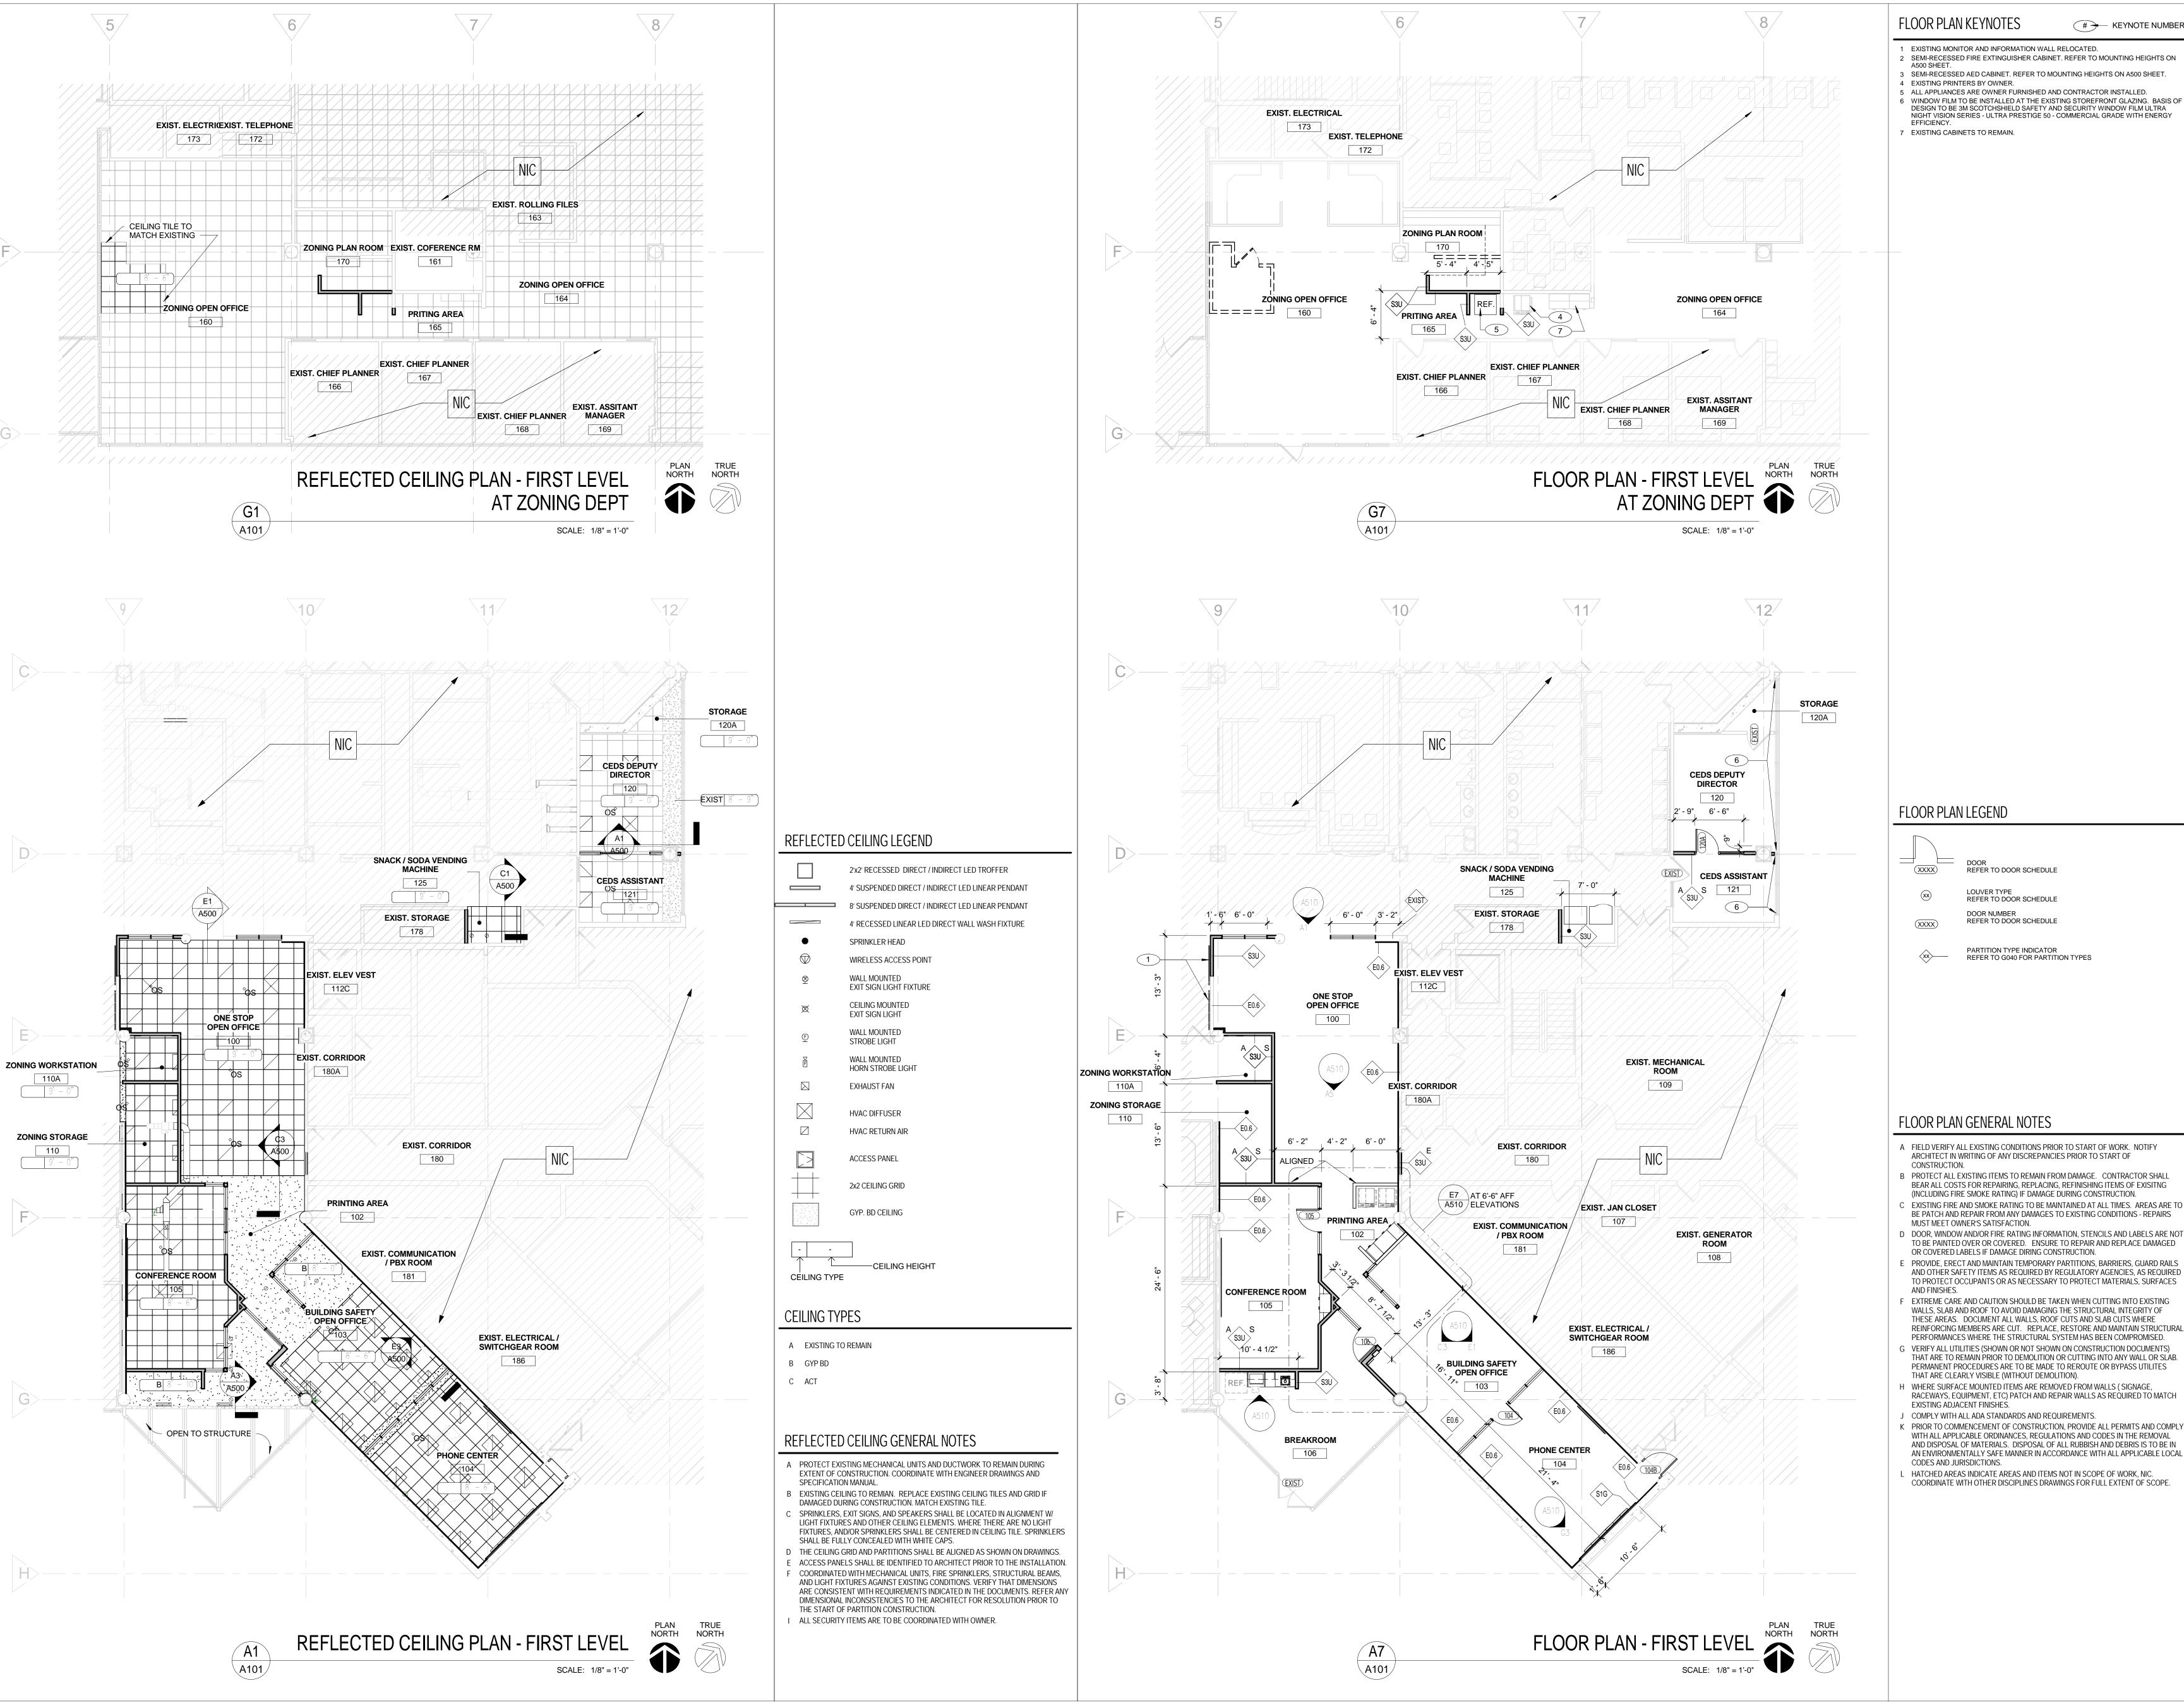

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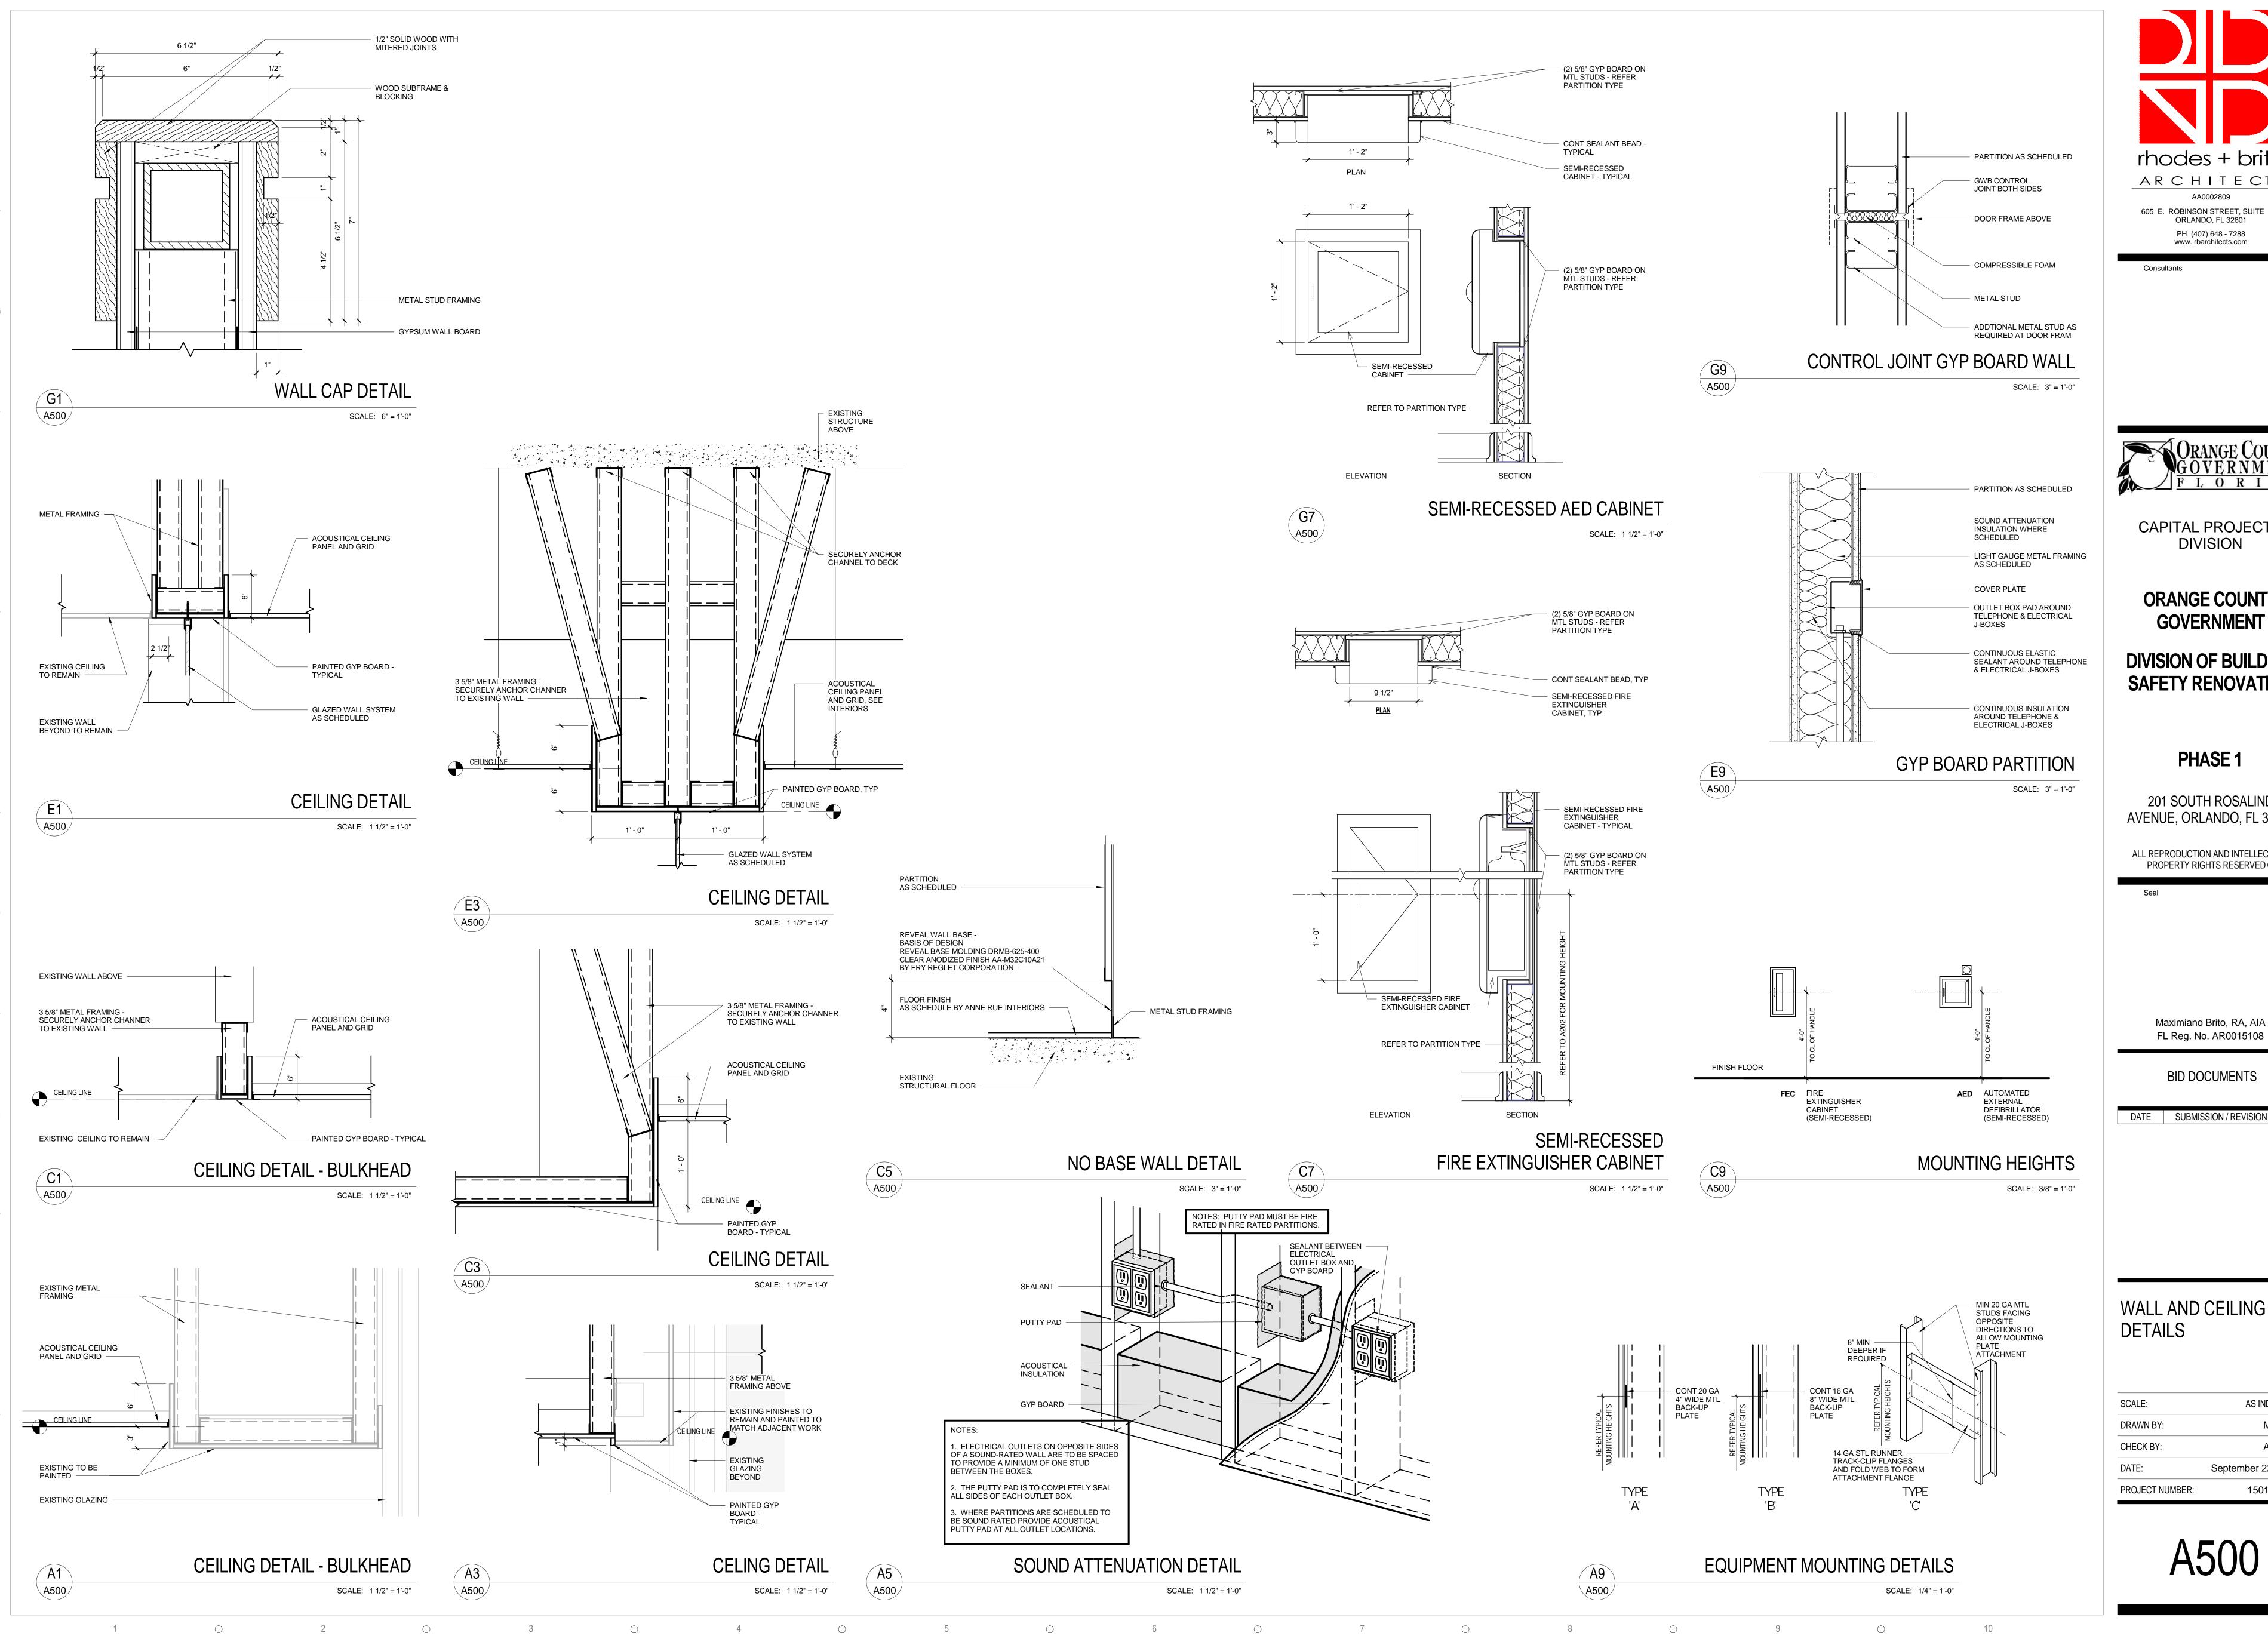
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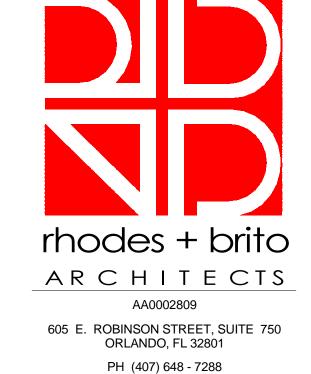
BID DOCUMENTS

DATE | SUBMISSION / REVISION | NO.

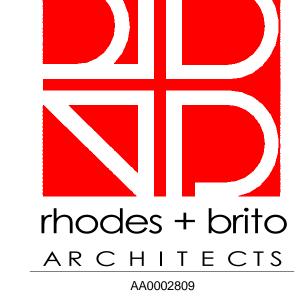FLOOR PLAN AND REFLECTED CEILING

SCALE: AS INDICATED MA / AC DRAWN BY: AC / MB CHECK BY: DATE: September 22, 2017 PROJECT NUMBER: 15012-0031







CAPITAL PROJECTS DIVISION

ORANGE COUNTY GOVERNMENT

DIVISION OF BUILDING SAFETY RENOVATION

PHASE 1

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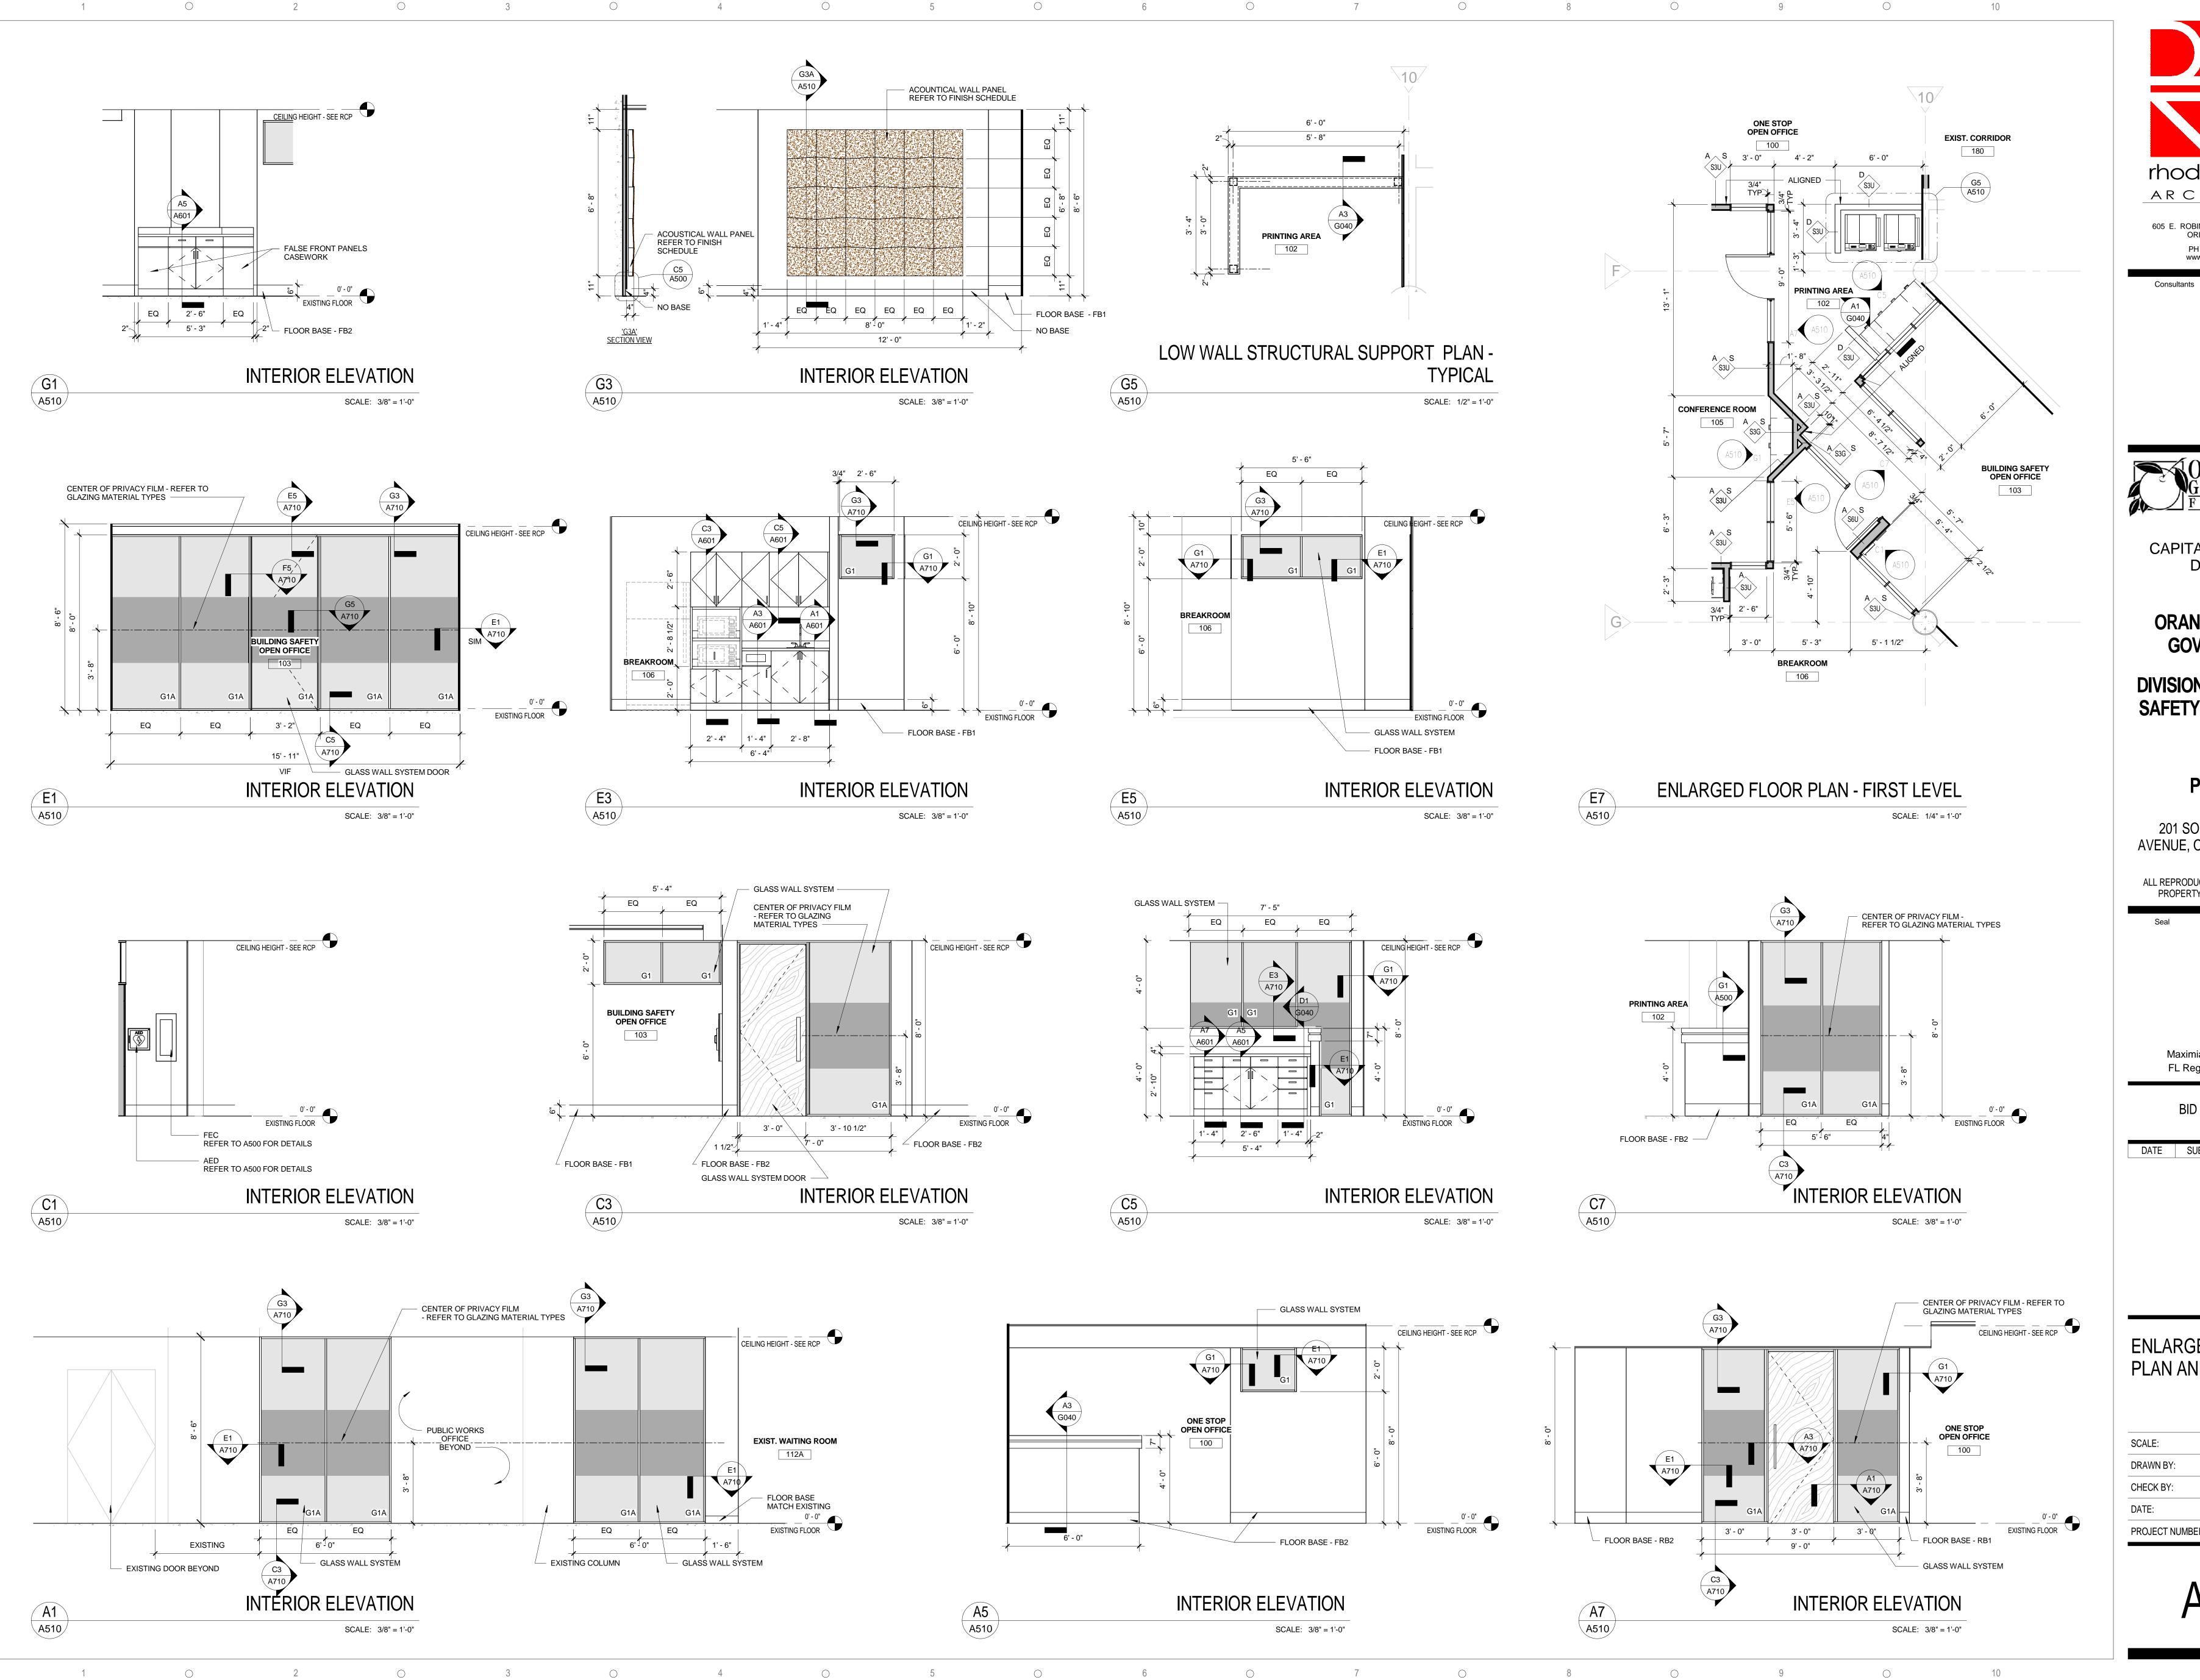
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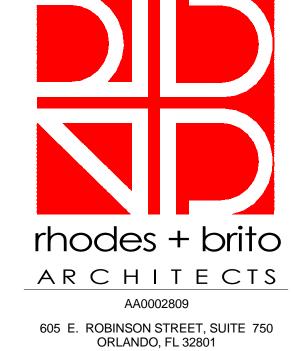
BID DOCUMENTS

DATE SUBMISSION / REVISION NO.

WALL AND CEILING

SCALE:	AS INDICATED
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ENLARGED FLOOR PLAN AND ELEVATIONS

SCALE: AS INDICATED


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DATE: September 22, 2017

PROJECT NUMBER: 15012-0031

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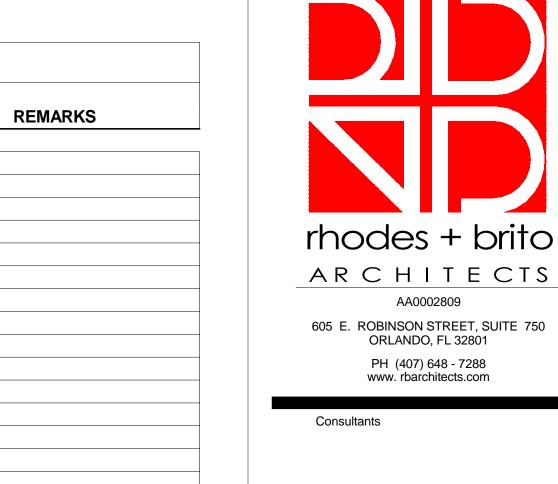


			FINISH SCHED	ULE					
				WALL FINISH					
OOM NUMBER	ROOM NAME	FLOOR FINISH	BASE FINISH	NORTH	SOUTH	EAST	WEST	CEILING FINISH	REMARKS
vel 1				•					
100	ONE STOP OPEN OFFICE	CPT1	FB1	PT1	PT1	PT1	PT3	ACP1	
102	PRINTING AREA	LVT1	FB1	PT1	PT1	PT1	PT1	ACP1	
103	BUILDING SAFETY OPEN OFFICE	CPT1	FB1	PT1	PT1	PT1	PT1	ACP1	
104	PHONE CENTER	CPT2	FB1	PT1	PT3	PT1	PT1	ACP1	
105	CONFERENCE ROOM	CPT2	FB2	PT2	PT3	PT2	PT2	ACP1	
106	BREAKROOM	LVT1	FB1	PT4	PT1	PT1	PT1	ACP1	
110	ZONING STORAGE	LVT1	FB1	PT1	PT1	PT1	PT1	ACP1	
110A	ZONING WORKSTATION	EXIST	EXIST	PT1	PT1	PT1	PT1	ACP1	
120	CEDS DEPUTY DIRECTOR	CPT2	FB1	PT1	PT1	PT1	PT1	ACP1	
120A	STORAGE	CPT2	FB1	PT1	PT1	PT1	PT1	ACP1	
121	CEDS ASSISTANT	CPT1	FB1	PT1	PT1	PT1	PT1	ACP1	
125	SNACK / SODA VENDING MACHINE	RT1	FB3	PT1	PT1	PT1	PT1	ACP1	
160	ZONING OPEN OFFICE	EXIST	EXIST	PT1	PT1	PT1	PT1	ACP1	
164	ZONING OPEN OFFICE	EXIST	EXIST	PT1	PT1	PT1	PT1	ACP1	
165	PRITING AREA	LVT1	EXIST	PT1	PT1	PT1	PT1	ACP1	
170	ZONING PLAN ROOM	LVT1	EXIST	PT1	PT1	PT1	PT1	ACP1	


FINISHES LISTED BELOW ARE BASIS OF DESIGN, SUBSTITUTIONS MUST MATCH THE SELECTED COLOR WAY AND HAVE A SIMILAR PATTERN.

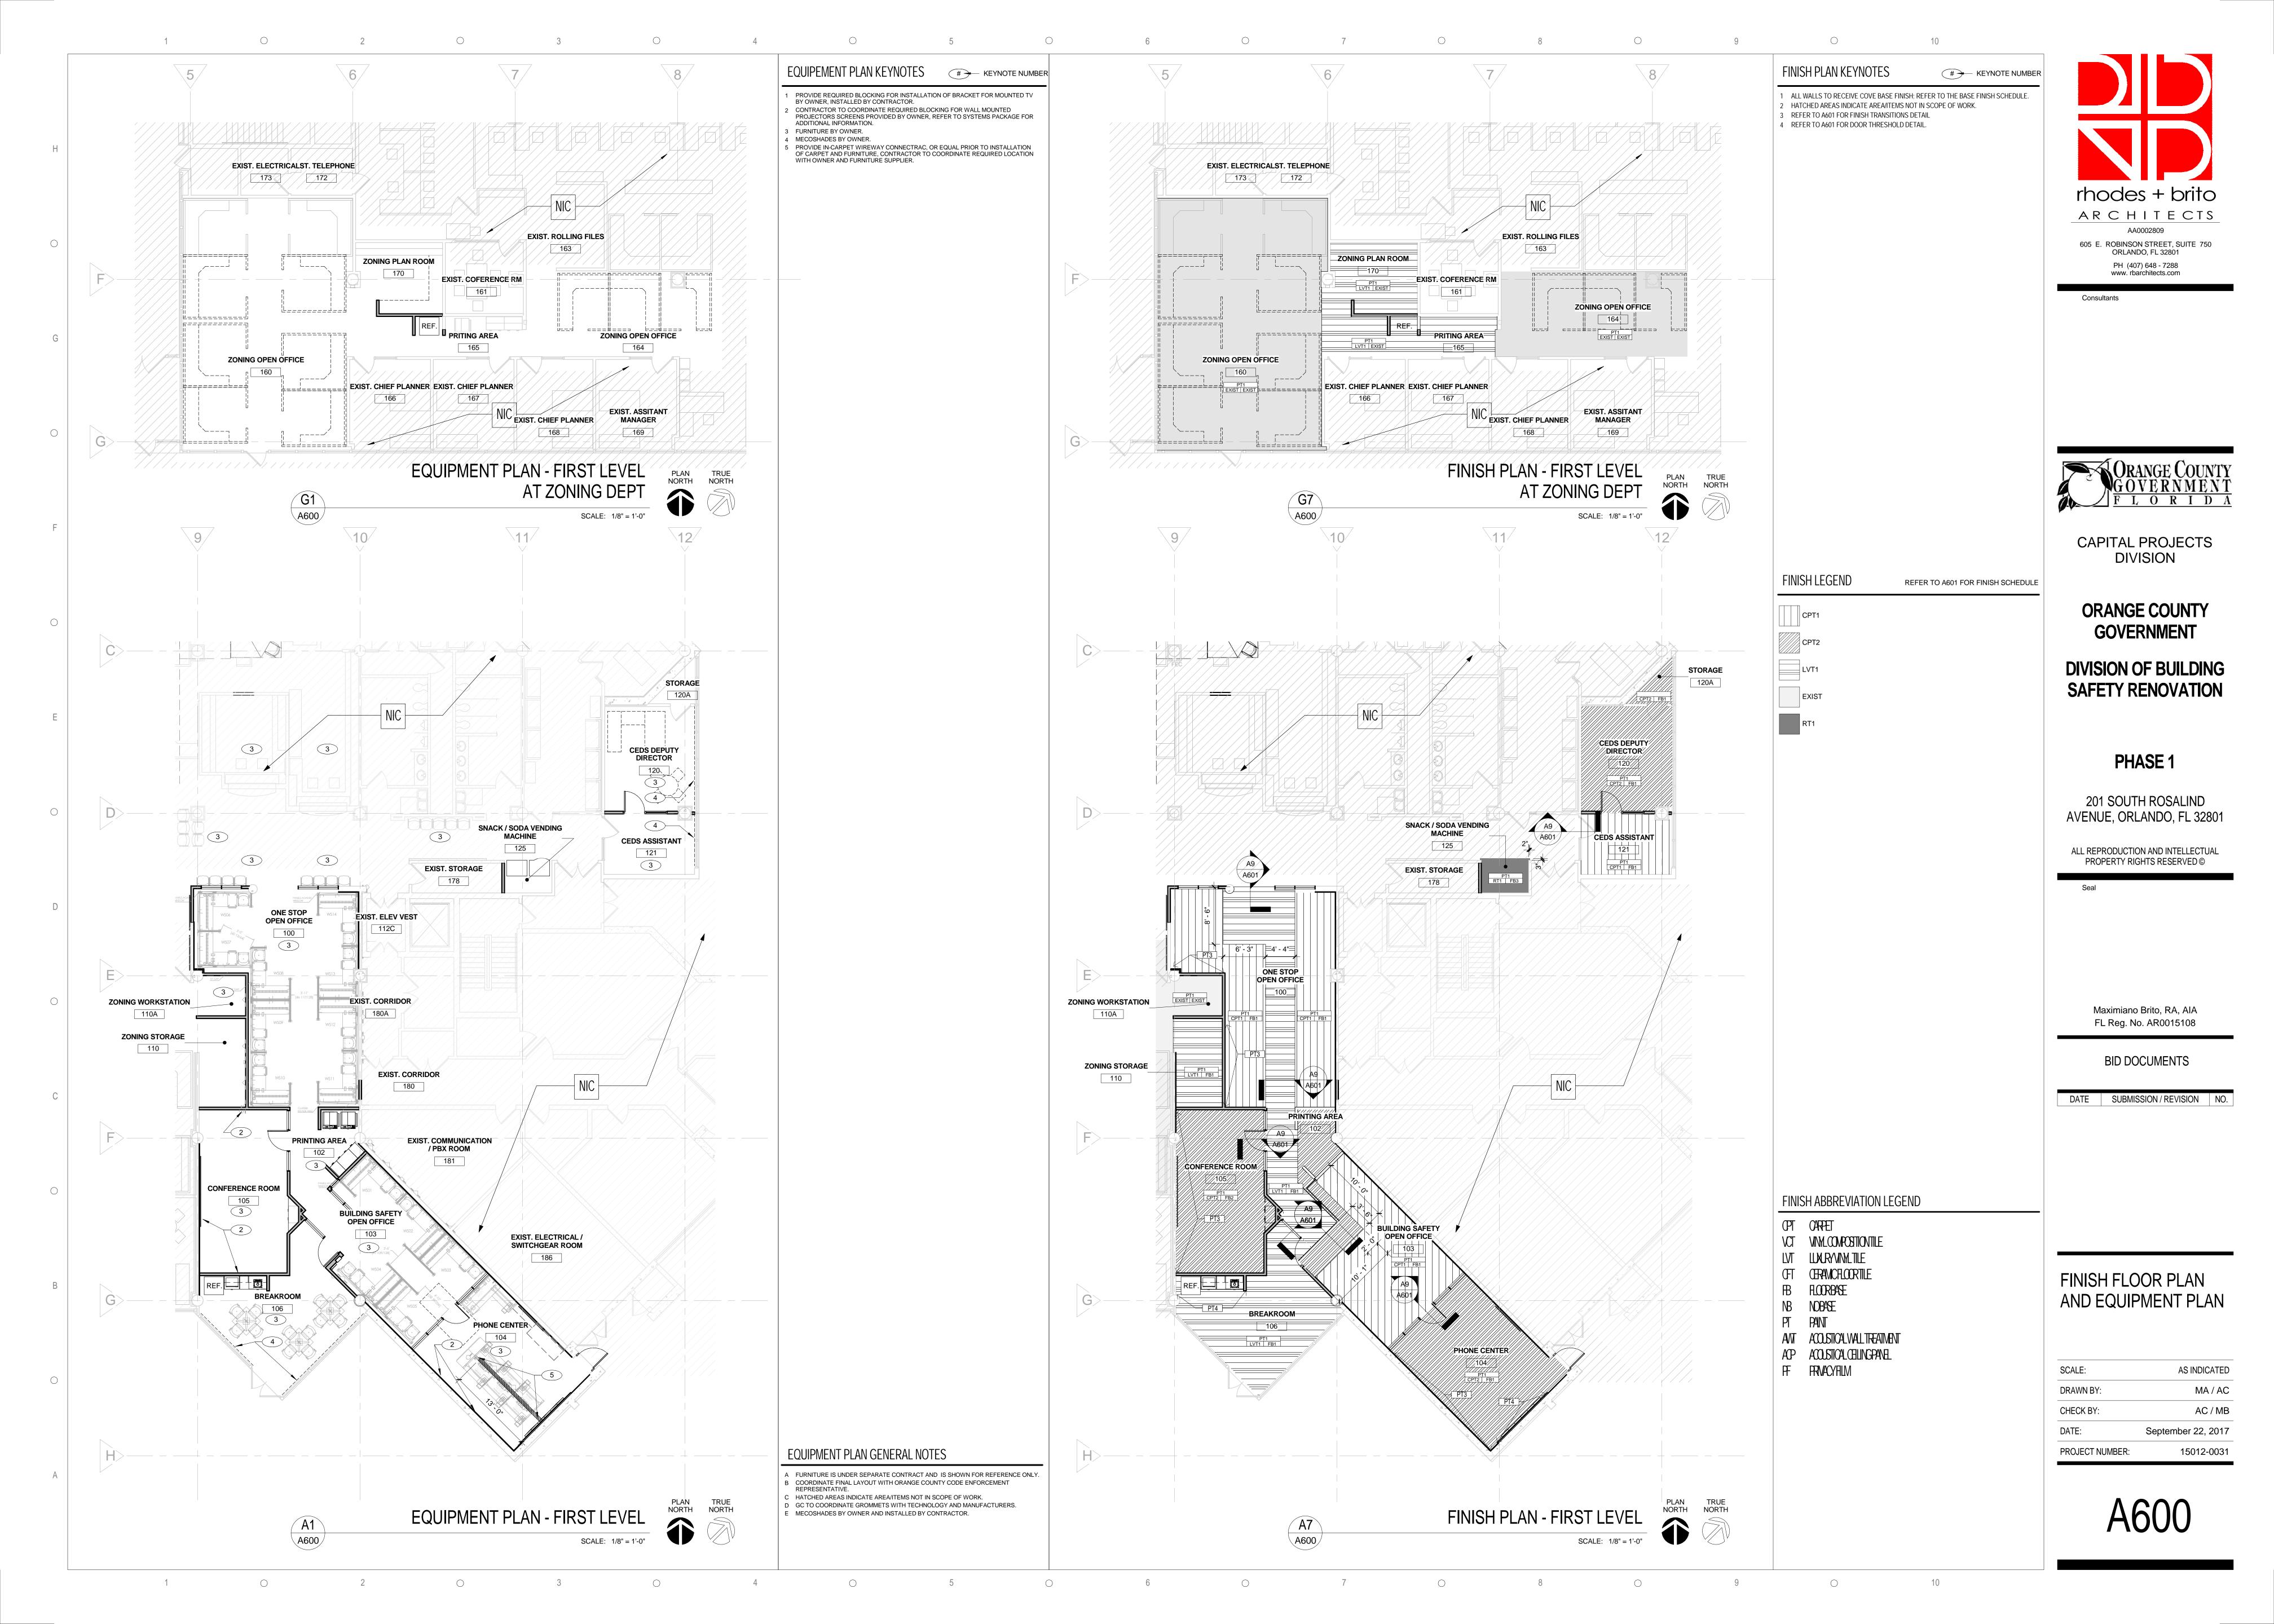ALL SUBSTITUTIONS MUST BE REVIEWED AND APPROVED BY ORANGE COUNTY CAPITAL PROJECTS AND ORANGE COUNTY PROCUREMENT DIVISION.

FLOOR BASE



ACOUSTICAL CEILING PANEL

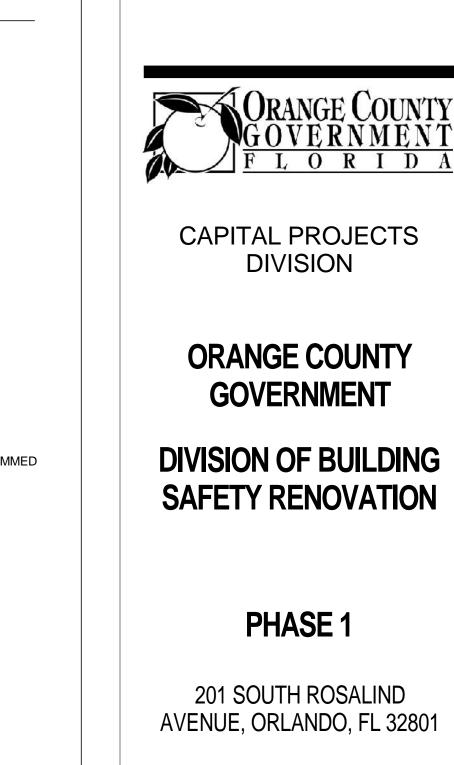

AA0002809

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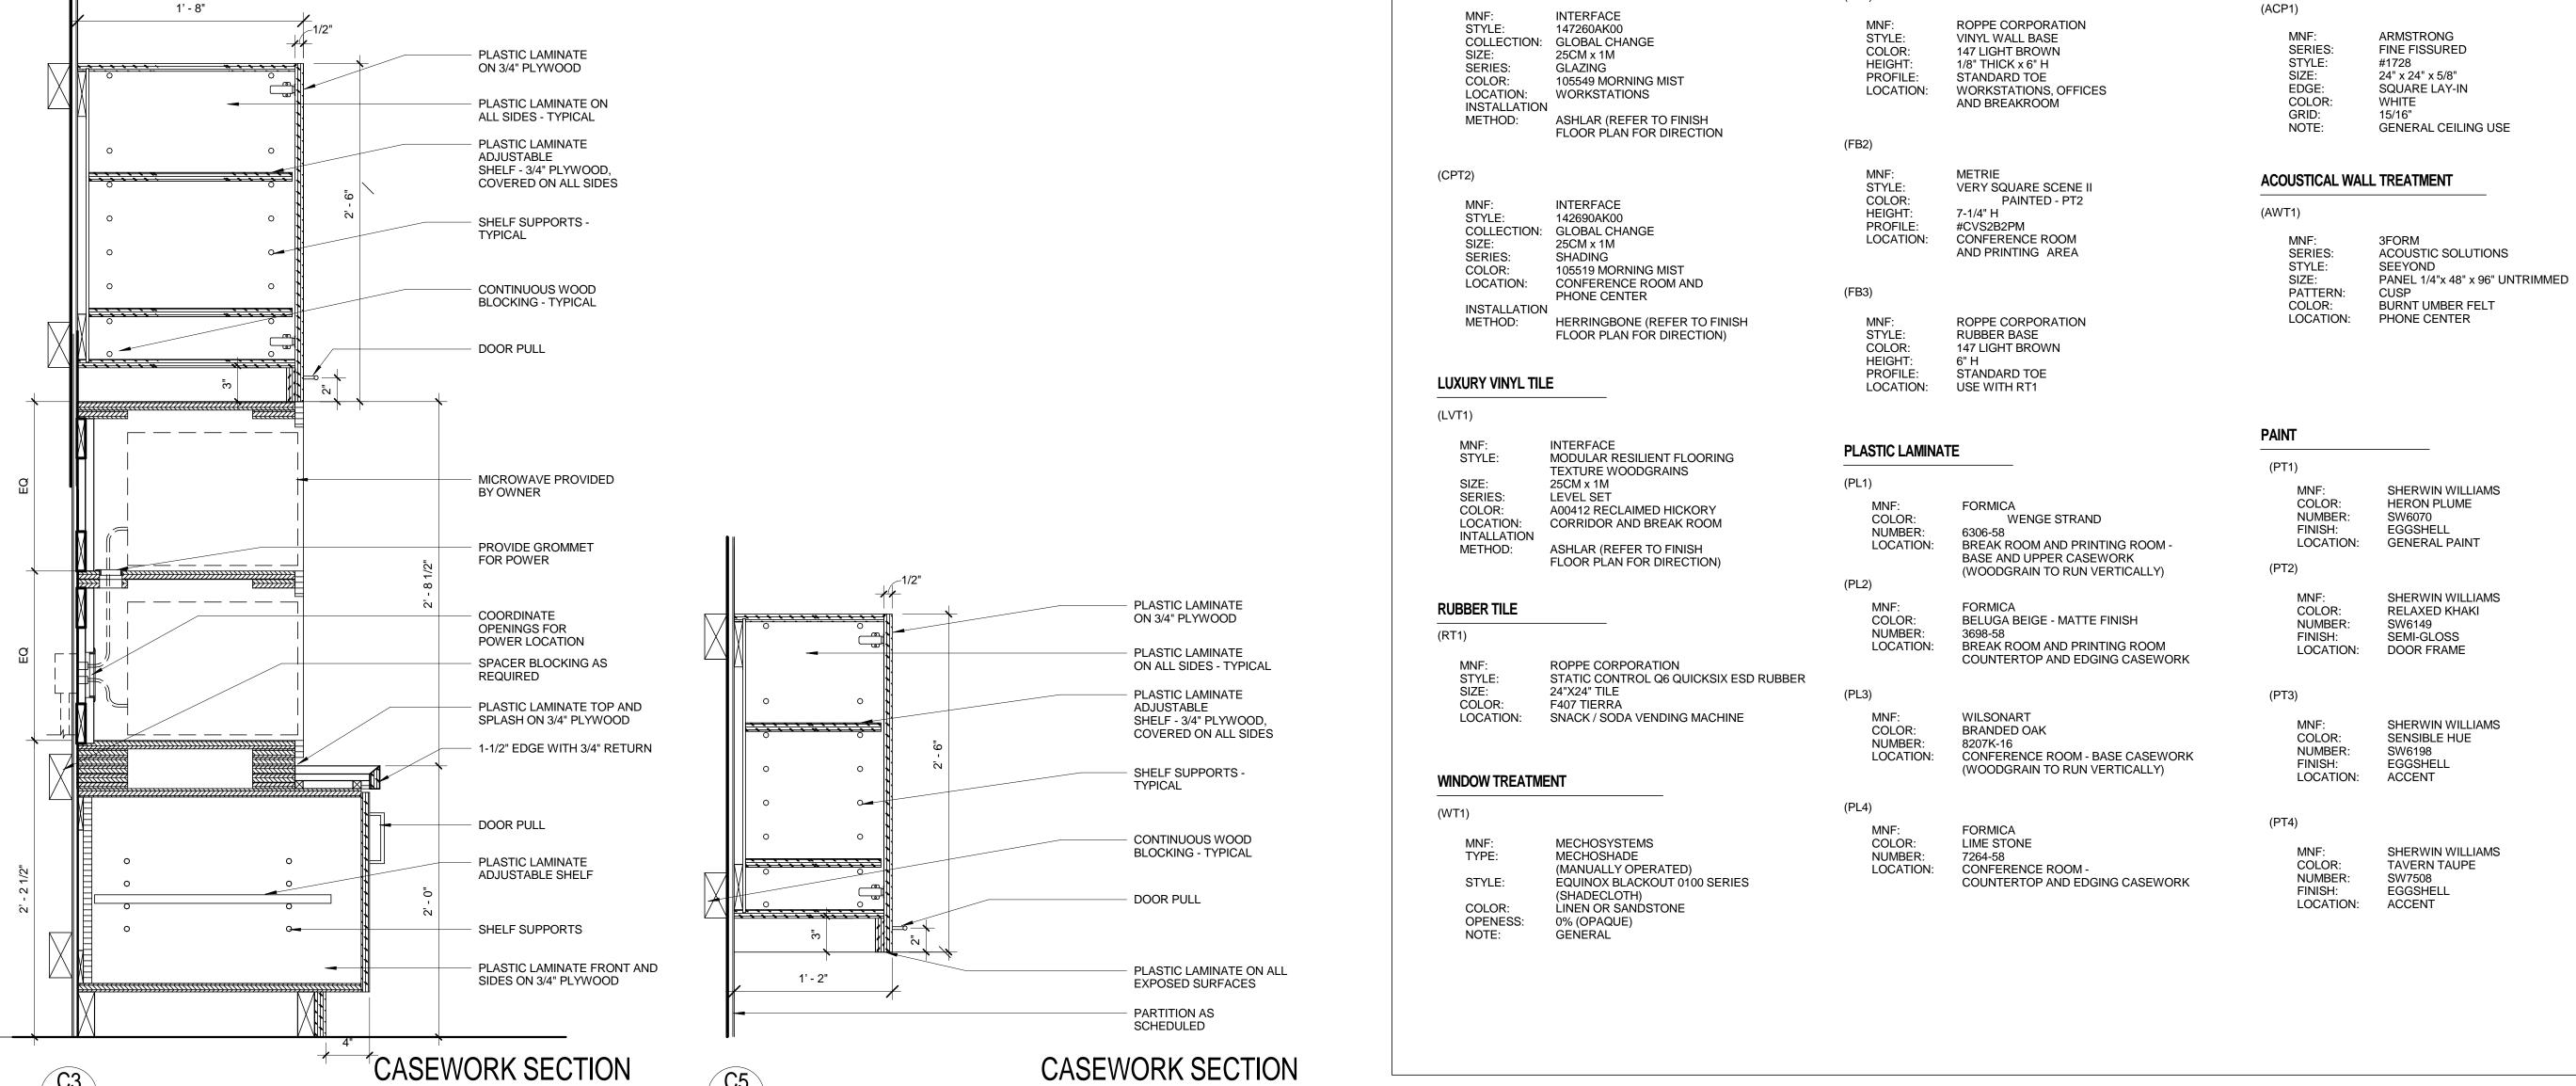
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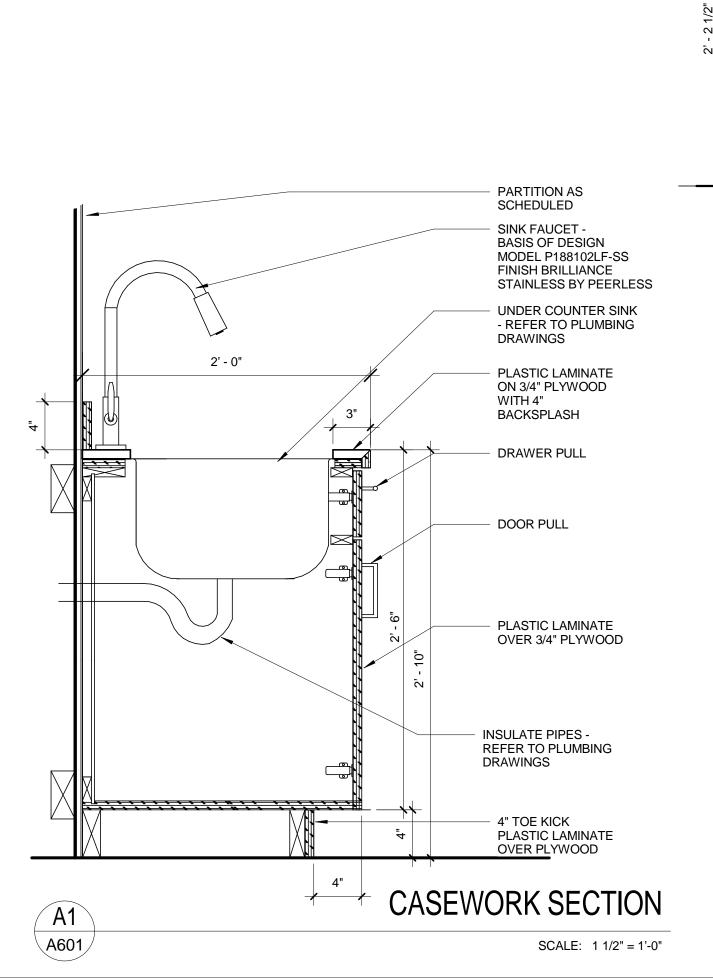
FINISH SCHEDULE AND	
CASEWORK DETAILS	


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DATE:	September 22, 2017
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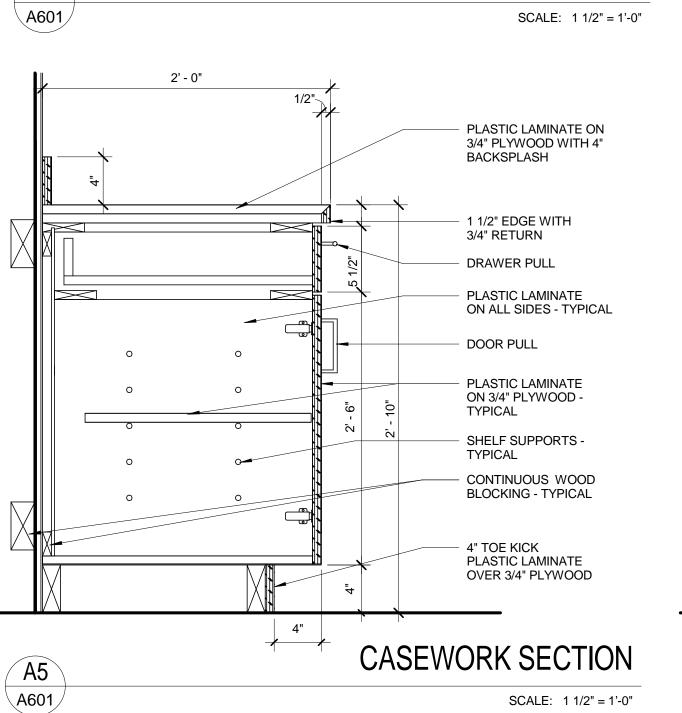


FINISH SCHEDULE LIST


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A601

CARPET (SEE FINSH SCHEDULE) -

RUBBER CARPET JOINER (MATCH ADJACENT BASE COLOR) —

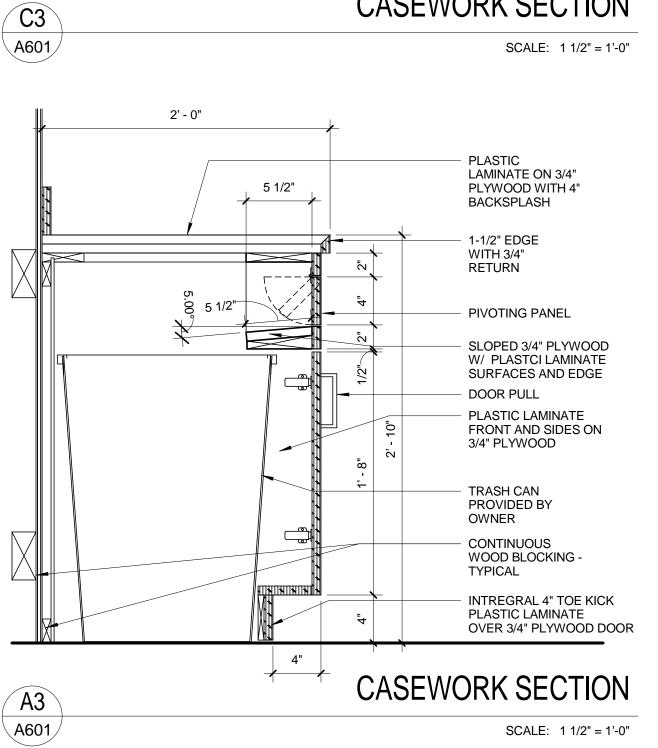
SCALE: 6" = 1'-0"

LUXURY VINYL TILE

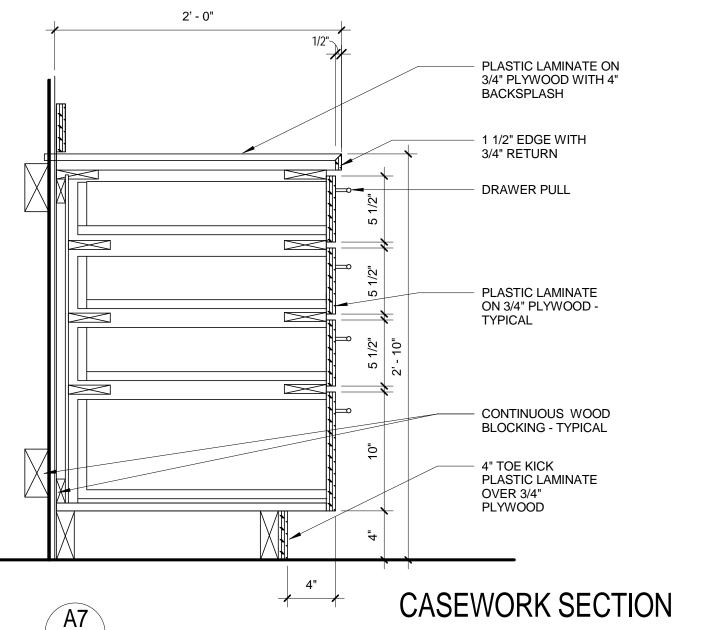(SEE FINISH SCHEDULE) -

OR RUBER TILE

SCALE: 1 1/2" = 1'-0"

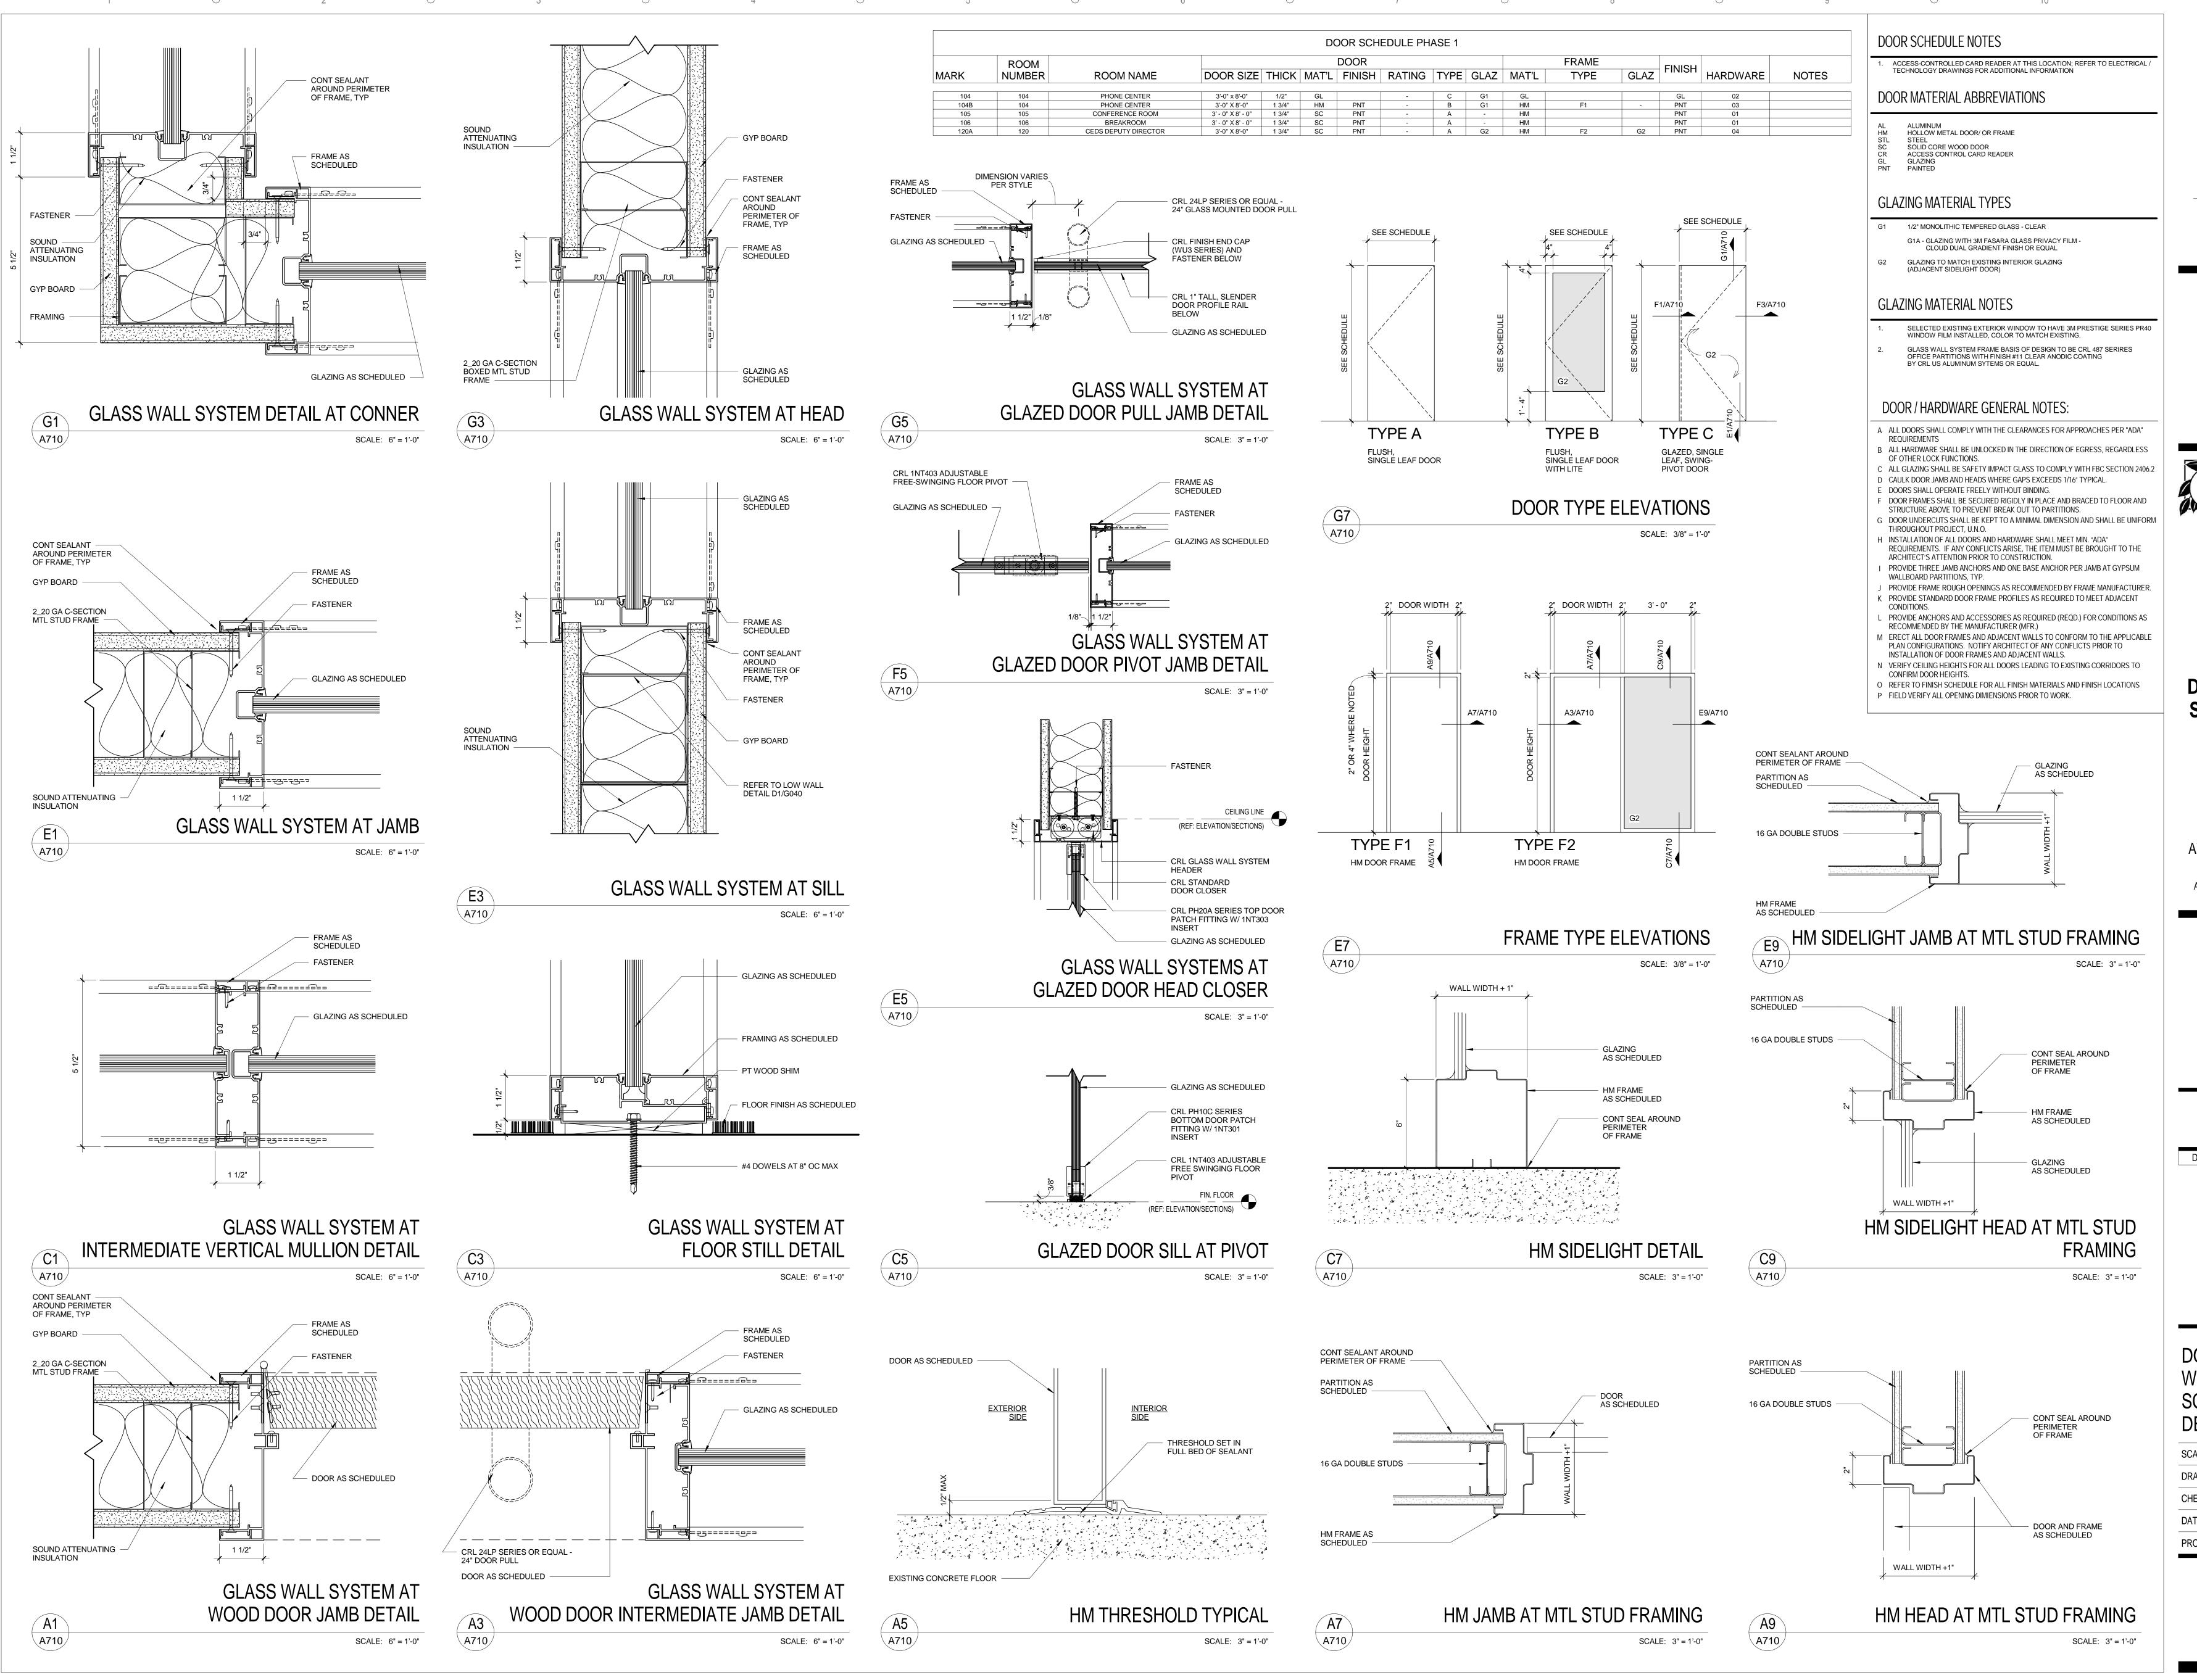



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Consultants

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CAPITAL PROJECTS DIVISION

ORANGE COUNTY GOVERNMENT

DIVISION OF BUILDING SAFETY RENOVATION

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DATE SUBMISSION / REVISION NO.

DOOR AND GLASS WALL SYSTEM -SCHEDULE AND DETAILS

SCALE: AS INDICATED


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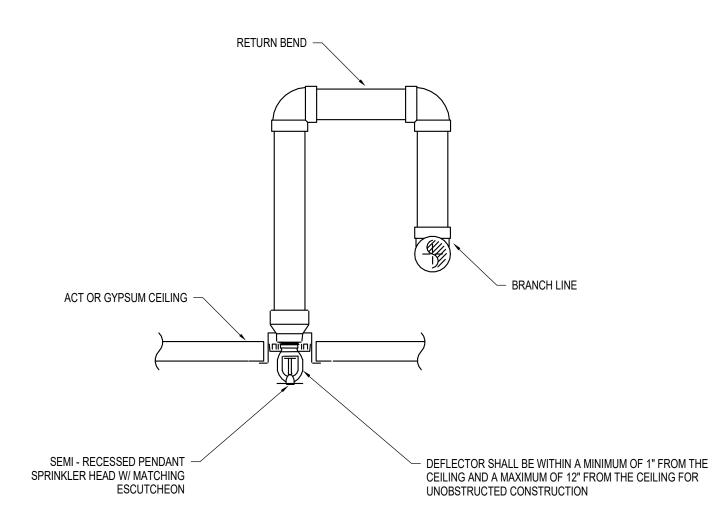
DATE: September 22, 2017

PROJECT NUMBER: 15012-0031

A710



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2 SEMI RECESSED PENDANT SPRINKLER HEAD DETAIL SCALE: NOT TO SCALE

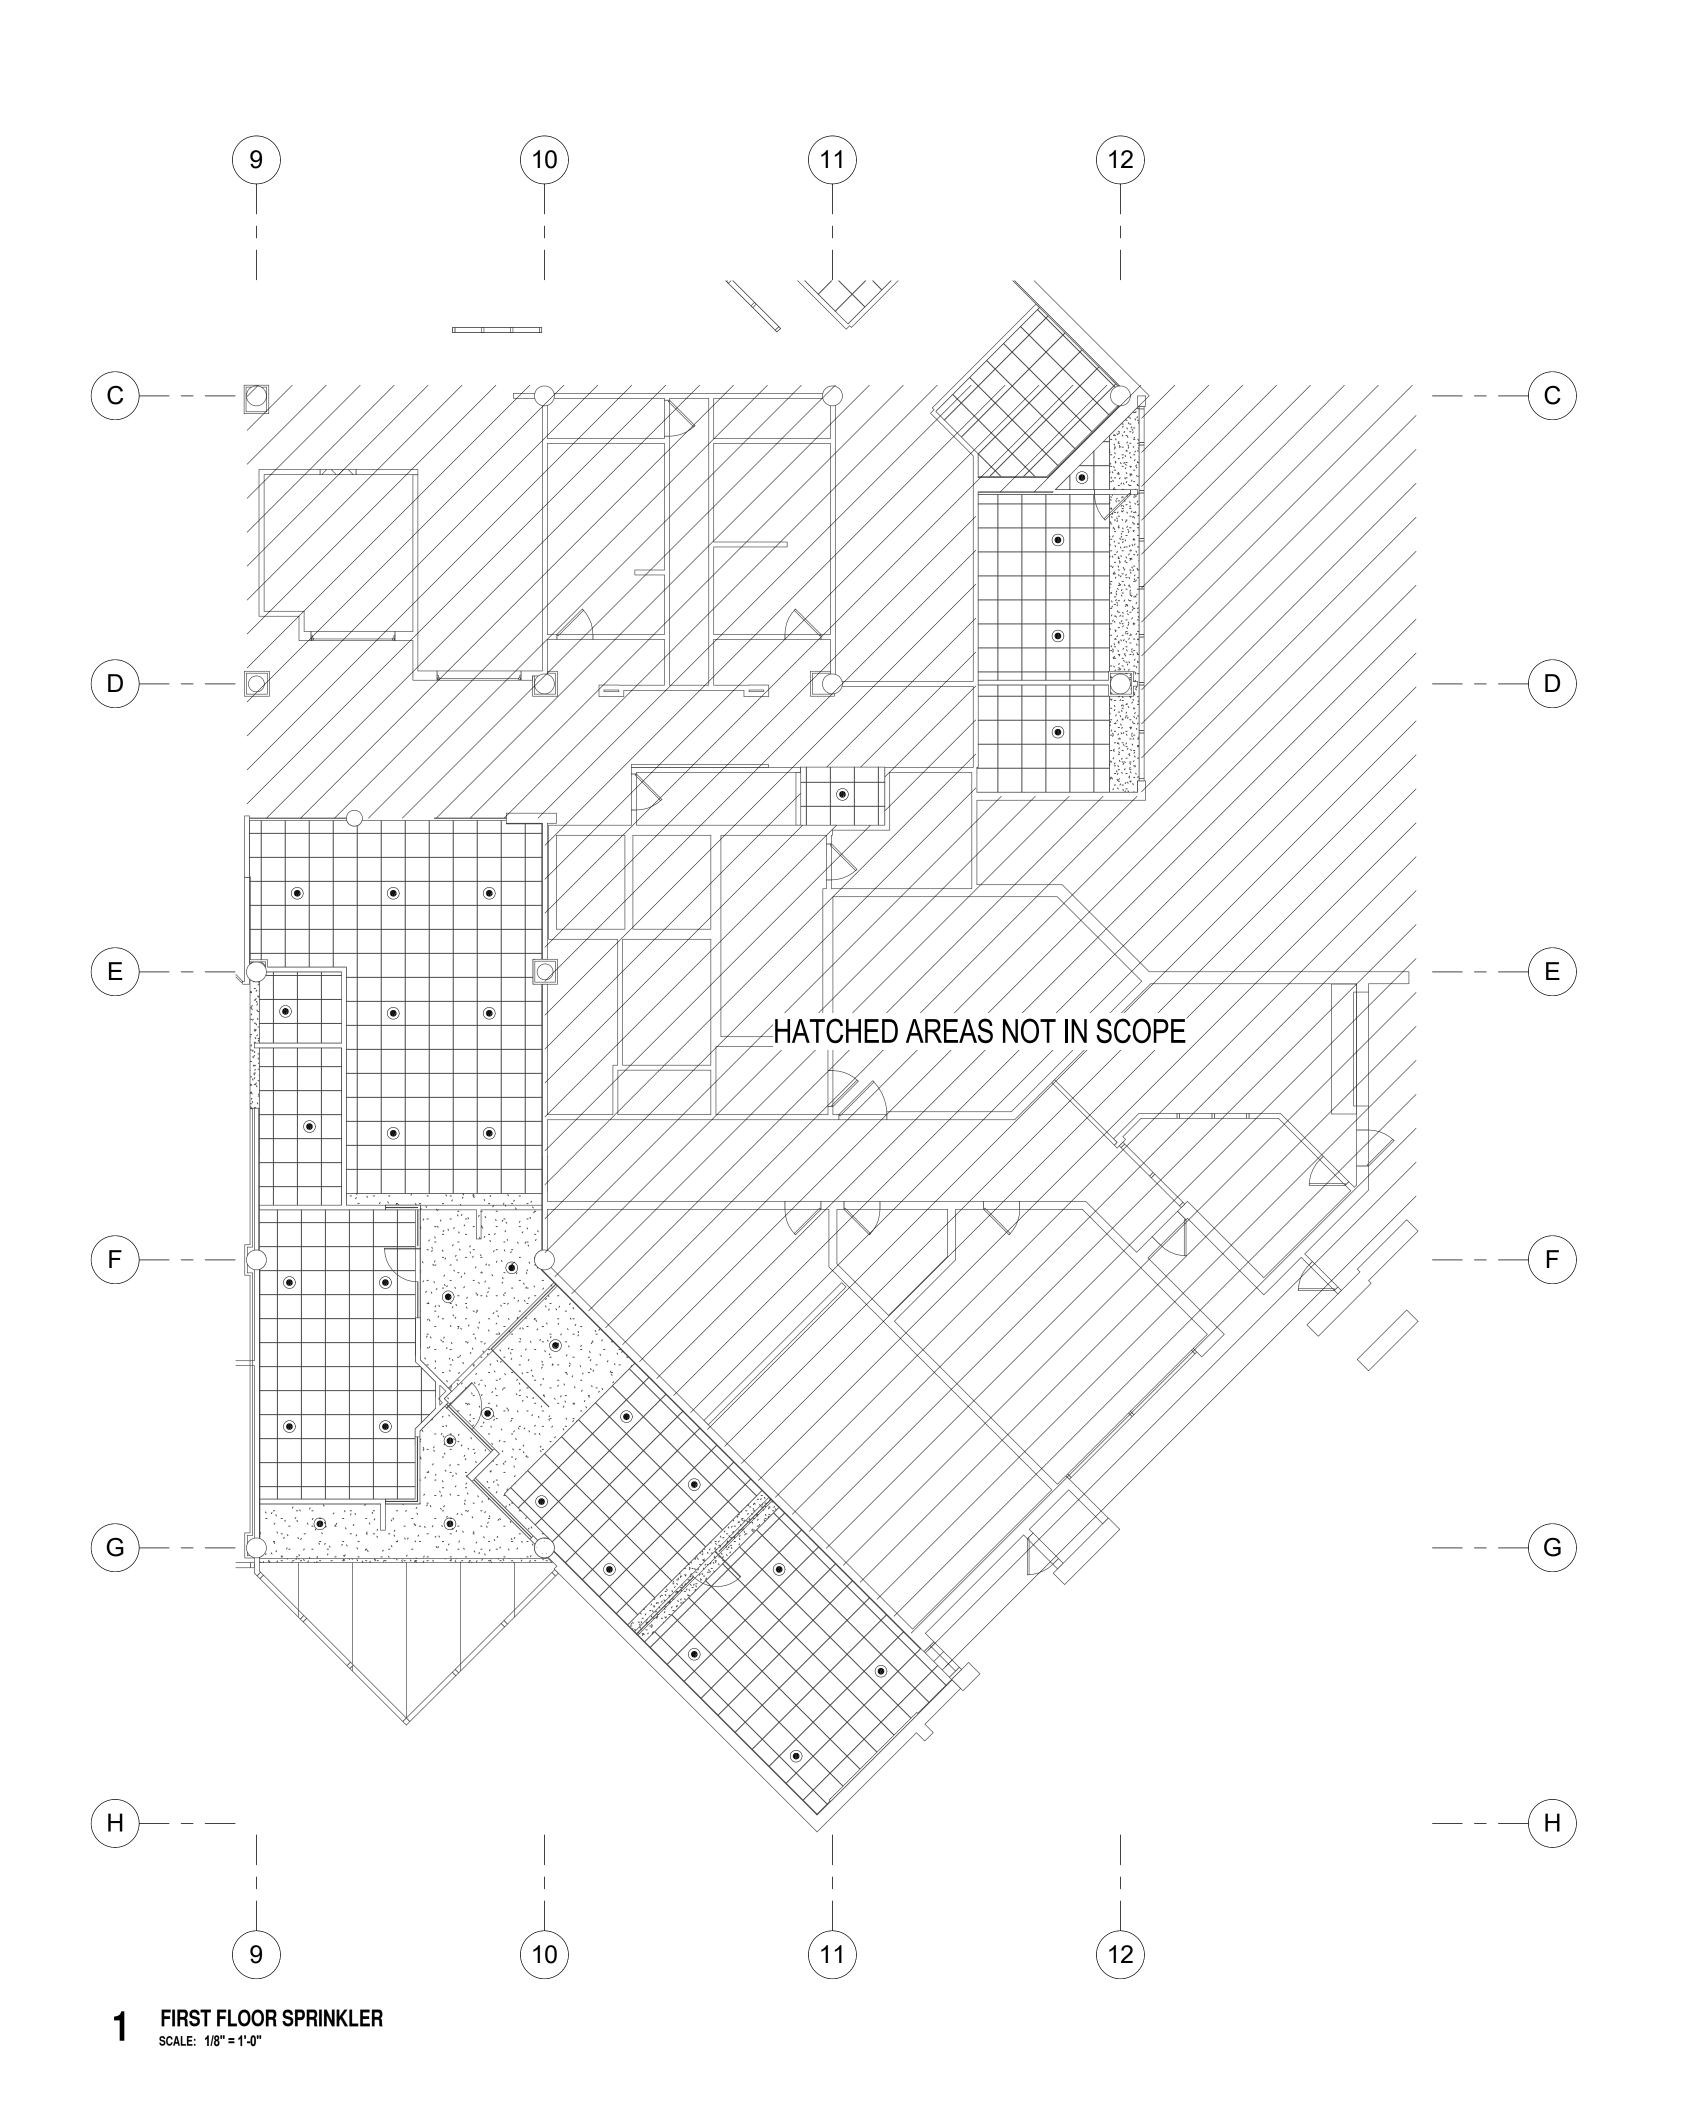SPRINKLER SYSTEM GENERAL NOTES:

WITH NFPA 13 AND THE FIRE FIRE PREVENTION CODE, 5TH EDITION.
CONTRACTOR IS RESPONSIBLE FOR FINAL SPRINKLER SYSTEM PIPE LAYOUT
AND SIZING, SPRINKLER HYDRAULIC CALCULATIONS AND COORDINATION WITH
OTHER TRADES. CONTRACTOR SHALL PROVIDE ALL MATERIALS REQUIRED FOR
A FULLY OPERATIONAL SPRINKLER SYSTEM.

2. CONTRACTOR SHALL CONDUCT FLOW TESTING TO OBTAIN BASELINE WATER
SUPPLY INFORMATION FOR SYSTEM INSTALLATION DRAWINGS.

3. SPRINKLER SYSTEM HYDRAULIC CALCULATIONS SHALL INCORPORATE A

SPRINKLER SYSTEM SHALL BE DESIGNED AND INSTALLED IN ACCORDANCE

SPRINKLER SYSTEM HYDRAULIC CALCULATIONS SHALL INCORPORATE A
MINIMUM 10% SAFETY FACTOR.
 ALL SPRINKLERS IN AREAS WITH ACCOUSTIC CEILING TILE SHALL BE MOUNTED
CENTER OF TILE IN TWO DIRECTIONS. COORDINATE WITH ARCHITECTURAL
DRAWINGS FOR CEILING FINISHES/TYPES.
 SPRINKLERS SHALL BE QUICK RESPONSE TYPE UNLESS OTHERWISE NOTED.

ALL PENETRATIONS THROUGH FIRE RATED PARTITIONS SHALL BE

APPROPRIATELY FIRE STOPPED AS SPECIFIED AND DETAILED. SPRINKLER SYSTEM IMPAIRMENT NOTES:

PRIOR TO REMOVING ANY FIRE PROTECTION SYSTEM FROM SERVICE THE FIRE PROTECTION CONTRACTOR SHALL NOTIFY THE OWNER, LOCAL FIRE DEPARTMENT AND CODE ENFORCEMENT OFFICIAL IN WRITING A MINIMUM OF 48 HOURS BEFORE HAND THAT THE SYSTEM IS TO BE REMOVED FROM SERVICE. THE NOTIFICATION SHALL INCLUDE THE DATE AND TIME THE SYSTEM WILL BE REMOVED FROM SERVICE AND THE PROJECTED DATE AND TIME THE SYSTEM WILL BE RESTORED.

DURING ANY FIRE PROTECTION SYSTEM OUTAGES THE BUILDING SHALL BE PROVIDED WITH A FIRE WATCH AS REQUIRED BY THE FIRE CODE OF FLORIDA. THE SOLE RESPONSIBILITY OF THE INDIVIDUAL ASSIGNED TO THE WATCH SHALL BE TO PERFORM CONSTANT PATROLS OF THE IMPAIRED AREA TO KEEP WATCH FOR FIRES. THE FIRE WATCH SHALL BE PROVIDED WITH AN APPROVED MEANS OF NOTIFICATION FOR THE FIRE DEPARTMENT.

THE FIRE DEPARTMENT CONNECTION SHALL BE AFFIXED WITH A OUT OF SERVICE SIGN WHENEVER THE SPRINKLER SYSTEM MAIN CONTROL VALVE IS CLOSED. THE SIGN SHALL BE PROVIDED, INSTALLED AND POLICED BY THE FIRE PROTECTION CONTRACTOR.

ALL FIRE PROTECTION SYSTEM IMPAIRMENTS SHALL OCCUR IN ACCORDANCE WITH THE FLORIDA FIRE PREVENTION CODE, 5TH EDITION.

THE FLORIDA FIRE PREVENTION CODE, 5TH EDITION.
THE SYSTEM IMPAIRMENT FOR THE RENOVATION SHALL BE CONDUCTED AS A PREPLANNED IMPAIRMENT. TO MINIMIZE THE IMPAIRMENT TIME ALL NECESSARY TOOLS
AND MATERIALS SHALL BE ASSEMBLED ONSITE PRIOR TO REMOVING THE SYSTEM
FROM SERVICE.
WITHIN 24 HOURS OF RESTORING ANY FIRE PROTECTION SYSTEM TO SERVICE THE
FIRE PROTECTION CONTRACTOR SHALL PROVIDE IN WRITING TO THE OWNER,

LOCAL FIRE DEPARTMENT AND CODE ENFORCEMENT OFFICIAL CERTIFICATION THAT THE FOLLOWING HAS BEEN IMPLEMENTED:

A. ALL INSPECTIONS AND TEST HAVE BEEN COMPLETED TO INSURE THE AFFECTED SYSTEM IS OPERATIONAL.

B. THE IMPAIRMENT TAG HAS BEEN REMOVED
 C. THE OWNER AND OR OCCUPANT HAVE BEEN INSTRUCTED ON THE OPERATION OF THE SYSTEM.
 D. THE THIRD PARTY MONITORING COMPANY HAS BEEN ADVISED

THAT THE SYSTEM IS IN SERVICE.

GENERAL SPECIFICATIONS

A. GENERAL: THE WORK COVERED CONSISTS OF FURNISHING ALL LABOR AND MATERIALS NECESSARY TO INSTALL, COMPLETE AND READY FOR CONTINUOUS OPERATION, THE FIRE PROTECTION SYSTEMS, APPARATUS AND EQUIPMENT FOR THE WET PIPE SPRINKLER SYSTEM PROTECTING THE INDICATED AREAS.

B. SHOP DRAWINGS: SHOP DRAWINGS OF ALL SPECIFIED EQUIPMENT AND APPARATUS SHALL BE SUBMITTED TO THE ENGINEER OF RECORD FOR APPROVAL.

C. CODES: ALL EQUIPMENT AND MATERIALS FURNISHED UNDER THE FIRE PROTECTION SUB-CONTRACT AND LABOR AND TESTING PERFORMED HEREIN SHALL BE IN COMPLETE ACCORDANCE WITH THE FLORIDA BUILDING CODE 5TH ED, LOCAL ORDINANCES, NATIONAL FIRE PROTECTION ASSOCIATION (NFPA) AND INSURANCE REGULATIONS AND REQUIREMENTS GOVERNING SUCH WORK.

D. PERMITS: ANY AND ALL PERMITS REQUIRED FOR INSTALLATION OF ANY MATERIAL

SHALL BE OBTAINED AS PART OF THE WORK OF THE SPECIFICATION INCLUDING ALL FEES OR EXPENSES INCURRED.

E. INSTRUCTIONS: DURING THE ASSEMBLY AND INSTALLATION OF ALL FIRE PROTECTION SYSTEMS, THE OWNER'S OPERATING PERSONNEL SHALL BE

INSTRUCTED REGARDING ITS OPERATION AND MAINTENANCE. A ONE (1) DAY INSTRUCTION PERIOD SHALL BE PROVIDED AFTER COMPLETION OF PROJECT. OPERATION AND MAINTENANCE MANUALS SHALL BE REQUIRED.

F. GUARANTEE: ALL MATERIALS AND EQUIPMENT FURNISHED AND INSTALLED SHALL BE GUARANTEED IN WRITING FOR ONE (1) YEAR FROM THE DATE OF ACCEPTANCE OF THE BUILDING BY THE OWNER.

OF THE BUILDING BY THE OWNER.

G. SHOP DRAWINGS: THE FIRE PROTECTION SUBCONTRACTOR SHALL MAINTAIN AT THE JOB, AT ALL TIMES, A COMPLETE AND SEPARATE SET OF BLACKLINE PRINTS OF THE FIRE PROTECTION DRAWINGS OF THEIR TRADE ON WHICH THEY SHALL MARK CLEARLY, NEATLY, ACCURATELY AND PROMPTLY AS THE WORK PROGRESSES. TWO SETS OF "AS-BUILT" DRAWINGS SHALL BE FURNISHED BY THE FIRE PROTECTION SUBCONTRACTOR AT THE JOB COMPLETION. THE FIRE PROTECTION CONTRACTOR'S DESIGN ENGINEER SHALL CERTIFY THAT THE COMPLETED INSTALLATION COMPLIES WITH ALL APPLICABLE CODES AND UNDERWRITERS' REQUIREMENTS

REQUIREMENTS.

H. INSPECTION: ALL WORK SHALL BE SUBJECT TO THE INSPECTION OF THE OWNER, THE ARCHITECT AND SUCH OTHER INSPECTORS HAVING JURISDICTION. A PROPERLY EXECUTED CERTIFICATE OF INSPECTION SHALL BE PROVIDED.

I. EXAMINATION OF SITE: THE FIRE PROTECTION SUBCONTRACTOR, BEFORE SUBMITTING PRICES OR BEGINNING WORK, SHALL THOROUGHLY EXAMINE THE SITE AND CONTRACT DOCUMENTS. NO CLAIM FOR EXTRA COMPENSATION WILL BE RECOGNIZED IF DIFFICULTIES WHICH AN EXAMINATION OF SITE CONDITIONS AND CONTRACT DOCUMENTS PRIOR TO EXECUTING CONTRACT WOULD HAVE REVEALED.

J. COORDINATION: COORDINATE ALL WORK INSTALLED UNDER THIS SPECIFICATION WITH THAT OF ALL OTHER TRADES.
 K. PROTECTION OF PROPERTY: PROTECT ALL NEW AND EXISTING WORK BEFORE, DURING AND AFTER INSTALLATION.

L. TESTS: THE FIRE PROTECTION SUBCONTRACTOR SHALL PERFORM ALL TESTS IN ACCORDANCE WITH NFPA AT THE COMPLETION OF THE WORK AND THE RESULTS FURNISHED TO THE OWNER AND ARCHITECT IN WRITING.

M. CERTIFICATES OF APPROVAL: UPON COMPLETION OF ALL WORK, THE FIRE PROTECTION SUBCONTRACTOR SHALL FURNISH, IN DUPLICATE, CERTIFICATES OF INSPECTIONS FROM ALL INSPECTORS AND AUTHORITIES HAVING JURISDICTION, NOTARIZED LETTERS FROM THE MANUFACTURERS STATING THAT AUTHORIZED FACTORY ENGINEERS HAVE INSPECTED AND TESTED THE INSTALLATION OF THEIR RESPECTIVE SYSTEMS AND FOUND SAME TO BE IN PERFECT OPERATING

CONDITION.

CONTRACT DRAWINGS: THE CONTRACT DRAWINGS ARE DIAGRAMMATIC AND INDICATE ONLY THE GENERAL ARRANGEMENTS OF WORK. IT IS NOT THE INTENT OF THESE DRAWINGS TO SHOW EVERY PIPE, RISE, DROP, ELBOW, ETC. ANY ADDITIONAL WORK NOT SHOWN AND REQUIRED TO INSTALL THE FIRE PROTECTION SYSTEMS SHALL BE INCLUDED AS PART OF THIS CONTRACT.

CONTINUITY OF SERVICES: SERVICES SHALL BE MAINTAINED IN ALL AREAS WHICH

WILL BE OCCUPIED DURING THE CONSTRUCTION PERIOD. IF AN INTERRUPTION OF SERVICE BECOMES NECESSARY, SUCH SHALL BE MADE ONLY UPON CONSENT OF THE OWNER AT A TIME OUTSIDE NORMAL WORKING HOURS AS HE SHALL DESIGNATE. REFER TO THE OVERALL SCHEDULING OF THE WORK OF THE PROJECT. SCHEDULE WORK TO CONFORM TO THIS SCHEDULE AND INSTALL WORK TO NOT DELAY NOR INTERFERE WITH THE PROGRESS OF THE PROJECT.

SCOPE

A. THE WORK OF THIS SECTION CONSISTS OF ALL LABOR, MATERIALS AND EQUIPMENT REQUIRED TO PROVIDE ALL FIRE PROTECTION WORK COMPLETE, IN PLACE, AS SHOWN ON THE DRAWINGS, SPECIFIED HEREIN AND AS NECESSARY FOR A PROPER INSTALLATION.

B. THE EXTENT OF THE FIRE PROTECTION SHALL INCLUDE, BUT NOT BE LIMITED TO THE

FOLLOWING:
B.1. COMPLETE AUTOMATIC WET PIPE FIRE SUPPRESSION SPRINKLER SYSTEM.
B.2. SHOP DRAWINGS AND HYDRAULIC CALCULATIONS.
B.3. SUBMITTALS AND ACCEPTANCE TESTING.

RELATED WORK

THE FOLLOWING EQUIPMENT ITEMS AND WORK SHALL NOT BE THE RESPONSIBILITY OF THIS CONTRACTOR:

A. TEMPORARY WATER, HEAT, FIRE PROTECTION AND TOILET FACILITIES

B. TEMPORARY POWER AND LIGHTING

C. FLASHING AND CAULKING

E. HEATING, VENTILATING AND AIR CONDITIONING
F. PLUMBING
C. FLECTRICAL POWER AND WIRING

G. ELECTRICAL POWER AND WIRING.

FINISH PAINTING

MATERIALS/PRODUCTS

PIPE AND FITTINGS:

A. SCHEDULE 40 BLACK STEEL PIPE WITH BLACK CAST IRON SCREWED SPRINKLER FITTINGS SUITABLE FOR 175 PSI WORKING PRESSURE

PIPE SLEEVES, HANGERS, AND SUPPORTS:

A. ALL PIPING SHALL BE PROPERLY SUPPORTED FROM BUILDING STRUCTURE IN ACCORDANCE WITH NFPA 13 AND THE MANUFACTURER'S RECOMMENDATIONS. PROVIDE SCHEDULE 40 STEEL SLEEVES, EXTEND 1 INCH ABOVE FLOOR, MAKE WATERTIGHT AND SEAL WITH MATERIAL THAT MAINTAINS FIRE RATING. PROVIDE CORE DRILLING WHERE REQUIRED AND PROVIDE FIRE RATED LINK SEAL PENETRATION CLOSURES.

SPRINKLERS:

A. SPRINKLERS SHALL BE GLASS BULB, QUICK RESPONSE TYPE, 155°F, 5.6K-FACTOR.

B. SPRINKLERS SHALL BE PENDENT TYPE TO MATCH EXISTING.

C. SPARE SPRINKLERS, CABINET AND WRENCH SHALL BE PROVIDED IN ACCORDANCE WITH NFPA 13.

WITH NFPA 13.

D. EXTENDED COVERAGE SPRINKLERS SHALL BE USED.

E. MANUFACTURER; TYCO, RELIABLE, VIKING OR APPROVED EQUAL.

PIPE IDENTIFICATION:

A. ALL FIRE PROTECTION PIPING SHALL BE LABELED AT EACH BRANCH, AT EACH PASSAGE THROUGH WALL AND AT INTERVALS OF NOT MORE THAN 20 FEET WITH SEMI-RIGID SETMARK PIPE MARKERS WITH ARROWS INDICATING THE DIRECTION OF

DESIGN CRITERIA:

A. LIGHT HAZARD 0.10 GPM/SQ.FT. OVER 1,500 SQ.FT.

B. ORDINARY HAZARD 0.15 GPM/SQ.FT. OVER 1,500 SQ.FT.

C. MAXIMUM PROTECTION AREA PER SPRINKLER SHALL NOT EXCEED 130 SQFT.

D. PROVIDE A 250 GPM HOSE ALLOWANCE

SPRINKLER SYSTEMS SHALL BE HYDRAULICALLY DESIGNED AND CALCULATED BY THE FIRE PROTECTION CONTRACTOR. THE FIRE PROTECTION CONTRACTOR SHALL SUBMIT ALL REQUIRED HYDRAULIC CALCULATIONS TO PROVE THE HYDRAULICALLY MOST REMOTE AREAS ARE BEING PROTECTED. FABRICATION DRAWINGS AND HYDRAULIC CALCULATIONS SHALL BE SUBMITTED AND STAMPED APPROVED BY THE ENGINEER OF RECORD AND INSURANCE UNDERWRITERS PRIOR TO INSTALLATION OF PIPING AND EQUIPMENT. MAINTAIN A MINIMUM OF 10 PSI SAFETY FACTOR BETWEEN THE REQUIRED PRESSURE AND AVAILABLE PRESSURE. COMPLY WITH ALL UNDERWRITERS' AND CODE AUTHORITIES REQUIREMENTS INCLUDING MAXIMUM WATER FLOW VELOCITY IN THE FIRE PROTECTION SYSTEM.

rhodes + brito

ARCHITECTS

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08/21/17

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BRYN R. CURRIE


BID DOCUMENTS

DATE SUBMISSION / REVISION NO.

FIRST FLOOR SPRINKLER

SCALE:	AS INDICATED
DRAWN BY:	R. PARSONS
CHECK BY:	B. CURRIE
DATE:	September 22, 2017
PROJECT NUMBER:	15012-0031

FP201

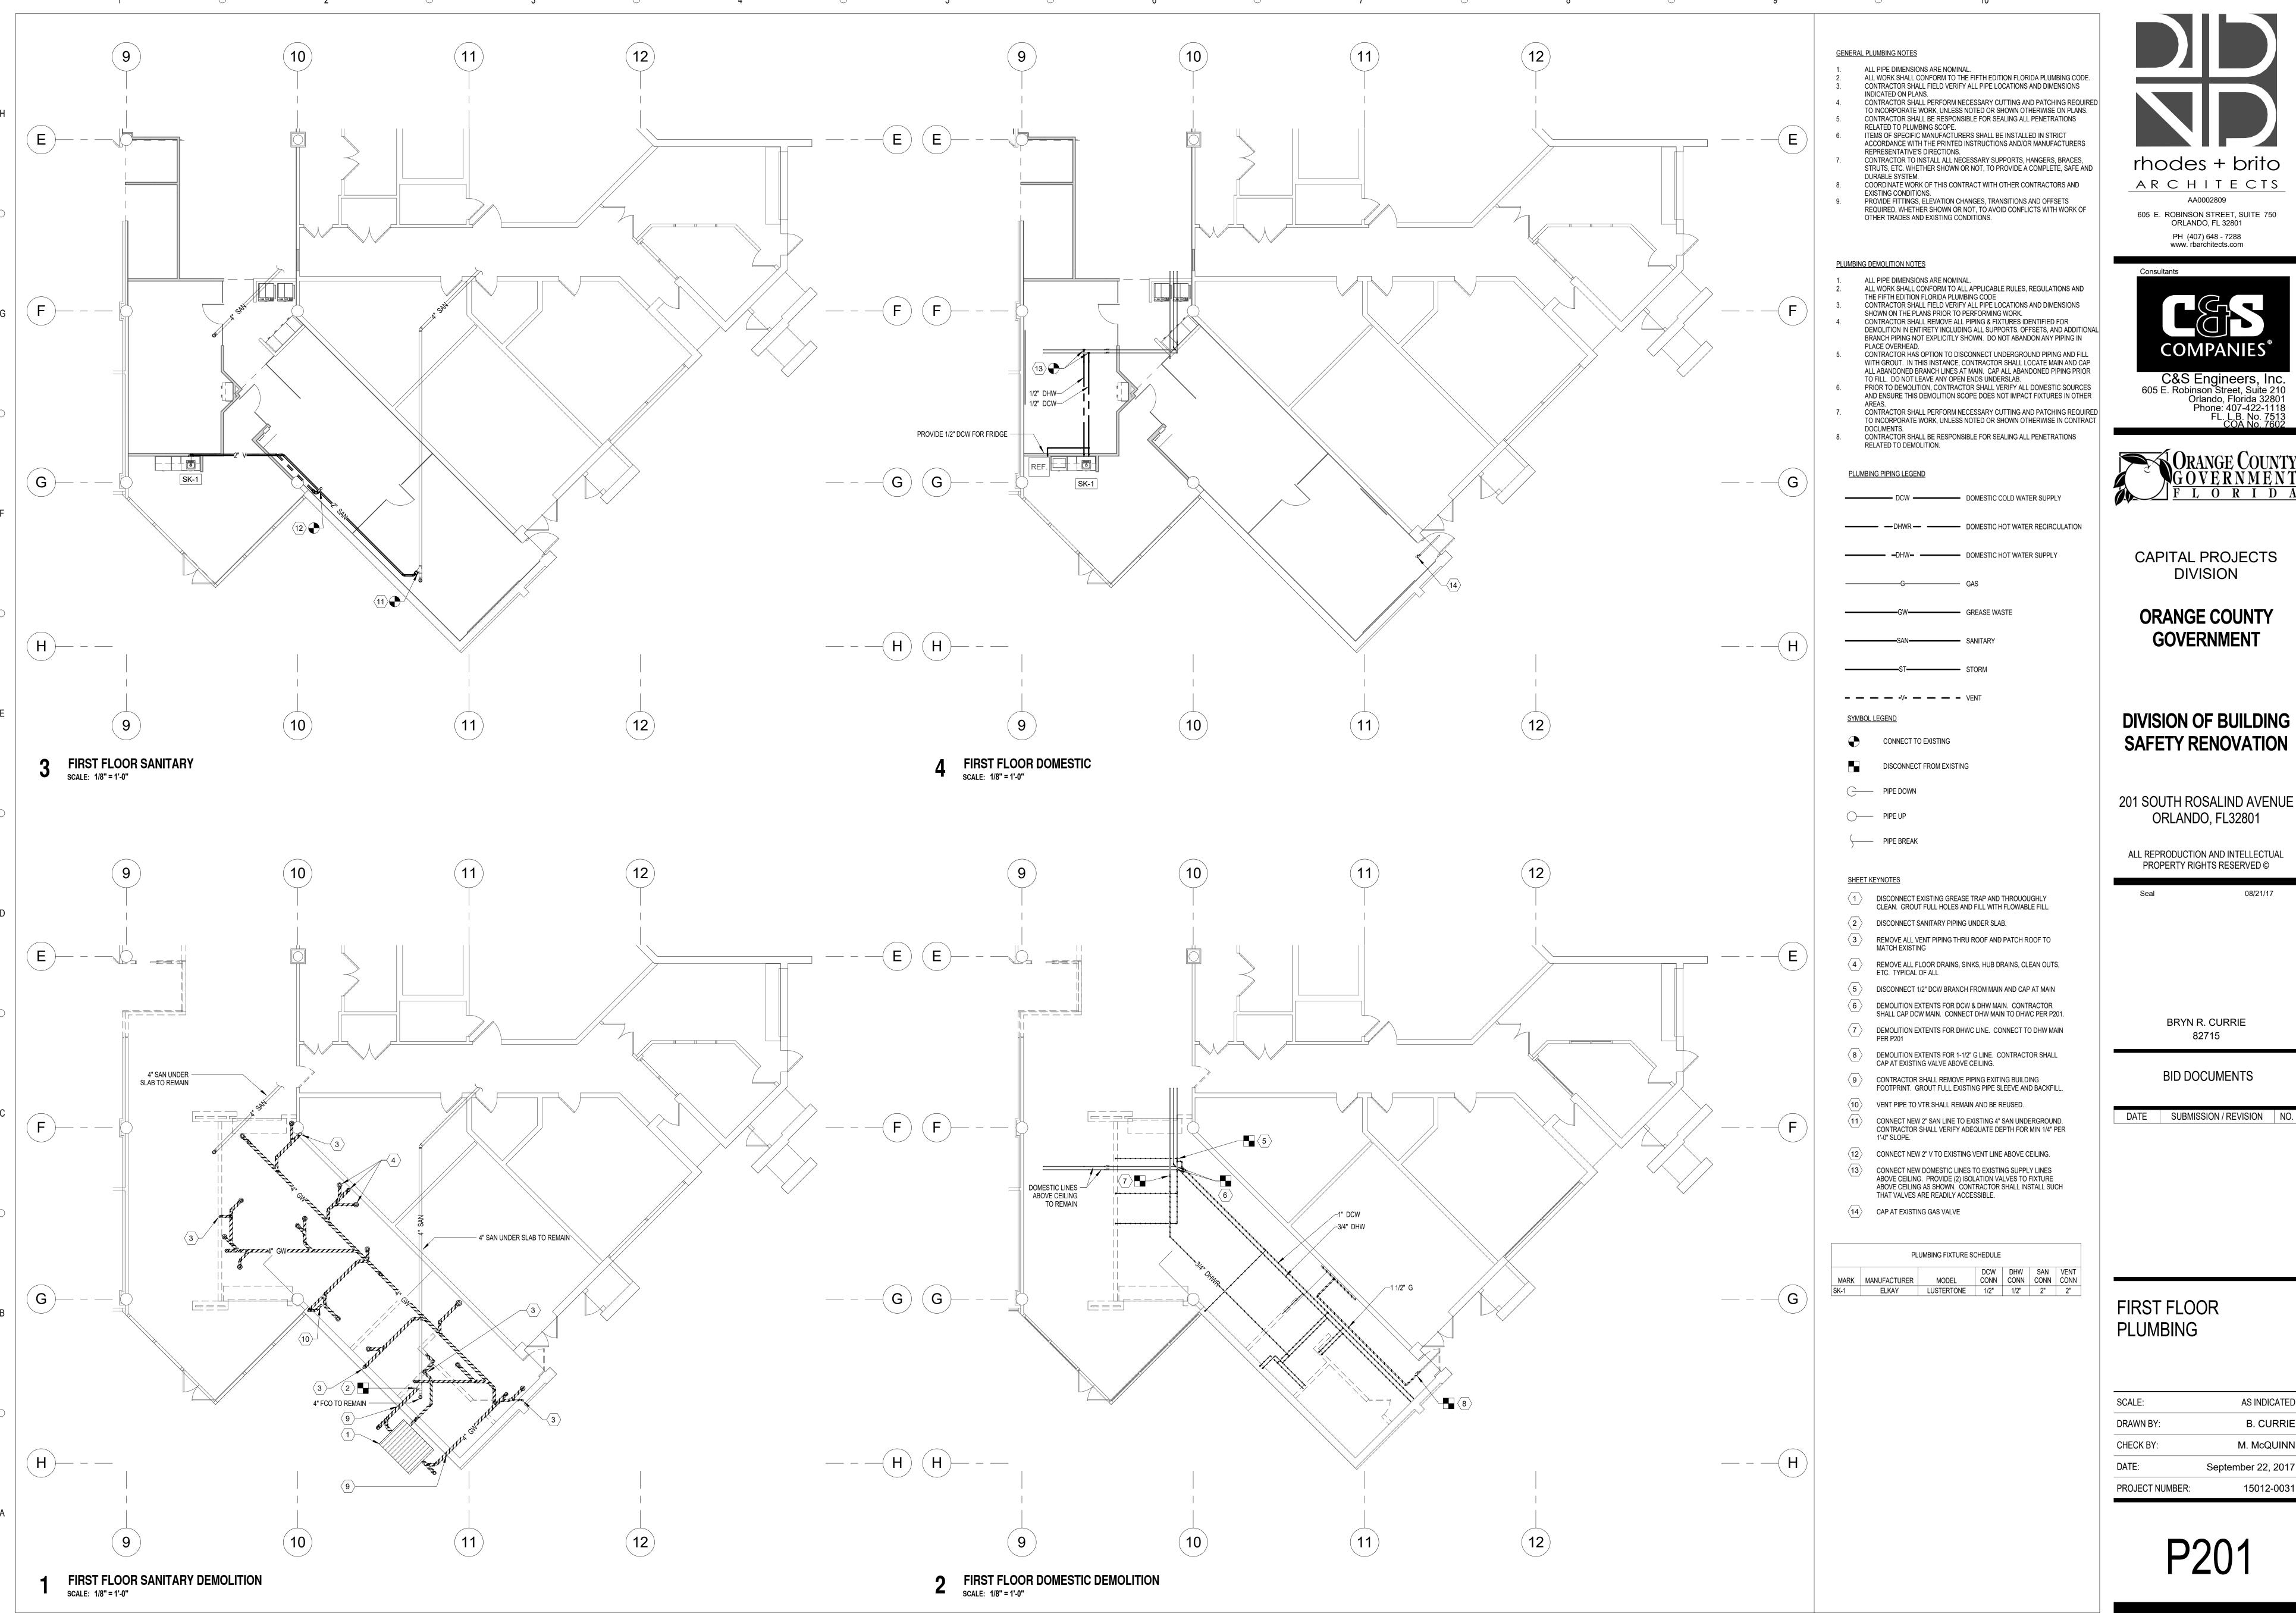



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08/21/17

FIRST FLOOR	
PLUMBING	

SCALE:	AS INDICATED
DRAWN BY:	B. CURRIE
CHECK BY:	M. McQUINN
DATE:	September 22, 2017
PROJECT NUMBER:	15012-0031

<u>ABBREVIATIONS</u>

AMPERES CABINET UNIT HEATER FILTER LEAVING DRY BULB TEMPERATURE SUPPLY AIR DECIBELS COMBINATION FIRE/SMOKE DAMPER SOLIDS SEPARATOR AUTOMATIC AIR DAMPER LOW PRESSURE CONDENSATE AIR COOLED CONDENSING UNIT DRY BULB TEMPERATURE FLOW MEASURING STATION LOW PRESSURE STEAM SMOKE DAMPER LOUVER SENSIBLE HEAT CAPACITY AIR CONDITIONING UNIT DUST COLLECTOR FEET PER MINUTE LEAVING WET BULB STATIC PRESSURE ABOVE FINISHED FLOOR LEAVING WATER TEMPERATURE DEWPOINT TEMPERATURE FIN TUBE RADIATION STATIONARY ROOF VENT DUCT SMOKE DETECTOR MAKEUP AIR UNIT TRIPLE DUTY VALVE AIR PRESSURE DROP DUAL TEMPERATURE WATER RETURN DTR GENERAL CONTRACTOR AIR SEPARATOR 1000 BTUH TOTAL DYNAMIC HEAD DUAL TEMPERATURE WATER SUPPLY GALLONS PER MINUTE MINIMUM CIRCUIT AMPACITY TRANSFER GRILLE BYPASS DAMPER DOMESTIC WATER HEATER TOTAL HEAT CAPACITY BACK DRAFT DAMPER HEAD MAXIMUM OVERCURRENT PROTECTION TSP TOTAL STATIC PRESSURE DIRECT EXPANSION BRAKE HORSE POWER ENTERING AIR TEMPERATURE HOT GLYCOL RETURN MANUAL VENT TYPICAL HOT GLYCOL SUPPLY NORMALLY CLOSED BOTTOM OF DUCT EBB ELECTRIC BASE BOARD UNIT VENTILATOR EXPANSION COMPENSATOR HORSEPOWER NOT IN CONTRACT VOLT BRITISH THERMAL UNIT PER HOUR EDB ENTERING DRY BULB TEMPERATURE HIGH PRESSURE CONDENSATE NORMALLY OPEN, NUMBER HPC VALANCE UNIT HIGH PRESSURE STEAM OUTSIDE AIR VARIABLE AIR VOLUME **CEILING CASSETTE UNIT** HUMIDITY RATIO, HOUR PUMP VOLUME DAMPER COLD CONDENSATE DRAIN ENERGY RECOVERY UNIT HEAT RECOVERY UNIT PRESSURE DROP VERIFY IN FIELD **CONDENSER WATER SUPPLY** EXTERNAL STATIC PRESSURE PROPYLENE GLYCOL HUMIDIFIER VACUUM PUMP CONDENSER WATER RETURN EXPANSION TANK HOT WATER COIL VARIABLE SPEED DRIVE CUBIC FEET PER MINUTE ENTERING WET BULB TEMPERATURE HOT WATER SUPPLY POUNDS PER SQUARE INCH VERTICAL UNIT VENTILATOR ENTERING WATER TEMPERATURE HOT WATER RETURN PACKAGED TERMINAL AIR CONDITIONER UNIT HEATER WET BULB TEMPERATURE CHILLED GLYCOL RETURN EXH HEAT EXCHANGER RETURN AIR WALL CASSETTE UNIT **EXIST** CHILLED GLYCOL SUPPLY RADIATOR, RADIANT PANEL WATER FLOW SWITCH CHILLED WATER SUPPLY INCH RADIANT CEILING PANEL WATER GAUGE CHILLED WATER RETURN FAHRENHEI1 INDUCTION UNIT RELATIVE HUMIDITY WALL HEATER REHEAT COIL CLEANOUT FLOAT AND THERMOSTATIC TRAP KILN HOOD WATER PRESSURE DROP CONVECTOR FLEXIBLE CONNECTION KILOWATT REVOLUTION PER MINUTE WWM ZD ZONE DAMPER ROOF TOP UNIT COOLING TOWER FIRE DAMPER

SYMBOLS RETURN WATER RETURN WATER REMOVALS DISCONNECT FROM EXISTING CONNECT TO EXISTING TEMPERATURE SENSOR WITH LOCKING GUARD PRESSURE SENSOR DAMPER MOTOR DIRECTION OF AIRFLOW DUCTWORK RETURN DIFFUSER FLEXIBLE DUCT CONNECTOR MANUAL VOLUME DAMPER

SQUARE TO ROUND DUCT TRANSITION SQUARE MAIN TO ROUND BRANCH TAKE-OFF POSITIVELY PRESSURIZED DUCT OUT OF THE PLANE POSITIVELY PRESSURIZED DUCT INTO THE PLANE NEGATIVELY PRESSURIZED DUCT OUT OF THE PLANE NEGATIVELY PRESSURIZED DUCT INTO THE PLANE SQUARE ELBOW WITH TURNING VANES AUTOMATIC AIR DAMPER UNIT WITH HEATING AND COOLING UNIT WITH AIR FLOW

UNIT WITH HEATING OR COOLING UNIT GENERAL EQUIPMENT DESIGNATION (#) KEYNOTE

FIRE DAMPER

ENLARGED PLAN & DETAIL CALL OUT

____ **VOLUME DAMPER**

GENERAL NOTES:

- ALL WORK SHALL CONFORM TO ALL APPLICABLE RULES, REGULATIONS AND CODES, INCLUDING, BUT NOT LIMITED TO FLORIDA ENERGY CODE, 2014 ED., FLORIDA BUILDING CODE, 2014 ED. AND OSHA.
- FIELD VERIFY ALL DIMENSIONS PRIOR TO DUCTWORK FABRICATION OR ANY OTHER MECHANICAL WORK. MECHANICAL CONTRACTOR SHALL COORDINATE INSTALLATION OF EQUIPMENT, PIPING, DUCTWORK, AND PADS WITH OTHER CONTRACTORS. PROVIDE FITTINGS, ELEVATION CHANGES, TRANSITIONS, AND OFFSETS REQUIRED, WHETHER SHOWN OR NOT, TO AVOID CONFLICTS WITH WORK OF OTHER CONTRACTS.
- MECHANICAL CONTRACTOR SHALL BE RESPONSIBLE FOR SEALING ALL HVAC PENETRATIONS (PIPING, DUCTWORK, ETC) IN ACCORDANCE WITH THE INTERNATIONAL BUILDING CODE AND
- 4. ITEMS OF SPECIFIC MANUFACTURER'S SHALL BE INSTALLED IN STRICT ACCORDANCE WITH THE PRINTED INSTRUCTIONS AND/OR MANUFACTURER'S REPRESENTATIVES DIRECTIONS.
- . MECHANICAL CONTRACTOR TO INSTALL ALL NECESSARY STIFFENERS, BRACES, STRUTS, ETC, WHETHER SHOWN OR NOT, TO PROVIDE A COMPLETE, SAFE, AND DURABLE SYSTEM.
- 6. DIMENSIONS SHOWN "AFF" INDICATE THE ACTUAL CLEAR DIMENSIONS FROM THE BOTTOM OF THE UNIT TO THE FINISHED FLOOR ELEVATION; UNLESS INDICATED OTHERWISE.
- 7. SUPPORT AND EQUIPMENT DETAILS MAY VARY TO SUIT EQUIPMENT AND PARTS SUPPLIED.
- 8. WELD ALL STEEL ANGLE JOINTS UNLESS OTHERWISE SHOWN.
- 9. PROVIDE NECESSARY BY-PASSES AND BALANCING MEANS AS REQUIRED TO ASSURE PROPER SYSTEM OPERATION.
- 10. ALL DUCT DIMENSIONS SHOWN ARE "SIDE SEEN" BY "SIDE NOT SEEN" AND ARE THE CLEAR INSIDE DIMENSIONS UNLESS OTHERWISE NOTED.
- 11. PROVIDE ACCESS DOORS AND CLEARANCES FOR EASY ACCESS TO ALL FIRE DAMPERS, CONTROL DAMPERS, LOUVERS, FILTERS, COILS, AND FANS.
- 12. BRANCH DUCTS TO REGISTER SHALL BE THE SAME SIZE AS REGISTER UNLESS INDICATED OTHERWISE. 13. REFER TO ARCHITECTURAL REFLECTED CEILING PLAN, FOR PRECISE LOCATION OF
- DIFFUSERS AND REGISTERS.
- 14. PROVIDE MANUAL VOLUME DAMPERS IN ALL BRANCH TAKE-OFFS AND WHERE SHOWN.
- 15. PROVIDE ALL CONTROL AND INTERLOCK WIRING REQUIRED OR SPECIFIED THAT IS NOT PROVIDED BY THE ELECTRICAL CONTRACTOR.
- 16. COORDINATE WITH ELECTRICAL CONTRACTOR AND FIRE PROTECTION CONTRACTOR REGARDING THE RESPONSIBILITIES FOR SUPPLYING, INSTALLING AND WIRING OF HVAC-RELATED DISCONNECT SWITCHES, STARTERS, SAFETY INTERLOCKS, EMERGENCY SHUTDOWN AND WIRING.
- 17. WORK ON M-SERIES DRAWINGS IS BY THE MECHANICAL CONTRACTOR (MC) UNLESS OTHERWISE NOTED.
- 18. VERIFY ALL LOCATIONS, DIMENSIONS, EQUIPMENT ARRANGEMENTS, CLEARANCES AND ELECTRICAL CHARACTERISTICS IN THE FIELD PRIOR TO BID. PROMPTLY NOTIFY THE ARCHITECT/ENGINEER OF ANY DISCREPANCIES.
- 19. PRIOR TO CUTTING THROUGH FLOORS AND WALLS THE CONTRACTOR SHALL VERIFY THE LOCATIONS OF ALL STRUCTURAL MEMBERS, JOISTS, AND OR COLUMNS. PROMPTLY NOTIFY THE ARCHITECT/ENGINEER OF ANY DISCREPANCIES. DO NOT CUT ANY STRUCTURAL MEMBERS UNLESS SPECIFICALLY DIRECTED TO DO SO.
- 20. THE MECHANICAL CONTRACTOR SHALL REMOVE DUCTWORK BACK TO A POINT WHICH WILL ALLOW THE INSTALLATION OF SUPPORT STEEL THAT IS REQUIRED / RELATED TO THE HVAC EQUIPMENT (IE RTU INSTALLATION). THE MECHANICAL CONTRACTOR SHALL COORDINATE WITH THE GENERAL CONTRACTOR IN THE LOCATIONS WHICH WILL REQUIRE MECHANICAL SUPPORT STEEL.
- 21. ALL EXISTING TO REMAIN DIFFUSERS AND DUCT SYSTEMS
- TO BE REBALANCED TO CFM INDICATED 22. PATCH AND SEAL DUCT WHERE BRANCHES / TAKEOFFS HAVE BEEN REMOVED AND NO NEW CONNECTION
- 23. CAP AND SEAL PIPING WHERE BRANCHES / TAKEOFFS HAVE BEEN REMOVED AND NO NEW CONNECTION IS NEEDED.

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ARCHITECTS

AA0002809





CAPITAL PROJECTS DIVISION

ORANGE COUNTY GOVERNMENT

DIVISION OF BUILDING SAFETY RENOVATION

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03/01/17


MATTHEW P. MCQUINN

BID DOCUMENTS

DATE SUBMISSION / REVISION NO.

LEGEND, ABBREVIATIONS AND **GENERAL NOTES**

AS INDICATED P. ROWAN DRAWN BY: CHECK BY: M. MCQUINN DATE: September 22, 2017 PROJECT NUMBER:

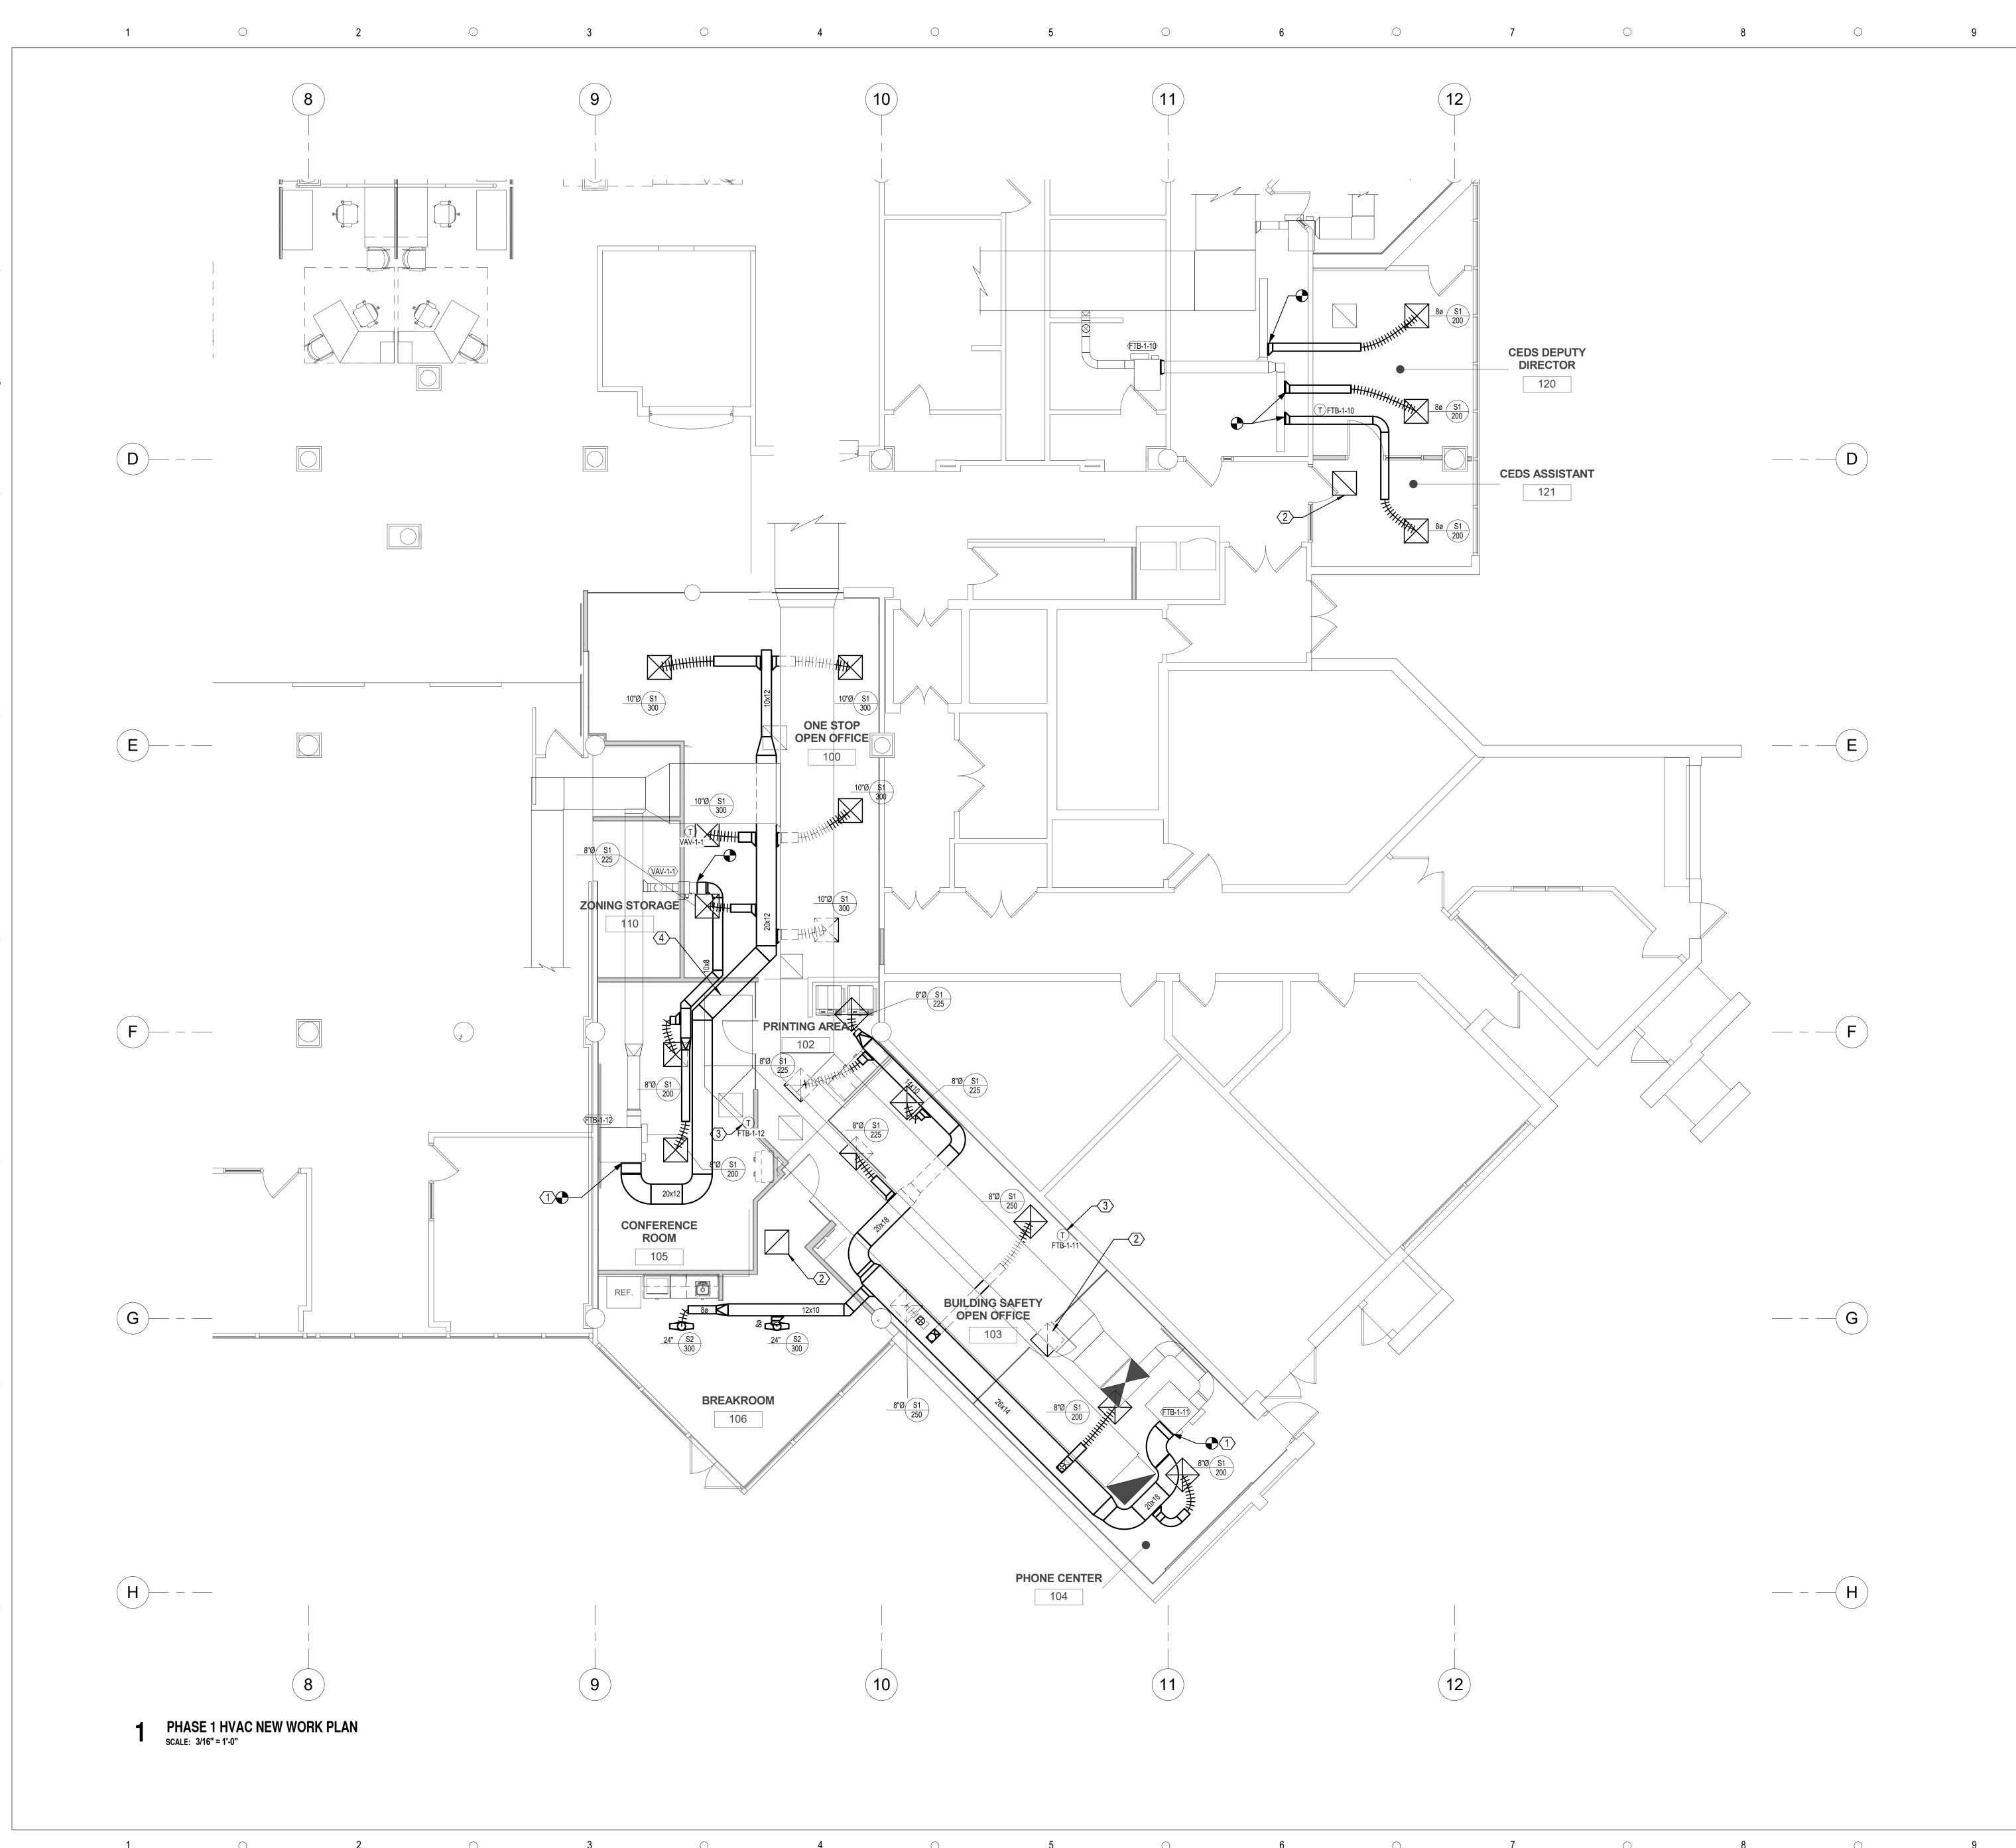

GENERAL NOTES:

 REFER TO M-100 FOR LEGEND, ABBREVIATIONS AND GENERAL NOTES.
 CONTRACTOR SHALL COORDINATE DUCT ROUTING WITH STRUCTURAL MEMBERS AND OTHER EXISTING CONDITIONS.

3. COORDINATE DESTRUCTIVE DEMOLITION, IF REQUIRED, WITH OWNER.

4. FOR ALL DUCTWORK TURNS, PROVIDE RADIUS ELBOWS. IF IMPEDED BY SPACE CONSTRAINTS, MILTERED ELBOWS WITH TURNING VANES MAY BE USED.

5. CONTRACTOR SHALL OPERATE EXISTING FIRE DAMPERS SHOWN AND REPLACE FUSIBLE LINKS.

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KEY NOTES:

- INSTALL NEW SUPPLY AIR DUCTWORK FROM EXISTING VAV UNIT. COORDINATE DUCT ROUTING WITH EXISTING CONDITIONS.
- 2 NEW RETURN GRILLE AT LOCATION INDICATED.
- RELOCATED EXISTING THERMOSTAT TO LOCATION INDICATED.
- TEMPORARY RETURN FLEX DUCTWORK TO BE REMOVED PRIOR TO COMPLETION OF CONSTRUCTION.

DUCT ROUTING WITH EXISTING CONDITIONS.

NEW RETURN CRULE AT LOCATION INDICATED.



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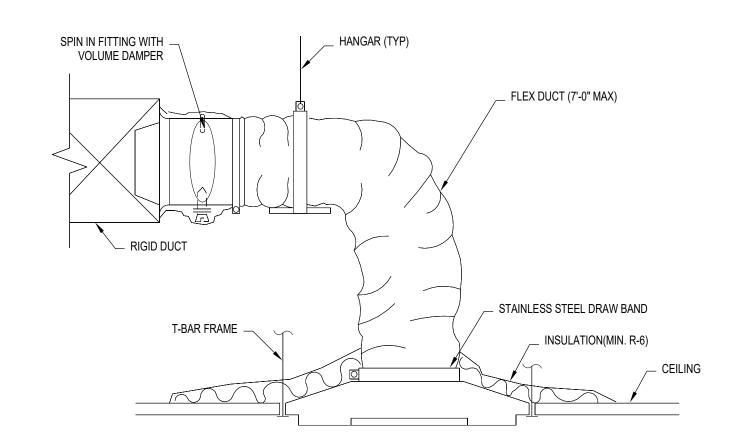
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DATE SUBMISSION / REVISION NO.


PHASE ONE HVAC NEW WORK PLAN

SCALE:		AS INDICATED
DRAWN BY:		P. ROWAN
CHECK BY:		M. MCQUINN
DATE:		September 22, 2017
PROJECT NUI	MBER:	15012-0031


M101






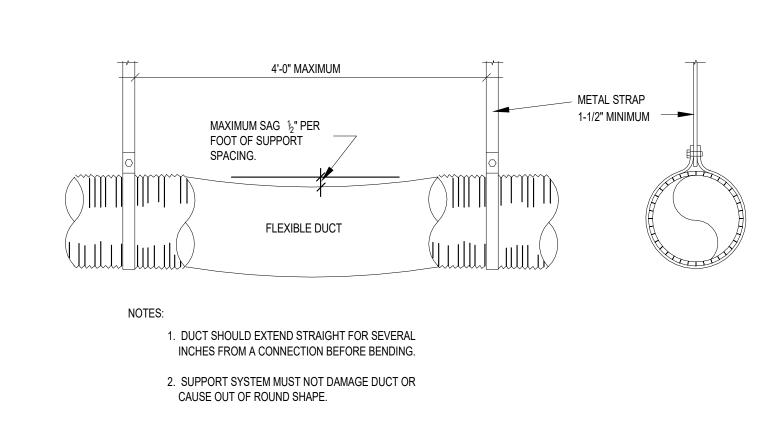



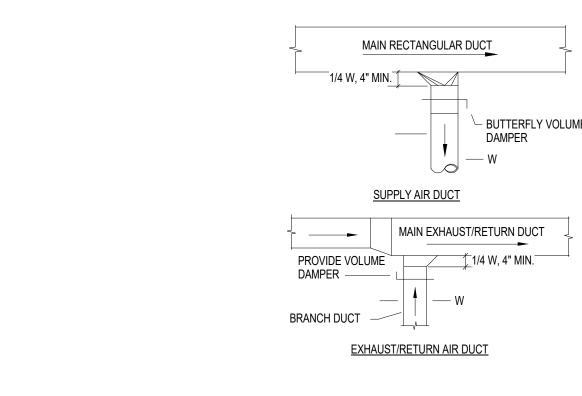




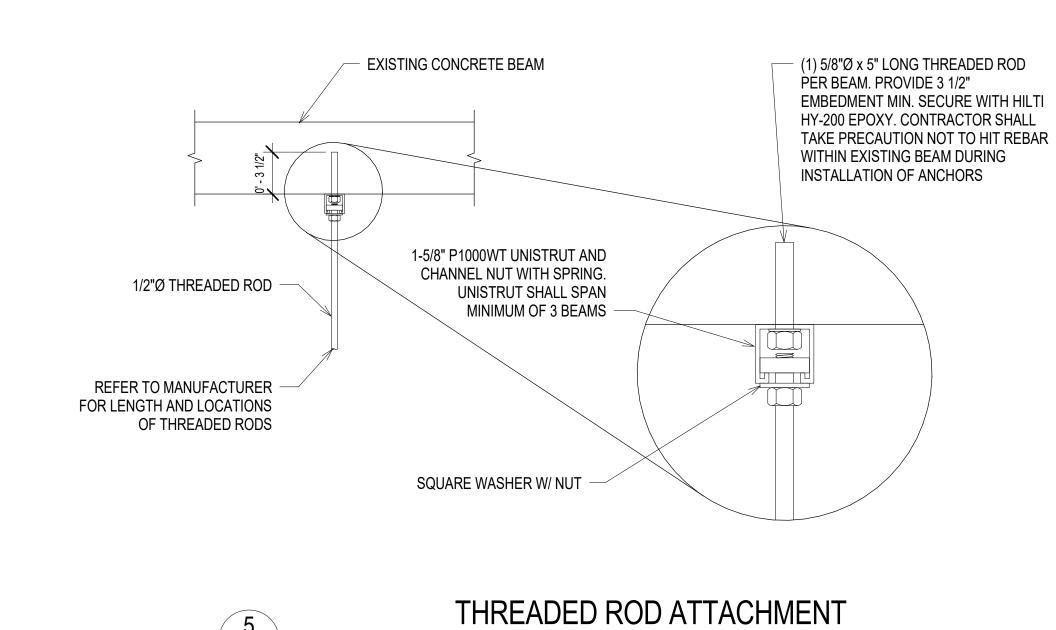


SCALE: 1 1/2" = 1'-0"

5 M501

1 0 5 0 8 0 9

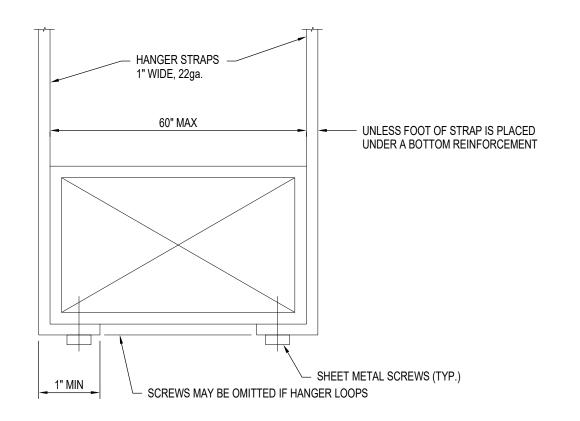



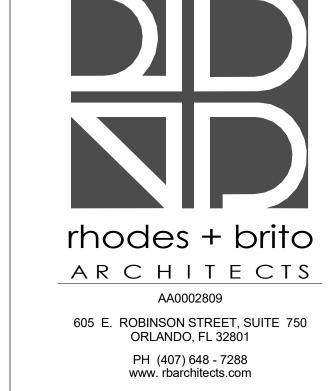





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Seal 05/24/16

72-00

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DETAIL SHEET

SCALE:	AS INDICATE
DRAWN BY:	P. ROWAN
CHECK BY:	M. MCQUINI
DATE:	September 22, 201
PROJECT NUMBER:	15012-003

M501

EXISTING VAV UNIT SCHEDULE																			
PRIMARY AIR CFM ELECTRIC HEATING COIL HYDRONIC HEATING COIL FAN SECTION																			
	SUPPLY				TYPE- SEE							NO. OF			WATER PD				
MARK	CFM	AREA SERVED	MANUFACTURER	MODEL NO.	NOTE 1	SIZE	MAX.	MIN.	HEATING	KW	VOLT/PHASE	STEPS	GPM	EWT/LWF °F	(FT. H20)	FAN CFM	STATIC PRESSURE	MOTOR HP	VOLT/PHASE
FTB-1-10	600 CFM	MANAGER OFFICE/ASSISTANT	PRICE	FDC5	S	3008	700	310	600				1.01	160/113	0.34	600	0.3	0.25	277/1
FTB-1-11	1725 CFM	UTILITES AREA	PRICE	FDC5	S	5014	1730	400	1725				3.25	160/115	1.75	1725	0.3	1	277/1
FTB-1-12	2400 CFM	PHONE CENTER AREA/MULTI-PURPOSE ROOM/PERMIT ANALYIST AREA	PRICE	FDC5	S	5014	2415	280	2400				2.59	160/115	1.07	2400	0.3	0.75	277/1
VAV-1-1	400 CFM	SMALL CONFERENCE ROOM	PRICE	SDV5	V	10	550	290	290	3.0	277/1	1							

GENERAL NOTES (APPLIES TO ALL UNITS):

1. VAV TYPE: "V"- SINGLE DUCT VARIABLE VOLUME TERMINAL UNIT, ELECTRIC HEAT, "S"- FAN POWERED

 \bigcirc

(2) DUCTWORK TO BE G90 GALVANIZED SHEET METAL.

1 0 5 0 8 0 9

SERIES TERMINAL UNIT, HYDRONIC HEAT.

DIFFUSER/RETURN GRILLE SCHEDULE				
MARK / LEGEND	TYPE	MFG.	MODEL	NOTES
NECK SIZE — 10Ø S1 MARK QUANTITY TYP — (2) 200 — CFM	ROUND NECK, SQUARE CEILING SUPPLY DIFFUSER	PRICE	ASCD	2,3,4,5,6,7
LENGTH 24" S2 MARK QUANTITY TYP (2) 200 CFM	CEILING MOUNTED LINEAR DIFFUSER, 2-SLOT	PRICE	JS215	1,5,7
NECK SIZE — 18x12 R1 MARK QUANTITY TYP — (2) 200 — CFM	CEILING OR SIDEWALL RETURN AIR GRILLE	PRICE	635	1,2,4,5

PROVIDE WITH OPPOSED BLADE VOLUME DAMPER.

NOTES: 2. PROVIDE 24x24 FULLY LOUVERED FACE LAYIN MODULE WHERE LOCATED IN LAYIN CEILING OR SUSPENDED FROM DUCTWORK.

FACTORY INSULATED BACKS ON ALL CEILING DIFFUSERS MUST BE PROVIDED.


COORDINATE BORDER TYPES WITH ARCHITECTURAL FLOOR PLAN AND REFLECTED CEILING PLAN. COORDINATE FINISH WITH ARCHITECTURAL.

WHERE DIFFUSER BALANCING DAMPER IS INACCESSIBLE, PROVIDE A CONCEALED REMOTE OPERATOR SIMILAR TO

YOUNG REGULATOR 270-301 BESIDE DIFFUSER/GRILLE. 7. PROVIDE WITH FACTORY INSULATED SUPPLY PLENUM

DUCT CONSTRUCTION SCHEDULE						
SERVICE	SMACNA PRESSURE CLASS	MATERIAL	ALLOWABLE SEAMS	SEALING REQUIREMENTS	INSULATION	NOTES
SUPPLY AIR DUCTS						
DUCTWORK DOWNSTREAM OF VAV	+ 1"		GROOVED, STANDING, SINGLE- CORNER, DOUBLE-CORNER AND PITTSBURGH-LOCK AND ALL OTHER ROLLED MECHANICAL SEAMS		CONCEALED - 2" THICK EXTERNAL WRAP	(1)(2)

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04/29/16

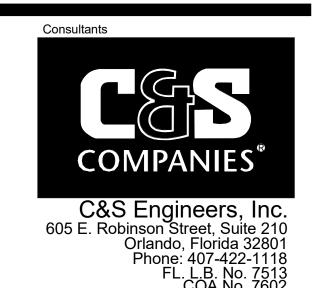MATTHEW P. MCQUINN

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DATE SUBMISSION / REVISION NO.

SCHEDULES

SCALE:	AS INDICATED
DRAWN BY:	P. ROWAN
CHECK BY:	M. MCQUINN
DATE:	September 22, 2017
PROJECT NUMBER:	15012-0031

LEGEND

DUPLEX RECEPTACLE, MOUNT 18" AFF UNLESS OTHERWISE NOTED QUAD RECEPTACLE, MOUNT 18" AFF UNLESS OTHERWISE NOTED GROUND FAULT CIRCUIT INTERRUPTER TYPE, MOUNT 48" AFF UNLESS

THREE-WAY TOGGLE SWITCH

 \boxtimes_1

SURFACE MOUNTED PANEL

SCHEDULES FOR DETAILS

 \square

2'X4' LUMINAIRE, LETTER DENOTES TYPE, SEE LUMINAIRE SCHEDULE

ABBREVIATIONS

FULL LOAD AMPERES GROUND FAULT INTERRUPT GROUND

INTERCOM ISOLATED GROUND INTERMEDIATE METAL CONDUIT JUNCTION BOX KILOVOLT KVA KILOVOLT AMPERES KILOWATT LENGTH, LONG LIGHTING MILLIAMPERES MBB

HORSEPOWER

HERTZ

GND

MONITOR BREAKOUT BOX MAIN CIRCUIT BREAKER MCB MOTOR CONTROL CENTER 1000 CIRCULAR MILLS MECHANICAL MICROPHONE MINIMUM MISC MISCELL ANEOUS MAIN LUGS ONLY MULTI MODE

OTHERWISE NOTED SINGLE POLE TOGGLE SWITCH

SINGLE POLE TOGGLE SWITCH WITH DUAL TECHNOLOGY OCCUPANCY SENSOR

COMBINATION MOTOR STARTER/CIRCUIT BREAKER DISCONNECT SWITCH

FUSED DISCONNECT SWITCH NON FUSED DISCONNECT SWITCH

BRANCH CIRCUIT HOME RUN WITH CIRCUIT NUMBER SEE PANEL

WALL MOUNTED LUMINAIRE, LETTER DENOTES TYPE, SEE LUMINAIRE SCHEDULE

2'X2' LUMINAIRE. LETTER DENOTES SWITCH FOR CONTROL. NUMBER DENOTES CIRCUIT NUMBER BACK TO INDICATED BRANCH PANEL (REFER TO SHEET NOTES)

2'X2' EMERGENCY LUMINAIRE, LETTER DENOTES SWITCH FOR CONTROL, NUMBER DENOTES CIRCUIT NUMBER BACK TO INDICATED BRANCH PANEL (REFER TO SHEET NOTES)

CEILING MOUNTED OCCUPANCY SENSOR. LOWERCASE LETTER DENOTES SWITCH IDENTIFICATION FOR NEW LIGHTING.

A A/C AC AF AFF A/H AIC AT ATSS AUX AWG	ALTERN. AMPERE WITH CII ABOVE F AIR HAN AMPERE AMPERE AUTOMA	NDITIONING ATE CURRENT E FRAME WHEN USED RCUIT BREAKER FINISHED FLOOR IDLER E INTERRUPTING CAPACITY E TRIP ATIC TRANSFER SWITCH	
BC BKR BOH	BARE CO BREAKE BACK OF		
C CAB CATSI CC CKT CMH CO CPB CUC CUTC	CABLED CIRCUIT COMMUI CONDUI COMMUI COMMO COMMO	T DRY-5E CONDUCTORS NICATION MANHOLE	
D DC DISC DN DPST DPDT	DISCON DOWN DOUBLE	G CABINET NECT E POLE SINGLE THROW E POLE DOUBLE THROW	
EER ELEC' ELEV EMT EP EQUIF	T ELECTR ELEVATI ELECTR EXPLOS P EQUIPM	ION ICAL METALLIC TUBING IION PROOF ENT	
F FACP FAT FBO FDR	FIRE ALA	ARM CONTROL PANEL ARM TERMINATION HED BY OWNER	

SHUNT TRIP SWITCH SWITCHBOARD SWBD TELEPHONE TWISTED PAIR CABLE TELEPHONE TERMINAL BOARD TYPICAL UNLESS OTHERWISE NOTED VARIABLE FREQUENCY DRIVE WATT, WIRE, WIDE WEATHERPROOF XFMR TRANSFORMER

NON-AUTOMATIC

NORMALLY OPEN

NOT TO SCALE

OVERLOADS ON CENTER

PULLBOX

POLYVINYL CHLORIDE

POINT OF CONNECTION

RIGID GALVANIZED STEEL

REMOTE TERMINAL UNIT

SOUND BREAKOUT BOX

SIGNALING LINE CIRCUIT

SOUND DISTRIBUTION BOX

SINGLE POLE SINGLE THROW

ROOT-MEAN-SQUARE

POINT OF SALES

REFERENCE

RECEPTACLE

SINGLE MODE

SOUND RACK STAINLESS STEEL

SPECIFICATIONS SPEAKER

PANEL

POWER

ROOM

RTU

PAIR

NORMALLY CLOSED NON-FUSED

NATIONAL FIRE PROTECTION ASS.

1. VISIT AND CAREFULLY EXAMINE THOSE PORTIONS OF THE BUILDING AND SITE AFFECTED BY THIS WORK BEFORE SUBMITTING PROPOSALS. SO AS TO BECOME FAMILIAR WITH EXISTING CONDITIONS AND DIFFICULTIES THAT WILL AFFECT EXECUTION OF THE WORK. SUBMISSION OF A PROPOSAL WILL BE CONSTRUED AS EVIDENCE THAT SUCH EXAMINATION HAS BEEN MADE AND LATER CLAIMS FOR LABOR, EQUIPMENT OR MATERIALS REQUIRED BECAUSE OF DIFFICULTIES ENCOUNTER WILL NOTE BE RECOGNIZED.

DRAWINGS. COOPERATION WITH OTHER TRADES IN ROUTING AND/OR BURIAL DEPTHS, AS DETERMINED UNDERSTOOD THAT THE PLANS ARE NOT COMPLETELY TO SCALE. THIS CONTRACTOR IS TO FIELD VERIFY DIMENSION OF ALL SITE UTILITIES, ETC. PRIOR TO BID.

3. ELECTRICAL CONTRACTOR SHALL TRACE LIGHTING AND POWER BRANCH CIRCUITS TO IDENTIFY CIRCUITS SERVING AREA WITHIN SCOPE OF WORK. PROVIDE UPDATED TYPEWRITTEN PANEL SCHEDULES AT COMPLETION OF WORK.

4. REMOVE EXISTING POWER, LIGHTING, SYSTEMS, MATERIAL, AND EQUIPMENT WHICH ARE MADE OBSOLETE OR WHICH INTERFERE WITH THE CONSTRUCTION OF THE PROJECT.

6. EXISTING OUTLET BOXES AND CONDUIT WHICH ARE LOCATED PROPERLY FOR NEW WORK MAY BE REUSED FOR

7. ALL CONDUIT AND WIRE REMOVED SHALL BE TAKEN BACK TO THE SOURCE OF SUPPLY UNLESS OTHERWISE

8. INSTALL A BLANK COVER PLATE WHERE REQUIRED.

ASSOCIATED CONDUCTORS, JUNCTION BOXES, FASTENERS AND SUPPORTS.

CODE AUTHORITY

2011 NATIONAL ELECTRIC CODE

2014 FLORIDA BUILDING CODE

- 1. ALL ELECTRICAL WORK SHALL CONFORM TO APPLICABLE STATE, LOCAL, AND NATIONAL ELECTRICAL CODES.
- 2. ELECTRICAL CHARACTERISTICS SHALL BE VERIFIED WITH EQUIPMENT MANUFACTURER.
- 3. ITEMS OF SPECIFIC MANUFACTURERS SHALL BE INSTALLED IN STRICT ACCORDANCE WITH MANUFACTURER'S PRINTED INSTRUCTIONS AND/OR MANUFACTURER'S REPRESENTATIVE'S DIRECTIONS.
- 4. THE CONTRACTOR SHALL FIELD VERIFY ALL LOCATIONS AND DIMENSIONS SHOWN ON DRAWINGS. 5. ALL AREAS DISTURBED BY WORK SHALL BE RESTORED TO A CONDITION EQUAL TO ORIGINAL OR AS
- DETERMINED BY THE OWNER. 6. NEW FLUORESCENT LAMPS SHALL MATCH EXISTING IN COLOR AND TYPE.

GENERAL NOTES

- 7. EXIT SIGNS TO BE WIRED TO NEAREST EMERGENCY LIGHTING CIRCUIT, WITH AN UNSWITCHED PHASE
- 8. EMERGENCY LIGHTING TO BE WIRED TO SEPARATE SWITCH LEG WITH WATTSTOPPER RELAY TO SENSE
- 9. COORDINATE WITH OWNER FOR METERING OF CIRCUITS TO TENANT SPACE.
- 10. THE ELECTRICAL CONTRACTOR SHALL COORDINATE THE INSTALLATION OF ALL EQUIPMENT WITH OTHER
- 11. THE CONTRACTOR SHALL PROVIDE RACEWAYS, WIRING, AND CONNECTIONS FOR ALL CONTROL CIRCUITS AND
- INTERLOCK.
- 12 ALL ELECTRICAL CONDUIT AND CONDUCTORS DISCONNECTED AND NOT TO BE REUSED SHALL BE REMOVED. 13. CONTRACTOR SHALL FIELD VERIFY ALL EXISTING CONDITIONS BEFORE STARTING WORK, IF ONLY A PORTION

OF AN EXISTING CIRCUIT IS BEING REMOVED FOR DEMOLITION, CONTINUITY SHALL BE MAINTAINED TO THE

- REST OF THE REMAINING CIRCUIT. 14. ALL BRANCH CIRCUITS SHALL CONSIST OF 2 #12 AWG CONDUCTORS PLUS 1 #12 AWG GROUND, UNLESS OTHERWISE SHOWN.
- 15. ALL RACEWAYS SHALL BE RUN IN NEAT AND WORKMAN-LIKE MANNER AND SHALL BE PROPERLY SUPPORTED.. 16. ALL RACEWAY RUNS, PRIOR TO TERMINATION AT BRANCH PANEL, SHALL BE CAPPED DURING THE COURSE OF
- CONSTRUCTION BUT NOT UNTIL WIRES ARE PULLED IN AND COVERS ARE IN PLACE. NO CONDUCTORS SHALL
- BE PULLED INTO RACEWAYS UNTIL CONSTRUCTION WORK, WHICH MIGHT DAMAGE THE RACEWAYS, HAS BEEN
- 17. CONTRACTOR TO PROVIDE NYLON PULL CORD IN ALL EMPTY RACEWAYS.
- 18. ALL CUTTING AND PATCHING AS A RESULT OF NEW CONSTRUCTION OR DEMOLITION SHALL BE PERFORMED IN A WORKMANLIKE MANNER, AND SHALL MATCH IN COLOR, SHAPE, SIZE AND TEXTURE ADJACENT TO AND/OR CONTIGUOUS WITH FINISHED SURFACES.
- 19. THE ELECTRICAL DRAWINGS ARE SCHEMATIC ONLY. COORDINATE EXACT LOCATIONS AND DETAILS OF ELECTRICAL EQUIPMENT, CONDUITS, ETC, WITH THE OWNER.
- 20. CONSTRUCTION DOCUMENTS REPRESENT THE CONSULTANT'S DESIGN INTENT. IT IS NOT THE INTENT OF THE DRAWINGS AND SPECIFICATIONS TO IDENTIFY EACH AND EVERY DETAIL OF THE ELECTRICAL CONSTRUCTION. PROVIDE ALL NECESSARY EQUIPMENT AND LABOR FOR A COMPLETE AND FULLY FUNCTIONAL ELECTRICAL
- 21. CONTRACTOR SHALL FIELD VERIFY ALL EXISTING CONDITIONS, LOCATIONS, AND DIMENSIONS SHOWN ON DRAWINGS AND SHALL NOTIFY THE ENGINEER/ARCHITECT OF ANY DISCREPANCIES PRIOR TO THE START OF
- 22. THE ENGINEER HAS MADE EVERY EFFORT TO PROPERLY ADDRESS ALL RELATED TRADES AND IT IS THE RESPONSIBILITY OF EACH INDIVIDUAL CONTRACTOR (AS PART OF THEIR BASE BID) TO THOROUGHLY REVIEW ALL DESIGN DOCUMENTS BEFORE WORK IS TO BEGIN. IN CASE OF A CONFLICT, NOTIFY THE ARCHITECT/ENGINEER IMMEDIATELY TO COORDINATE ANY DISCREPANCY.
- 23. ALL ELEVATIONS NOTED ON THE CONTRACT DRAWING ARE RELATIVE TO THE FINISHED FLOOR UNLESS NOTED
- 24. CONTRACTOR SHALL REPAIR AND REFINISH ALL CONTRACTOR RELATED DAMAGES AND RELATED AREAS AFFECTED BY RENOVATION WORK BACK TO THEIR ORIGINAL CONDITION AS NEW AND IN AN ACCEPTABLE MANNER TO OWNER / ARCHITECT, WITH NO ADDITIONAL COST TO OWNER.
- 25. IF ASBESTOS IS ENCOUNTERED DURING CONTRACTED WORK, STOP WORK IN THAT AREA AND IMMEDIATELY CONTACT THE OWNER.
- 26. ALL PROJECT SUBMITTALS SHALL BE SUBMITTED AND RETURNED MARKED REVIEWED OR REVIEWED AS NOTED PRIOR TO ORDERING/INSTALLATION OF ANY PRODUCT / SERVICE.
- 27. CONTRACTOR SHALL ASSUME THAT ALL ELECTRICAL EQUIPMENT, RACEWAYS, CONDUCTORS, ETC. SHOWN ON THE DRAWINGS SHALL BE FURNISHED AND INSTALLED BY THE CONTRACTOR UNLESS SPECIFICALLY
- 28. CONTRACTOR SHALL REVIEW AND COORDINATE THE ELECTRICAL CONSTRUCTION WITH OTHER TRADES, EQUIPMENT SUPPLIERS AND THE OWNER.
- 29. ALL WIRE SHALL BE STRANDED COPPER CONDUCTORS, 600V RATED, TYPE THHN/THWN, UNLESS OTHERWISE NOTED. ALL INTERIOR CONDUITS SHALL BE ELECTRICAL METALLIC TUBING (EMT), RIGID METAL CONDUIT (RMC) OR FLEXIBLE METAL CONDUIT (FMT), UNLESS OTHERWISE NOTED.
- 30. CONTRACTOR SHALL PERMANENTLY IDENTIFY ALL WIRING WITH THE SOURCE AND CIRCUIT AT ALL ELECTRICAL EQUIPMENT, PULL AND JUNCTION BOXES AND ELECTRICAL TERMINATIONS PROVIDED OR ASSOCIATED WITH THIS CONSTRUCTION.
- 31. WHERE CONDUITS PENETRATE FIRE RATED WALLS OR FLOORS, FURNISH AND INSTALL FIRE STOPPING THAT IS AN UNDERWRITER'S LABORATORIES LISTED SYSTEM OR A DESIGN AND INSTALLATION THAT CONFORMS TO
- 32. CONTRACTOR SHALL PATCH AND REPAIR ALL DAMAGED SURFACES AND AREAS WHERE EQUIPMENT WAS REMOVED OR MODIFIED, TO MATCH EXISTING CONDITIONS.
- 33. ALL NEW CONDUITS TO BE CONCEALED IN WALL WHERE POSSIBLE. ALL CONDUITS IN CEILING TO BE PAINTED TO MATCH SURROUNDING MATERIAL.
- 34. ALL BRANCH CIRCUIT SHALL BE CONCEALED UNLESS OTHERWISE NOTED. 35. REFER TO ARCHITECTURAL RCP FOR REFERENCE AS TO WHICH FIXTURES ARE NEW, EXISTING, OR TO BE
- 36. REFER TO E-601 SHEET FOR SECTION VIEWS OF STACKED RECEPTACLE LOCATIONS.

RELOCATED.

EXISTING CONDITIONS GENERAL NOTES

- 2. UTILITIES AND SERVICES INDICATED ARE TAKEN FROM FIELD INVESTIGATION. IT IS TO BE UNDERSTOOD THAT UNFORESEEN CONDITIONS EXIST AND NEW WORK MAY NOT BE FILED LOCATED EXACTLY AS SHOWN ON THE DURING CONSTRUCTION AND AS DIRECTED BY THE ARCHITECT/ENGINEER, MAY BE NECESSARY. IT IS ALSO
- 5. REINSTALL ANY SUCH POWER, LIGHTING, SYSTEMS, MATERIALS AND EQUIPMENT WHICH ARE REQUIRED TO REMAIN ACTIVE FOR THE FACILITY TO BE FULLY FUNCTIONAL.

- 9. ALL UNUSED RACEWAYS WITHIN ACCESSIBLE SPACES SHALL BE COMPLETELY REMOVED. REMOVE ALSO


DEMOLITION NOTES

- 1. THE CONTRACTOR SHALL VISIT AND CAREFULLY EXAMINE THOSE PORTIONS OF THE BUILDING AND SITE AFFECTED BY THIS WORK BEFORE SUBMITTING PROPOSAL SO AS TO BECOME FAMILIAR WITH EXISTING WORK. SUBMISSION OF A PROPOSAL WILL BE CONSTRUED AS EVIDENCE THAT SUCH EXAMINATION HAS BEEN MADE AND LATER CLAIMS FOR LABOR, EQUIPMENT OR MATERIALS REQUIRED BECAUSE OF DIFFICULTIES ENCOUNTERED WILL NOT BE RECOGNIZED. IT IS TO BE UNDERSTOOD THAT UNFORESEEN CONDITIONS EXIST AND NEW WORK MAY NOT BE FIELD LOCATED EXACTLY AS SHOWN ON THE DRAWINGS. COORDINATION WITH OTHER TRADES IN EQUIPMENT ROUTING AS DETERMINED DURING CONSTRUCTION AND AS DIRECTED BY THE ARCHITECT/ENGINEER MAY BE NECESSARY AND ALL REQUIRED COORDINATION BETWEEN TRADES SHALL BE CONSIDERED AS PART OF THIS CONTRACT. IT IS ALSO UNDERSTOOD THAT THE PLANS ARE NOT COMPLETELY TO SCALE. FIELD VERIFY DIMENSIONS OF ALL EXISTING CONDITIONS, PRIOR TO BID AND INCLUDE ANY DEVIATIONS IN THE CONTRACT.
- 2. ALL DEVICES AND EQUIPMENT NOT SHOWN AND IN AREAS OUTSIDE OF THE SCOPE OF WORK SHALL REMAIN ACTIVE UNLESS OTHERWISE NOTED. INSTALL TEMPORARY SERVICES AS REQUIRED TO MAINTAIN CONTINUITY TO EXISTING DEVICES AND EQUIPMENT THAT REMAIN.
- 3. ALL EQUIPMENT AND MATERIAL REMOVED AND NOT REUSED SHALL BE TURNED OVER TO THE OWNER OR AT
- THE OWNERS REQUEST DISPOSED OF BY THE CONTRACTOR. 4. ALL ELECTRICAL DEVICES THAT ARE REMOVED SHALL BE REMOVED AS DIRECTED BY THE OWNER, AND
- CEILING OR WALL SHALL BE PATCHED OR PAINTED AS DIRECTED BY ARCHITECT. 5. ALL EXISTING ELECTRICAL EQUIPMENT IS NOT SHOWN. IT IS THE CONTRACTORS RESPONSIBILITY TO BECOME FAMILIAR WITH ALL EXISTING CONDITIONS PRIOR TO BID, AND INCLUDE IN HIS BID THE REMOVAL OF ALL
- EQUIPMENT, CONDUIT, WIRE, ETC. THAT IS NOT BEING REUSED BACK TO ITS SOURCE. 6. ALL CONCRETE, WALL PATCHING, CEILING REPAIR, AND OTHER GENERAL WORK REQUIRED FOR INSTALLING
- THE ELECTRICAL SYSTEMS AND TO REPAIR TO "LIKE NEW CONDITION" TO BE PROVIDED AND INSTALLED BY ELECTRICAL CONTRACTOR. (COORDINATE WITH GENERAL CONTRACTOR).
- 7. PROVIDE AND INSTALL ANY ADDITIONAL HANGERS/SUPPORTS REQUIRED TO ACCOMMODATE ANY EQUIPMENT
- 8. COORDINATE ALL CEILING MOUNTED DEVICES WITH ARCHITECTURAL REFLECTED CEILING AND WORK OF ALL

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REUSE EXISTING RACEWAY AND OUTLETS WITHIN EXISTING WALL PARTITIONS WHERE POSSIBLE. WHERE EXISTING RACEWAY CANNOT BE REUSED. CONTRACTOR TO PROVIDE NEW RACEWAYS EQUIVALENT TO THE DESIGN INTENT. FINAL APPROVAL TO BE MADE BY THE ARCHITECT, ENGINEER, OR OWNER'S REPRESENTATIVE PRIOR TO INSTALLATION.



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ORANGE COUNTY

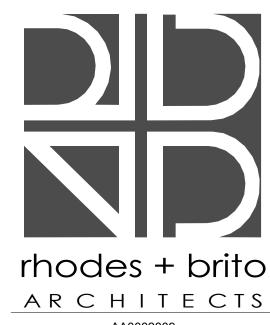DIVISION OF BUILDING SAFETY RENOVATION

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03/15/17

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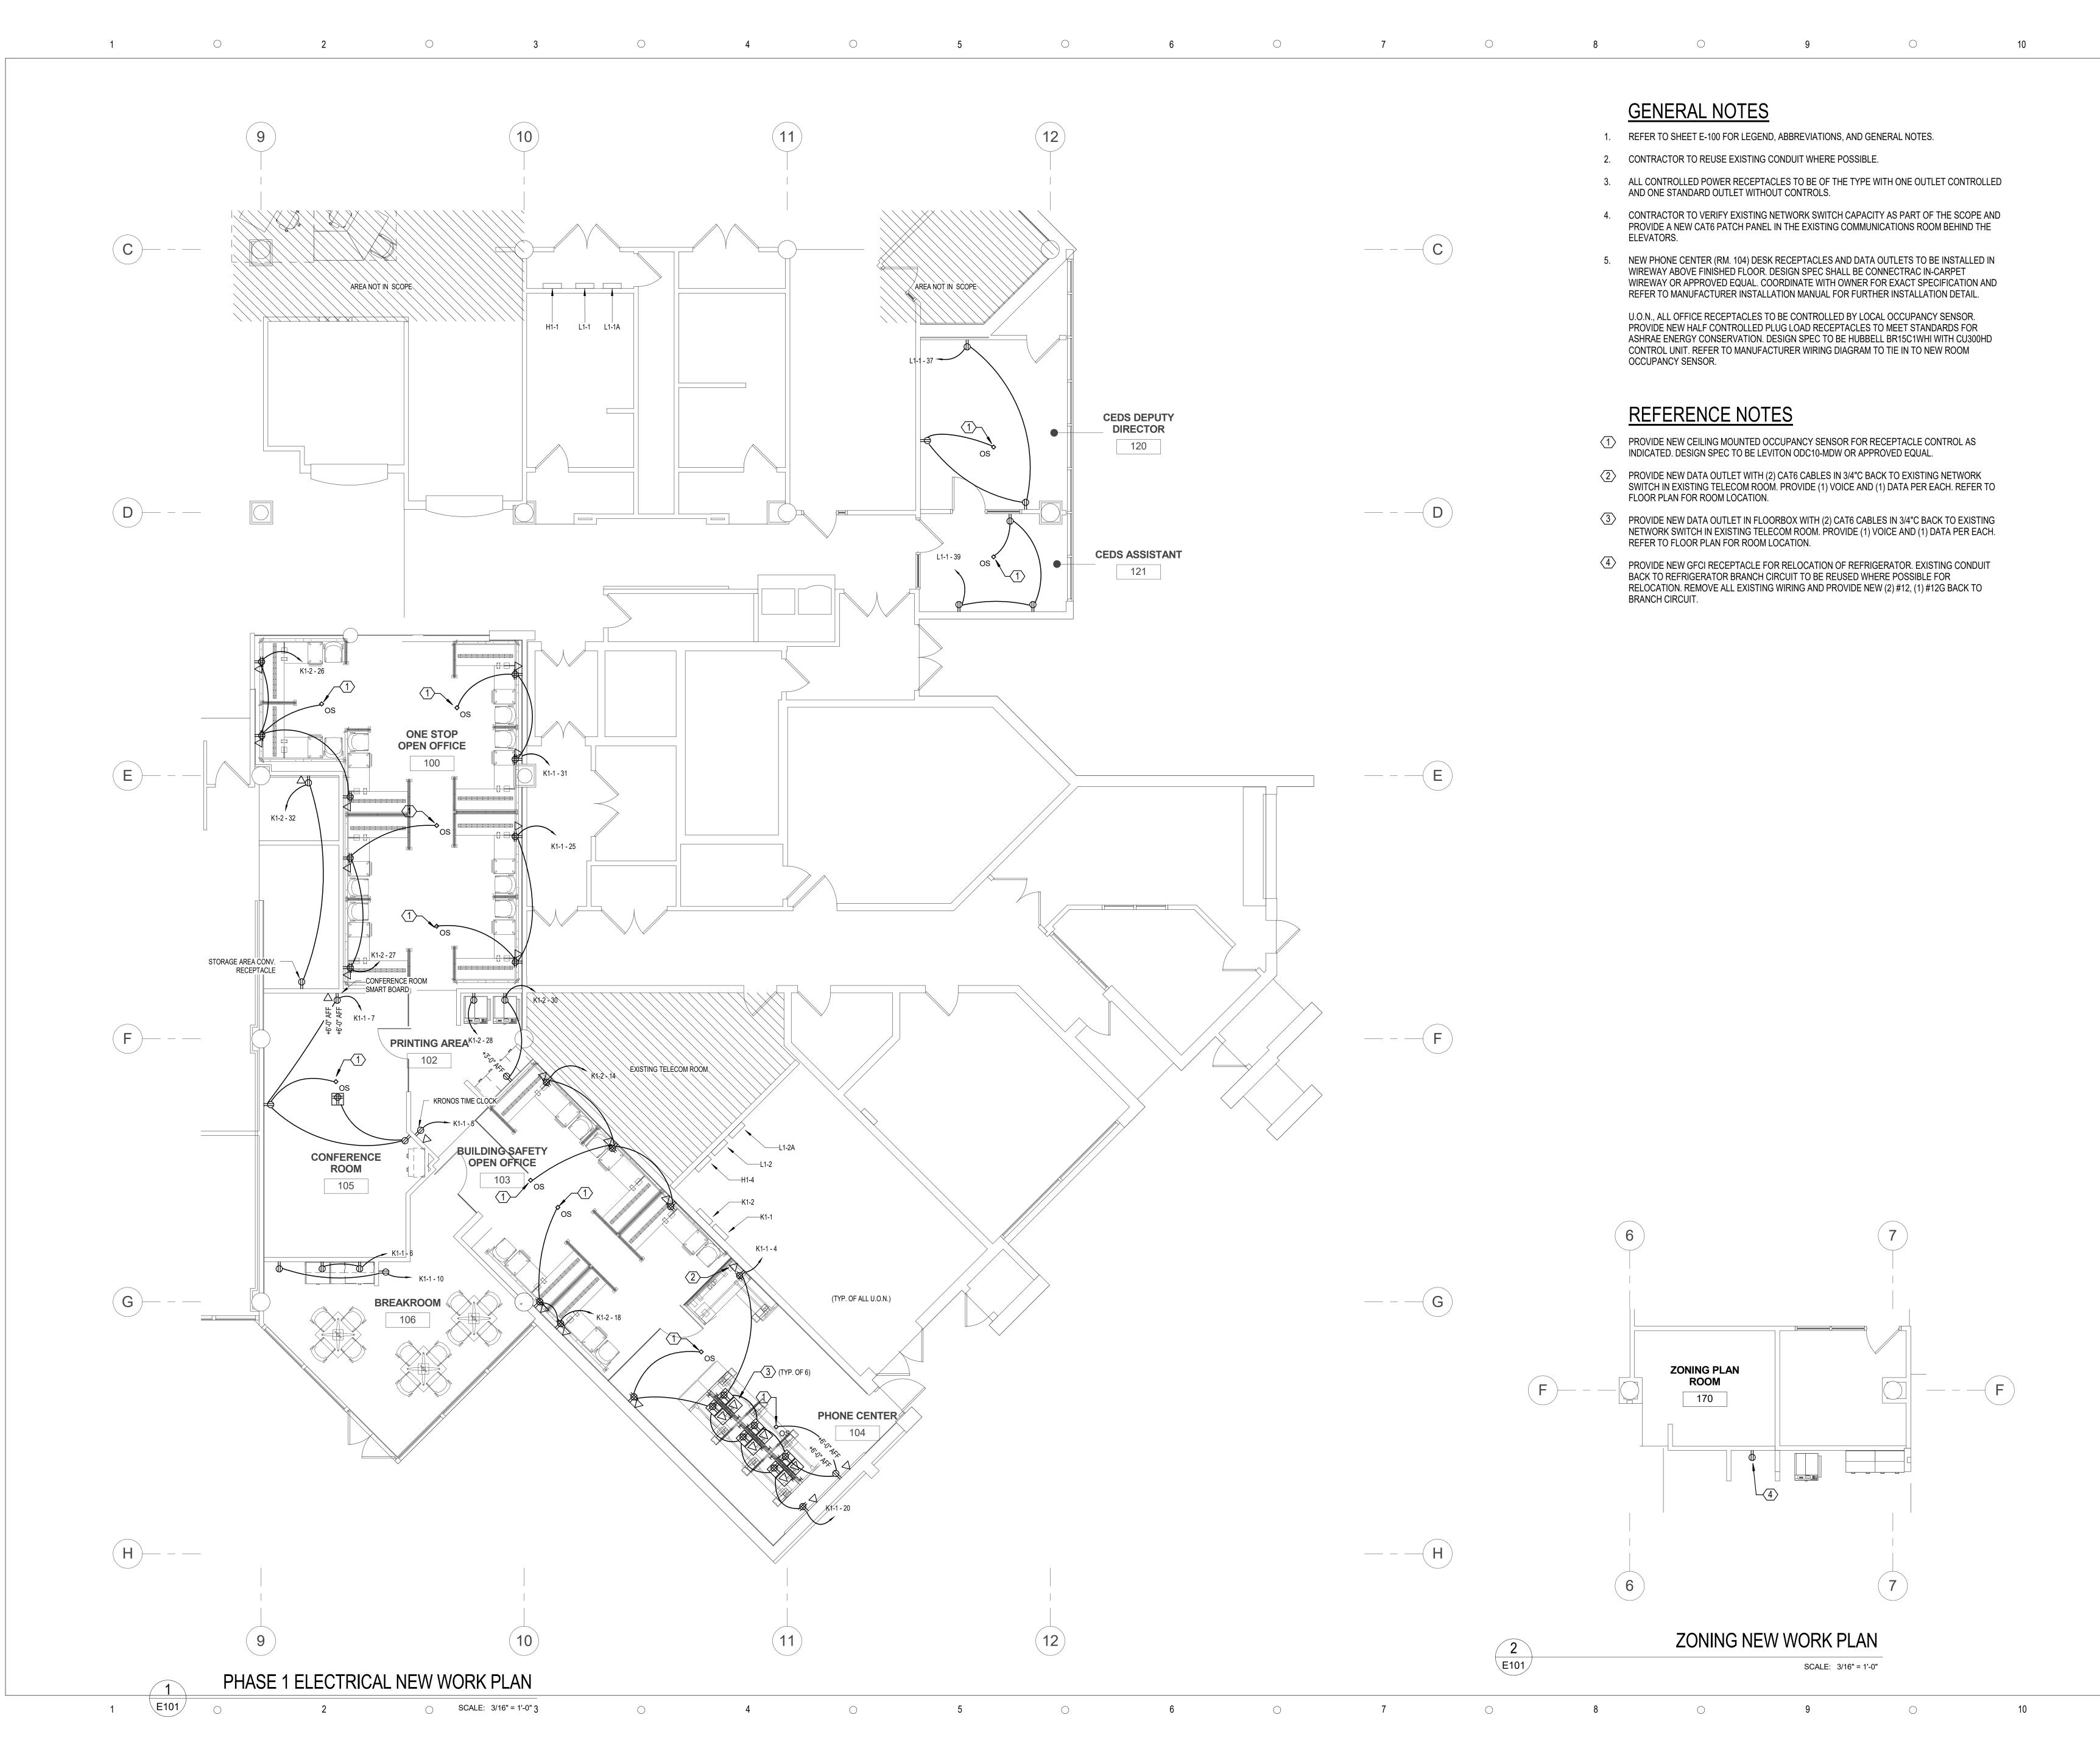
62471

BID DOCUMENTS

DATE SUBMISSION / REVISION NO.

LEGEND, ABBREVIATIONS, AND

SCALE: AS INDICATED DRAWN BY: M. LARUE T. COMER CHECK BY: DATE: September 22, 2017 PROJECT NUMBER:





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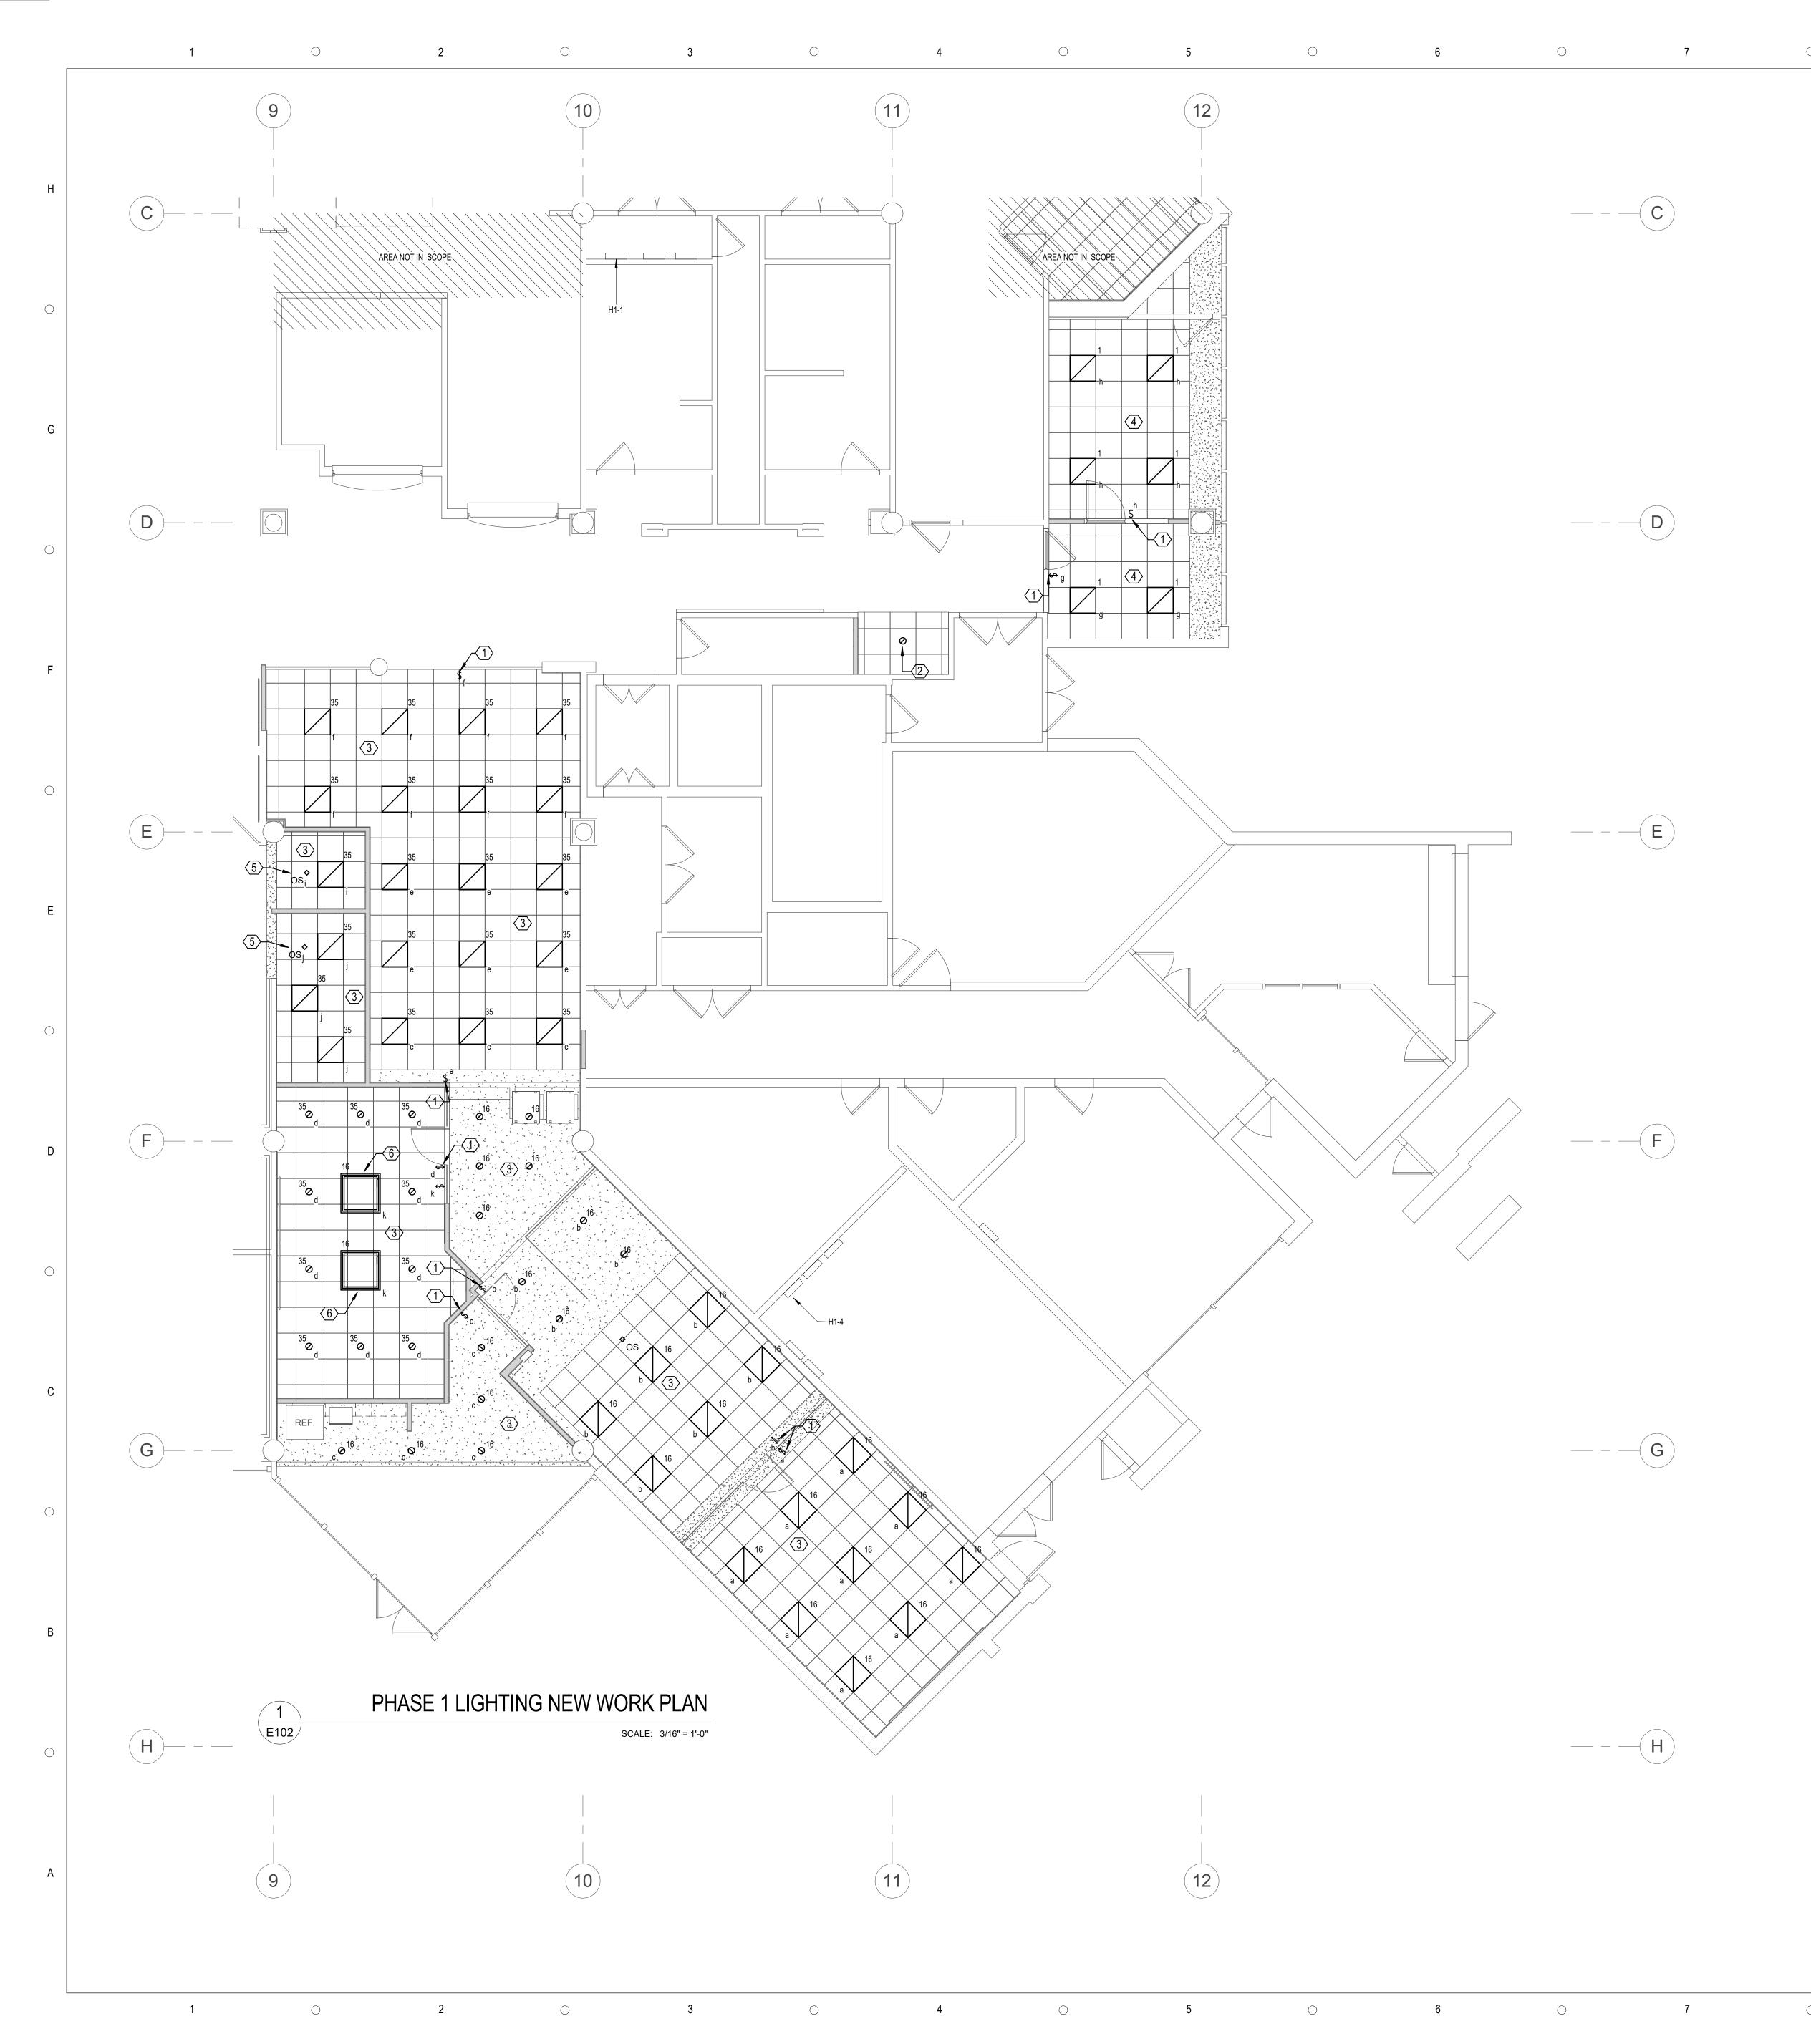
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DATE SUBMISSION / REVISION NO.

PHASE ONE POWER NEW WORK PLAN

SCALE:	AS INDICATED
DRAWN BY:	M. LARUE
CHECK BY:	T. COMER
DATE:	August 21, 2017
PROJECT NUMBER:	15012-0031

E101



GENERAL NOTES

- 1. REFER TO SHEET E-100 FOR LEGEND, ABBREVIATIONS, AND GENERAL NOTES.
- 2. CONTRACTOR TO REUSE EXISTING CONDUIT WHERE POSSIBLE.
- 3. NEW 2X2 LED TROFFER DESIGN SPEC SHALL BE LITHONIA: 2BZL2-30L-SLD-LP840 OR APPROVED EQUAL.
- 4. NEW 6" LED DOWNLIGHT DESIGN SPEC SHALL BE PRESCOLITE: LBP6-6LBP15L-30K OR APPROVED EQUAL.

REFERENCE NOTES

- PROVIDE NEW WALL MOUNTED STEP DIMMING OCCUPANCY SENSOR FOR LIGHTING CONTROL OF GENERAL OFFICE AND WORK AREAS AS INDICATED. SWITCH VOLTAGE TO MATCH BRANCH CIRCUIT VOLTAGE.
- CONNECT NEW DOWNLIGHT TO EXISTING HALLWAY LIGHTING BRANCH CIRCUIT AND SWITCH LEG. PROVIDE (2) #12, (1) #12G IN 3/4"C FROM NEAREST HALLWAY LIGHTING JUNCTION BOX TO NEW FIXTURE.
- LIGHT CIRCUIT NUMBERS INDICATED IN THIS ROOM ARE CIRCUITED BACK TO BRANCH PANEL 'H1-4'. REFER TO SYMBOL LEGEND ON E-100 FOR CIRCUIT NUMBER AND CONTROL INDICATION.
- LIGHT CIRCUIT NUMBERS INDICATED IN THIS ROOM ARE CIRCUITED BACK TO BRANCH PANEL 'H1-1'. REFER TO SYMBOL LEGEND ON E-100 FOR CIRCUIT NUMBER AND CONTROL INDICATION.
- PROVIDE NEW CEILING MOUNTED OCCUPANCY SENSOR FOR LIGHTING CONTROL OF AREA AS INDICATED. SENSOR VOLTAGE TO MATCH BRANCH CIRCUIT VOLTAGE.
- PROVIDE NEW SQUARE LED PENDANT FOR CONFERENCE ROOM FEATURE LIGHTING. DESIGN SPEC SHALL BE VOIGHT LIGHTING: TIMO-LED750L4K-SQHPFR-ACST-3X3-SIL-UNIV OR APPROVED EQUAL.



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DATE SUBMISSION / REVISION NO.

PHASE ONE LIGHTING NEW WORK PLAN

SCALE:	AS INDICATED
DRAWN BY:	M. LARUE
CHECK BY:	T. COMER
DATE:	September 22, 2017
PROJECT NUMBER:	15012-0031

E102



- REFER TO ARCHITECTURAL ELEVATIONS FOR FINAL MOUNTING HEIGHTS OF ALL DEVICES. UNLESS OTHERWISE NOTED, ARCHITECTURAL ELEVATIONS SHALL DICTATE MOUNTING
- COORDINATE LOCATIONS AND MOUNTING HEIGHTS OF ALL DEVICES WITH ARCHITECTURAL
- ALL EQUIPMENT SHALL BE NEW, U.L. LISTED, AND SHALL BE LISTED FOR USE AND
- THE FIRE ALARM SYSTEM SHALL CONSIST OF A FIRE DETECTION, CONTROL, SIGNALING, AND
- CABLE TYPE, SIZE AND INSTALLATION REQUIREMENTS SHALL COMPLY WITH ARTICLE 760 OF NFPA 70, NATIONAL ELECTRICAL CODE FOR POWER LIMITED FIRE PROTECTION SIGNALING CIRCUITS-WIRING METHODS AND MATERIALS.
- ALL WIRING AND CONDUIT TO CONFORM TO NFPA 70, NATIONAL ELECTRICAL CODE (2011 EDITION). WIRE SHALL BE SOLID COPPER OR STRANDED COPPER WITH A MAXIMUM OF 7 STRANDS FOR SIZES 16 AND 18AWG. STRANDED COPPER WITH A MAXIMUM OF 19 STRANDS.
- 11. ALL WIRING INSTALLED IN DUCTS, PLENUMS AND OTHER SPACES USED FOR ENVIROMENTAL AIR SHALL BE TYPE FPLP, AS PER NFPA 70, NATIONAL ELECTRICAL
- AUDIBLE COMPONENTS SHALL BE HORN/STROBES, AND SHALL CONFORM WITH NFPA
- VISUAL DEVICES SHALL BE XENON, WITH A MINIMUM CANDELA RATING OF 30 CANDELA AND SHALL BE PLACED AT 80" TO THE BOTTOM OR 6" FROM THE CEILING WHICHEVER IS LOWER PER ARTICLE 4.28 OF THE FLORIDA ACCESSIBILITY CODE. VISUAL DEVICES SHALL CONFORM WITH NFPA 72, FOR SPACING IN ROOMS
- AND THE FLORIDA FIRE PREVENTION CODE .
- ALARM SYSTEM, AS FINALED. DEVICES SHOWN ON PLANS MAY NEED TO BE RELOCATED DUE TO ACTUAL BUILDING DESIGN.
- 17. CIRCUIT POLARITY MUST BE OBSERVED.
- CONDUIT FILL SHALL BE NO MORE THAN 40%, PER NFPA 70, NATIONAL ELECTRICAL CODE.
- WILL PRODUCE AN AUDIBLE AND VISIBLE ANNUNCIATION AT THE PANEL(S) AND ANY REMOTE ANNUNCIATOR.
- UPON COMPLETION OF THE INSTALLATION A "CERTIFICATE OF COMPLETION" SHALL BE PROVIDED TO THE CUSTOMER AND THE LOCAL AUTHORITY HAVING JURISDICTION. AN OWNERS MANUAL AND INSTALLATION INSTRUCTIONS COVERING ALL SYSTEM EQUIPMENT, RECORD DRAWINGS AND FOR SOFTWARE BASED SYSTEMS, A RECORD COPY OF SITE-SPECIFIC SOFTWARE.
- 24. ALL EQUIPMENT SHALL BE INSTALLED IN CONFORMITY OF THE LIFE SAFETY CODE NFPA 101.
- 25. THE DESIGN INSTALLATION COMPLIES WITH THE FBC-B 2014 5TH EDITION.
- 26. BUILDING IS SPRINKLED.
- BUILDING IS A RENOVATION OF AN EXISTING SPACE.
- REVIEW AND APPROVAL BY AHJ SHALL NOT RELIEVE THE APPLICANT OF THE RESPONSIBILITY OF COMPLIANCE WITH THIS CODE

FIRE ALARM SCOPE OF WORK:

SUPPLY AND INSTALL NEW FIRE ALARM DEVICES TO ACCOMODATE NEW OFFICE LAYOUT, NEW DEVICES TO REMAIN COMPATIBLE WITH EXISTING FIRE ALARM CONTROL PANEL

A = 2 COND #18 FPL - SIGNALING LINE CIRCUIT V = 2 #12 THHN SOLID ORANGE/BROWN - NAC STROBES - NOTIFICATION APPLIANCE CIRCUIT S = 2 #14 THHN SOLID GRAY/WHITE - NAC HORN - NOTIFICATION APPLIANCE CIRCUIT

INITIATING DEVICE CIRCUIT (IDC) = CLASS B SIGNALING LINE CIRCUIT (SLC) = CLASS B - STYLE 4 NOTIFICATION APPLIANCE CIRCUIT (NAC) = CLASS B FACP NETWORK CIRCUIT = CLASS A - STYLE 6

GENERAL SYSTEMS NEW CONSTRUCTION NOTES:

NOTIFICATION SYSTEM.


- HEIGHTS OF ALL DEVICES.
- CASEWORK.
- CONTRACTOR TO PROVIDE DEVICES COMPATIBLE WITH NEW F.A.C.P., REFER TO FLOOR PLAN FOR CANDELA & HORN WATTAGE REQUIREMENTS.
- 7. THE FIRE ALARM EQUIPMENT SHALL BE "POWER LIMITED".
- MINIMUM CABLE SIZE REFER TO WIRE LEGEND.

- ALARM NOTIFICATION APPLIANCES SHALL BE VISUAL, AUDIBLE-VISUAL AND/OR AUDIBLE TYPE.
- 72, FOR LOCATION, SPACING AND AUDIBILITY REQUIREMENTS.
- AND CORRIDORS. IF MORE THAN 2 VISUAL DEVICES ARE IN ANY FIELD OF VIEW THEY SHALL BE SYNCHRONIZED, PER NFPA 72.
- MANUAL PULL STATIONS SHALL BE INSTALLED IN CONFORMANCE WITH NFPA 72
- CONTRACTOR WILL MAKE ANY CORRECTIONS TO DRAWINGS TO REFLECT THE FIRE
- 19. THE FIRE ALARM PANEL(S) SHALL NOT BE USED TO POWER ANY UNAUTHORIZED EXTERNAL DEVICES.
- ALL FIRE STOP PENETRATIONS SHALL BE SEALED WITH A UL APPROVED FIRESTOP MATERIAL.
- 21. FIRE ALARM RISER CIRCUITS SHALL BE CLASS "B", STYLE "Y" & STYLE "4".
- A BREAK IN ANY FIELD WIRING OR GROUNDING OF ANY CONDUCTOR WILL RESULT IN THE ACTIVATION OF THE FIRE ALARM CONTROL PANEL(S) "TROUBLE" SIGNAL WHICH

-FIRE ALARM WIRE LEGEND-

-CIRCUIT TYPE / STYLE LEGEND-

ALL CIRCUITS ARE COPPER CONDUCTORS - 2010 NFPA 72 DESIGNATIONS

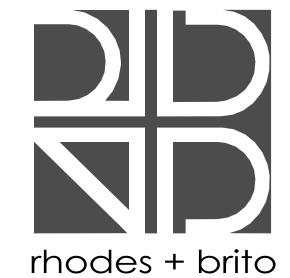

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DATE SUBMISSION / REVISION NO.

PHASE ONE FIRE **ALARM NEW WORK** PLAN

SCALE:	AS INDICATED
DRAWN BY:	T. COMER
CHECK BY:	T. COMER
DATE:	September 22, 2017
PROJECT NUMBER:	15012-0031

E103



GENERAL NOTES

- 1. REFER TO SHEET E-100 FOR LEGEND, ABBREVIATIONS, AND GENERAL NOTES.
- 2. ALL PANEL BOARDS ARE EXISTING TO REMAIN.

REFERENCE NOTES

- ALL EXISTING BRANCH CIRCUITS FOR KITCHEN EQUIPMENT TO BE DEMOLISHED BACK TO BRANCH PANELS 'K1-1' AND 'K1-2'.
- ALL EXISTING ELECTRICAL DEVICES, EQUIPMENT, AND BRANCH CIRCUITS TO BE DEMOLISHED BACK TO ASSOCIATED BRANCH PANEL.





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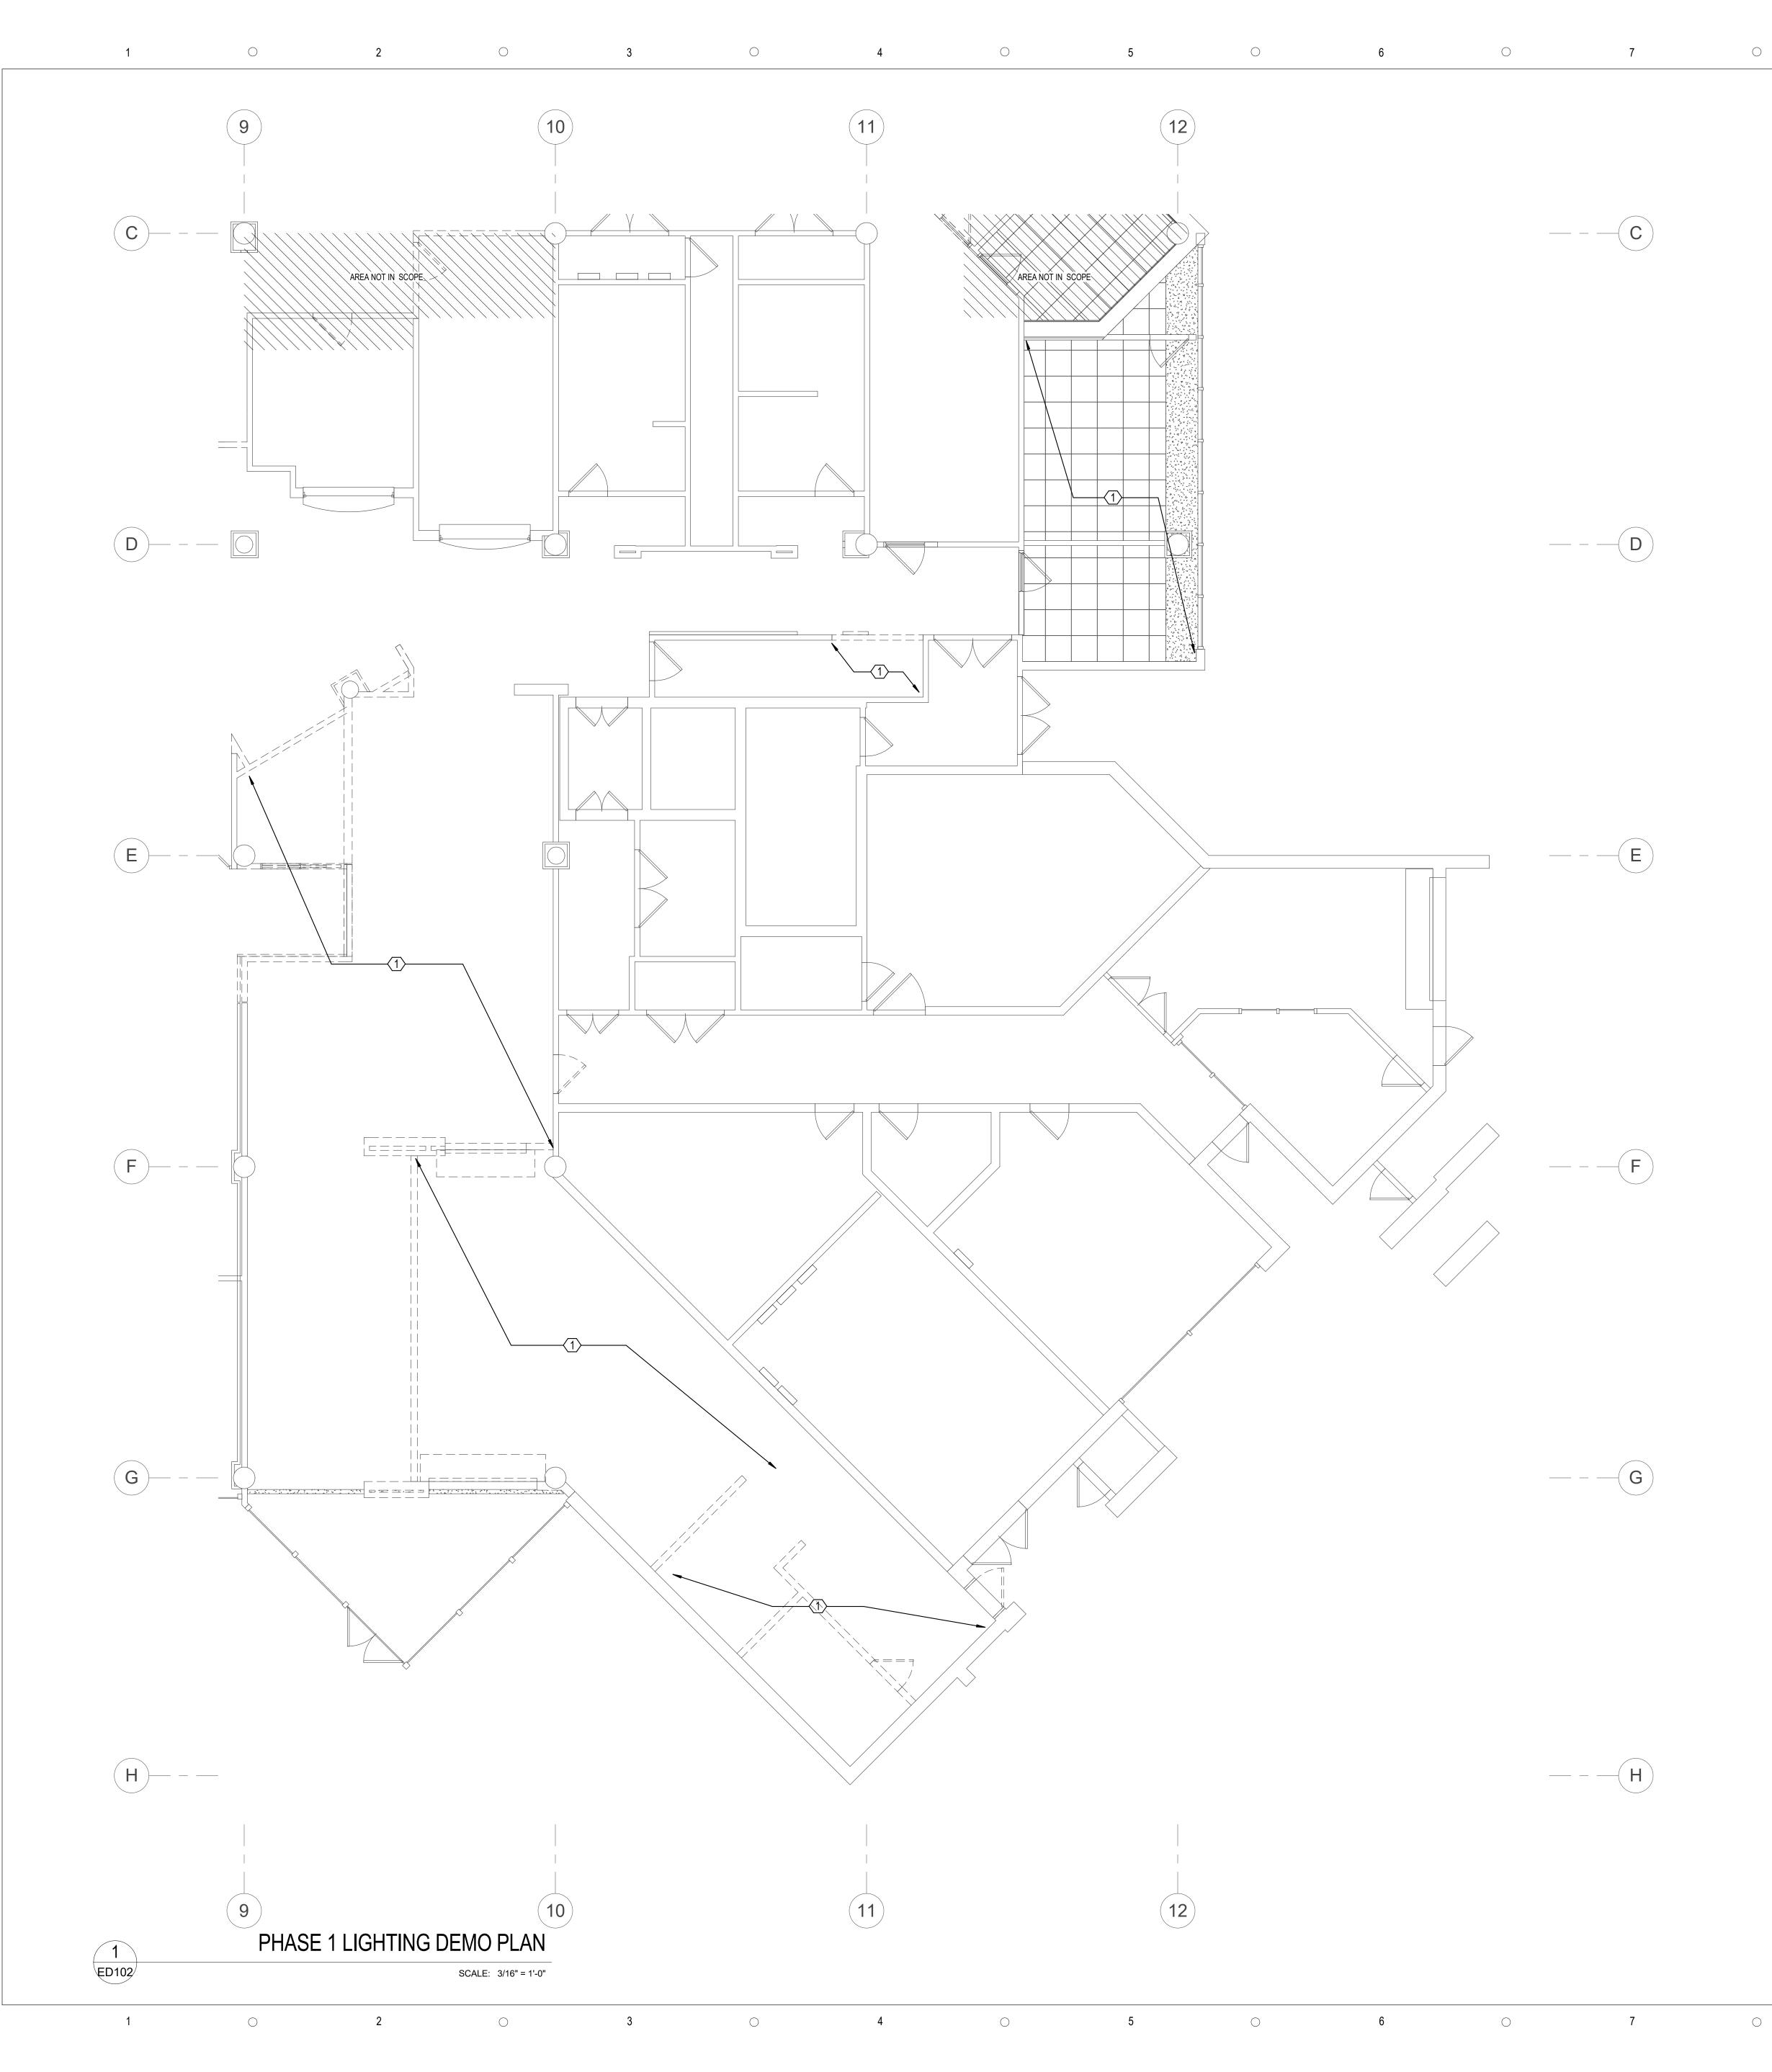
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DATE SUBMISSION / REVISION NO.

PHASE ONE POWER DEMO PLAN

SCALE:	AS INDICATED
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CHECK BY:	T. COMER
DATE:	September 22, 2017
PROJECT NUMBER:	15012-0031

ED101



GENERAL NOTES

- 1. REFER TO SHEET E-100 FOR LEGEND, ABBREVIATIONS, AND GENERAL NOTES.
- 2. ALL PANEL BOARDS ARE EXISTING TO REMAIN.

REFERENCE NOTES

ALL EXISTING LIGHTING FIXTURES IN THIS AREA SHALL BE REMOVED. ALL LIGHTING BRANCH CIRCUITS SHALL BE REMOVED COMPLETE BACK TO ASSOCIATED BRANCH PANEL.



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PHASE ONE LIGHTING DEMO PLAN

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ED102