# ORANGE COUNTY CAPITAL PROJECT DIVISION INTERNAL OPERATIONS CENTER II 400 E. SOUTH STREET, 5TH FLOOR ORLANDO, FL 32801

ORANGE COUNTY MAYOR
HONORABLE TERESA JACOBS

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COMMISSIONER DISTRICT 2
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COMMISSIONER DISTRICT 3
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COMMISSIONER DISTRICT 4
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COMMISSIONER DISTRICT 5
EMILY BONILLA

COMMISSIONER DISTRICT 6
VICTORIA P. SIPLIN

ORANGE COUNTY COURTHOUSE
EXTERIOR BUILDING PROTECTION MODIFICATIONS
425 N. ORANGE AVE,
ORLANDO, FL, 32801

ORANGE COUNTY PROJECT MANAGER: JACK DAVIS



CONTACT: KAREN ANDERSON



SGM

ELECTRICAL ENGINER

ELECTRICAL ENGINEER
935 LAKE BALDWIN LANE,
ORLANDO, FL 32814
(407) 767-5188
CONTACT: JOHN J BONOTTO





Orange County
Courthouse



**Orange County** 

Courthouse

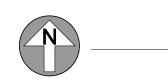

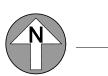

# ARCHITECTURAL ABBREVIATIONS

ARC	HITECTURAL		REVIATIONS
Α		G	
ACCES ACOUS AFF AHJ AL ALT ANNUNC ANOD APPL ARCH AUTO AVG	ACCESSORY ACOUSTIC(AL) ABOVE FINISHED FLOOR AUTHORITY HAVING JURISDICTION ALUMINUM ALTERNATE ANNUNCIATOR ANODIZED APPLIANCE ARCHITECT(URAL) AUTOMATIC AVERAGE	GA GFRC GFRG GFRP GL GR GYP	GAUGE GLASS FIBER REINFORCED CONCRETE GLASS FIBER REINFORCED GYPSUM GLASS FIBER REINFORCED PLASTER GLASS GRAD(E)(ING) GYPSUM
&	AND	HD	HEAD
BLDG BOLLD BD BLKG BRDLM BU	BUILDING BOLLARD BOARD BLOCKING BROADLOOM BUILT UP	HDWD HDWE HM HORIZ HVAC	HARDWOOD HARDWARE HOLLOW METAL HORIZONTAL HEATING, VENTILATING, AND AIR CONDITIONING
С		INFO INSTRUM	INFORMATION INSTRUMENT(ATION)
CAB CPT CEM CER CLG	CABINET CARPET CEMENT(ITIOUS) CERAMIC CEILING	INSUL INTLK INT INFILTR	INSULATION (INTERLOCK(ING)) INTERIOR INFILTRATION
COATG	COATING COILING	JAN	JANITOR
CONC CONSTR CONT	CONCRETE CONSTRUCTION CONTINUOUS(ATION)	K	
CONTR COV	CONTRACT(OR) COVER	KIT	KITCHEN
CMU	CONCRETE MASONRY UNIT	ı	
D		<u> </u>	
DBL DEPT DES DET DF DIA	DOUBLE DEPARTMENT DESIGN(ED) DETAIL DRINKING FOUNTAIN DIAMETER	LAV LB £ LT LVLG LVR	LAVATORY POUND BRITISH POUND (CURRENCY) LIGHT LEVELING LOUVER
DIFF DIM	DIFFUSER DIMENSION	M	
DISP DIV DN \$ DR DSCON DWR	DISPENSER DIVISION DOWN DOLLAR (US CURRENCY) DOOR DISCONNECT DRAWER	MAX MFD MFR MECH MET MEMB MEZZ	MAXIMUM MANUFACTURED MANUFACTURER MECHANICAL METAL MEMBRANE MEZZANINE
E		MIN MISC	MINIMUM MISCELLANEOUS
ELAST ELEC EMBED ENGR	ELASTOMERIC ELECTRICAL EMBEDD(ED)(ING) ENGINEER(ED)	MLWK MOIST MOT MTD	MILLWORK MOISTURE MOTOR(IZED) MOUNTED
ENTR EQ	ENTRANCE EQUAL	<u>N</u>	
EXIST EXP JT	EQUIPMENT EXISTING EXPANSION JOINT EXPOSE(D)	NIC NO NTS	NOT IN CONTRACT NUMBER NOT TO SCALE
EXT	EXTERIOR	0	
FAB FD FE FE&C	FABRICATION FLOOR DRAIN FIRE EXTINGUISHER FIRE EXTINGUISHER AND	ORNA OVFL OVHD OPNG OPR	ORNAMENTAL OVERFLOW OVERHEAD OPENING(S) OPERABLE
FHC	CABINET FIRE HOSE CABINET	P DTN	DADTITION
FIN FLDG FPLC FR FRMG FXD FXTR FLR FURN FUT FWC	FINISH FOLDING FIREPLACE FIRE RAT(ING)(ED) FRAMING FIXED FIXTURE FLOOR(ING) FURNITURE FUTURE FABRIC WALL COVERING	PTN PEDTR PBD P jM PNL POLYST PORT PREFIN PREFAB PLAM PLAS PLSTC	PROJECT MANAGER PANEL POLYSTYRENE PORTABLE PREFINISHED PREFABRICATED PLASTIC LAMINATE PLASTIC
FUT	FUTURE	PLYWD	PLYWOOD

PLYWD PLYWOOD PRTECN PROTECTION

# SCOPE

READER

RECESSED

RECEPTACLE

REFER(ENCE)

REFLECTED REFRIGERATOR

REQUIRED

RESILIENT

ROOFING

ROOM

SCRIBE SECURITY

SINGLE

SHORING SIMILAR

**STANDARD** 

STOREFRONT

STRUCTURAL

SURFACE

SUSPENDED

SYSTEM(S)

THICK

TOILET

TRAFFIC

TREATED

TYPICAL

UNDRLAY UNDERLAYMENT

UTILITY

**VEHICLE** 

WITH

WINDOW WITHOUT

WEIGHT

WTRPRF WATERPROOFING

VERTICAL

VERIFY IN FIELD

WATER CLOSET

TRANSPARENT

TONGUE AND GROOVE

UNLESS NOTED OTHERWISE

STEEL

SQUARE FEET

STAINLESS STEEL

RESIST(ANT)(IVE)

REINFORCE(D)(ING)(MENT)

RDR

SCR

SGL

SST

STD

STRUCT

SYS

TLT

TRTD

TYP

UTIL

### **OVERALL SCOPE OF WORK**

- 1. ORANGE COUNTY FACILITIES IS LOOKING TO INSTALL A BIRD DETERRENT SYSTEM ON MULTIPLE FLOORS TO AVOID THE PRESENCE OF TURKEY VULTURES ON THE BALCONIES AND ROOF OF THE BUILDING.
- 2. REPAIRS TO DAMAGED CAULK JOINTS ON BUILDING FACADE.
- 3. THE MAIN SYSTEMS PROPOSED IS: a. ELECTRIFIED TRACK SYSTEM BIRD DETERRENT
- 4. THE PROJECT SCOPE DOES NOT INCLUDE THE REMOVAL OF THE EXISTING BIRD DETERRENT SYSTEM.

### SCOPE OF WORK NOTES:

- 1. WORK THAT IS NOT STATED HEREIN NOR SHOWN IN THESE PLANS IS NOT PART OF THE SCOPE OF WORK FOR THIS PROJECT.
- 2. ADDITIONAL WORK REQUIRED THAT WOULD ALTER THE PRESENTED SCOPE OF WORK SHALL BE SUBJECT TO A REVISION OF THESE DOCUMENTS AND TO BE REVIEWED BY THE BUILDING DEPARTMENT HAVING JURISDICTION.
- 3. ALL BIDS SHOULD INCLUDE MANUFACTURE'S WARRANTIES FOR A MINIMUM OF 5 YEARS AND INCLUDE A 5-YEAR MAINTENANCE PROGRAM TO BEGIN AT NOTICE OF SUBSTANTIAL COMPLETION
- 4. FOR PURPOSE OF BID USE ESTIMATED QUANTITY OF 150 LINEAR FEET FOR REPAIR OF JOINTS (LUMP SUM). PHOTO DOCUMENTATION OF DAMAGED AREAS SHOULD BE PROVIDED BEFORE ANY CHANGE ORDER.
- 5. THE PROPOSED SYSTEM MUST BE EFFECTIVE AGAINST TURKEY VULTURES, BUT ALSO EFFECTIVE FOR OTHER BIRD SPECIES.
- 6. THE ARCHITECTURAL FEATURES AND ESTHETICS OF THE BUILDING SHOULD NOT BE ALTERED.
- 7. THE INSTALLATION METHODS SHOULD AVOID PERFORATION OF THE LEDGES AND ROOF SURFACES. THE INSTALLATION OF BIRD BARRIER COMPONENTS SHOULD BE CHEMICALLY ATTACHED, PER SPECIFICATIONS, TO MINIMIZE PENETRATIONS.
- 8. A GROUND PENETRATING RADAR (GPR) SCAN SHALL BE PERFORMED PRIOR TO ANY CORE DRILLING TO ENSURE NO DAMAGE OCCURS TO POST-TENSION CABLES

# NOTE TO CONTRACTOR

THE BUILDING WILL REMAIN IN OPERATION DURING CONSTRUCTION.

NIGHT SHIFT WORK MAY BE REQUIRED TO ROUTE CIRCUITS TROUGH EXISTING OFFICES ETC.

CONTRACTOR SHALL VISIT SITE TO BECOME FAMILIAR WITH ROUTING OF CIRCUITS THROUGH EXISTING CEILINGS AND WALLS. REMOVAL OF DRYWALL MAY BE NECESSARY TO FACILITATE ROUTING OF SLEEVE THROUGH WALL TO EXTERIOR ROOF AREA.

# PROJECT INFORMATION DRAWING INDEX

# **ARCHITECTURAL**

	COVER SHEET
A00.00	INDEX
A02.21	FLOOR PLAN LEVEL 21
A02.22	FLOOR PLAN LEVEL 22
A02.23	FLOOR PLAN LEVEL 23
A02.24.5	FLOOR PLAN LEVEL 24-1/2
A03.01	ROOF PLAN
A09.21	DETAILS
A09.22	SITE PICTURES

### **ELECTRICAL**

	E00.00	SYMBOL LEGEND
	E02.21	ELECTRICAL FLOOR PLAN LEVEL 21
	E02.22	ELECTRICAL FLOOR PLAN LEVEL 22
	E02.23	ELECTRICAL FLOOR PLAN LEVEL 23
	E02.24.5	ELECTRICAL FLOOR PLAN LEVEL 24-1/2
	E03.01	ELECTRICAL ROOF PLAN
	E09.01	ELECTRICAL DETAILS
	E09.02	ELECTRICAL PANEL SCHEDULES
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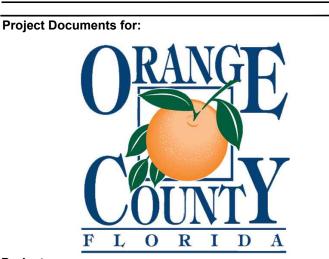
945 N. PENNSYLVANIA AVENUE WINTER PARK, FLORIDA 32789 OFFICE: (407) 629-1188 FAX: (407) 388-1220 WWW. ADCINTERNATIONAL.NET



AA-C001315

AR-95752

STATE OF FLORIDA
MARIA FERREIRA, R.A.
Architect • Seal/Signature



ORANGE COUNTY COURTHOUSE BIRD DETERRENT SYSTEM. 425 N. ORANGE AVE, ORLANDO, FL, 32801

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ş	3	04.20.17	90% CD REVIEW SET	AA	KA
Ź	4	05.17.17	90% CD	AA	KA
SPACE PLANNING	5	05.22.17	90% CD REVIEW SET	AA	KA
AC	6	07.13.17	100% CD	AA	KA
R	7	09.15.17	100% CD REV-01	AA	KA
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<u>z</u> 🚹	06/23/17	AA	
	ADDENDUM 1		
	07/13/17	AA	
	PROCUREMENT COMMENTS		
INTERIOR	09/15/17	AA	
Z	PROCUREMENT COMMENTS		

Client Information
ORANGE COUNTY CAPITAL PROJECTS DIVISION
400 E SOUTH STREET 5th FLOOR
ORLANDO, FL 32801

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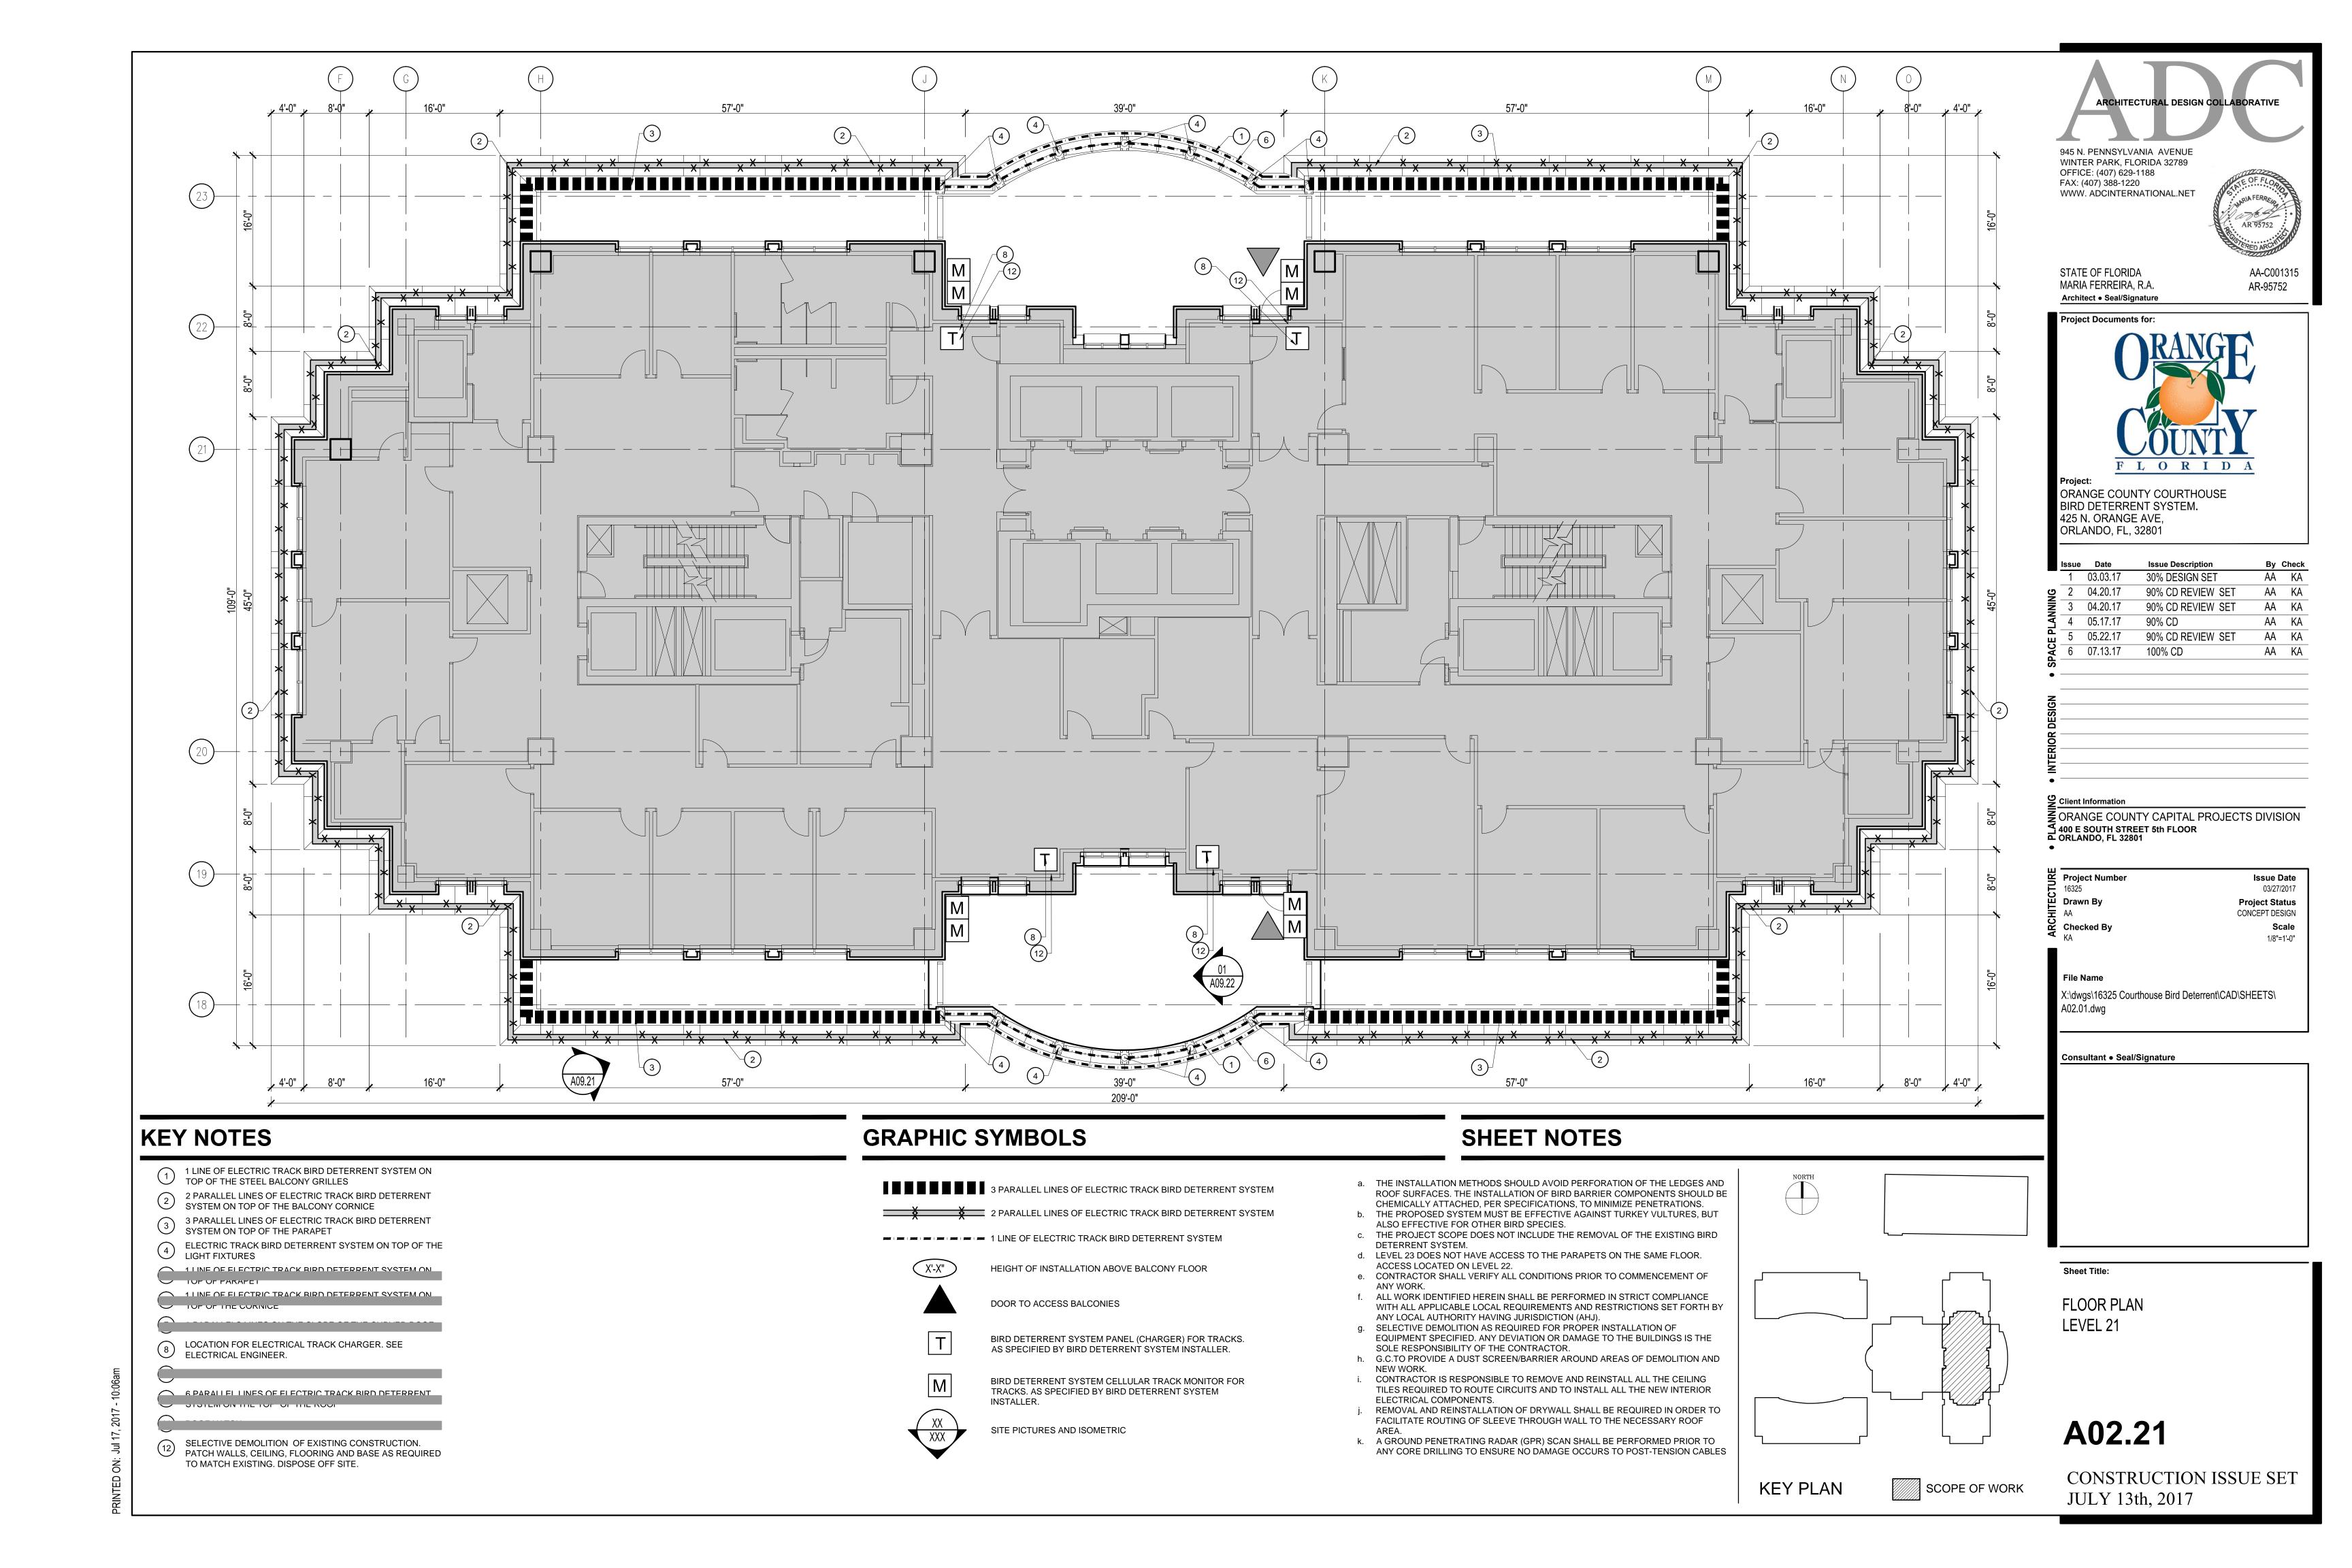
Consultant ● Seal/Signature


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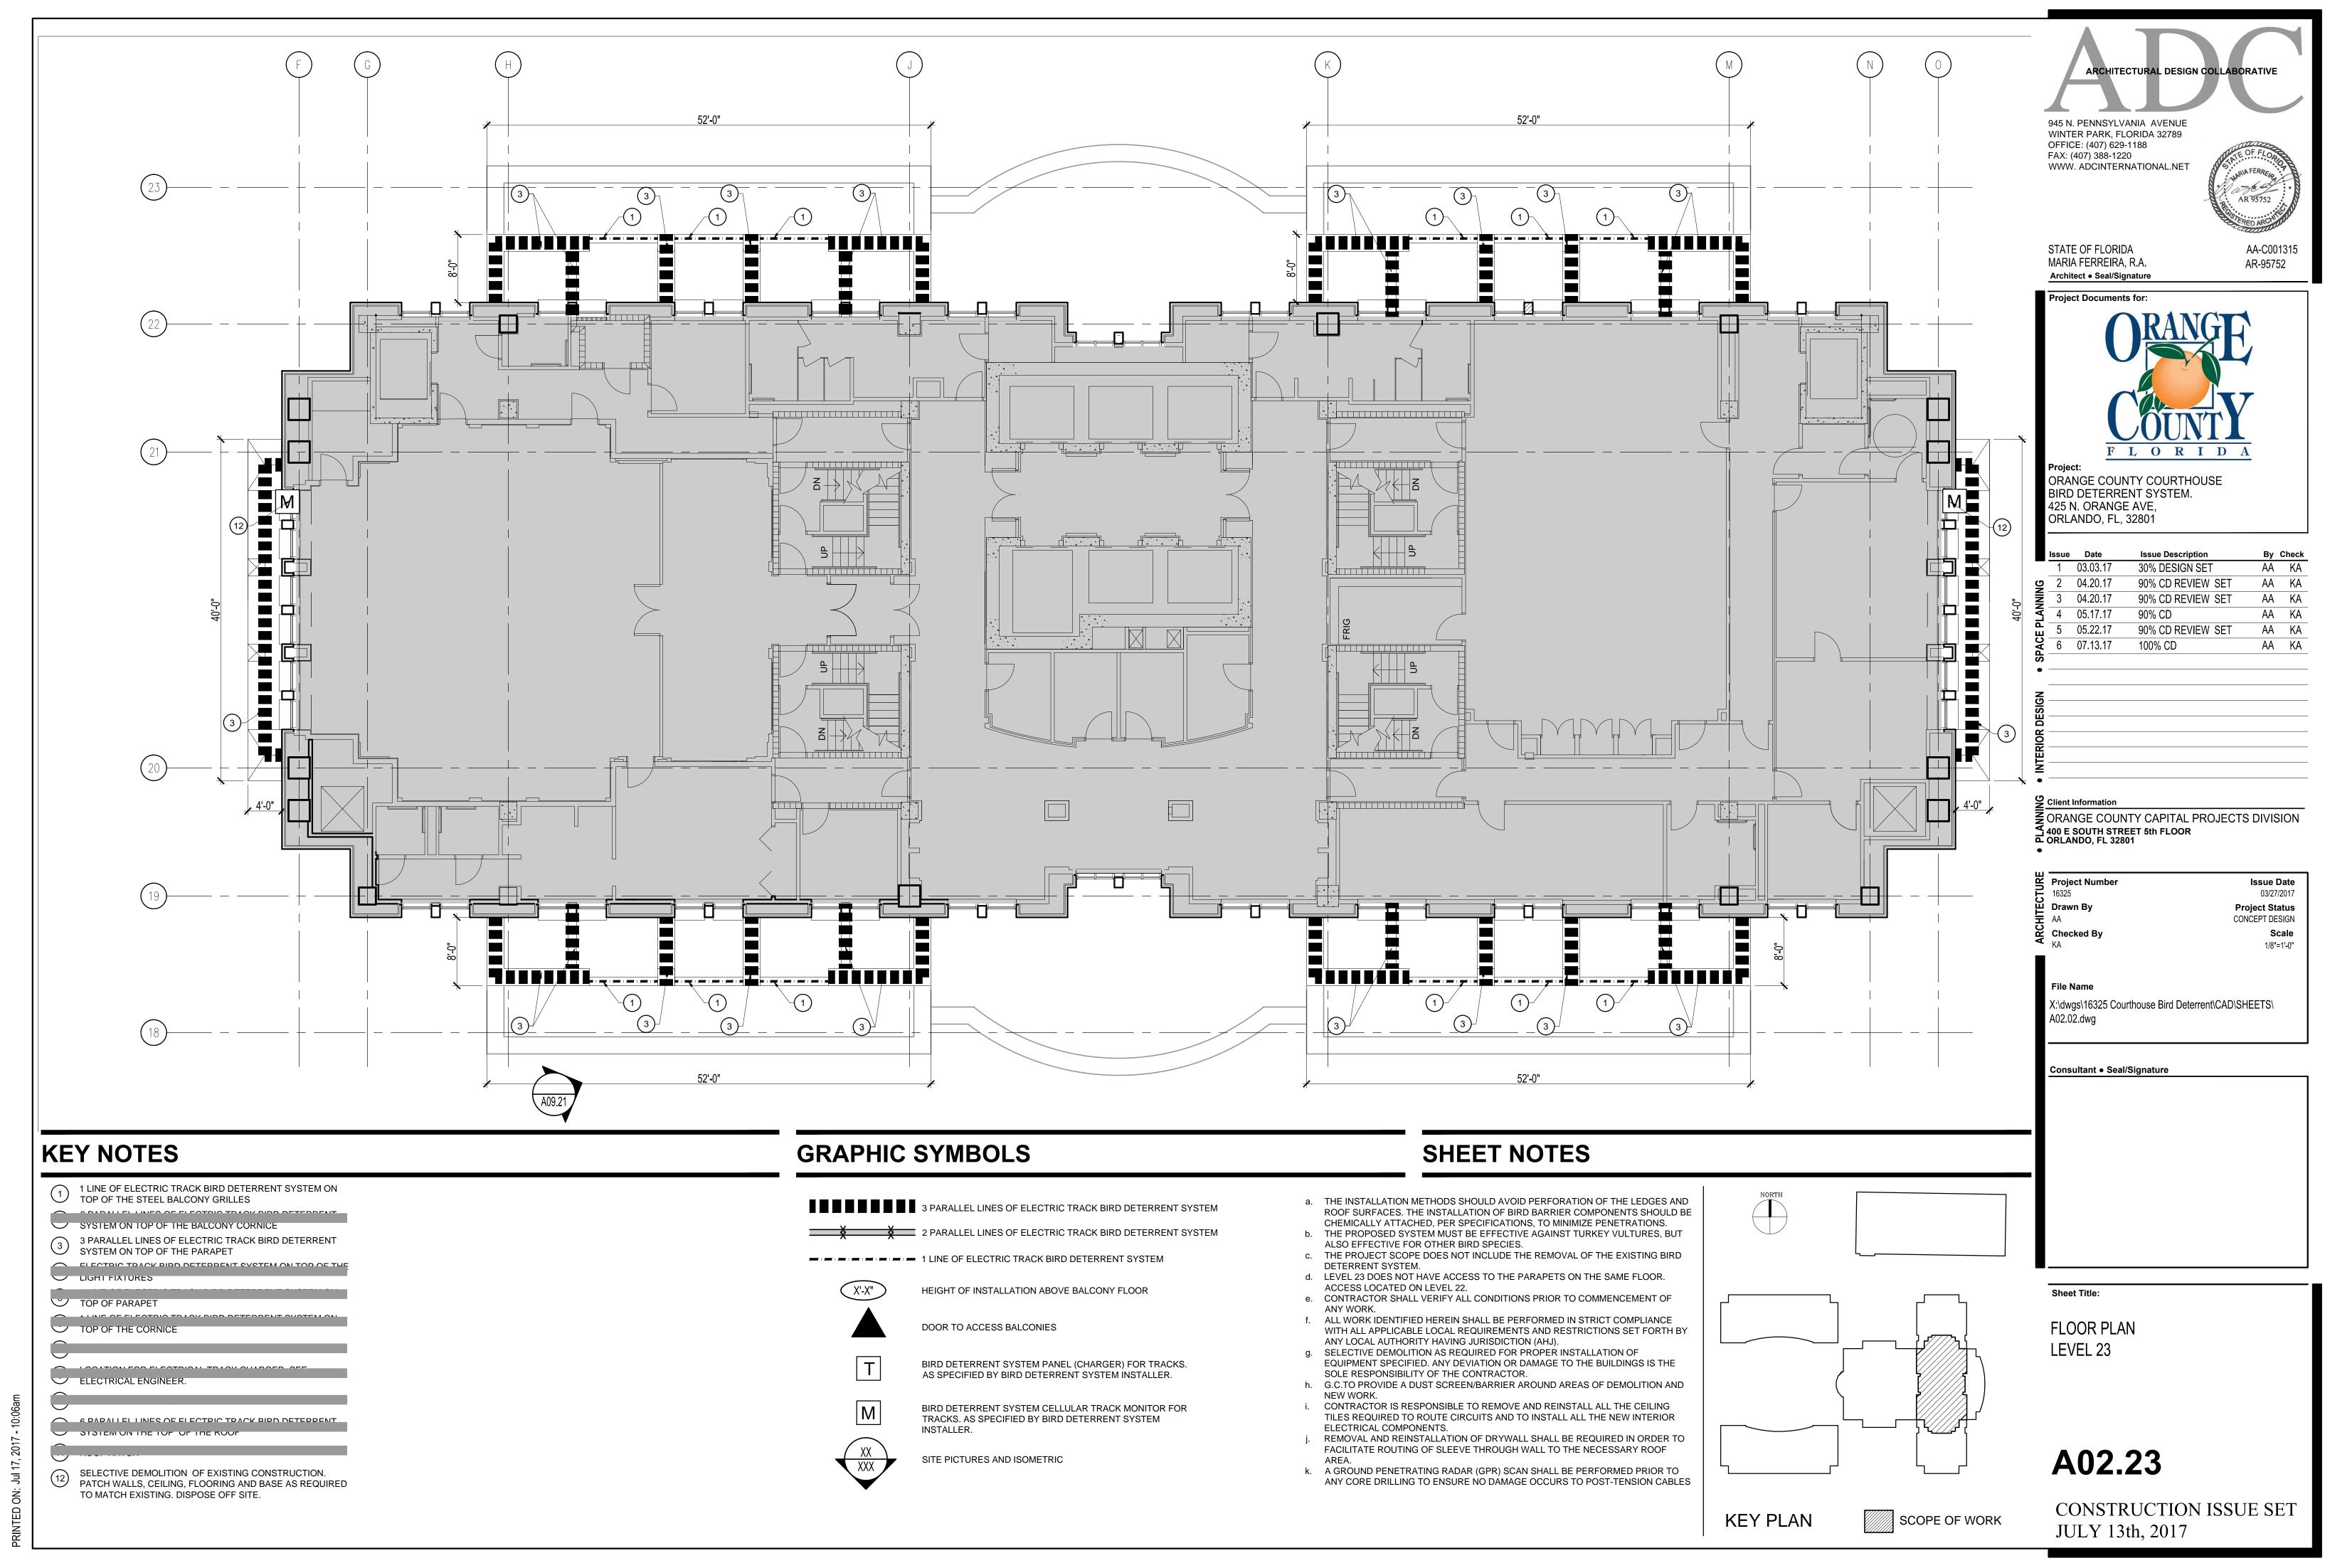
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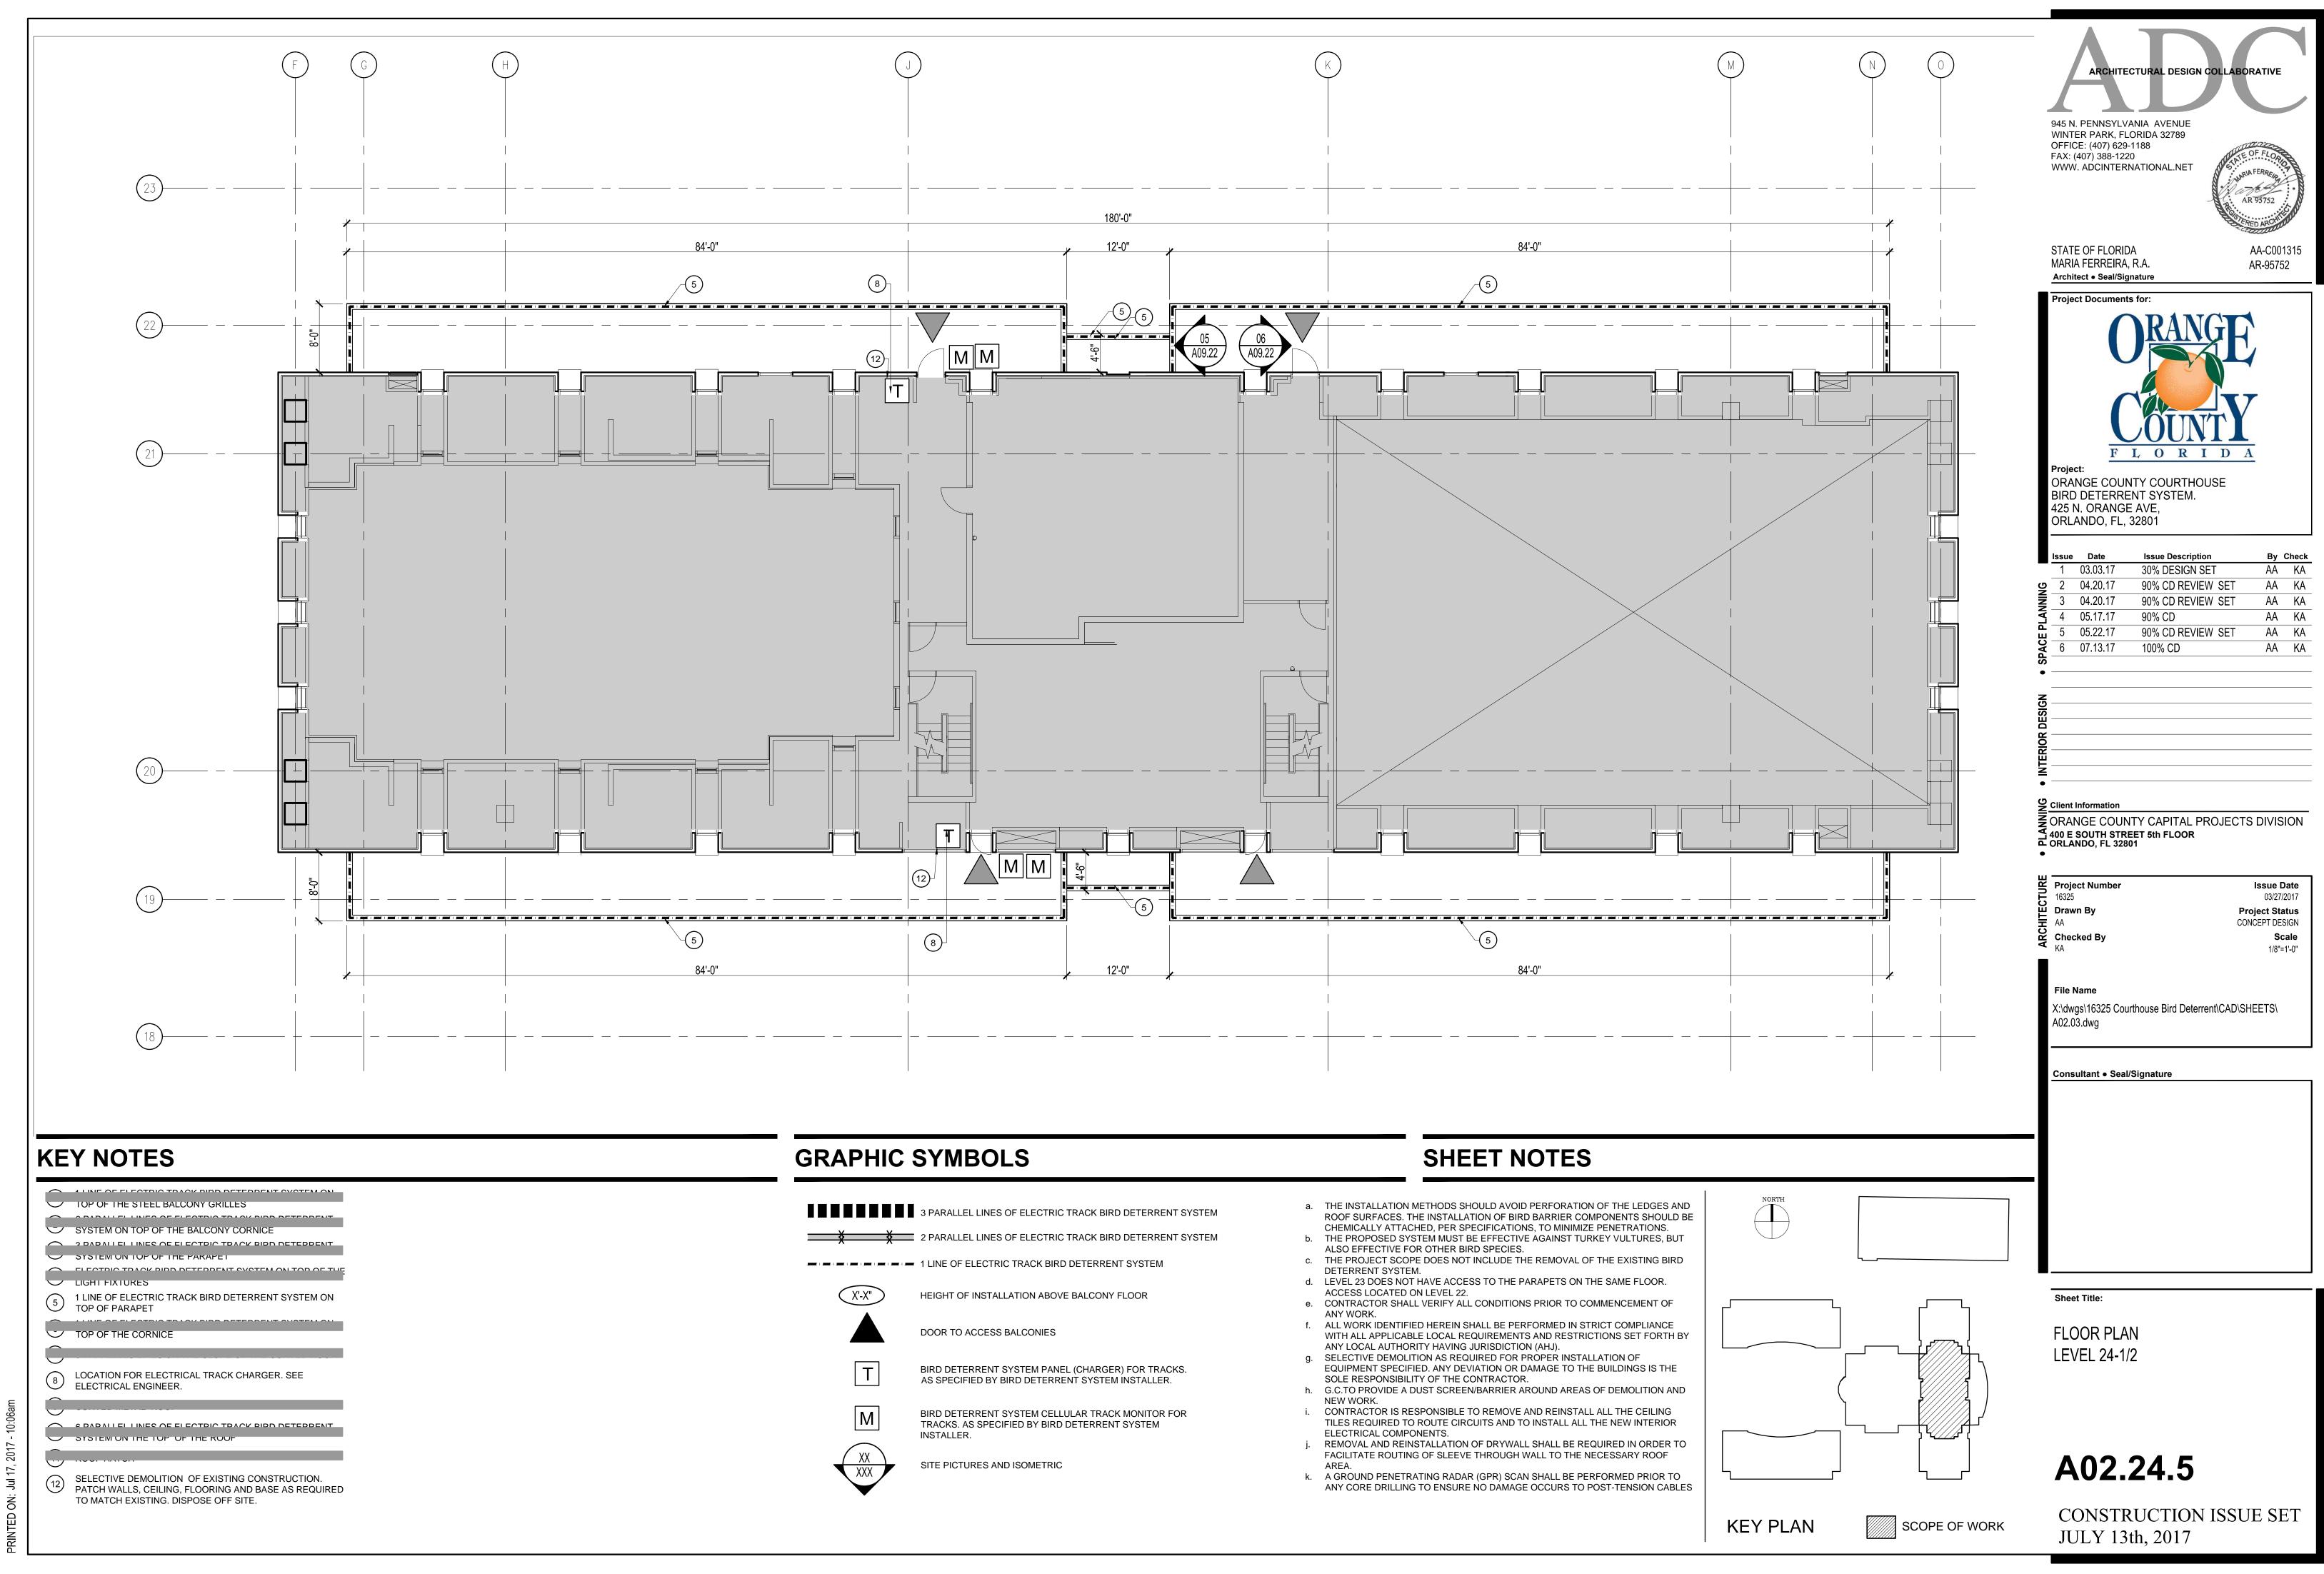
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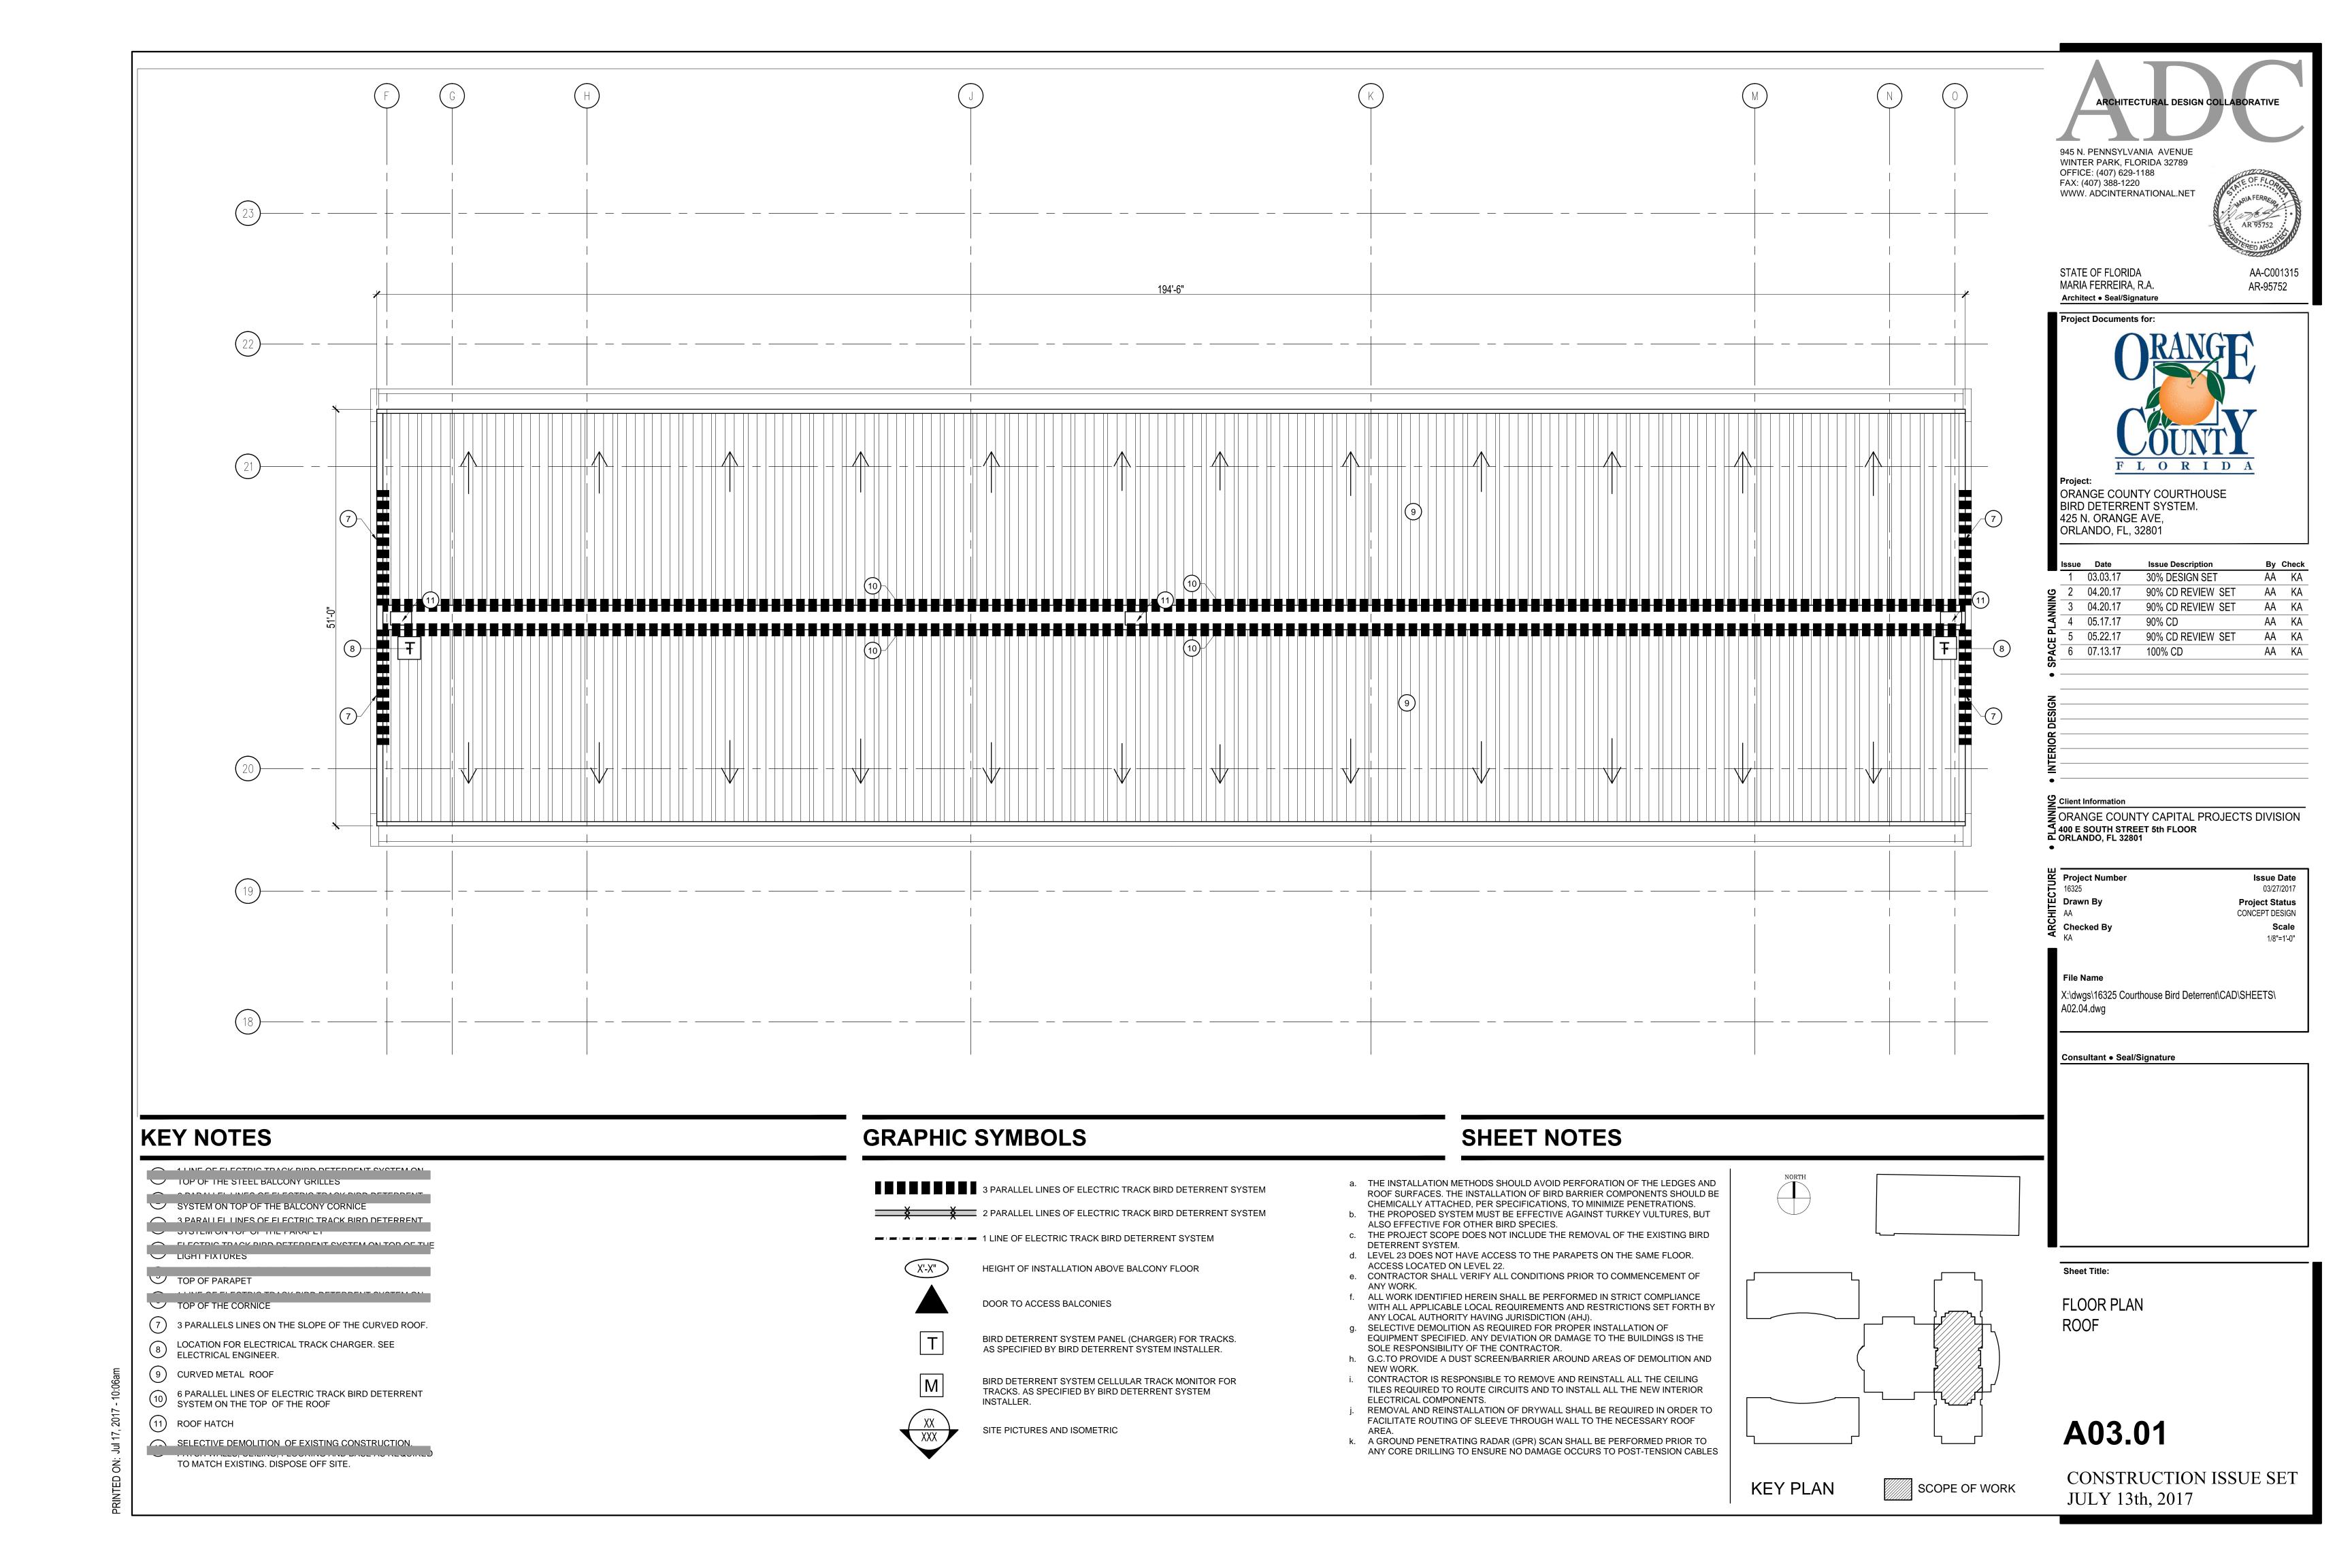
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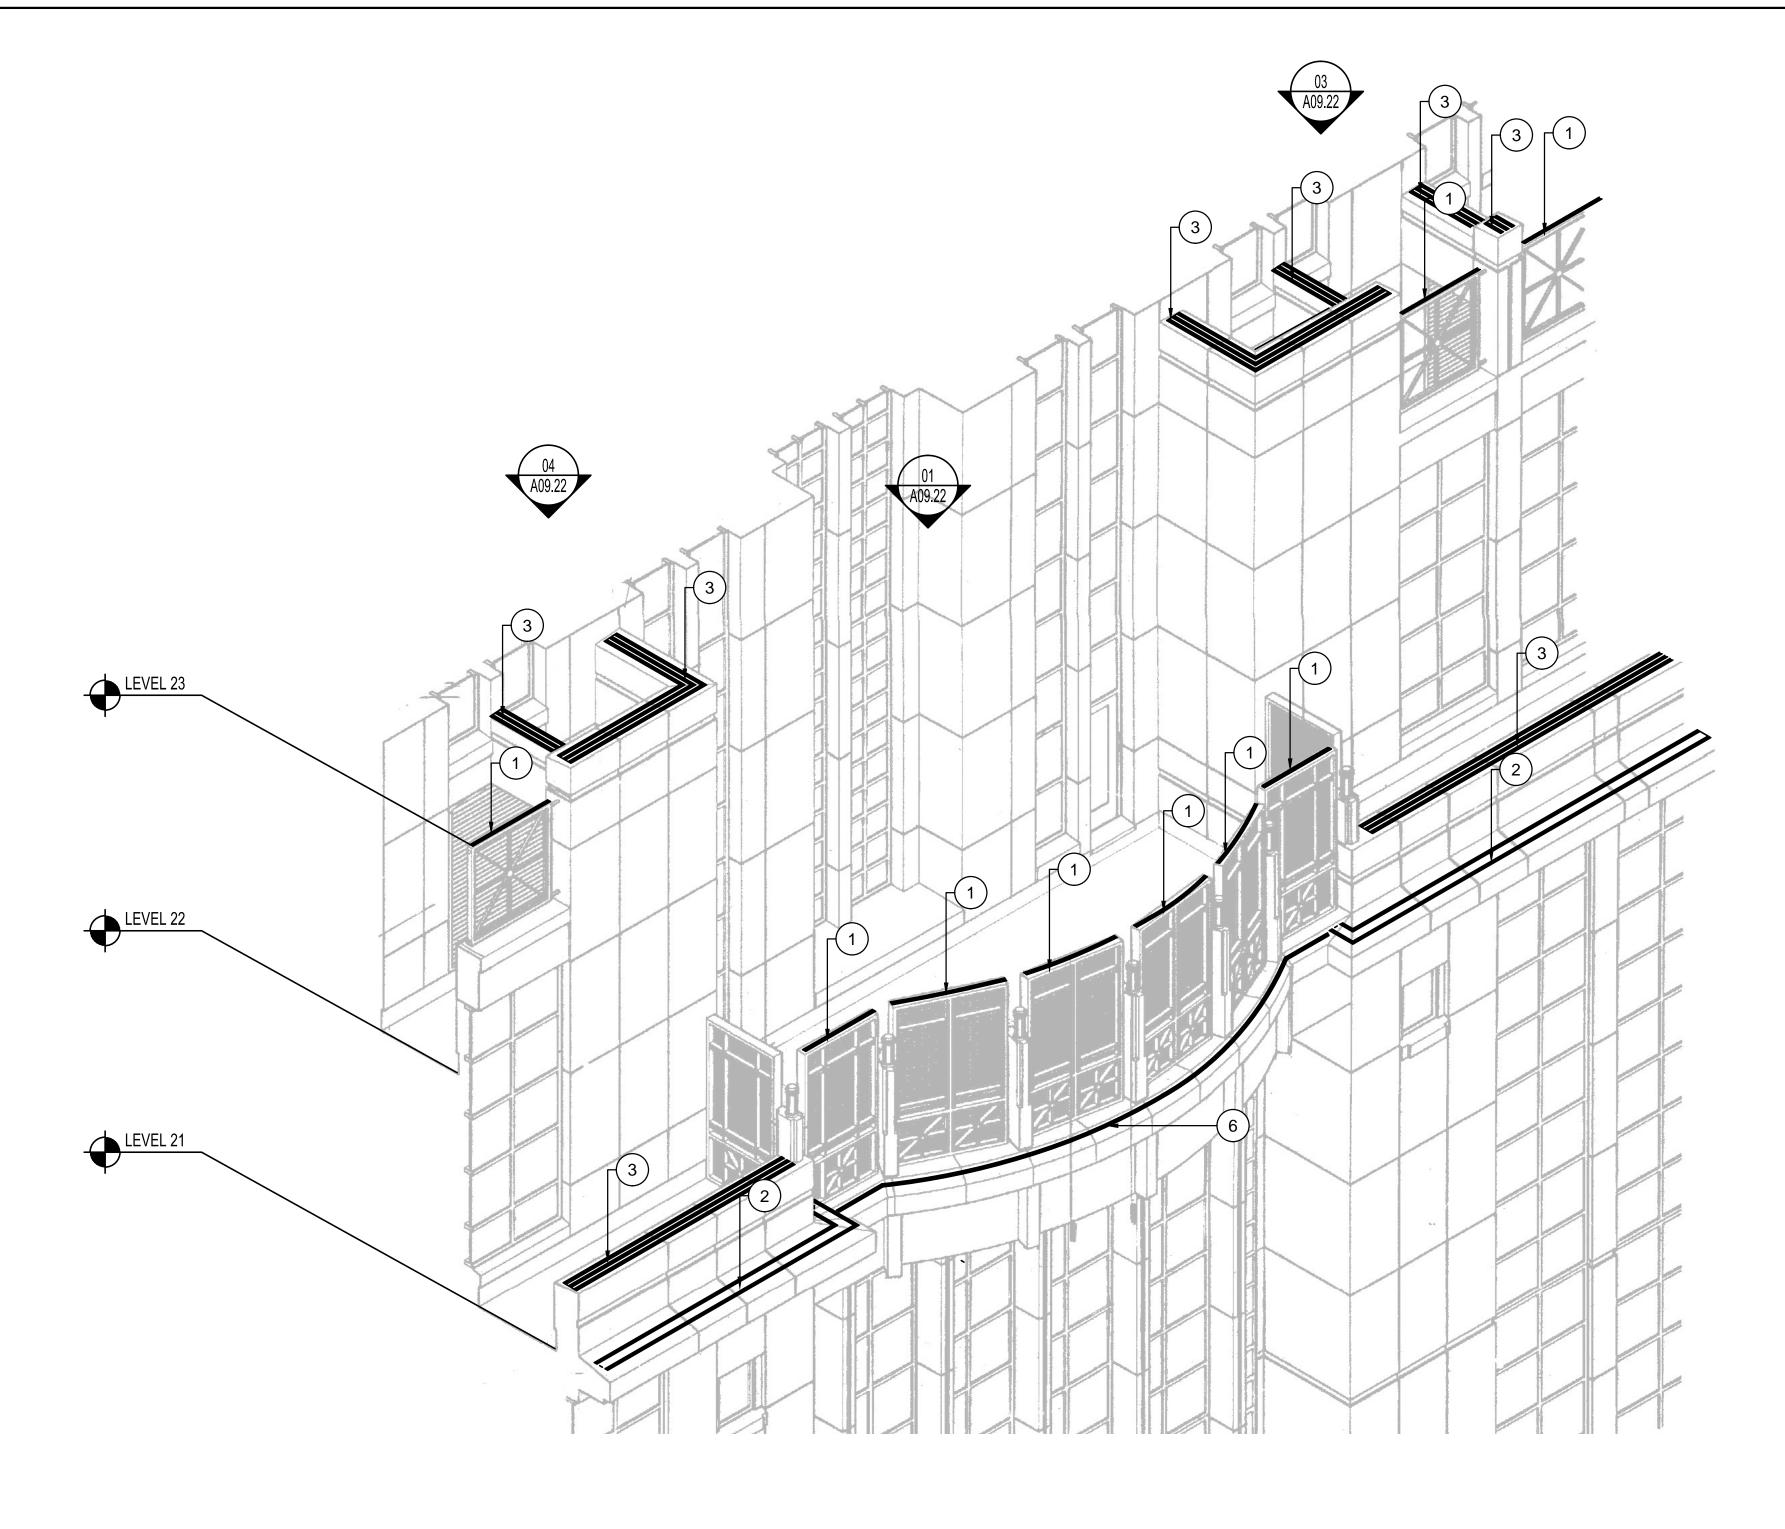











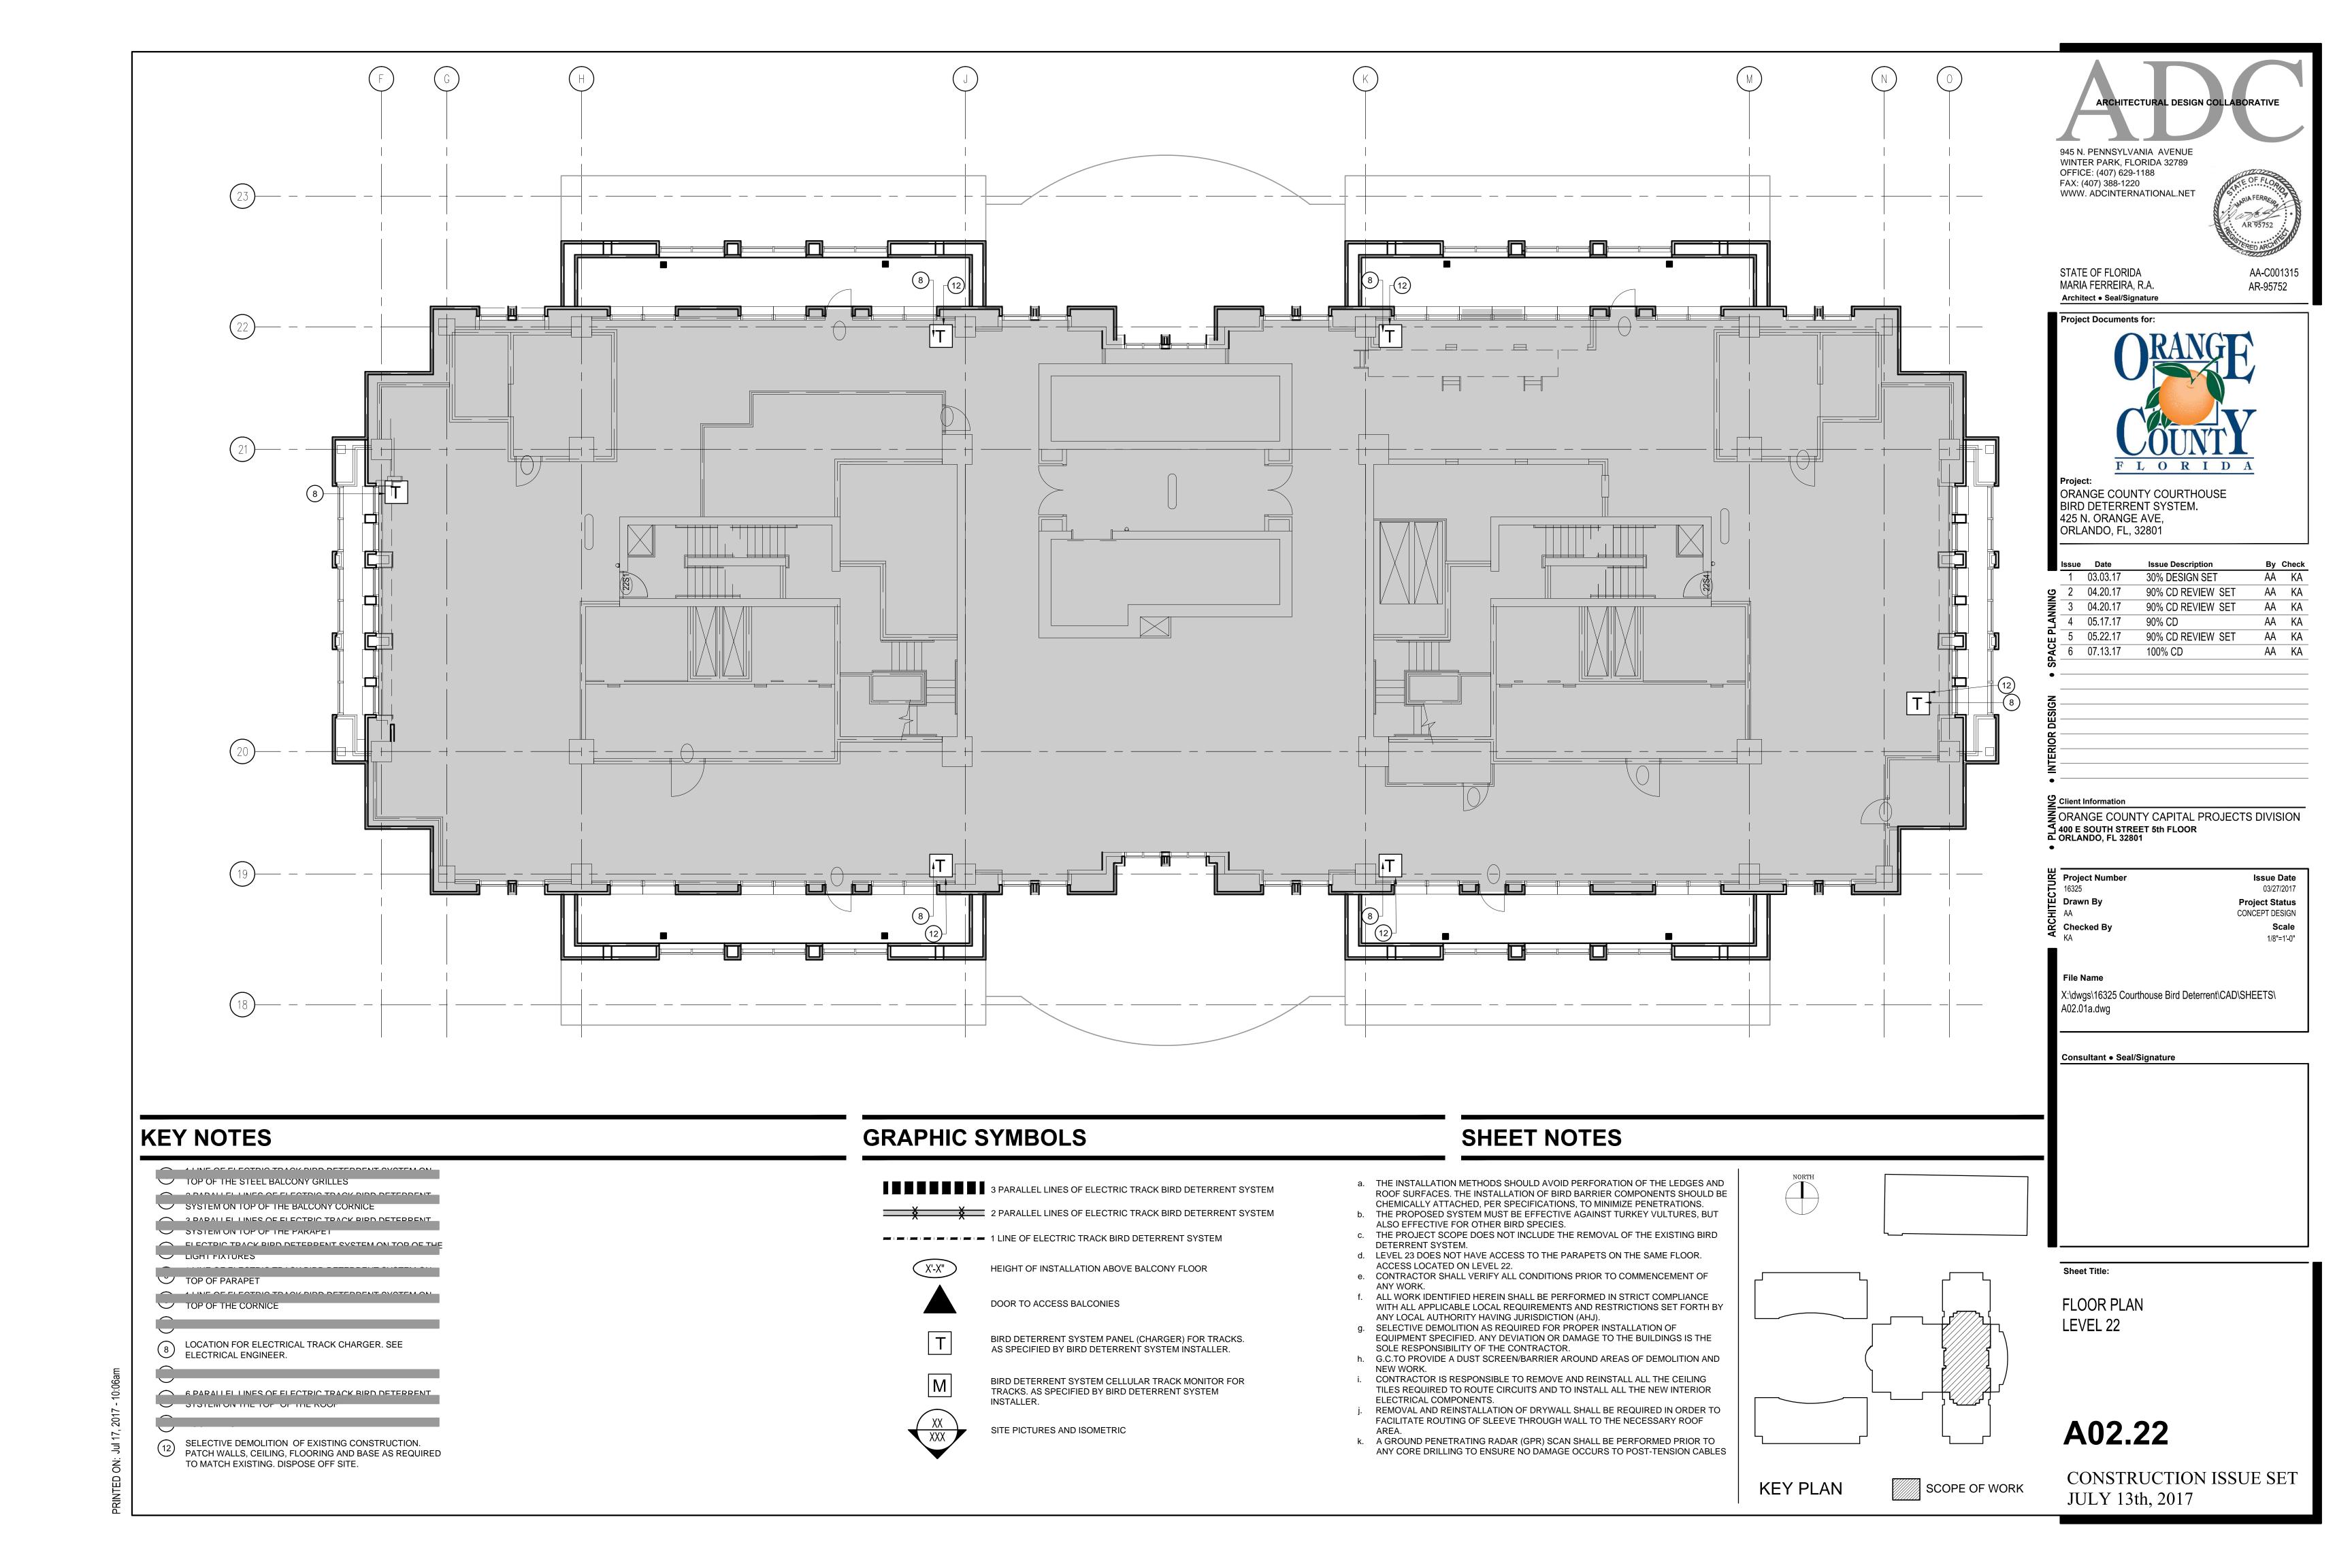

ARCHITECTURAL DESIGN COLLABORATIVE 945 N. PENNSYLVANIA AVENUE WINTER PARK, FLORIDA 32789 OFFICE: (407) 629-1188 FAX: (407) 388-1220 WWW. ADCINTERNATIONAL.NET

STATE OF FLORIDA MARIA FERREIRA, R.A. Architect • Seal/Signature AA-C001315 AR-95752

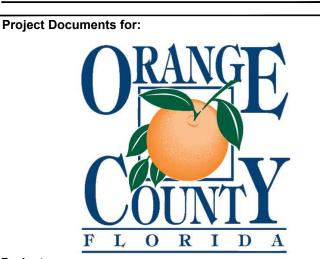

ORANGE COUNTY COURTHOUSE BIRD DETERRENT SYSTEM. 425 N. ORANGE AVE, ORLANDO, FL, 32801

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PLANNING	3	04.20.17	90% CD REVIEW SET	AA	KA
Š	4	05.17.17	90% CD	AA	KA
	5	05.22.17	90% CD REVIEW SET	AA	KA
SPACE	6	07.13.17	100% CD	AA	KA
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Client Information ORANGE COUNTY CAPITAL PROJECTS DIVISION
400 E SOUTH STREET 5th FLOOR
ORLANDO, FL 32801

**Project Number** Issue Date 16325 □ Drawn By Project Status CONCEPT DESIGN

03/27/2017

Scale

File Name

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Consultant • Seal/Signature

Checked By

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# **KEY NOTES**

- 1 LINE OF ELECTRIC TRACK BIRD DETERRENT SYSTEM ON TOP OF THE STEEL BALCONY GRILLES
- 2 PARALLEL LINES OF ELECTRIC TRACK BIRD DETERRENT SYSTEM ON TOP OF THE BALCONY CORNICE
- 3 PARALLEL LINES OF ELECTRIC TRACK BIRD DETERRENT SYSTEM ON TOP OF THE PARAPET
- 4 ELECTRIC TRACK BIRD DETERRENT SYSTEM ON TOP OF THE LIGHT FIXTURES
- 1 LINE OF ELECTRIC TRACK BIRD DETERRENT SYSTEM ON TOP OF PARAPET
- 6 1 LINE OF ELECTRIC TRACK BIRD DETERRENT SYSTEM ON TOP OF THE CORNICE
- 7 3 PARALLELS LINES ON THE SLOPE OF THE CURVED ROOF.
- 8 LOCATION FOR ELECTRICAL TRACK CHARGER. SEE ELECTRICAL ENGINEER.
- 9 CURVED METAL ROOF
- 6 PARALLEL LINES OF ELECTRIC TRACK BIRD DETERRENT SYSTEM ON THE TOP OF THE ROOF
- 11) ROOF HATCH
- SELECTIVE DEMOLITION OF EXISTING CONSTRUCTION.
  PATCH WALLS, CEILING, FLOORING AND BASE AS REQUIRED TO MATCH EXISTING. DISPOSE OFF SITE.

a. THE INSTALLATION METHODS SHOULD AVOID PERFORATION OF THE LEDGES AND ROOF SURFACES. THE INSTALLATION OF BIRD BARRIER COMPONENTS SHOULD BE CHEMICALLY ATTACHED, PER SPECIFICATIONS, TO MINIMIZE PENETRATIONS.

SHEET NOTES


ALSO EFFECTIVE FOR OTHER BIRD SPECIES. c. THE PROJECT SCOPE DOES NOT INCLUDE THE REMOVAL OF THE EXISTING BIRD

b. THE PROPOSED SYSTEM MUST BE EFFECTIVE AGAINST TURKEY VULTURES, BUT


- DETERRENT SYSTEM. d. LEVEL 23 DOES NOT HAVE ACCESS TO THE PARAPETS ON THE SAME FLOOR.
- ACCESS LOCATED ON LEVEL 22.
- e. CONTRACTOR SHALL VERIFY ALL CONDITIONS PRIOR TO COMMENCEMENT OF ANY WORK. f. ALL WORK IDENTIFIED HEREIN SHALL BE PERFORMED IN STRICT COMPLIANCE
- ANY LOCAL AUTHORITY HAVING JURISDICTION (AHJ). g. SELECTIVE DEMOLITION AS REQUIRED FOR PROPER INSTALLATION OF EQUIPMENT SPECIFIED. ANY DEVIATION OR DAMAGE TO THE BUILDINGS IS THE SOLE RESPONSIBILITY OF THE CONTRACTOR.

WITH ALL APPLICABLE LOCAL REQUIREMENTS AND RESTRICTIONS SET FORTH BY

- h. G.C.TO PROVIDE A DUST SCREEN/BARRIER AROUND AREAS OF DEMOLITION AND NEW WORK. i. CONTRACTOR IS RESPONSIBLE TO REMOVE AND REINSTALL ALL THE CEILING
- TILES REQUIRED TO ROUTE CIRCUITS AND TO INSTALL ALL THE NEW INTERIOR ELECTRICAL COMPONENTS. j. REMOVAL AND REINSTALLATION OF DRYWALL SHALL BE REQUIRED IN ORDER TO FACILITATE ROUTING OF SLEEVE THROUGH WALL TO THE NECESSARY ROOF
- k. A GROUND PENETRATING RADAR (GPR) SCAN SHALL BE PERFORMED PRIOR TO ANY CORE DRILLING TO ENSURE NO DAMAGE OCCURS TO POST-TENSION CABLES

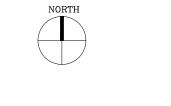



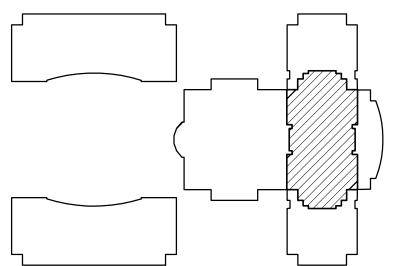


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ISOMETRIC AND DETAILS

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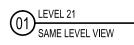
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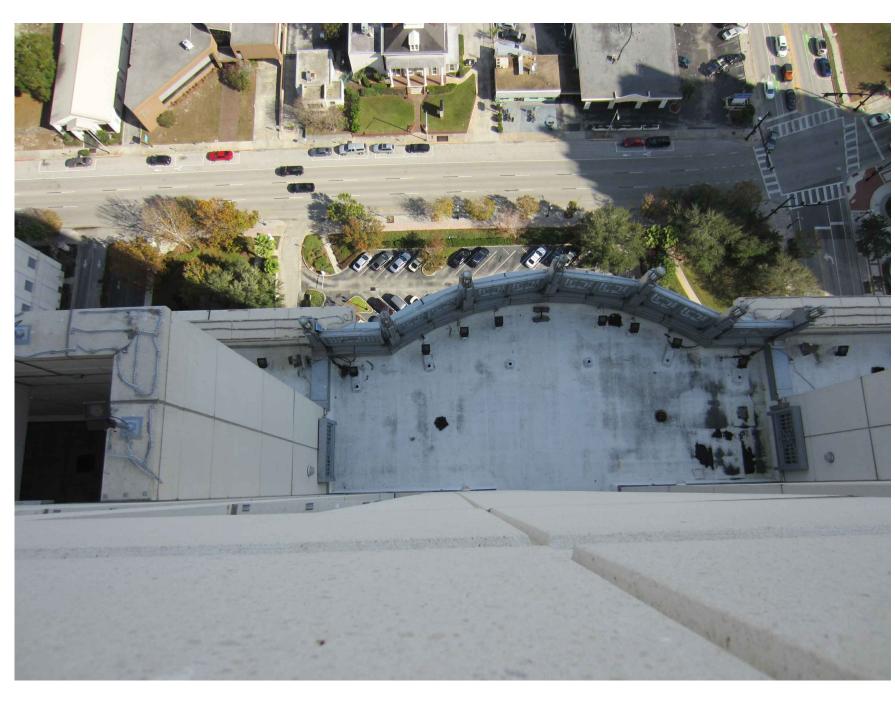


KEY PLAN



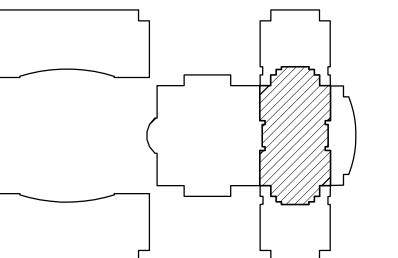






02) LEVEL 21
AERIAL VIEW




03 LEVEL 23
AERIAL VIEW



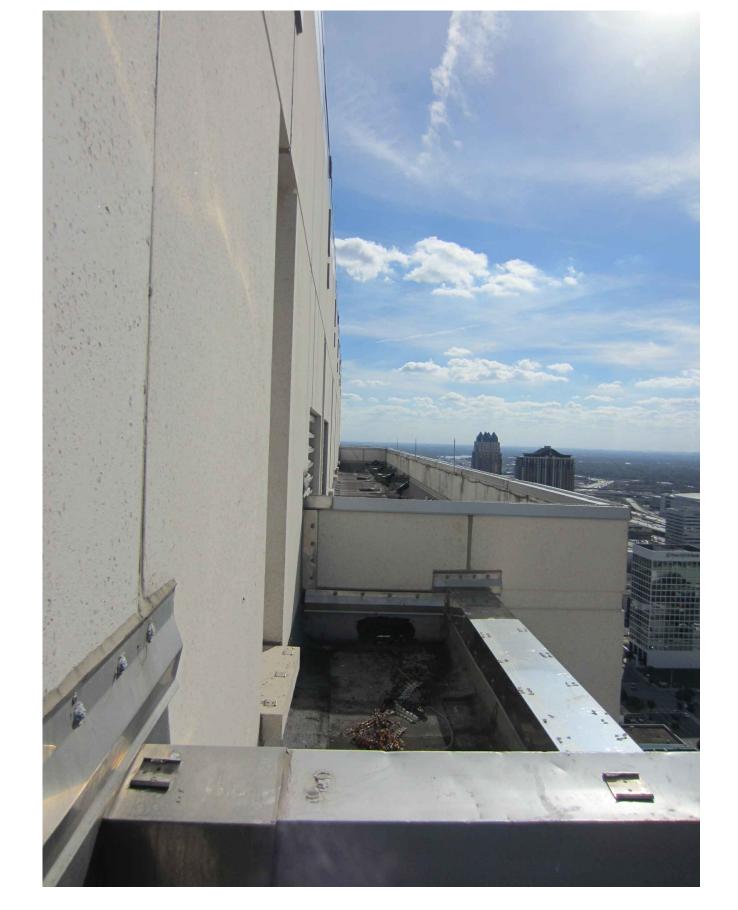

05 LEVEL 24 1/2
SAME LEVEL VIEW

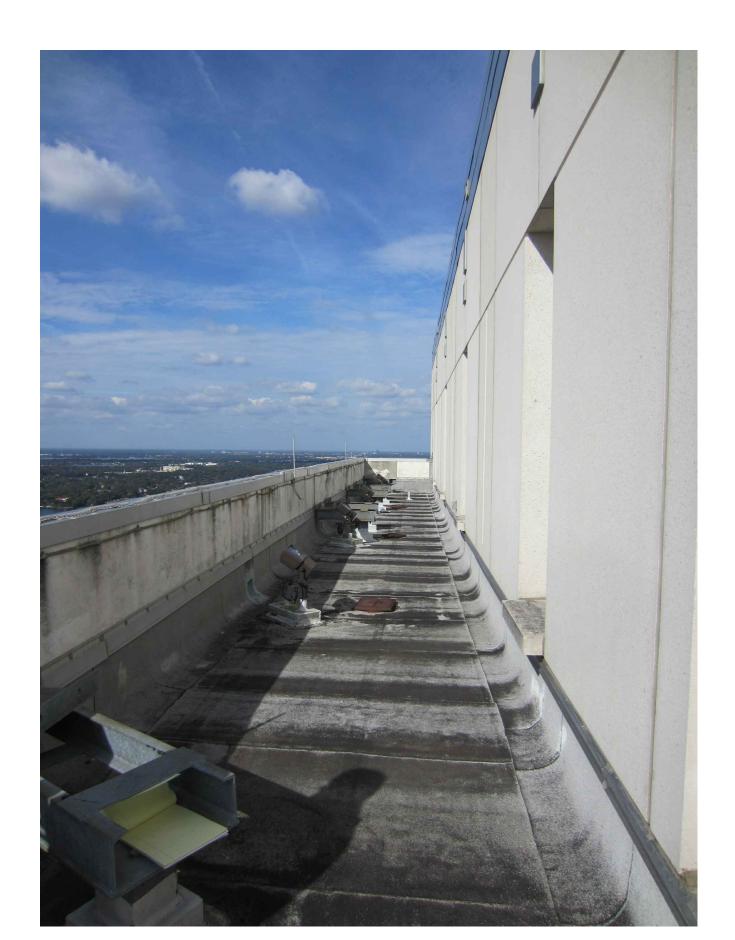

06 LEVEL 24 1/2
SAME LEVEL VIEW



STATE OF FLORIDA
MARIA FERREIRA, R.A.
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Client Information

ORANGE COUNTY CAPITAL PROJECTS DIVISION
400 E SOUTH STREET 5th FLOOR
ORLANDO, FL 32801

<b>ARCHITECTURE</b>	Project Number 16325	Issue Date 03/27/2017
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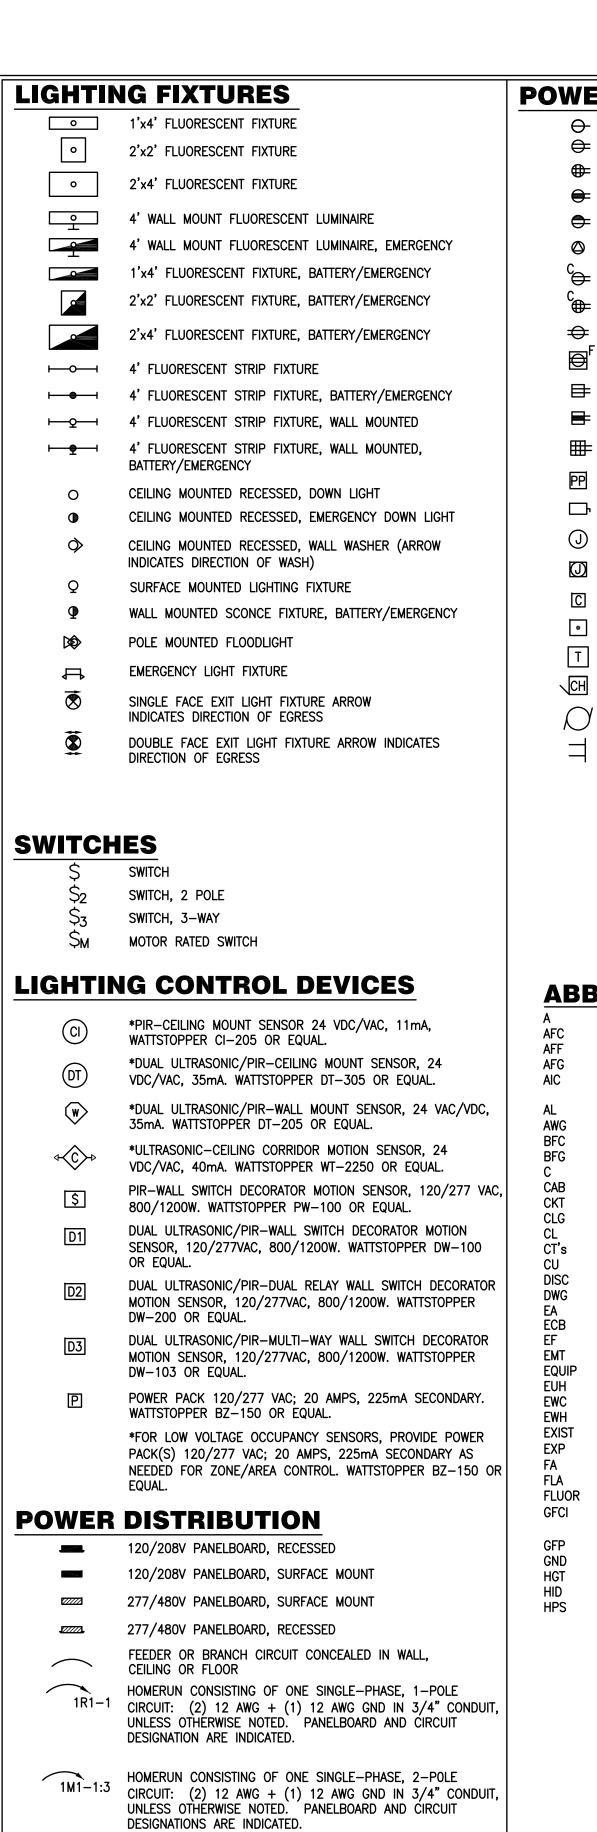
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SITE PICTURES

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CONSTRUCTION ISSUE SET JULY 13th, 2017

04 LEVEL 23
AERIAL VIEW



HOMERUN CONSISTING OF TWO SINGLE-PHASE CIRCUITS: (3)

OTHERWISE NOTED. PANELBOARD AND CIRCUIT DESIGNATION

HOMERUN CONSISTING OF THREE SINGLE-PHASE CIRCUITS:

OTHERWISE NOTED. PANELBOARD AND CIRCUIT DESIGNATIONS

HOMERUN CONSISTING OF ONE THREE-PHASE CIRCUITS: (3)

OTHERWISE NOTED. PANELBOARD AND CIRCUIT DESIGNATIONS

12 AWG + (1) 12 AWG GND IN 3/4" CONDUIT, UNLESS


1R1-1,3,5 (4) 12 AWG + (1) 12 AWG GND IN 3/4" CONDUIT, UNLESS

12 AWG + (1) 12 AWG GND IN 3/4" CONDUIT, UNLESS

ARE INDICATED.

ARE INDICATED.

ARE INDICATED.

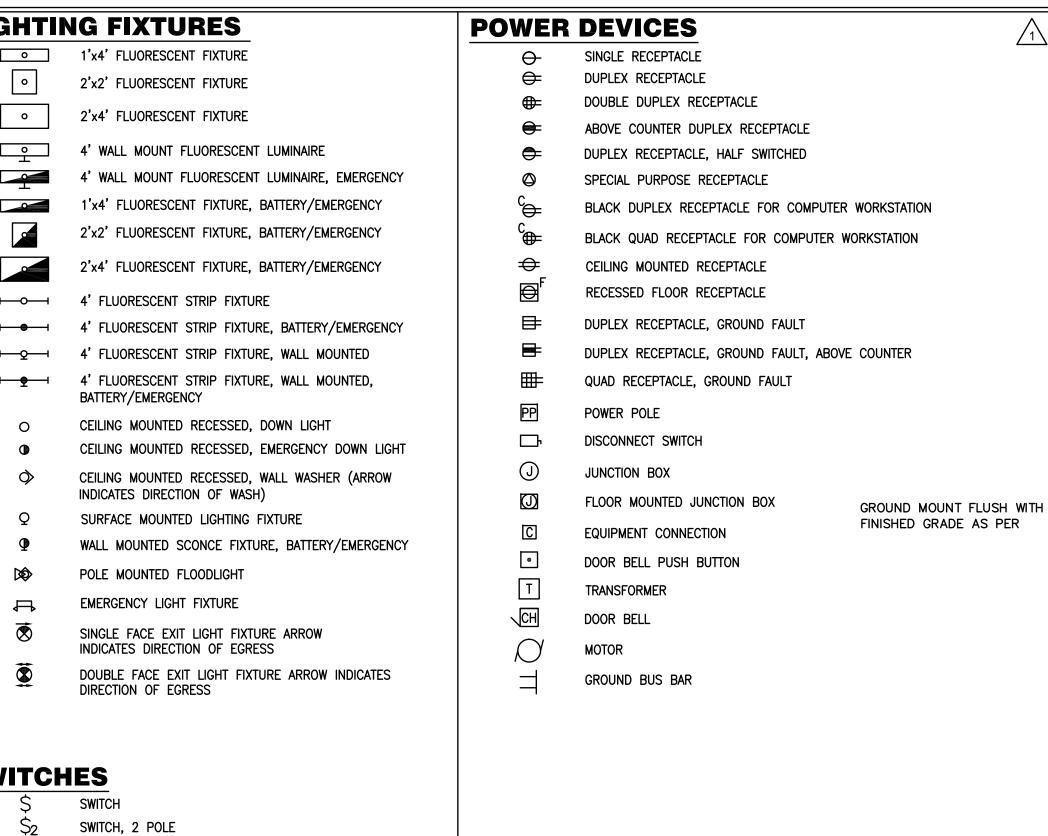

**ABBREVIATIONS** AMPERES

A	AMPERES	HOA	HAND-OFF-AUTOMATIC
AFC	ABOVE FINISHED CEILING	HP	HORSEPOWER
AFF	ABOVE FINISHED FLOOR	HVAC	HEATING/VENTILATING/
AFG	ABOVE FINISHED GRADE		AIR CONDITIONING
AIC	AMPERES INTERUPTING	HV	HIGH VOLTAGE
	CAPACITY	INC	INCANDESCENT
AL	ALUMINUM	JB	JUNCTION BOX
AWG	AMERICAN WIRE GAUGE	kV	KILO-VOLTS
BFC	BELOW FINISHED CEILING	kVA	KILO-VOLTS-AMPERES
BFG	BELOW FINISHED GRADE	kVAR	KILO-VOLTS-AMPERES REACTIVE
С	CONDUIT	kW	KILO-WATTS
CAB	CABINET	kWH	KILO-WATT-HOURS
CKT	CIRCUIT	LTG	LIGHTING
CLG	CEILING	m	METER
CL	CENTERLINE	mm	MILLIMETER
CT's	CURRENT TRANSFORMERS	MAX	MAXIMUM
CU	COPPER	MCB	MAIN CIRCUIT BREAKER
DISC	DISCONNECT(ING)	MFR	
DWG	DRAWING(S) ` ´	MH	
EΑ	EACH	MIN	MINIMUM
ECB	ENCLOSED CIRCUIT BREAKER	MISC	MISCELLANEOUS
EF	EXHAUST FAN	MTD	MOUNTED
EMT	ELECTRICAL METALLIC TUBING	MTG	MOUNTING
EQUIP	EQUIPMENT	NEC	NATIONAL ELECTRICAL CODE
EUH	ELECTRIC UNIT HEATER	PNL	PANEL
EWC	ELECTRIC WATER COOLER	PSI	PULL STATION INSIDE
EWH	ELECTRIC WATER HEATER	PVC	POLYVINYL CHLORIDE
EXIST	EXISTING	REC	
EXP	EXPLOSION PROOF	RGS	
FA	FIRE ALARM	SPD	
FLA	FULL LOAD AMPERES	TEL	TELEPHONE
FLUOR	FLUORESCENT	TYP	
GFCI	GROUND FAULT CIRCUIT	UON	UNLESS OTHERWISE NOTED
	INTERRUPTER	USB	RECEPTACLE WITH USB PORT
GFP	GROUND FAULT PROTECTION	V	VOLTS
GND	GROUND	V VA	VOLTS VOLT—AMPERES
HGT	HEIGHT	W	WATTS
HID	HIGH INTENSITY DISCHARGE	W WP	WEATHER PROOF
HPS	HIGH PRESSURE SODIUM	WP XFMR	TRANSFORMER
5	THOSE TREGOONE SOUR	VLML	INANSFURMER

# **GENERAL NOTES:**

1. ALL ELECTRICAL WORK AND MATERIALS SHALL BE IN COMPLIANCE WITH ALL GOVERNING CODES AND STANDARDS. THIS SHALL INCLUDE BUT NOT BE LIMITED TO THE FOLLOWING.


FLORIDA BUILDING CODE 2014 FIFTH EDITION NFPA 70 NATIONAL ELECTRICAL CODE 2011 EDITION

2. BRANCH CIRCUIT CONDUCTORS ARE DESIGNED IN ACCORDANCE WITH FBC FLORIDA CONSERVATION2014 FIFTH EDITION, C505.73. BRANCH CIRCUITS ARE SIZED FOR A MAXIMUM VOLTAGE DROP OF 3% AT DESIGN LOAD. REFER TO SPECIFICATION 26 05 19.

NOTE: SOME SYMBOLS SHOWN ON THIS LEGEND MAY NOT PERTAIN TO THIS PROJECT.

### System No.W-L-1001

June 15, 2005 F Ratings - 1, 2, 3 and 4 Hr (See Items 2 and 3) T Ratings - 0, 1, 2, 3, and 4 Hr (See Item 3) L Rating At Ambient - less than 1 CFM/sq ft

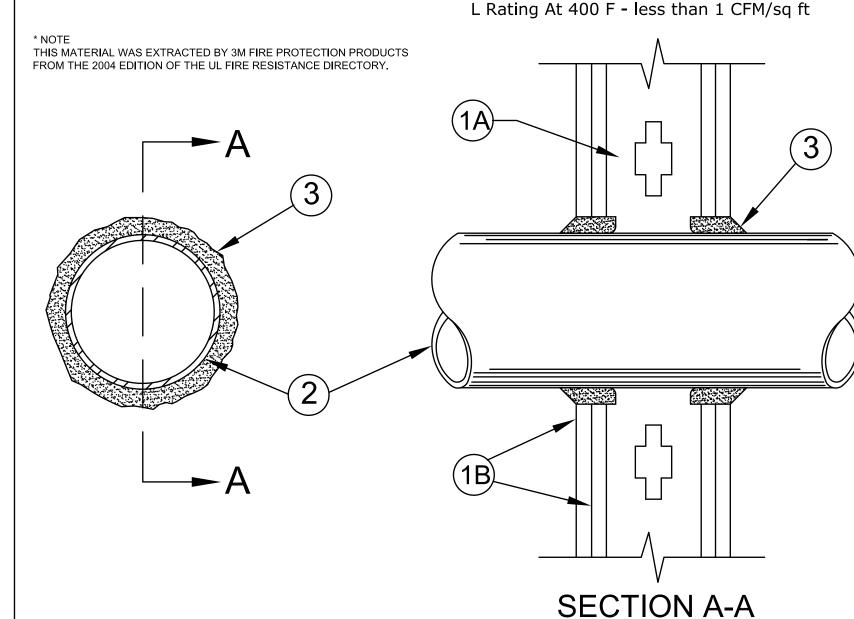

# **TYPICAL FOR ALL WALL PENETRATIONS**

1. Wall Assembly - The 1, 2, 3 or 4 hr fire-rated gypsum wallboard/stud wall assembly shall be constructed of the materials and in the manner described in the individual U300 or U400 Series Wall or Partition Designs in the UL Fire Resistance Directory and shall include the following

A. Studs - Wall framing may consist of either wood studs (max 2 hr fire rated assemblies) or steel channel studs. Wood studs to consist of nom 2 by 4 in. (51 by 102 mm) lumber spaced 16 in. (406 mm) OC with nom 2 by 4 in. (51 by 102 mm) lumber end plates and cross braces. Steel studs to be

min 3-5/8 in. (92 mm) wide by 1-3/8 in. (35 mm) deep channels spaced max 24 in. (610 mm) OC. B. Gypsum Board\* - Nom 1/2 or 5/8 in. (13 or 16 mm) thick, 4 ft. (122 cm) wide with square or tapered edges. The gypsum wallboard type, thickness, number of layers, fastener type and sheet orientation shall be as specified in the individual U300 or U400 Series Design in the UL Fire

Resistance Directory. Max diam of opening is 26 in. (660 mm). 2. Through Penetrant - One metallic pipe, conduit or tubing installed either concentrically or eccentrically within the firestop system. The annular space between pipe, conduit or tubing and periphery of opening shall be min of 0 in. (0 mm) (point contact) to max 2 in. (51 mm). Pipe, conduit or

tubing to be rigidly supported on both sides of wall assembly. The following types and sizes of metallic pipes, conduits or tubing may be used: A. Steel Pipe - Nom 24 in. (610 mm) diam (or smaller) Schedule 10 (or heavier) steel pipe. B. Iron Pipe - Nom 24 in. (610 mm) diam (or smaller) service weight (or heavier) cast iron soil pipe, nom 12 in. (305 mm) diam (or smaller) or Class

50 (or heavier) ductile iron pressure pipe. C. Conduit - Nom 6 in. (152 mm) diam (or smaller) steel conduit or nom 4 in. (102 mm) diam (or smaller) steel electrical metallic tubing

E. Copper Pipe - Nom 6 in. (152 mm) diam (or smaller) Regular (or heavier) copper pipe. F. Through Penetrating Product\* - Flexible Metal Piping - The following types of steel flexible metal gas piping may be used:

D. Copper Tubing - Nom 6 in. (152 mm) diam (or smaller) Type L (or heavier) copper tubing

1. Nom 2 in. (51 mm) diam (or smaller) steel flexible metal gas piping. Plastic covering on piping may or may not be removed on both sides of floor or

### OMEGA FLEX INC

2. Nom 1 in. (25 mm) diam (or smaller) steel flexible metal gas piping. Plastic covering on piping may or may not be removed on both sides of floor or

### TITEFLEX CORP A BUNDY CO

3. Nom 1 in. (25 mm) diam (or smaller) steel flexible metal gas piping. Plastic covering on piping may or may not be removed on both sides of floor or wall assembly.

### WARD MFG INC

3. Fill, Void or Cavity Material\* - Caulk or Sealant - Min 5/8. 1-1/4,1-7/8 and 2-1/2 in. (16, 32, 48 and 64 mm) thickness of caulk for 1, 2, 3 and 4 hr rated assemblies, respectively, applied within annulus, flush with both surfaces of wall. Min 1/4 in. (6 mm) diam bead of caulk applied to gypsum board/penetrant interface at point contact location on both sides of wall. The hourly F Rating of the firestop system is dependent upon the hourly fire rating of the wall assembly in which it is installed, as shown in the

The hourly T Rating of the firestop system is dependent upon the type or size of the pipe or conduit and the hourly fire rating of the wall assembly in which it is installed, as tabulated below:

Max Pipe or Conduit Diam in. (mm)	F Rating Hr	T Rating Hr
1 (25)	1 or 2	0+, 1 or 2
1 (25)	3 or 4	3 or 4
4 (102)	1 or 2	0
6 (152)	3 or 4	0
12 (305)	1 or 2	0

+When copper pipe is used, T Rating is 0 hr.


3M COMPANY - CP 25WB+ caulk or FB-3000 WT sealant

\*Bearing the UL Classification Marking

### EMT THRU GYP BOARD PENETRATION DETAIL No Scale

System No. C-AJ-1044

F Ratings - 2, 3, and 4 Hr (See Items 2A and 4) T Rating - 0 Hr L Rating At Ambient - 2 CFM/sq ft L Rating At 400 F - less than 1 CFM/sq ft W Rating - Class I (See Item 4)

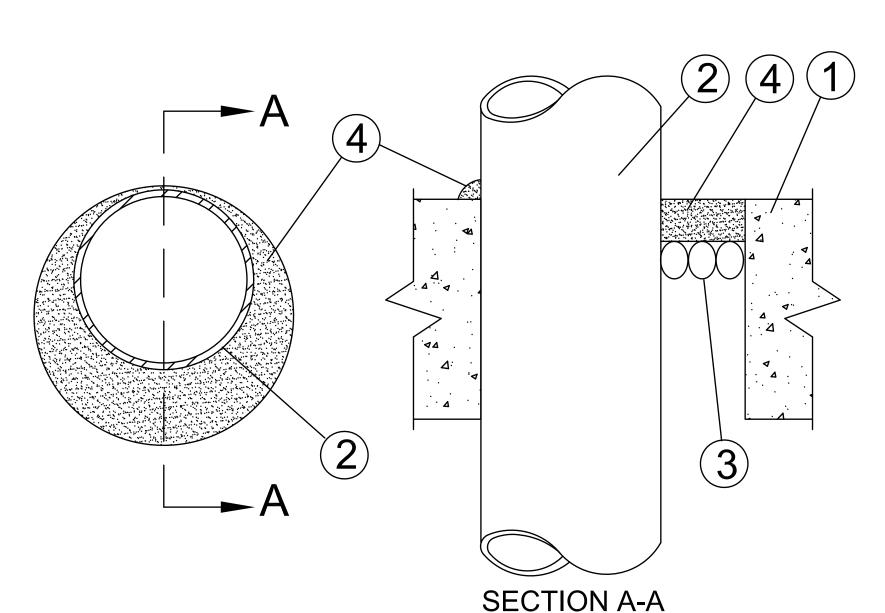

TYPICAL FOR ALL FLOOR PENETRATIONS

1. Floor or Wall Assembly - Lightweight or normal weight (100-150 pcf or 1600-2400 kg/m3) concrete. Except as noted in table under Item 4, min thickness of solid concrete floor or wall assembly is 4-1/2 in. (114 mm). Floor may also be constructed of any min 6 in. (152 mm) thick UL Classified hollow core Precast Concrete Units\*. When floor is constructed of hollow core precast concrete units, packing material (Item 3) and caulk fill material (Item 4) to be installed symmetrically on both sides of floor, flush with floor surface. Wall assembly may also be constructed of any UL Classified Concrete Blocks\*. Max diam of opening is in solid lightweight or normal weight concrete. Floor is 32 in. (813 mm). Max diam of opening in floor constructed of hollow-core precast concrete units is 7 in. (178 mm).

See Concrete Blocks (CAZT) and Precast Concrete Units (CFTV) categories in the Fire Resistance Directory for names of manufacturers.

1A. Steel Sleeve (Optional, not shown) - Max 15 in. (381 mm) ID (or smaller) Schedule 10 (or heavier) steel sleeve cast or grouted into floor or wall assembly. Sleeve may extend a max of 2 in. (51 mm) above top of floor or beyond either surface of wall. Max 16 in. (406 mm) ID (or smaller) min 0.028 (0.71 mm) wall thickness (or heavier) galvanized steel sleeve cast or grouted into floor or wall assembly. Sleeve may extend a max of 1/2 in. (13 mm) beyond either surface of floor or wall.

2. Through Penetrants - One metallic pipe, conduit or tubing to be installed either concentrically or eccentrically within the firestop system. Max annular space between pipe, conduit or tubing and edge of through opening or sleeve is dependent on the parameters shown in Item 4. Min annular space between pipe or conduit and edge of through opening is 0 in. (0 mm) (point contact). Pipe conduit or tubing to be rigidly supported on both sides of floor or wall assembly. The following types and sizes of metallic pipes, conduits or tubing may be used:

A. Steel Pipe - Nom 30 in. (762 mm) diam (or smaller) Schedule 10 (or heavier) steel pipe.

B. Iron Pipe - Nom 30 in. (762 mm) diam (or smaller) cast or ductile iron pipe.

C. Conduit - Nom 6 in. (152 mm) diam (or smaller) rigid steel conduit. D. Conduit - Nom 4 in. (102 mm) diam (or smaller) steel electrical metallic tubing.

E. Copper - Tubing Nom 6 in. (152 mm) diam (or smaller) Type L (or heavier) copper tube.

F. Copper Pipe - Nom 6 in. (152 mm) diam (or smaller) Regular (or heavier) copper pipe.

3. Packing Material - Polyethylene backer rod or nom 1 in. (25 mm) thickness of tightly-packed mineral wool batt or glass fiber insulation firmly packed into opening as a permanent form. Packing material to be recessed from top surface of floor or from both surfaces of wall as required to accommodate the required thickness of caulk fill material (Item 4).

4. Fill, Void or Cavity Material\* - Caulk or Sealant - Applied to fill the annular space flush with top surface of floor. In wall assemblies, required caulk thickness to be installed symmetrically on both sides of wall, flush with wall surface. At point contact location between penetrant and sleeve or between penetrant and concrete, a min 1/4 in. (6 mm) diam bead of caulk shall be applied at top surface of floor and at both surfaces of wall. The hourly F Ratings and the min required caulk thicknesses are dependent upon a number of parameters, as shown in the following

Min Floor or Wall Thkns In. (mm)	Nom Pipe Tube or Conduit Diam in. (mm)	Max Annular Space in. (mm)	Min Caulk Thkns in. (mm)	F Rating Hr
2-1/2 (64)	1/2-12 (13-305)	1-3/8 (35)	1/2 (13)	2
2-1/2 (64)	1/2-12 (13-305)	3-1/4 (83)	1 (25)	2
4-1/2 (114)	1/2-6 (13-152)	1-3/8 (35)	1/4 (6) (a)	2
4-1/2 (114)	1/2-12 (13-305)	1-1/4 (32)	1/2 (13)	3
4-1/2 (114)	1/2-20 (13-508)	2 (51)	1 (25)	3
4-1/2 (114)	1/2-20 (13-508)	2 (51)	1 (25)	3
4-1/2 (114)	1/2-12 (13-305)	3-1/4 (83)	1 (25)	3
4-1/2 (114)	22-30 (558-762)	2 (51)	2 (51)	3
5-1/2 (140)	1/2-6 (13-152)	1-3/8 (35)	1 (25) (b)	4

(a)Min 2 in. (51 mm) thickness of mineral wool batt insulation required in annular space. (b)Min 1 in. (25 mm) thickness of mineral wool batt insulation required in annular space on both sides of floor or wall assembly. Min 1 in. (25 mm) thickness of caulk to be installed flush with each surface of floor or wall assembly.

3M COMPANY - CP 25WB+ caulk or FB-3000 WT sealant. (Note: W Rating applies only when FB-3000 WT sealant is used.)

### EMT THRU CONCRETE PENETRATION DETAIL No Scale

\*Bearing the UL Classification Marking

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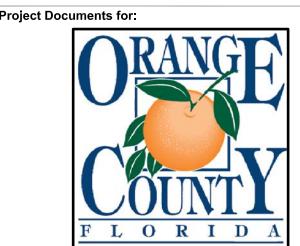


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AR-95752

AA-C001315



ORANGE COUNTRY COURTHOUSE BIRD DETERRENT SYSTEM. 425 N. ORANGE AVE. ORLANDO, FL 32801

Issue Description Drawn By Checked By 90% DESIGN SET MB/JJB JLM MB/JJB JLM 06.14.17 07.13.17 100% CD

 $\frac{1}{1}$  06.27.17 B.D. COMMENTS MB/JJB

Client Information

SORANGE COUNTY CAPITAL PROJECTS DIVISION 400 E SOUTH STREET 5th FLOOR ORLANDO, FL 32801

> Project Number Issue Date 16325 07/13/2017 Drawn By Project Status MB/JJB Checked By


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JUSTIN L. MUNDELL-FL70700

Sheet Title:

SYMBOL



- a. REFER TO SYMBOL LEGEND ON DRAWING E00.00.
- b. REFER TO SPECIFICATIONS IN THE PROJECT MANUAL.
- c. CONTRACTOR SHALL VISIT SITE TO BECOME FAMILIAR WITH ROUTING OF CIRCUITS THROUGH EXISTING CEILINGS AND WALLS. REMOVAL OF DRYWALL MAY BE NECESSARY TO FACILITATE ROUTING OF SLEEVE THROUGH WALL TO EXTERIOR ROOF AREA.
- NIGHT SHIFT WORK MAY BE REQUIRED TO ROUTE CIRCUITS THROUGH EXISTING OFFICES ETC..
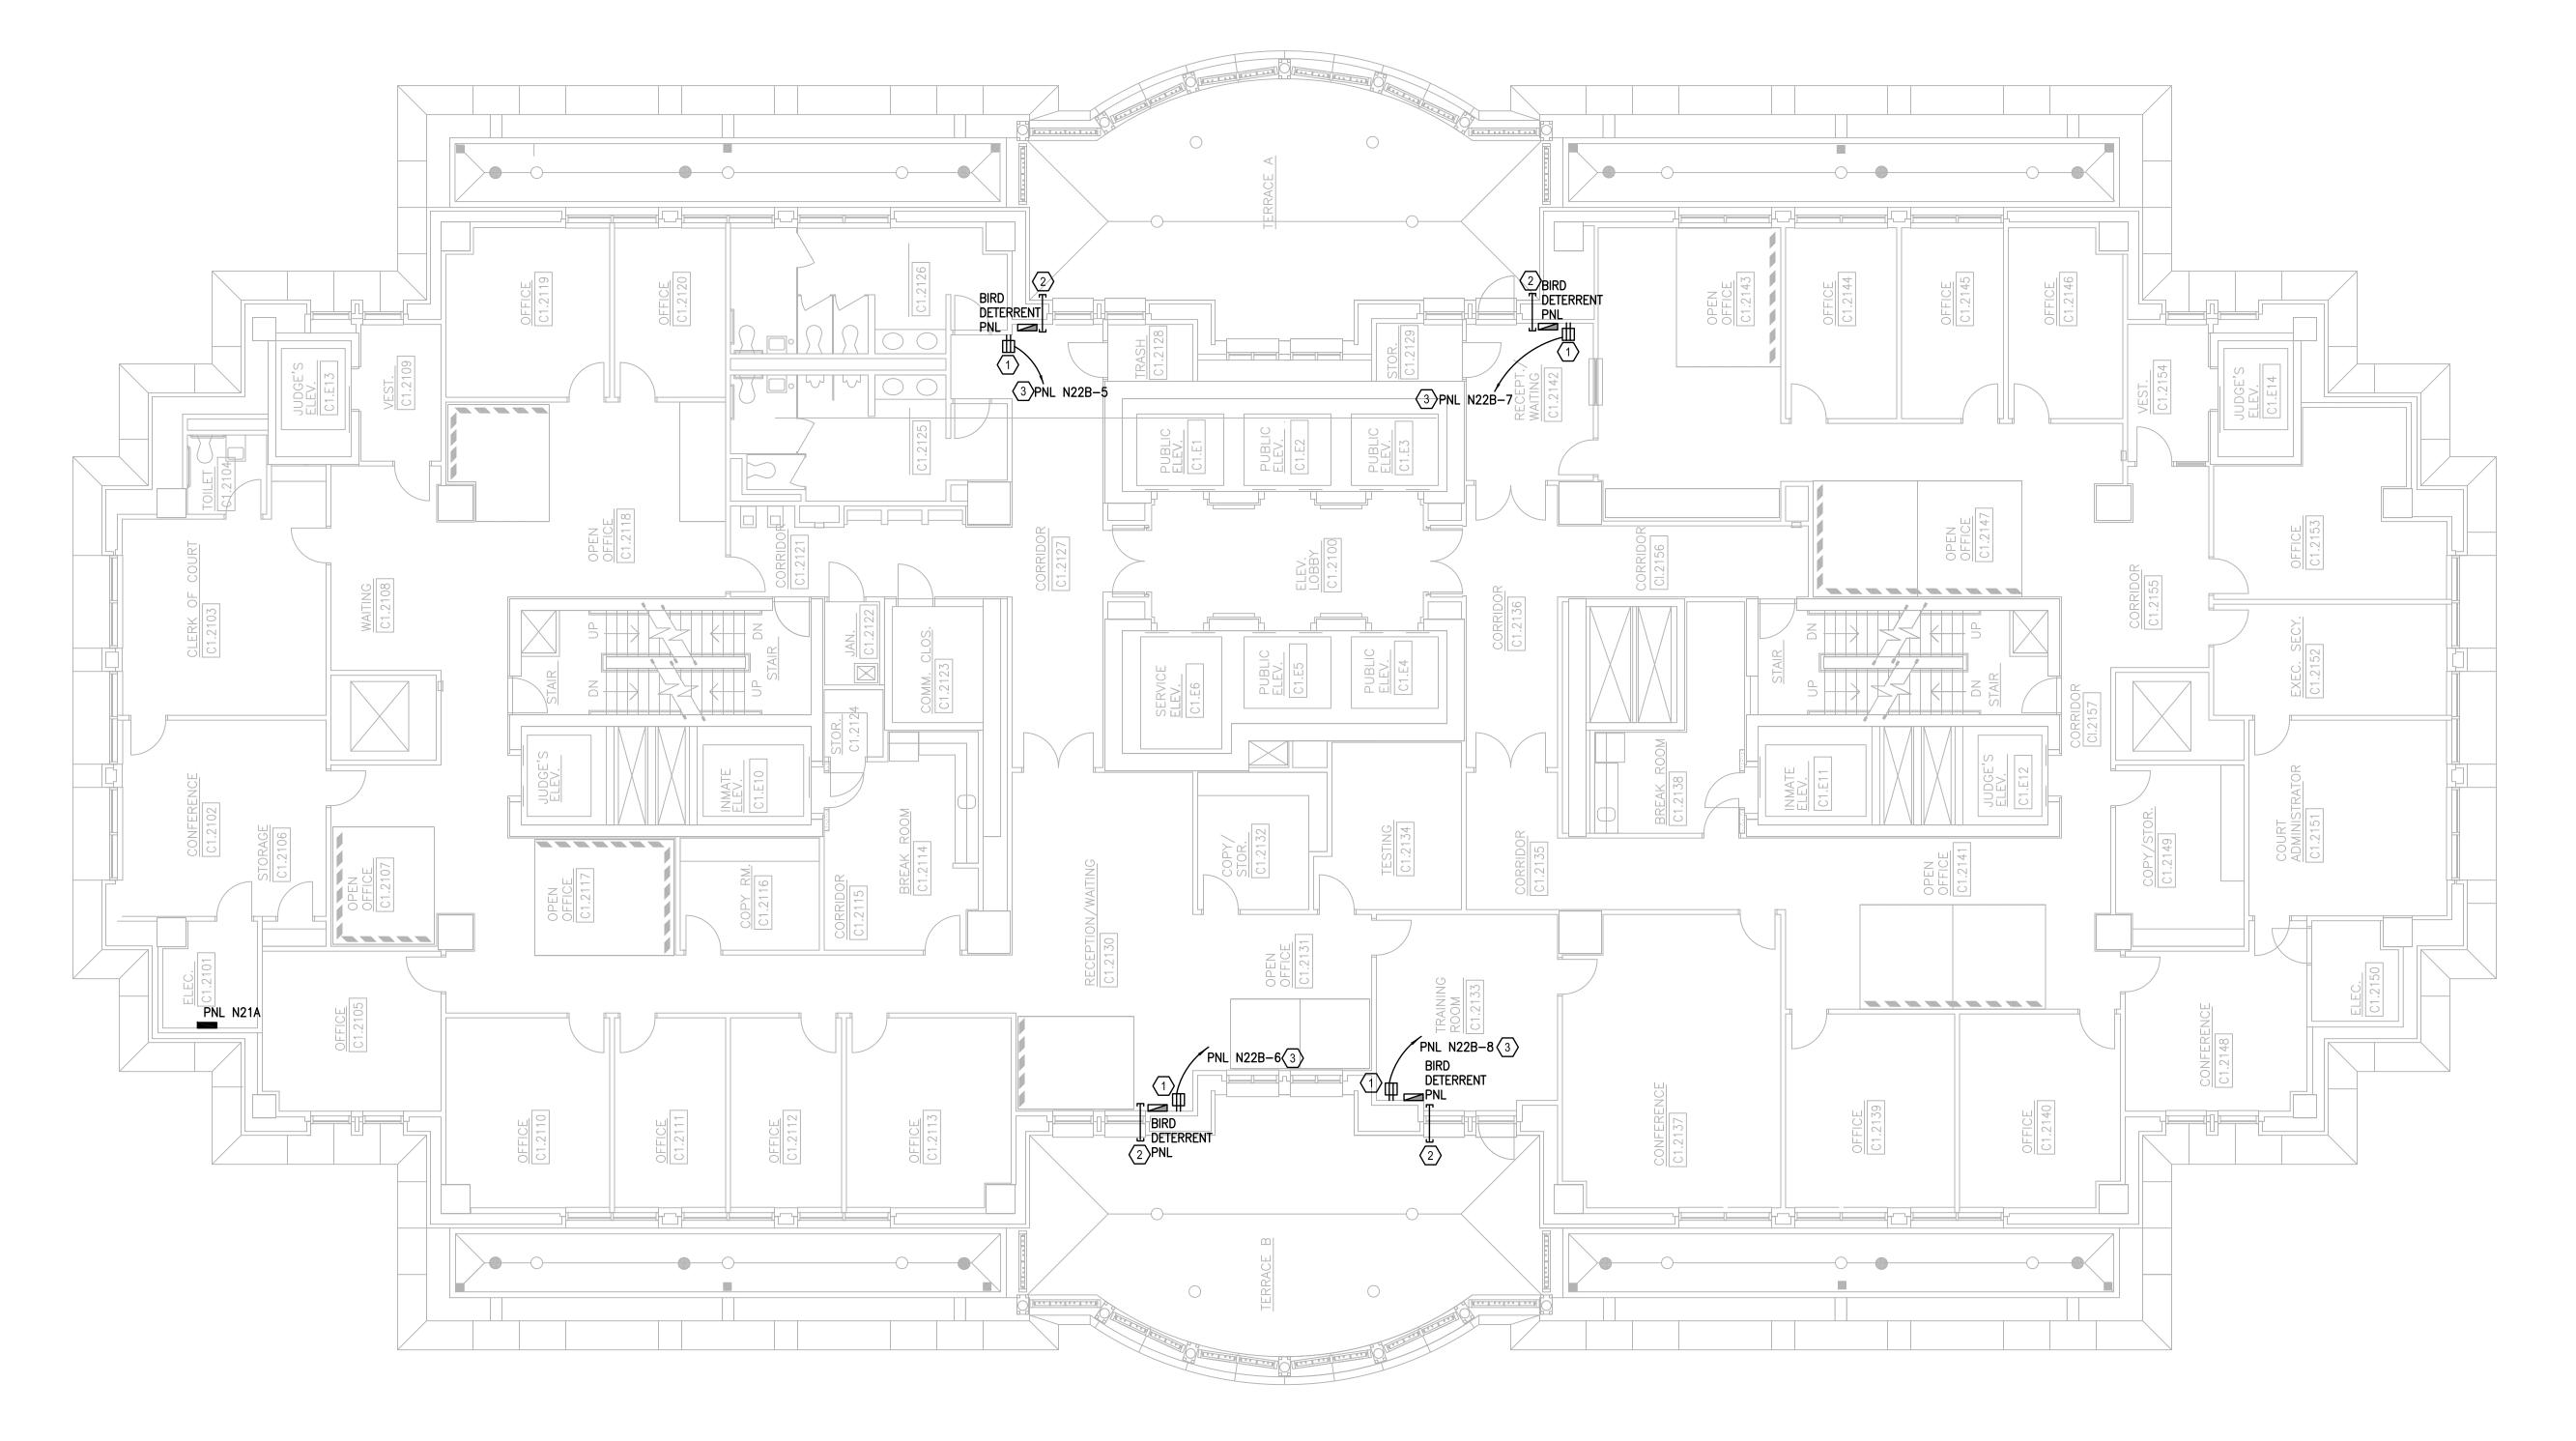
# PLAN KEY NOTES: 🗴

- PROVIDE NEW GFI OUTLET ABOVE CEILING FOR POWER TO BIRD DETERRENT SYSTEM PANEL PROVIDED BY THE BIRD DETERRENT SYSTEM INSTALLER. MARK LOCATION ON CEILING GRID WITH SMALL RED LABEL.
- 2. PROVIDE SLEEVE THROUGH WALL FOR BIRD DETERRENT SYSTEM CABLE TO PASS FROM ROOF TO SYSTEM PANEL ABOVE CEILING. COORDINATE LOCATION WITH BIRD DETERRENT SYSTEM INSTALLER. SEAL ALL SLEEVES TO PREVENT ANY WATER FROM ENTERING THE BUILDING.
- ROUTE NEW CIRCUIT TO EXISTING PANEL INDICATED (MAY BE LOCATED ON DIFFERENT FLOOR).
- 4. MOUNT ELECTRICAL BELOW ROOF NEAR EXISTING ROOF ACCESS HATCH. PENETRATE ROOF SLEEVE HORIZONTALLY INTO DEPRESSED WALKWAY AREA.
- 5. PROVIDE NEW 20 AMP 120 VOLT C.B.'S IN PANEL FOR EACH NEW CIRCUIT INDICATED, REFER TO PANEL SCHEDULE.
- 6. BIRD DETERRENT SYSTEM CABLE FROM LEVEL 23 DOWN INTO SLEEVE STUBBED INTO LEVEL 22 CEILING.




ELECTRICAL FLOOR PLAN LEVEL 21



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ORANGE COUNTRY COURTHOUSE BIRD DETERRENT SYSTEM. 425 N. ORANGE AVE, ORLANDO, FL 32801

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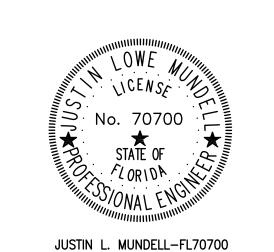
Client Information
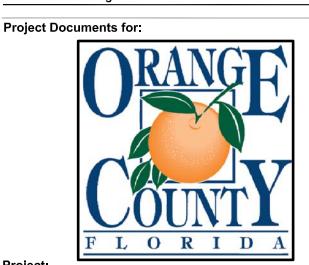
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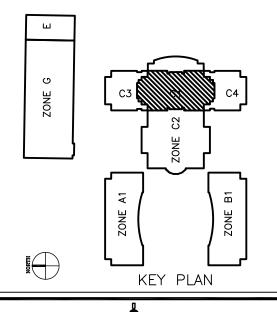


JUSTIN L. MUNDELL-FL7070

Sheet Title:


ELECTRICAL FLOOR PLAN LEVEL 21

E02.21



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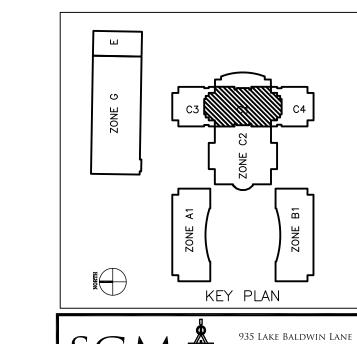
- a. REFER TO SYMBOL LEGEND ON DRAWING E00.00.
- b. REFER TO SPECIFICATIONS IN THE PROJECT MANUAL.
- c. CONTRACTOR SHALL VISIT SITE TO BECOME FAMILIAR WITH ROUTING OF CIRCUITS THROUGH EXISTING CEILINGS AND WALLS. REMOVAL OF DRYWALL MAY BE NECESSARY TO FACILITATE ROUTING OF SLEEVE THROUGH WALL TO EXTERIOR ROOF AREA.
- d. NIGHT SHIFT WORK MAY BE REQUIRED TO ROUTE CIRCUITS THROUGH EXISTING OFFICES ETC..

# PLAN KEY NOTES: 🗵

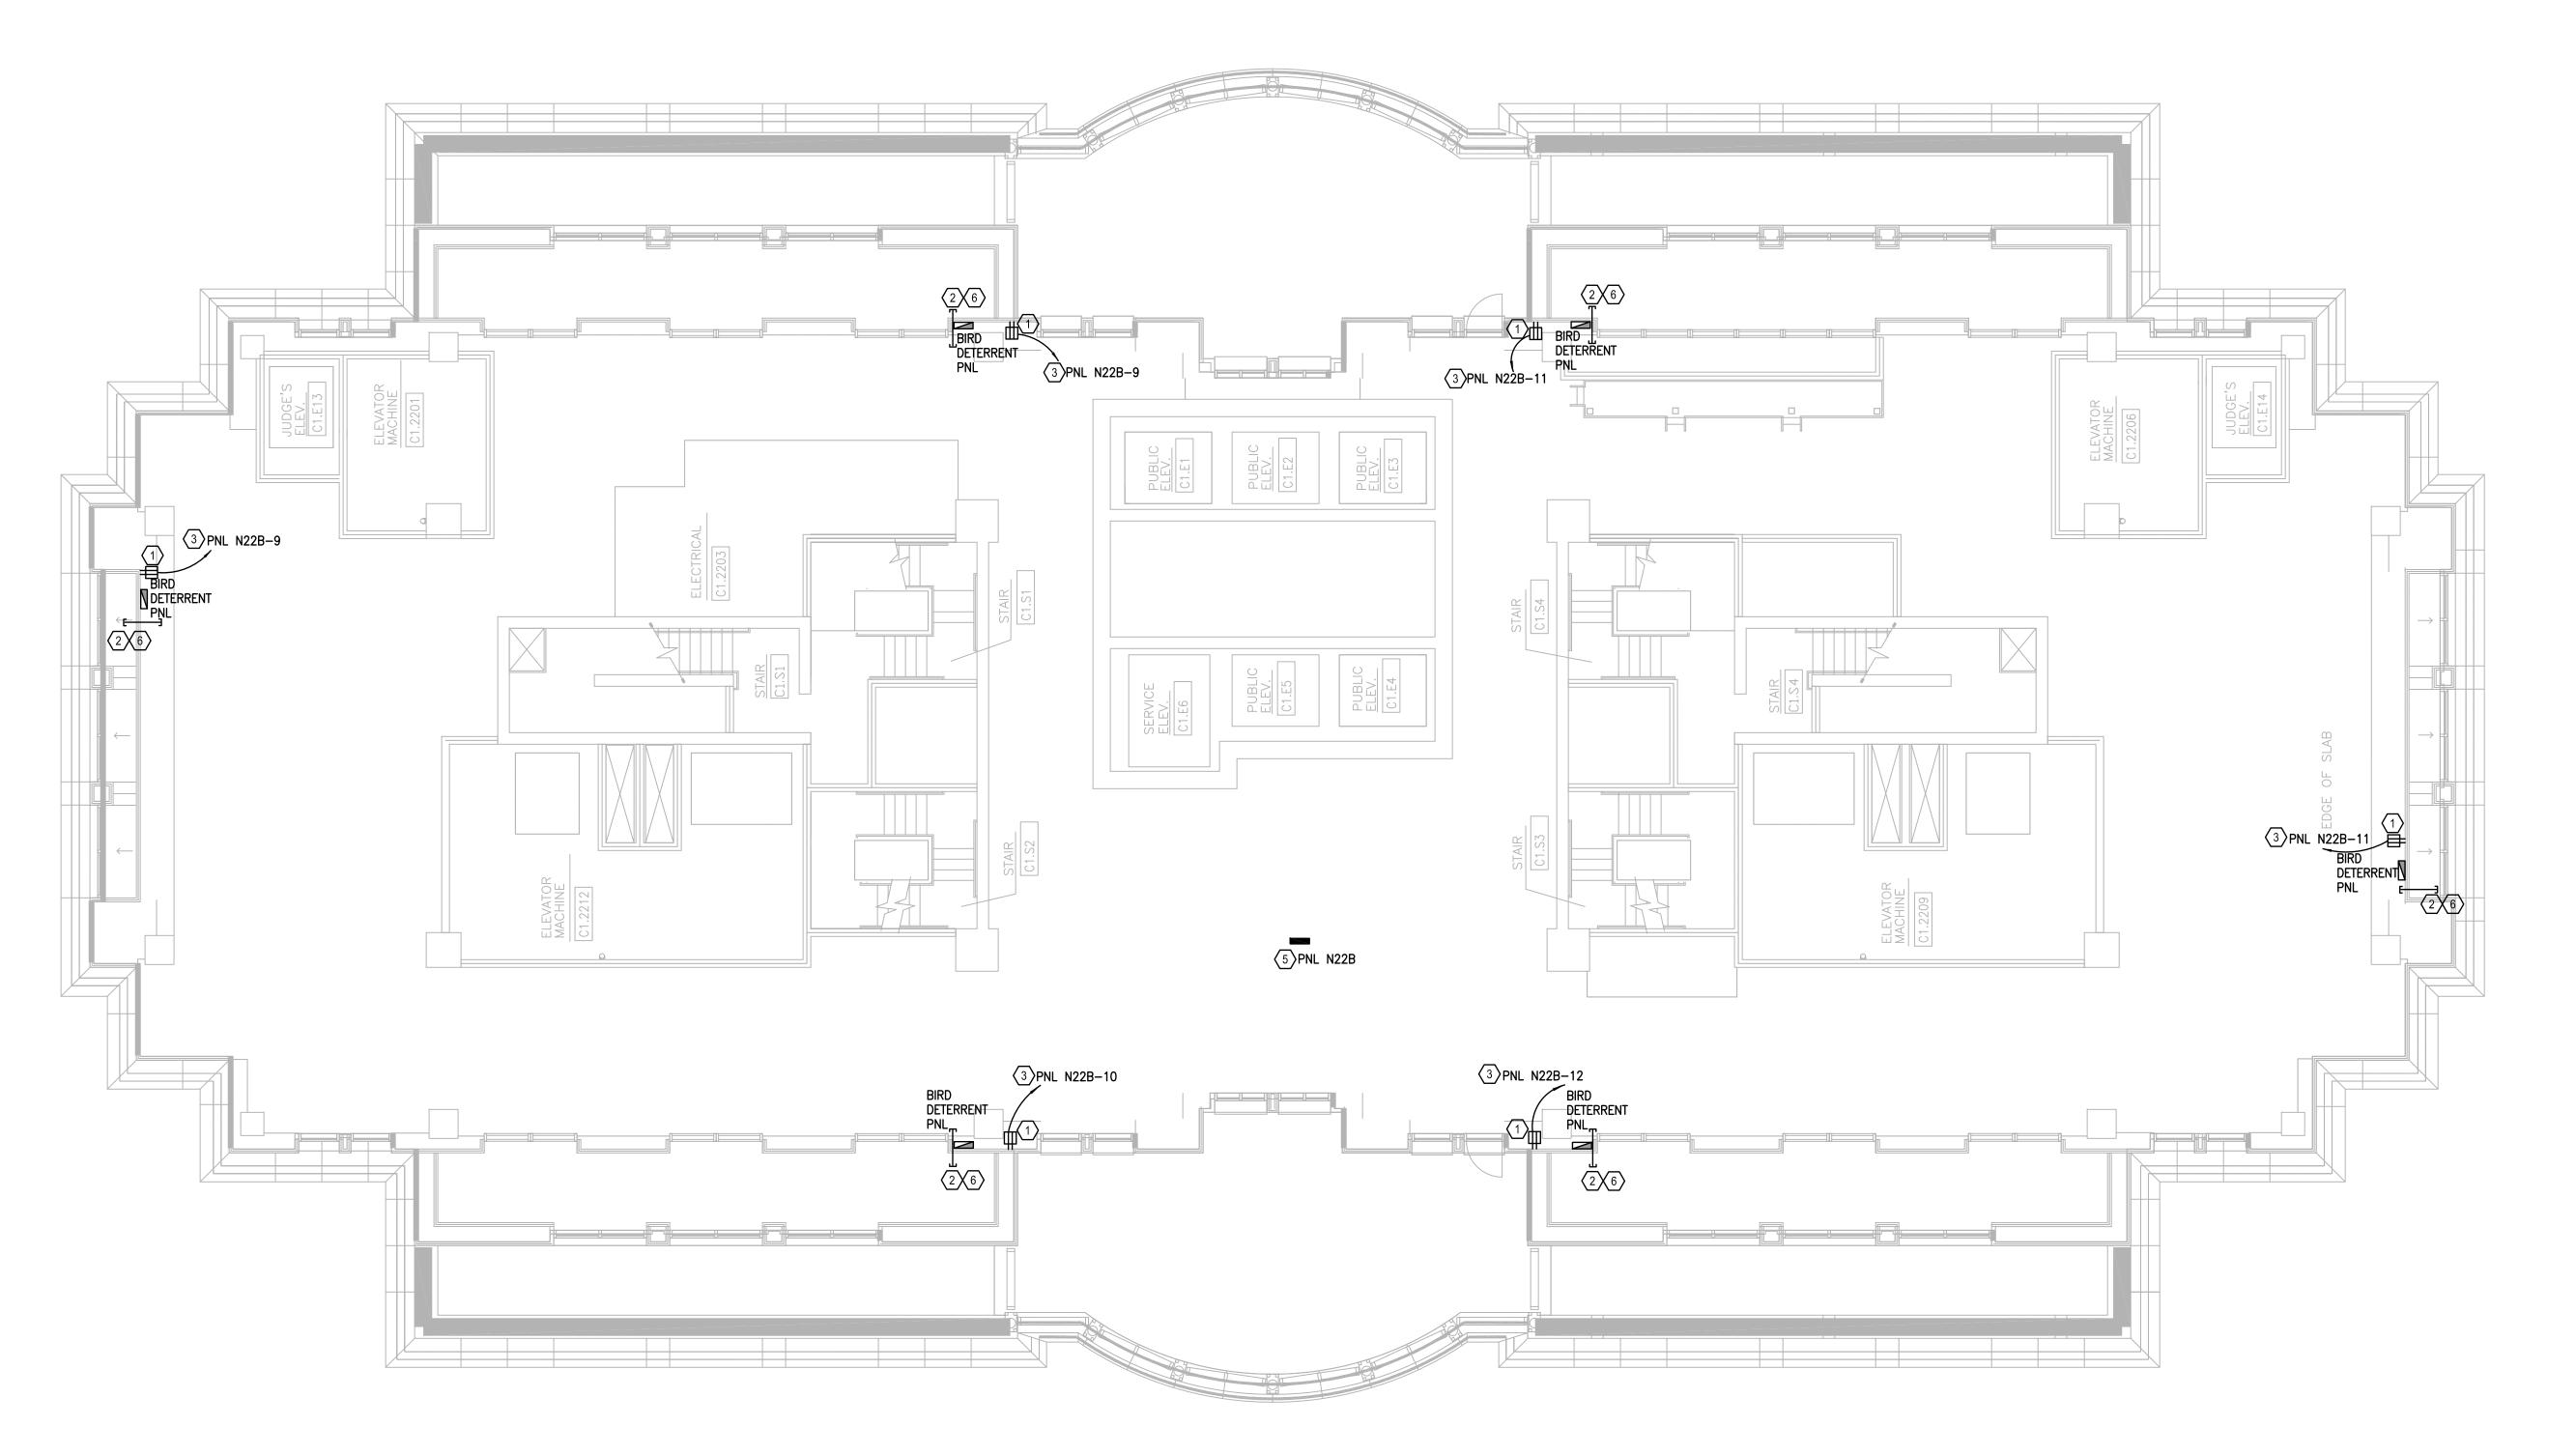- PROVIDE NEW GFI OUTLET ABOVE CEILING FOR POWER TO BIRD DETERRENT SYSTEM PANEL PROVIDED BY THE BIRD DETERRENT SYSTEM INSTALLER. MARK LOCATION ON CEILING GRID WITH SMALL RED LABEL.
- 2. PROVIDE SLEEVE THROUGH WALL FOR BIRD DETERRENT SYSTEM CABLE TO PASS FROM ROOF TO SYSTEM PANEL ABOVE CEILING. COORDINATE LOCATION WITH BIRD DETERRENT SYSTEM INSTALLER. SEAL ALL SLEEVES TO PREVENT ANY WATER FROM ENTERING THE BUILDING.
- ROUTE NEW CIRCUIT TO EXISTING PANEL INDICATED (MAY BE LOCATED ON DIFFERENT FLOOR).
- 4. MOUNT ELECTRICAL BELOW ROOF NEAR EXISTING ROOF ACCESS HATCH. PENETRATE ROOF SLEEVE HORIZONTALLY INTO DEPRESSED WALKWAY AREA.
- 5. PROVIDE NEW 20 AMP 120 VOLT C.B.'S IN PANEL FOR EACH NEW CIRCUIT INDICATED, REFER TO PANEL SCHEDULE.
- 6. BIRD DETERRENT SYSTEM CABLE FROM LEVEL 23 DOWN INTO SLEEVE STUBBED INTO LEVEL 22 CEILING.



ELECTRICAL FLOOR PLAN LEVEL 22



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ORANGE COUNTRY COURTHOUSE BIRD DETERRENT SYSTEM. 425 N. ORANGE AVE, ORLANDO, FL 32801

• INTERIOR DESIGN

Client Information
ORANGE COUNTY CAPITAL PROJECTS DIVISION
400 E SOUTH STREET 5th FLOOR
ORLANDO, FL 32801


Project Number Issue Date

16325 07/13/2017
Project Status

MB/JJB 100% CD
Checked By Scale
JLM 1/8" = 1'-0"

File Name

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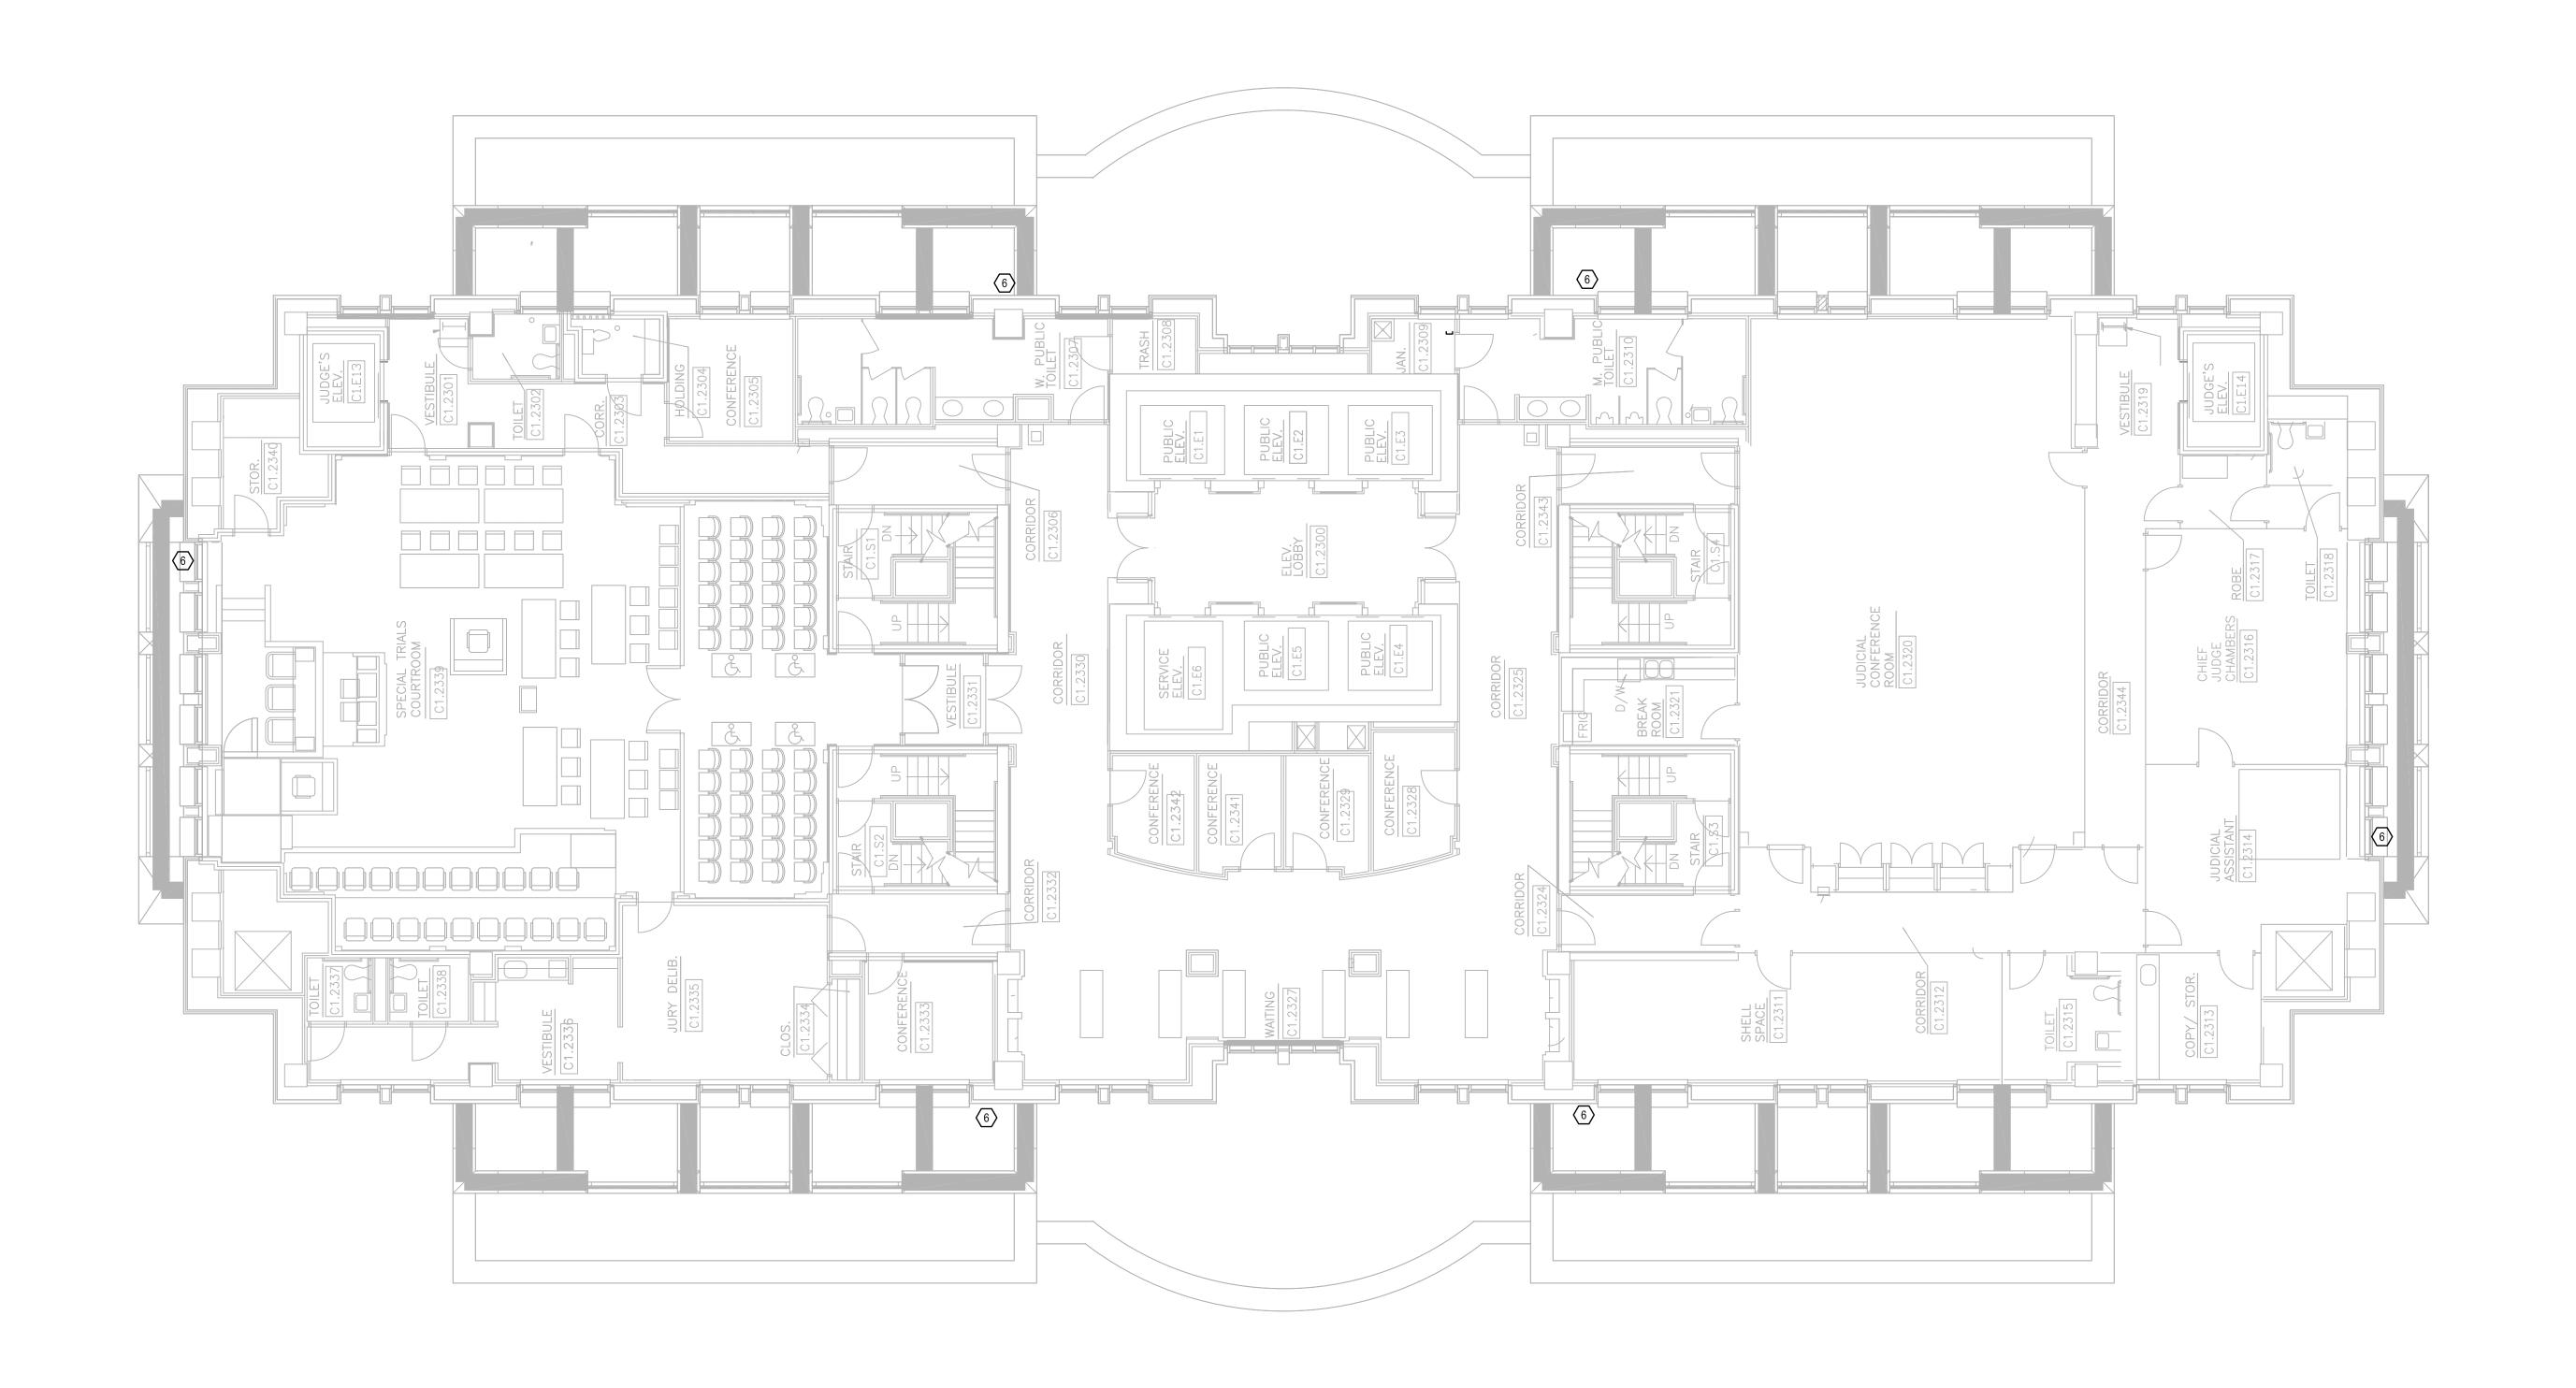

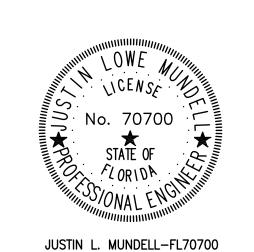
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Sheet Title:

ELECTRICAL FLOOR PLAN LEVEL 22

-02.22



- a. REFER TO SYMBOL LEGEND ON DRAWING E00.00.
- b. REFER TO SPECIFICATIONS IN THE PROJECT MANUAL.
- CONTRACTOR SHALL VISIT SITE TO BECOME FAMILIAR WITH ROUTING OF CIRCUITS THROUGH EXISTING CEILINGS AND WALLS. REMOVAL OF DRYWALL MAY BE NECESSARY TO FACILITATE ROUTING OF SLEEVE THROUGH WALL TO EXTERIOR ROOF AREA.
- d. NIGHT SHIFT WORK MAY BE REQUIRED TO ROUTE CIRCUITS THROUGH EXISTING OFFICES ETC..

# PLAN KEY NOTES: 🗵

- 1. PROVIDE NEW GFI OUTLET ABOVE CEILING FOR POWER TO BIRD DETERRENT SYSTEM PANEL PROVIDED BY THE BIRD DETERRENT SYSTEM INSTALLER. MARK LOCATION ON CEILING GRID WITH SMALL
- 2. PROVIDE SLEEVE THROUGH WALL FOR BIRD DETERRENT SYSTEM CABLE TO PASS FROM ROOF TO SYSTEM PANEL ABOVE CEILING. COORDINATE LOCATION WITH BIRD DETERRENT SYSTEM INSTALLER. SEAL ALL SLEEVES TO PREVENT ANY WATER FROM ENTERING THE BUILDING.
- 3. ROUTE NEW CIRCUIT TO EXISTING PANEL INDICATED (MAY BE LOCATED ON DIFFERENT FLOOR).
- 4. MOUNT ELECTRICAL BELOW ROOF NEAR EXISTING ROOF ACCESS HATCH. PENETRATE ROOF SLEEVE HORIZONTALLY INTO DEPRESSED WALKWAY AREA.
- 5. PROVIDE NEW 20 AMP 120 VOLT C.B.'S IN PANEL FOR EACH NEW CIRCUIT INDICATED, REFER TO PANEL SCHEDULE.
- 6. BIRD DETERRENT SYSTEM CABLE FROM LEVEL 23 DOWN INTO SLEEVE STUBBED INTO LEVEL 22 CEILING.



**ELECTRICAL FLOOR PLAN LEVEL 23** 

SCALE: 1/8"=1'-0"



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ORANGE COUNTRY COURTHOUSE BIRD DETERRENT SYSTEM. 425 N. ORANGE AVE, ORLANDO, FL 32801

07.13.17 100% CD

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Project Number Issue Date 16325 07/13/2017 Drawn By Project Status MB/JJB Checked By Scale 1/8" = 1'-0"

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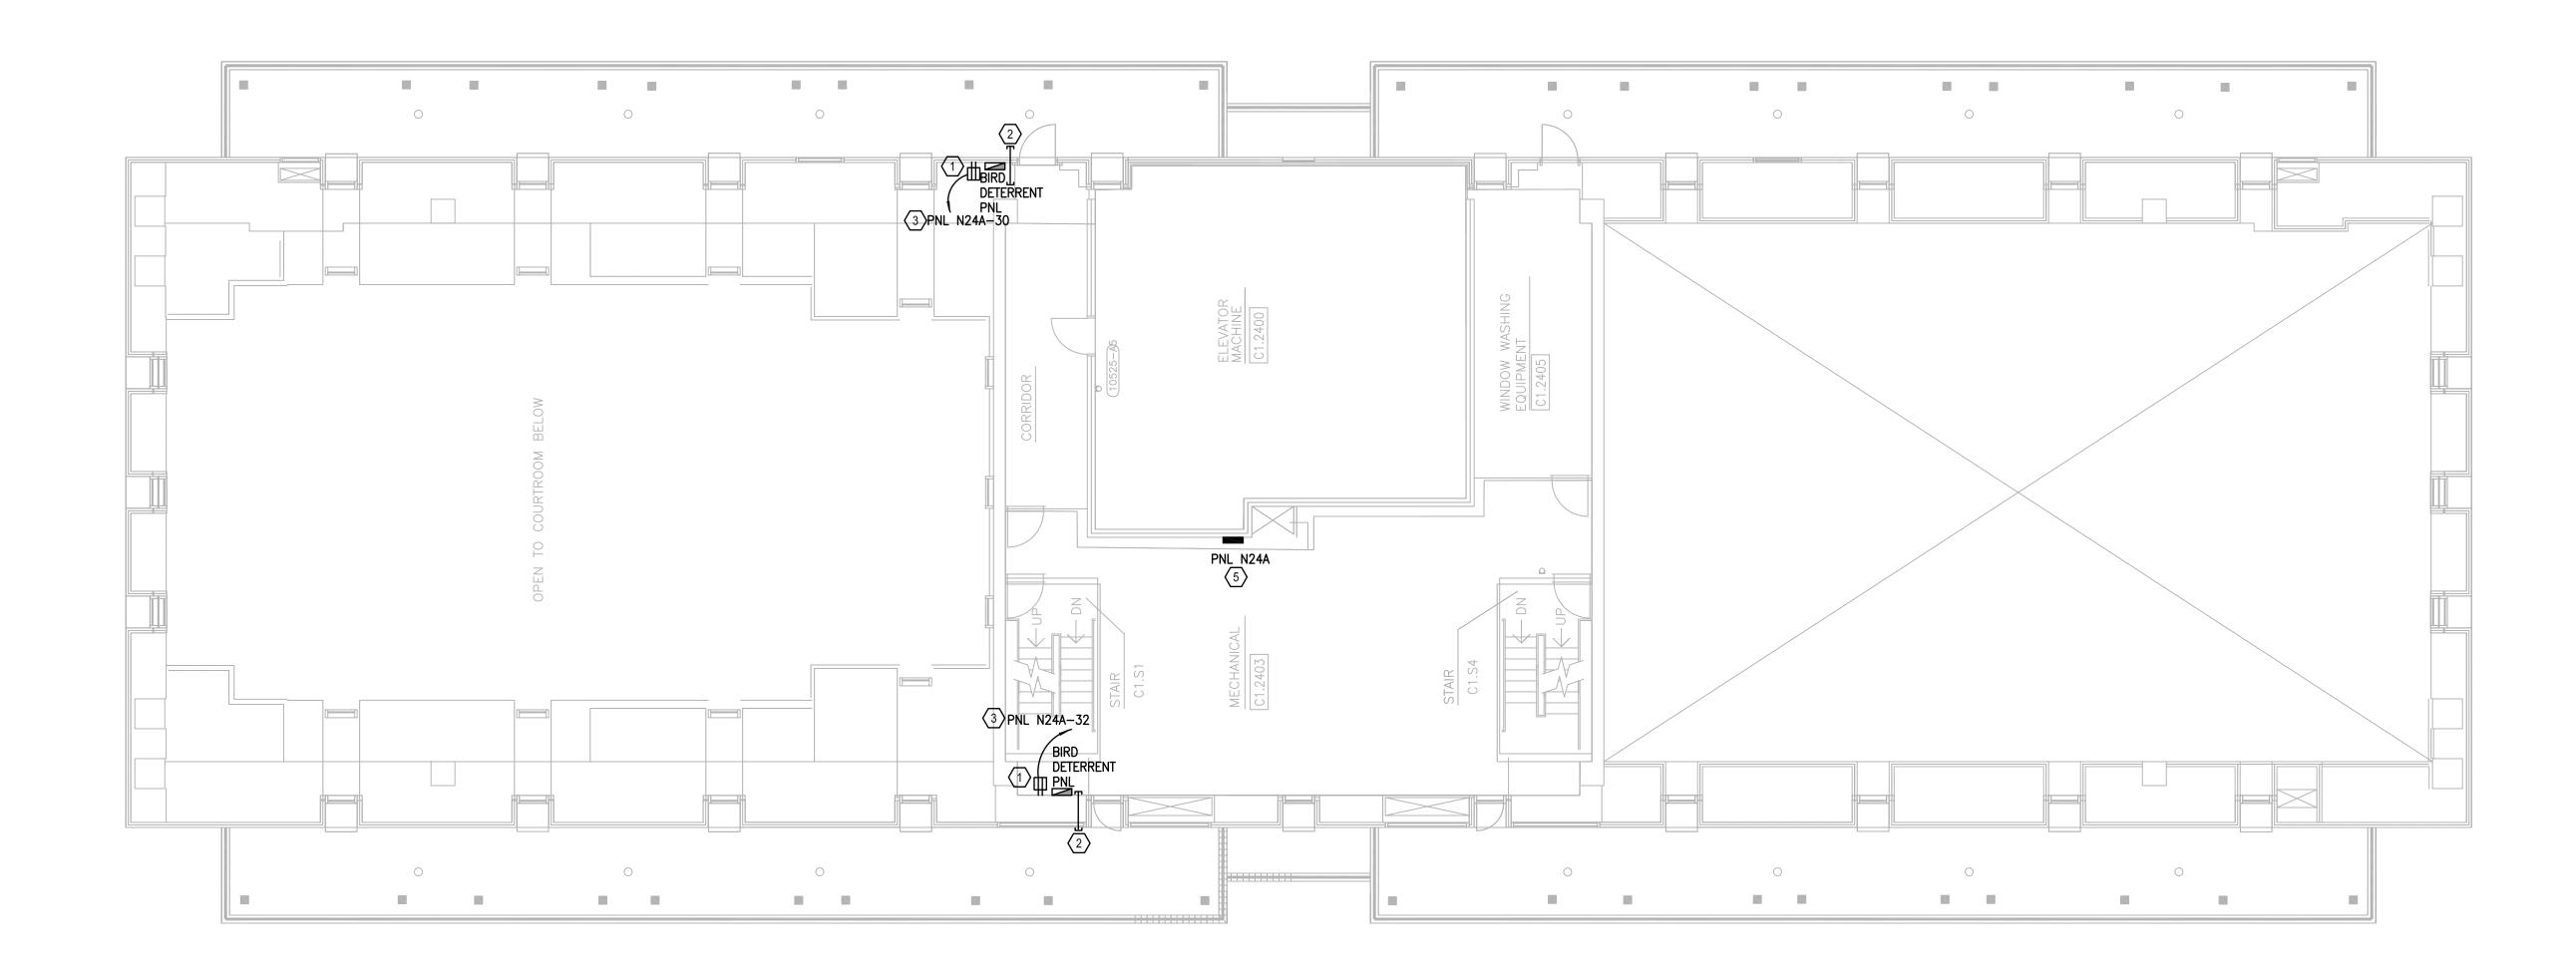


Sheet Title:

FLOOR PLAN LEVEL 23

KEY PLAN 935 Lake Baldwin Lane Orlando, Fl. 32814 SGM TEL: 407-767-5188 ENGINEERING

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# PLAN KEY NOTES: 🗵

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ELECTRICAL FLOOR PLAN LEVEL 24.5



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ORANGE COUNTRY COURTHOUSE BIRD DETERRENT SYSTEM. 425 N. ORANGE AVE, ORLANDO, FL 32801

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File Name


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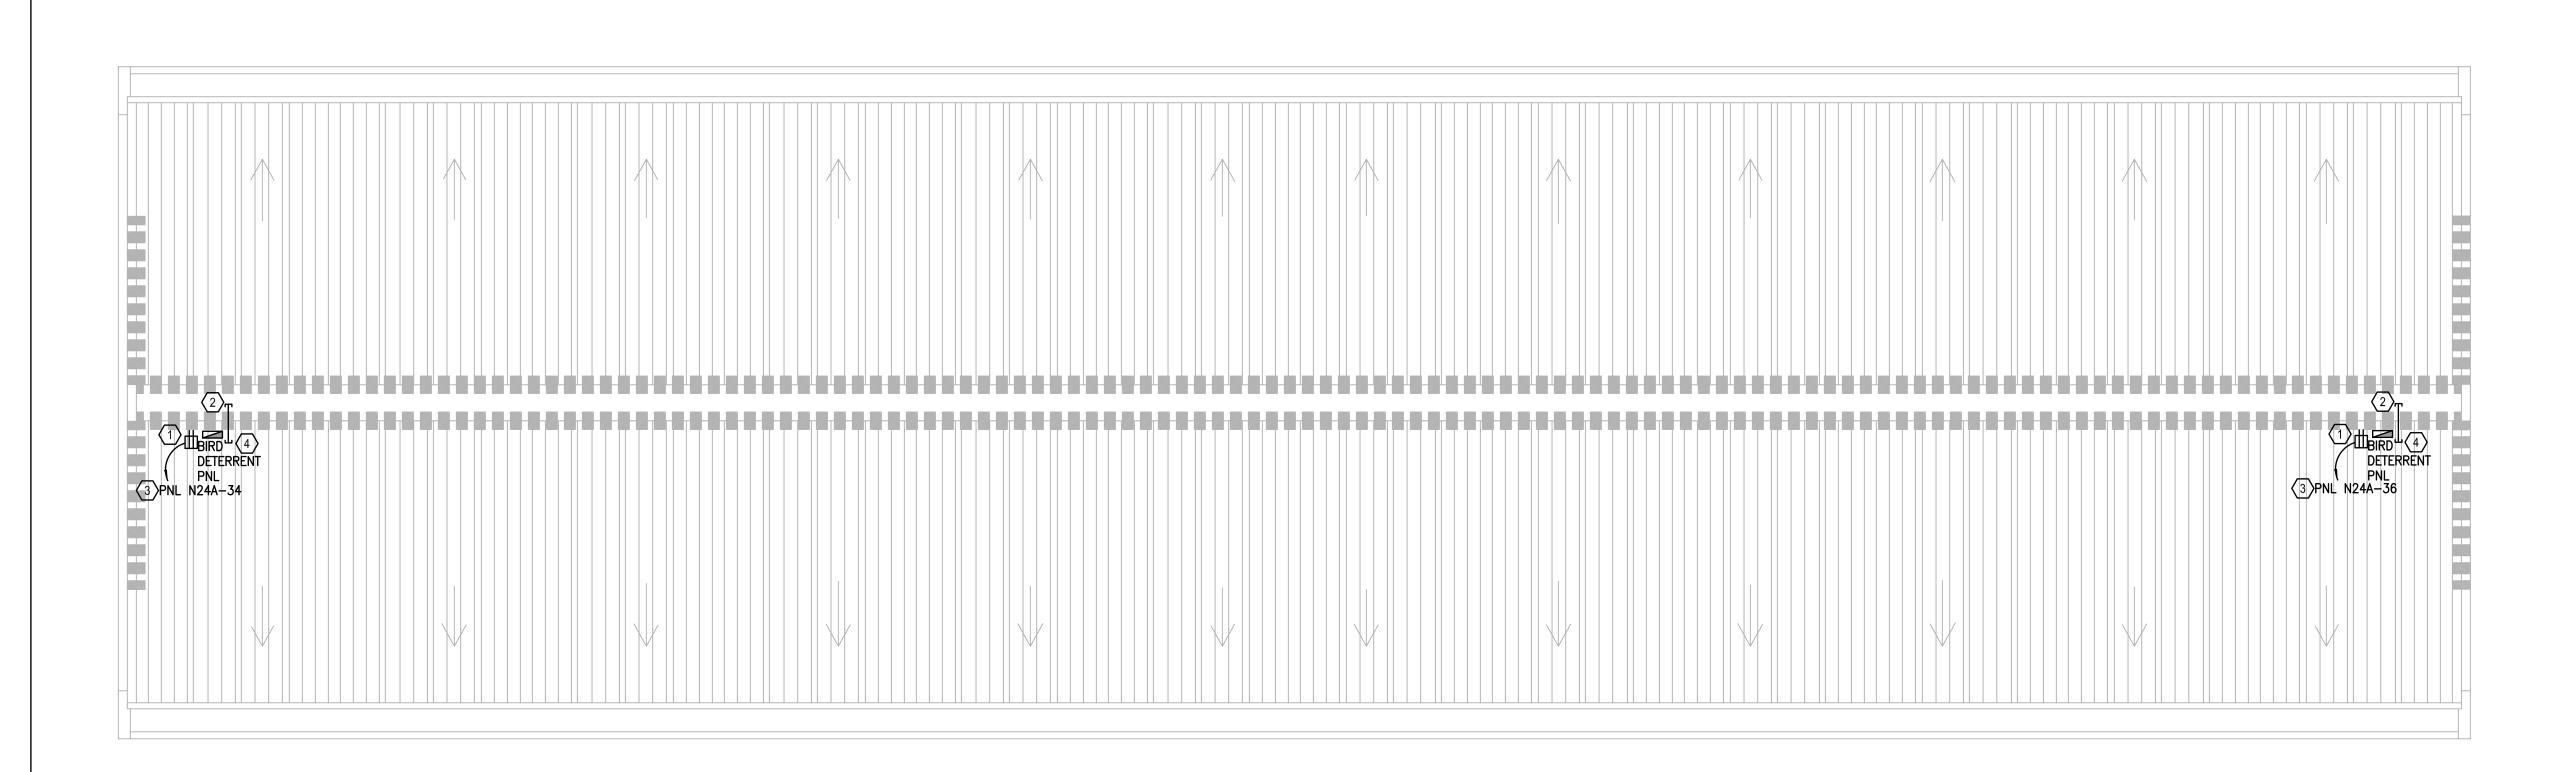
ELECTRICAL FLOOR PLAN LEVEL 24.5

E02.24.5



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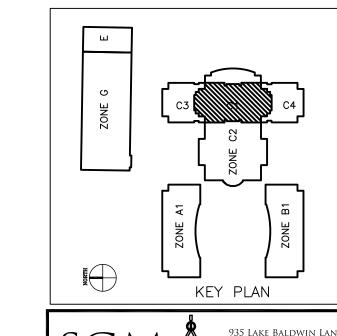


- a. REFER TO SYMBOL LEGEND ON DRAWING E00.00.
- b. REFER TO SPECIFICATIONS IN THE PROJECT MANUAL.
- c. CONTRACTOR SHALL VISIT SITE TO BECOME FAMILIAR WITH ROUTING OF CIRCUITS THROUGH EXISTING CEILINGS AND WALLS. REMOVAL OF DRYWALL MAY BE NECESSARY TO FACILITATE ROUTING OF SLEEVE THROUGH WALL TO EXTERIOR ROOF AREA.
- d. NIGHT SHIFT WORK MAY BE REQUIRED TO ROUTE CIRCUITS THROUGH EXISTING OFFICES ETC..
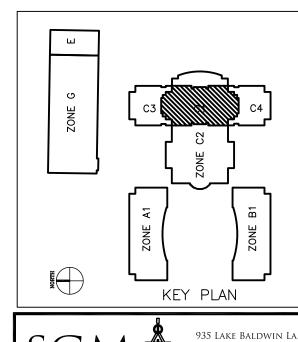
# PLAN KEY NOTES: 🗵

- 1. PROVIDE NEW GFI OUTLET ABOVE CEILING FOR POWER TO BIRD DETERRENT SYSTEM PANEL PROVIDED BY THE BIRD DETERRENT SYSTEM INSTALLER. MARK LOCATION ON CEILING GRID WITH SMALL RED LABEL.
- PROVIDE SLEEVE THROUGH WALL FOR BIRD DETERRENT SYSTEM CABLE TO PASS FROM ROOF TO SYSTEM PANEL ABOVE CEILING. COORDINATE LOCATION WITH BIRD DETERRENT SYSTEM INSTALLER. SEAL ALL SLEEVES TO PREVENT ANY WATER FROM ENTERING THE BUILDING.
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- 4. MOUNT ELECTRICAL BELOW ROOF NEAR EXISTING ROOF ACCESS HATCH.
  PENETRATE ROOF SLEEVE HORIZONTALLY INTO DEPRESSED WALKWAY AREA.
- 5. PROVIDE NEW 20 AMP 120 VOLT C.B.'S IN PANEL FOR EACH NEW CIRCUIT INDICATED, REFER TO PANEL SCHEDULE.





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ARCHITECTURAL DESIGN COLLABORATIVE

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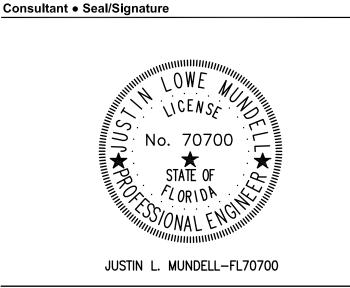
Project:
ORANGE COUNTRY COURTHOUSE
BIRD DETERRENT SYSTEM.
425 N. ORANGE AVE,
ORLANDO, FL 32801

• INTERIOR DESIG

Client Information
ORANGE COUNTY CAPITAL PROJECTS DIVISION
400 E SOUTH STREET 5th FLOOR
ORLANDO, FL 32801

| Project Number | Issue Date | 16325 | 07/13/2017 | Drawn By | Project Status | MB/JJB | 100% CD | Checked By | Scale | 1/8" = 1'-0" |


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Sheet Title:

ELECTRICAL ROOF PLAN

03.01



- a. REFER TO SYMBOL LEGEND ON DRAWING E00.00.
- b. REFER TO SPECIFICATIONS IN THE PROJECT MANUAL.
- c. CONTRACTOR SHALL VISIT SITE TO BECOME FAMILIAR WITH ROUTING OF CIRCUITS THROUGH EXISTING CEILINGS AND WALLS. REMOVAL OF DRYWALL MAY BE NECESSARY TO FACILITATE ROUTING OF SLEEVE THROUGH WALL TO EXTERIOR ROOF AREA.
- d. NIGHT SHIFT WORK MAY BE REQUIRED TO ROUTE CIRCUITS THROUGH EXISTING OFFICES ETC..
- e. THIS PLAN SHOWN FOR APPROXIMATE INSTALLATION INFORMATION ONLY. COORDINATE ALL SLEEVE AND OUTLET LOCATIONS WITH BIRD DETERRENT SYSTEM INSTALLER.
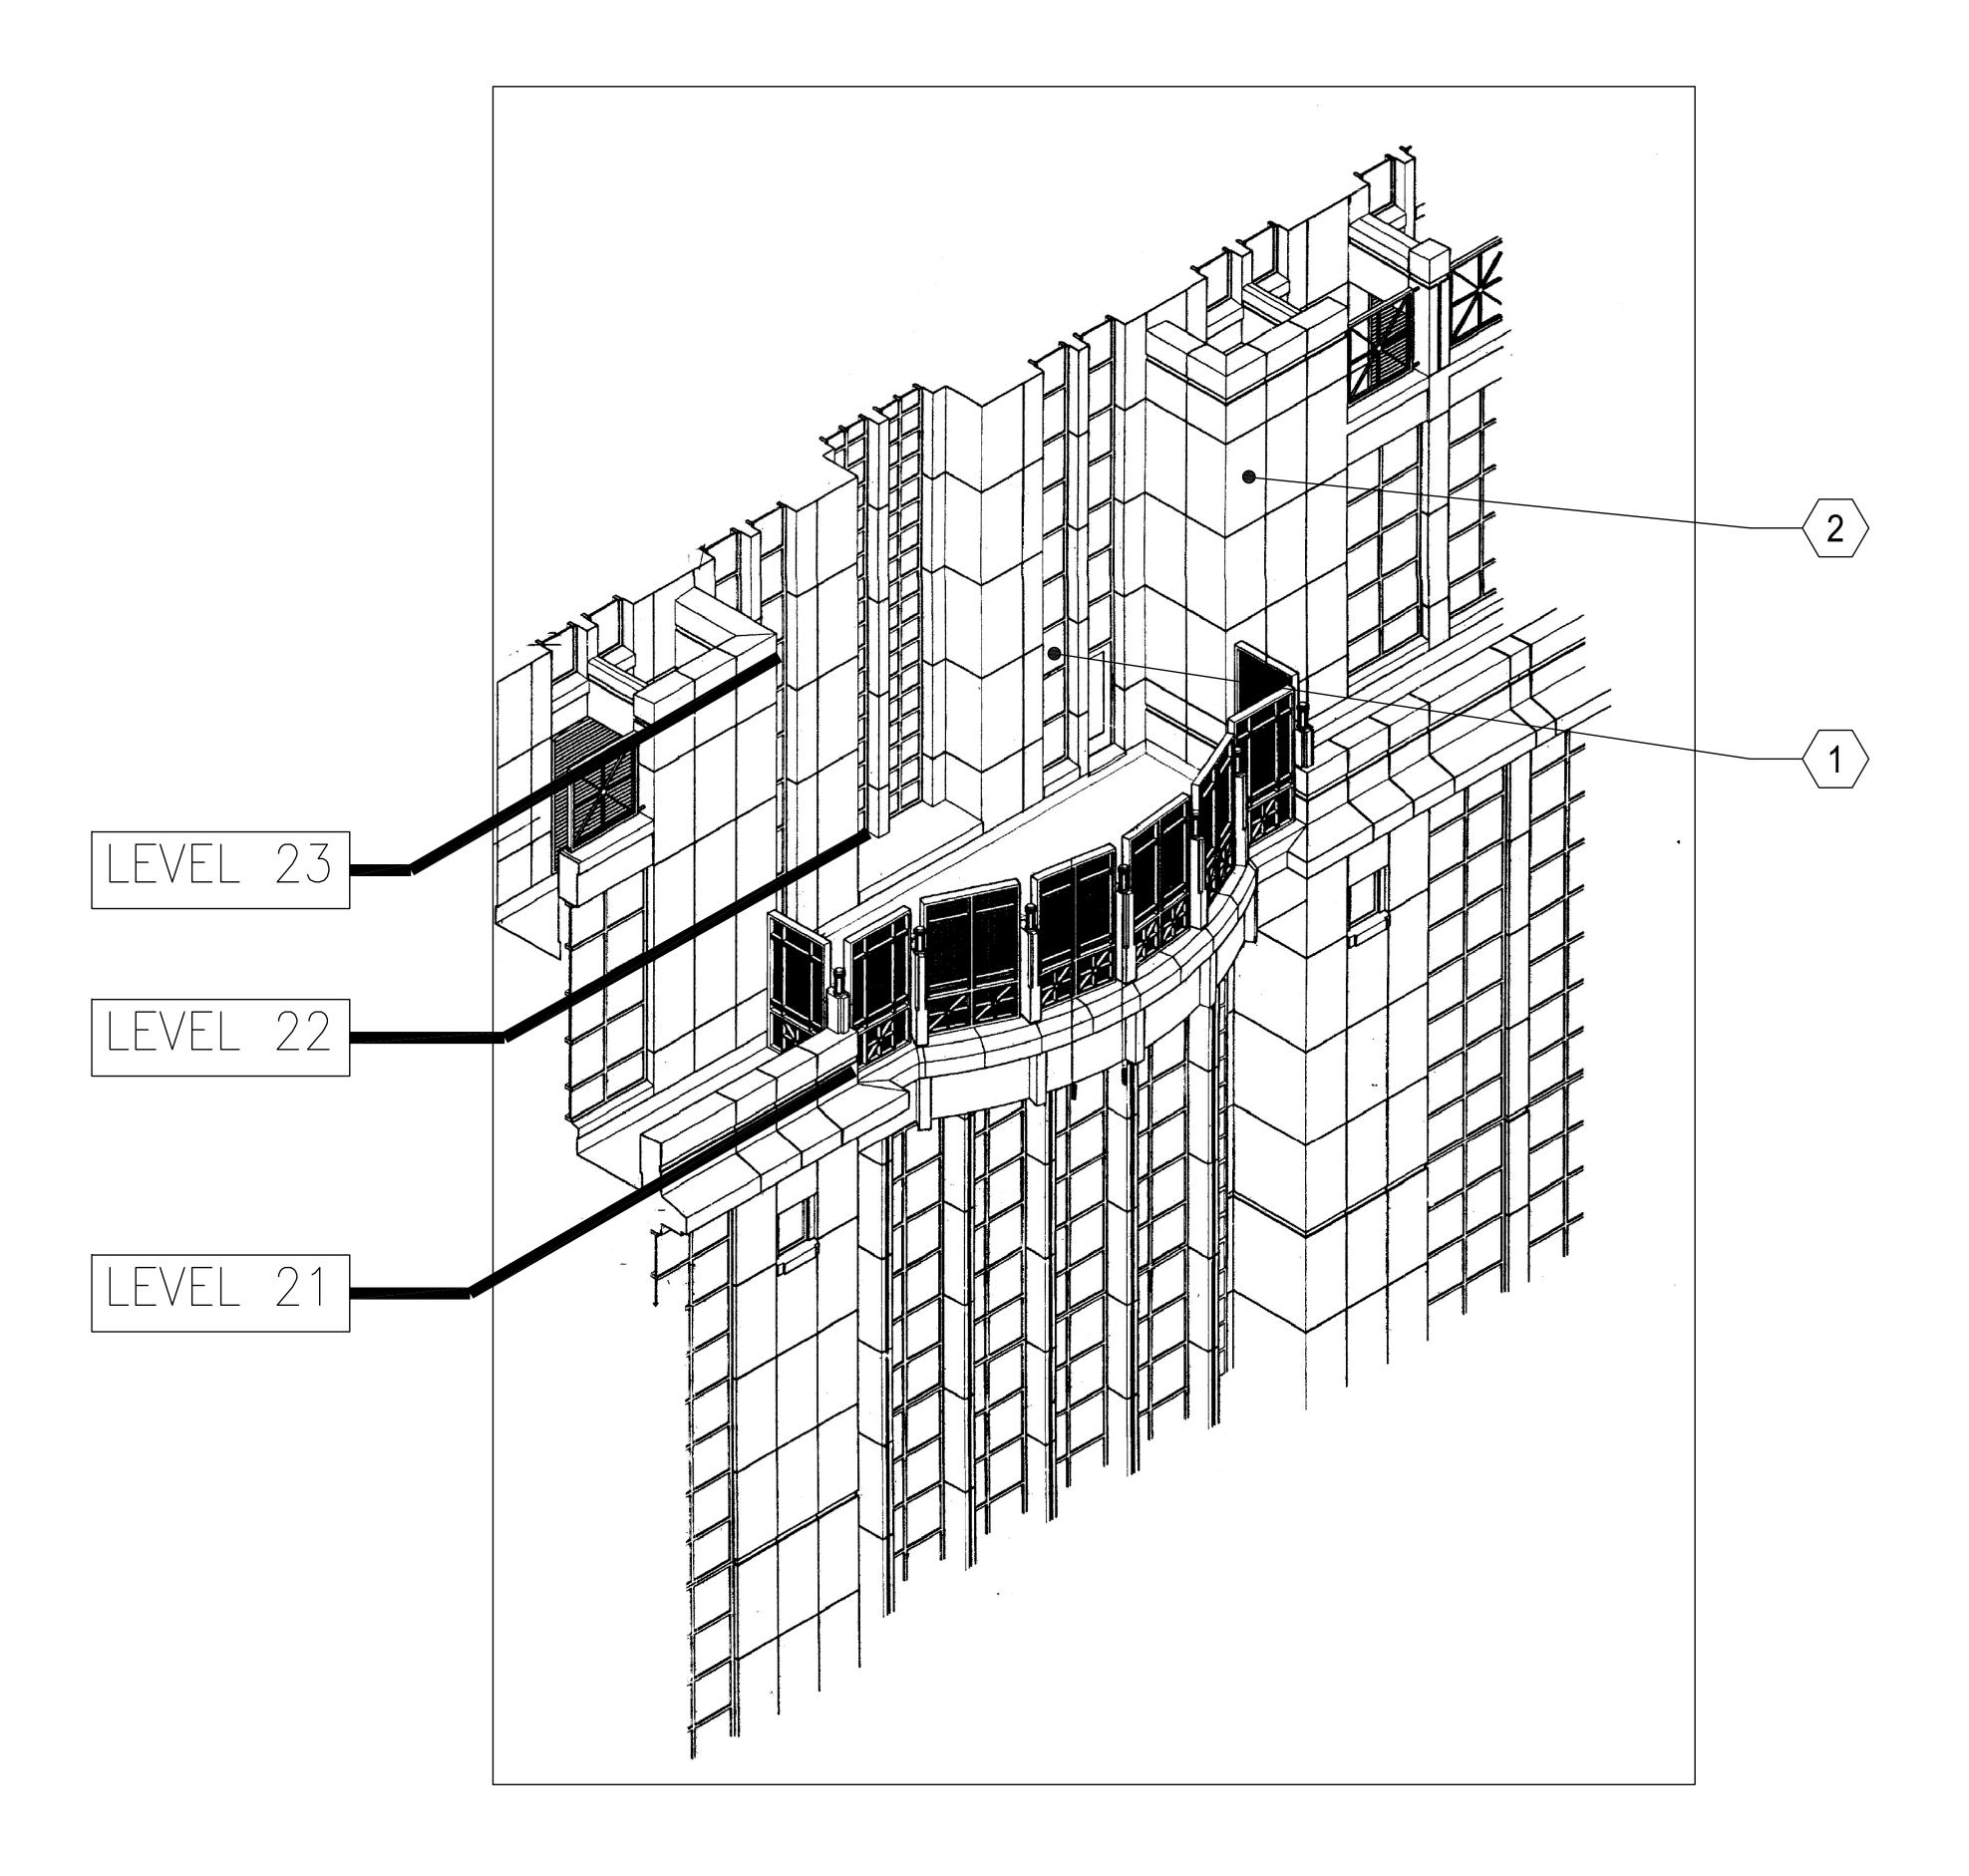
# PLAN KEY NOTES: 🗵

- 1. APPROXIMATE LOCATION OF SLEEVE FOR LEVER 21 CABLE.
- 2. APPROXIMATE LOCATION OF SLEEVE FOR LEVER 23 CABLE, LOCATION BEHIND THIS WALL WITHIN ENCLOSED AREA.

ARCHITECTURAL DESIGN COLLABORATIVE

945 N. PENNSYLVANIA AVENUE WINTER PARK, FLORIDA 32789 OFFICE: (407) 629-1188 FAX: (407) 388-1220 WWW. ADCINTERNATIONAL.NET

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Project Documents for:

ORANGE

AA-C001315

AR-95752

Project:
ORANGE COUNTRY COURTHOUSE
BIRD DETERRENT SYSTEM.
425 N. ORANGE AVE,
ORLANDO, FL 32801

Client Information
ORANGE COUNTY CAPITAL PROJECTS DIVISION
400 E SOUTH STREET 5th FLOOR
ORLANDO, FL 32801

Project Number Issue Date

16325 07/13/2017

Drawn By Project Status

MB/JJB 100% CD
Checked By Scale
NA

File Name

Consultant • Seal/Signature

OWE

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No. 70700

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JUSTIN L. MUNDELL-FL70700

Sheet Title:

ELECTRICAL DETAILS

935 LAKE BALDWIN LANE ORLANDO, FL. 32814
TEL: 407-767-5188
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E09.01

		MANUFACTURER: SQ. D. TYPE: NQOD AIC RATING: 22 VOLTS L-N: 120 VOLTS L-L: 208 PHASE 3	K V V	AMPS			S.E R GFI SHUNT	M ATI PR	CB: LO: ED:	N/A NO	AMPS AMPS			F	PANEL NAME: N22B (EXIST) LOCATION: 22ND FL MECH RM MOUNTING: SURFACE NEMA TYPE: 1 WIDTH: 20.00 DEPTH: 5.75	
N O T E S	CKT NO.	IDENTIFICATION	L O A D	LOAD/PHASE (KVA)			CIRCUIT BRE			EAKER	LOAD/PHASE (KVA)			L O A D	IDENTIFICATION	CKT NO.
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$\dashv$	1		S					-	1					S		2
4	3	SPACE	s					-	1					s	SPACE	4
1	5	BIRD DETERRENT SYSTEM	E			1.00	20	-	1	20			1.00	E	BIRD DETERRENT SYSTEM	6
1	7	BIRD DETERRENT SYSTEM	E	1.00			20	-	1	20	1.00			E	BIRD DETERRENT SYSTEM	8
1	9	BIRD DETERRENT SYSTEM	E		1.50		20	-	1	20		1.00		E	BIRD DETERRENT SYSTEM	10
1	11	BIRD DETERRENT SYSTEM	E			1.50	20	-	1	20			1.00	E	BIRD DETERRENT SYSTEM	12
4	13	SPACE	S					1	₩.					s	SPACE	14
╛	15	SPACE	S					+	1					s	SPACE	16
	17	SPACE	S					1	1					s	SPACE	18
	19	SPARE	S				20	1	1	20				s	SPARE	20
	21	SPARE	S				20	1	1	20				s	SPARE	22
٦	23	SPEAKER MONITOR RECEPT	E			1.00	20	1	1	20			1.00	E	JURY BOX 23RD FL	24
╛	25	FLOOD LIGHT RECEPT	L	1.00			20	1	1	20	0.50			E	WW RELAY POWER	26
7	27	CONFERENCE RM	R		1.00		20	1	1	20		1.00		E	JURY BOX 23RD FL	28
┪	29	SPARE	s				20	1	1	20				s	SPARE	30
┪	31	SPEAKER MONITOR RECEPT	E	1.00			20	1	1	20				s	SPARE	32
T	33	ANTENNA EQUIPMENT	E		1.00		20	1	1					s	SPACE	34
┪	35	SPARE	s				20	1	1					s	SPACE	36
┪	37		0					T	П		7.00			0		38
7	39	PNL N23B	0	1100	7.00		100	3	3	100	1100	7.00		1	EXIST LOAD (OFF)	40
$\dashv$	41		0		1.00	7.00	1					7.00	7.00	0		42
_	71		10		CI ID EE	EDLUGS	L A S INIDI		TED	LEDIA	NK /NOT	HSED)	7.00	101		72
$\neg$			Т		30011	LDLOGC	AO INDI	T	T	, II DLA	IN (NOT	OOLD)				
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				CONN.		DEMAND	1		,	TOTAL 0				,		
				LOAD	DEMAND	LOAD		TO			ONNECTE CTED AN			_		
				(KVA)	FACTOR						L DEMAN					
		LIGHTING (L)	$\vdash$	1.00	1.25	1.25	1		то		MAND AN			_		
		RECEPTACLES 1ST 10 KVA(R)	_	1.00	1.00	1.00	1					THIS P	ANEL IS	FED	FROM A 112.5 KVA XFMR/350 AMP C.B.	
		RECEPTACLES OVER 10KVA(R)		0.00	0.50	0.00	]	G	ENE	RAL NO	TES:					
		HVAC EQUIPMENT (H)	_	0.00	1.00	0.00		a.				HLABE	LING FO	RT	HE PANEL IN ACCORDANCE WITH NFPA 7	0 & 70
		APPLIANCES (A)	_	0.00	1.00	0.00		_		SPECIFIE						
		EQUIPMENT (E)	`—	14.50	1.00	14.50		S	CHE	DULE N	OTES:					
		LARGEST MOTOR (M) OTHER (O)	-	0.00 42.00	1.25	0.00 42.00	-	4	DD.	OVIDE		EAR TH	IC NEW	CIE	CHIT LIDDATE DANE! SCHEDULE	
		OTHER (C)		MAZ UIU	1.00	47. UU	1		. rk	UVIDEN	IEVV C.B.	TUK IH	IS NEW	UK	CUIT. UPDATE PANEL SCHEDULE.	
		SPARE (S)		0.00	1.00	0.00	1	١.								

		MANUFACTURER: SQ. D. TYPE: NQOD AIC RATING: 22 VOLTS L-N: 120 VOLTS L-L: 208 PHASE 3	K A V V	AMPS			S.E.R. GFII SHUNT	MC ML ATE	CB: LO: ED: OT:	N/A 225 N/A N/A	RED AMPS AMPS			F	PANEL NAME: N24A (EXIST) LOCATION: 22ND FL MECH RM MOUNTING: SURFACE NEMA TYPE: 1 WIDTH: 20.00 DEPTH: 5.75	IN IN	
N O T E S	скт	IDENTIFICATION	L O A D		D/PHASE	CIRCUIT BREAKER						PHASE (KVA)		IDENTIFICATION		N O T E	
	NO.		Ш	Α	В	С	TRIP	Р	Р	TRIP	Α	В	С			NO.	
	1		Е	1.50					П		1.50			Ε		2	
	3	WINDOW WASH RECEPT	Е		1.50		30	3	3	30		1.50		Ε	WINDOW WASH RECEPT	4	Т
	5		Е			1.50	1		Н				1.50	Е		6	Т
	7		Е	1.50					П		1.50			Е		8	Т
	9	WINDOW WASH RECEPT	Ε		1.50		30	3	3	30		1.50		Ε	WINDOW WASH RECEPT	10	T
	11		Е			1.50	1		Н				1.50	Е		12	Т
	13	RECEPTS	R	1.00			20	1	1	20				S	SPARE	14	Т
	15	RECEPTS	R		1.00		20	1	1	20				S	SPARE	16	Τ
	17	RECEPTS	R			1.00	20	1	1	20			1.00	R	RECEPTS	18	$\Box$
	19		Е	1.50					П		1.50			Ε		20	Τ
	21	WINDOW WASH RECEPT	Е		1.50		30	3	3	30		1.50		Ε	WINDOW WASH RECEPT	22	$\perp$
	23		Е			1.50			Ш				1.50	Ε		24	Ι
	25	TIME CLOCK	Е	1.00			20	2	1	20				S	SPARE	26	
	27		Е		1.00			_	1	20				S	SPARE	28	
	29	EF	Е			1.00	20	1	1	20			1.00	S	BIRD DETERRENT SYSTEM	30	1
	31	SPACE	S					-	1	20	1.00			S	BIRD DETERRENT SYSTEM	32	1
	33	SPACE	S					-	1	20		1.00		S	BIRD DETERRENT SYSTEM	34	1
	35	SPACE	S					-	1	20			1.00	S	BIRD DETERRENT SYSTEM	36	_
_	37	SPACE	S						1					S	SPACE	38	_
_	39	SPACE	S					_	1					S	SPACE	40	-
	41	SPACE	S					Ι.	1					S	SPACE	42	$\perp$
_			_		SUB FE	ED LUGS	S AS INDI	CA'	TED	, IF BLA	NK (NOT	USED)					_
_	'			6.5	6.5	6.5					5.5	5.5	7.5				
			1	CONN.	DEMAND	DEMAND LOAD		TO.			ONNECTI CTED AN						
			1	(KVA)	FACTOR	(KVA)					L DEMAI			_			
		LIGHTING (L)	-	0.00	1.25	0.00	]		то		MAND AN		106	_			
		RECEPTACLES 1ST 10 KVA(R)	-	4.00	1.00	4.00		_					THIS P	ANE	EL IS FED BY A 200 AMP C.B.		
		RECEPTACLES OVER 10KVA(R)	-	0.00													
		HVAC EQUIPMENT (H) APPLIANCES (A)		0.00	1.00	0.00	-	d.		OVIDE A SPECIFIE		DIL FARE	LING FC	ır I	TE FAMEL IN ACCORDANCE WITH NEPA /	J & 70	ıΕ
		EQUIPMENT (E)		30.00	1.00	30.00	1	SC	-	DULE N							
		LARGEST MOTOR (M)	-	0.00	1.25	0.00	1										
		OTHER (O)		0.00	1.00	0.00		1.	PR	OVIDE N	EW C.B.	FOR NE	W CIRC	UIT	. UPDATE PANEL SCHEDULE.		
		SPARE (S) LINKED PANEL (P)	-	4.00	1.00	4.00											
		LINNED PANEL (P)		INCLUDED	IN ABOVE	IOIALS	]										

945 N. PENNSYLVANIA AVENUE
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STATE OF FLORIDA MARIA FERREIRA Architect • Seal/Signature

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AA-C001315 AR-95752

ORANGE COUNTRY COURTHOUSE BIRD DETERRENT SYSTEM. 425 N. ORANGE AVE, ORLANDO, FL 32801

Issue Date Issue Description Drawn By Checked By

Client Information

ORANGE COUNTY CAPITAL PROJECTS DIVISION

400 E SOUTH STREET 5th FLOOR
ORLANDO, FL 32801

Project Number

16325
Drawn By

MB/JJB
Checked By
JLM

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Consultant • Seal/Signature

OWE

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No. 70700

STATE OF

YORIDA

JUSTIN L. MUNDELL—FL70700

Sheet Title:

ELECTRICAL PANEL SCHEDULES



-09.02