# ORANGE COUNTY CAPITAL PROJECT DIVISION INTERNAL OPERATIONS CENTER II 400 E. SOUTH STREET, 5TH FLOOR ORLANDO, FL 32801

ORANGE COUNTY MAYOR HONORABLE TERESA JACOBS

COMMISSIONER DISTRICT 1 BETSY VANDERLEY

COMMISSIONER DISTRICT 2 **BRYAN NELSON** 



**PROJECT** ORANGE COUNTY SHERIFF'S GUN RANGE EAST / WEST BUILDING, NORTH RANGE BUILDING, & RIFLE RANGE STRUCTURAL & LIGHTING REPAIRS 12455 WEWAHOOTEE RD. ORLANDO, FL 32832

ORANGE COUNTY PROJECT MANAGER: AJ MURRAY

ARCHITECTURAL DESIGN COLLABORATIVE



945 N. PENNSYLVANIA AVENUE WINTER PARK, FLORIDA 32789 P: (407) 629-1188 CONTACT: AL COOPER EMAIL: acooper@adcinternational.net COMMISSIONER DISTRICT 3 PETE CLARKE

COMMISSIONER DISTRICT 4 JENNIFER THOMPSON

COMMISSIONER DISTRICT 5 EMILY BONILLA

COMMISSIONER DISTRICT 6 VICTORIA P. SIPLIN

SGM ENGINEERING




MEP ENGINEER 935 LAKE BALDWIN LANE ORLANDO, FL 32814 CONTACT: JOHN J BONOTTO

BASE CONSULTANTS

STRUCTURAL ENGINEERS 4767 NEW BROAD STREET #1018 ORLANDO, FL 32814 CONTACT: NICK CHAPMAN EMAIL: nick@baseconsults.com

> **ADDRESS** 12455 WEWAHOOTEE RD ORLANDO, FL

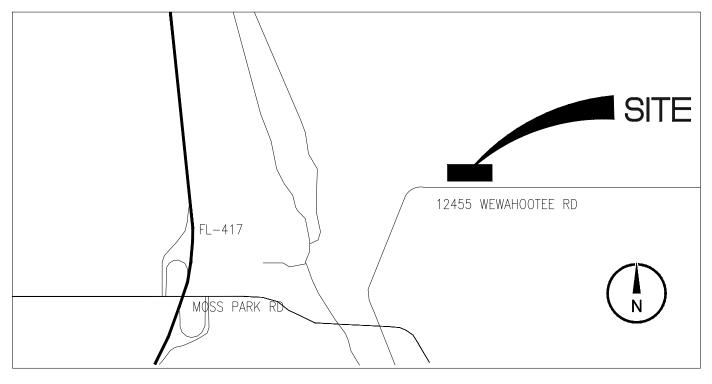

**LOCATION MAP** 

FINAL BID/PERMIT SET 05.01.17

### ARCHITECTURAL ABBREVIATIONS

RDR

REFL

REQD

REINF

SCR

SGL

STD

STL

STRUCT

SUSP

SYS

THK

TLT

T&G

TYP

UTIL

VEH

VERT

VIF

WD

WDW

SHORG

SECUR

READER

RECESSED

RECEPTACLE

REFER(ENCE)

REFRIGERATOR

REINFORCE(D)(ING)(MENT)

REFLECTED

REQUIRED RESIST(ANT)(IVE)

RESILIENT

ROOFING

ROOM

SCRIBE

SINGLE

SHORING

SIMILAR

STEEL

STANDARD

STOREFRONT

STRUCTURAL

SUSPENDED

SYSTEM(S)

THICK

TOILET

TRAFFIC

TREATED

TYPICAL

UNDRLAY UNDERLAYMENT

UTILITY

VEHICLE

VERTICAL

WITH

WOOD

WINDOW

WITHOUT WEIGHT WTRPRF WATERPROOFING

VERIFY IN FIELD

WATER CLOSET

TRANSPARENT

TONGUE AND GROOVE

UNLESS NOTED OTHERWISE

SURFACE

SECURITY

**SQUARE FEET** 

STAINLESS STEEL

ARC	CHITECTURAL	ABBF	REVIATIONS
A		G	
ACCES	ACCESSORY	GA	GAUGE
ACOUS AFF	ACOUSTIC(AL) ABOVE FINISHED FLOOR	GFRC	GLASS FIBER REINFORCED CONCRETE
AHJ AL	AUTHORITY HAVING JURISDICTION ALUMINUM	GFRG	GLASS FIBER REINFORCED GYPSUM
ALT ANNUNC	ALTERNATE ANNUNCIATOR	GFRP	GLASS FIBER REINFORCED PLASTER
ANOD	ANODIZED	GL	GLASS GRAD(F)(ING)
APPL ARCH	APPLIANCE ARCHITECT(URAL)	GR GYP	GRAD(E)(ING) GYPSUM
AUTO AVG	AUTOMATIC AVERAGE		
&	AND	<u>H</u>	
В		HD	HEAD
		HDWD HDWE	HARDWOOD HARDWARE
BLDG BOLLD	BUILDING BOLLARD	HM	HOLLOW METAL
BD	BOARD	HORIZ HVAC	HORIZONTAL HEATING, VENTILATING, AND
BLKG BRDLM	BLOCKING BROADLOOM	ı	AIR CONDITIONING
BU	BUILT UP	<u> </u>	
C		INFO INSTRUM	INFORMATION INSTRUMENT(ATION)
CAB	CABINET	INSUL	INSULATION
CPT	CARPET	INTLK INT	INTERLOCK(ING) INTERIOR
CEM CER	CEMENT(ITIOUS) CERAMIC	INFILTR	INFILTRATION
CLG COATG	CEILING COATING	J	
COILG	COILING	JAN	JANITOR
CONC CONSTR	CONCRETE CONSTRUCTION		
CONT CONTR	CONTINUOUS(ATION) CONTRACT(OR)	<u>K</u>	
COV	COVER	KIT	KITCHEN
CMU	CONCRETE MASONRY UNIT	L	
<u>D</u>		LAV	LAVATORY
DBL	DOUBLE	LB	POUND
DEPT DES	DEPARTMENT DESIGN(ED)	£ LT	BRITISH POUND (CURRENCY) LIGHT
DET	DETAIL	LVLG	LEVELING
DF DIA	DRINKING FOUNTAIN DIAMETER	LVR	LOUVER
DIFF DIM	DIFFUSER DIMENSION	M	
DISP	DISPENSER	MAX	MAXIMUM
DIV DN	DIVISION DOWN	MFD MFR	MANUFACTURED MANUFACTURER
\$	DOLLAR (US CURRENCY)	MECH	MECHANICAL
DR DSCON	DOOR DISCONNECT	MET MEMB	METAL MEMBRANE
DWR	DRAWER	MEZZ	MEZZANINE
E		MIN MISC	MINIMUM MISCELLANEOUS
-	FLACTOMEDIO.	MLWK	MILLWORK
ELAST ELEC	ELASTOMERIC ELECTRICAL	MOIST MOT	MOISTURE MOTOR(IZED)
EMBED	EMBEDD(ED)(ING)	MTD	MOUNTED
ENGR ENTR	ENGINEER(ED) ENTRANCE	N	
EQ	EQUAL		NOT IN CONTRACT
EQUIP EXIST	EQUIPMENT EXISTING	NIC NO	NOT IN CONTRACT NUMBER
EXP JT EXPS	EXPANSION JOINT EXPOSE(D)	NTS	NOT TO SCALE
EXT	EXTERIOR	0	
F		ORNA	ORNAMENTAL
FAB	FABRICATION	OVFL OVHD	OVERFLOW OVERHEAD
FD	FLOOR DRAIN	OPNG	OPENING(S)
FE FE&C	FIRE EXTINGUISHER FIRE EXTINGUISHER AND	OPR	OPERABLE
	CABINET	<u>P</u>	
FHC FIN	FIRE HOSE CABINET FINISH	PTN	PARTITION
FLDG	FOLDING	PEDTR	PEDESTRIAN
FPLC FR	FIREPLACE FIRE RAT(ING)(ED)	PBD PjM	PARTICLE BOARD PROJECT MANAGER
FRMG	FRAMING	PNL POLYST	PANEL POLYSTYRENE
FXD FXTR	FIXED FIXTURE	POLYST	PORTABLE
FLR	FLOOR(ING)	PREFIN	PREFINISHED
FURN	FURNITURE	PREFAB PLAM	PREFABRICATED PLASTIC LAMINATE


PLASTER


PLSTC PLASTIC

PLYWD PLYWOOD PRTECN PROTECTION

PLAS

## **VICINITY MAP**

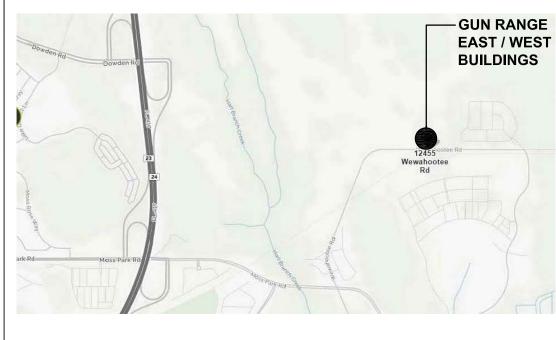

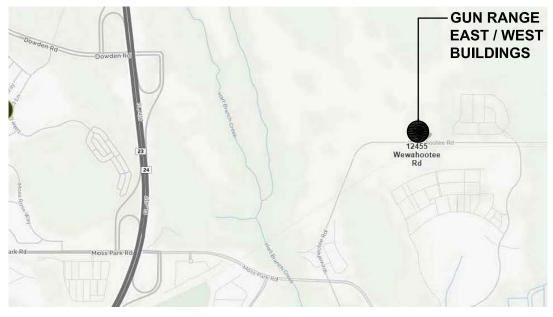

### PROJECT INFORMATION

**APPLICABLE CODES** FLORIDA BUILDING CODE - 2014 FLORIDA BUILDING CODE ACCESSIBILITY (5th EDITION 2014) FLORIDA FIRE PREVENTION CODE - (5th EDITION) NFPA 101 - LIFE SAFETY CODE 2012 WITH FLORIDA AMENDMENTS NFPA 1- UNIFORM FIRE CODE 2012 WITH FLORIDA AMENDMENTS NFPA 70 - NATIONAL ELECTRICAL CODE -2011 FLORIDA MECHANICAL CODE - N/A

**OCCUPANCY** GROUP CLASSIFICATION: OCCUPANT/SQ. FT.: SCOPE OF WORK SQ. FT.:

OCCUPANT DESIGN LOAD:

UTILITY GROUP U 300 GROSS ASSUMED 30,100 SQ. FT. PISTOL RANGE 2,520 SQ. FT N PPC BUILDING 840 SQ. FT. RIFLE RANGE 30,100 SQFT/300 = 101 PL 2,520 SQFT/300 = 9 PL

840 SQFT/300 = 3 PL

**ALTERATION LEVEL:** ALTERATION LEVEL I

N/A

CONSTRUCTION

TYPE: VΒ SPRINKLED or NONSPRINKLED: NONSPRINKLED BUILDING HEIGHT: 1 STORY

**PLUMBING REQUIREMENTS:** 

# **PROJECT NARRATIVE**

PROJECT NARRATIVE/SCOPE OF WORK

STRUCTURAL REPAIRS TO AN EXISTING OPEN WOOD STRUCTURE WITH METAL ROOF. EXISTING WOOD TRUSSES AND BEAMS HAVE DETERIORATED DUE TO WEATHER CONDITIONS. STRUCTURAL DRAWINGS HAVE BEEN PROVIDED FOR REMEDIATION.

ALTERNATE: INSTALL LED FLOOD LIGHTS AND LIGHTING CONTROLS TO ILLUMINATE TARGETS.

#### **SCOPE OF WORK NOTES:**

- 1. WORK THAT IS NOT STATED HEREIN NOR SHOWN IN THESE PLANS IS NOT PART OF THE SCOPE OF WORK FOR THIS PROJECT.
- 2. ADDITIONAL WORK REQUIRED THAT WOULD ALTER THE PRESENTED SCOPE OF WORK SHALL BE SUBJECT TO A REVISION OF THESE DOCUMENTS AND MAY BE REQUIRED TO BE REVIEWED BY THE BUILDING DEPARTMENT HAVING JURISDICTION.

### **DRAWING INDEX**

### **ARCHITECTURAL**

**COVER SHEET** A00.00 INDEX, CODES & PROJECT INFORMATION ARCHITECTURAL SITE PLAN

### MEP (ALTERNATE 1 & 2)

ELECTRICAL SYMBOLS AND FIXTURE SCHEDULE E100 ELECTRICAL SITE PLAN E101 ISOMETRIC PLAN-LTG PHOTOMETRICS E102 PHOTOMETRIC RENDERING E201 ENLARGED ELECTRICAL PLANS E202 ENLARGED ELECTRICAL PLANS

### STRUCTURAL

E401

S001 STRUCTURAL GENERAL NOTES S101 PISTOL RANGE REPAIR PLAN S102 PISTOL RANGE REPAIR PLAN S103 PISTOL RANGE REPAIR PLAN S104 NORTH PPC BLDG / RIFLE RANGE REPAIR PLAN

ELECTRICAL DETAILS

S401 STRUCTURAL REPAIR DETAILS

STRUCTURAL REPAIR DETAILS

ARCHITECTURAL DESIGN COLLABORATIVE

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05/01/17

STATE OF FLORIDA AA-C001315 MARIA FERREIRA, R.A. AR-0095752

Architect ● Seal/Signature

Construction Documents for:

ORANGE COUNTY SHERIFF'S GUN RANGE EAST / WEST RANGE BUILDING NORTH BUILDING, & RIFLE RANGE STRUCTURAL & LIGHTING REPAIRS
12455 WEWAHOOTEE RD RLANDO, FL 32832

Issue	Date & Issue	Description Drawn By	Checked I
1	06.27.16	90% CD	KA
2	01.19.17	90% REVIEW SET	KA
3	05.01.17	FINAL BID/PERMIT SET	KA

Client Information



Project Number 16123 Drawn By Checked By

**Project Status** FINAL BID/PERMIT

Issue Date

X:\dwgs\16123 OC Sheriff's Office Gun Range\CAD\SHEETS\ A00.00 INDEX.dwg

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Sheet Title:

INDEX


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**FUTURE** 

FUTURE

FABRIC WALL COVERING

FUT

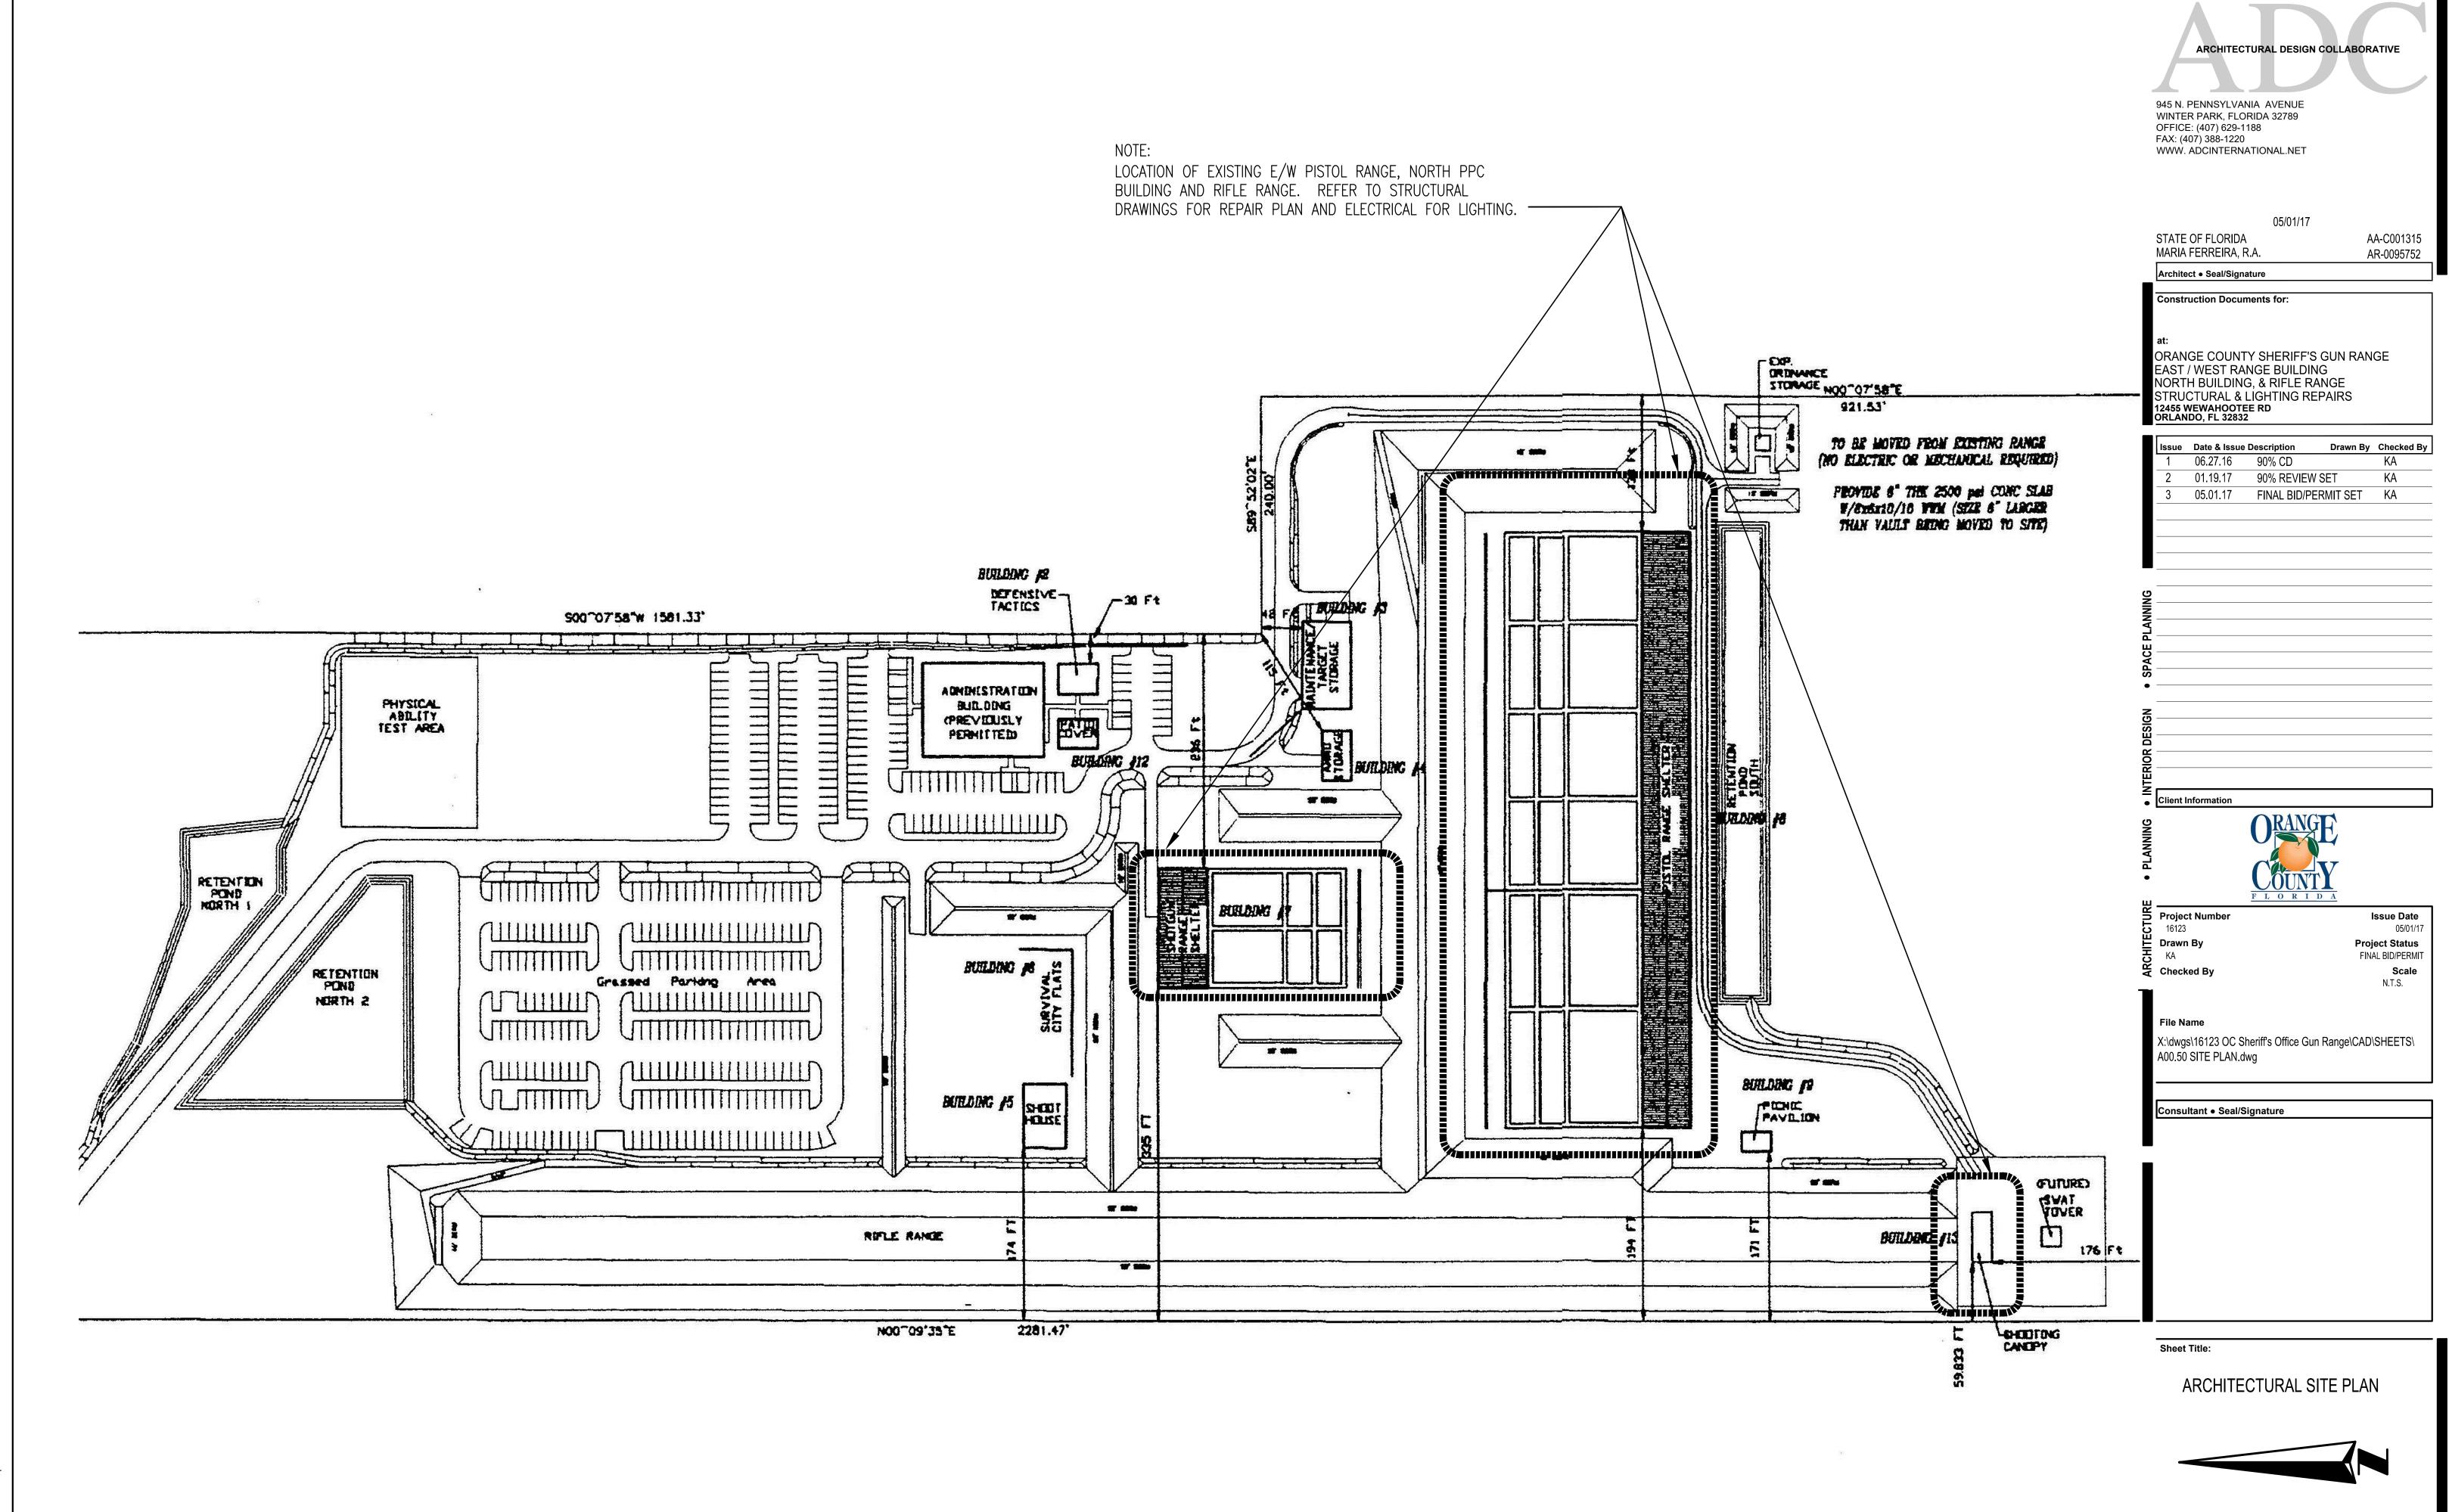

NTED ON: Apr 28, 2017 - 4:58pm

A00.50

FEEDER OR BRANCH CIRCUIT CONCEALED IN WALL,

HOMERUN CONSISTING OF ONE SINGLE-PHASE, 1-POLE 1R1-1 CIRCUIT: (2) 12 AWG + (1) 12 AWG GND IN 3/4" CONDUIT, UNLESS OTHÉRWISE NOTED. PANELBOARD AND CIRCUIT

> HOMERUN CONSISTING OF ONE SINGLE-PHASE, 2-POLE CIRCUIT: (2) 12 AWG + (1) 12 AWG GND IN 3/4" CONDUIT, UNLESS OTHÉRWISE NOTED. PANELBOARD AND CIRCUIT

1R1-1,3 12 AWG + (1) 12 AWG GND IN 3/4" CONDUIT, UNLESS

1R1-1,3,5 (4) 12 AWG + (1) 12 AWG GND IN 3/4" CONDUIT, UNLESS

HOMERUN CONSISTING OF TWO SINGLE-PHASE CIRCUITS: (3)

OTHERWISE NOTED. PANELBOARD AND CIRCUIT DESIGNATION

HOMERUN CONSISTING OF THREE SINGLE-PHASE CIRCUITS:

OTHERWISE NOTED. PANELBOARD AND CIRCUIT DESIGNATIONS

HOMERUN CONSISTING OF ONE THREE-PHASE CIRCUITS: (3) 12 AWG + (1) 12 AWG GND IN 3/4" CONDUIT, UNLESS OTHERWISE NOTED. PANELBOARD AND CIRCUIT DESIGNATIONS

CEILING OR FLOOR

DESIGNATION ARE INDICATED.

DESIGNATIONS ARE INDICATED.

ARE INDICATED.

ARE INDICATED.

ARE INDICATED.

	LUMINAIRE SCHEDULE				
TYPE	DESCRIPTION	DESIGN SELECTION	VOLTS	LAMPS/FIXT.	
SA	BRACKET MOUNTED LED FLOOD LIGHT WITH 0-10 VOLT DIMMING	CREE # FLD-EHO-40-HV-12-UL-BZ-1000/WM -DIM-4L-BZ ("L" MOUNTING BRACKET)	UNV	421W	
SSA	CONCRETE POLE MOUNTED LED FLOOD LIGHT. PROVIDE ALL MOUNTING ACCESSORIES.	CREE # FLD-EHO-40-HV-12-UL-BZ-1000/WM -4L-BZ - POLE	UNV	421W	

PROVIDE SPECIFIED LIGHT FIXTURES OR PRE-APPROVED EQUAL.

#### **ABBREVIATIONS**

ADE	PREVIATIONS				
A AFC AFF AFG AIC AWG BFC CAB CKT CLG CU DISC DWG EA ECB	AMPERES ABOVE FINISHED CEILING ABOVE FINISHED FLOOR ABOVE FINISHED GRADE AMPERES INTERUPTING CAPACITY ALUMINUM AMERICAN WIRE GAUGE BELOW FINISHED CEILING BELOW FINISHED GRADE CONDUIT CABINET CIRCUIT CEILING CENTERLINE CURRENT TRANSFORMERS COPPER DISCONNECT(ING) DRAWING(S) EACH ENCLOSED CIRCUIT BREAKER	EXIST EXP FA FLA FLUOR GFCI GFP GND HGT HID HPS HOA HP HVAC HV INC JB kV	EXISTING EXPLOSION PROOF FIRE ALARM FULL LOAD AMPERES FLUORESCENT GROUND FAULT CIRCUIT INTERRUPTER GROUND FAULT PROTECTION GROUND HEIGHT HIGH INTENSITY DISCHARGE HIGH PRESSURE SODIUM HAND-OFF-AUTOMATIC HORSEPOWER HEATING/VENTILATING/ AIR CONDITIONING HIGH VOLTAGE INCANDESCENT JUNCTION BOX KILO-VOLTS	m mm MAX MCB MFR MH MIN MISC MTD MTG NEC PNL PSC REC SPD TEL TYP UON USB	TELEPHONE TYPICAL UNLESS OTHERWISE NOTE
CLG CL CT's CU DISC DWG EA ECB EF EMT EQUIP EUH EWC EWH	CENTERLINE CURRENT TRANSFORMERS COPPER DISCONNECT(ING) DRAWING(S) EACH	HP HORSEPO' HVAC HEATING/' AIR COND HV HIGH VOL INC INCANDES JB JUNCTION kV KILO-VOL kVA KILO-VOL kVAR KILO-VOL kW KILO-WAT	HORSEPOWER HEATING/VENTILATING/ HIGH VOLTAGE NCANDESCENT HUNCTION BOX KILO-VOLTS KILO-VOLTS-AMPERES KILO-VOLTS-AMPERES KILO-WATTS KILO-WATT-HOURS	REC RGS SPD TEL TYP	RECEPTACLE RIGID GALVANIZED STEEL SURGE PROTECTION DEVICE TELEPHONE

ALL ELECTRICAL DRAWINGS SHALL BE BID AS PART OF ADD ALTERNATE #1 EXCEPT FOR DRAWING E401 WHICH SHOULD BE BID AS ADD ALTERNATE #2

945 N. PENNSYLVANIA AVENUE WINTER PARK, FLORIDA 32789 OFFICE: (407) 629-1188 FAX: (407) 388-1220 WWW. ADCINTERNATIONAL.NET STATE OF FLORIDA AA-C001315 MARIA FERREIRA, r.a. AR-0095752 Architect ● Seal/Signature **Construction Documents for:** 

ARCHITECTURAL DESIGN COLLABORATIVE

ORANGE COUNTY SHERIFF'S GUN RANGE EAST / WEST RANGE BUILDING NORTH BUILDING, & RIFLE RANGE STRUCTURAL & LIGHTING REPAIRS 12455 WEWAHOOTEE RD ORLANDO, FL 32832 Drawn By Checked By Issue Date & Issue Description

1 06.27.16 90% CD 2 01.19.17 90% REVIEW SET 05.01.17 FINAL BID/PERMIT SET JJB Client Information

> **Project Number** Issue Date 16123 Drawn By **Project Status** MB FINAL BID/PERMIT Checked By N.T.S.

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JUSTIN L. MUNDELL-FL70700

E001

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OWNERSHIP OF INSTRUMENTS OF SERVICE:

NOTE: SOME SYMBOLS SHOWN ON THIS LEGEND MAY NOT PERTAIN TO THIS PROJECT.

Sheet Title: ELECT. SYMBOLS AND FIXT. SCHED.

### **GENERAL NOTES:**

- a. ALL ELECTRICAL ON THIS DRAWING SHALL BE BID AS ADD ALTERNATE #1.
- b. REFER TO SYMBOL LEGEND AND LIGHT FIXTURE ON E001.
- c. REFER TO BOOK SPECIFICATIONS.

### PLAN KEY NOTES:

1. PROVIDE NEW FLOODLIGHTING AT RIFLE RANGE TARGET. CONNECT

TO EXISTING PANEL LOCATED AT SHOOT HOUSE. LOCATE NEW POLE

MOUNTED FLOODLIGHT 3/4 OF THE WAY UP THE INSIDE STEEP SLOPE

OF THE EXISTING BERM. BURY 30' CONCRETE POLE 10' DEEP IN THE

30 FEET HIGH BERM AND TURN POLE 45 DEGREES SO SIDE OF POLE

IS NOT SQUARE WITH FLIGHT OF BULLETS. LOCATE 50 YARDS FROM

TARGET AND AIM FIXTURES AS REQUIRED BY COUNTY. A CRANE MAY

BE NEEDED TO AUGER HOLE AND INSTALL POLE. VISIT SITE PRIOR TO

2. ROUTE CONDUIT IN BERM TO EXISTING PANEL. LOCATE EXISTING UTILITIES AND HAND DIG TRENCH. PROVIDE 1" C. WITH (3) #4 CU

BID TO ASSESS EXISTING CONDITIONS.

- BETWEEN LIGHT FIXTURE AND CONTACTOR. PROVIDE QUAZITE PULLBOXES EVERY 200 FEET.
- PROVIDE NEW CIRCUIT BREAKERIN EXISTING PANEL AND A PHOTOCELL TO CONTROL CIRCUIT.
- PROVIDE NEMA 3R 120 VOLT COIL LIGHTING CONTACTOR TO CONTROL NEW POLE MOUNTED FLOODLIGHTS. ROUTE CONTROL CIRCUIT, FROM CONTACTOR TO WEATHERPROOF SWITCH LOCATED AT RIFLE RANGE SHELTER. COORDINATE EXACT LOCATION OF SWITCH AT SHELTER WITH THE COUNTY.
- 5. ROUTE 1" C. AND (3) #8 CU CONDUCTORS BETWEEN CONTACTOR AND SWITCH. PROVIDE QUAZITE PULLBOXES EVERY 200 FEET.



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06/27/16

MARIA FERREIRA, r.a. AR-0095752

AA-C001315

Architect • Seal/Signature

**Construction Documents for:** 

ORANGE COUNTY SHERIFF'S GUN RANGE EAST / WEST RANGE BUILDING NORTH BUILDING, & RIFLE RANGE STRUCTURAL & LIGHTING REPAIRS 12455 WEWAHOOTEE RD ORLANDO, FL 32832

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No. 70700

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ELECTRICAL SITE PLAN

E100


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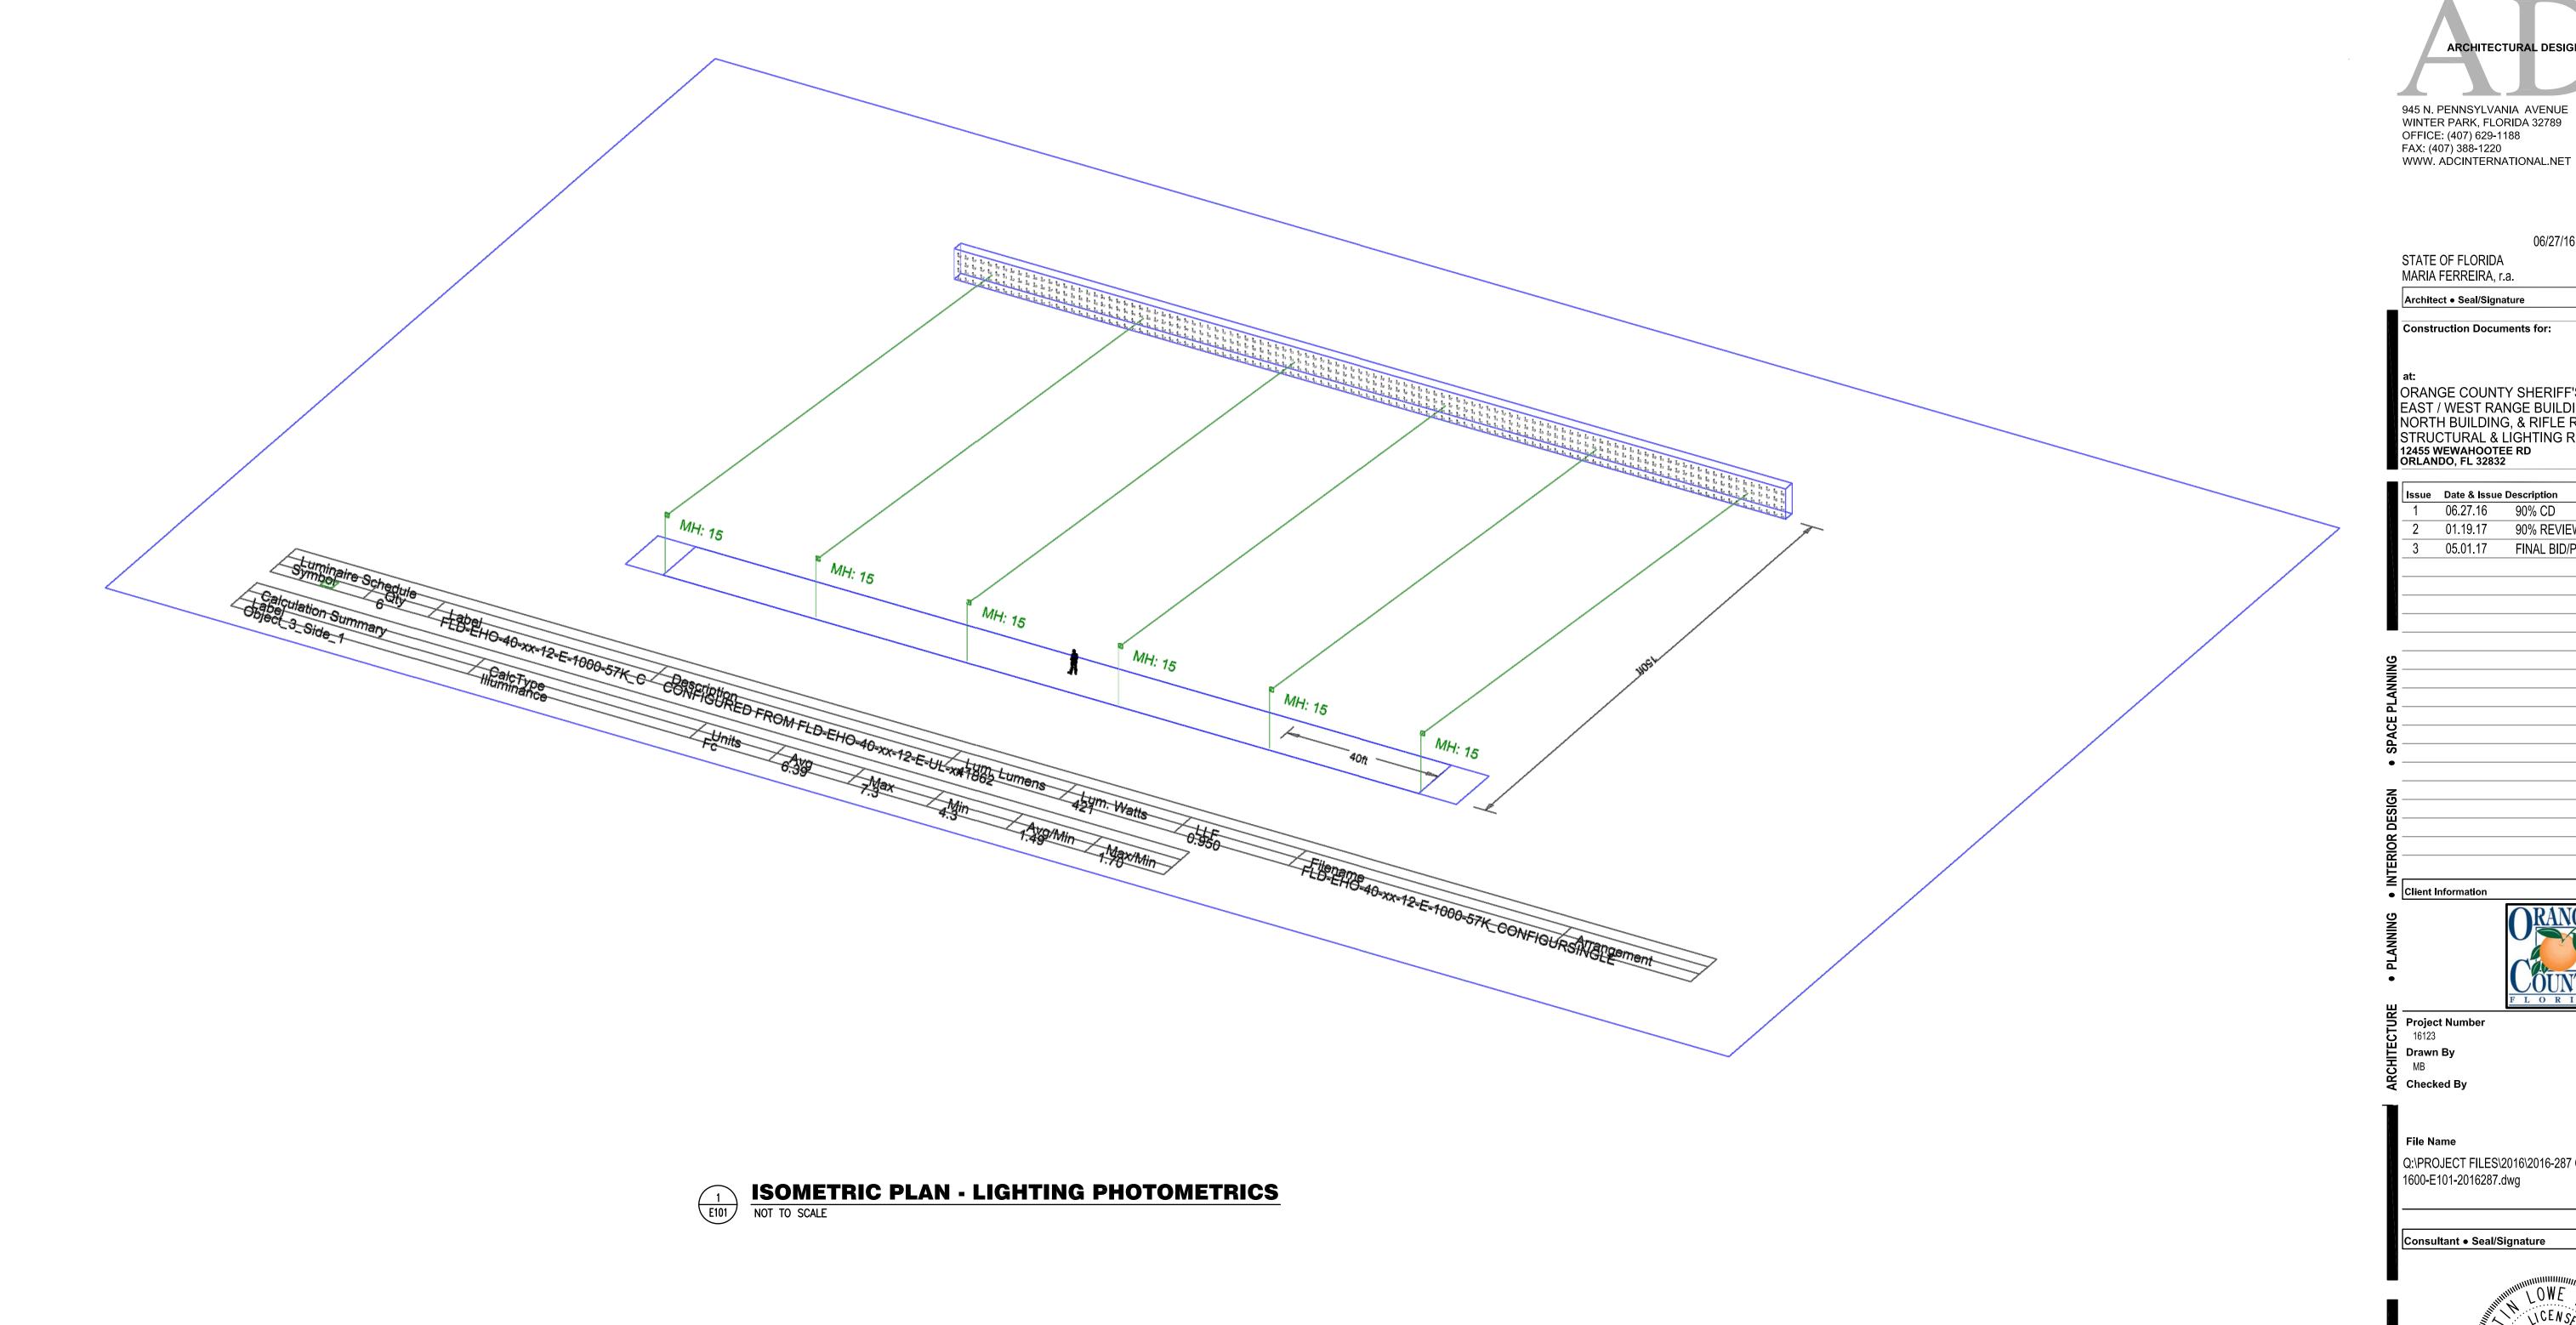
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06/27/16

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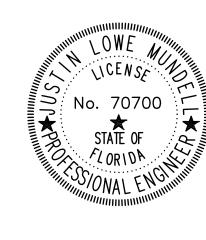
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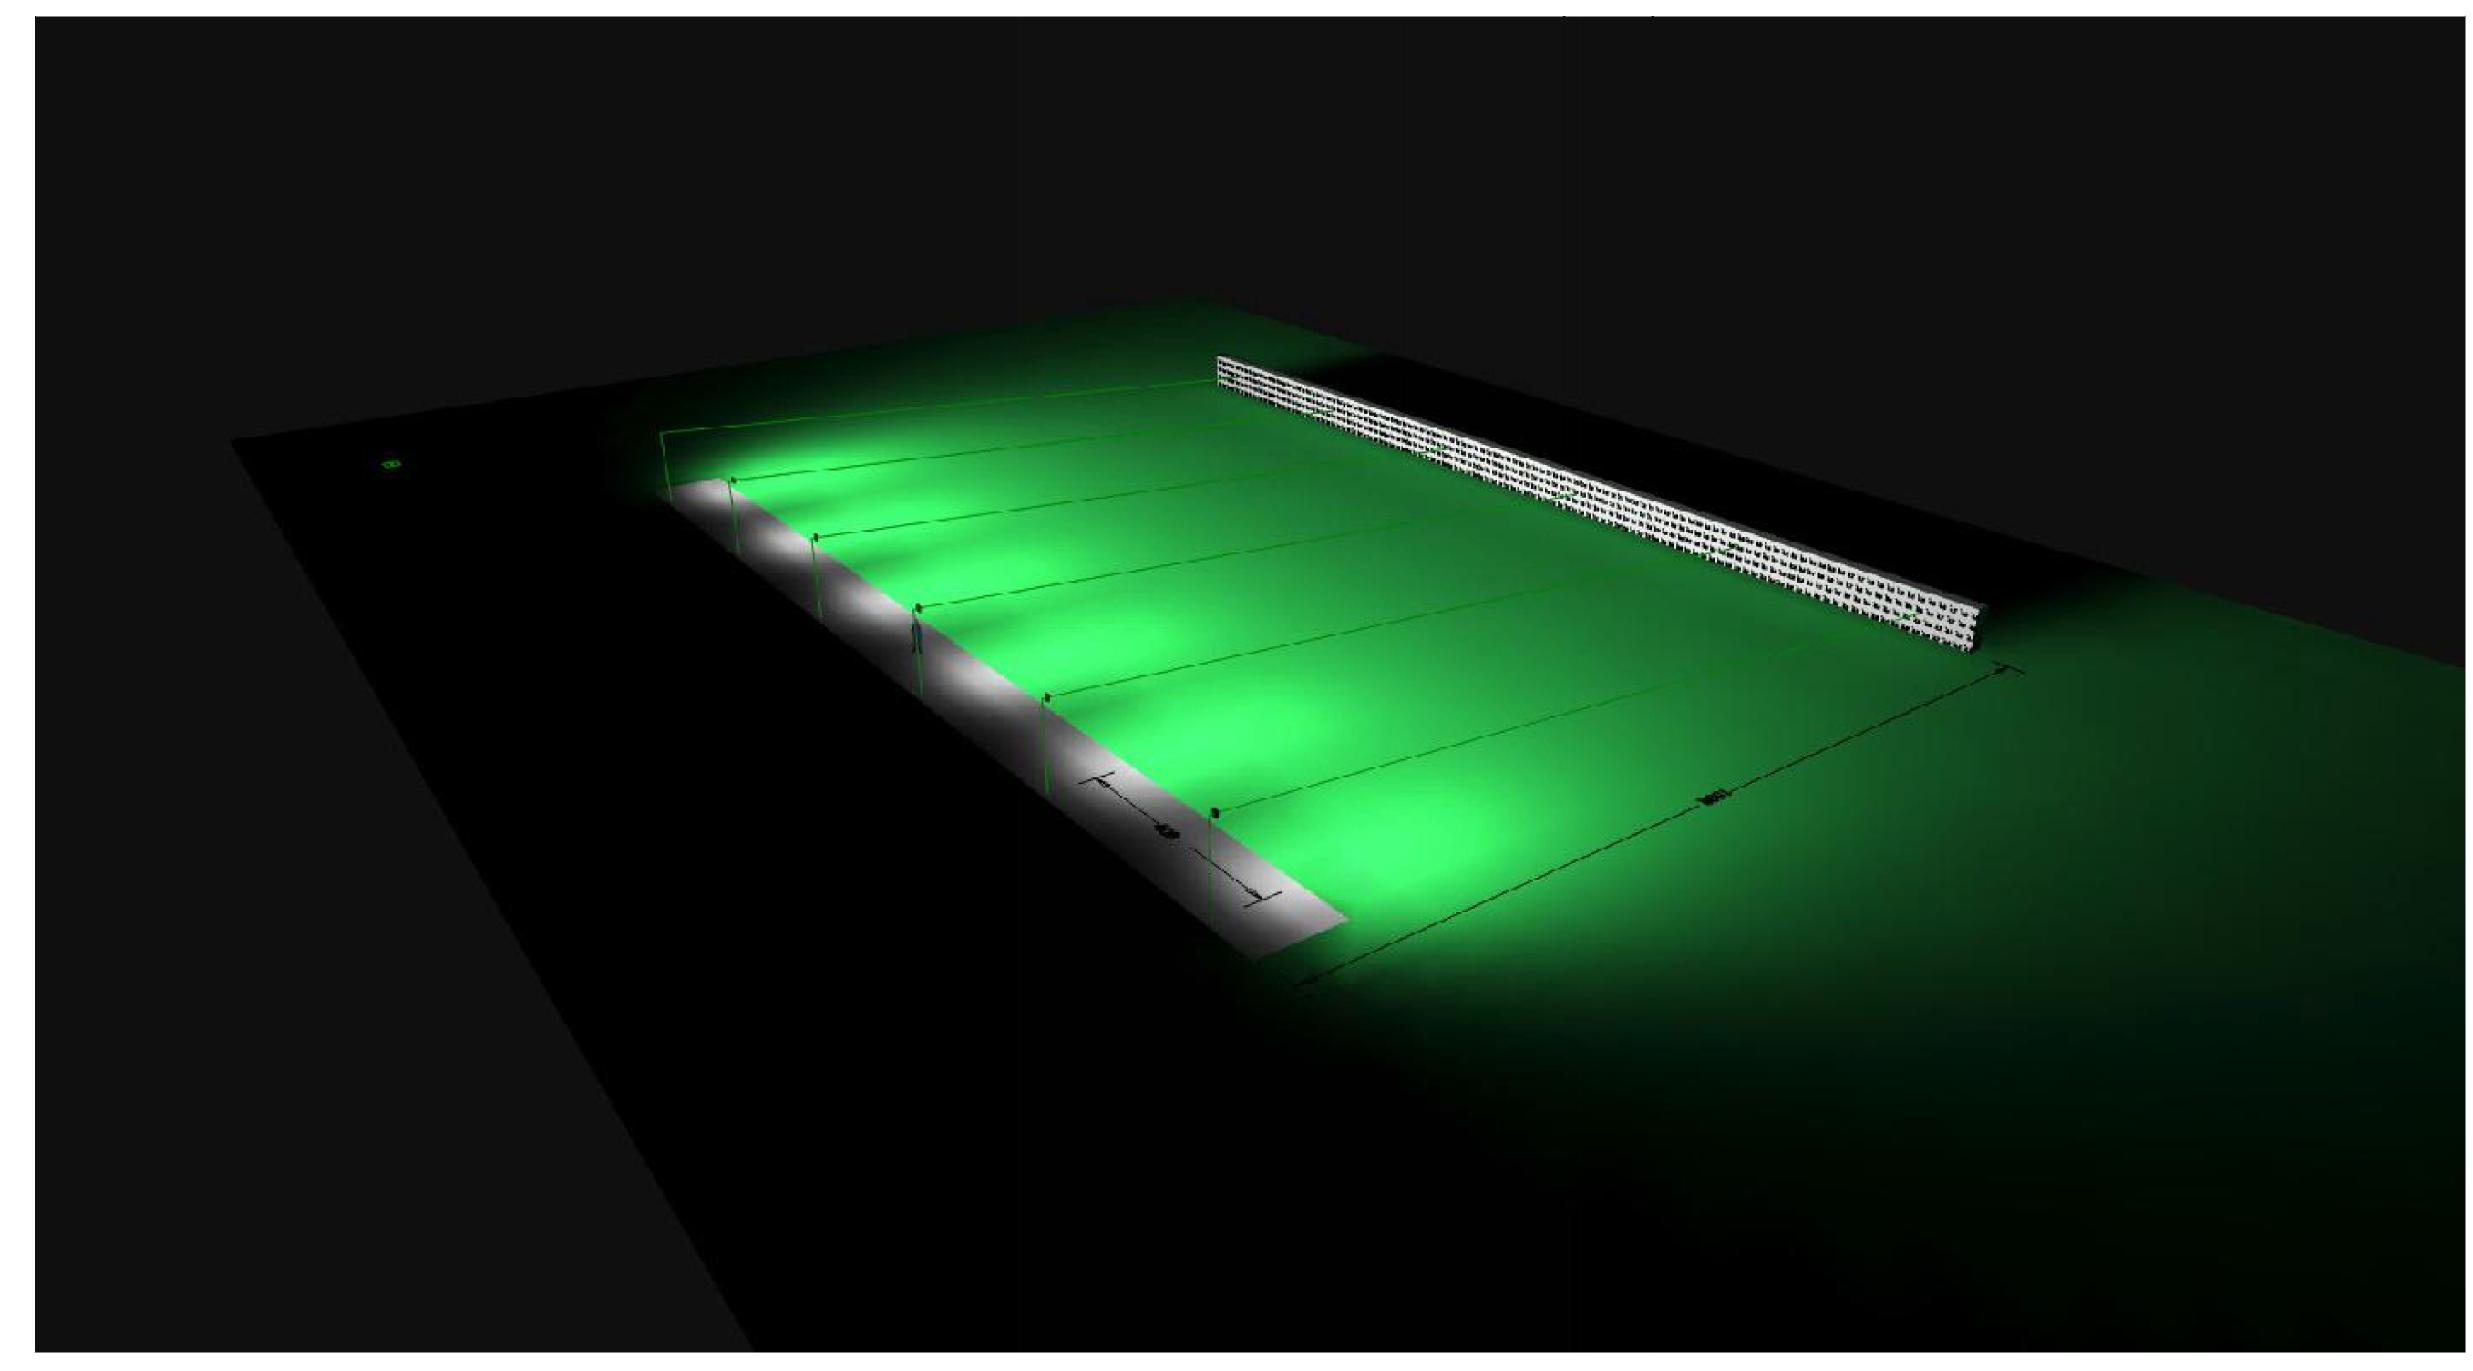


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ISOMETRIC PLAN - LTG PHOTOMETRICS

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E101

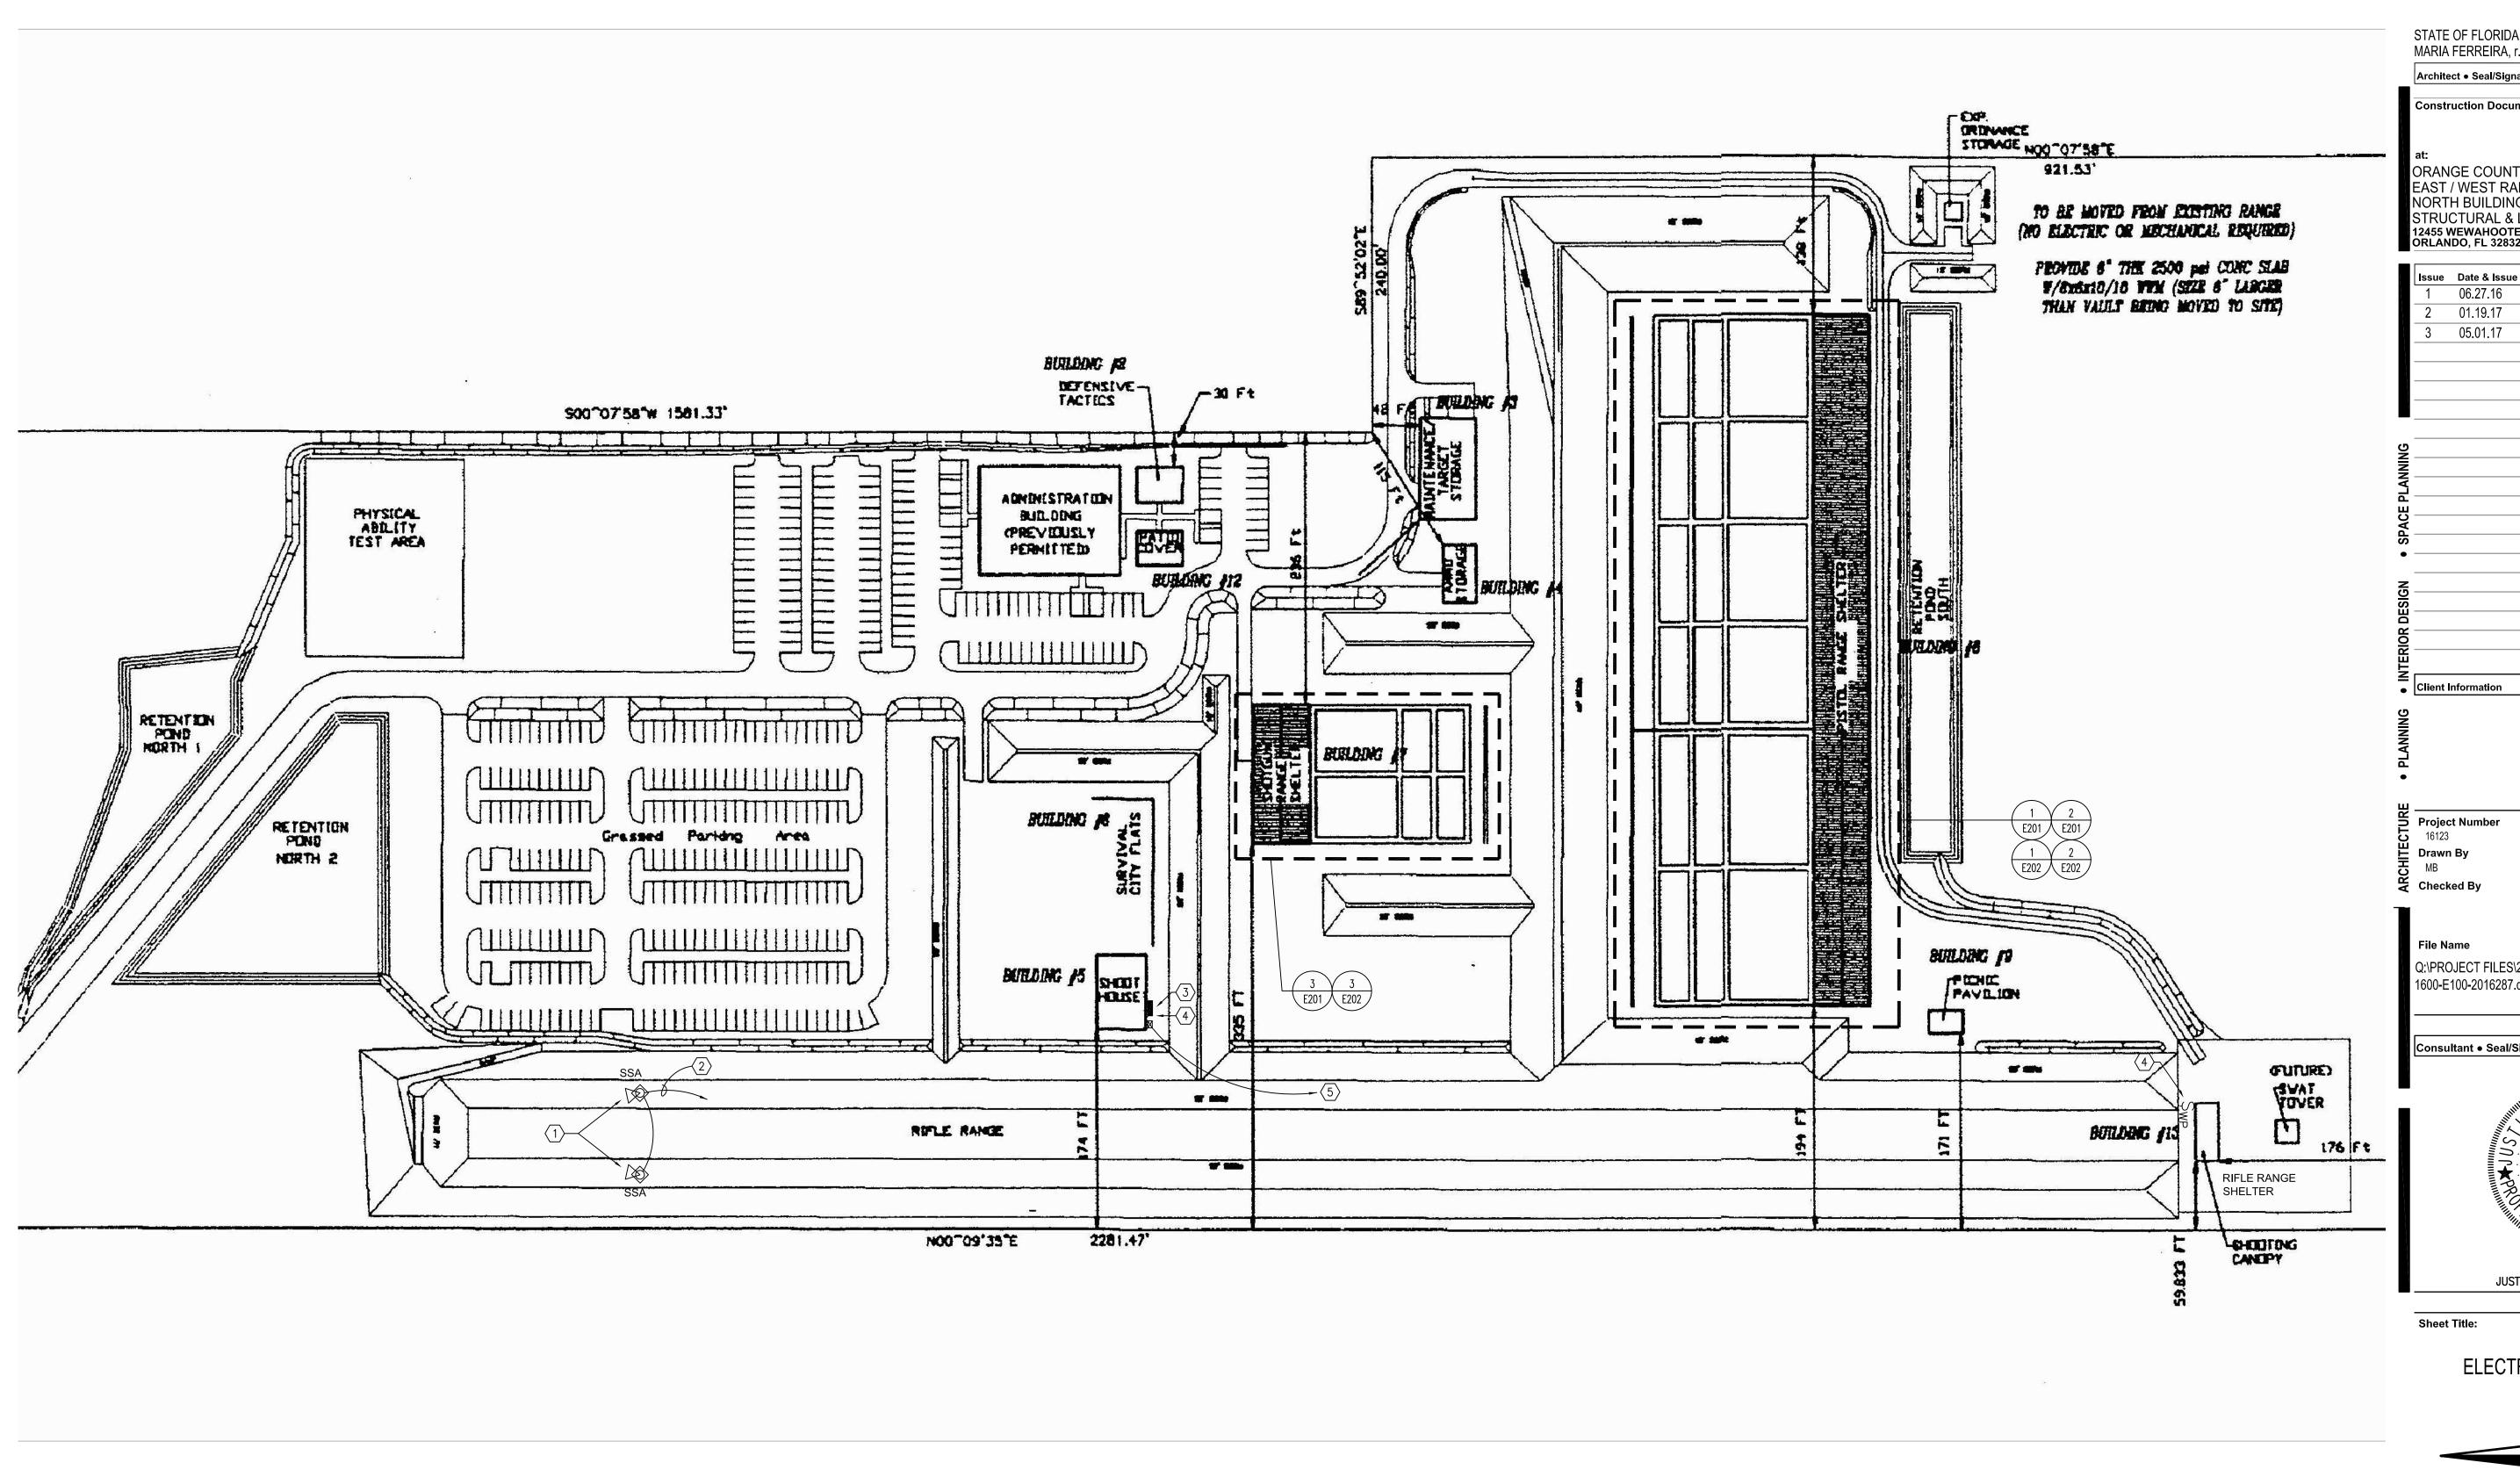

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STATE OF FLORIDA AA-C001315
MARIA FERREIRA, r.a. AR-0095752

Architect • Seal/Signature

Construction Documents for:

at:
ORANGE COUNTY SHERIFF'S GUN RANGE
EAST / WEST RANGE BUILDING
NORTH BUILDING, & RIFLE RANGE
STRUCTURAL & LIGHTING REPAIRS
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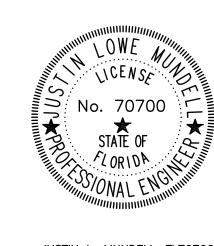
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PHOTOMETRIC RENDERING

E102

Sheet Title:

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PARTIAL ENLARGED DEMO PLAN - PISTOL RANGE

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OWNERSHIP OF INSTRUMENTS OF SERVICE:

SCALE: 1/16"=1'-0"

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SCALE: 1/16"=1'-0"

PARTIAL ENLARGED DEMO PLAN - PISTOL RANGE

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#### I. GENERAL

- A. STRUCTURAL DRAWINGS SHALL BE USED IN CONJUNCTION WITH THE ARCHITECTURAL, ELECTRICAL, SHOP DRAWINGS AND SPECIFICATIONS. THE CONTRACTOR SHALL COORDINATE ALL ELEVATIONS AND DIMENSIONS, INCLUDING BUT NOT LIMITED TO THOSE FOR OPENINGS IN WALLS AND IN ROOF AND FLOOR SYSTEMS, WITH THE OTHER DISCIPLINES. THE GENERAL CONTRACTOR SHALL COMPARE ALL CONTRACT DRAWINGS AND REPORT ANY DISCREPANCY BETWEEN DISCIPLINES AND WITHIN A GIVEN DISCIPLINE TO THE ARCHITECT AND ENGINEER BEFORE PROCEEDING WITH THE AFFECTED PART OF THE WORK.
- B. ALL DIMENSIONS, ELEVATIONS, AND ANY OTHER CONDITIONS OF ANY EXISTING STRUCTURES OR OTHER FEATURES SHALL BE VERIFIED BY THE GENERAL CONTRACTOR AND ANY DISCREPANCIES WITH THE CONTRACT DRAWINGS REPORTED TO THE ARCHITECT AND ENGINEER BEFORE PROCEEDING WITH THE AFFECTED PART OF THE WORK. DURING THE CONSTRUCTION PROCESS, IT SHALL BE SOLELY THE CONTRACTOR'S RESPONSIBILITY TO MAINTAIN THE INTEGRITY OF THE EXISTING STRUCTURE AND TO PROTECT FROM DAMAGE ANY PORTIONS THAT ARE TO REMAIN.
- C. IT IS THE GENERAL CONTRACTOR'S RESPONSIBILITY TO OBTAIN ALL CONTRACT DOCUMENTS AND LATEST ADDENDA AND TO SUBMIT TO ALL SUBCONTRACTORS AND SUPPLIERS PRIOR TO THE SUBMITTAL OF SHOP DRAWINGS.
- D. IF A CONFLICT EXISTS AMONG THE STRUCTURAL DRAWINGS, GENERAL NOTES, OR THE SPECIFICATIONS, THE STRICTEST REQUIREMENTS, AS INDICATED BY THE ENGINEER, SHALL GOVERN.
- E. THE STRUCTURE IS DESIGNED TO BE SELF SUPPORTING AND STABLE AFTER THE BUILDING IS COMPLETE. THE COMPLETED LATERAL—FORCE RESISTING SYSTEMS AND DIAPHRAGMS ARE REQUIRED FOR THE STRUCTURE TO RESIST LATERAL LOADS AND PROVIDE STABILITY UNDER GRAVITY LOADS. DURING THE CONSTRUCTION PROCESS, THE CONTRACTOR SHALL PROVIDE ALL REQUIRED BRACING DURING CONSTRUCTION TO MAINTAIN THE STABILITY AND SAFETY OF ALL STRUCTURAL ELEMENTS UNTIL THE LATERAL-LOAD RESISTING OR STABILITY-PROVIDING SYSTEM IS COMPLETELY INSTALLED AND THE STRUCTURE IS COMPLETELY TIED TOGETHER. THIS ALSO INCLUDES NECESSARY SHORING, SHEETING, GUYS OR TIE DOWNS.
- F. UNLESS OTHERWISE NOTED, DETAILS SHOWN ON ANY DRAWING ARE TO BE CONSIDERED TYPICAL FOR ALL SIMILAR CONDITIONS. DETAILS LABELED TYPICAL DETAILS ON THE DRAWINGS SHALL APPLY TO ALL SITUATIONS OCCURRING ON THE PROJECT THAT ARE SIMILAR OR SAME TO THOSE SPECIFICALLY DETAILED. THE APPLICABILITY OF THE DETAIL TO ITS LOCATION CAN BE DETERMINED BY THE TITLE OF DETAIL. SUCH DETAILS SHALL APPLY WHETHER OR NOT THEY ARE REFERENCED AT EACH LOCATION
- G. THE CONTRACTOR SHALL BE SOLELY RESPONSIBLE FOR ALL CONSTRUCTION MEANS AND METHODS AND FOR SAFETY PRECAUTIONS AND PROGRAMS. DURING THE CONSTRUCTION PROCESS, IT SHALL BE SOLELY THE CONTRACTOR'S RESPONSIBILITY TO MAINTAIN THE INTEGRITY OF THE EXISTING STRUCTURE AND TO PROTECT FROM DAMAGE ANY PORTIONS THAT ARE TO REMAIN.
- H. BASE CONSULTANTS, INC., SHALL NOT BE RESPONSIBLE FOR THE ACTS OR OMISSION OF THE CONTRACTOR OR FOR
- THEIR FAILURE TO CARRY OUT THE WORK IN ACCORDANCE WITH THE CONTRACT DOCUMENTS I. PERIODIC SITE OBSERVATION BY BASE CONSULTANTS, INC. IS SOLELY FOR THE PURPOSE OF DETERMINING IF THE WORK OF THE CONTRACTOR IS PROCEEDING IN ACCORDANCE WITH THE STRUCTURAL CONTRACT DOCUMENTS. THIS LIMITED SITE OBSERVATION SHALL NOT BE CONSTRUED AS EXHAUSTIVE OR CONTINUOUS TO CHECK THE QUALITY OR QUANTITY OF THE WORK.
- J. ALL STRUCTURES REQUIRE PERIODIC MAINTENANCE TO EXTEND LIFESPAN AND TO INSURE STRUCTURAL INTEGRITY FROM EXPOSURE TO THE ENVIRONMENT. A PLANNED PROGRAM OF MAINTENANCE SHALL BE ESTABLISHED BY THE BUILDING OWNER. THIS PROGRAM SHALL INCLUDE SUCH ITEMS SUCH AS BUT NOT LIMITED TO PAINTING OF STRUCTURAL STEEL, PROTECTIVE COATING FOR CONCRETE, SEALANTS, CAULKED JOINTS, EXPANSION JOINTS, CONTROL JOINTS, SPALLS AND CRACKS IN CONCRETE, AND PRESSURE WASHING OF EXPOSED STRUCTURAL ELEMENTS EXPOSED TO A SALT ENVIRONMENT OR OTHER HARSH CHEMICALS
- K. ANY MATERIALS OR PRODUCTS SUBMITTED FOR APPROVAL THAT ARE DIFFERENT FROM THE MATERIAL OR PRODUCTS SPECIFIED IN THE STRUCTURAL CONTRACT DOCUMENTS WILL BE APPROVED ONLY IF THE FOLLOWING CRITERIA ARE
- 1. A COST SAVINGS TO THE OWNER IS DOCUMENTED AND SUBMITTED WITH THE REQUEST.
- 2. THE MATERIAL OR PRODUCT HAS BEEN APPROVED BY THE INTERNATIONAL CONFERENCE OF BUILDING OFFICIALS (ICBO) AND THE ICBO REPORT IS SUBMITTED WITH THE REQUEST
- SUBMITTALS NOT SATISFYING THE ABOVE CRITERIA WILL NOT BE CONSIDERED.
- L. CONTRACTOR TO ISSUE REQUEST FOR INFORMATION (RFI) FOR ANY INFORMATION NOT CLEAR/NOT SHOWN IN THE
- M. DO NOT SCALE DRAWINGS
- N. NO STRUCTURAL MEMBER SHALL BE CUT, NOTCHED OR OTHERWISE ALTERED UNLESS APPROVED IN WRITING BY THE ENGINEER OF RECORD. THE CONTRACTOR SHALL BE RESPONSIBLE FOR ANY AND ALL COSTS INCURRED BY ENGINEER OF RECORD FOR THE REVIEW.

### II. DESIGN CRITERIA

- A. THE CONTRACT DOCUMENTS ARE BASED ON THE REQUIREMENTS OF THE
- 1. FLORIDA BUILDING CODE 2014 WITH 2016 SUPPLEMENT AND ALL APPLICABLE LOCAL CODES.
- B. WIND CRITERIA FOR STRENGTH DESIGN WITH A LOAD FACTOR OF 1.0: ULTIMATE WIND SPEED 139 MPH EXPOSURE

### III. DEMOLITION

RISK CATEGORY

- A. REMOVE STRUCTURE FROM TOP DOWN. DO NOT ALLOW DEBRIS TO PILE UP OR FALL ON SLABS WHICH ARE TO REMAIN IN PLACE. PROVIDE PLYWOOD AND/OR PLANKING TO CUSHION AND PROTECT SLABS FROM DAMAGE. REPAIR OR REPLACE DAMAGED SLABS, BEAMS, OR GIRDERS AS DIRECTED BY OWNER.
- B. THESE DRAWINGS ARE INTENDED TO DEFINE LIMITS OF REMOVAL OF STRUCTURAL ELEMENTS AND PRECAUTIONS TO BE TAKEN TO PREVENT DAMAGE TO STRUCTURE WHICH WILL REMAIN.
- C. CONTRACTOR TO VERIFY ALL EXISTING CONDITIONS AND SUBMIT A WRITTEN REPORT TO THE ENGINEER FOR REVIEW AND/OR INSTRUCTION OF ACTUAL FIELD CONDITIONS, WHICH MAY VARY FROM INFORMATION, INDICATED ON DRAWINGS.
- D. CONTRACTOR SHALL PROVIDE TEMPORARY SHORING AND BRACING OF STRUCTURE AS REQUIRED, AS WELL AS PROTECT EXISTING FACILITIES, STRUCTURES AND THE PUBLIC DURING DEMOLITION AND ERECTION OF THE NEW CONSTRUCTION.
- E. THE DETAILS AND ENGINEERING OF SHORING, BRACING AND OTHER CONSTRUCTION REQUIRED FOR SUCH WORK AND THE PHASING, STAGING, AND SEQUENCE OF SUCH OPERATION SHALL BE PREPARED IN THE FORM OF SHOP OR DETAIL DRAWINGS BY A PROFESSIONAL ENGINEER, RETAINED BY THE CONTRACTOR OR SUB-CONTRACTOR. THE DRAWINGS SHALL BE PROVIDED TO THE REGISTERED ARCHITECT OR PROFESSIONAL ENGINEER RESPONSIBLE FOR THE INSPECTION OF SUCH WORK, WHO SHALL REPORT TO THE OWNER ANY DEVIATIONS OBSERVED DURING HIS INSPECTION.
- F. THE CONTRACTOR IS REQUIRED TO COORDINATE WITH THE OWNER FOR THE TEMPORARY SUSPENSION OF USE OF ANY FACILITY OR PORTION THEREOF, AND THE ASSOCIATED BARRICADING REQUIREMENTS WITHIN A MINIMUM OF 7 DAYS PRIOR TO COMMENCING WORK.
- G. THE CONTRACTOR IS REQUIRED TO PERFORM HIS WORK IN A MANNER WHICH WILL NOT CONFLICT WITH ANY OPERATION WHICH IS TO REMAIN FUNCTIONAL DURING THE COURSE OF THE PROJECT. UNTIL SUCH OPERATION IS SCHEDULED TO SHUT DOWN.
- H. THE CONTRACTOR IS REQUIRED TO COORDINATE WITH OWNER FOR THE TEMPORARY SUSPENSION OF USE OF ANY UTILITY SYSTEM A MINIMUM OF 3 DAYS PRIOR TO COMMENCING WORK. I. AT ALL LOCATIONS WHERE NEW CONSTRUCTION WILL INTERFACE WITH EXISTING ELEMENTS, CUT THROUGH EXISTING
- STRUCTURE IN STRAIGHT AND TRUE LINES TO INSURE A NEAT INTERFACE. J. BEFORE DEMOLISHING ANY STRUCTURAL ELEMENT, INSTALL ALL REQUIRED TEMPORARY AND/OR PERMANENT BRACING
- AND SUPPORTS. K. UPON COMPLETION OF NEW CONSTRUCTION UNDER EACH PHASE, ALL DEMOLISHED AREAS SHALL BE RESTORED TO ACCEPTABLE USAGE ACCORDING TO THE CONTRACT DOCUMENTS AS DETERMINED BY THE ARCHITECT AND/OR ENGINEER.

L. REMOVE COMPLETELY FROM THE SITE AND LEGALLY DISPOSE ALL DEBRIS GENERATED BY THE DEMOLITION WORK AS THE WORK PROGRESSES. STOCKPILING OF DEBRIS AND BURNING OF DEBRIS ON THE PREMISES IS STRICTLY PROHIBITED.

#### IV. EXISTING STRUCTURE

- A. INFORMATION SHOWN ON THE DRAWINGS WAS TAKEN FROM THE DRAWINGS "ORANGE COUNTY SHERIFF'S OFFICE FIRING RANGE & TRAINING FACILITY". PREPARED BY MONTA CONSULTING & DESIGN, AND DATED 03/22/2000.
- B. WORK SHOWN ON THE DRAWINGS ASSUMES THAT THE ORIGINAL CONSTRUCTION WAS PERFORMED IN ACCORDANCE WITH THE ABOVE INDICATED ORIGINAL DRAWINGS (BUT NOT LIMITED TO) DIMENSIONS, ELEVATIONS, MEMBER SIZES MATERIALS, DETAILS ETC. IT SHALL BE THE RESPONSIBILITY OF THE CONTRACTOR TO VERIFY THE CONDITIONS RELATING TO THE EXISTING STRUCTURE AND NOTIFY THE ENGINEER IMMEDIATELY OF ANY DISCREPANCIES OR CONFLICTS.

- A. ALL WOOD FRAMING SHALL BE DESIGNED, DETAILED AND FABRICATED IN ACCORDANCE WITH THE PROCEDURES AND REQUIREMENTS OUTLINED IN THE LATEST EDITION OF THE NATIONAL DESIGN SPECIFICATIONS FOR WOOD
- B. UNLESS NOTED OTHERWISE, ALL LUMBER TO BE NO. 2 SOUTHERN YELLOW PINE PRESSURE TREATED WITH A MAXIMUM MOISTURE CONTENT OF 19%.
- C. ALL BOLTS USED FOR WOOD CONSTRUCTION SHALL BE A MINIMUM OF  $1\!\!\!/2$ " DIAMETER (ASTM A-307) WITH 7" MINIMUM EMBED (U.N.O. IN PLANS).
- D. PROVIDE FRAMING MEMBERS OF SIZES AND SPACING SHOWN, OR IF NOT SHOWN, COMPLY WITH THE RECOMMENDATIONS OF THE FLORIDA BUILDING CODE, LATEST EDITION.
- E. PROVIDE ANCHORAGE AND NAILING FOR MEMBERS AND SHEATHING AS SHOWN IN THE DWG'S AND TO COMPLY WITH THE FLORIDA BUILDING CODE. LATEST EDITION.
- F. DO NOT SPLICE STRUCTURAL MEMBERS BETWEEN SUPPORTS, U.N.O.
- G. WHERE PRESSURE TREATED (P.T.) WOOD IS SPECIFIED PROVIDE STAINLESS STEEL CONNECTORS AND FASTENERS (SIMPSON STRONGTIE SST300 OR BETTER.), U.N.O.

#### VI. STRUCTURAL STEEL

- A. STRUCTURAL STEEL SHALL BE AS FOLLOWS, U.N.O.: 1. ANGLES AND PLATES: ASTM A36, Fy = 36 KSI
- 2. CONNECTION MATERIALS:
- a. ALL OTHER CONNECTION MATERIAL, U.N.O.: ASTM A36 UNLESS A HIGHER GRADE OF STEEL IS REQUIRED BY STRENGTH AND PROVIDED THE RESULTING SIZES ARE COMPATIBLE WITH THE CONNECTED MEMBERS
- 3. STRUCTURAL STEEL SHALL MEET THE LATEST AISC "SPECIFICATION FOR THE DESIGN, FABRICATION AND ERECTION OF STRUCTURAL STEEL FOR BUILDINGS"
- 4. ALL STEEL THAT IS PERMANENTLY EXPOSED TO THE EXTERIOR SHALL BE HOT DIPPED GALVANIZED.
- 5. G.C. TO VERIFY ALL EXISTING ELEVATIONS AND DIMENSIONS. ALL VARIANCES ARE TO BE REPORTED TO ENGINEER PRIOR TO FABRICATION.

#### VII. SPECIALITY ENGINEERING REQUIREMENTS:

VII. THE FLORIDA BOARD OF PROFESSIONAL ENGINEERS HAS ISSUED STATEMENTS ON RESPONSIBILITIES OF PROFESSIONAL ENGINEERS, IN ACCORDANCE WITH RULE 21H-19.00(3). CERTAIN COMPONENTS OF THE STRUCTURE REQUIRE THE WORK OF A SPECIALTY ENGINEER FOR THE DESIGN OF THOSE COMPONENTS.

#### VIII. SUBMITTALS

**DRAWINGS** 

- A. THE GENERAL CONTRACTORS SHALL REVIEW AND STAMP ALL SHOP DRAWINGS BEFORE SUBMITTING FOR REVIEW. SHOP DRAWINGS SHALL BE SUBMITTED TO THE ARCHITECT AND/OR ENGINEER AND HAVE THE ENGINEER'S SHOP DRAWING STAMP AFFIXED PRIOR TO FABRICATION. FABRICATION AND ERECTION SHALL BE FROM REVIEWED SHOP
- B. A RECORD SET OF APPROVED SHOP DRAWINGS SHALL BE KEPT IN THE FIELD BY THE GENERAL CONTRACTOR
- C. ANY DEVIATION FROM, ADDITION TO, SUBSTITUTION FOR, OR MODIFICATION TO THE STRUCTURE OR ANY PART OF THE STRUCTURE DETAILED ON THE CONTRACT DOCUMENTS SHALL BE SUBMITTED IN WRITING TO THE ENGINEER FOR REVIEW. SHOP DRAWINGS SUBMITTED FOR REVIEW DO NOT CONSTITUTE "IN-WRITING" UNLESS IT IS CLEARLY NOTED THAT SPECIFIC CHANGES ARE BEING SUGGESTED
- D. THE CONTRACTOR SHALL PREPARE A LIST AND SCHEDULE OF ALL STRUCTURAL SUBMITTALS PRIOR TO CONSTRUCTION.
- E. THE FOLLOWING SHOP DRAWINGS SHALL BE SUBMITTED BY THE CONTRACTOR FOR THE ENGINEER'S REVIEW: 1. SHORING (1, 3)
- 2. METAL HURRICANE HOLD-DOWN STRAPS AND FRAMING ANGLE CONNECTORS (2)
- 3. ALL STEEL ITEMS
- F. ITEMS MARKED (1) SHALL HAVE SHOP DRAWINGS SIGNED AND SEALED BY A REGISTERED ENGINEER IN THE STATE WHERE THE PROJECT IS LOCATED. ITEMS MARKED (2) SHALL BE SUBMITTED TO ENGINEER FOR OWNER'S RECORD ONLY AND WILL NOT HAVE THE ENGINEER'S SHOP DRAWING STAMP AFFIXED. ITEMS MARKED (3) SHALL HAVE DESIGN CALCULATIONS SIGNED AND SEALED BY A REGISTERED ENGINEER IN THE STATE WHERE THE PROJECT IS LOCATED. 1. THE OMISSION FROM THE SHOP DRAWINGS OF ANY MATERIALS REQUIRED BY THE CONTRACT DOCUMENTS TO BE FURNISHED SHALL NOT RELIEVE THE CONTRACTOR OF THE RESPONSIBILITY OF FURNISHING AND INSTALLING SUCH MATERIALS, REGARDLESS OF WHETHER THE SHOP DRAWINGS HAVE BEEN REVIEWED AND APPROVED.
- G. THE USE OF ELECTRONIC FILES OR REPRODUCTIONS OF THESE CONTRACT DOCUMENTS BY ANY CONTRACTOR, SUBCONTRACTOR, ERECTOR, FABRICATOR, OR MATERIAL SUPPLIER IN LIEU OF PREPARATION OF SHOP DRAWINGS SIGNIFIES THEIR ACCEPTANCE OF ALL INFORMATION SHOWN HEREON AS CORRECT, AND OBLIGATES THEMSELVES TO ANY JOB EXPENSE, REAL OR IMPLIED, ARISING DUE TO ANY ERRORS THAT MAY OCCUR HEREON.
- H. REQUEST FOR INFORMATION SHALL BE ORIGINATE WITH CONTRACTOR AND SHALL BE SUBMITTED TO THE ENGINEER VIA ARCHITECT OR DIRECTLY TO ENGINEER WHEN APPROVED BY ARCHITECT. RFI SHALL BE SUBMITTED IN A PROMPT MANNER TO AVOID DELAYS IN THE CONTRACTORS WORK.
- I. RFI RESPONSES ARE NOT INTENDED TO AUTHORIZE ANY INCREASE IN CONSTRUCTION COST, SCHEDULE OR CONFLICT WITH APPLICABLE STANDARDS OR CODES. IT IS TECH RESPONSIBILITY OF THE CONTRACTOR TO NOTIFY DESIGN TEAM IMMEDIATELY MANY PERCEIVED COST, SCHEDULE OR SCOPE IMPACTS.



rchitect • Seal/Signature

Construction Documents for:

ORANGE COUNTY SHERIFF'S GUN RANGE EAST / WEST RANGE BUILDING STRUCTURAL REPAIRS 12455 WEWAHOOTEE RD ORLANDO, FL 32832

Issue Date & Issue Description Drawn By Checked By 1 03.24.17 BID/PERMIT DOCS

Engineering + Construction | CGC 1521662

CERTIFICATE OF AUTHORIZATION No. 27343 LAURA BARBERO-BUFFA, P.E. No. 74027 1214 EAST CONCORD STREET

ORLANDO, FLORIDA 32803 P: 407.377.7227 Client Information

**Project Number** Drawn By Checked By


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**Issue Date** 

**Project Status BID/PERMIT DOCS** 

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Sheet Title:

STRUCTURAL **GENERAL NOTES** 

**S001** 
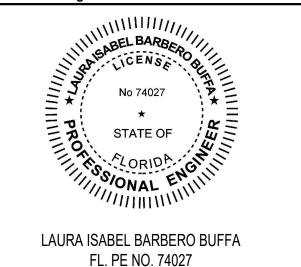
#### REPAIR PLAN NOTES:

S401

+ EXISTING (2) 2x|12

12'-0"

LUMBER BEÁM, TYP.

12'-0"

12'-0"

12'-0"

12'-0"

- 1. SMALL HOLES IN METAL ROOF DECK (LESS THAN ONE INCH IN DIAMETER) SHALL BE REPAIRED USING AN ACRYLIC-BASED ROOF MASTIC. CONTRACTOR TO PROVIDE ALLOWANCE FOR 2 S.F. OF ROOF-DECK HOLE REPAIRS.
- 2. CRACKED/DAMAGED METAL TRUSS CONNECTOR PLATES SHALL BE REPLACED W/NEW METAL CONNECTOR PLATES SIZED TO MATCH EXISTING. NEW METAL CONNECTOR PLATES SHALL CONFORM TO ASTM A653 FOR HOT-DIPPED GALVANIZED OR GALVANNEALED SHEET STEEL.
- 3. SEE GENERAL NOTES AND SPECIFICATIONS FOR ADDITIONAL INFORMATION. 4. GC TO COORDINATE NEW LIGHT LOCATIONS WITH ELECTRICAL DRAWINGS. SEE 1/S402 FOR LIGHT MOUNTING BRACKET REINFORCEMENT.



Architect • Seal/Signature

**Construction Documents for:** 



Project Status BID/PERMIT DOCS Scale AS SHOWN LAURA ISABEL BARBERO BUFFA FL. PE NO. 74027

**Issue Date** 03/24/17

Sheet Title:

PISTOL RANGE REPAIR PLAN

**S101** 

1 PISTOL RANGE REPAIR PLAN SCALE: 1/8" = 1'-0"

12'-0"

9 \$401

1'-0"

12'-0"

12'-0"

12'-0"

12'-0"

ROOF LINE

EXISTING | 6x6

TIMBER POST, TYP.

— PROVIDE NEW CONT. 2x/6 FASCIA BOARD

ALONG EDGE (TYP); SEE DET. 11/S401

REPAIR PLAN NOTES: 1. SMALL HOLES IN METAL ROOF DECK (LESS THAN ONE INCH IN DIAMETER) ARCHITECTURAL DESIGN COLLABORATIVE SHALL BE REPAIRED USING AN ACRYLIC-BASED ROOF MASTIC. CONTRACTOR TO PROVIDE ALLOWANCE FOR 2 S.F. OF ROOF-DECK HOLE REPAIRS. 2. CRACKED/DAMAGED METAL TRUSS CONNECTOR PLATES SHALL BE REPLACED W/NEW METAL CONNECTOR PLATES SIZED TO MATCH EXISTING. NEW METAL 945 N. PENNSYLVANIA AVENUE WINTER PARK, FLORIDA 32789 CONNECTOR PLATES SHALL CONFORM TO ASTM A653 FOR HOT-DIPPED OFFICE: (407) 629-1188 GALVANIZED OR GALVANNEALED SHEET STEEL. FAX: (407) 388-1220 3. SEE GENERAL NOTES AND SPECIFICATIONS FOR ADDITIONAL INFORMATION. WWW. ADCINTERNATIONAL.NET 4. GC TO COORDINATE NEW LIGHT LOCATIONS WITH ELECTRICAL DRAWINGS. SEE 1/S402 FOR LIGHT MOUNTING BRACKET REINFORCEMENT. Architect • Seal/Signature Construction Documents for: ORANGE COUNTY SHERIFF'S GUN RANGE EAST / WEST RANGE BUILDING STRUCTURAL REPAIRS 12455 WEWAHOOTEE RD ORLANDO, FL 32832 Issue Date & Issue Description Drawn By Checked By 1 03.24.17 BID/PERMIT DOCS (25)(30)(34)(35) S401 — EXISTING | 6x6  $\longrightarrow$  EXISTING (2) 2x12 1/5 S401 Engineering + Construction | CGC 1521662 TIMBER POST, TYP. LUMBER BEAM, TYP. CERTIFICATE OF AUTHORIZATION No. 27343 LAURA BARBERO-BUFFA, P.E. No. 74027 1214 EAST CONCORD STREET ORLANDO, FLORIDA 32803 - P|RO|VIDE NEW|CO|NT.| 2x|6 FAS|CIA|BO|ARD| P: 407.377.7227 Client Information Project Number Issue Date 16123 Drawn By
MR Project Status BID/PERMIT DOCS Checked By Scale AS SHOWN File Name Consultant • Seal/Signature 12'-0" 12'-0" 12'-0" 12'-0" 12'-0" 12'-0" 12'-0" 12'-0" 12'-0" 602'-0" LAURA ISABEL BARBERO BUFFA FL. PE NO. 74027 Sheet Title: PISTOL RANGE REPAIR PLAN 1 PISTOL RANGE REPAIR PLAN SCALE: 1/8" = 1'-0"**S102** 

OWNERSHIP OF INSTRUMENTS OF SERVICE:

#### REPAIR PLAN NOTES:


- 1. SMALL HOLES IN METAL ROOF DECK (LESS THAN ONE INCH IN DIAMETER) SHALL BE REPAIRED USING AN ACRYLIC-BASED ROOF MASTIC. CONTRACTOR TO PROVIDE ALLOWANCE FOR 2 S.F. OF ROOF-DECK HOLE REPAIRS.
- 2. CRACKED/DAMAGED METAL TRUSS CONNECTOR PLATES SHALL BE REPLACED W/NEW METAL CONNECTOR PLATES SIZED TO MATCH EXISTING. NEW METAL CONNECTOR PLATES SHALL CONFORM TO ASTM A653 FOR HOT-DIPPED GALVANIZED OR GALVANNEALED SHEET STEEL
- 3. SEE GENERAL NOTES AND SPECIFICATIONS FOR ADDITIONAL INFORMATION. 4. GC TO COORDINATE NEW LIGHT LOCATIONS WITH ELECTRICAL DRAWINGS. SEE
- 1/S402 FOR LIGHT MOUNTING BRACKET REINFORCEMENT.






PISTOL RANGE REPAIR PLAN

**S103** 

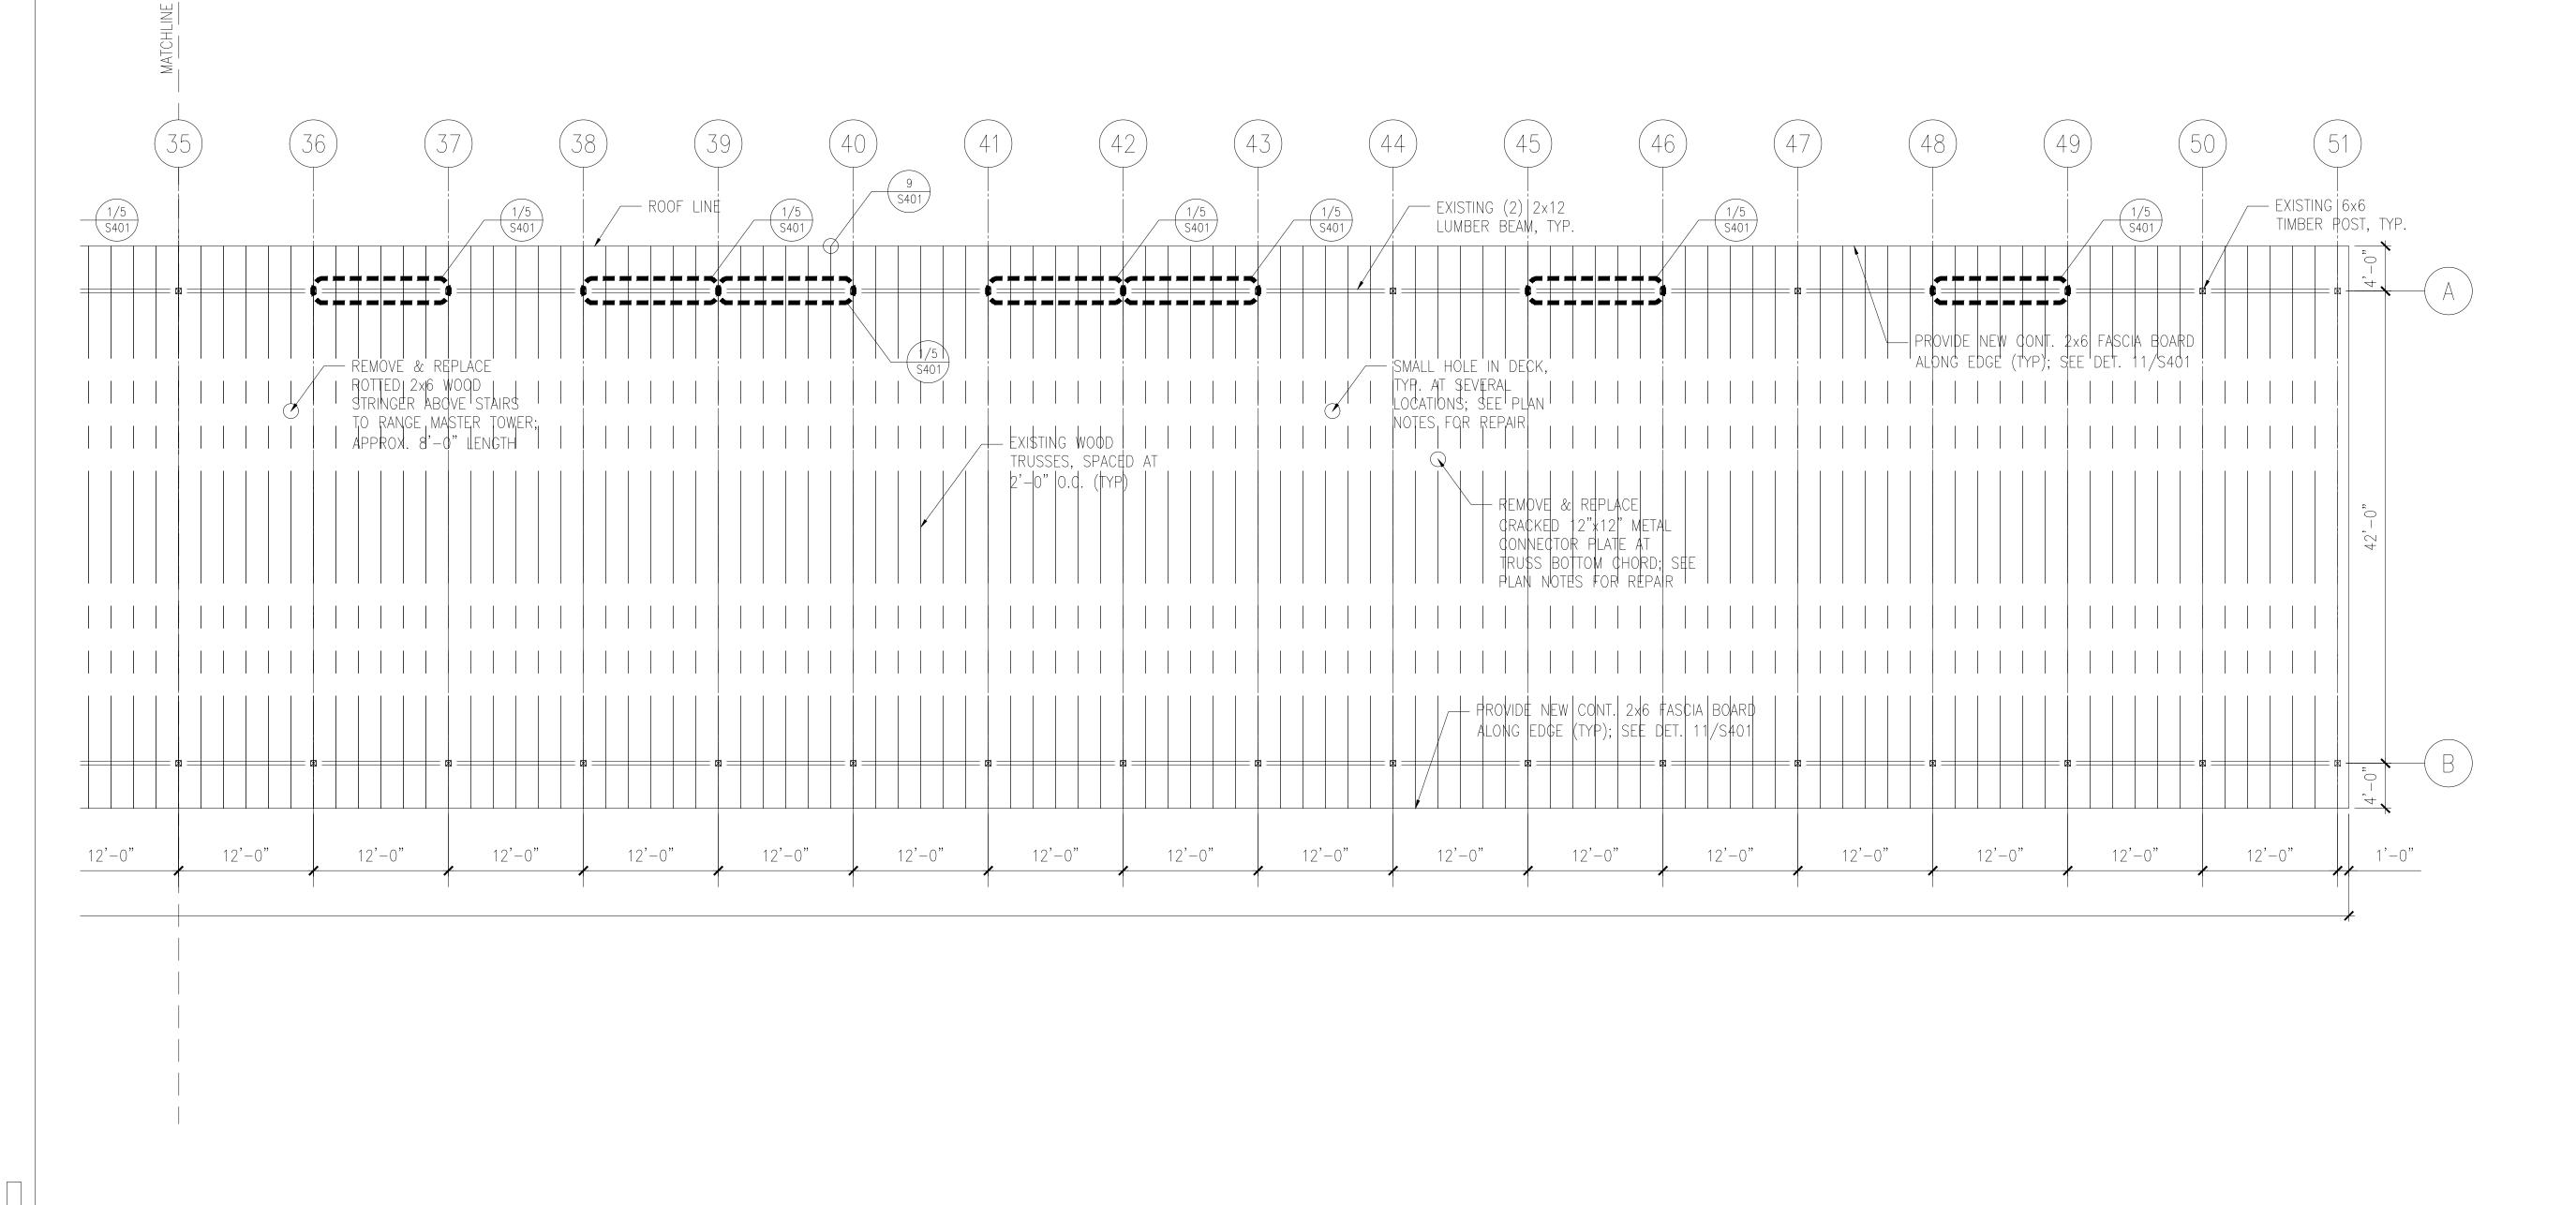


1 PISTOL RANGE REPAIR PLAN

SCALE: 1/8" = 1'-0"

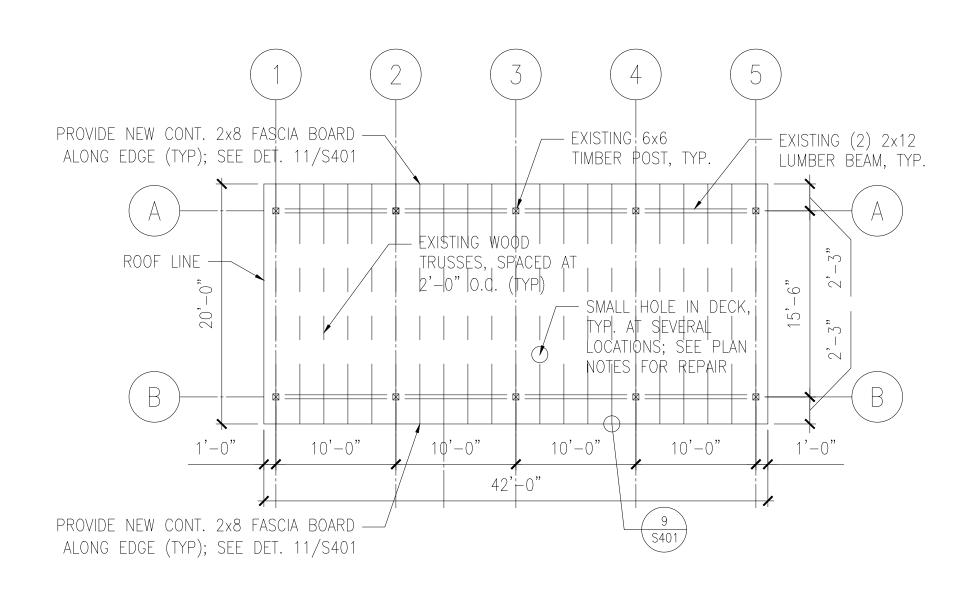



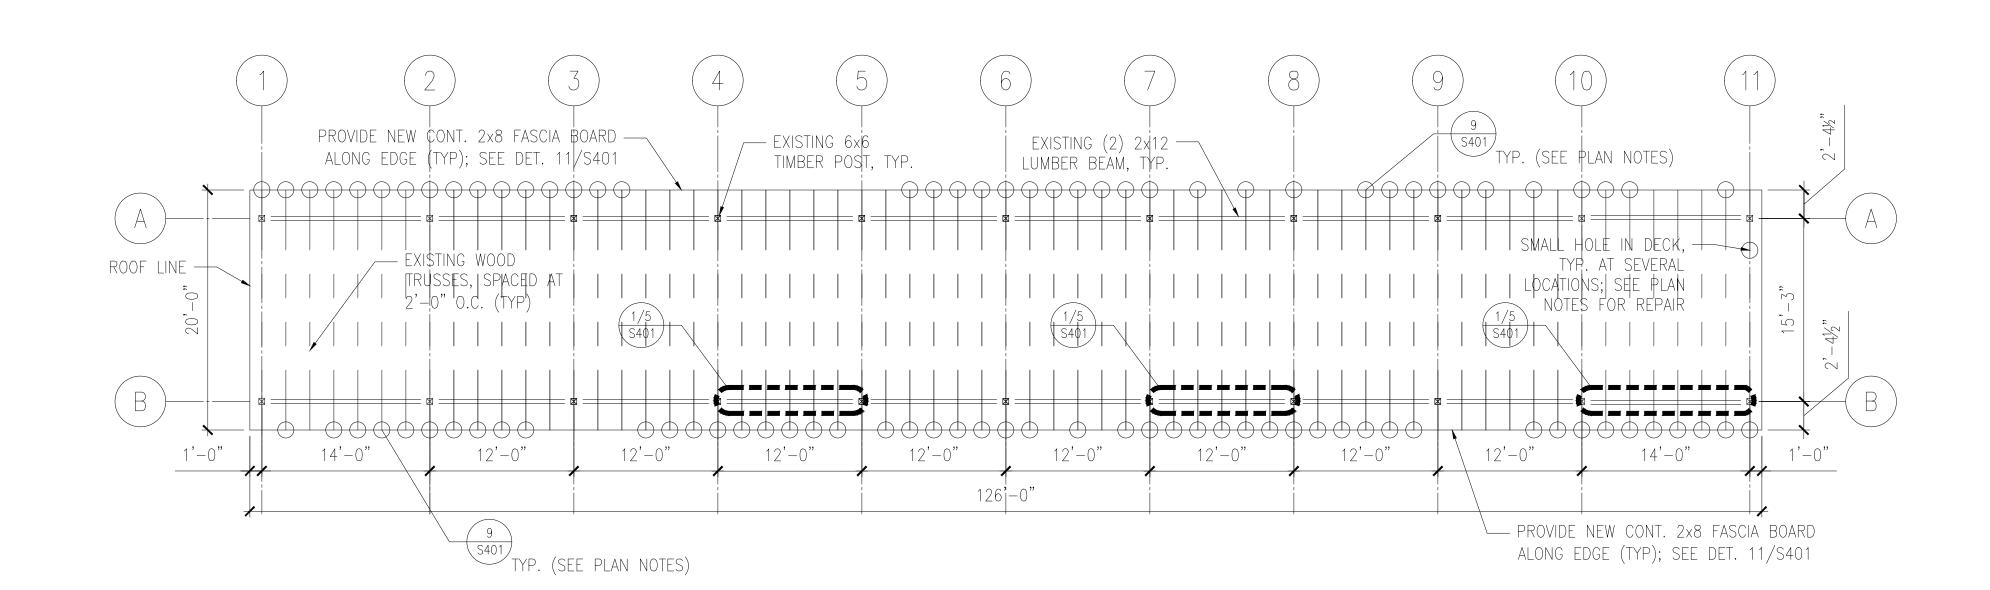


### NORTH PPC BUILDING REPAIR PLAN SCALE: 1/8" = 1'-0"

#### REPAIR PLAN NOTES:

- 1. SMALL HOLES IN METAL ROOF DECK (LESS THAN ONE INCH IN DIAMETER) SHALL BE REPAIRED USING AN ACRYLIC-BASED ROOF MASTIC. CONTRACTOR TO PROVIDE ALLOWANCE FOR 2 S.F. OF ROOF-DECK HOLE REPAIRS.
- 2. ALL ITEMS MARKED WITH O AT THE ROOF EDGE REQUIRE A TRUSS TAIL REPAIR; SEE DET. 9/S401.
- 3. SEE GENERAL NOTES AND SPECIFICATIONS FOR ADDITIONAL INFORMATION. 4. GC TO COORDINATE NEW LIGHT LOCATIONS WITH ELECTRICAL DRAWINGS. SEE
- 2/S402 FOR LIGHT MOUNTING BRACKET REINFORCEMENT.

ARCHITECTURAL DESIGN COLLABORATIVE 945 N. PENNSYLVANIA AVENUE WINTER PARK, FLORIDA 32789 OFFICE: (407) 629-1188 FAX: (407) 388-1220 WWW. ADCINTERNATIONAL.NET

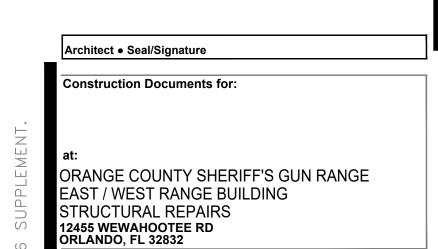

Issue Date & Issue Description Drawn By Checked By 1 03.24.17 BID/PERMIT DOCS



CERTIFICATE OF AUTHORIZATION No. 27343 LAURA BARBERO-BUFFA, P.E. No. 74027 1214 EAST CONCORD STREET ORLANDO, FLORIDA 32803 P: 407.377.7227

• Client Information

5 Project Number 16123 Drawn By Checked By

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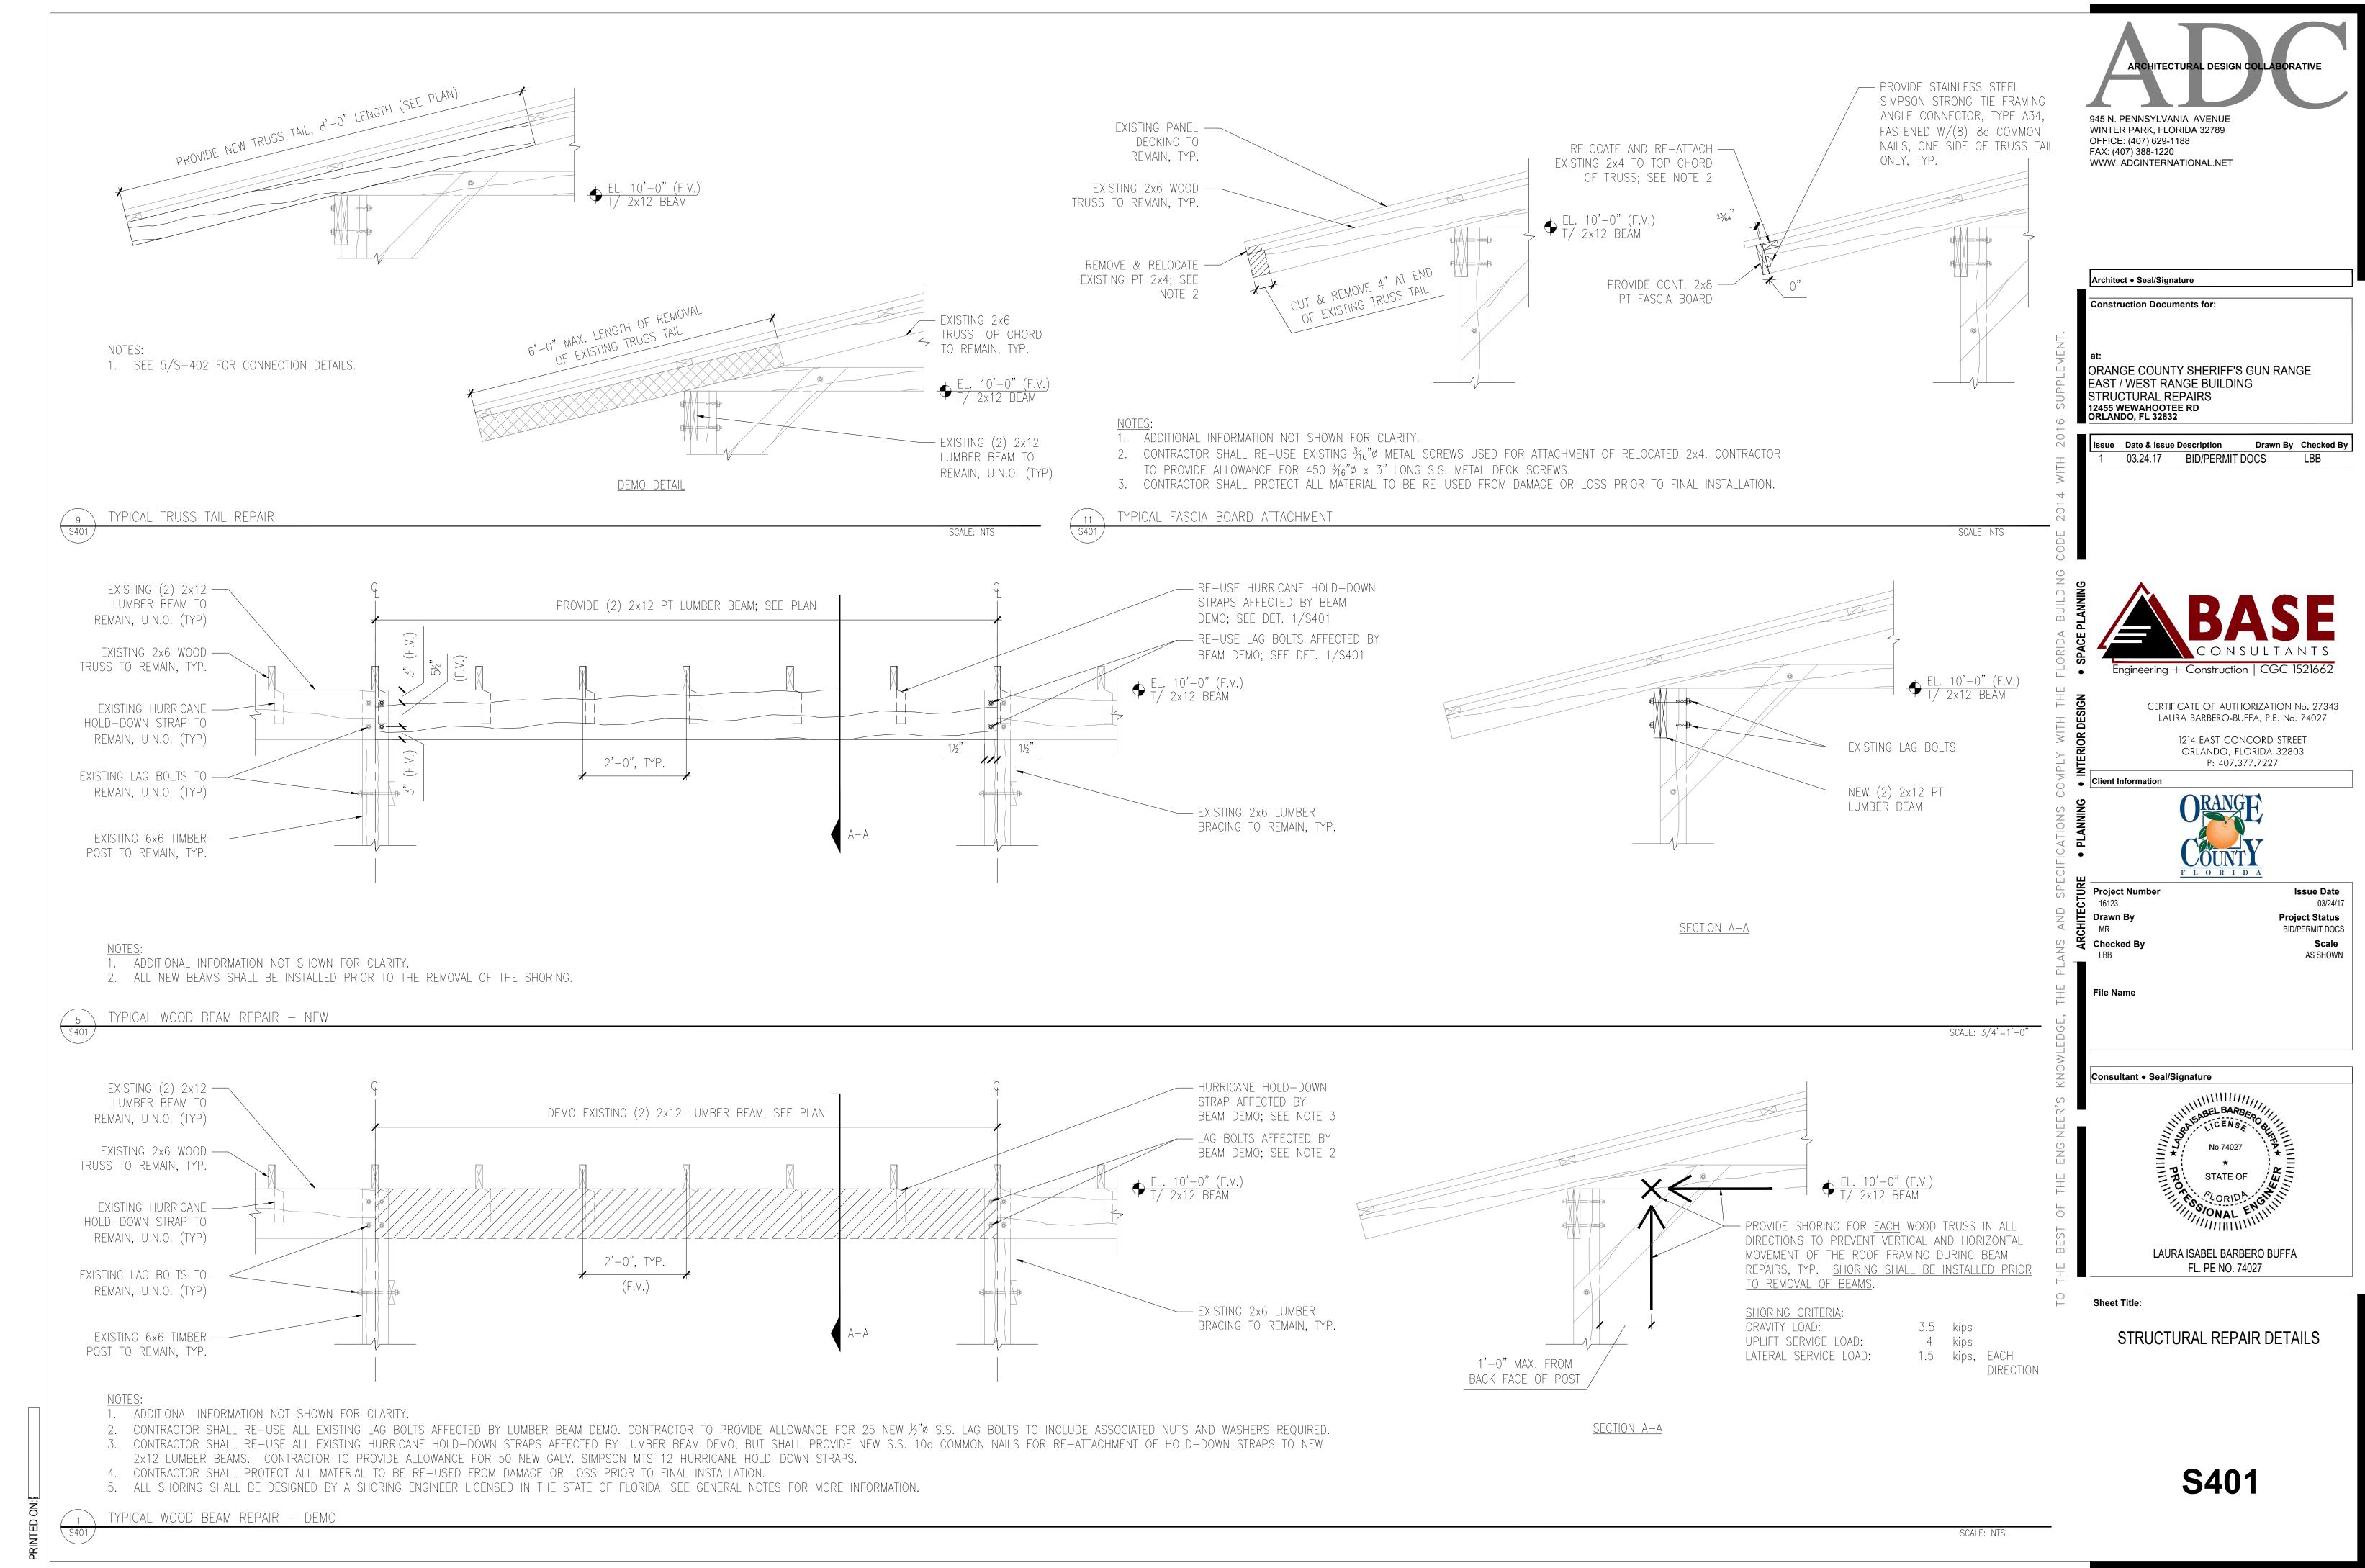
Issue Date Project Status BID/PERMIT DOCS Scale AS SHOWN

Consultant • Seal/Signature LAURA ISABEL BARBERO BUFFA FL. PE NO. 74027


Sheet Title:

NORTH PPC BLDG / RIFLE RANGE REPAIR PLAN

**S104** 



OWNERSHIP OF INSTRUMENTS OF SERVICE:
ALL REPORTS, PLANS, SPECIFICATIONS, FIELD DATA AND NOTES AND OTHER DOCUMENTS, INCLUDING ALL DOCUMENTS ON ELECTRONIC MEDIA, PREPARED BY THE DESIGN PROFESSIONAL AS INSTRUMENTS OF SERVICE SHALL REMAIN THE PROPERTY OF THE DESIGN PROFESSIONAL.

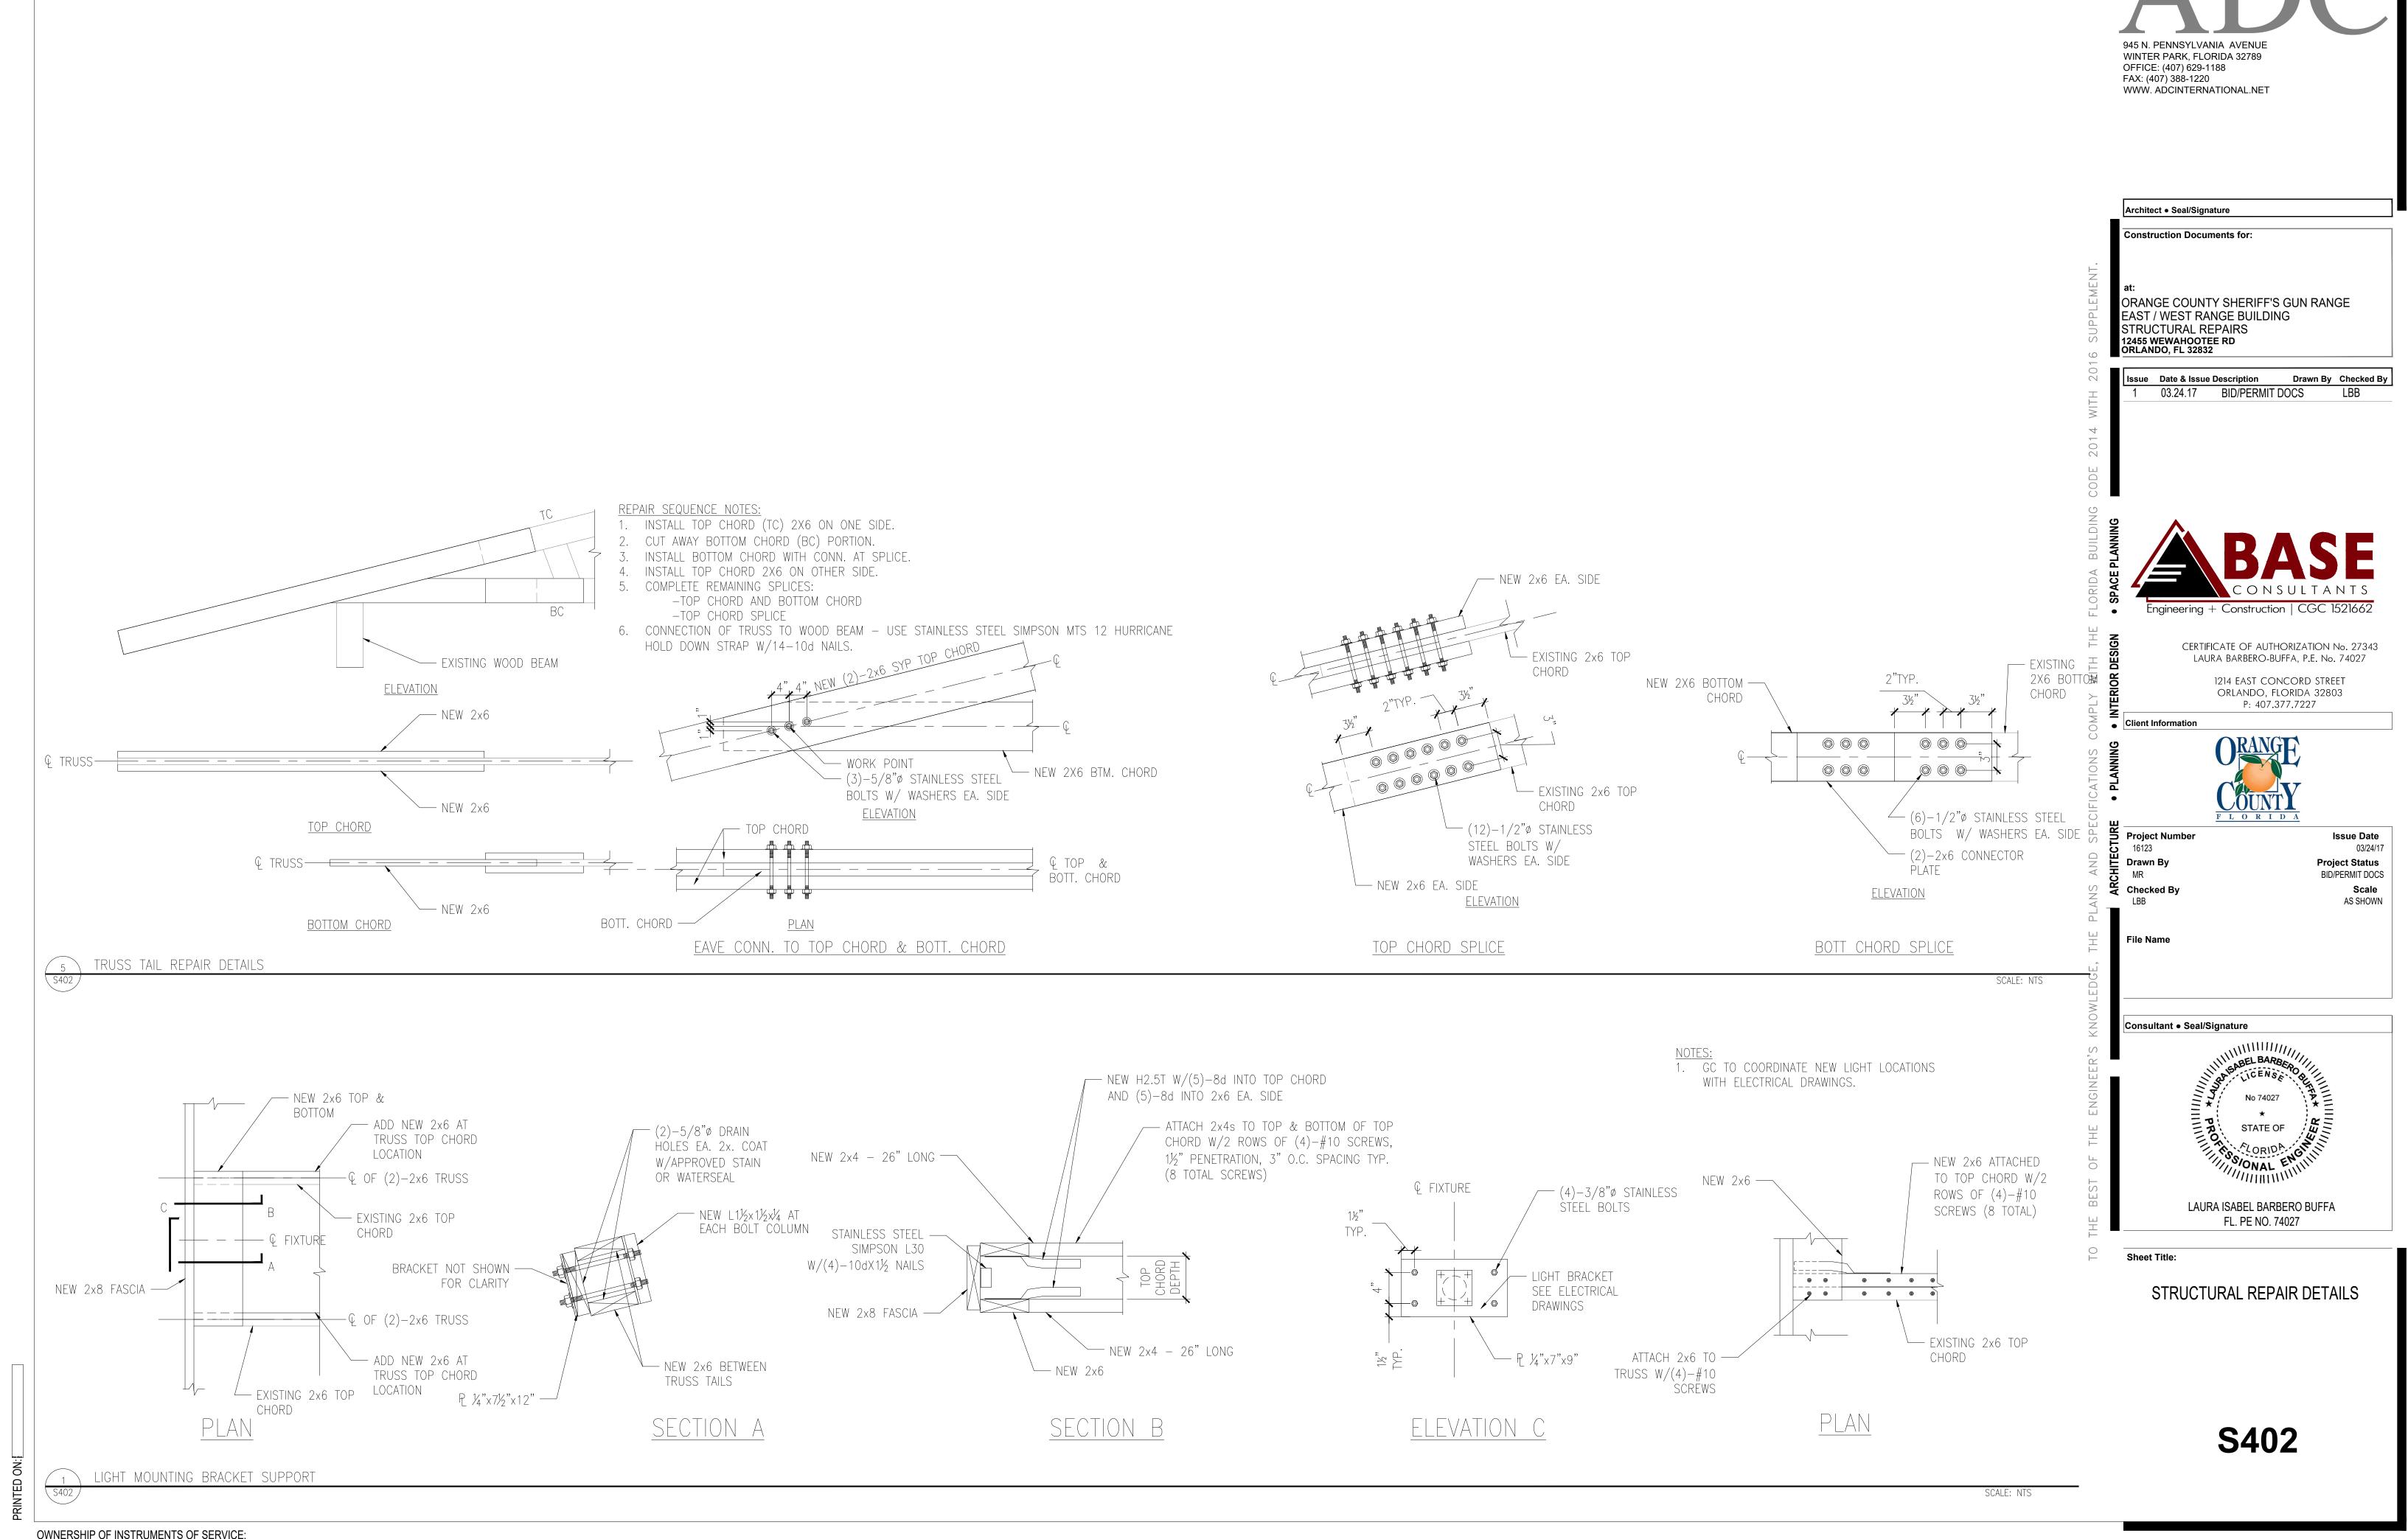

ARCHITECTURAL DESIGN COLLABORATIV