

PUMP STATION R/R PACKAGE NO. 22

PUMP STATION IMPROVEMENTS

PS 3337 - WHISPER LAKES 7

PS 3351 - WHISPER LAKES 4

PS 3301 - PEPPER MILL 4

PS 3390 - WHISPER LAKES 8

PS 3325 - MEADOW WOODS 1

ISSUED FOR BID

BOARD OF COUNTY COMMISSIONERS

JERRY L. DEMINGS
ORANGE COUNTY MAYOR

BETSY VANDERLAY
DISTRICT 1

MARIBEL GOMEZ CORDERO
DISTRICT 4

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COUNTY ADMINISTRATOR

RAYMOND E. HANSON, P.E.
DIRECTOR ORANGE COUNTY UTILITIES DEPARTMENT

ORANGE COUNTY UTILITIES DEPARTMENT
ENGINEERING DIVISION
ORANGE COUNTY, FLORIDA

MAY 2019



ATTENTION IS DIRECTED TO THE FACT THAT THESE PLANS MAY HAVE BEEN REDUCED IN SIZE BY REPRODUCTION. THIS MUST BE CONSIDERED WHEN OBTAINING SCALED DATA. DIMENSION INFORMATION SHOULD NOT BE OBTAINED BY SCALING THE PLANS. DIMENSION INFORMATION NOT PROVIDED HEREIN CAN BE OBTAINED BY CONTACTING ORANGE COUNTY UTILITIES ENGINEERING DIVISION, AT (407)254-9900


RE REISS ENGINEERING, INC.
CONSULTING ENGINEERS

1016 SPRING VILLAS POINT
WINTER SPRINGS, FLORIDA 32708
TEL: (407) 679-5358
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CERTIFICATE OF AUTHORIZATION NO. 8181


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CIP FUNDING CODE:

- 1559-0118
- 1559-0117
- 1559-11
- 1559-0116
- 1559-26

DRAWING INDEX

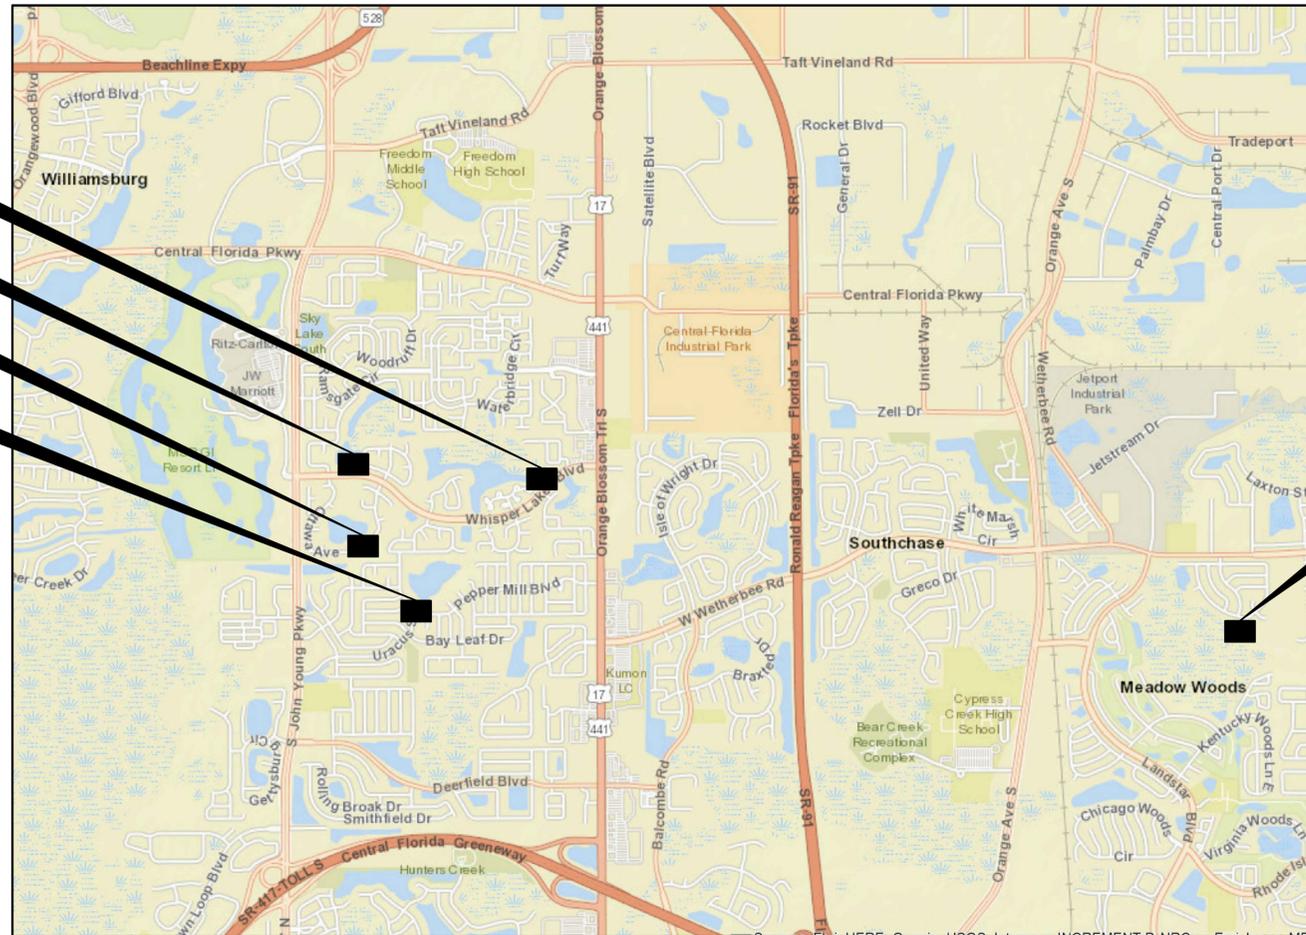

LOCATION MAP
ORANGE COUNTY, FLORIDA
 SCALE: N.T.S.

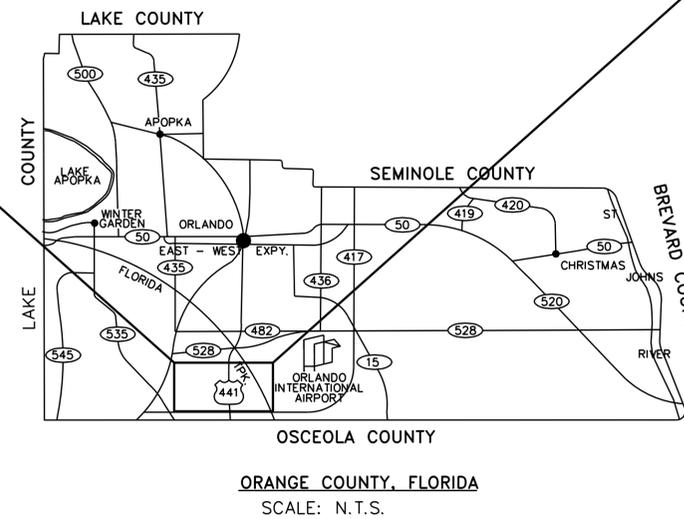

ORANGE COUNTY, FLORIDA
 SCALE: N.T.S.

ADDRESSES FOR THE EXISTING PUMP STATIONS:

- PS 3337: WHISPER LAKES 7 - 3307 WHISPER LAKES BLVD, ORLANDO, FL 32837
- PS 3351: WHISPER LAKES 4 - 2243 WHISPER LAKES BLVD, ORLANDO, FL 32837
- PS 3301: PEPPER MILL 4 - 12156 URACUS STREET, ORLANDO, FL 32837
- PS 3390: WHISPER LAKES 8 - 11808 OTTAWA AVENUE, ORLANDO, FL 32837
- PS 3325: MEADOW WOODS 1 - 852 CALIFORNIA WOODS CIRCLE, ORLANDO, FL 32824

SHEET TITLE		
SHEET	DRAWING	DESCRIPTION
GENERAL		
01	G100	COVER SHEET
02	G200	LOCATION MAP AND DRAWING INDEX
03	G300	GENERAL NOTES, ABBREVIATIONS AND LEGEND
04	G400	OCU GENERAL NOTES
SURVEY		
05	V100	PUMP STATION 3337 - WHISPER LAKES 7 BOUNDARY SURVEY & TOPOGRAPHIC SURVEY
06	V200	PUMP STATION 3351 - WHISPER LAKES 4 BOUNDARY SURVEY & TOPOGRAPHIC SURVEY
07	V300	PUMP STATION 3301 - PEPPER MILL 4 BOUNDARY SURVEY & TOPOGRAPHIC SURVEY
08	V400	PUMP STATION 3390 - WHISPER LAKES 8 BOUNDARY SURVEY & TOPOGRAPHIC SURVEY
09	V500	PUMP STATION 3325 - MEADOW WOODS 1 BOUNDARY SURVEY & TOPOGRAPHIC SURVEY
CIVIL		
10	C100	PUMP STATION 3337 - WHISPER LAKES 7 DEMOLITION SITE PLAN
11	C101	PUMP STATION 3337 - WHISPER LAKES 7 PROPOSED SITE PLAN
12	C200	PUMP STATION 3351 - WHISPER LAKES 4 DEMOLITION SITE PLAN
13	C201	PUMP STATION 3351 - WHISPER LAKES 4 PROPOSED SITE PLAN
14	C300	PUMP STATION 3301 - PEPPER MILL 4 DEMOLITION SITE PLAN
15	C301	PUMP STATION 3301 - PEPPER MILL 4 PROPOSED SITE PLAN
16	C400	PUMP STATION 3390 - WHISPER LAKES 8 DEMOLITION SITE PLAN
17	C401	PUMP STATION 3390 - WHISPER LAKES 8 PROPOSED SITE PLAN
18	C500	PUMP STATION 3325 - MEADOW WOODS 1 DEMOLITION SITE PLAN
19	C501	PUMP STATION 3325 - MEADOW WOODS 1 PROPOSED SITE PLAN
MECHANICAL		
20	P100	PUMP STATION 3337 - WHISPER LAKES 7 PLAN AND SECTIONS
21	P200	PUMP STATION 3351 - WHISPER LAKES 4 PLAN AND SECTIONS
22	P300	PUMP STATION 3301 - PEPPER MILL 4 PLAN AND SECTIONS
23	P400	PUMP STATION 3390 - WHISPER LAKES 8 PLAN AND SECTIONS
24	P500	PUMP STATION 3325 - MEADOW WOODS 1 PLAN AND SECTIONS
MECHANICAL & CIVIL DETAILS		
25	D100	OCU STANDARD MECHANICAL AND CIVIL DETAILS
26	D101	OCU STANDARD MECHANICAL AND CIVIL DETAILS
27	D102	OCU STANDARD MECHANICAL AND CIVIL DETAILS
28	D103	OCU STANDARD MECHANICAL AND CIVIL DETAILS
ELECTRICAL		
29	E001	ELECTRICAL NOTES, SYMBOLS AND ABBREVIATIONS
30	E100	PUMP STATION 3337 - WHISPER LAKES 7 SINGLE LINE DIAGRAM
31	E101	PUMP STATION 3337 - WHISPER LAKES 7 ELECTRICAL DEMOLITION PLAN
32	E102	PUMP STATION 3337 - WHISPER LAKES 7 ELECTRICAL PLAN
33	E200	PUMP STATION 3351 - WHISPER LAKES 4 SINGLE LINE DIAGRAM
34	E201	PUMP STATION 3351 - WHISPER LAKES 4 ELECTRICAL DEMOLITION PLAN
35	E202	PUMP STATION 3351 - WHISPER LAKES 4 ELECTRICAL PLAN
36	E300	PUMP STATION 3301 - PEPPER MILL 4 SINGLE LINE DIAGRAM
37	E301	PUMP STATION 3301 - PEPPER MILL 4 ELECTRICAL DEMOLITION PLAN
38	E302	PUMP STATION 3301 - PEPPER MILL 4 ELECTRICAL PLAN
39	E400	PUMP STATION 3390 - WHISPER LAKES 8 SINGLE LINE DIAGRAM
40	E401	PUMP STATION 3390 - WHISPER LAKES 8 ELECTRICAL DEMOLITION PLANS
41	E402	PUMP STATION 3390 - WHISPER LAKES 8 ELECTRICAL PLAN
42	E500	PUMP STATION 3325 - MEADOW WOODS 1 SINGLE LINE DIAGRAM
43	E501	PUMP STATION 3325 - MEADOW WOODS 1 ELECTRICAL DEMOLITION PLAN
44	E502	PUMP STATION 3325 - MEADOW WOODS 1 ELECTRICAL PLAN
45	ED100	ELECTRICAL DETAILS - 1
46	ED101	ELECTRICAL DETAILS - 2
ASSET ATTRIBUTE TABLES		
47	X100	ASSET TABLES



REV	DATE	DESCRIPTION	BY
C	05/2019	ISSUED FOR BID	AJM
B	10/2018	90% DRAWINGS	AJM
A	08/2018	60% DRAWINGS	AJM

Issue Certification	
Designed	ARS
Drawn	AJM
Checked	MDP
Reviewed	JRV
Approved	MDP
Melanie D. Peckham, P.E. Florida P.E. No. 66478	

Designed	ARS
Drawn	AJM
Checked	MDP
Reviewed	JRV
Approved	MDP
LINE IS 1" AT FULL SIZE	

ORANGE COUNTY
R/R PACKAGE 22 PUMP STATIONS
 GENERAL
LOCATION MAP AND DRAWING INDEX

PROJECT NO.: 110034	
SCALE: NOTED	REVISION: C
DRAWING NO. G200	SHEET NO.: 02 OF 47

REISS ENGINEERING, INC.
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 CERTIFICATE OF AUTH. 8181

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GENERAL NOTES

- EXCAVATE CAUTIOUSLY** LOCATIONS OF EXISTING UTILITIES INDICATED HEREIN ARE BASED ON BEST AVAILABLE INFORMATION AND ARE NOT TO BE CONSIDERED ALL INCLUSIVE. CONTRACTOR SHALL VERIFY EXACT LOCATION, CHARACTER AND NATURE OF ALL EXISTING AND PROPOSED UTILITIES PRIOR TO BEGINNING CONSTRUCTION AND PRIOR TO FABRICATION OF PIPING AND EQUIPMENT TO ENSURE PROPER ASSEMBLY OF ALL ITEMS.
- LOCATIONS AND DIMENSION OF EXISTING RIGHTS-OF-WAY AND EASEMENTS ARE BASED ON BEST AVAILABLE INFORMATION. CONTRACTOR SHALL VERIFY THE LIMITS OF THE RIGHTS-OF-WAY AND EASEMENTS IN ORDER TO AVOID ENCRoACHMENTS.
- COVER OVER ALL PIPES SHALL BE THREE (3) FEET MINIMUM, OR AS SHOWN.
- PIPE JOINTS SHALL NOT BE DEFLECTED.
- ALL EXCAVATIONS SHALL BE BACK FILLED AT THE END OF EACH WORK DAY. ALL FINAL BACK FILL IS TO BE COMPACTED TO 98% OF MAXIMUM MODIFIED PROCTOR.
- ALL SITE WORK SHALL BE COORDINATED WITH THE COUNTY RESIDENT PROJECT REPRESENTATIVE (RPR).
- THE ELEVATIONS SHOWN ARE BASED ON NGVD 1929 DATUM.
- NEW OR RELOCATED, UNDERGROUND WATER MAINS SHALL BE LAID TO PROVIDE A HORIZONTAL DISTANCE OF AT LEAST SIX FEET, AND PREFERABLY TEN FEET, BETWEEN THE OUTSIDE OF THE WATER MAIN AND THE OUTSIDE OF ANY EXISTING OR PROPOSED GRAVITY- OR PRESSURE-TYPE SANITARY SEWER, WASTEWATER FORCE MAIN, OR PIPELINE CONVEYING RECLAIMED WATER NOT REGULATED UNDER PART III OF CHAPTER 62-610, F.A.C. THE MINIMUM HORIZONTAL SEPARATION DISTANCE BETWEEN WATER MAINS AND GRAVITY-TYPE SANITARY SEWERS SHALL BE REDUCED TO THREE FEET WHERE THE BOTTOM OF THE WATER MAIN IS LAID AT LEAST SIX INCHES ABOVE THE TOP OF THE SEWER. NEW OR RELOCATED, UNDERGROUND WATER MAINS CROSSING ANY EXISTING OR PROPOSED GRAVITY-OR VACUUM-TYPE SANITARY SEWER SHALL BE LAID SO THE OUTSIDE OF THE WATER MAIN IS AT LEAST SIX INCHES, AND PREFERABLY 12 INCHES, ABOVE OR AT LEAST 12 INCHES BELOW THE OUTSIDE OF THE OTHER PIPELINE. HOWEVER, IT IS PREFERABLE TO LAY THE WATER MAIN ABOVE THE OTHER PIPELINE. NEW OR RELOCATED, UNDERGROUND WATER MAINS CROSSING ANY EXISTING OR PROPOSED PRESSURE TYPE SANITARY SEWER, WASTEWATER OR STORMWATER FORCE MAIN, OR PIPELINE CONVEYING RECLAIMED WATER SHALL BE LAID SO THE OUTSIDE OF THE WATER MAIN IS AT LEAST 12 INCHES ABOVE OR BELOW THE OUTSIDE OF THE OTHER PIPELINE. HOWEVER, IT IS PREFERABLE TO LAY THE WATER MAIN ABOVE THE OTHER PIPELINE.
- AT THE UTILITY CROSSINGS DESCRIBED ABOVE, ONE FULL LENGTH OF WATER MAIN PIPE SHALL BE CENTERED ABOVE OR BELOW THE OTHER PIPELINE SO THE WATER MAIN JOINTS WILL BE AS FAR AS POSSIBLE FROM THE OTHER PIPELINE. ALTERNATIVELY, AT SUCH CROSSINGS, THE PIPES SHALL BE ARRANGED SO THE ALL WATER MAIN JOINTS ARE AT LEAST THREE FEET FROM ALL JOINTS IN VACUUM-TYPE SANITARY SEWERS, OR PIPELINES CONVEYING RECLAIMED WATER REGULATED UNDER PART III OF CHAPTER 62-610, F.A.C., AND AT LEAST SIX FEET FROM ALL JOINTS IN GRAVITY-OR PRESSURE-TYPE SANITARY SEWERS, WASTEWATER FORCE MAINS, OR PIPELINES CONVEYING RECLAIMED WATER NOT REGULATED UNDER PART III OF CHAPTER 62-610, F.A.C.
- ALL PROPOSED DUCTILE IRON M.J. FITTINGS, PIPES, OR RESTRAINTS WITHIN FORTY (40) FEET OF EXISTING GAS MAINS SHALL BE POLYETHYLENE ENCASED.
- ALL EXISTING AND PROPOSED WATER, WASTEWATER AND REUSE VALVES SHALL BE OPERATED BY ORANGE COUNTY UTILITIES AUTHORIZED REPRESENTATIVES. EXISTING VALVE BOXES AND MANHOLES, WHICH ARE TO REMAIN, SHALL BE ADJUSTED TO THE FINISHED GRADE. ALL VALVES UNDER CONSTRUCTION SHALL REMAIN CLOSED DURING CONSTRUCTION.
- THE CONTRACTOR SHALL PROVIDE TANKERS AND SIGNED DOCUMENT ACKNOWLEDGING THE UNDERSTANDING OF THE ORANGE COUNTY UTILITY "EMERGENCY WASTEWATER SPILL AND WATER MAIN BREAK PROCEDURES", IN THE PRE-CONSTRUCTION PACKET FOR THE MEETING.
- THE CONTRACTOR SHALL PROVIDE AND MAINTAIN ON-SITE DURING THE LIFE OF THE PROJECT, A WEATHERPROOF ENCLOSURE CONTAINING A READILY ACCESSIBLE LIST OF EMERGENCY CONTACTS AND PHONE NUMBERS.
- THE CONTRACTOR SHALL BE RESPONSIBLE FOR THE SATISFACTION OF ALL REQUIREMENTS OF REGULATORY AGENCY PERMITS WITH REGARD TO CONSTRUCTION ACTIVITIES AND RELATED CONDITIONS.
- THE CONTRACTOR SHALL CALL SUNSHINE STATE ONE CALL NO LESS THAN FORTY-EIGHT (48) HOURS PRIOR TO THE START OF CONSTRUCTION. - PHONE - 800-432-4777.
- ADVANCE NOTIFICATION of CONSTRUCTION**
THE ORANGE COUNTY UTILITY CONSTRUCTION SECTION (407) 254-9798, SHALL BE NOTIFIED AT LEAST SEVEN (7) DAYS PRIOR TO ANY CONSTRUCTION ACTIVITY.
- THE CONTRACTOR SHALL MAKE EXPLORATORY EXCAVATIONS AT ALL INTERSECTIONS OF PROPOSED WORK AND EXISTING UTILITIES. THE EXPLORATORY EXCAVATIONS SHALL BE MADE FORTY-EIGHT (48) HOURS IN ADVANCE OF THE WORK. IF THERE IS A POTENTIAL CONFLICT, THE CONTRACTOR SHALL NOTIFY THE COUNTY RESIDENT PROJECT REPRESENTATIVE IMMEDIATELY WITH INFORMATION WHICH SHALL INCLUDE LOCATION, ELEVATION, UTILITY TYPE, MATERIAL AND SIZE.
- IN AREAS WHERE CONSTRUCTION ACTIVITIES RESTRICT NORMAL ACCESS TO PROPERTIES, THE CONTRACTOR SHALL PROVIDE AND MAINTAIN ALTERNATE ACCESS ROUTES WHICH ARE SUBJECT TO APPROVAL BY THE ENGINEER, AS PART OF THE M.O.T. PLAN.
- THE DISPOSAL OF ANY EXCESS EARTH WORK MATERIAL SHALL BE THE RESPONSIBILITY OF THE CONTRACTOR.
- THE CONTRACTOR SHALL REPLACE WITH EQUAL MATERIAL, OR AS DIRECTED BY THE RPR, ALL PAVING, GRASSED AREAS, STABILIZED EARTH, DRIVEWAYS, ETC., DISTURBED OR DAMAGED BY THE CONSTRUCTION OR RELATED ACTIVITIES. ALL DISTURBED AREAS SHALL BE SODDED, EXCEPT DIRT DRIVES AND WHERE INDICATED IN THE DRAWINGS.
- SALVAGE AND/OR DISPOSAL OF ALL EXISTING EQUIPMENT SHALL BE AT THE DIRECTION OF THE RPR.
- THE CONTRACTOR SHALL BE RESPONSIBLE FOR PROPER DISPOSAL OF ALL STRUCTURES, PIPE, CONDUIT, WIRE, FITTINGS, PANELS, ETC. THAT ARE DEMOLISHED, DISASSEMBLED, OR REMOVED, PER SECTION 02080 OF THE SPECIFICATION MANUAL OF THIS PROJECT.

- OPERATION OF ORANGE COUNTY PUMP STATIONS** THE CONTRACTOR SHALL COORDINATE ALL PUMP STATION OPERATIONS AND SHUT DOWN CONTROL WITH THE ORANGE COUNTY RPR.
- THE CONTRACTOR SHALL PROVIDE TEMPORARY BY-PASS PUMPING AS NEEDED FOR EACH PUMP STATION AND/OR MANHOLE TO BE REHABILITATED AND/OR REPLACED PRIOR TO THE START OF ANY WORK. BOTH THE PRIMARY AND THE BACKUP BY-PASS PUMPING SYSTEMS SHALL BE OF ADEQUATE CAPACITIES AND SIZES TO HANDLE THE FLOW AND SHALL MAINTAIN CONTINUOUS SERVICE DURING THE ENTIRE CONSTRUCTION PROCESS UNTIL THE NEW OR REHABILITATED PUMP STATION OR MANHOLE HAS BEEN ACCEPTED BY THE COUNTY. THE BY-PASS PUMPING SYSTEMS SHALL BE APPROVED AND ACCEPTED BY THE COUNTY PRIOR TO INSTALLATION. THE CONTRACTOR SHALL NOT MAINTAIN MORE THAN TWO (2) PUMP STATION BY-PASS OPERATIONS AT THE SAME TIME DURING THE CONSTRUCTION PROCESS.
- BY-PASS PUMPING SHALL BE LOW NOISE SUITABLE FOR RESIDENTIAL NEIGHBORHOODS (SEE SECTION 01001.1.05B OF THE TECHNICAL SPECIFICATIONS).
- THE CONTRACTOR SHALL BE RESPONSIBLE FOR ANY DE-WATERING REQUIRED DURING CONSTRUCTION AND TO OBTAIN AND PAY FOR ALL PERMITS REQUIRED FOR THE TEMPORARY DEWATERING OF DRAINAGE STRUCTURES.
- THE CONTRACTOR SHALL FURNISH AND INSTALL ALL TEMPORARY PLUGS, BLOCKING, TAPS, AND TESTING EQUIPMENT REQUIRED TO COMPLETE PRESSURE TESTING, AS SPECIFIED.
- THE CONTRACTOR SHALL PREPARE AND SUBMIT FOR APPROVAL BY THE COUNTY, A COMPREHENSIVE WRITTEN PROCEDURE THAT DESCRIBES THE INTENDED CONSTRUCTION SEQUENCE FOR MAINTAINING AND TRANSFERRING SERVICE FROM THE EXISTING PUMP STATION TO THE NEW PUMP STATION. ITEMS TO ADDRESS SHALL INCLUDE THE FOLLOWING AS A MINIMUM:
 - LOCATION AND METHOD OF BY-PASS PUMPING.
 - STATION START-UP AND DRAW-DOWN PROCEDURES.
 - TIE IN OF THE NEW PUMP STATION.
 - DISMANTLING OF EQUIPMENT AND CONVERSION OR REMOVAL OF OLD WET WELL.
 THIS PROCEDURE SHALL BE SUBMITTED WITH THE PROJECT SCHEDULE.
- THE CONTRACTOR SHALL NOTIFY THE COUNTY SEVEN (7) WORKING DAYS IN ADVANCE OF ANY WASTEWATER FORCE MAIN SHUT-DOWN.
- ALL CONNECTIONS TO EXISTING FORCE MAINS SHALL BE MADE BY THE CONTRACTOR ONLY AFTER THE CONNECTION PROCEDURE AND THE WORK SCHEDULING HAS BEEN REVIEWED AND APPROVED BY THE COUNTY. THE CONTRACTOR SHALL SUBMIT A WRITTEN REQUEST TO THE COUNTY A MINIMUM OF SEVEN (7) WORKING DAYS PRIOR TO SCHEDULING SAID CONNECTIONS. THE REQUEST SHALL OUTLINE THE FOLLOWING:
 - POINTS OF CONNECTION, FITTINGS TO BE USED, AND METHOD OF FLUSHING.
 - ESTIMATED CONSTRUCTION TIME FOR SAID CONNECTIONS.
- THE COUNTY SHALL REVIEW THE SUBMITTAL WITHIN THREE (3) WORKING DAYS AFTER RECEIPT AND INFORM THE CONTRACTOR REGARDING APPROVAL OR DENIAL OF THE REQUEST. IF THE REQUEST IS REJECTED BY THE COUNTY, THE CONTRACTOR SHALL RESUBMIT THE WRITTEN REQUEST, WHICH HAS BEEN MODIFIED IN A MANNER ACCEPTABLE TO THE COUNTY. ALL CONNECTIONS SHALL BE MADE ONLY ON THE AGREED UPON DATE AND TIME. IF THE CONTRACTOR DOES NOT INITIATE AND COMPLETE THE CONNECTION WORK IN THE AGREED UPON MANNER, HE SHALL BE REQUIRED TO RESCHEDULE THE SAID CONNECTIONS BY FOLLOWING THE PROCEDURE OUTLINED IN NOTE 29.
- ADVANCE NOTIFICATION OF PENDING CONNECTION**
THE ORANGE COUNTY UTILITY WATER DIVISION AND THE ORANGE COUNTY UTILITY WATER RECLAIMATION DIVISION SHALL BE NOTIFIED AT LEAST SEVEN (7) DAYS IN ADVANCE TO SCHEDULE MAIN TIE-INS AND VALVE OPERATIONS.
- ANY WORK PROPOSED FOR THE POTABLE WATER SYSTEM SHALL BE PERFORMED IN ACCORDANCE WITH THE STANDARDS AND DETAILS OF THE APPROPRIATE UTILITY PROVIDER.
- REPAIR IMMEDIATELY**
ALL DAMAGE TO ORANGE COUNTY MAINS SHALL BE REPAIRED IMMEDIATELY BY THE CONTRACTOR AT THE CONTRACTOR'S EXPENSE. IF THE REPAIR IS NOT DONE IN A TIMELY MANNER, AS DETERMINED BY THE ORANGE COUNTY UTILITY INSPECTOR, THE UTILITY MAY PERFORM REPAIRS AND THE CONTRACTOR WILL BE CHARGED FOR SAID REPAIRS.
- TELEPHONE NOTIFICATIONS**
THE ORANGE COUNTY DISPATCH OPERATOR SHALL BE NOTIFIED IMMEDIATELY IN THE EVENT OF A FORCEMAIN, GRAVITY SEWER, OR WATER MAIN BREAK OR DAMAGE AT (407)836-2777 (24-HOURS ASSISTANCE).
- ALL WORK AND MATERIAL SHALL CONFORM TO THE ORANGE COUNTY UTILITIES STANDARDS AND CONSTRUCTION SPECIFICATIONS MANUAL, LATEST EDITION OR AS INDICATED IN THE PROJECT SPECIFICATIONS OR DRAWINGS.

EMERGENCY NUMBERS

POWER	ORLANDO UTILITIES COMMISSION (OUC)	407-236-9651
POWER	DUKE ENERGY (PROGRESS ENERGY)	407-938-6670
WATER/SEWER	ORANGE COUNTY UTILITIES ENGINEERING DIVISION	407-254-9900
WATER	ORLANDO UTILITIES COMMISSION ENGINEERING DIVISION	407-423-9018
PHONE	BRIGHT HOUSE	407-532-8509, 407-532-8520
PHONE	CENTURY LINK	407-815-5344, 407-557-6766
PHONE	IMCI	972-729-6016
PHONE	SMART CITY TELECOM	407-828-6648
PHONE	TW TELECOM	407-215-6895
FIBER OPTIC	COMCAST COMMUNICATIONS	407-312-5944
FIBER OPTIC	LEVEL 3 COMMUNICATIONS	720-888-2061
GAS	TECO PEOPLES GAS-ORLANDO	407-420-6609
DOT EQUIPMENT		
TRAFFIC SIGNALS	TRAFFIC CONTROL DEVICES	407-869-5300
	SUNSHINE ONE CALL SERVICE	800-432-4770
	ORANGE COUNTY UTILITIES DISPATCH (EMERGENCY ONLY)	407-836-2777
	FIELD SERVICES CENTER	407-836-6818

LEGEND

	GUY WIRE AND ANCHOR		EXISTING STORM PIPE
	CAP		EXISTING BURIED TELEPHONE
	PLUG		EXISTING FIBER OPTIC CABLE
	BENCHMARK		EXISTING BURIED ELECTRIC
	TREE (TYPE & SIZE NOTED)		EXISTING OVERHEAD ELECTRIC
	SHRUB		EXISTING CABLE TV (BURIED)
	PROPOSED ELEVATION		EXISTING ELEVATION
	PROPOSED FORCE MAIN		EXISTING FORCE MAIN
	PROPOSED GRAVITY MAIN		EXISTING GRAVITY MAIN
	PROPOSED WATER SERVICE		EXISTING WATER MAIN
	PROPOSED CHAIN-LINK FENCE		EXISTING CHAN-LINK FENCE
	PROPOSED WOOD FENCE		EXISTING WOOD FENCE
	PROPOSED POWER POLE		EXISTING POWER POLE
	PROPOSED MANHOLE (SPECIFY)		EXISTING MANHOLE (SPECIFY)
	PROPOSED VALVE (SPECIFY)		EXISTING VALVE (SPECIFY)
	PROPOSED WATER METER		EXISTING WATER METER
	PROPOSED BACK-FLOW PREVENTER		EXISTING BACK-FLOW PREVENTER
	PROPOSED SILT FENCE		

PRECAST STRUCTURAL NOTES

- PRECAST STRUCTURES SHALL BE ENGINEERED PRODUCTS OF A PRECAST MANUFACTURER AND SHALL BE SPECIFICALLY DESIGNED FOR THE SERVICE AND APPLICATION AS SHOWN ON THESE DRAWINGS. THE PRECAST MANUFACTURER IS SOLELY RESPONSIBLE FOR DESIGN AND MANUFACTURE OF EACH STRUCTURE. THE CONTRACTOR SHALL BE SOLELY RESPONSIBLE FOR INSTALLATION OF THESE PRODUCTS AND CONFORMANCE OF SAME WITH ALL PROJECT DOCUMENTS. THE CONTRACTOR SHALL SUBMIT COMPLETE SHOP DRAWINGS FOR ALL SUCH PRECAST STRUCTURES ON THE PROJECT FOR REVIEW AND APPROVAL, PRIOR TO THE ORDERING OF ANY STRUCTURES OR MATERIALS.
- THE CONTRACTOR SHALL SUBMIT SHOP DRAWINGS OF THE CAST-IN-PLACE REINFORCEMENT AND CONCRETE PLACEMENT USED IN THE INSTALLATION OF SADDLE MANHOLES FOR REVIEW AND APPROVAL BY THE COUNTY, PRIOR TO THE ORDERING OF ANY MATERIALS.
- STRUCTURAL DESIGN STANDARDS - ACI STANDARD 318-89 BUILDING CODE REQUIREMENTS FOR REINFORCED CONCRETE AND ACI 350R-83, "CONCRETE SANITARY ENGINEERING STRUCTURES". PRECAST WALL SECTIONS ASTM C478.
- ALL CONCRETE SHALL HAVE A SPECIFIED MINIMUM COMPRESSIVE STRENGTH OF fc' = 4000 P.S.I. AT 28 DAYS, UNLESS NOTED ON DRAWINGS.
- ALL REINFORCING BARS SHALL CONFORM TO ASTM A615 GRADE 60. MINIMUM YIELD STRENGTH SHALL BE 60,000 P.S.I..
- CONTRACTOR SHALL COORDINATE WET WELL HATCH OPENING SIZE AND LOCATION AS REQUIRED BY PUMP MANUFACTURER/SUPPLIER WITH THE PRECAST CONCRETE SUPPLIER PRIOR TO CASTING. SHOP DRAWINGS OF THE PRECAST SHALL BE PROVIDED TO THE COUNTY FOR REVIEW.
- THE FLOOR GROUT (FILLET) SHALL BE FULL CIRCUMFERENCE OF THE STRUCTURE.

POWER AND WATER SUPPLY NOTES:

- THE CONTRACTOR SHALL CONTACT THE APPROPRIATE UTILITY PROVIDER FOR POWER AND WATER SERVICE, AND SHALL INCLUDE IN HIS BID ALL PROVIDER CHARGES FOR MATERIALS, LABOR, ONE-TIME NONRECURRING CONSTRUCTION COSTS AND OTHER COSTS, INCLUDING WATER METER, ASSESSED BY THE PROVIDER, WHETHER OR NOT INDICATED ON THE DRAWINGS, OR SPECIFIED.
- THE CONTRACTOR SHALL COORDINATE THE INSTALLATION OF THE POWER SUPPLY AND THE WATER SYSTEM RELOCATION AND INSTALLATION WITH THE SUPPLIER.
- THE POWER PROVIDER SHALL MAKE ALL SECONDARY TERMINATIONS AT POWER TRANSFORMERS.
- THE WATER SUPPLIER WILL PERFORM THE REQUIRED RELOCATIONS AND MAKE ALL CONNECTIONS TO THE EXISTING WATER SYSTEM, INCLUDING WATER METER INSTALLATION.
- POWER SUPPLIER FOR ALL PUMP STATIONS: DUKE ENERGY
- WATER SUPPLIER FOR ALL PUMP STATIONS: O. U. C.

ABBREVIATIONS			
AKA	ALSO KNOWN AS	MAX.	MAXIMUM
AC	ASBESTOS CEMENT	MATL	MATERIAL
ALUM.	ALUMINUM	M.H.	MANHOLE
APPROX.	APPROXIMATELY	MIN.	MINIMUM
ARV	AIR RELEASE VALVE (PW-RCW)	MOD	MODIFIED
ASPH.	ASPHALT	M.O.T.	MAINTENANCE OF TRAFFIC
ASSEM.	ASSEMBLY	M.J.	MECHANICAL JOINT
BE	BURIED ELECTRIC	N.G.	NATURAL GROUND
BL	BASELINE	NO.	NUMBER
B.M.	BENCHMARK	NPW	NON-POTABLE WATER
B.O.	BLOWOFF	N.T.S.	NOT TO SCALE
BCL	BURIED CABLE LINE	O.C.U.	ORANGE COUNTY UTILITIES
BT	BURIED TELEPHONE	O.D.	OUTSIDE DIAMETER
B.F.V.	BUTTERFLY VALVE	O.H.E.	OVERHEAD ELECTRIC
CATV	CABLE TELEVISION	O.U.C.	ORLANDO UTILITIES COMMISSION
C.B.	CATCH BASIN	PAVT.	PAVEMENT
C.F.S.	CUBIC FEET PER SECOND	P.B.	PULL BOX
CIP	CAST IRON PIPE	PG.	PAGE
CL	CENTERLINE	P.I.	POINT OF INTERSECTION
C.M.	CONCRETE MONUMENT	PL	PROPERTY LINE
C.M.P.	CORRUGATED METAL PIPE	POLY.	POLYETHYLENE
CONC.	CONCRETE	PP	POWER POLE
CONN.	CONNECTION	PROP.	PROPOSED
CONST.	CONSTRUCT	PS	PUMP STATION
CONT.	CONTINUOUS	PSF	PUMP STATION FITTING
CORP.	CORPORATION	P.S.I.	POUNDS PER SQUARE INCH
C.V.	CHECK VALVE	PSMH	PUMP STATION MANHOLE
C.Y.	CUBIC YARD	PSOL	PUMP STATION OUTER LIMIT
DBL.	DOUBLE	PSPC	PUMP STATION PROPERTY CORNER
DHW	DESIGN HIGH WATER	PSV	PUMP STATION VALVE
DIA	DIAMETER	PSWW	PUMP STATION WET WELL
DIP	DUCTILE IRON PIPE	P.U.E.	PERMANENT UTILITY EASEMENT
DWLS.	DOWELS	PV	PLUG VALVE
DWG.	DRAWING	RAD. PT.	RADIUS POINT
ELEC	ELECTRIC	R	RADIUS
EA.	EACH	RCP	REINFORCED CONCRETE PIPE
EFF	EFFLUENT	REINF.	REINFORCED
ELEV.	ELEVATION	REQ.	REQUIRED
EMB.	EMBED OR EMBEDDED	RMJ	REINFORCED MECHANICAL JOINT
E/P	EDGE OF PAVEMENT	RPBP	REDUCED PRESSURE ZONE BACKFLOW PREVENTER
ESMT.	EASEMENT	RT.	RIGHT
E.W.	EACH WAY	RW	RECLAIMED WATER
EXIST.	EXISTING	R/W	RIGHT OF WAY
EXP. JT.	EXPANSION JOINT	SAN.	SANITARY SEWER
F.D.	FLOOR DRAIN	SARV	SEWAGE AIR RELEASE VALVE
F.D.E.P.	FLORIDA DEPT. OF ENVIRONMENTAL PROTECTION AGENCY	SCH.	SCHEDULE
F.P.A.	FLORIDA DEPT. OF TRANSPORTATION	S.D.	STORM DRAIN
F.F.	FINISHED FLOOR	S.F.	SQUARE FEET
F.H.	FIRE HYDRANT	SHT.	SHEET
FKA	FORMALLY KNOWN AS	SPECS.	SPECIFICATIONS
FLG.	FLANGE	SQ.	SQUARE
FL.	FLOW LINE	SS	STORM SEWER
FM	FORCEMAIN	SST	STAINLESS STEEL
FT.	FEET	STA.	STATION
FTG.	FOOTING	STD.	STANDARD
GA	GAUGE	STL.	STEEL
GAL.	GALLONS	S.Y.	SQUARE YARDS
GEN.	GENERATOR	TEL	TELEPHONE
GRD.	GROUND	T&B	TOP AND BOTTOM
G.S.P.	GALVANIZED STEEL PIPE	TBM	TEMPORARY BENCH MARK
GM	GAS MAIN	TCE	TEMPORARY CONSTRUCTION EASEMENT
GPM	GALLONS PER MINUTE	TEMP.	TEMPORARY
GV	GATE VALVE	THD.	THREADED
HB	HOSE BIBB	THK.	THICK
HDWL.	HEADWALL	TRA	TRANSPORTATION
HT.	HEIGHT	TYP.	TYPICAL
HP	HIGH POINT	U.G.	UNDERGROUND
HORIZ.	HORIZONTAL	VAC	VOLTAGE ALTERNATING CURRENT
H.W.L.	HIGH WATER LEVEL	VCP	VITRIFIED CLAY PIPE
I.E.	INVERT ELEVATION	VDC	VOLTAGE DIRECT CURRENT
I.D.	INSIDE DIAMETER	VERT.	VERTICAL
IN.	INCHES	V.V.H.	VERIFIED VERTICALLY & HORIZONTALLY
INV.	INVERT	W/	WITH
I.P.	IRON PIPE	WM	WATERMAIN
I.R.	IRON ROD	WM	WATER METER
J.B.	JUNCTION BOX	WP	WALL PIPE
JUNC.	JUNCTION	WS	WATER SERVICE
LAT.	LATERAL	W.S.	WATER SURFACE
LF	LINEAR FEET	WWF	WELDED WIRE FABRIC
L.S.	LIFT STATION	"X"	SPOT ELEVATION
LT	LEFT		
L.W.L.	LOW WATER LEVEL		

REF:NNNNN REFERENCE MADE TO AN APPLICABLE SECTION(S) OF THE TECHNICAL SPECIFICATIONS FOR THIS PROJECT.

ADDRESSES FOR THE EXISTING PUMP STATIONS:

- PS 3337: WHISPER LAKES 7 - 3307 WHISPER LAKES BLVD, ORLANDO, FL 32837
- PS 3351: WHISPER LAKES 4 - 2243 WHISPER LAKES BLVD, ORLANDO, FL 32837
- PS 3301: PEPPER MILL 4 - 12156 URACUS STREET, ORLANDO, FL 32837
- PS 3390: WHISPER LAKES 8 - 11808 OTTAWA AVENUE, ORLANDO, FL 32837
- PS 3325: MEADOW WOODS 1 - 852 CALIFORNIA WOODS CIRCLE, ORLANDO, FL 32824



REV	DATE	DESCRIPTION	BY
C	05/2019	ISSUED FOR BID	AJM
B	10/2018	90% DRAWINGS	AJM
A	08/2018	60% DRAWINGS	AJM

Issue Certification	Designed <u>ARS</u>
	Drawn <u>AJM</u>
	Checked <u>MDP</u>
	Reviewed <u>JRV</u>
	Approved <u>MDP</u>
Melanie D. Peckham, P.E. Florida P.E. No. 66478	LINE IS 1" AT FULL SIZE

ORANGE COUNTY
R/R PACKAGE 22 PUMP STATIONS

GENERAL

GENERAL NOTES, ABBREVIATIONS AND LEGEND

PROJECT NO.: 110034	
SCALE: NOTED	REVISION: C
DRAWING NO. G300	SHEET NO.: 03 OF 47

REISS ENGINEERING, INC.
1016 SPRING VILLAS PT.
WINTER SPRINGS, FL 32708
(407) 679-5358
CERTIFICATE OF AUTH. 8181

Parent Sheet Set:1100340C_PKG22PS Rev/Plot by:JAY MILLER Rev on: 4/18/2019 8:38 AM Individual File Path:R:\Projects\110034 - Orange County R-R Package 22 Pump Stations\Design\FinalDesign\G400.dwg

OUW WATER ENGINEERING NOTES (REV. 05/12/09):

THE DEVELOPER/CUSTOMER SHALL ACCOMPLISH ALL WATER MAIN AND SERVICE WORK THROUGH THE POINT OF SERVICE/CONTROL VALVE AND WATER METERS AND DEED TO OUC. OUC WILL OWN AND OPERATE UP TO AND INCLUDING THE OUC POINT OF SERVICE/CONTROL VALVE AND METERS ONLY. THE REQUIRED WORK SHALL BE PERFORMED PER CURRENT OUC GUIDELINES, OUC WATER DISTRIBUTION STANDARD SPECIFICATIONS AND OUC WATER DISTRIBUTION MATERIAL SPECIFICATIONS AND WATER DETAIL SHEET UNDER OUC INSPECTION. THE DEVELOPER/CUSTOMER MUST CONTACT OUC INSPECTION AT 407-649-4436 TO SCHEDULE A PRE-CONSTRUCTION MEETING PRIOR TO ANY WATER CONSTRUCTION.

A MINIMUM 4' CLEARANCE (INCLUDING LANDSCAPING) MUST BE MAINTAINED AROUND METER ASSEMBLY.

THE DEVELOPER/CUSTOMER SHALL FIELD VERIFY THE HORIZONTAL AND VERTICAL LOCATION OF EXISTING OUC WATER FACILITIES BEFORE COMMENCEMENT OF CONSTRUCTION.

FOR WATER WET TAPS, USE ONLY OUC APPROVED TAPPING CONTRACTORS:

- ACTION INDUSTRIES, INC. 352-732-6941 OR 800-216-4464
- CENTRAL FLORIDA TAPPING AND CONSTRUCTION SERVICES, INC. 407-834-8271
- MAC TAPPING, INC. 407-468-0557
- RANGELINE TAPPING SERVICES, INC. 800-346-5971
- TDW SERVICES, INC. 407-843-2800
- T & R TAPPING SERVICE, INC. 407-339-3685

EASEMENTS:

ALL ON-SITE OUC WATER FACILITIES (MAINS, SERVICES, METERS, AND FIRE HYDRANTS) SHALL BE LOCATED WITHIN A UTILITY EASEMENT IN ACCORDANCE WITH CURRENT OUC PRIVATE PROPERTY GUIDELINES. THE DEVELOPER IS TO FURNISH ALL NECESSARY INFORMATION, INCLUDING LEGAL DESCRIPTION(S) TO PREPARE AND DOCUMENT THIS EASEMENT. ANY QUESTIONS OR COMMENTS PLEASE CONTACT OUC PROPERTY AND RIGHT OF WAY DEPARTMENT AT 407-423-9190.

CONNECTION TO EXISTING VALVE

CONTRACTOR TO VERIFY CONDITION AND PRESSURE TEST EXISTING VALVE PRIOR TO CONNECTION. IF VALVE DOES NOT HOLD REQUIRED PRESSURE TEST ADDITIONAL VALVE WILL BE REQUIRED AT DEVELOPERS/CONTRACTOR'S EXPENSE.

OUW BACKFLOW PREVENTION REQUIREMENTS:

BACKFLOW DEVICES WILL BE OWNED AND MAINTAINED BY CUSTOMER UNLESS OTHERWISE NOTED. ANY QUESTIONS CONTACT OUC BACKFLOW PREVENTION DEPARTMENT AT 407-649-4436.

DOMESTIC AND IRRIGATION

THE DEVELOPER/CUSTOMER IS RESPONSIBLE FOR THE REQUIRED REDUCED PRESSURE BACKFLOW PREVENTER. RESIDENTIAL DOMESTIC BACKFLOW PREVENTERS ARE REQUIRED IN AREAS WHERE RECLAIMED OR OTHER WATER SUPPLY, I.E. WELL, IS PROVIDED TO THE SITE.

AS - BUILT DRAWINGS

THE CUSTOMER/DEVELOPER SHALL PROVIDE VERTICAL AND HORIZONTAL AS-BUILT INFORMATION RELATIVE TO ALL CONSTRUCTED UTILITIES AND STRUCTURES. THE SUBMITTAL WILL INCLUDE A SIGNED AND SEALED DRAWING AND A CD WITH THE AS BUILT INFORMATION IN AUTOCAD 2004 FORMAT.

STATE PLANE COORDINATES, EAST FLORIDA, NAD 1983-90 IS THE PREFERRED COORDINATE SYSTEM. IF A PROJECT COORDINATE SYSTEM IS USED, ALL DRAWINGS WILL BE BASED ON THIS SYSTEM AND EXISTING FEATURES I.E. EDGE OF PAVEMENT, ROAD INTERSECTIONS, BUILDINGS MUST BE REFERENCED TO AID IN THE LOCATING OF PROJECT INFRASTRUCTURE IN OUC'S GEOGRAPHIC INFORMATION SYSTEM. IF NO EXISTING FEATURES ARE SHOWN AT LEAST 2 STATE PLANE COORDINATE POINTS MUST BE SURVEYED AND BENCH MARKED.

AS-BUILT INFORMATION FOR THE WATER SYSTEM SHALL INCLUDE, BUT NOT BE LIMITED TO, THE FOLLOWING:

1. LOCATION OF ALL VALVES, FITTINGS, HYDRANTS, AND SERVICES.
2. LOCATION OF THE WATER MAIN TIED HORIZONTALLY TO THE BACK OF CURB OR EDGE OF PAVEMENT.
3. CERTIFICATION AS TO THE SYSTEM MEETING THE MINIMUM COVER REQUIREMENTS.
4. HORIZONTAL AND VERTICAL DATA FOR ANY CONSTRUCTION WHICH DEVIATES FROM THE APPROVED ENGINEERING PLANS.

THE CONTRACTOR SHALL CUT "W" IN THE TOP CURB OF EACH WATER SERVICE AND A "V" AT ALL VALVE LOCATIONS. CUT W'S AND V'S SHALL BE HIGHLIGHTED WITH BLUE PAINT.



REV	DATE	DESCRIPTION	BY
C	05/2019	ISSUED FOR BID	AJM
B	10/2018	90% DRAWINGS	AJM
A	08/2018	60% DRAWINGS	AJM

Issue Certification	
Melanie D. Peckham, P.E. Florida P.E. No. 66478	


Designed	ARS
Drawn	AJM
Checked	MDP
Reviewed	JRV
Approved	MDP
LINE IS 1" AT FULL SIZE	

ORANGE COUNTY
 R/R PACKAGE 22 PUMP STATIONS
 GENERAL
OUW GENERAL NOTES

PROJECT NO.: 110034	
SCALE: NOTED	REVISION: C
DRAWING NO. G400	SHEET NO.: 04 OF 47

REISS ENGINEERING, INC.
 1016 SPRING VILLAS PT.
 WINTER SPRINGS, FL 32708
 (407) 679-5358
 CERTIFICATE OF AUTH. 8181

Rev on: 5/17/2019 6:59 AM Individual File Path: R:\Projects\110034 - Orange County R-R Package 22 Pump Stations\Design\FinalDesign\1100.dwg
 Parent Sheet Set: 1100340C_PKG22PS Rev/Plot by: JAY MILLER

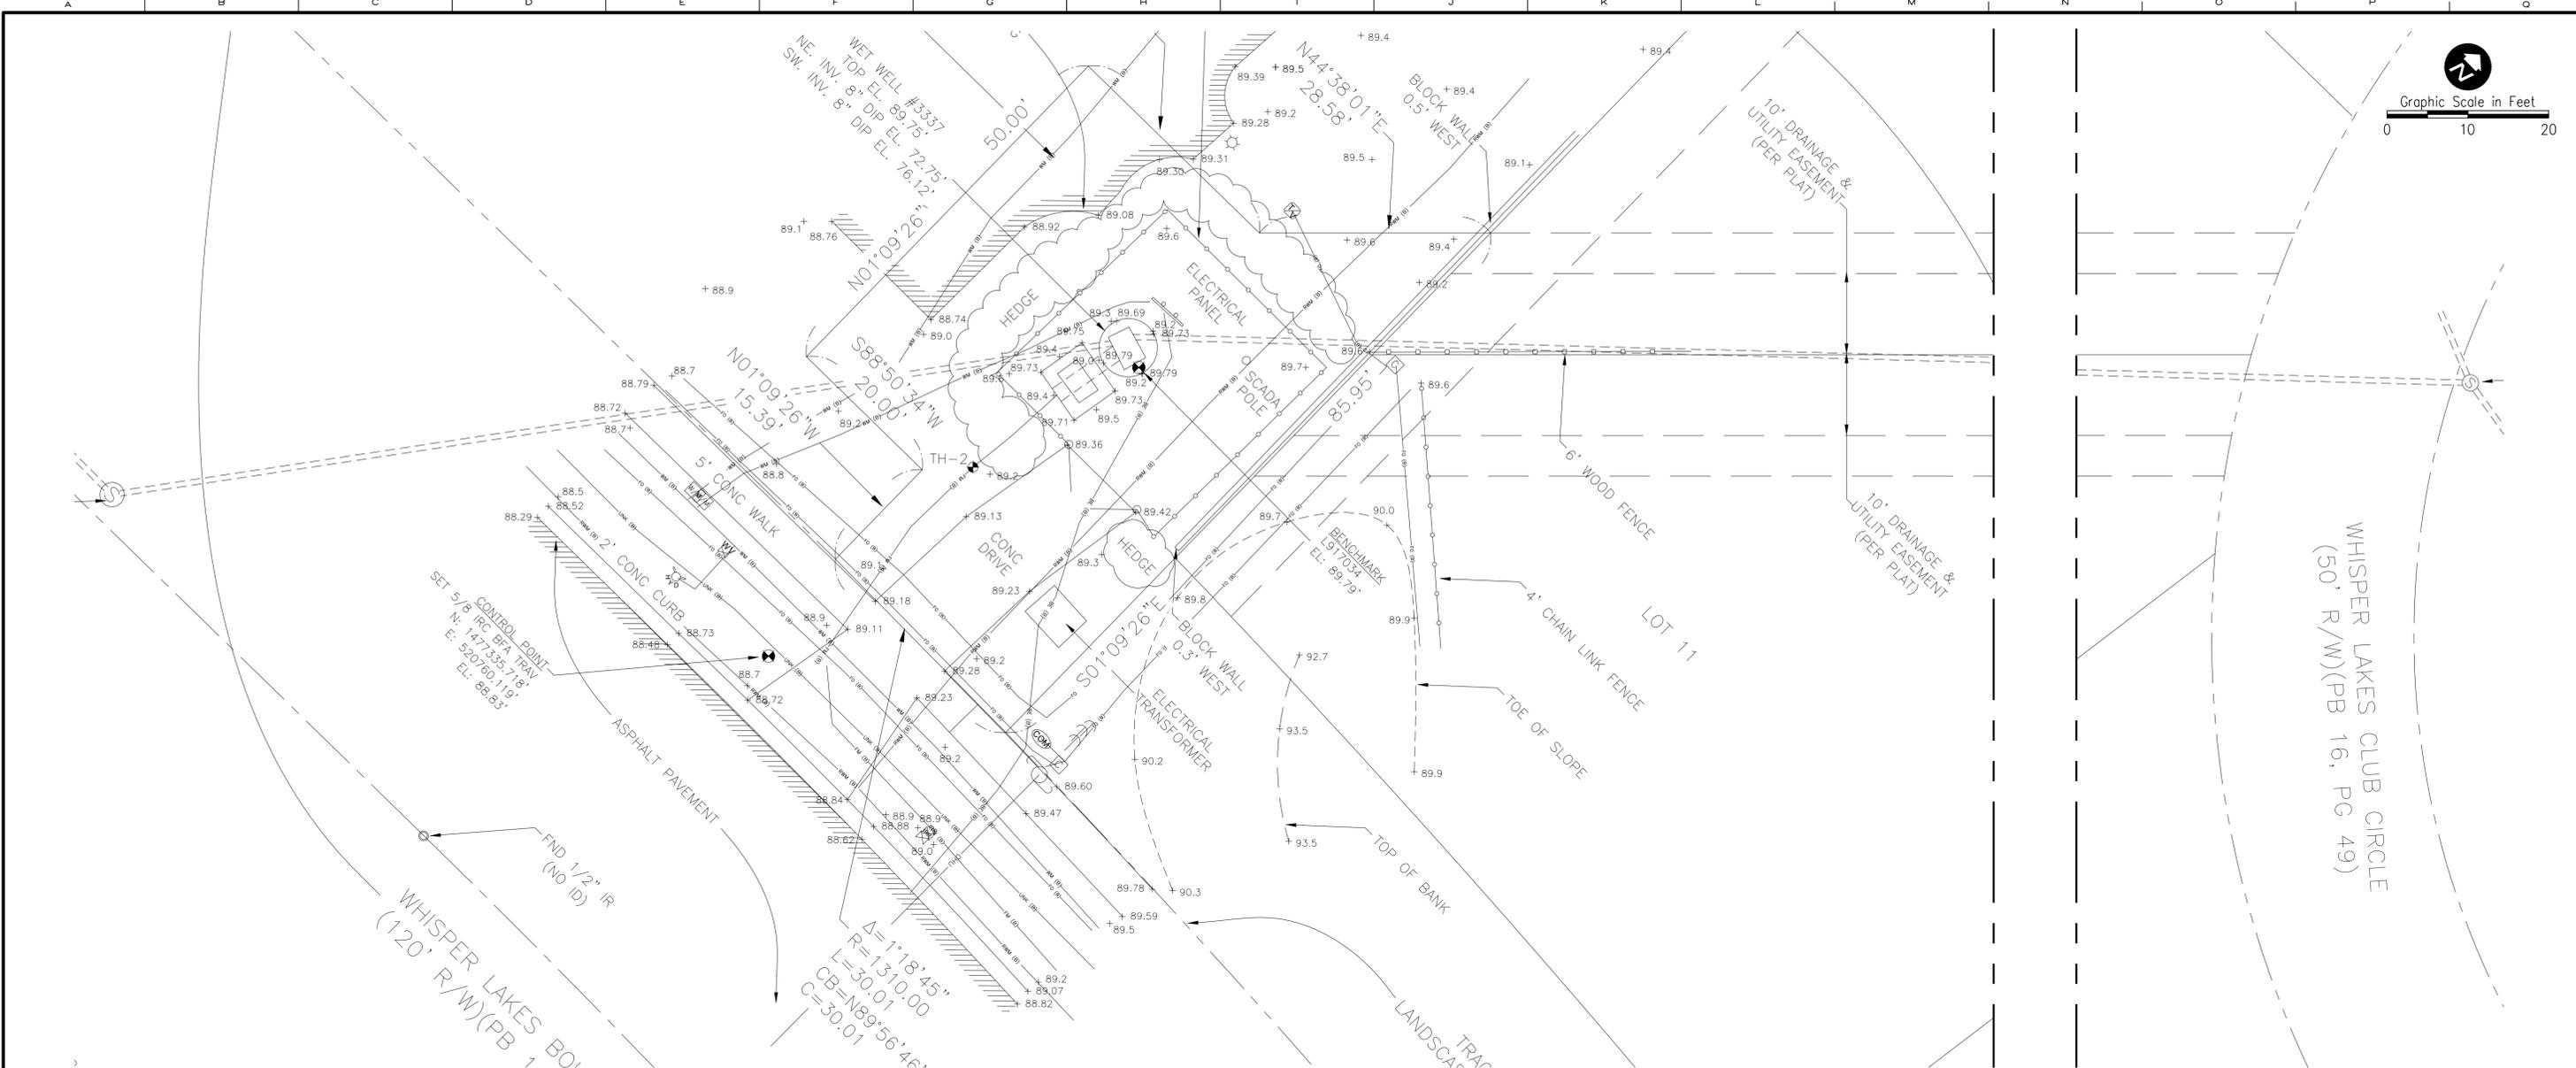

LEGEND

CONC	- CONCRETE
CPP	- CORRUGATED PLASTIC PIPE
RCP	- REINFORCED CONCRETE PIPE
INV	- INVERT
DE	- DRAINAGE EASEMENT
UE	- UTILITY EASEMENT
EL	- ELEVATION
PB	- PLAT BOOK
PC	- PAGE
PC	- POINT OF CURVATURE
ORB	- OFFICIAL RECORDS BOOK
R/W	- RIGHT OF WAY
IRC	- IRON ROD AND CAP
IP	- IRON PIPE
FND	- FOUND
LB	- LICENSED BUSINESS
ID	- IDENTIFICATION
WM	- WATER METER
WV	- WATER VALVE
IRV	- IRRIGATION VALVE
FH	- FIRE HYDRANT
EHH	- ELECTRIC HAND HOLE
THH	- TELEPHONE HAND HOLE
CB	- COMMUNICATIONS BOX
TSB	- TRAFFIC SIGNAL BOX
UP	- UTILITY POLE
LP	- LIGHT POLE
GLM	- GAS LINE MARKER
AVAC	- AVACADO

LEGEND

PVC	- POLYVINYL CHLORIDE
DIP	- DUCTILE IRON PIPE
PK	- PARKER KALON NAIL
ND	- NAIL AND DISK
PCP	- PERMANENT CONTROL POINT
DUE	- CABLE TV PEDESTAL DRAINAGE AND UTILITY EASEMENT
ARV	- AIR RELEASE VALVE
RMW	- RECLAIM WATER METER
RWM	- RECLAIM WATER VALVE
FRM	- RECLAIM WATER MARKER
FB	- FIBER OPTIC MARKER
TEP	- TELEPHONE PEDESTAL
CN	- CLEANOUT
MS	- METAL SIGN
MB	- MAIL BOX
ET	- ELECTRIC TRANSFORMER
EB	- ELECTRIC BOX
UNK	- UNKNOWN
OAK	- TREE (SIZE, TYPE)
OHU	- OVERHEAD UTILITY LINE
WM (B)	- WATER MAIN
RWM (B)	- RECLAIM WATER MAIN
FM (B)	- FORCE MAIN
BT (B)	- BURIED TELEPHONE LINE
BE (B)	- BURIED ELECTRICAL LINE
GC (B)	- BURIED GAS LINE

Surveyor's Notes

- This Topographic Survey is not valid unless signed and embossed with the raised seal of a Florida licensed Surveyor and Mapper.
- Bearings are based on the South Line of Whisper Lakes Boulevard, in the vicinity of this survey as being: N88°50'34"E. Coordinates are relative to the Florida State Plane Coordinate System, East Zone, North American Datum of 1983/2011 Adjustment.
- Elevations shown hereon are relative to North American Vertical Datum of 1988 (NAVD 88) with direct ties to the following published Orange County benchmarks:
 L917047 - Elevation 88.25'
 2" Orange County brass disc in pump sta. #3351 at intersection of Whisper Lakes Blvd. and Athabasca St., north side of Whisper Lakes Blvd.
 L917034 - Elevation 89.793'
 2" Orange County brass disc in pump sta. #3337, north side of Whisper Lakes Blvd. and east of private recreation park.
- Last day in the field: December 18, 2017.
- Graphic symbols shown hereon may not be to scale.
- This Topographic Survey is certified true and correct to: Orange County Utilities.

Location ID	Horizontal Coordinates	Elevation (ft)	(Presumed) Utility Owner	Size, Material & Type
TH-2	N 1477370.08 E 520761.29	85.12'	OCU	6" Blue PVC Force Main
ALL ELEVATIONS ARE TO TOP OF UTILITY				
Field work performed July 2, 2018				
PVC Polyvinyl Chloride				
TH-# Test Hole #				

Legal Description

Tract K, Whisper Lakes Unit 7, according to the plat recorded in Plat Book 16, Pages 49 and 50, Public Records of Orange County, Florida.

TOPOGRAPHIC SURVEY
PUMP STATION #3337
SECTION 16, TOWNSHIP 24 SOUTH, RANGE 29 EAST
ORANGE COUNTY, FLORIDA.



REV	DATE	DESCRIPTION	BY
C	05/2019	ISSUED FOR BID	AJM
B	10/2018	90% DRAWINGS	AJM
A	08/2018	60% DRAWINGS	AJM

Issue Certification

Designed	ARS
Drawn	AJM
Checked	MDP
Reviewed	JRV
Approved	MDP

William L. Miller, PLS
Florida Surveyor and Mapper LSS010

ORANGE COUNTY
R/R PACKAGE 22 PUMP STATIONS
SURVEY

PUMP STATION 3337 - WHISPER LAKES 7
BOUNDARY SURVEY & TOPOGRAPHIC SURVEY

PROJECT NO.:	110034
SCALE:	NOTED
REVISION:	C
DRAWING NO.:	V100
SHEET NO.:	05 OF 47



Parent Sheet Set: 1100340C_PKG22PS Rev/Plot by: JAY MILLER
 Rev on: 5/15/2019 12:53 PM
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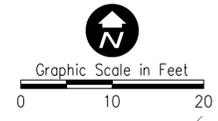
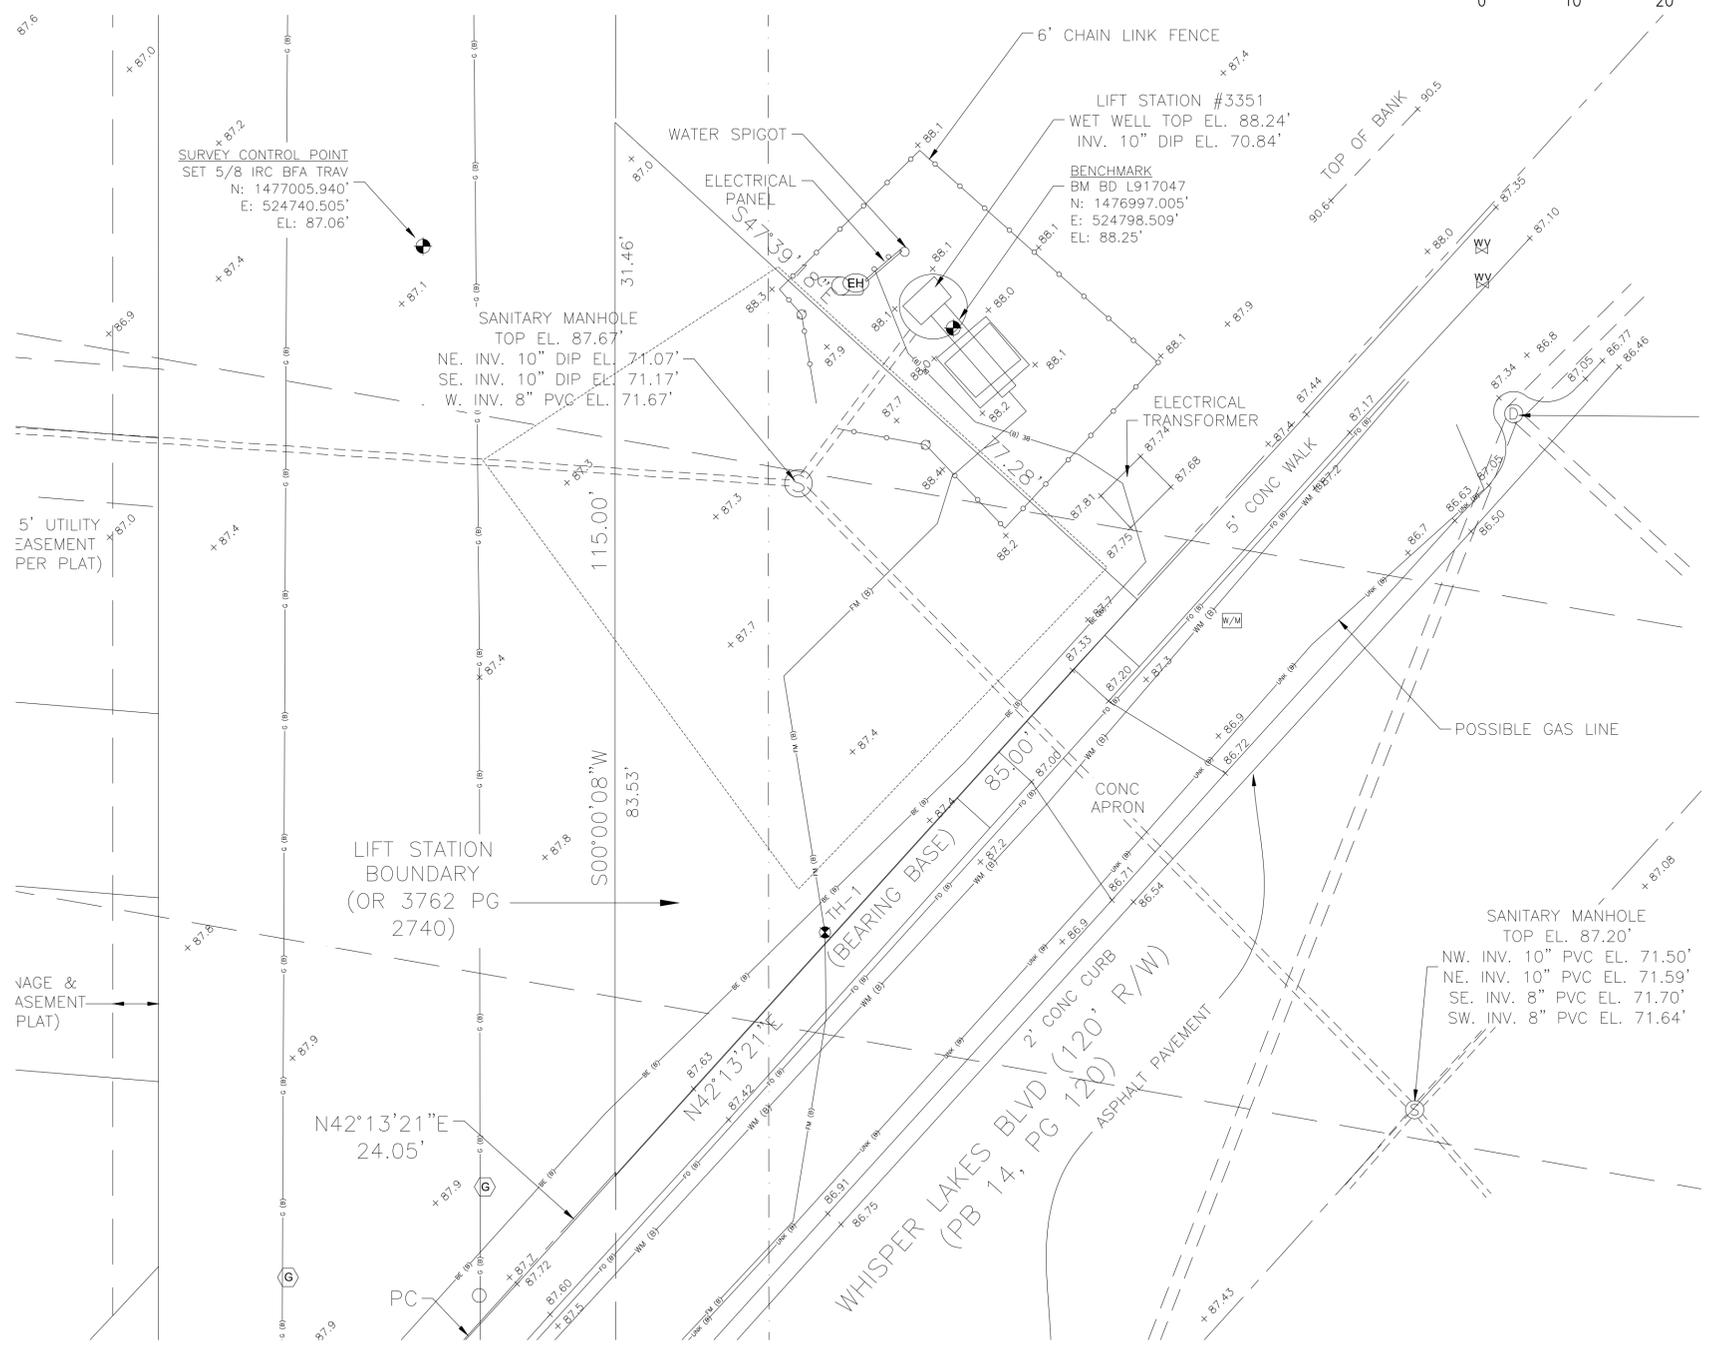
Surveyor's Notes

- This Topographic Survey is not valid unless signed and embossed with the raised seal of a Florida licensed Surveyor and Mapper.
- Lands were not researched by this firm for matters such as ownership, easements, right of way or other matters in the public records that may affect these lands. A title report was not provided for this survey.
- Bearings are based on the Northerly Right of Way Line of Whisper Lakes Boulevard in the vicinity of this survey as being South 42°13'21" West. Coordinates are relative to the Florida State Plane Coordinate System, East Zone, North American Datum of 1983/1990 Adjustment.
- Elevations shown hereon are relative to North American Vertical Datum of 1988 (NAVD 88) with direct ties to the following published Orange County benchmark:
 - L917047 - Elevation 88.25'
2" Orange County brass disc in pump sta. #3351 at intersection of Whisper Lakes Blvd. and Athabasca St., north side of Whisper Lakes Blvd.
 - L917034 - Elevation 89.793'
2" Orange County brass disc in pump sta. #3337, north side of Whisper Lakes Blvd. and east of private recreation park.
- Last day in the field: December 19, 2017.
- Graphic symbols shown hereon may not be to scale.
- This Topographic Survey is certified true and correct to: Orange County Utilities.
- Apparent Right of Way line determination is based on recovered monumentation in the area of this survey, and information provided by others.

LEGEND

- | | |
|--|---|
| <ul style="list-style-type: none"> CONC - CONCRETE CPP - CORRUGATED PLASTIC PIPE RCP - REINFORCED CONCRETE PIPE INV - INVERT DE - DRAINAGE EASEMENT UE - UTILITY EASEMENT EL - ELEVATION PB - PLAT BOOK PG - PAGE PC - POINT OF CURVATURE ORB - OFFICIAL RECORDS BOOK R/W - RIGHT OF WAY IRC - IRON ROD AND CAP IP - IRON PIPE FND - FOUND LB - LICENSED BUSINESS ID - IDENTIFICATION WM - WATER METER WV - WATER VALVE IRV - IRRIGATION VALVE FH - FIRE HYDRANT EH - ELECTRIC HAND HOLE TH - TELEPHONE HAND HOLE CB - COMMUNICATIONS BOX TSB - TRAFFIC SIGNAL BOX UP - UTILITY POLE LP - LIGHT POLE GLM - GAS LINE MARKER | <ul style="list-style-type: none"> PVC - POLYVINYL CHLORIDE DIP - DUCTILE IRON PIPE PK - PARKER KALON NAIL ND - NAIL AND DISK PCP - PERMANENT CONTROL POINT CPT - CABLE TV PEDESTAL DUE - DRAINAGE AND UTILITY EASEMENT ARV - AIR RELEASE VALVE RWM - RECLAIM WATER METER RWV - RECLAIM WATER VALVE RWM - RECLAIM WATER MARKER FOM - FIBER OPTIC MARKER TP - TELEPHONE PEDESTAL CN - CLEANOUT MS - METAL SIGN MB - MAIL BOX ET - ELECTRIC TRANSFORMER EB - ELECTRIC BOX UNK - UNKNOWN TR - TREE (SIZE, TYPE) OHL - OVERHEAD UTILITY LINE WM (B) - WATER MAIN RWM (B) - RECLAIM WATER MAIN FM (B) - FORCE MAIN BT (B) - BURIED TELEPHONE LINE BE (B) - BURIED ELECTRICAL LINE G (B) - BURIED GAS LINE |
|--|---|

Location ID	Horizontal Coordinates	Elevation (ft)	(Presumed) Utility Owner	Size, Material & Type
TH-1	N 1476931.06 E 524784.48	83.64'	OCU	6" White PVC Force Main
ALL ELEVATIONS ARE TO TOP OF UTILITY				
Field work performed July 2				
PVC Polyvinyl Chloride				
TH# Test Hole #				



TOPOGRAPHIC SURVEY
 PUMP STATION #3351
 SECTION 16, TOWNSHIP 24 SOUTH, RANGE 29 EAST
 ORANGE COUNTY, FLORIDA.



REV	DATE	DESCRIPTION	BY
C	05/2019	ISSUED FOR BID	AJM
B	10/2018	90% DRAWINGS	AJM
A	08/2018	60% DRAWINGS	AJM

Issue Certification

William L. Miller, PLS
Florida Surveyor and Mapper LSS010

Designed ARS
 Drawn AJM
 Checked MDP
 Reviewed JRV
 Approved MDP

ORANGE COUNTY
 R/R PACKAGE 22 PUMP STATIONS
 SURVEY
PUMP STATION 3351 - WHISPER LAKES 4
BOUNDARY SURVEY & TOPOGRAPHIC SURVEY

PROJECT NO.: 110034	
SCALE: NOTED	REVISION: C
DRAWING NO. V200	SHEET NO.: 06 OF 47



Rev on: 5/15/2019 12:54 PM Individual File Path: R:\Projects\110034 - Orange County R-R Package 22 Pump Stations\Design\Drawings\FinalDesign\V300.dwg

Surveyor's Notes

- This Topographic Survey is not valid unless signed and embossed with the raised seal of a Florida licensed Surveyor and Mapper.
- Bearings are based on the West Line Uracus Steert, in the vicinity of this survey as being: N00°01'34"W. Coordinates are relative to the Florida State Plane Coordinate System, East Zone, North American Datum of 1983/ 2011 Adjustment.
- Elevations shown hereon are relative to North American Vertical Datum of 1988 (NAVD 88) with direct ties to the following published Orange County benchmarks:

L917009 - Elevation 88.519'
2" Orange County brass disc in Northwest corner of drop-inlet, 6m. Northwest of c/l of Molucca Ct. between address #12000 and 12017 Molucca Ct.

L917008 - Elevation 88.165'
2" Orange County brass disc in Northwest corner of drop inlet 6m West of c/l of Molucca Ct. and 7.5m north of Peppermill Blvd.

- Last day in the field: December 14, 2017.
- Graphic symbols shown hereon may not be to scale.
- This Topographic Survey is certified true and correct to: Orange County Utilities.



LEGEND

- CONC - CONCRETE
- CPP - CORRUGATED PLASTIC PIPE
- RCP - REINFORCED CONCRETE PIPE
- INV - INVERT
- DE - DRAINAGE EASEMENT
- UE - UTILITY EASEMENT
- EL - ELEVATION
- PB - PLAT BOOK
- PC - PAGE
- PC - POINT OF CURVATURE
- ORB - OFFICIAL RECORDS BOOK
- R/W - RIGHT OF WAY
- IRC - IRON ROD AND CAP
- IP - IRON PIPE
- FND - FOUND
- LB - LICENSED BUSINESS
- ID - IDENTIFICATION
- WM - WATER METER
- WV - WATER VALVE
- IRV - IRRIGATION VALVE
- FH - FIRE HYDRANT
- EH - ELECTRIC HAND HOLE
- TH - TELEPHONE HAND HOLE
- CB - COMMUNICATIONS BOX
- TSB - TRAFFIC SIGNAL BOX
- UP - UTILITY POLE
- LP - LIGHT POLE
- GLM - GAS LINE MARKER
- AVAC - AVACADO

LEGEND

- PVC - POLYVINYL CHLORIDE
- DIP - DUCTILE IRON PIPE
- PK - PARKER KALON NAIL
- ND - NAIL AND DISK
- PCP - PERMANENT CONTROL POINT
- GTP - GABLE TV PEDESTAL
- DUE - DRAINAGE AND UTILITY EASEMENT
- ARV - AIR RELEASE VALVE
- RCW - RECLAIM WATER METER
- RWV - RECLAIM WATER VALVE
- RWM - RECLAIM WATER MARKER
- FOM - FIBER OPTIC MARKER
- TEP - TELEPHONE PEDESTAL
- CLEANOUT - CLEANOUT
- MS - METAL SIGN
- MB - MAIL BOX
- ET - ELECTRIC TRANSFORMER
- EB - ELECTRIC BOX
- UNK - UNKNOWN
- OHU - OVERHEAD UTILITY LINE
- WM (B) - WATER MAIN
- RWM (B) - RECLAIM WATER MAIN
- FM (B) - FORCE MAIN
- BT (B) - BURIED TELEPHONE LINE
- BE (B) - BURIED ELECTRICAL LINE
- CG (B) - BURIED GAS LINE

Location ID	Horizontal Coordinates	Elevation (ft)	(Presumed) Utility Owner	Size, Material & Type
TH-4	N 1474229.64 E 521976.70	87.66'	OCU	6" White PVC Force Main
ALL ELEVATIONS ARE TO TOP OF UTILITY				
Field work performed July 3, 2018				
PVC Polyvinyl Chloride				
TH-# Test Hole #				

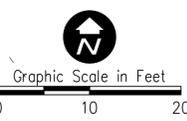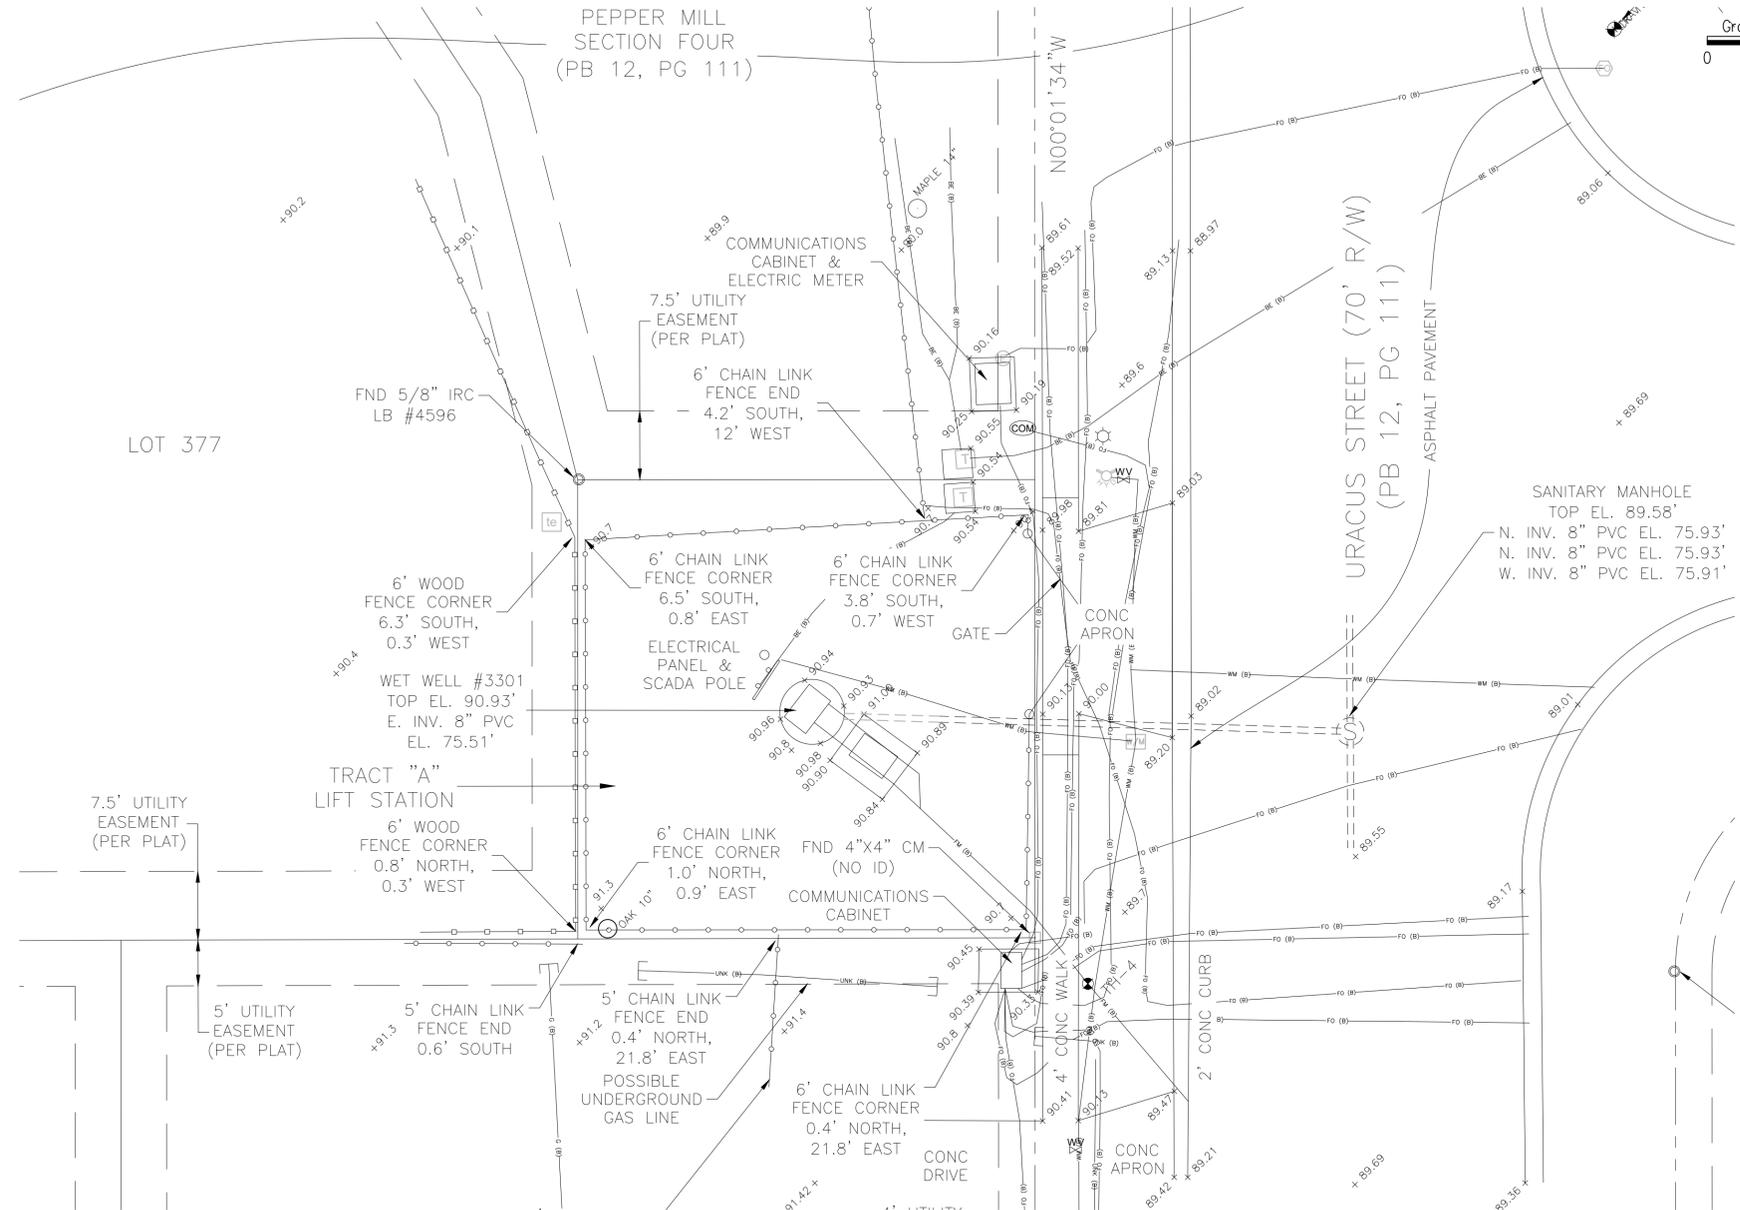

TOPOGRAPHIC SURVEY
PUMP STATION #3301
SECTION 16, TOWNSHIP 24 SOUTH, RANGE 29 EAST
ORANGE COUNTY, FLORIDA.



REV	DATE	DESCRIPTION	BY
C	05/2019	ISSUED FOR BID	AJM
B	10/2018	90% DRAWINGS	AJM
A	08/2018	60% DRAWINGS	AJM

Issue Certification

William L. Miller, PLS
Florida Surveyor and Mapper LSS010

Designed: ARS
Drawn: AJM
Checked: MDP
Reviewed: JRV
Approved: MDP

LINE IS 1" AT FULL SIZE

ORANGE COUNTY
R/R PACKAGE 22 PUMP STATIONS
SURVEY


PUMP STATION 3301 - PEPPER MILL 4
BOUNDARY SURVEY & TOPOGRAPHIC SURVEY

PROJECT NO.: 110034	
SCALE: NOTED	REVISION: C
DRAWING NO. V300	SHEET NO.: 07 OF 47

RE

REISS ENGINEERING, INC.
1016 SPRING VILLAS PT.
WINTER SPRINGS, FL 32708
(407) 679-5358
CERTIFICATE OF AUTH. 8181

Parent Sheet Set: 1100340C_PK022PS Rev/Plot by: JAY MILLER
 Rev on: 5/15/2019 12:54 PM Individual File Path: R:\Projects\110034 - Orange County R-R Package 22 Pump Stations\Design\FinalDesign\V400.dwg

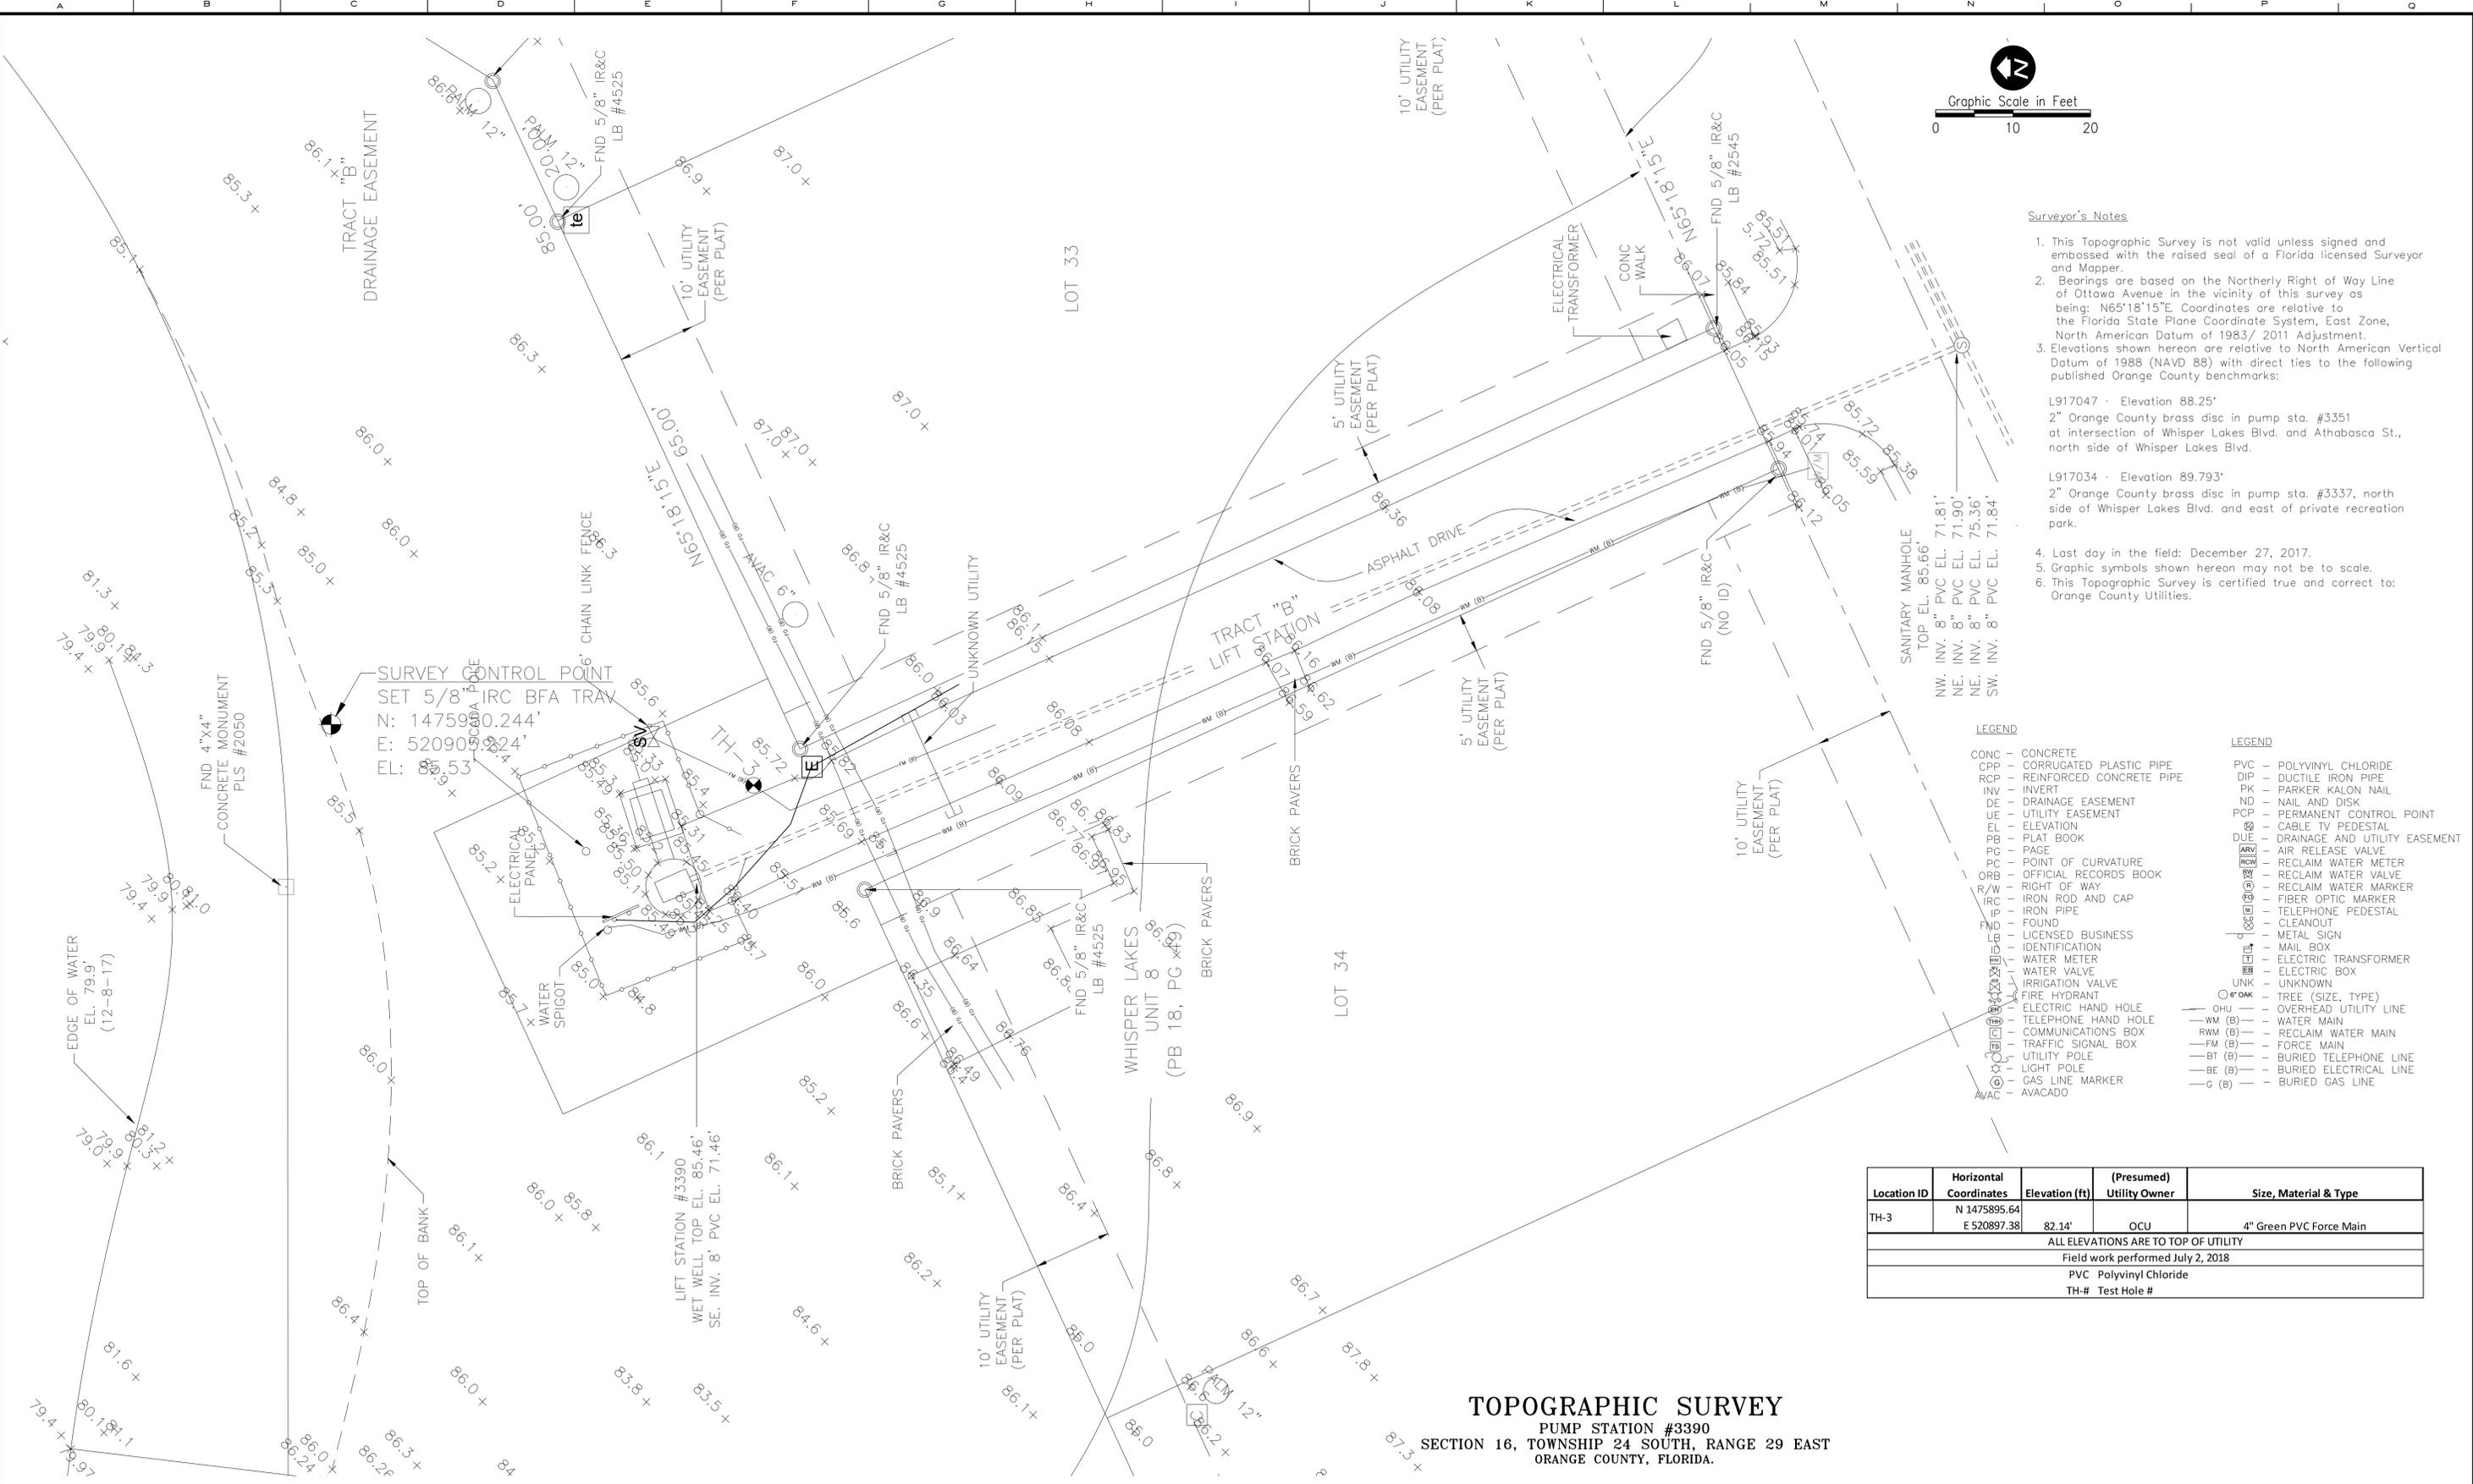

Location ID	Horizontal Coordinates	Elevation (ft)	(Presumed) Utility Owner	Size, Material & Type
TH-3	N 1475895.64 E 520897.38	82.14'	OCU	4" Green PVC Force Main
ALL ELEVATIONS ARE TO TOP OF UTILITY				
Field work performed July 2, 2018				
PVC Polyvinyl Chloride				
TH-# Test Hole #				

TOPOGRAPHIC SURVEY
 PUMP STATION #3390
 SECTION 16, TOWNSHIP 24 SOUTH, RANGE 29 EAST
 ORANGE COUNTY, FLORIDA.



REV	DATE	DESCRIPTION	BY
C	05/2019	ISSUED FOR BID	AJM
B	10/2018	90% DRAWINGS	AJM
A	08/2018	60% DRAWINGS	AJM

Issue Certification

Designed	ARS
Drawn	AJM
Checked	MDP
Reviewed	JRV
Approved	MDP

William L. Miller, PLS
Florida Surveyor and Mapper LSS010

Scale: 1" = 40'

Graphic Scale: 1" = 40'

ORANGE COUNTY
 R/R PACKAGE 22 PUMP STATIONS
 SURVEY
PUMP STATION 3390 - WHISPER LAKES 8
BOUNDARY SURVEY & TOPOGRAPHIC SURVEY

PROJECT NO.: 110034

SCALE: NOTED



DRAWING NO.: V400

REVISION: C

SHEET NO.: 08 OF 47

REISS ENGINEERING, INC.
 1016 SPRING VILLAS PT.
 WINTER SPRINGS, FL 32708
 (407) 679-5358
 CERTIFICATE OF AUTH. 8181

Parent Sheet Set: 11003400_PK022PS Rev/Plot by: JAY MILLER Rev on: 5/15/2019 12:55 PM Individual File Path: R:\Projects\110034 - Orange County R-R Package 22 Pump Stations\Design\FinalDesign\V500.dwg

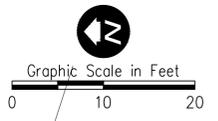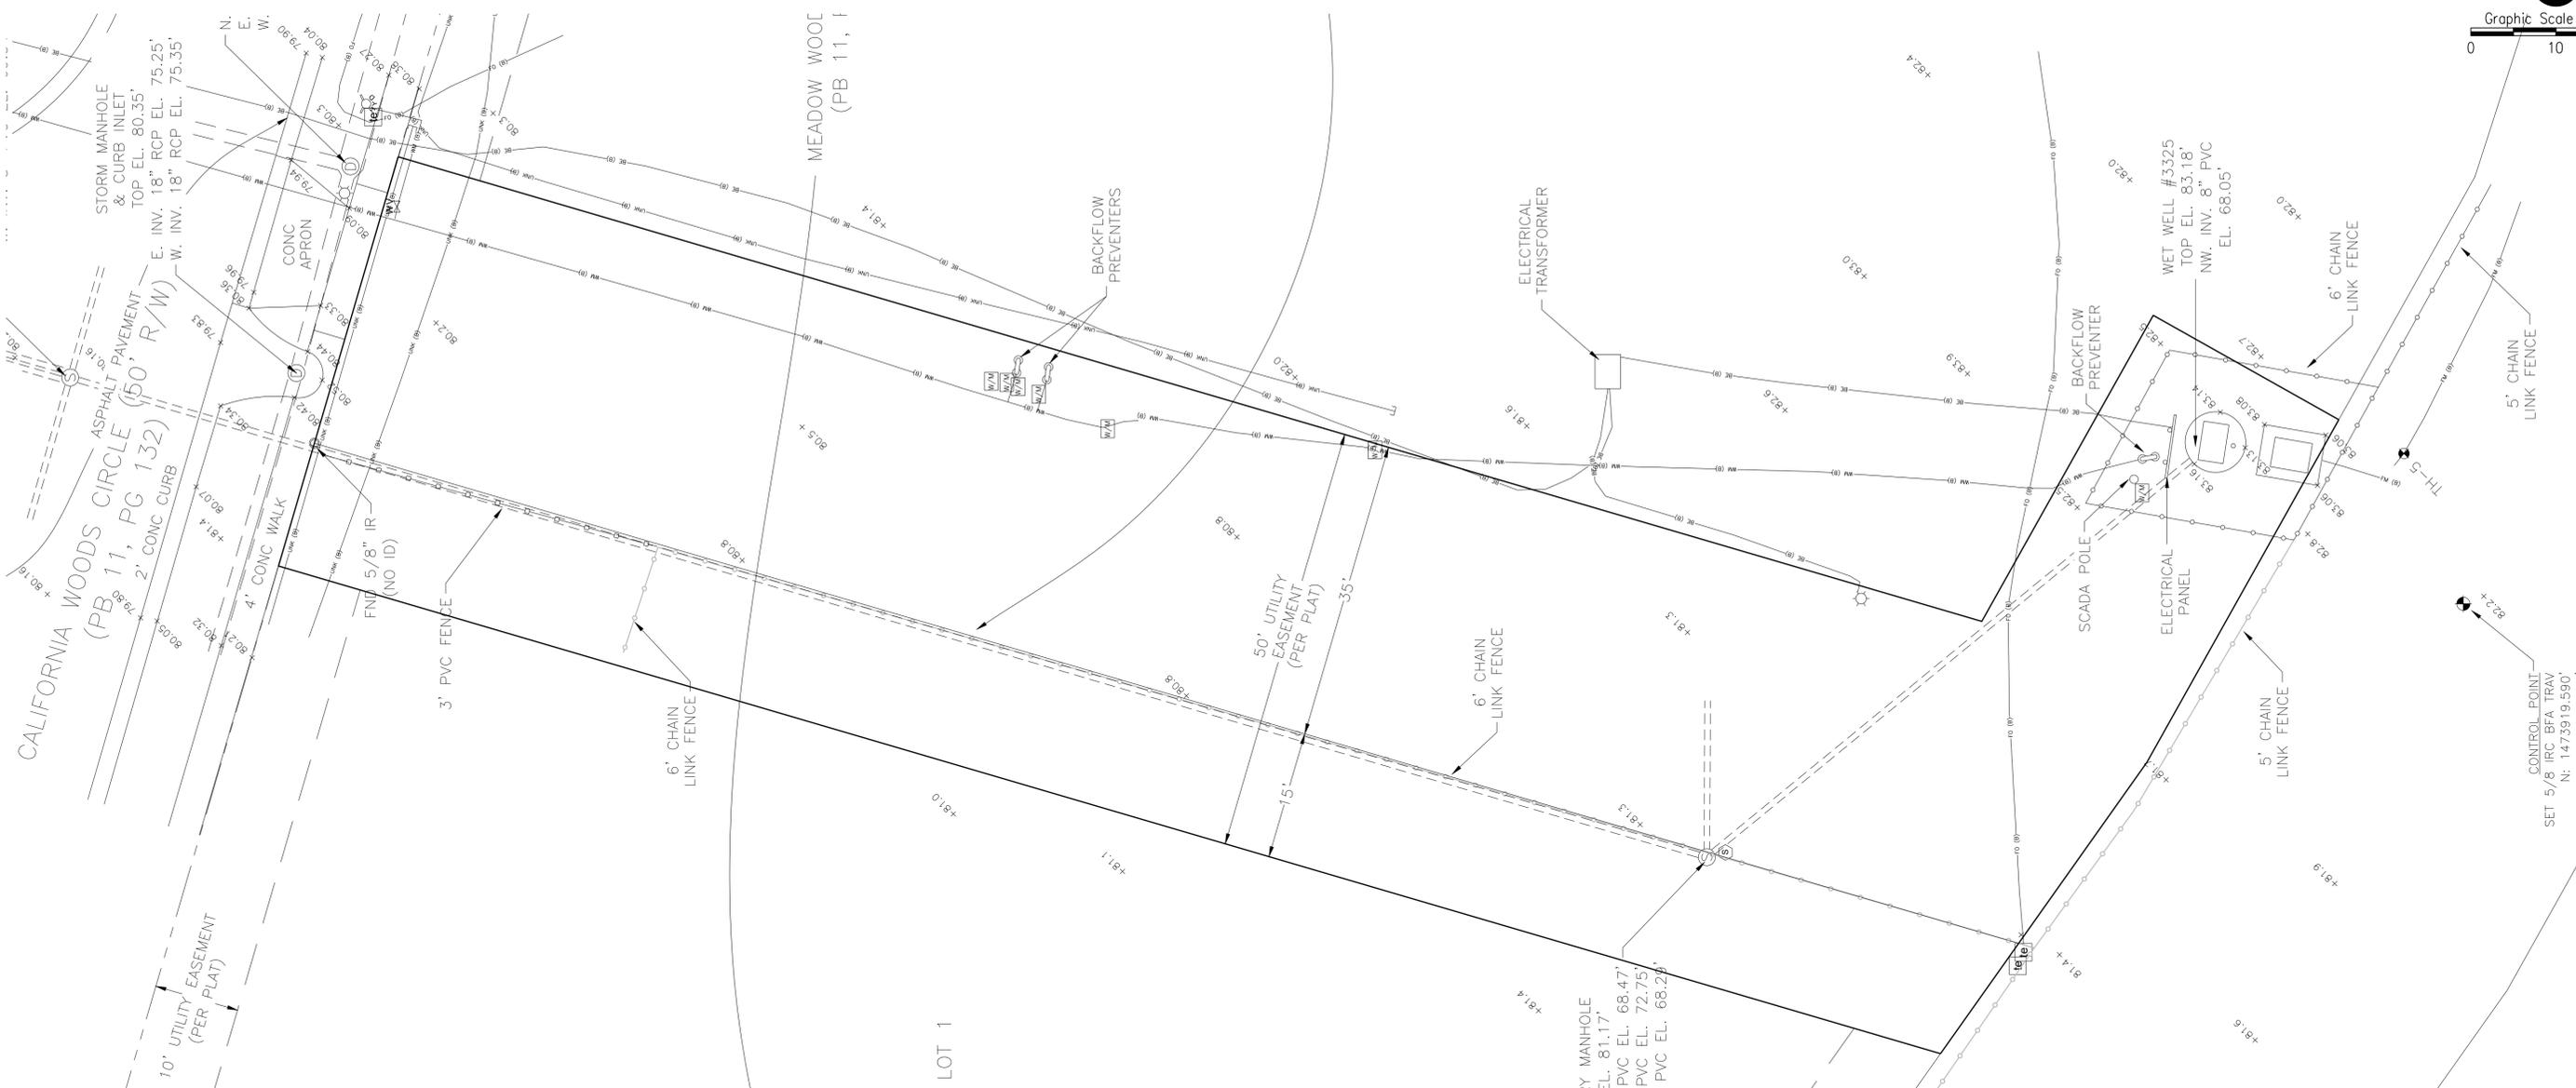

LEGEND

- CONC - CONCRETE
- CPP - CORRUGATED PLASTIC PIPE
- RCP - REINFORCED CONCRETE PIPE
- INV - INVERT
- DE - DRAINAGE EASEMENT
- UE - UTILITY EASEMENT
- ELEV - ELEVATION
- PB - PLAT BOOK
- PG - PAGE
- PC - POINT OF CURVATURE
- ORB - OFFICIAL RECORDS BOOK
- R/W - RIGHT OF WAY
- IRC - IRON ROD AND CAP
- IP - IRON PIPE
- FND - FOUND
- LB - LICENSED BUSINESS IDENTIFICATION
- WM - WATER METER
- WV - WATER VALVE
- IRV - IRRIGATION VALVE
- FH - FIRE HYDRANT
- EH - ELECTRIC HAND HOLE
- TH - TELEPHONE HAND HOLE
- CB - COMMUNICATIONS BOX
- TSB - TRAFFIC SIGNAL BOX
- UP - UTILITY POLE
- LP - LIGHT POLE
- GLM - GAS LINE MARKER
- AVAC - AVACADO

LEGEND

- PVC - POLYVINYL CHLORIDE
- DIP - DUCTILE IRON PIPE
- PK - PARKER KALON NAIL
- ND - NAIL AND DISK
- PCP - PERMANENT CONTROL POINT
- CD - CABLE TV PEDESTAL
- DUE - DRAINAGE AND UTILITY EASEMENT
- ARV - AIR RELEASE VALVE
- RWM - RECLAIM WATER METER
- RWV - RECLAIM WATER VALVE
- SM - SEWER MARKER
- FOM - FIBER OPTIC MARKER
- TP - TELEPHONE PEDESTAL
- C - CLEANOUT
- M - METAL SIGN
- MB - MAIL BOX
- ET - ELECTRIC TRANSFORMER
- EB - ELECTRIC BOX
- UNK - UNKNOWN
- OAK - TREE (SIZE, TYPE)
- OHU - OVERHEAD UTILITY LINE
- WM (B) - WATER MAIN
- RWM (B) - RECLAIM WATER MAIN
- FM (B) - FORCE MAIN
- BT (B) - BURIED TELEPHONE LINE
- BE (B) - BURIED ELECTRICAL LINE
- G (B) - BURIED GAS LINE

Surveyor's Notes

1. This Topographic Survey is not valid unless signed and embossed with the raised seal of a Florida licensed Surveyor and Mapper.
2. Coordinates are relative to the Florida State Plane Coordinate System, East Zone, North American Datum of 1983/ 2011 Adjustment.
3. Elevations shown hereon are relative to North American Vertical Datum of 1988 (NAVD 88) with direct ties to the following published Orange County benchmarks:

 L1495061 - Elevation 84.999'
 3 1/2" Orange County Public Works survey marker disc in curb inlet in c/l of Brindle St and +/-30 ft West of c/l of Ayres Drive.

 G1423005 - Elevation 86.852'
 2" Orange County brass disc in Northwest end of rub rail of bridge over crear. +/-20 ft west of c/l of Landstar Blvd. and +/-310 ft south of c/l of Wetherbee Rd.
4. Last day in the field: December 18, 2017.
5. Graphic symbols shown hereon may not be to scale.
6. This Topographic Survey is certified true and correct to: Orange County Utilities.

Location ID	Horizontal Coordinates	Elevation (ft)	(Presumed) Utility Owner	Size, Material & Type
TH-5	N 1473926.57 E 539896.20	78.47'	OCU	4" Cast Iron Force Main
ALL ELEVATIONS ARE TO TOP OF UTILITY				
Field work performed July 3, 2018				
PVC Polyvinyl Chloride				
TH-# Test Hole #				

TOPOGRAPHIC SURVEY
PUMP STATION #3325
SECTION 24, TOWNSHIP 24 SOUTH, RANGE 29 EAST
ORANGE COUNTY, FLORIDA.



REV	DATE	DESCRIPTION	BY
C	05/2019	ISSUED FOR BID	AJM
B	10/2018	90% DRAWINGS	AJM
A	08/2018	60% DRAWINGS	AJM

Issue Certification	
William L. Miller, PLS Florida Surveyor and Mapper LSS010	Designed <u>ARS</u> Drawn <u>AJM</u> Checked <u>MDP</u> Reviewed <u>JRV</u> Approved <u>MDP</u>



ORANGE COUNTY R/R PACKAGE 22 PUMP STATIONS SURVEY
PUMP STATION 3325 - MEADOW WOODS 1 BOUNDARY SURVEY & TOPOGRAPHIC SURVEY

PROJECT NO.: 110034	SCALE: NOTED
DRAWING NO.: V500	REVISION: C
SHEET NO.: 09 OF 47	



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Parent Sheet Set: 1100340C_PKG22PS Rev/Plot by: JAY MILLER Rev on: 4/12/2019 11:00 AM Individual File Path: R:\Projects\110034 - Orange County R-R Package 22 Pump Stations\Design\Drawings\FinalDesign\C100.dwg

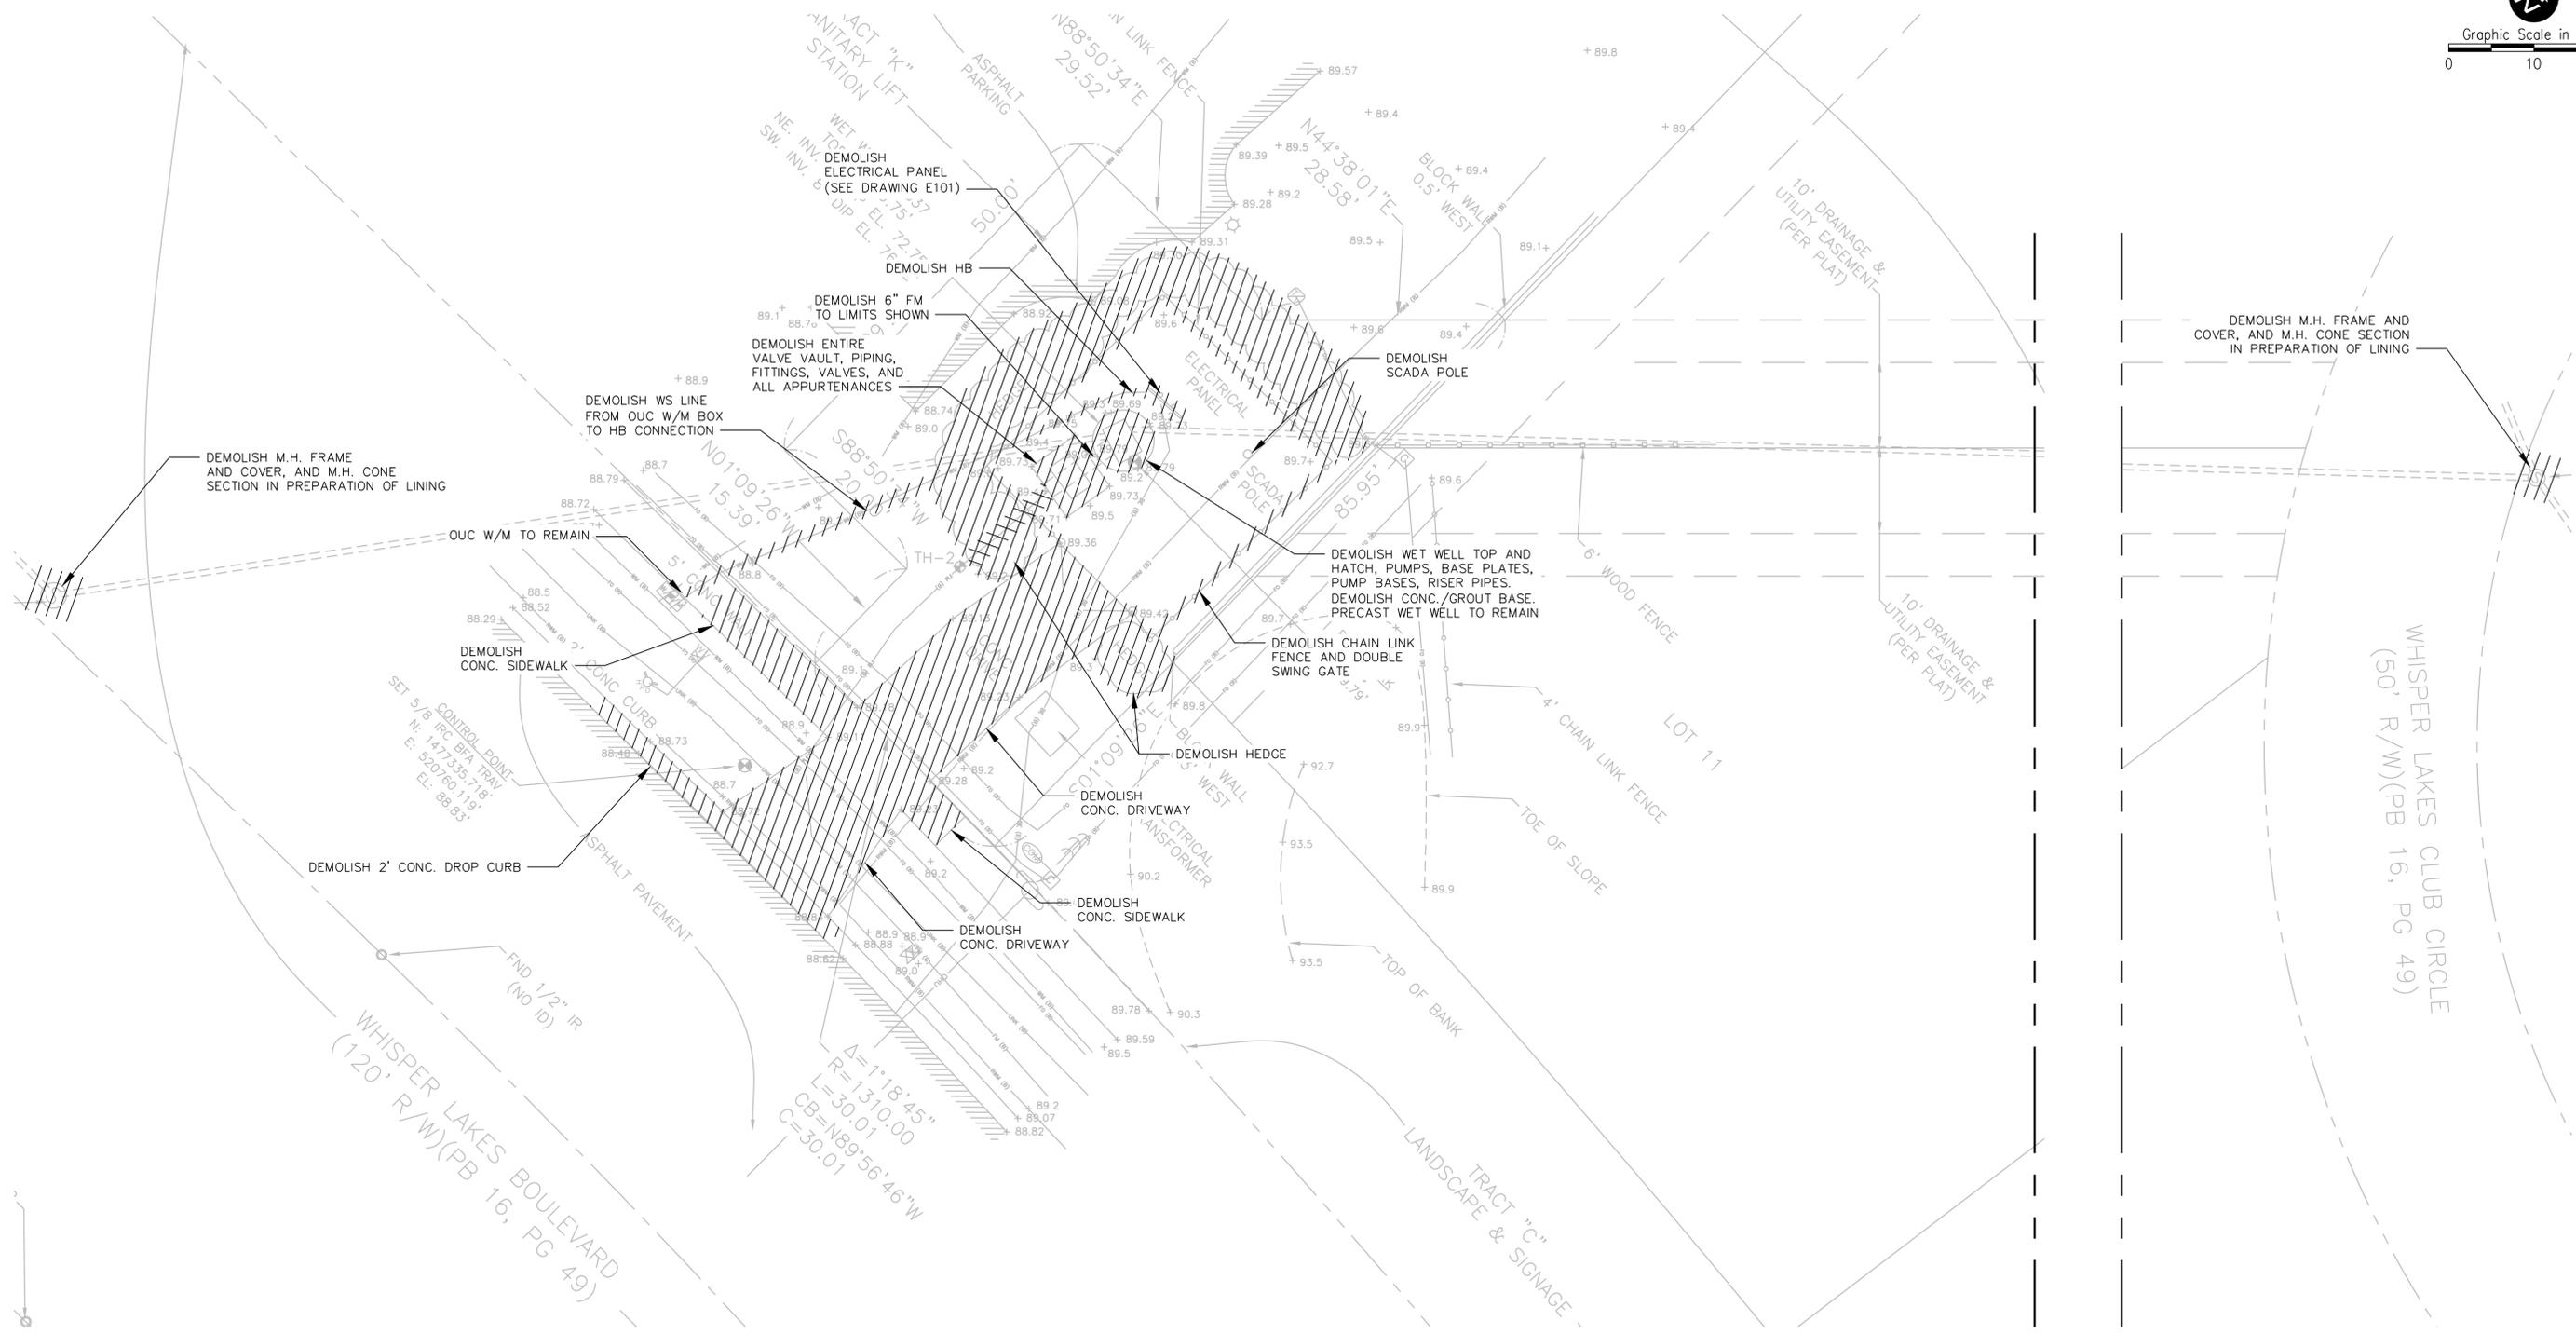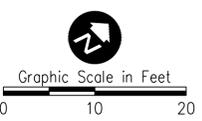

PS 3337 - WHISPER LAKES 7 DEMOLITION PLAN

NOTE:
SALVAGE AND/OR DISPOSAL OF ALL EXISTING
EQUIPMENT SHALL BE AT THE DIRECTION OF THE RPR.



REV	DATE	DESCRIPTION	BY
C	05/2019	ISSUED FOR BID	AJM
B	10/2018	90% DRAWINGS	AJM
A	08/2018	60% DRAWINGS	AJM

Issue Certification	
Designed	ARS
Drawn	AJM
Checked	MDP
Reviewed	JRV
Approved	MDP
Melanie D. Peckham, P.E. Florida P.E. No. 66478	


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ORANGE COUNTY
R/R PACKAGE 22 PUMP STATIONS
 CIVIL
PUMP STATION 3337 - WHISPER LAKES 7
DEMOLITION SITE PLAN

PROJECT NO.: 110034	
SCALE: NOTED	REVISION: C
DRAWING NO. C100	SHEET NO.: 10 OF 47

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 Rev on: 5/15/2019 2:16 PM
 Individual File Path: R:\Projects\110034 - Orange County R-R Package 22 Pump Stations\Design\FinalDesign\C101.dwg



PS 3337 - WHISPER LAKES 7 PROPOSED PLAN

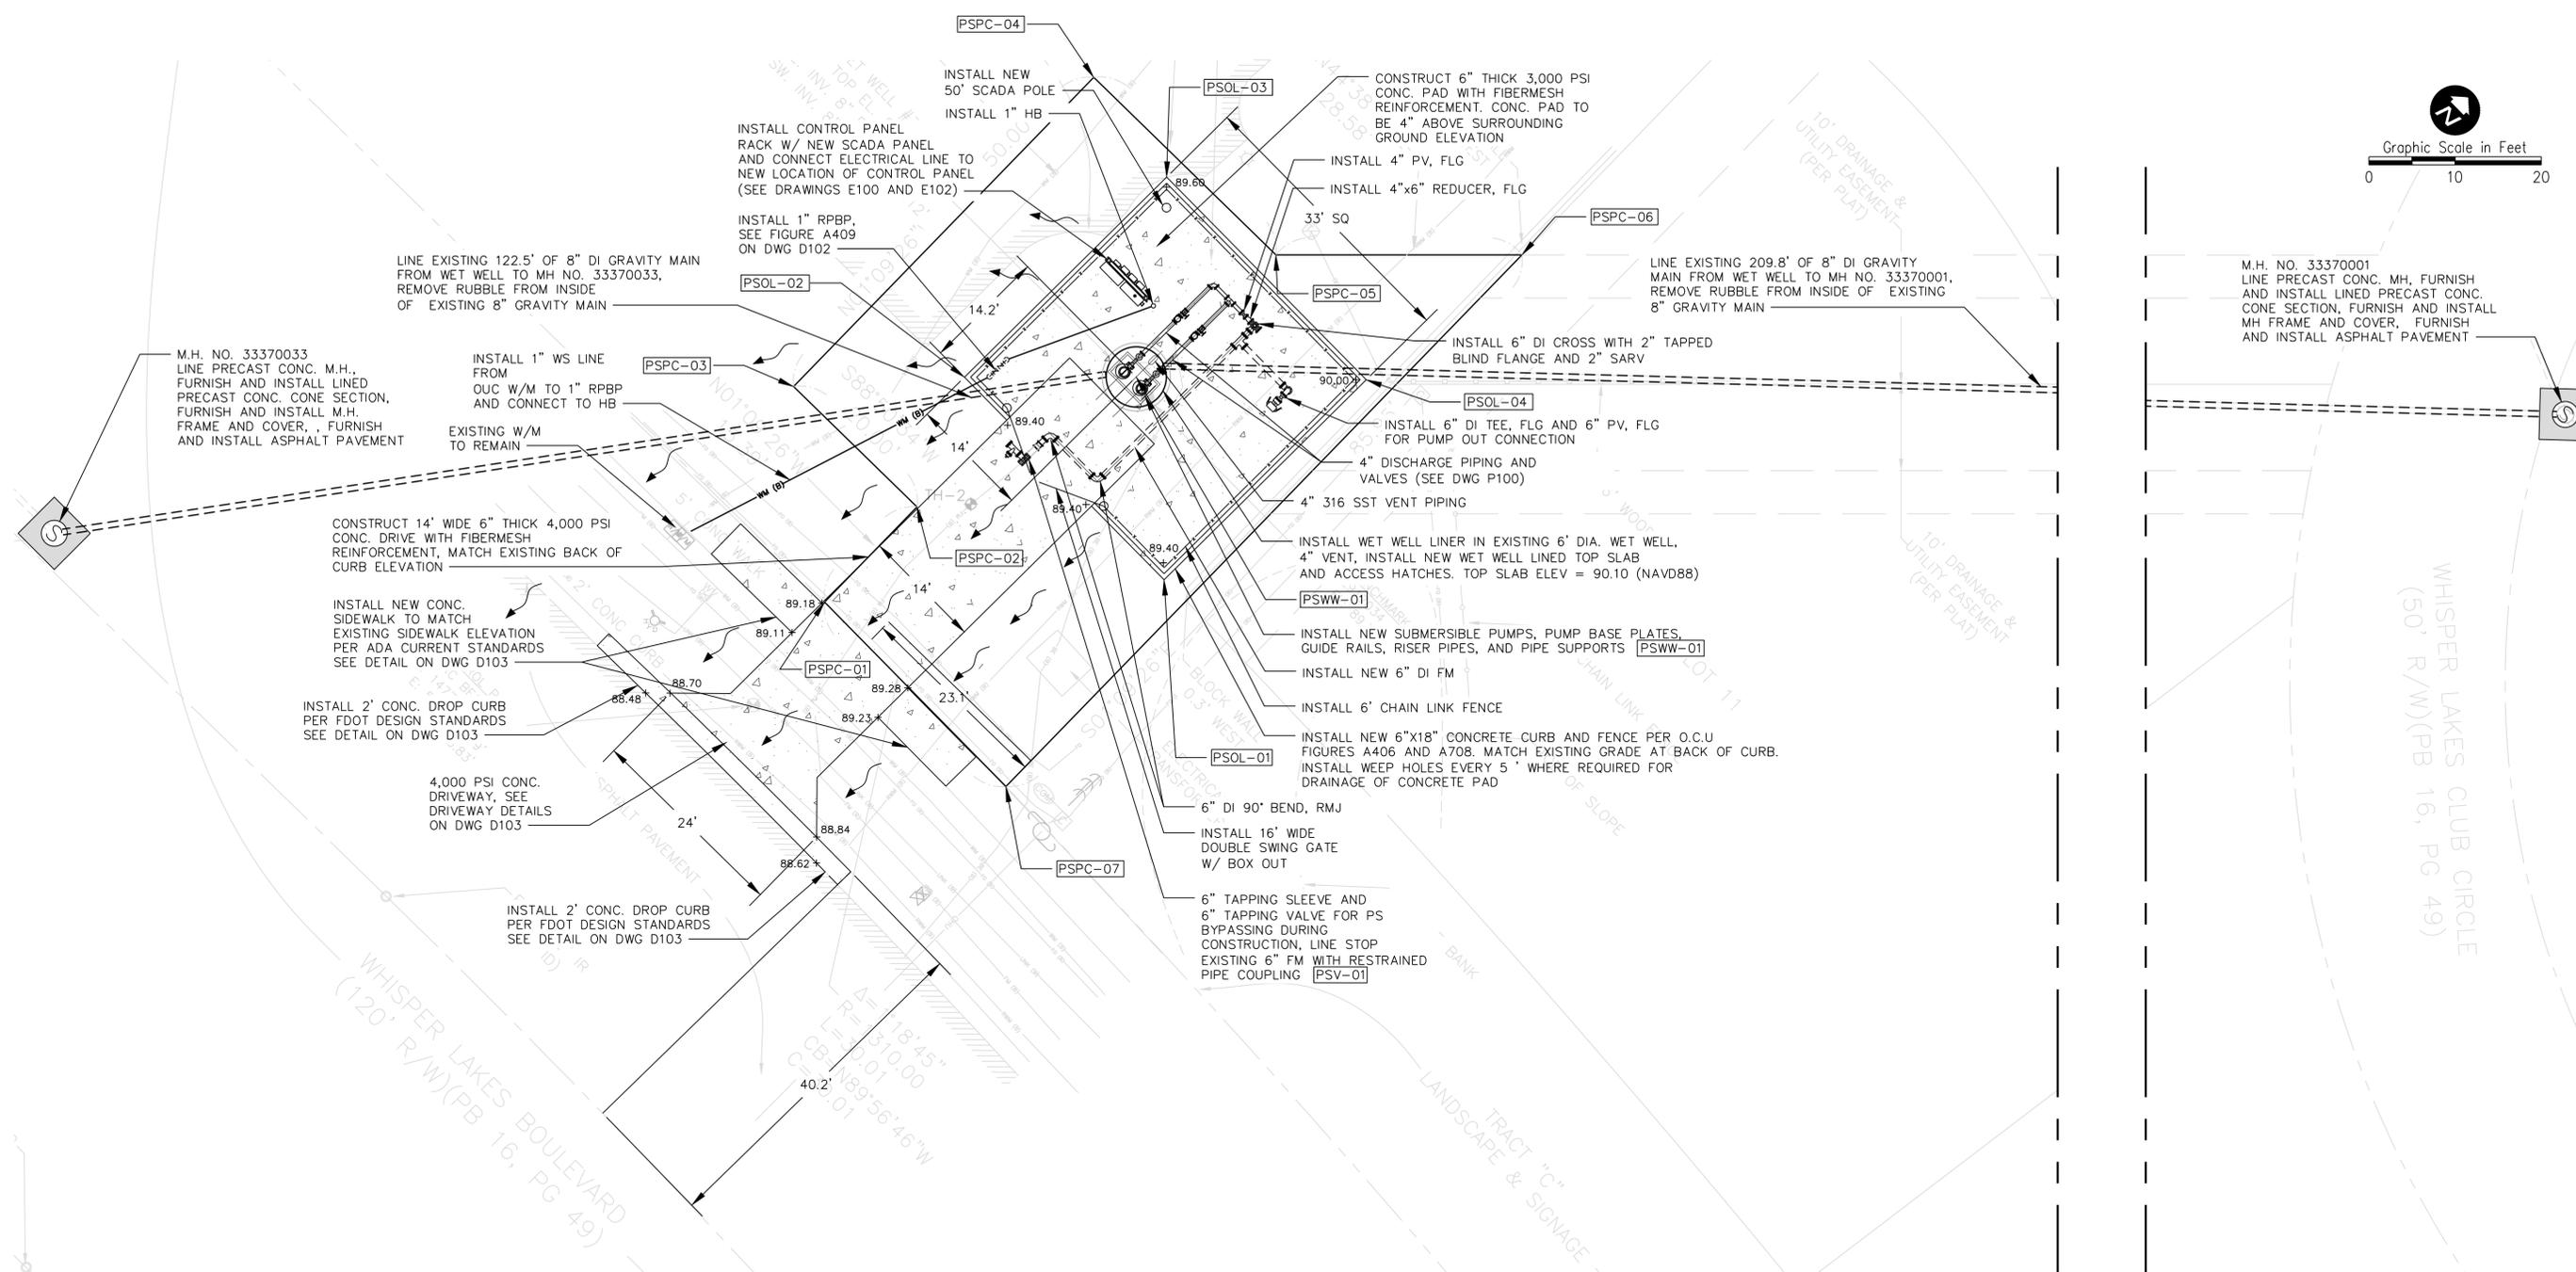

REV	DATE	DESCRIPTION	BY
C	05/2019	ISSUED FOR BID	AJM
B	10/2018	90% DRAWINGS	AJM
A	08/2018	60% DRAWINGS	AJM

Issue Certification	
Designed	ARS
Drawn	AJM
Checked	MDP
Reviewed	JRV
Approved	MDP
Melanie D. Peckham, P.E. Florida P.E. No. 66478	



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ORANGE COUNTY
 R/R PACKAGE 22 PUMP STATIONS
 CIVIL
PUMP STATION 3337 - WHISPER LAKES 7
 PROPOSED SITE PLAN

PROJECT NO.: 110034	
SCALE: NOTED	REVISION: C
DRAWING NO. C101	SHEET NO.: 11 OF 47

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 WINTER SPRINGS, FL 32708
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 Rev on: 4/12/2019 11:11 AM
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PS 3351 - WHISPER LAKES 4 DEMOLITION PLAN

NOTE:
SALVAGE AND/OR DISPOSAL OF ALL EXISTING EQUIPMENT SHALL BE AT THE DIRECTION OF THE RPR.

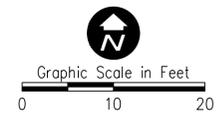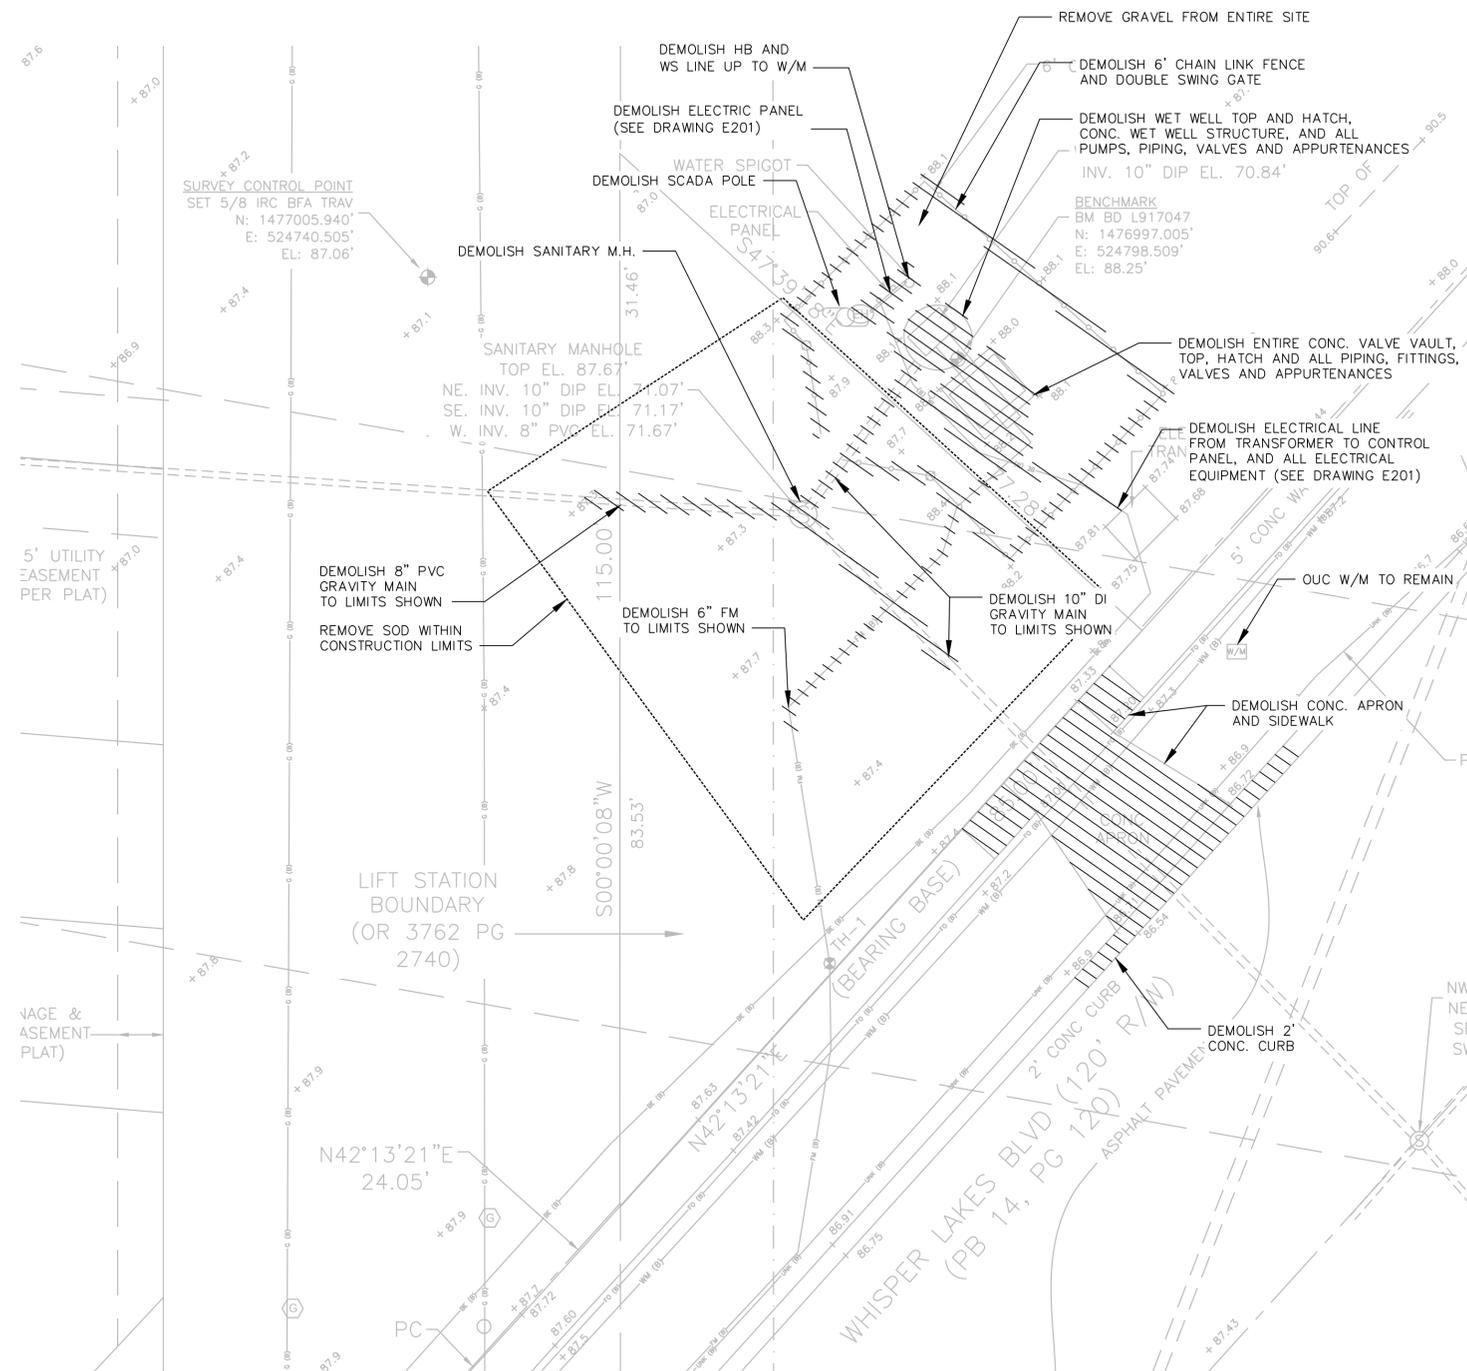

REV	DATE	DESCRIPTION	BY
C	05/2019	ISSUED FOR BID	AJM
B	10/2018	90% DRAWINGS	AJM
A	08/2018	60% DRAWINGS	AJM

Issue Certification

Melanie D. Peckham, P.E.
Florida P.E. No. 66478

Designed ARS
 Drawn AJM
 Checked MDP
 Reviewed JRV
 Approved MDP



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ORANGE COUNTY
 R/R PACKAGE 22 PUMP STATIONS
 CIVIL
 PUMP STATION 3351 - WHISPER LAKES 4
 DEMOLITION SITE PLAN

PROJECT NO.: 110034	
SCALE: NOTED	REVISION: C
DRAWING NO. C200	SHEET NO.: 12 OF 47



INSTALL NEW 6"x18" CONCRETE CURB AND FENCE PER O.C.U. FIGURES A406 AND A708. MATCH EXISTING GRADE AT BACK OF CURB. INSTALL WEEP HOLES EVERY 5 FT WHERE REQUIRED FOR DRAINAGE OF CONCRETE PAD

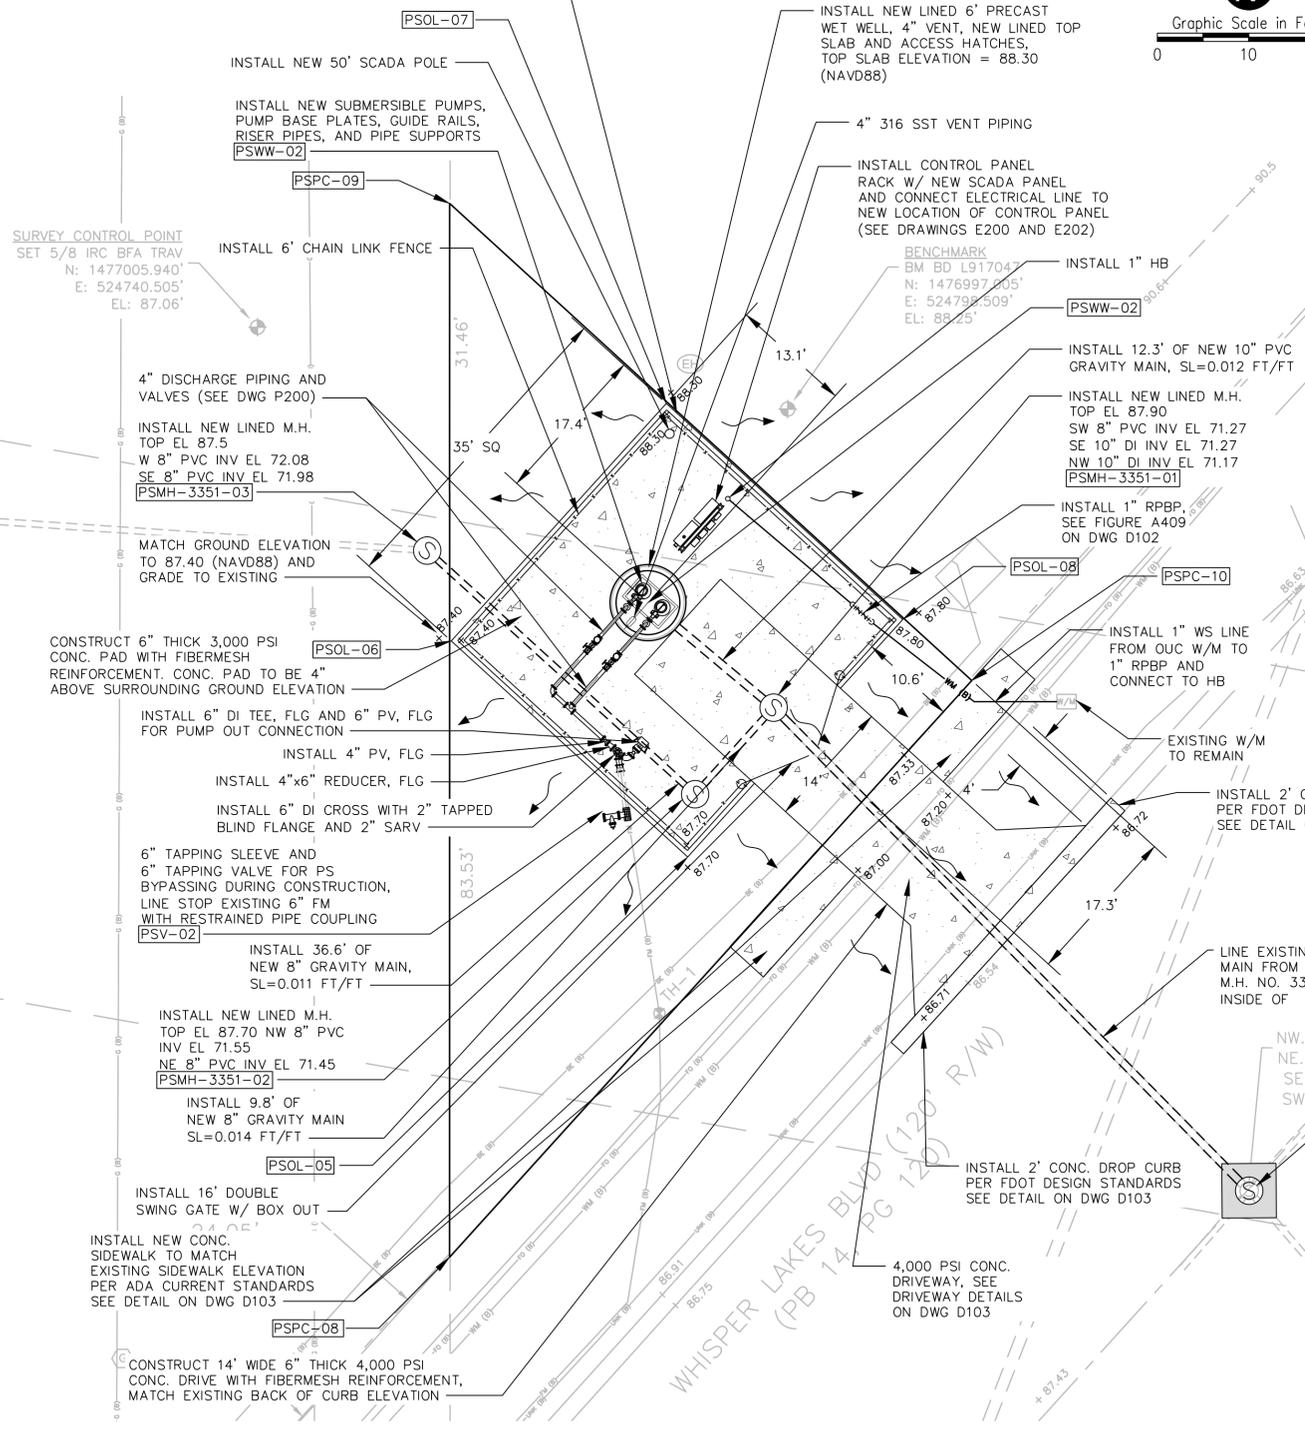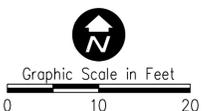

M.H. NO. 33640002
LINE PRECAST CONC. M.H., FURNISH AND INSTALL LINED PRECAST CONC. CONE SECTION, FURNISH AND INSTALL M.H. FRAME AND COVER, FURNISH AND INSTALL ASPHALT PAVEMENT

PS 3351 - M.H. 33640002

M.H. NO. 33510046
LINE PRECAST CONC. M.H. FURNISH AND INSTALL LINED PRECAST CONC. CONE SECTION, FURNISH AND INSTALL M.H. FRAME AND COVER, FURNISH AND INSTALL ASPHALT PAVEMENT

PS 3351 - WHISPER LAKES 4 PROPOSED PLAN

Parent Sheet Set: 1100340C_PKG22PS Rev/Plot by: JAY MILLER Rev on: 5/15/2019 2:24 PM Individual File Path: R:\Projects\110034 - Orange County R-R Package 22 Pump Stations\Design\FinalDesign\C201.dwg



REV	DATE	DESCRIPTION	BY
C	05/2019	ISSUED FOR BID	AJM
B	10/2018	90% DRAWINGS	AJM
A	08/2018	60% DRAWINGS	AJM

Issue Certification	
Melanie D. Peckham, P.E.	Florida P.E. No. 66478


Designed	ARS
Drawn	AJM
Checked	MDP
Reviewed	JRV
Approved	MDP

ORANGE COUNTY
R/R PACKAGE 22 PUMP STATIONS
CIVIL
PUMP STATION 3351 - WHISPER LAKES 4
PROPOSED SITE PLAN

PROJECT NO.:	110034
SCALE:	NOTED
REVISION:	C
DRAWING NO.:	C201
SHEET NO.:	13 OF 47



Parent Sheet Set: 1100340C_PKG22PS Rev/Plot by: JAY MILLER
 Rev on: 4/12/2019 11:01 AM
 Individual File Path: R:\Projects\110034 - Orange County R-R Package 22 Pump Stations\Design\FinalDesign\C300.dwg

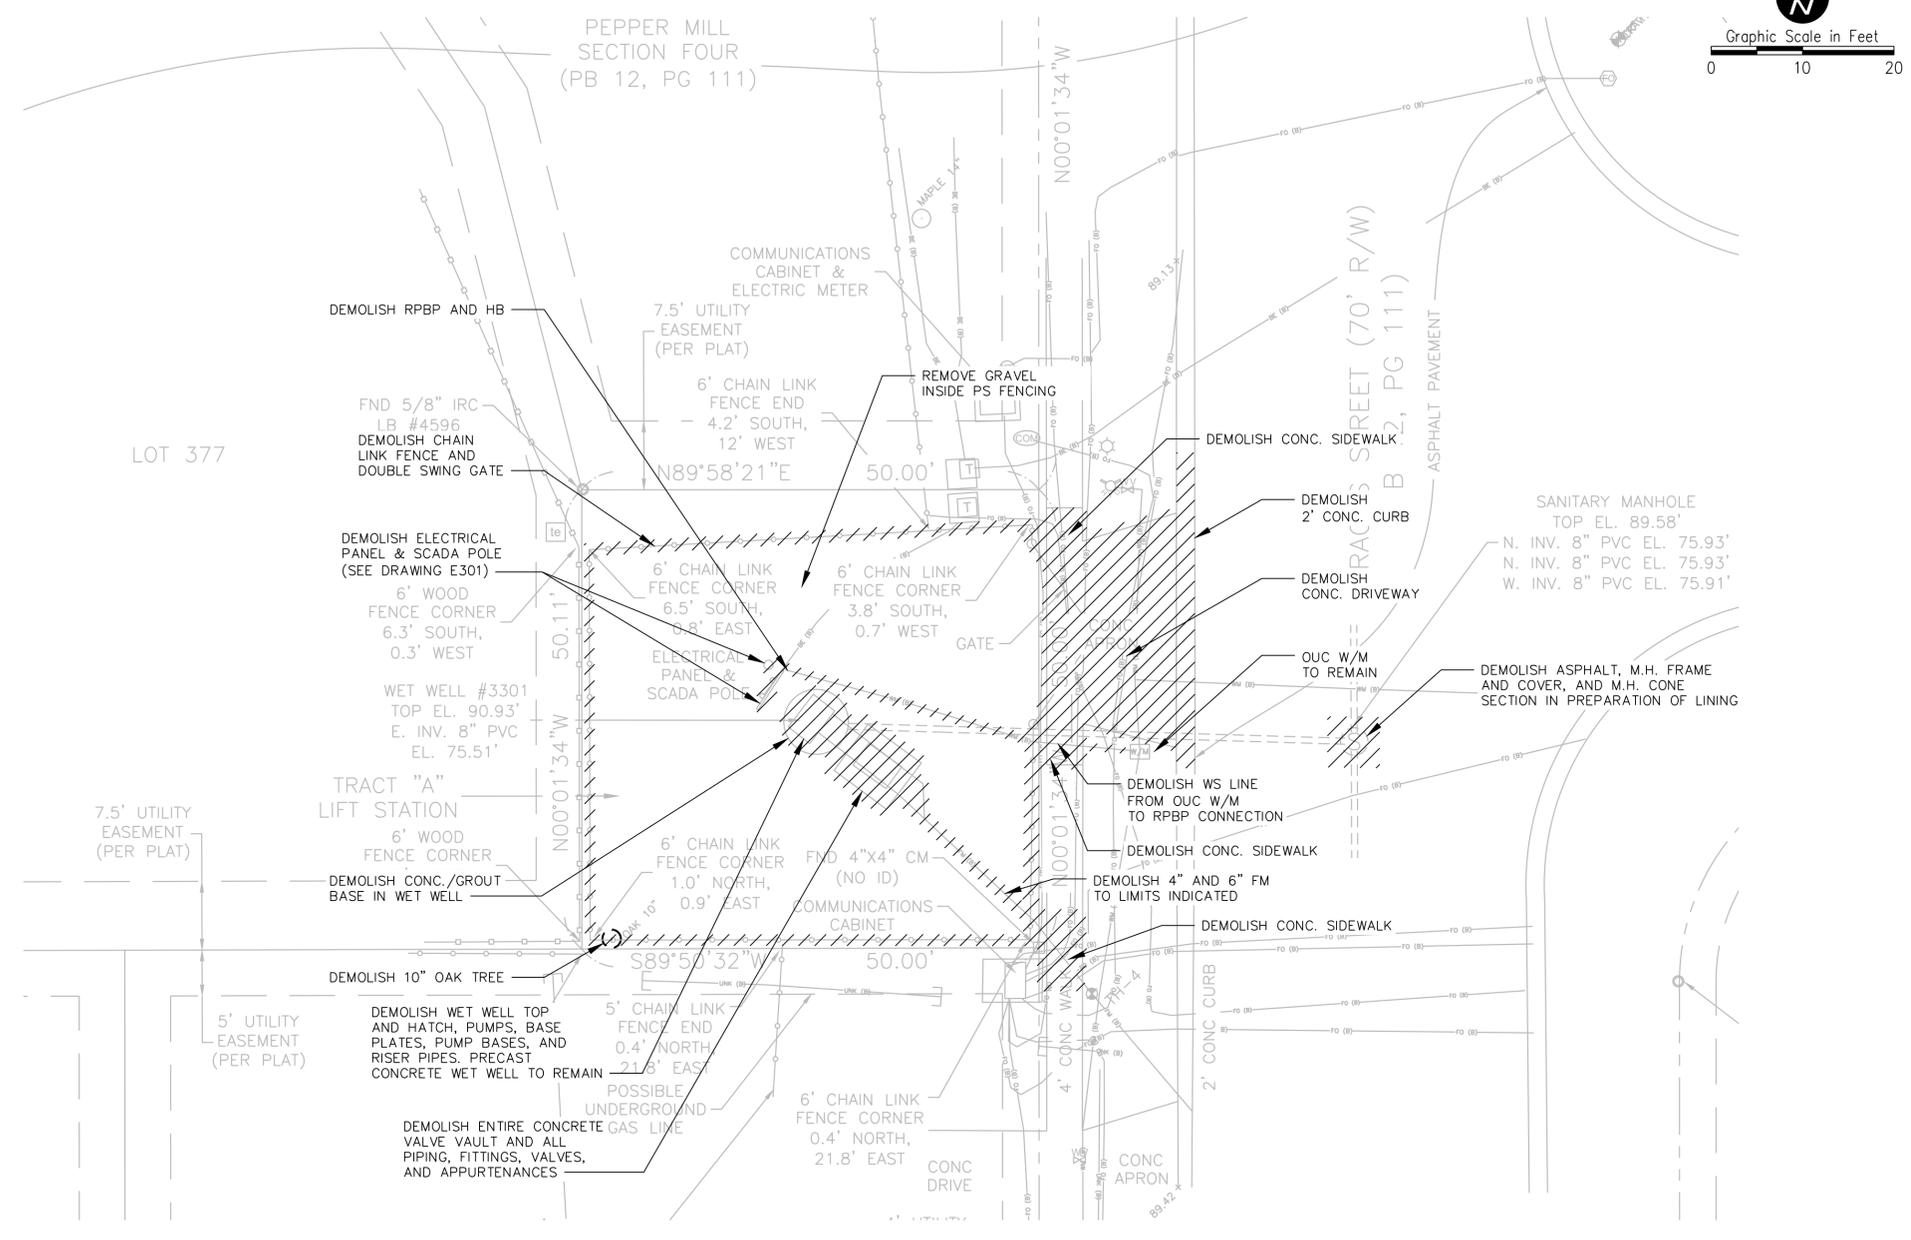

PS 3301 - PEPPERMILL 4 DEMOLITION PLAN

NOTE:
SALVAGE AND/OR DISPOSAL OF ALL EXISTING
EQUIPMENT SHALL BE AT THE DIRECTION OF THE RPR.



REV	DATE	DESCRIPTION	BY
C	05/2019	ISSUED FOR BID	AJM
B	10/2018	90% DRAWINGS	AJM
A	08/2018	60% DRAWINGS	AJM

Issue Certification	
Designed	ARS
Drawn	AJM
Checked	MDP
Reviewed	JRV
Approved	MDP
Melanie D. Peckham, P.E. Florida P.E. No. 66478	



Designed	ARS
Drawn	AJM
Checked	MDP
Reviewed	JRV
Approved	MDP

ORANGE COUNTY
R/R PACKAGE 22 PUMP STATIONS
 CIVIL
PUMP STATION 3301 - PEPPERMILL 4
DEMOLITION SITE PLAN

PROJECT NO.: 110034	
SCALE: NOTED	REVISION: C
DRAWING NO. C300	SHEET NO.: 14 OF 47

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 WINTER SPRINGS, FL 32708
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 Rev on: 5/15/2019 2:24 PM
 Individual File Path: R:\Projects\110034 - Orange County R-R Package 22 Pump Stations\Design\Drawings\FinalDesign\C301.dwg

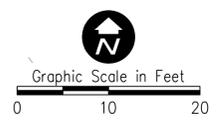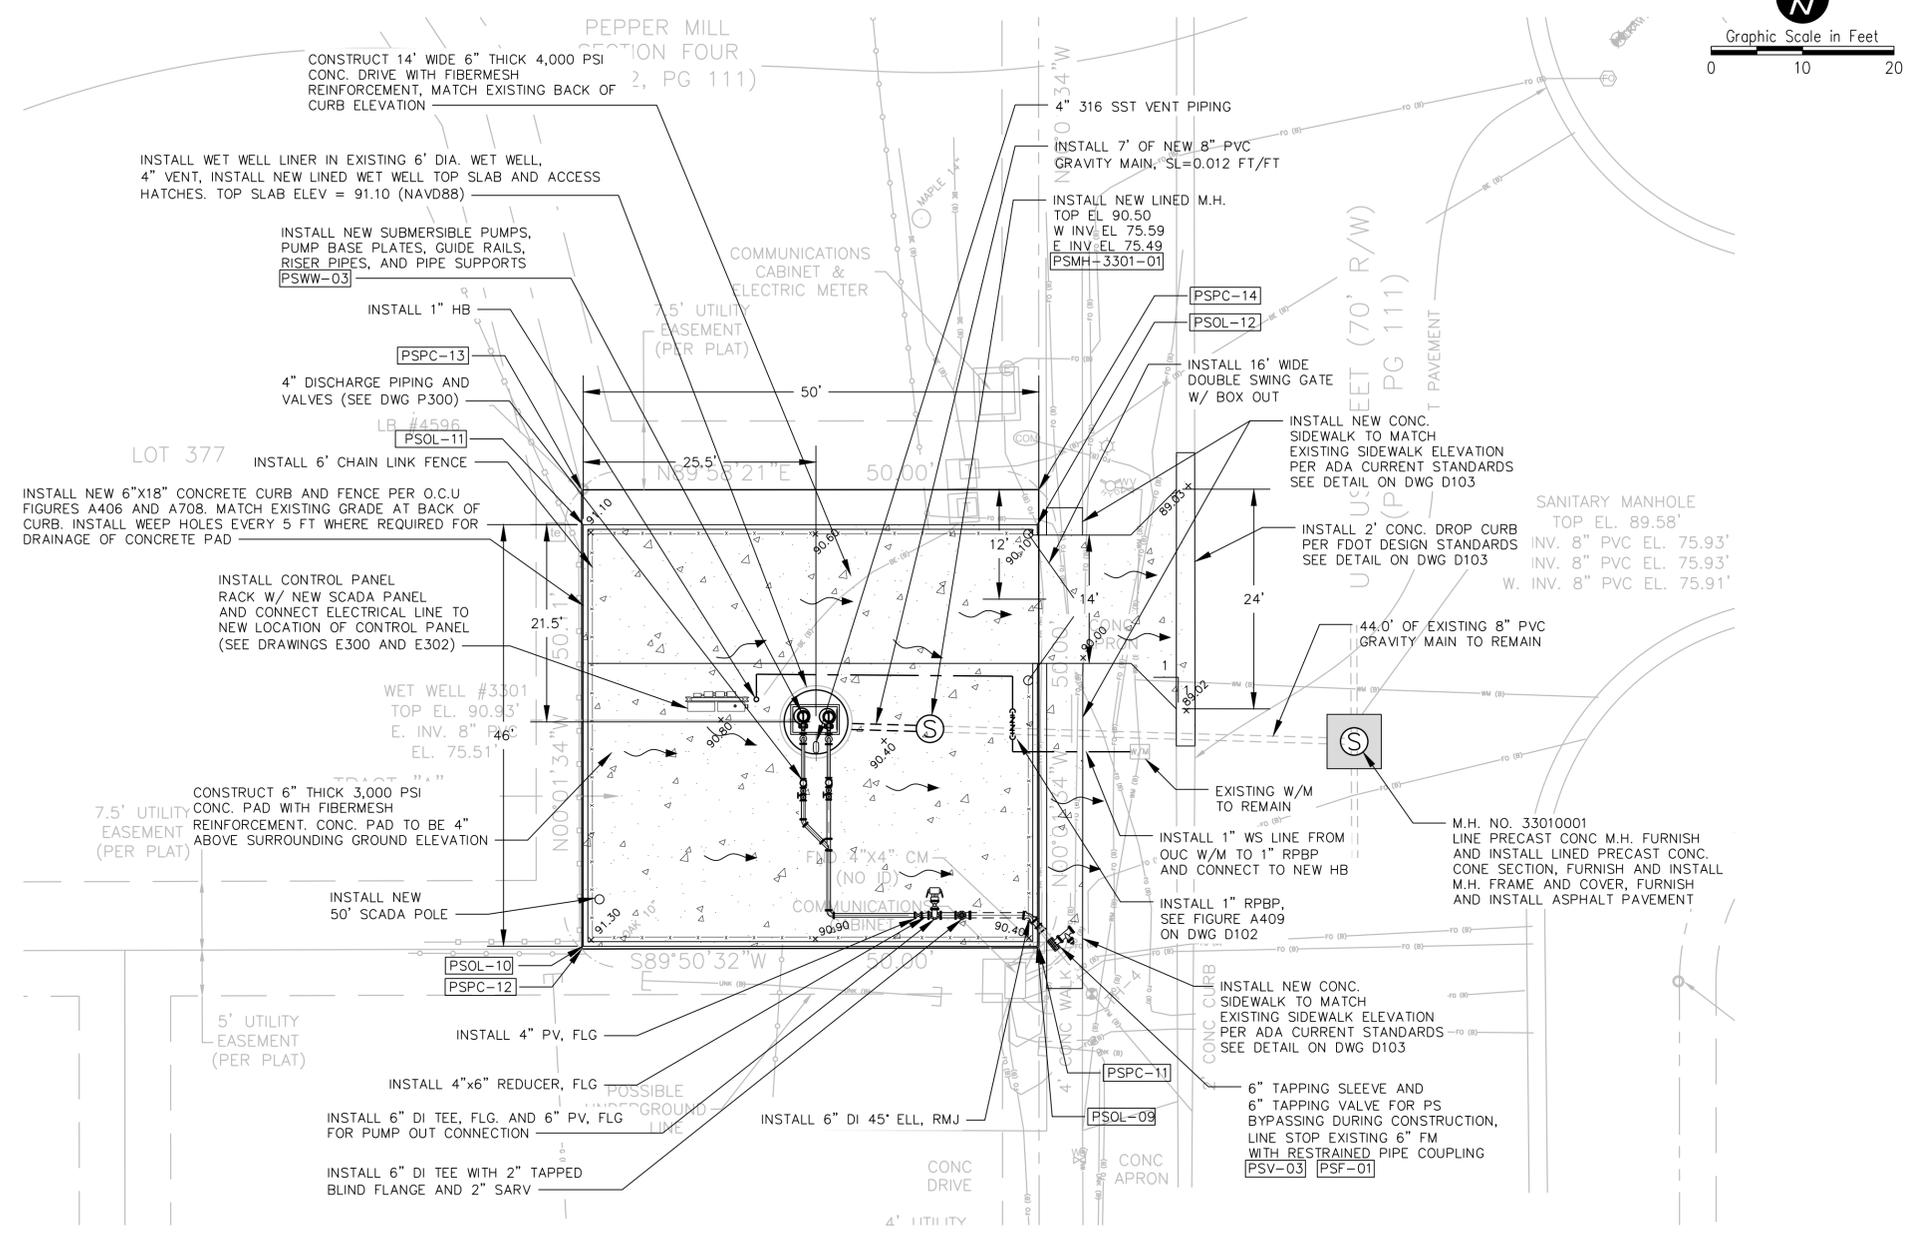

PS 3301 - PEPPERMILL 4 PROPOSED PLAN



REV	DATE	DESCRIPTION	BY
C	05/2019	ISSUED FOR BID	AJM
B	10/2018	90% DRAWINGS	AJM
A	08/2018	60% DRAWINGS	AJM

Issue Certification	
Designed	ARS
Drawn	AJM
Checked	MDP
Reviewed	JRV
Approved	MDP
Melanie D. Peckham, P.E. Florida P.E. No. 66478	


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Line Size	1/8" = 1"

ORANGE COUNTY
 R/R PACKAGE 22 PUMP STATIONS
 CIVIL
**PUMP STATION 3301 - PEPPERMILL 4
 PROPOSED SITE PLAN**

PROJECT NO.: 110034	
SCALE: NOTED	REVISION: C
DRAWING NO. C301	SHEET NO.: 15 OF 47

REISS ENGINEERING, INC.
 1016 SPRING VILLAS PT.
 WINTER SPRINGS, FL 32708
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Parent Sheet Set: 1100340C_PKG22PS Rev/Plot by: JAY MILLER
 Rev on: 5/17/2019 6:59 AM
 Individual File Path: R:\Projects\110034 - Orange County R-R Package 22 Pump Stations\Design\FinalDesign\C401.dwg

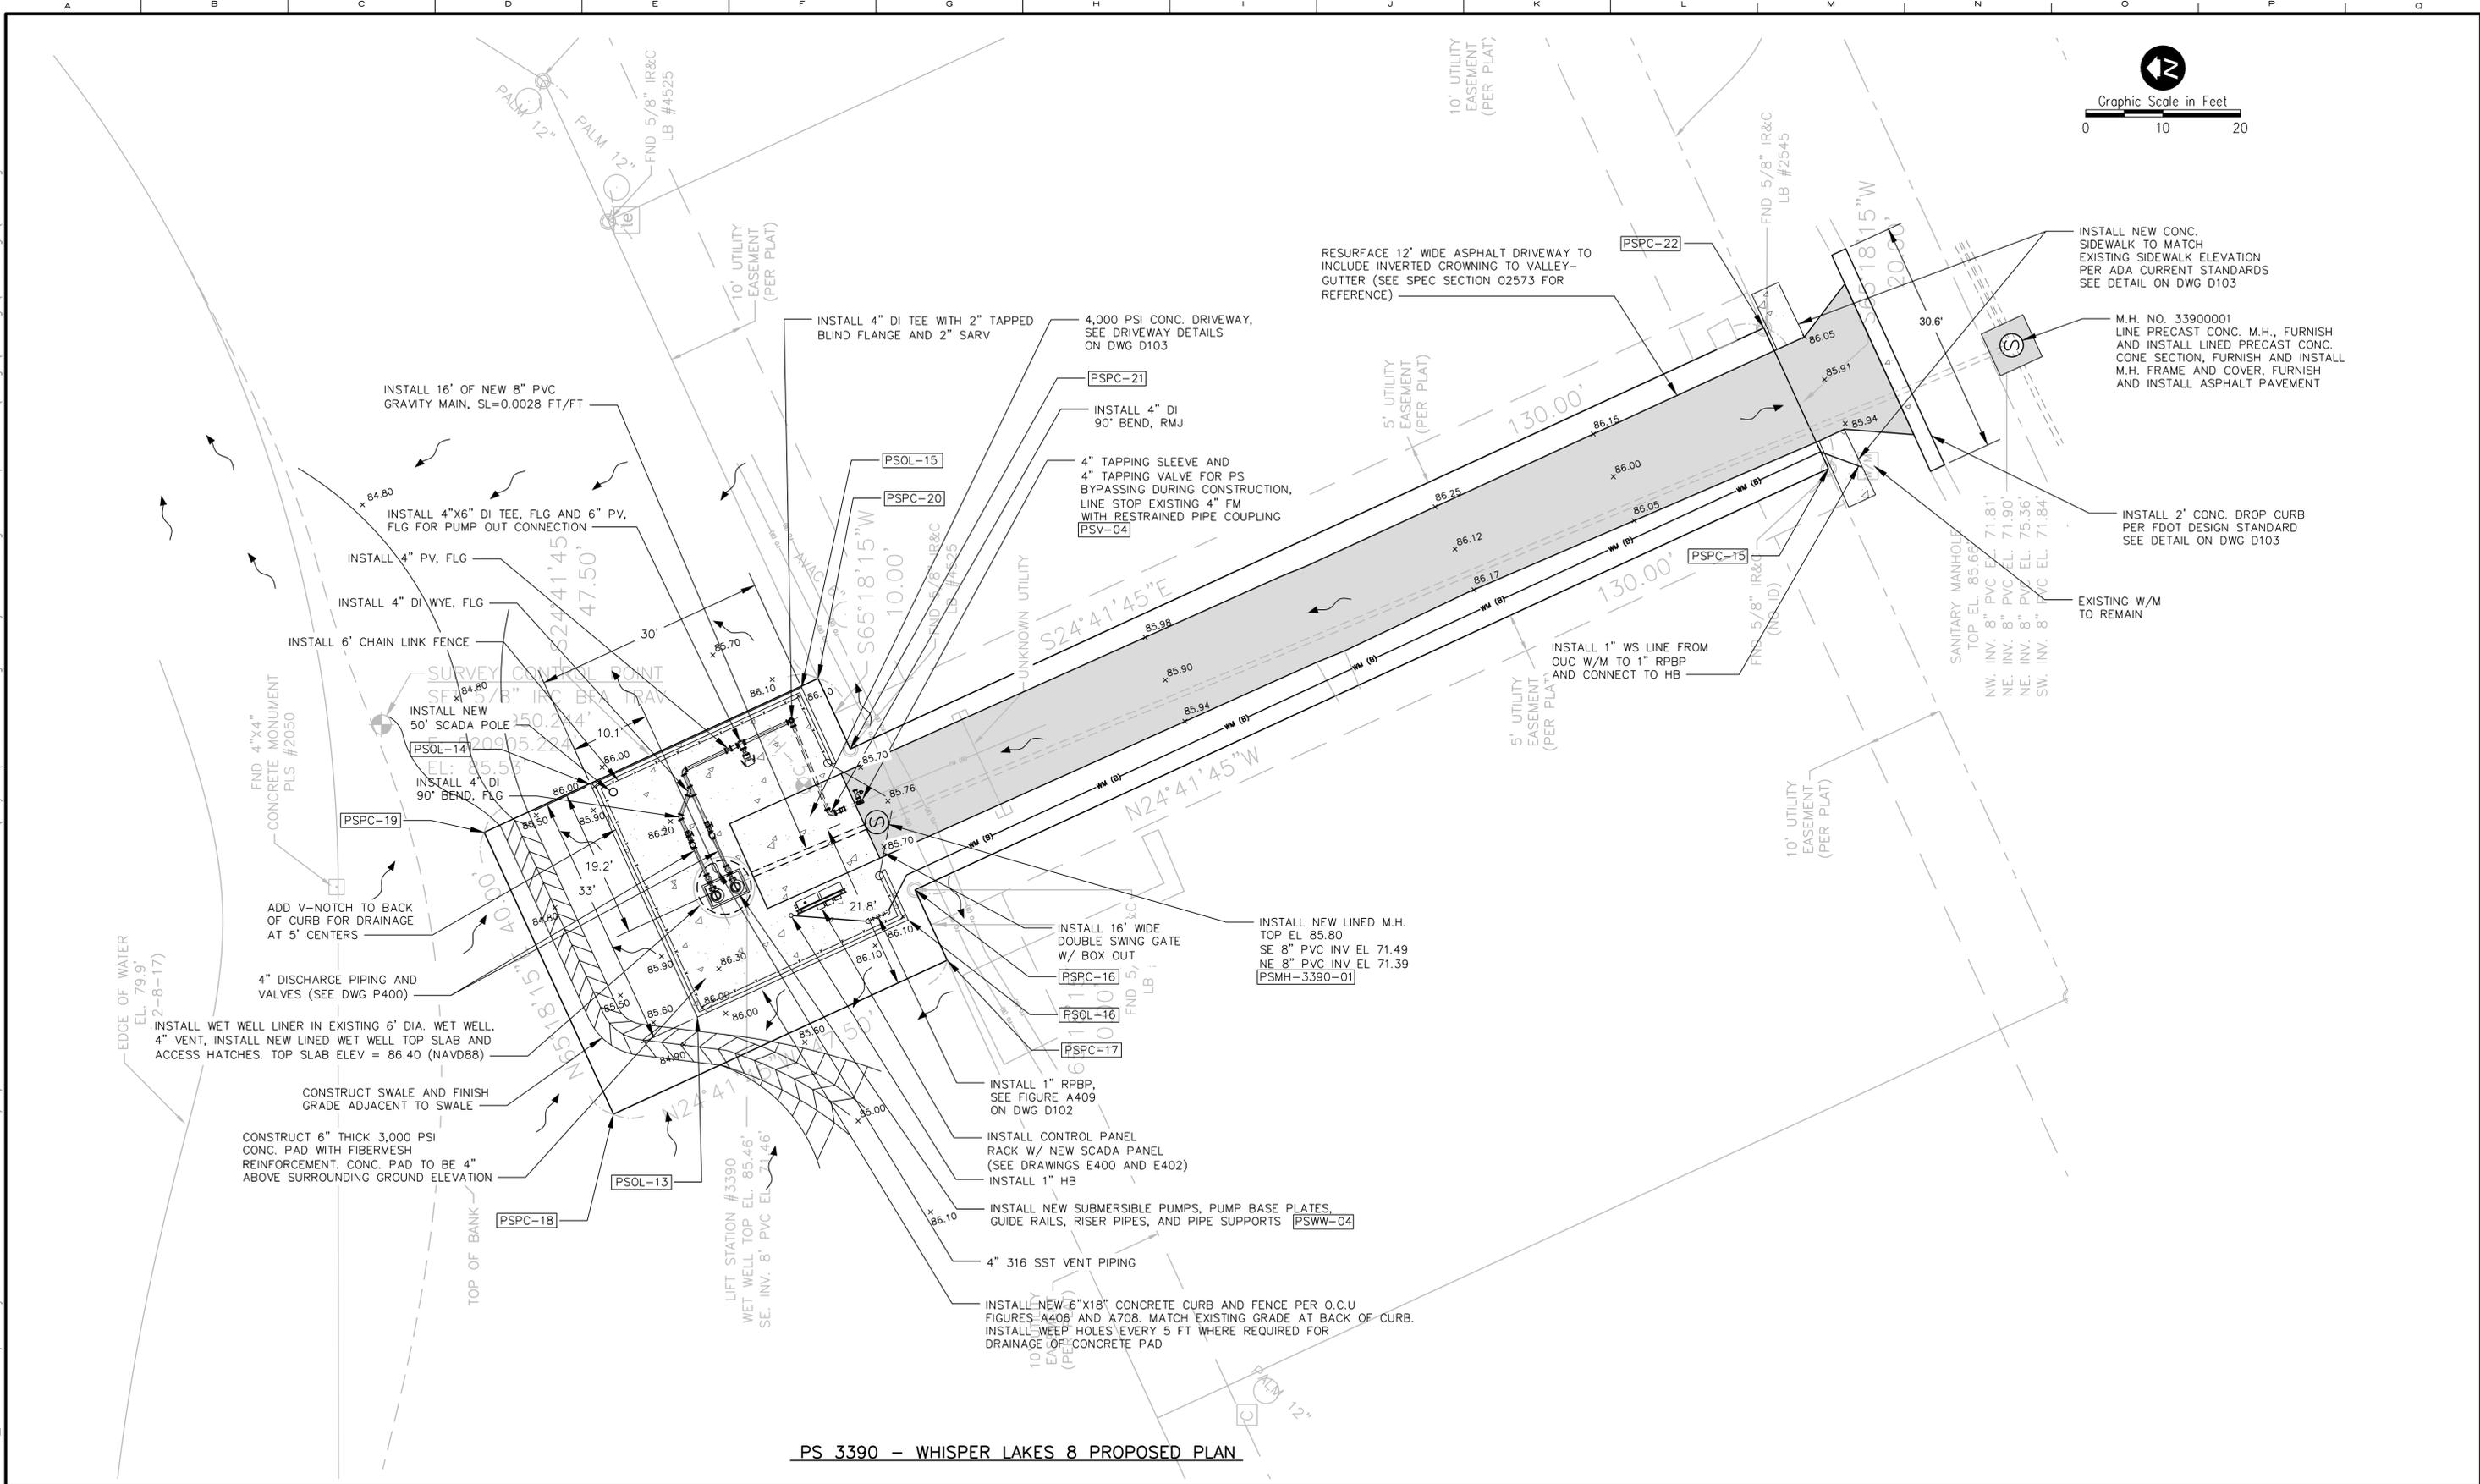

PS 3390 - WHISPER LAKES 8 PROPOSED PLAN



REV	DATE	DESCRIPTION	BY
C	05/2019	ISSUED FOR BID	AJM
B	10/2018	90% DRAWINGS	AJM
A	08/2018	60% DRAWINGS	AJM

Issue Certification	
Melanie D. Peckham, P.E.	Florida P.E. No. 66478

Designed	ARS
Drawn	AJM
Checked	MDP
Reviewed	JRV
Approved	MDP


ORANGE COUNTY
 R/R PACKAGE 22 PUMP STATIONS
 CIVIL
PUMP STATION 3390 - WHISPER LAKES 8
 PROPOSED SITE PLAN

PROJECT NO.: 110034	
SCALE: NOTED	REVISION: C
DRAWING NO. C401	SHEET NO.: 17 OF 47

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Parent Sheet Set: 1100340C_PKG22PS Rev/Plot by: JAY MILLER



PS 3325 - MEADOW WOODS 1 DEMOLITION PLAN

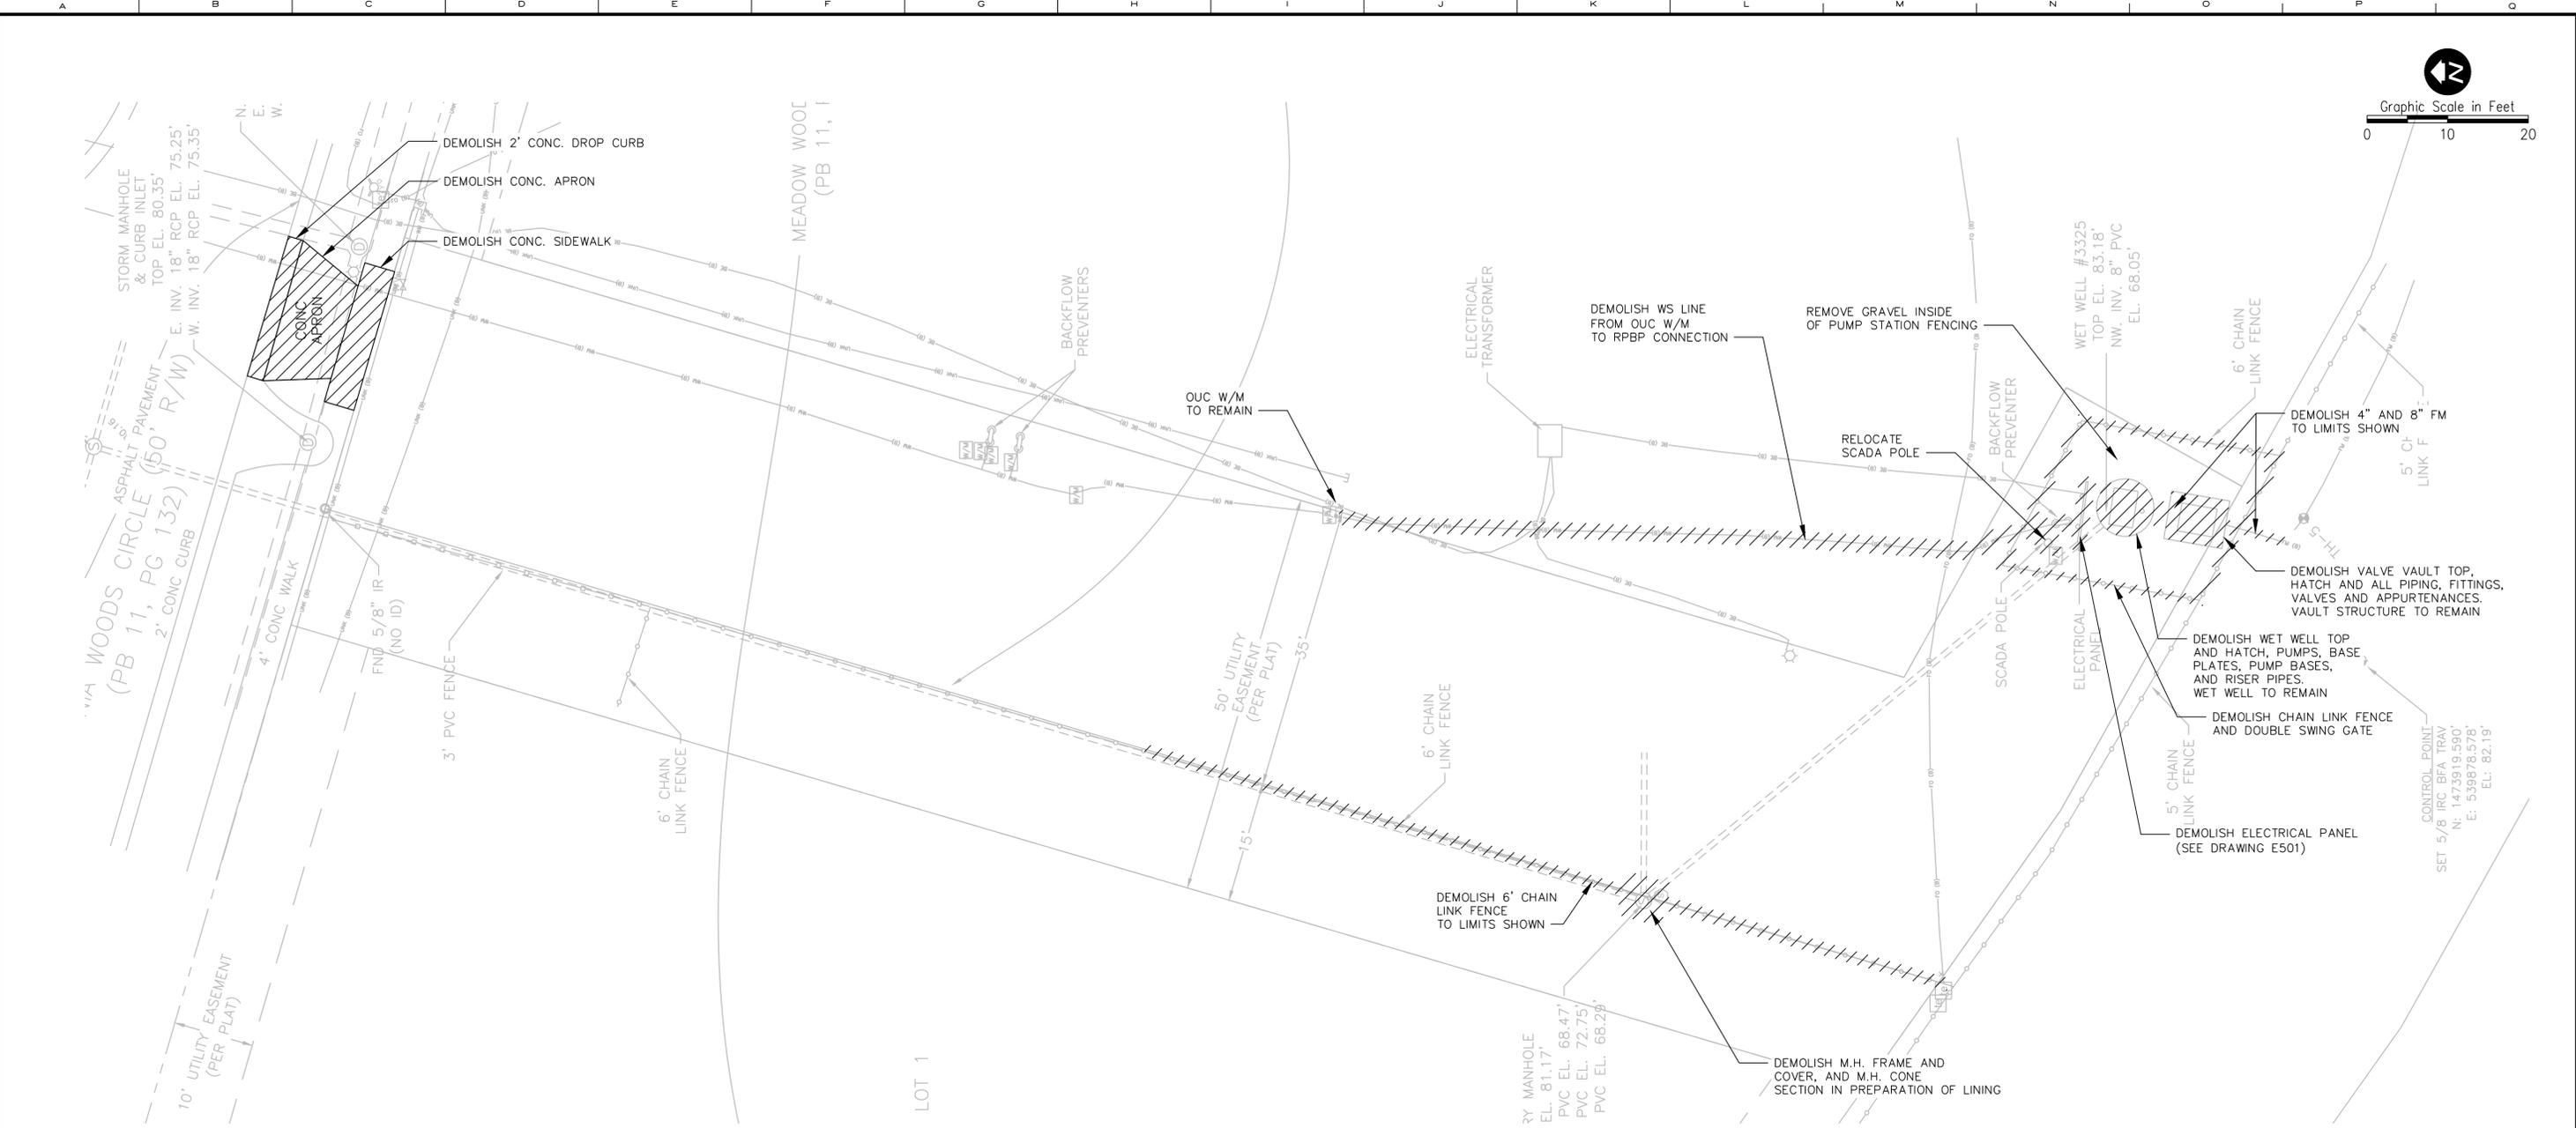NOTE:
SALVAGE AND/OR DISPOSAL OF ALL EXISTING
EQUIPMENT SHALL BE AT THE DIRECTION OF THE RPR.



REV	DATE	DESCRIPTION	BY
C	05/2019	ISSUED FOR BID	AJM
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A	08/2018	60% DRAWINGS	AJM

Issue Certification	
Designed	ARS
Drawn	AJM
Checked	MDP
Reviewed	JRV
Approved	MDP
Melanie D. Peckham, P.E. Florida P.E. No. 66478	

Designed	ARS
Drawn	AJM
Checked	MDP
Reviewed	JRV
Approved	MDP
LINE IS 1" AT FULL SIZE	



ORANGE COUNTY
R/R PACKAGE 22 PUMP STATIONS
CIVIL
PUMP STATION 3325 - MEADOW WOODS 1
DEMOLITION SITE PLAN

PROJECT NO.: 110034	
SCALE: NOTED	REVISION: C
DRAWING NO. C500	SHEET NO.: 18 OF 47

RE

REISS ENGINEERING, INC.
1016 SPRING VILLAS PT.
WINTER SPRINGS, FL 32708
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CERTIFICATE OF AUTH. 8181

Parent Sheet Set: 1100340C_PKG22PS Rev/Plot by: JAY MILLER
 Rev on: 5/15/2019 2:07 PM
 Individual File Path: R:\Projects\110034 - Orange County R-R Package 22 Pump Stations\Design\Drawings\FinalDesign\C501.dwg

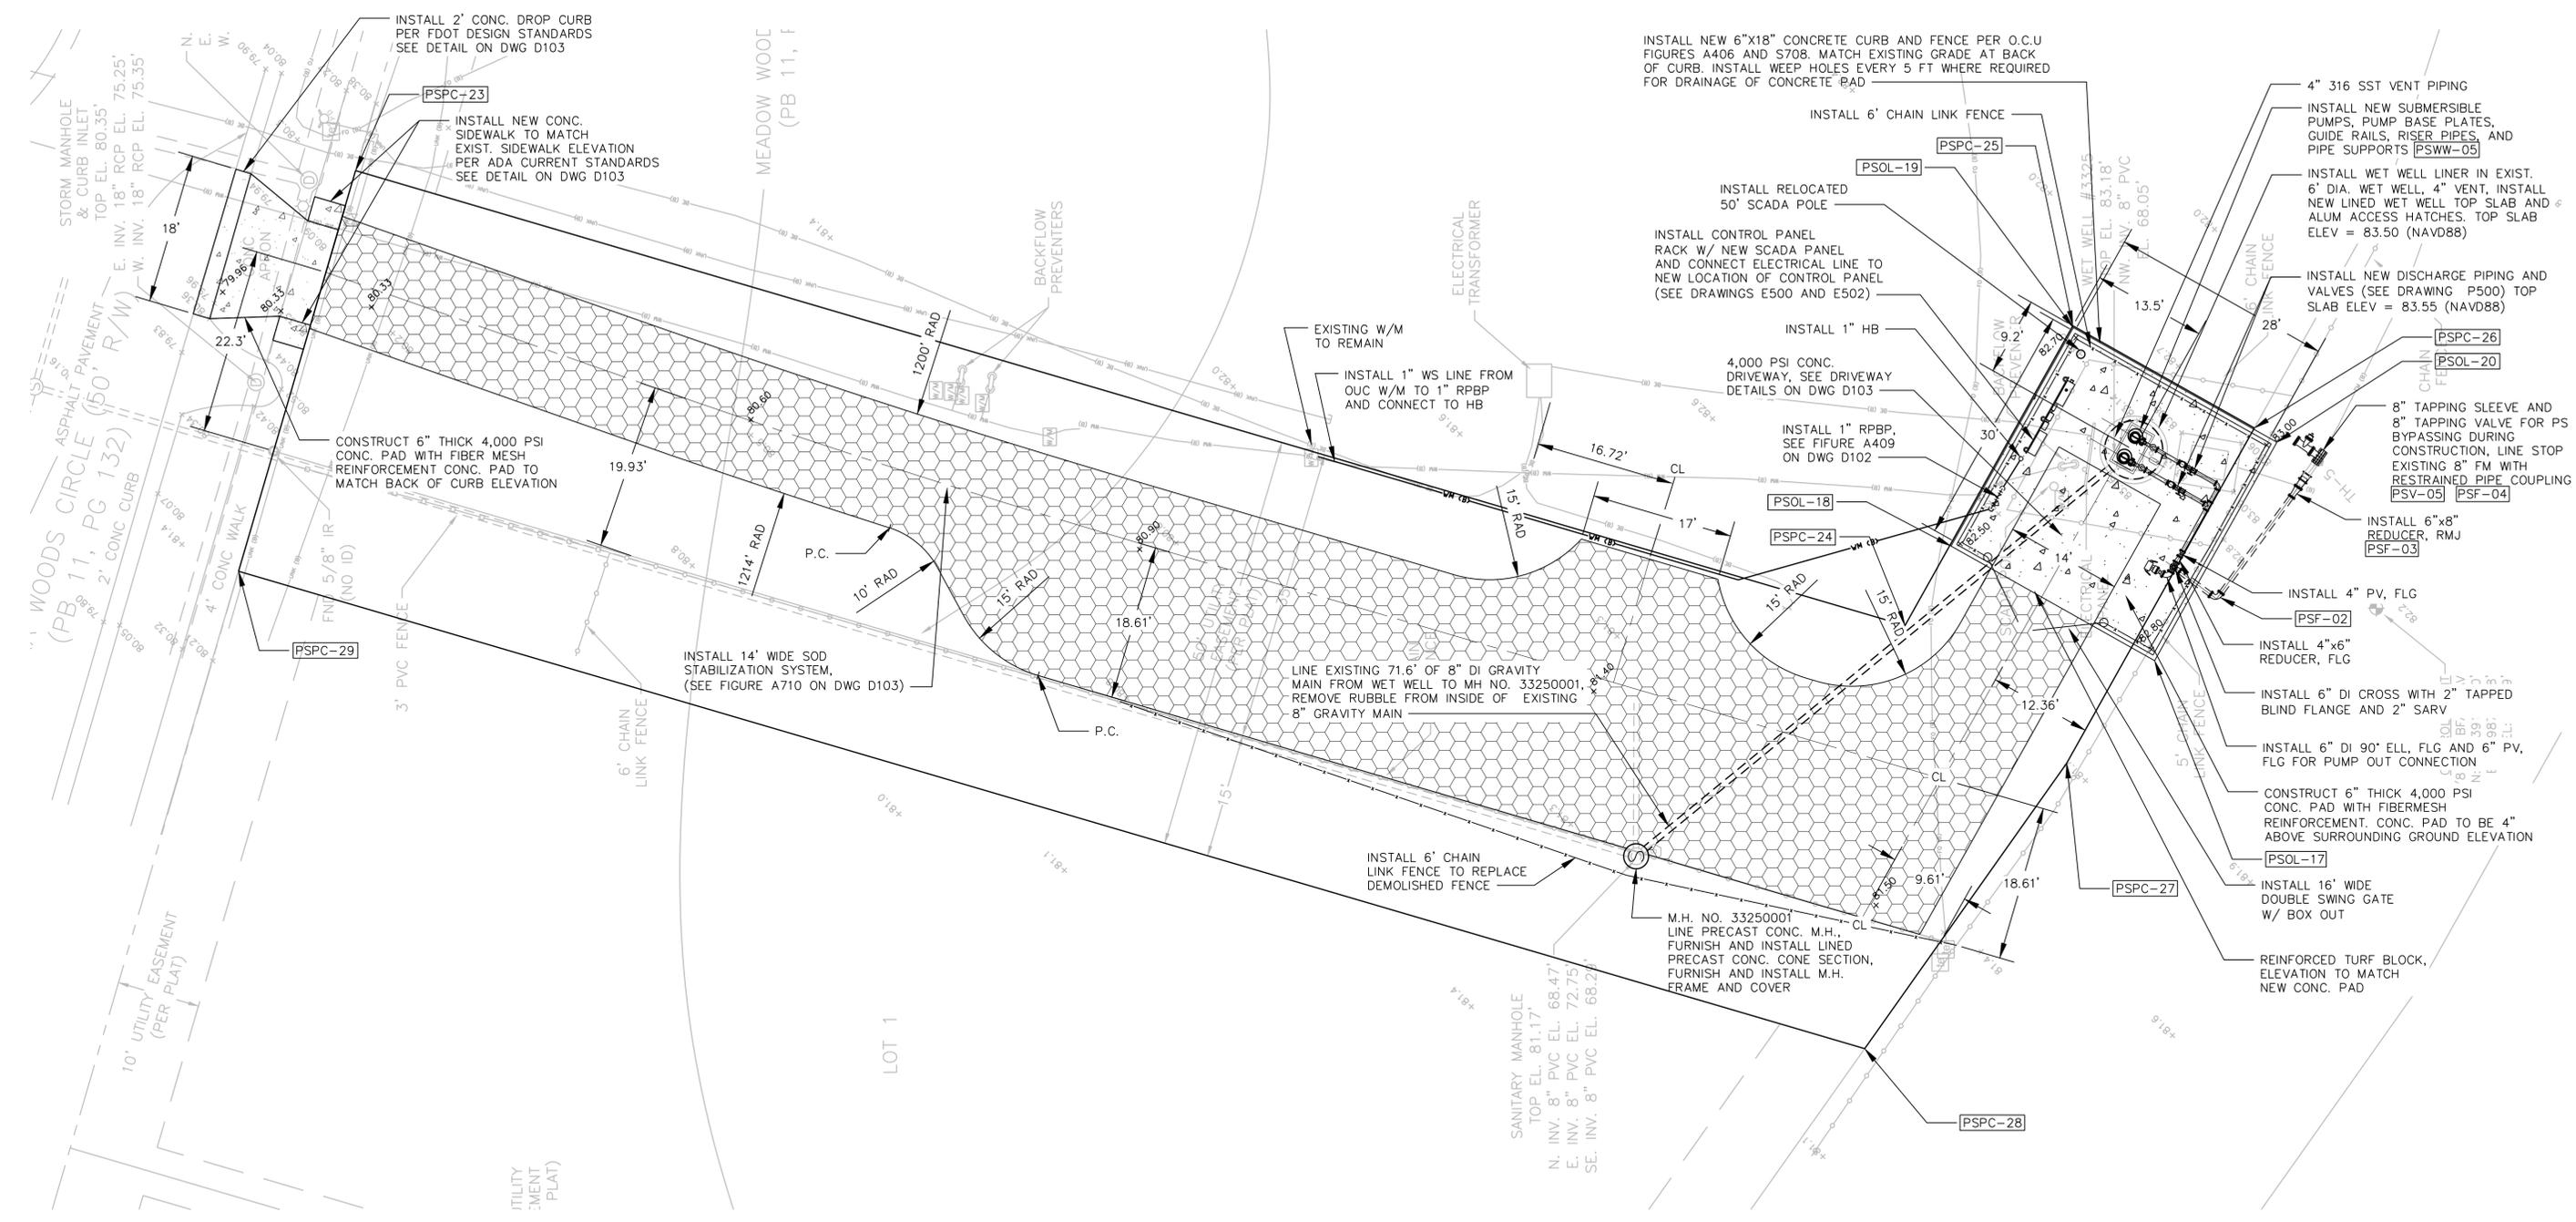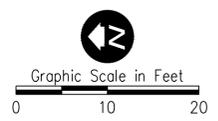

PS 3325 - MEADOW WOODS 1 PROPOSED PLAN



REV	DATE	DESCRIPTION	BY
C	05/2019	ISSUED FOR BID	AJM
B	10/2018	90% DRAWINGS	AJM
A	08/2018	60% DRAWINGS	AJM

Issue Certification	
Designed	ARS
Drawn	AJM
Checked	MDP
Reviewed	JRV
Approved	MDP
Melanie D. Peckham, P.E. Florida P.E. No. 66478	


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Notes	SEE DRAWING FOR FULL SIZE

ORANGE COUNTY
 R/R PACKAGE 22 PUMP STATIONS
 CIVIL
PUMP STATION 3325 - MEADOW WOODS 1
 PROPOSED SITE PLAN


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REVISION:	C
DRAWING NO.:	C501
SHEET NO.:	19 OF 47

REISS ENGINEERING, INC.
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 WINTER SPRINGS, FL 32708
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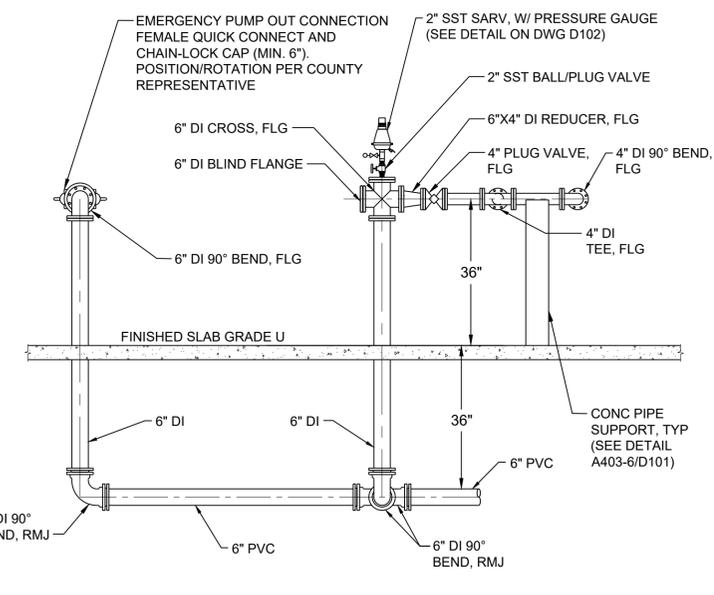
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 Parent Sheet Set: 1100340C_Pkg22PS Rev/Plot by: JAY MILLER

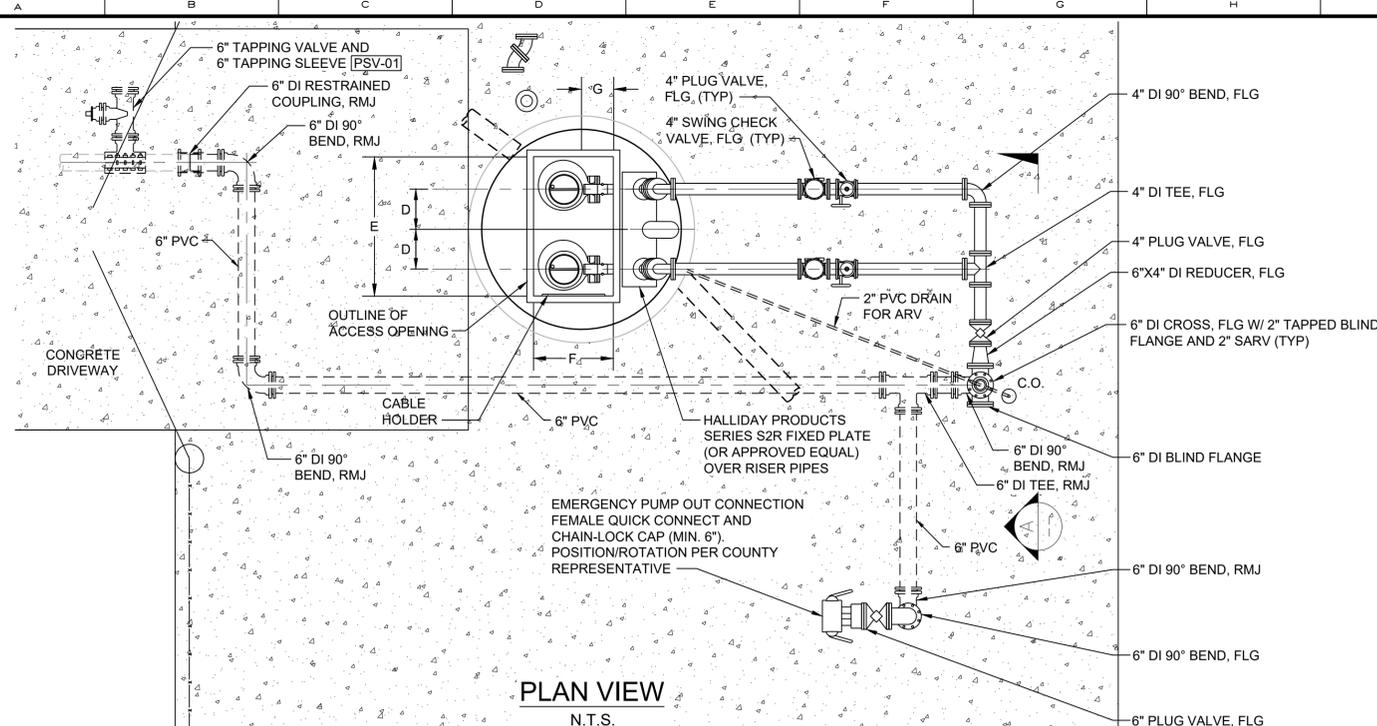

PLAN VIEW
N.T.S.

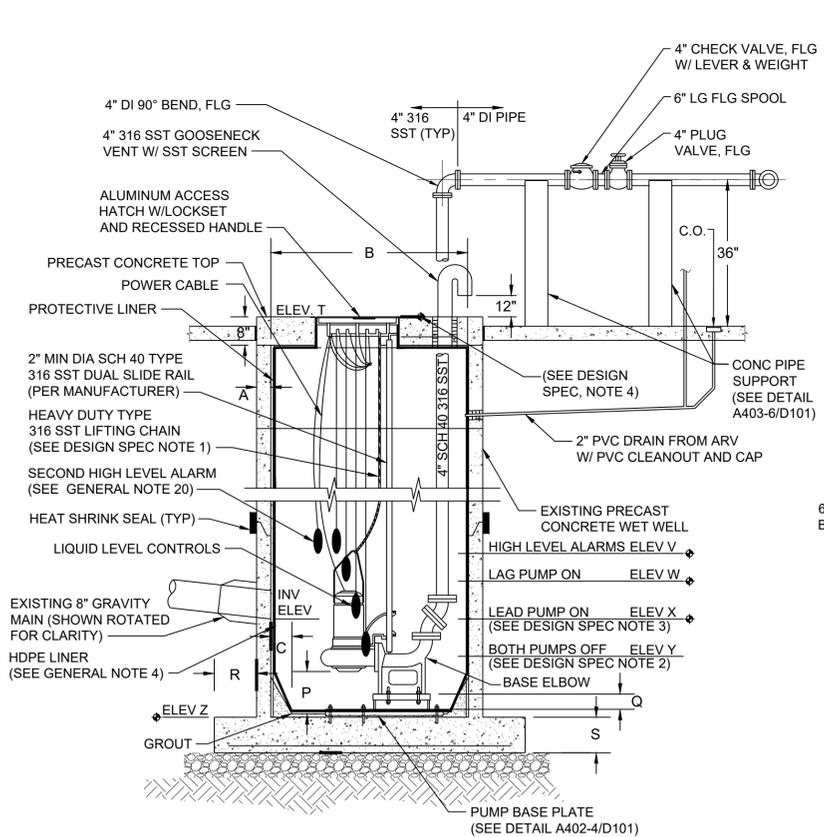

SECTION VIEW
N.T.S.



SECTION ALONG PUMPOUT
SCALE: N.T.S.

GENERAL NOTES

- ALL MATERIALS AND CONSTRUCTION SHALL BE IN ACCORDANCE WITH THE ORANGE COUNTY UTILITIES STANDARDS AND SPECIFICATIONS MANUAL (LATEST EDITION), AND/OR AS SPECIFIED HEREIN.
- ALL EXPOSED METAL OUTSIDE OF THE WET WELL SHALL BE PRIMED AND PAINTED IN ACCORDANCE WITH THE ORANGE COUNTY UTILITIES STANDARDS AND CONSTRUCTION SPECIFICATION MANUAL.
- A CRYSTALLINE WATER PROOFING ADMIXTURE SHALL BE ADDED TO THE CONCRETE DURING THE MIXING CYCLE FOR THE WET WELL PRECAST STRUCTURES. THE CRYSTALLINE WATER PROOFING ADMIXTURE SHALL BE APPROVED PRODUCT AS LISTED IN OCU APPENDIX D.
- THE INSIDE OF THE WET WELL SHALL BE LINED WITH EITHER A HIGH DENSITY POLYETHYLENE (HDPE) LINER, A POLYPROPYLENE RANDOM COPOLYMER (PP-R) LINING SYSTEM, OR AN ACCEPTABLE EQUAL AS LISTED IN OCU APPENDIX D. FINAL SEALS AND SEALING TO BE MADE IN THE FIELD.
- WET WELL ACCESS OPENING SHALL BE COVERED ON ALL FOUR VERTICAL SIDES WITH A PROTECTIVE LINER.
- WET WELL ACCESS HATCH AND COVER SHALL BE ALUMINUM, WITH 316 STAINLESS STEEL HARDWARE AND LOCK BRACKET PLATE WITH THE WORDS "CONFINED SPACE" STAMPED (ETCHED) ON THE TOP SIDE. EACH DOOR WILL BE EQUIPPED WITH RECESSED HASP ENCLOSURE.
- ALL HARDWARE IN THE WET WELL SHALL BE 316 STAINLESS STEEL.
- THERE SHALL BE NO VALVES OR ELECTRICAL JUNCTION BOXES IN THE WET WELL.
- ALL PIPING AND CONDUIT PENETRATIONS THROUGH CONCRETE SHALL BE WATERTIGHT. CAST-IN-PLACE SLEEVES SHALL BE PLACED IN ALL OPENINGS WHERE PRESSURE PIPE ENTER OR LEAVE THE WET WELL. PENETRATIONS THROUGH WET WELL SHALL BE A COMPRESSION TYPE SEAL, SUCH AS "LINK-SEAL", OR AN ACCEPTABLE EQUAL AS LISTED IN OCU APPENDIX D.
- ALL CONNECTIONS WITHIN THE WET WELL SHALL BE FLANGED JOINTS. ALL REMAINING JOINTS BETWEEN THE WET WELL AND THE CONNECTION TO THE EXISTING FORCE MAIN SHALL BE RESTRAINED MECHANICAL JOINTS. (SEE TABLE ON DETAIL SHEET D100).
- ALL PIPING WITHIN THE WET WELL SHALL BE STAINLESS STEEL 316 SCHEDULE 40.
- PIPE SUPPORTS SHALL BE CONCRETE, PROVIDED AND INSTALLED TO SUPPORT AND ANCHOR THE PIPING SECURELY.
- CONTRACTOR SHALL, AS DIRECTED BY THE COUNTY REPRESENTATIVE, REMOVE AND SALVAGE TO THE COUNTY, ALL EXISTING PUMP STATION EQUIPMENT, INCLUDING PUMPS, CHECK VALVES, SHUTOFF VALVES, AND CONTROL PANEL.
- CONTRACTOR SHALL DEMOLISH AND REMOVE FROM SITE ALL DEBRIS RESULTING FROM THE REMOVAL OF THE EXISTING STRUCTURES.
- CONTRACTOR SHALL VERIFY ALL DIMENSIONS AND ELEVATIONS PRIOR TO ORDERING ANY MATERIALS OR EQUIPMENT.
- CONTRACTOR SHALL GROUT FLOOR OF WET WELL, AS REQUIRED BY MANUFACTURER'S SPECIFICATIONS, TO ACCOMMODATE INSTALLATION OF THE NEW PUMPS.
- STRUCTURAL DESIGN OF THE PRECAST WET WELL, TOP SHALL BE THE RESPONSIBILITY OF THE PRECAST MANUFACTURER. CONTRACTOR SHALL SUBMIT SHOP DRAWINGS FOR THE PRECAST WET WELL, THE PRECAST LINED WET WELL TOP AND HATCH COVER, AND RISERS, TO THE ENGINEER.
- 100-YEAR FLOOD ELEVATION: OUT OF THE 100-YEAR FLOOD ZONE.
- ALL EXTERNAL JOINTS OF THE WET WELL SHALL BE COVERED WITH A HIGH STRENGTH, WATER TIGHT, PRESS-TO-SEAL TYPE TAPE/AS LISTED IN OCU APPENDIX D.
- A SECOND HIGH LEVEL ALARM LIQUID FLOAT SHALL BE INSTALLED TO PROVIDE DRY CONTACT FOR SCADA. REFER TO PUMP CONTROL SCHEMATIC.
- ALL SPOOLS SHALL BE MINIMUM OF SIX INCHES WHERE SPACE ALLOWS.
- CONTRACTOR SHALL BE RESPONSIBLE FOR ALIGNMENT FROM THE BASE PLATE TO THE BASE ELBOW AT NO EXTRA COST TO OCU.

DESIGN SPECIFICATIONS			
MANUFACTURER: ABS	VOLTAGE: 460V		
MODEL: XFP	PHASE: 3		
IMP: 100E CB1.4	H.P.: 12.1		
DIA: 217 MM	MAX. SOLID SIZE (3 IN MIN): 3.00 IN		
SPEED: 1780 RPM	CURVE NUMBER: PE90/4 60HZ		
DISCHARGE SIZE: 4 IN			
SHUT OFF HEAD: 87.9 FEET TDH			
HIGH HEAD CONDITION: 290 GPM AT 62.5 FEET TDH			
MINIMUM HEAD CONDITION: 480 GPM AT 53.0 FEET TDH			
DESCRIPTION	SYMBOL	DIMENSION	ELEVATION
THICKNESS OF WALL	A	EXISTING	—
DIAMETER OF WET WELL	B	6'	—
WIDTH OF BOTTOM FILLET	C	SEE NOTE 1	—
C/L OF WET WELL TO C/L OF PIPES	D	SEE NOTE 1	—
LENGTH OF PUMP ACCESS OPENING	E	SEE NOTE 1	—
WIDTH OF PUMP ACCESS OPENING	F	SEE NOTE 1	—
CENTER OF WET WELL TO EDGE OF HATCH	G	SEE NOTE 1	—
CONCRETE SLAB LENGTH	H	NA	—
CONCRETE SLAB WIDTH	I	NA	—
LIP WIDTH OF WETWELL BASE	R	EXISTING	—
THICKNESS OF WETWELL BASE	S	EXISTING	—
TOP OF WET WELL	T	—	90.00
SLAB GRADE	U	—	89.82
INFLUENT PIPE INVERT (LOWEST-NE)		—	72.75
HIGH LEVEL ALARMS	V	—	72.75
LAG PUMP ON	W	—	72.25
LEAD PUMP ON	X	—	71.25
PUMPS OFF (TOP OF PUMP VOLUTE)	Y	—	68.75
BOTTOM OF PUMP TO FLOOR OF WET WELL	P	—	—
STEP HEIGHT (IF REQUIRED)	Q	—	—
FLOOR OF WET WELL	Z	—	65.77

- NOTES:
- PER PUMP MANUFACTURER'S REQUIREMENTS
 - DIMENSION P AND ELEVATIONS Y AND Z MUST MEET BOTH FLYGT AND ABS REQUIREMENTS.
 - ELEVATION X - ELEVATION Z ≥ 5 FEET
 - TOP ELEVATION OF WET WELL SHALL BE A MINIMUM OF 1' ABOVE THE 100 YEAR FLOOD ELEVATION AND THE ELEVATION OF THE CROWN OF THE ROAD.
 - SYMBOLS SHOWN IN TABLE ARE USED ON SECTION DRAWINGS ON THIS SHEET.

DESIGN SPECIFICATIONS			
MANUFACTURER: FLYGT	VOLTAGE: 460V		
MODEL: NP3127 HT3	PHASE: 3		
IMP: 488	H.P.: 10		
DIA: 215 MM	MAX. SOLID SIZE (3 IN MIN): 3.00 IN		
SPEED: 1720 RPM	CURVE NUMBER: 488		
DISCHARGE SIZE: 4 IN			
SHUT OFF HEAD: 83.1 FEET TDH			
HIGH HEAD CONDITION: 284 GPM AT 62 FEET TDH			
MINIMUM HEAD CONDITION: 460 GPM AT 51.2 FEET TDH			
DESCRIPTION	SYMBOL	DIMENSION	ELEVATION
THICKNESS OF WALL	A	EXISTING	—
DIAMETER OF WET WELL	B	6'	—
WIDTH OF BOTTOM FILLET	C	SEE NOTE 1	—
C/L OF WET WELL TO C/L OF PIPES	D	SEE NOTE 1	—
LENGTH OF PUMP ACCESS OPENING	E	SEE NOTE 1	—
WIDTH OF PUMP ACCESS OPENING	F	SEE NOTE 1	—
CENTER OF WET WELL TO EDGE OF HATCH	G	SEE NOTE 1	—
CONCRETE SLAB LENGTH	H	NA	—
CONCRETE SLAB WIDTH	I	NA	—
LIP WIDTH OF WETWELL BASE	R	EXISTING	—
THICKNESS OF WETWELL BASE	S	EXISTING	—
TOP OF WET WELL	T	—	90.00
SLAB GRADE	U	—	89.82
INFLUENT PIPE INVERT (LOWEST-NE)		—	72.75
HIGH LEVEL ALARMS	V	—	72.75
LAG PUMP ON	W	—	72.25
LEAD PUMP ON	X	—	71.25
PUMPS OFF (TOP OF PUMP VOLUTE)	Y	—	68.75
BOTTOM OF PUMP TO FLOOR OF WET WELL	P	—	—
STEP HEIGHT (IF REQUIRED)	Q	—	—
FLOOR OF WET WELL	Z	—	65.77

- NOTES:
- PER PUMP MANUFACTURER'S REQUIREMENTS
 - DIMENSION P AND ELEVATIONS Y AND Z MUST MEET BOTH FLYGT AND ABS REQUIREMENTS.
 - ELEVATION X - ELEVATION Z ≥ 5 FEET
 - TOP ELEVATION OF WET WELL SHALL BE A MINIMUM OF 1' ABOVE THE 100 YEAR FLOOD ELEVATION AND THE ELEVATION OF THE CROWN OF THE ROAD.
 - SYMBOLS SHOWN IN TABLE ARE USED ON SECTION DRAWINGS ON THIS SHEET.



REV	DATE	DESCRIPTION	BY
C	05/2019	ISSUED FOR BID	AJM
B	10/2018	90% DRAWINGS	AJM
A	08/2018	60% DRAWINGS	AJM

Issue Certification	
Designed	ARS
Drawn	AJM
Checked	MDP
Reviewed	JRV
Approved	MDP

Melanie D. Peckham, P.E.
Florida P.E. No. 66478




Designed	ARS
Drawn	AJM
Checked	MDP
Reviewed	JRV
Approved	MDP

ORANGE COUNTY
R/R PACKAGE 22 PUMP STATIONS
 MECHANICAL
PUMP STATION 3337 - WHISPER LAKES 7
PLAN AND SECTIONS

PROJECT NO.: 110034	
SCALE: NOTED	REVISION: C
DRAWING NO. P100	SHEET NO.: 20 OF 47

REISS ENGINEERING, INC.
 1016 SPRING VILLAS PT.
 WINTER SPRINGS, FL 32708
 (407) 679-5358
 CERTIFICATE OF AUTH. 8181

Rev on: 5/16/2019 10:04 AM Individual File Path: R:\Projects\110034 - Orange County R-R Package 22 Pump Stations\Design\FinalDesign\P200.dwg
 Parent Sheet Set: 1100340C_PKG22PS Rev/Plot by: JAY MILLER

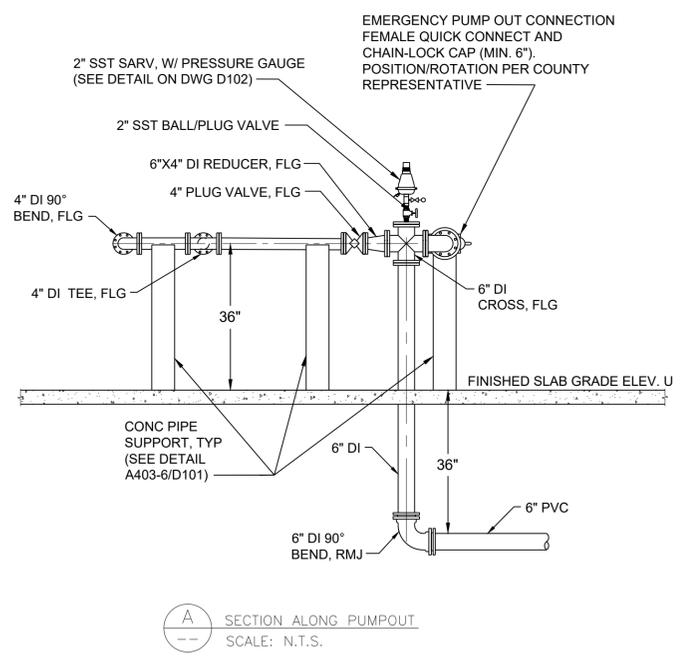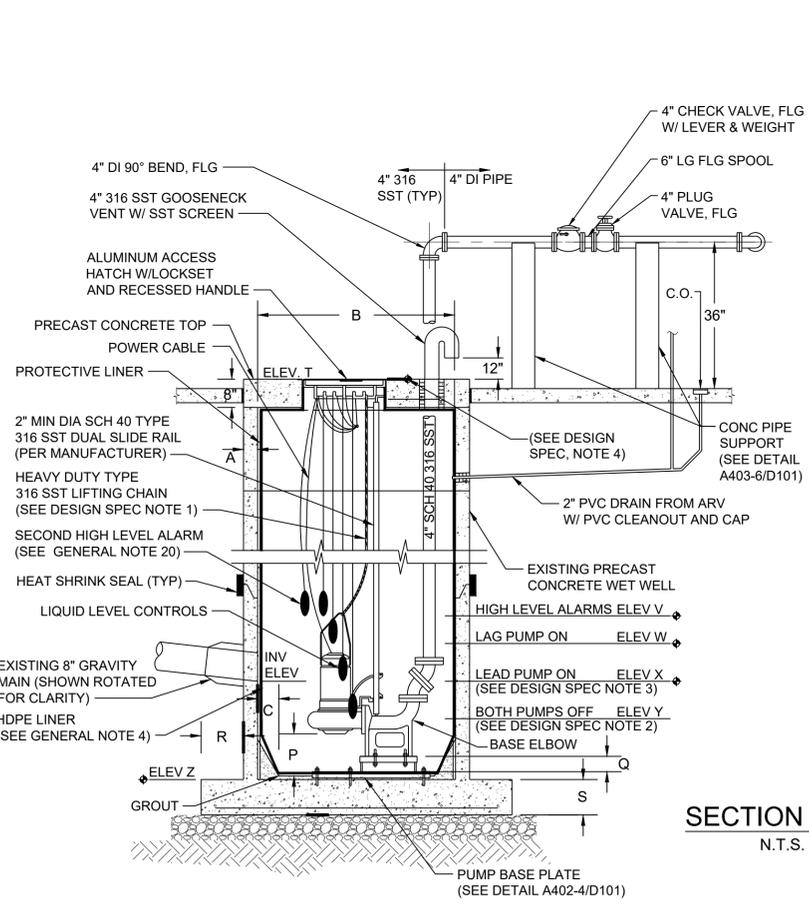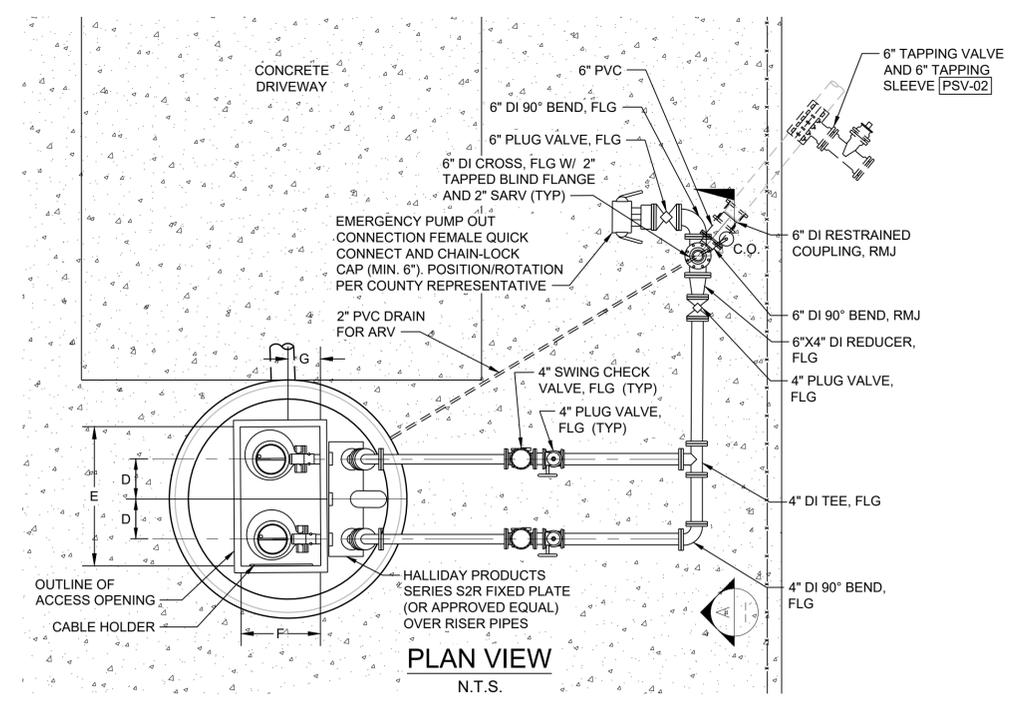

GENERAL NOTES

- ALL MATERIALS AND CONSTRUCTION SHALL BE IN ACCORDANCE WITH THE ORANGE COUNTY UTILITIES STANDARDS AND SPECIFICATIONS MANUAL (LATEST EDITION), AND/OR AS SPECIFIED HEREIN.
- ALL EXPOSED METAL OUTSIDE OF THE WET WELL SHALL BE PRIMED AND PAINTED IN ACCORDANCE WITH THE ORANGE COUNTY UTILITIES STANDARDS AND CONSTRUCTION SPECIFICATION MANUAL.
- A CRYSTALLINE WATER PROOFING ADMIXTURE SHALL BE ADDED TO THE CONCRETE DURING THE MIXING CYCLE FOR THE WET WELL PRECAST STRUCTURES. THE CRYSTALLINE WATER PROOFING ADMIXTURE SHALL BE APPROVED PRODUCT AS LISTED IN OCU APPENDIX D.
- THE INSIDE OF THE WET WELL SHALL BE LINED WITH EITHER A HIGH DENSITY POLYETHYLENE (HDPE) LINER, A POLYPROPYLENE RANDOM COPOLYMER (PP-R) LINING SYSTEM, OR AN ACCEPTABLE EQUAL AS LISTED IN OCU APPENDIX D. FINAL SEALS AND SEALING TO BE MADE IN THE FIELD.
- WET WELL ACCESS OPENING SHALL BE COVERED ON ALL FOUR VERTICAL SIDES WITH A PROTECTIVE LINER.
- WET WELL ACCESS HATCH AND COVER SHALL BE ALUMINUM, WITH 316 STAINLESS STEEL HARDWARE AND LOCK BRACKET PLATE WITH THE WORDS "CONFINED SPACE" STAMPED (ETCHED) ON THE TOP SIDE. EACH DOOR WILL BE EQUIPPED WITH RECESSED HASP ENCLOSURE.
- ALL HARDWARE IN THE WET WELL SHALL BE 316 STAINLESS STEEL.
- THERE SHALL BE NO VALVES OR ELECTRICAL JUNCTION BOXES IN THE WET WELL.
- ALL PIPING AND CONDUIT PENETRATIONS THROUGH CONCRETE SHALL BE WATERTIGHT. CAST-IN-PLACE SLEEVES SHALL BE PLACED IN ALL OPENINGS WHERE PRESSURE PIPE ENTER OR LEAVE THE WET WELL. PENETRATIONS THROUGH WET WELL SHALL BE A COMPRESSION TYPE SEAL, SUCH AS "LINK-SEAL", OR AN ACCEPTABLE EQUAL AS LISTED IN OCU APPENDIX D.
- ALL CONNECTIONS WITHIN THE WET WELL SHALL BE FLANGED JOINTS. ALL REMAINING JOINTS BETWEEN THE WET WELL AND THE CONNECTION TO THE EXISTING FORCE MAIN SHALL BE RESTRAINED MECHANICAL JOINTS. (SEE TABLE ON DETAIL SHEET D100).
- ALL PIPING WITHIN THE WET WELL SHALL BE STAINLESS STEEL 316 SCHEDULE 40.
- PIPE SUPPORTS SHALL BE CONCRETE, PROVIDED AND INSTALLED TO SUPPORT AND ANCHOR THE PIPING SECURELY.
- CONTRACTOR SHALL, AS DIRECTED BY THE COUNTY REPRESENTATIVE, REMOVE AND SALVAGE TO THE COUNTY, ALL EXISTING PUMP STATION EQUIPMENT, INCLUDING PUMPS, CHECK VALVES, SHUTOFF VALVES, AND CONTROL PANEL.
- CONTRACTOR SHALL DEMOLISH AND REMOVE FROM SITE ALL DEBRIS RESULTING FROM THE REMOVAL OF THE EXISTING STRUCTURES.
- CONTRACTOR SHALL VERIFY ALL DIMENSIONS AND ELEVATIONS PRIOR TO ORDERING ANY MATERIALS OR EQUIPMENT.
- CONTRACTOR SHALL GROUT FLOOR OF WET WELL, AS REQUIRED BY MANUFACTURER'S SPECIFICATIONS, TO ACCOMMODATE INSTALLATION OF THE NEW PUMPS.
- STRUCTURAL DESIGN OF THE PRECAST WET WELL, TOP SHALL BE THE RESPONSIBILITY OF THE PRECAST MANUFACTURER. CONTRACTOR SHALL SUBMIT SHOP DRAWINGS FOR THE PRECAST WET WELL, THE PRECAST LINED WET WELL TOP AND HATCH COVER, AND RISERS, TO THE ENGINEER.
- 100-YEAR FLOOD ELEVATION: OUT OF THE 100-YEAR FLOOD ZONE.
- ALL EXTERNAL JOINTS OF THE WET WELL SHALL BE COVERED WITH A HIGH STRENGTH, WATER TIGHT, PRESS-TO-SEAL TYPE TAPE/AS LISTED IN OCU APPENDIX D.
- A SECOND HIGH LEVEL ALARM LIQUID FLOAT SHALL BE INSTALLED TO PROVIDE DRY CONTACT FOR SCADA. REFER TO PUMP CONTROL SCHEMATIC.
- ALL SPOOLS SHALL BE MINIMUM OF SIX INCHES WHERE SPACE ALLOWS.
- CONTRACTOR SHALL BE RESPONSIBLE FOR ALIGNMENT FROM THE BASE PLATE TO THE BASE ELBOW AT NO EXTRA COST TO OCU.

DESIGN SPECIFICATIONS			
MANUFACTURER: ABS	VOLTAGE: 460V		
MODEL: XFP	PHASE: 3		
IMP: 100E CB1.3	H.P.: 14.1		
DIA: 225 MM	MAX. SOLID SIZE (3 IN MIN): 3.00 IN		
SPEED: 1750 RPM	CURVE NUMBER: 105/4 60HZ		
DISCHARGE SIZE: 4 IN			
SHUT OFF HEAD: 95.2 FEET TDH			
HIGH HEAD CONDITION: 280 GPM AT 71 FEET TDH			
MINIMUM HEAD CONDITION: 530 GPM AT 60 FEET TDH			
DESCRIPTION	SYMBOL	DIMENSION	ELEVATION
THICKNESS OF WALL	A	8"	--
DIAMETER OF WET WELL	B	6'	--
WIDTH OF BOTTOM FILLET	C	SEE NOTE 1	--
C/L OF WET WELL TO C/L OF PIPES	D	SEE NOTE 1	--
LENGTH OF PUMP ACCESS OPENING	E	SEE NOTE 1	--
WIDTH OF PUMP ACCESS OPENING	F	SEE NOTE 1	--
CENTER OF WET WELL TO EDGE OF HATCH	G	SEE NOTE 1	--
CONCRETE SLAB LENGTH	H	NA	--
CONCRETE SLAB WIDTH	I	NA	--
LIP WIDTH OF WETWELL BASE	R	18"	--
THICKNESS OF WETWELL BASE	S	12"	--
TOP OF WET WELL	T	--	88.25
SLAB GRADE	U	--	88.05
INFLUENT PIPE INVERT			71.00
HIGH LEVEL ALARMS	V	--	71.00
LAG PUMP ON	W	--	70.50
LEAD PUMP ON	X	--	69.50
PUMPS OFF (TOP OF PUMP VOLUTE)	Y	--	67.00
BOTTOM OF PUMP TO FLOOR OF WET WELL	P	--	--
STEP HEIGHT (IF REQUIRED)	Q	--	--
FLOOR OF WET WELL	Z	--	64.00

NOTES:
 1. PER PUMP MANUFACTURER'S REQUIREMENTS
 2. DIMENSION P AND ELEVATIONS Y AND Z MUST MEET BOTH FLYGT AND ABS REQUIREMENTS.
 3. ELEVATION X - ELEVATION Z ≥ 5 FEET
 4. TOP ELEVATION OF WET WELL SHALL BE A MINIMUM OF 1' ABOVE THE 100 YEAR FLOOD ELEVATION AND THE ELEVATION OF THE CROWN OF THE ROAD.
 5. SYMBOLS SHOWN IN TABLE ARE USED ON SECTION DRAWINGS ON THIS SHEET.

DESIGN SPECIFICATIONS			
MANUFACTURER: FLYGT	VOLTAGE: 460V		
MODEL: NP3153 HT3	PHASE: 3		
IMP: 465	H.P.: 12.0		
DIA: 239 MM	MAX. SOLID SIZE (3 IN MIN): 3.00 IN		
SPEED: 1765 RPM	CURVE NUMBER: 465		
DISCHARGE SIZE: 4 IN			
SHUT OFF HEAD: 98.8 FEET TDH			
HIGH HEAD CONDITION: 288 GPM AT 74.1 FEET TDH			
MINIMUM HEAD CONDITION: 510 GPM AT 56.9 FEET TDH			
DESCRIPTION	SYMBOL	DIMENSION	ELEVATION
THICKNESS OF WALL	A	8"	--
DIAMETER OF WET WELL	B	6'	--
WIDTH OF BOTTOM FILLET	C	SEE NOTE 1	--
C/L OF WET WELL TO C/L OF PIPES	D	SEE NOTE 1	--
LENGTH OF PUMP ACCESS OPENING	E	SEE NOTE 1	--
WIDTH OF PUMP ACCESS OPENING	F	SEE NOTE 1	--
CENTER OF WET WELL TO EDGE OF HATCH	G	SEE NOTE 1	--
CONCRETE SLAB LENGTH	H	NA	--
CONCRETE SLAB WIDTH	I	NA	--
LIP WIDTH OF WETWELL BASE	R	18"	--
THICKNESS OF WETWELL BASE	S	12"	--
TOP OF WET WELL	T	--	88.25
SLAB GRADE	U	--	88.05
INFLUENT PIPE INVERT			71.00
HIGH LEVEL ALARMS	V	--	71.00
LAG PUMP ON	W	--	70.50
LEAD PUMP ON	X	--	69.50
PUMPS OFF (TOP OF PUMP VOLUTE)	Y	--	67.00
BOTTOM OF PUMP TO FLOOR OF WET WELL	P	--	--
STEP HEIGHT (IF REQUIRED)	Q	--	--
FLOOR OF WET WELL	Z	--	64.00

NOTES:
 1. PER PUMP MANUFACTURER'S REQUIREMENTS
 2. DIMENSION P AND ELEVATIONS Y AND Z MUST MEET BOTH FLYGT AND ABS REQUIREMENTS.
 3. ELEVATION X - ELEVATION Z ≥ 5 FEET
 4. TOP ELEVATION OF WET WELL SHALL BE A MINIMUM OF 1' ABOVE THE 100 YEAR FLOOD ELEVATION AND THE ELEVATION OF THE CROWN OF THE ROAD.
 5. SYMBOLS SHOWN IN TABLE ARE USED ON SECTION DRAWINGS ON THIS SHEET.



REV	DATE	DESCRIPTION	BY
C	05/2019	ISSUED FOR BID	AJM
B	10/2018	90% DRAWINGS	AJM
A	08/2018	60% DRAWINGS	AJM


Issue Certification	Designed: ARS
	Drawn: AJM
	Checked: MDP
	Reviewed: JRV
	Approved: MDP
Melanie D. Peckham, P.E. Florida P.E. No. 66478	LINE IS 1" AT FULL SIZE

ORANGE COUNTY
 R/R PACKAGE 22 PUMP STATIONS
 MECHANICAL
PUMP STATION 3351 - WHISPER LAKES 4
 PLAN AND SECTIONS


PROJECT NO.:	110034
SCALE:	NOTED
REVISION:	C
DRAWING NO.:	P200
SHEET NO.:	21 OF 47

REISS ENGINEERING, INC.
 1016 SPRING VILLAS PT.
 WINTER SPRINGS, FL 32708
 (407) 679-5358
 CERTIFICATE OF AUTH. 8181


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PLAN VIEW
N.T.S.

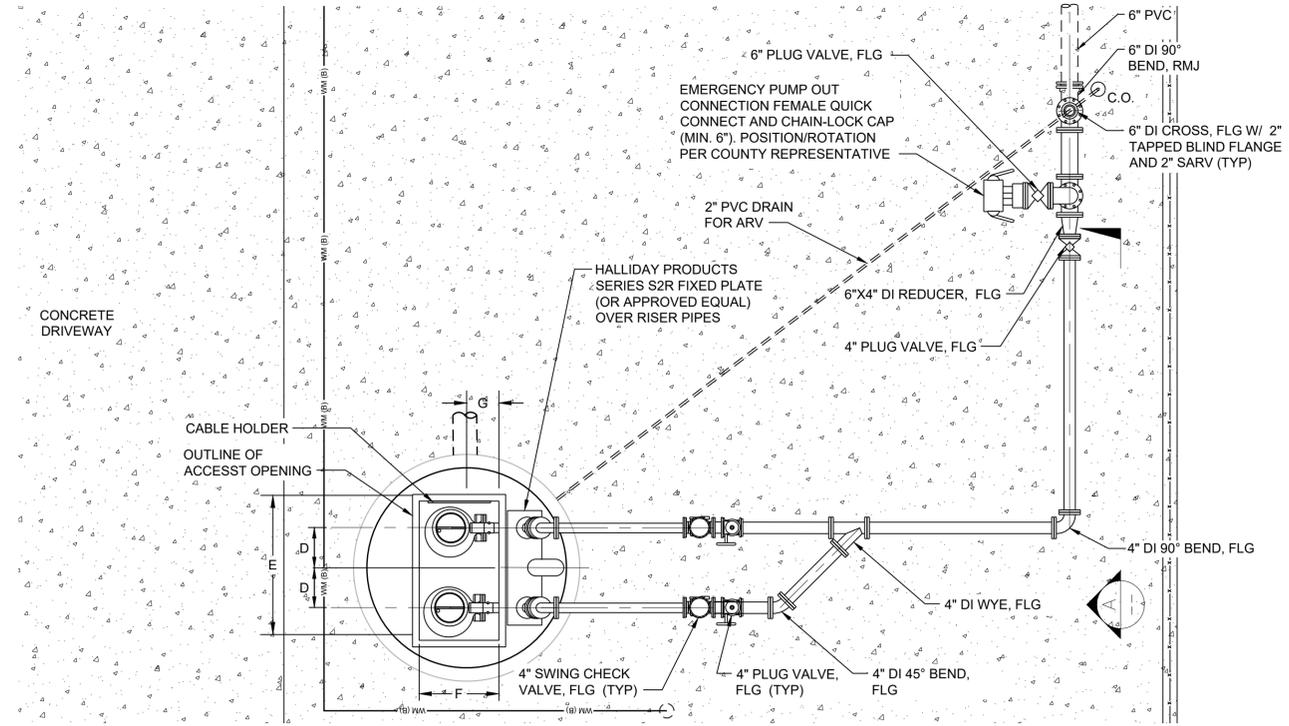

SECTION VIEW
N.T.S.

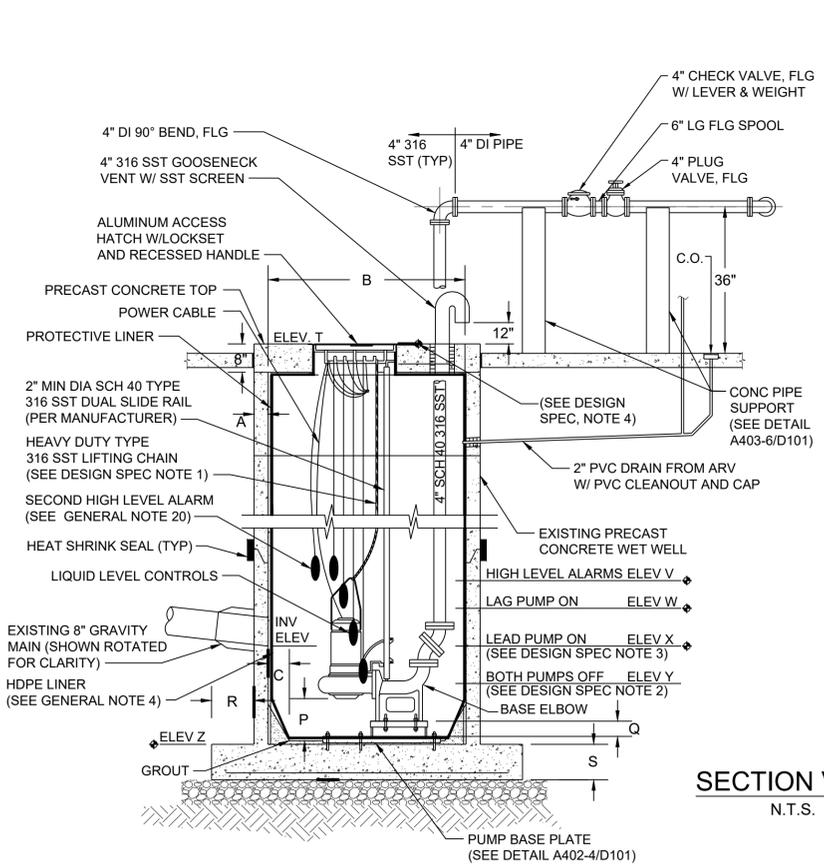

SECTION ALONG PUMPOUT
SCALE: N.T.S.

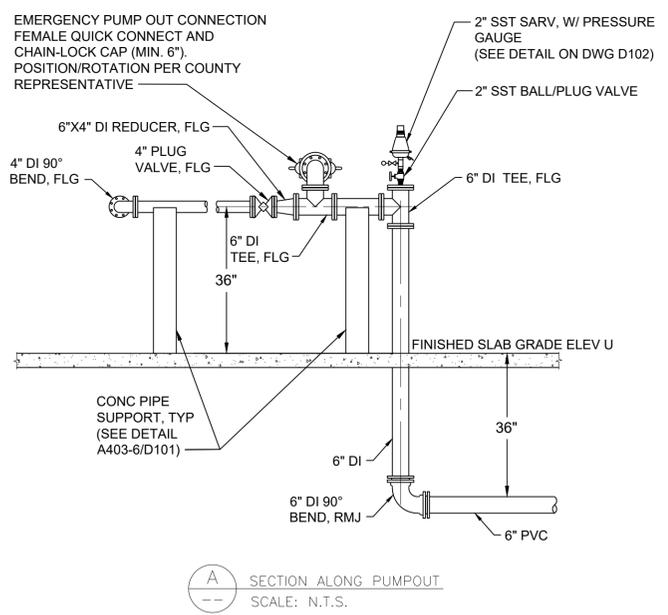GENERAL NOTES

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- THE INSIDE OF THE WET WELL SHALL BE LINED WITH EITHER A HIGH DENSITY POLYETHYLENE (HDPE) LINER, A POLYPROPYLENE RANDOM COPOLYMER (PP-R) LINING SYSTEM, OR AN ACCEPTABLE EQUAL AS LISTED IN OCU APPENDIX D. FINAL SEALS AND SEALING TO BE MADE IN THE FIELD.
- WET WELL ACCESS OPENING SHALL BE COVERED ON ALL FOUR VERTICAL SIDES WITH A PROTECTIVE LINER.
- WET WELL ACCESS HATCH AND COVER SHALL BE ALUMINUM, WITH 316 STAINLESS STEEL HARDWARE AND LOCK BRACKET PLATE WITH THE WORDS "CONFINED SPACE" STAMPED (ETCHED) ON THE TOP SIDE. EACH DOOR WILL BE EQUIPPED WITH RECESSED HASP ENCLOSURE.
- ALL HARDWARE IN THE WET WELL SHALL BE 316 STAINLESS STEEL.
- THERE SHALL BE NO VALVES OR ELECTRICAL JUNCTION BOXES IN THE WET WELL.
- ALL PIPING AND CONDUIT PENETRATIONS THROUGH CONCRETE SHALL BE WATERTIGHT. CAST-IN-PLACE SLEEVES SHALL BE PLACED IN ALL OPENINGS WHERE PRESSURE PIPE ENTER OR LEAVE THE WET WELL. PENETRATIONS THROUGH WET WELL SHALL BE A COMPRESSION TYPE SEAL, SUCH AS "LINK-SEAL", OR AN ACCEPTABLE EQUAL AS LISTED IN OCU APPENDIX D.
- ALL CONNECTIONS WITHIN THE WET WELL SHALL BE FLANGED JOINTS. ALL REMAINING JOINTS BETWEEN THE WET WELL AND THE CONNECTION TO THE EXISTING FORCE MAIN SHALL BE RESTRAINED MECHANICAL JOINTS. (SEE TABLE ON DETAIL SHEET D100).
- ALL PIPING WITHIN THE WET WELL SHALL BE STAINLESS STEEL 316 SCHEDULE 40.
- PIPE SUPPORTS SHALL BE CONCRETE, PROVIDED AND INSTALLED TO SUPPORT AND ANCHOR THE PIPING SECURELY.
- CONTRACTOR SHALL, AS DIRECTED BY THE COUNTY REPRESENTATIVE, REMOVE AND SALVAGE TO THE COUNTY, ALL EXISTING PUMP STATION EQUIPMENT, INCLUDING PUMPS, CHECK VALVES, SHUTOFF VALVES, AND CONTROL PANEL.
- CONTRACTOR SHALL DEMOLISH AND REMOVE FROM SITE ALL DEBRIS RESULTING FROM THE REMOVAL OF THE EXISTING STRUCTURES.
- CONTRACTOR SHALL VERIFY ALL DIMENSIONS AND ELEVATIONS PRIOR TO ORDERING ANY MATERIALS OR EQUIPMENT.
- CONTRACTOR SHALL GROUT FLOOR OF WET WELL, AS REQUIRED BY MANUFACTURER'S SPECIFICATIONS, TO ACCOMMODATE INSTALLATION OF THE NEW PUMPS.
- STRUCTURAL DESIGN OF THE PRECAST WET WELL, TOP SHALL BE THE RESPONSIBILITY OF THE PRECAST MANUFACTURER. CONTRACTOR SHALL SUBMIT SHOP DRAWINGS FOR THE PRECAST WET WELL, THE PRECAST LINED WET WELL TOP AND HATCH COVER, AND RISERS, TO THE ENGINEER.
- 100-YEAR FLOOD ELEVATION: OUT OF THE 100-YEAR FLOOD ZONE.
- ALL EXTERNAL JOINTS OF THE WET WELL SHALL BE COVERED WITH A HIGH STRENGTH, WATER TIGHT, PRESS-TO-SEAL TYPE TAPE/AS LISTED IN OCU APPENDIX D.
- A SECOND HIGH LEVEL ALARM LIQUID FLOAT SHALL BE INSTALLED TO PROVIDE DRY CONTACT FOR SCADA. REFER TO PUMP CONTROL SCHEMATIC.
- ALL SPOOLS SHALL BE MINIMUM OF SIX INCHES WHERE SPACE ALLOWS.
- CONTRACTOR SHALL BE RESPONSIBLE FOR ALIGNMENT FROM THE BASE PLATE TO THE BASE ELBOW AT NO EXTRA COST TO OCU.

DESIGN SPECIFICATIONS			
MANUFACTURER: ABS	VOLTAGE: 230V		
MODEL: XFP	PHASE: 3		
IMP: 100E CB1.5	H.P.: 7.5		
DIA: 195 MM	MAX. SOLID SIZE (3 IN MIN): 3.00 IN		
SPEED: 1780 RPM	CURVE NUMBER: PE56/4-E-60HZ		
DISCHARGE SIZE: 4 IN			
SHUT OFF HEAD: 62.7 FEET TDH			
HIGH HEAD CONDITION: 325 GPM AT 44 FEET TDH			
MINIMUM HEAD CONDITION: 480 GPM AT 37 FEET TDH			
DESCRIPTION	SYMBOL	DIMENSION	ELEVATION
THICKNESS OF WALL	A	EXISTING	--
DIAMETER OF WET WELL	B	6'	--
WIDTH OF BOTTOM FILLET	C	SEE NOTE 1	--
C/L OF WET WELL TO C/L OF PIPES	D	SEE NOTE 1	--
LENGTH OF PUMP ACCESS OPENING	E	SEE NOTE 1	--
WIDTH OF PUMP ACCESS OPENING	F	SEE NOTE 1	--
CENTER OF WET WELL TO EDGE OF HATCH	G	SEE NOTE 1	--
HATCH OPENING	I	4'-8"	--
LIP WIDTH OF WETWELL BASE	R	EXISTING	--
THICKNESS OF WETWELL BASE	S	EXISTING	--
TOP OF WET WELL	T	--	91.10
SLAB GRADE	U	--	90.82
INFLUENT PIPE INVERT			75.51
HIGH LEVEL ALARMS	V	--	75.50
LAG PUMP ON	W	--	75.00
LEAD PUMP ON	X	--	74.50
PUMPS OFF (TOP OF PUMP VOLUTE)	Y	--	72.00
BOTTOM OF PUMP TO FLOOR OF WET WELL	P	--	--
STEP HEIGHT (IF REQUIRED)	Q	--	--
FLOOR OF WET WELL	Z	--	69.48

NOTES:
 1. PER PUMP MANUFACTURER'S REQUIREMENTS
 2. DIMENSION P AND ELEVATIONS Y AND Z MUST MEET BOTH FLYGT AND ABS REQUIREMENTS.
 3. ELEVATION X - ELEVATION Z ≥ 5 FEET
 4. TOP ELEVATION OF WET WELL SHALL BE A MINIMUM OF 1' ABOVE THE 100 YEAR FLOOD ELEVATION AND THE ELEVATION OF THE CROWN OF THE ROAD.
 5. SYMBOLS SHOWN IN TABLE ARE USED ON SECTION DRAWINGS ON THIS SHEET.

DESIGN SPECIFICATIONS			
MANUFACTURER: FLYGT	VOLTAGE: 230V		
MODEL: NP3127 MT3	PHASE: 3		
IMP: 439	H.P.: 7.5		
DIA: 188 MM	MAX. SOLID SIZE (3 IN MIN): 3.00 IN		
SPEED: 1740 RPM	CURVE NUMBER: 439		
DISCHARGE SIZE: 4 IN			
SHUT OFF HEAD: 59.0 FEET TDH			
HIGH HEAD CONDITION: 297 GPM AT 44 FEET TDH			
MINIMUM HEAD CONDITION: 488 GPM AT 36.8 FEET TDH			
DESCRIPTION	SYMBOL	DIMENSION	ELEVATION
THICKNESS OF WALL	A	EXISTING	--
DIAMETER OF WET WELL	B	6'	--
WIDTH OF BOTTOM FILLET	C	SEE NOTE 1	--
C/L OF WET WELL TO C/L OF PIPES	D	SEE NOTE 1	--
LENGTH OF PUMP ACCESS OPENING	E	SEE NOTE 1	--
WIDTH OF PUMP ACCESS OPENING	F	SEE NOTE 1	--
CENTER OF WET WELL TO EDGE OF HATCH	G	SEE NOTE 1	--
HATCH OPENING	I	4'-8"	--
LIP WIDTH OF WETWELL BASE	R	EXISTING	--
THICKNESS OF WETWELL BASE	S	EXISTING	--
TOP OF WET WELL	T	--	91.10
SLAB GRADE	U	--	90.82
INFLUENT PIPE INVERT			75.51
HIGH LEVEL ALARMS	V	--	75.50
LAG PUMP ON	W	--	75.00
LEAD PUMP ON	X	--	74.50
PUMPS OFF (TOP OF PUMP VOLUTE)	Y	--	72.00
BOTTOM OF PUMP TO FLOOR OF WET WELL	P	--	--
STEP HEIGHT (IF REQUIRED)	Q	--	--
FLOOR OF WET WELL	Z	--	69.48

NOTES:
 1. PER PUMP MANUFACTURER'S REQUIREMENTS
 2. DIMENSION P AND ELEVATIONS Y AND Z MUST MEET BOTH FLYGT AND ABS REQUIREMENTS.
 3. ELEVATION X - ELEVATION Z ≥ 5 FEET
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 5. SYMBOLS SHOWN IN TABLE ARE USED ON SECTION DRAWINGS ON THIS SHEET.



REV	DATE	DESCRIPTION	BY
C	05/2019	ISSUED FOR BID	AJM
B	10/2018	90% DRAWINGS	AJM
A	08/2018	60% DRAWINGS	AJM

Issue Certification	Designed: ARS
	Drawn: AJM
	Checked: MDP
	Reviewed: JRV
	Approved: MDP
Melanie D. Peckham, P.E. Florida P.E. No. 66478	


Scale: 1" = 1'-0"

ORANGE COUNTY
 R/R PACKAGE 22 PUMP STATIONS
 MECHANICAL
PUMP STATION 3301 - PEPPER MILL 4
 PLAN AND SECTIONS


PROJECT NO.: 110034
SCALE: NOTED
DRAWING NO. P300
REVISION: C
SHEET NO.: 22 OF 47

REISS ENGINEERING, INC.
 1016 SPRING VILLAS PT.
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 (407) 679-5358
 CERTIFICATE OF AUTH. 8181


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 Parent Sheet Set: 1100340C_PKG22PS Rev/Plot by: JAY MILLER

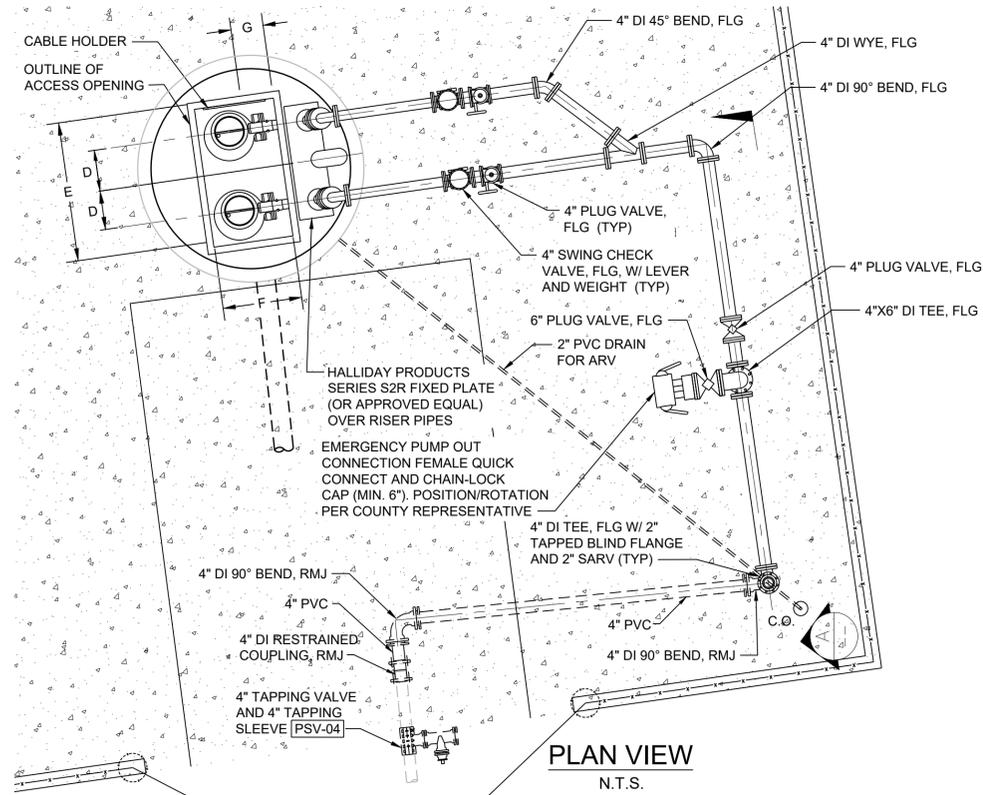

PLAN VIEW
N.T.S.

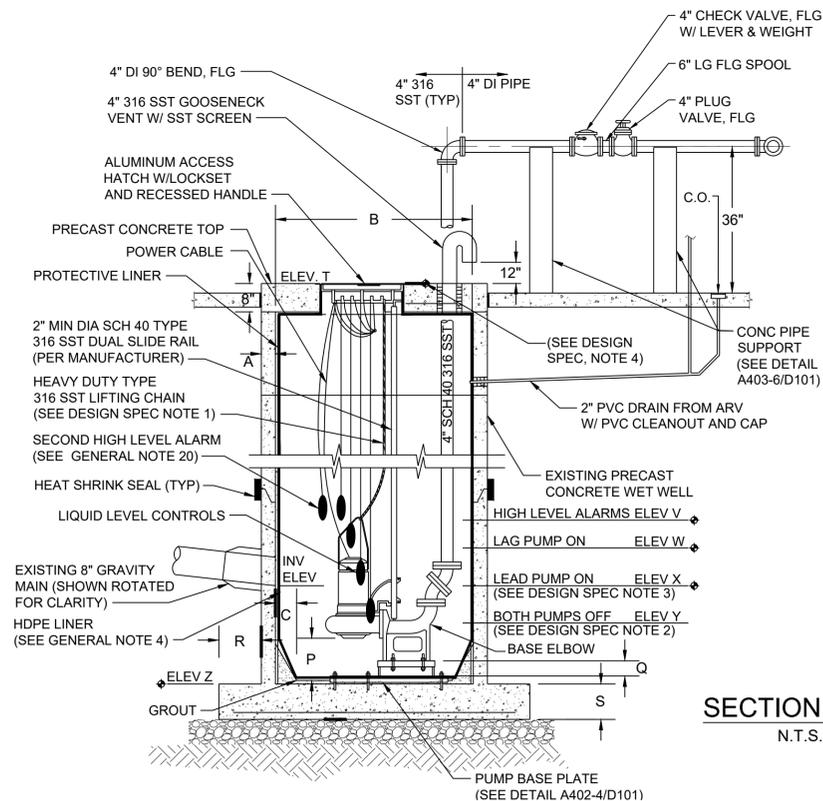

SECTION VIEW
N.T.S.

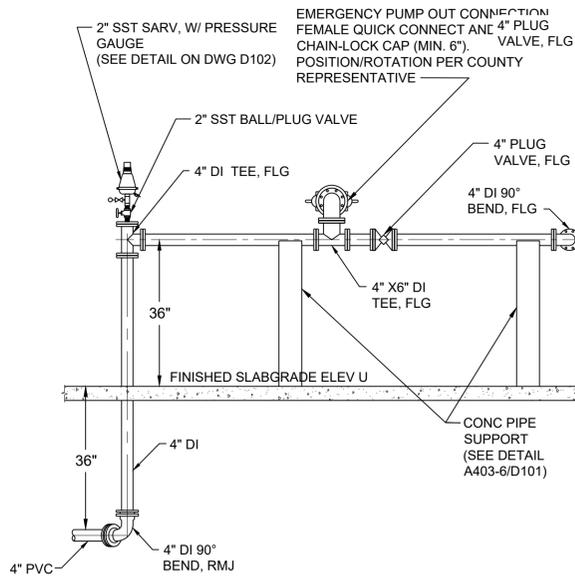

SECTION A-A
SCALE: N.T.S.

GENERAL NOTES

- ALL MATERIALS AND CONSTRUCTION SHALL BE IN ACCORDANCE WITH THE ORANGE COUNTY UTILITIES STANDARDS AND SPECIFICATIONS MANUAL (LATEST EDITION), AND/OR AS SPECIFIED HEREIN.
- ALL EXPOSED METAL OUTSIDE OF THE WET WELL SHALL BE PRIMED AND PAINTED IN ACCORDANCE WITH THE ORANGE COUNTY UTILITIES STANDARDS AND CONSTRUCTION SPECIFICATION MANUAL.
- A CRYSTALLINE WATER PROOFING ADMIXTURE SHALL BE ADDED TO THE CONCRETE DURING THE MIXING CYCLE FOR THE WET WELL PRECAST STRUCTURES. THE CRYSTALLINE WATER PROOFING ADMIXTURE SHALL BE APPROVED PRODUCT AS LISTED IN OCU APPENDIX D.
- THE INSIDE OF THE WET WELL SHALL BE LINED WITH EITHER A HIGH DENSITY POLYETHYLENE (HDPE) LINER, A POLYPROPYLENE RANDOM COPOLYMER (PP-R) LINING SYSTEM, OR AN ACCEPTABLE EQUAL AS LISTED IN OCU APPENDIX D. FINAL SEALS AND SEALING TO BE MADE IN THE FIELD.
- WET WELL ACCESS OPENING SHALL BE COVERED ON ALL FOUR VERTICAL SIDES WITH A PROTECTIVE LINER.
- WET WELL ACCESS HATCH AND COVER SHALL BE ALUMINUM, WITH 316 STAINLESS STEEL HARDWARE AND LOCK BRACKET PLATE WITH THE WORDS "CONFINED SPACE" STAMPED (ETCHED) ON THE TOP SIDE. EACH DOOR WILL BE EQUIPPED WITH RECESSED HASP ENCLOSURE.
- ALL HARDWARE IN THE WET WELL SHALL BE 316 STAINLESS STEEL.
- THERE SHALL BE NO VALVES OR ELECTRICAL JUNCTION BOXES IN THE WET WELL.
- ALL PIPING AND CONDUIT PENETRATIONS THROUGH CONCRETE SHALL BE WATERTIGHT. CAST-IN-PLACE SLEEVES SHALL BE PLACED IN ALL OPENINGS WHERE PRESSURE PIPE ENTER OR LEAVE THE WET WELL. PENETRATIONS THROUGH WET WELL SHALL BE A COMPRESSION TYPE SEAL, SUCH AS "LINK-SEAL", OR AN ACCEPTABLE EQUAL AS LISTED IN OCU APPENDIX D.
- ALL CONNECTIONS WITHIN THE WET WELL SHALL BE FLANGED JOINTS. ALL REMAINING JOINTS BETWEEN THE WET WELL AND THE CONNECTION TO THE EXISTING FORCE MAIN SHALL BE RESTRAINED MECHANICAL JOINTS. (SEE TABLE ON DETAIL SHEET D100).
- ALL PIPING WITHIN THE WET WELL SHALL BE STAINLESS STEEL 316 SCHEDULE 40.
- PIPE SUPPORTS SHALL BE CONCRETE, PROVIDED AND INSTALLED TO SUPPORT AND ANCHOR THE PIPING SECURELY.
- CONTRACTOR SHALL, AS DIRECTED BY THE COUNTY REPRESENTATIVE, REMOVE AND SALVAGE TO THE COUNTY, ALL EXISTING PUMP STATION EQUIPMENT, INCLUDING PUMPS, CHECK VALVES, SHUTOFF VALVES, AND CONTROL PANEL.
- CONTRACTOR SHALL DEMOLISH AND REMOVE FROM SITE ALL DEBRIS RESULTING FROM THE REMOVAL OF THE EXISTING STRUCTURES.
- CONTRACTOR SHALL VERIFY ALL DIMENSIONS AND ELEVATIONS PRIOR TO ORDERING ANY MATERIALS OR EQUIPMENT.
- CONTRACTOR SHALL GROUT FLOOR OF WET WELL, AS REQUIRED BY MANUFACTURER'S SPECIFICATIONS, TO ACCOMMODATE INSTALLATION OF THE NEW PUMPS.
- STRUCTURAL DESIGN OF THE PRECAST WET WELL, TOP SHALL BE THE RESPONSIBILITY OF THE PRECAST MANUFACTURER. CONTRACTOR SHALL SUBMIT SHOP DRAWINGS FOR THE PRECAST WET WELL, THE PRECAST LINED WET WELL TOP AND HATCH COVER, AND RISERS, TO THE ENGINEER.
- 100-YEAR FLOOD ELEVATION: OUT OF THE 100-YEAR FLOOD ZONE.
- ALL EXTERNAL JOINTS OF THE WET WELL SHALL BE COVERED WITH A HIGH STRENGTH, WATER TIGHT, PRESS-TO-SEAL TYPE TAPE/AS LISTED IN OCU APPENDIX D.
- A SECOND HIGH LEVEL ALARM LIQUID FLOAT SHALL BE INSTALLED TO PROVIDE DRY CONTACT FOR SCADA. REFER TO PUMP CONTROL SCHEMATIC.
- ALL SPOOLS SHALL BE MINIMUM OF SIX INCHES WHERE SPACE ALLOWS.
- CONTRACTOR SHALL BE RESPONSIBLE FOR ALIGNMENT FROM THE BASE PLATE TO THE BASE ELBOW AT NO EXTRA COST TO OCU.

DESIGN SPECIFICATIONS

MANUFACTURER: ABS
MODEL: XFP
IMP: 100C CB1.4
DIA: 180 MM
SPEED: 1730 RPM
DISCHARGE SIZE: 4 IN
VOLTAGE: 230V
PHASE: 3
H.P.: 4.7
MAX. SOLID SIZE (3 IN MIN): 3.00 IN
CURVE NUMBER: PE35/4 60HZ
SHUT OFF HEAD: 48.8 FEET TDH
HIGH HEAD CONDITION: 130 GPM AT 43 FEET TDH
MINIMUM HEAD CONDITION: 175 GPM AT 39.5 FEET TDH

DESCRIPTION	SYMBOL	DIMENSION	ELEVATION
THICKNESS OF WALL	A	EXISTING	--
DIAMETER OF WET WELL	B	6'	--
WIDTH OF BOTTOM FILLET	C	SEE NOTE 1	--
C/L OF WET WELL TO C/L OF PIPES	D	SEE NOTE 1	--
LENGTH OF PUMP ACCESS OPENING	E	SEE NOTE 1	--
WIDTH OF PUMP ACCESS OPENING	F	SEE NOTE 1	--
CENTER OF WET WELL TO EDGE OF HATCH	G	SEE NOTE 1	--
HATCH OPENING	I	4'-8"	--
LIP WIDTH OF WETWELL BASE	R	EXISTING	--
THICKNESS OF WETWELL BASE	S	EXISTING	--
TOP OF WET WELL	T	--	86.18
SLAB GRADE	U	--	86.00
INFLUENT PIPE INVERT	--	--	71.34
HIGH LEVEL ALARMS	V	--	71.50
LAG PUMP ON	W	--	71.00
LEAD PUMP ON	X	--	70.00
PUMPS OFF (TOP OF PUMP VOLUTE)	Y	--	69.00
BOTTOM OF PUMP TO FLOOR OF WET WELL	P	--	--
STEP HEIGHT (IF REQUIRED)	Q	--	--
FLOOR OF WET WELL	Z	--	64.92

- NOTES:**
- PER PUMP MANUFACTURER'S REQUIREMENTS
 - DIMENSION P AND ELEVATIONS Y AND Z MUST MEET BOTH FLYGT AND ABS REQUIREMENTS.
 - ELEVATION X - ELEVATION Z ≥ 5 FEET
 - TOP ELEVATION OF WET WELL SHALL BE A MINIMUM OF 1' ABOVE THE 100 YEAR FLOOD ELEVATION AND THE ELEVATION OF THE CROWN OF THE ROAD.
 - SYMBOLS SHOWN IN TABLE ARE USED ON SECTION DRAWINGS ON THIS SHEET.

DESIGN SPECIFICATIONS

MANUFACTURER: FLYGT
MODEL: NP3102 MT3
IMP: 463
DIA: 172 MM
SPEED: 1745 RPM
DISCHARGE SIZE: 4 IN
VOLTAGE: 230V
PHASE: 3
H.P.: 5.0
MAX. SOLID SIZE (3 IN MIN): 3.00 IN
CURVE NUMBER: 483
SHUT OFF HEAD: 51.5 FEET TDH
HIGH HEAD CONDITION: 127 GPM AT 43.2 FEET TDH
MINIMUM HEAD CONDITION: 180 GPM AT 40.2 FEET TDH

DESCRIPTION	SYMBOL	DIMENSION	ELEVATION
THICKNESS OF WALL	A	EXISTING	--
DIAMETER OF WET WELL	B	6'	--
WIDTH OF BOTTOM FILLET	C	SEE NOTE 1	--
C/L OF WET WELL TO C/L OF PIPES	D	SEE NOTE 1	--
LENGTH OF PUMP ACCESS OPENING	E	SEE NOTE 1	--
WIDTH OF PUMP ACCESS OPENING	F	SEE NOTE 1	--
CENTER OF WET WELL TO EDGE OF HATCH	G	SEE NOTE 1	--
HATCH OPENING	I	4'-8"	--
LIP WIDTH OF WETWELL BASE	R	EXISTING	--
THICKNESS OF WETWELL BASE	S	EXISTING	--
TOP OF WET WELL	T	--	86.18
SLAB GRADE	U	--	86.00
INFLUENT PIPE INVERT	--	--	71.34
HIGH LEVEL ALARMS	V	--	71.50
LAG PUMP ON	W	--	71.00
LEAD PUMP ON	X	--	70.00
PUMPS OFF (TOP OF PUMP VOLUTE)	Y	--	69.00
BOTTOM OF PUMP TO FLOOR OF WET WELL	P	--	--
STEP HEIGHT (IF REQUIRED)	Q	--	--
FLOOR OF WET WELL	Z	--	64.92

- NOTES:**
- PER PUMP MANUFACTURER'S REQUIREMENTS
 - DIMENSION P AND ELEVATIONS Y AND Z MUST MEET BOTH FLYGT AND ABS REQUIREMENTS.
 - ELEVATION X - ELEVATION Z ≥ 5 FEET
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 - SYMBOLS SHOWN IN TABLE ARE USED ON SECTION DRAWINGS ON THIS SHEET.



REV	DATE	DESCRIPTION	BY
C	05/2019	ISSUED FOR BID	AJM
B	10/2018	90% DRAWINGS	AJM
A	08/2018	60% DRAWINGS	AJM

Issue Certification
 Designed: ARS
 Drawn: AJM
 Checked: MDP
 Reviewed: JRV
 Approved: MDP
 Melanie D. Peckham, P.E.
 Florida P.E. No. 66478


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ORANGE COUNTY
 R/R PACKAGE 22 PUMP STATIONS
 MECHANICAL
 PUMP STATION 3390 - WHISPER LAKES 8
 PLAN AND SECTIONS



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 SHEET NO.: 23 OF 47



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- GENERAL NOTES**
- ALL MATERIALS AND CONSTRUCTION SHALL BE IN ACCORDANCE WITH THE ORANGE COUNTY UTILITIES STANDARDS AND SPECIFICATIONS MANUAL (LATEST EDITION), AND/OR AS SPECIFIED HEREIN.
 - ALL EXPOSED METAL OUTSIDE OF THE WET WELL SHALL BE PRIMED AND PAINTED IN ACCORDANCE WITH THE ORANGE COUNTY UTILITIES STANDARDS AND CONSTRUCTION SPECIFICATION MANUAL.
 - A CRYSTALLINE WATER PROOFING ADMIXTURE SHALL BE ADDED TO THE CONCRETE DURING THE MIXING CYCLE FOR THE WET WELL PRECAST STRUCTURES. THE CRYSTALLINE WATER PROOFING ADMIXTURE SHALL BE APPROVED PRODUCT AS LISTED IN OCU APPENDIX D.
 - THE INSIDE OF THE WET WELL SHALL BE LINED WITH EITHER A HIGH DENSITY POLYETHYLENE (HDPE) LINER, A POLYPROPYLENE RANDOM COPOLYMER (PP-R) LINING SYSTEM, OR AN ACCEPTABLE EQUAL AS LISTED IN OCU APPENDIX D. FINAL SEALS AND SEALING TO BE MADE IN THE FIELD.
 - WET WELL ACCESS OPENING SHALL BE COVERED ON ALL FOUR VERTICAL SIDES WITH A PROTECTIVE LINER.
 - WET WELL ACCESS HATCH AND COVER SHALL BE ALUMINUM, WITH 316 STAINLESS STEEL HARDWARE AND LOCK BRACKET PLATE WITH THE WORDS "CONFINED SPACE" STAMPED (ETCHED) ON THE TOP SIDE. EACH DOOR WILL BE EQUIPPED WITH RECESSED HASP ENCLOSURE.
 - ALL HARDWARE IN THE WET WELL SHALL BE 316 STAINLESS STEEL.
 - THERE SHALL BE NO VALVES OR ELECTRICAL JUNCTION BOXES IN THE WET WELL.
 - ALL PIPING AND CONDUIT PENETRATIONS THROUGH CONCRETE SHALL BE WATERTIGHT. CAST-IN-PLACE SLEEVES SHALL BE PLACED IN ALL OPENINGS WHERE PRESSURE PIPE ENTER OR LEAVE THE WET WELL. PENETRATIONS THROUGH WET WELL SHALL BE A COMPRESSION TYPE SEAL, SUCH AS "LINK-SEAL", OR AN ACCEPTABLE EQUAL AS LISTED IN OCU APPENDIX D.
 - ALL CONNECTIONS WITHIN THE WET WELL SHALL BE FLANGED JOINTS. ALL REMAINING JOINTS BETWEEN THE WET WELL AND THE CONNECTION TO THE EXISTING FORCE MAIN SHALL BE RESTRAINED MECHANICAL JOINTS. (SEE TABLE ON DETAIL SHEET D100).
 - ALL PIPING WITHIN THE WET WELL SHALL BE STAINLESS STEEL 316 SCHEDULE 40.
 - PIPE SUPPORTS SHALL BE CONCRETE, PROVIDED AND INSTALLED TO SUPPORT AND ANCHOR THE PIPING SECURELY.
 - CONTRACTOR SHALL, AS DIRECTED BY THE COUNTY REPRESENTATIVE, REMOVE AND SALVAGE TO THE COUNTY, ALL EXISTING PUMP STATION EQUIPMENT, INCLUDING PUMPS, CHECK VALVES, SHUTOFF VALVES, AND CONTROL PANEL.
 - CONTRACTOR SHALL DEMOLISH AND REMOVE FROM SITE ALL DEBRIS RESULTING FROM THE REMOVAL OF THE EXISTING STRUCTURES.
 - CONTRACTOR SHALL VERIFY ALL DIMENSIONS AND ELEVATIONS PRIOR TO ORDERING ANY MATERIALS OR EQUIPMENT.
 - CONTRACTOR SHALL GROUT FLOOR OF WET WELL, AS REQUIRED BY MANUFACTURER'S SPECIFICATIONS, TO ACCOMMODATE INSTALLATION OF THE NEW PUMPS.
 - STRUCTURAL DESIGN OF THE PRECAST WET WELL, TOP SHALL BE THE RESPONSIBILITY OF THE PRECAST MANUFACTURER. CONTRACTOR SHALL SUBMIT SHOP DRAWINGS FOR THE PRECAST WET WELL, THE PRECAST LINED WET WELL TOP AND HATCH COVER, AND RISERS, TO THE ENGINEER.
 - 100-YEAR FLOOD ELEVATION: OUT OF THE 100-YEAR FLOOD ZONE.
 - ALL EXTERNAL JOINTS OF THE WET WELL SHALL BE COVERED WITH A HIGH STRENGTH, WATER TIGHT, PRESS-TO-SEAL TYPE TAPE/AS LISTED IN OCU APPENDIX D.
 - A SECOND HIGH LEVEL ALARM LIQUID FLOAT SHALL BE INSTALLED TO PROVIDE DRY CONTACT FOR SCADA. REFER TO PUMP CONTROL SCHEMATIC.
 - ALL SPOOLS SHALL BE MINIMUM OF SIX INCHES WHERE SPACE ALLOWS.
 - CONTRACTOR SHALL BE RESPONSIBLE FOR ALIGNMENT FROM THE BASE PLATE TO THE BASE ELBOW AT NO EXTRA COST TO OCU.

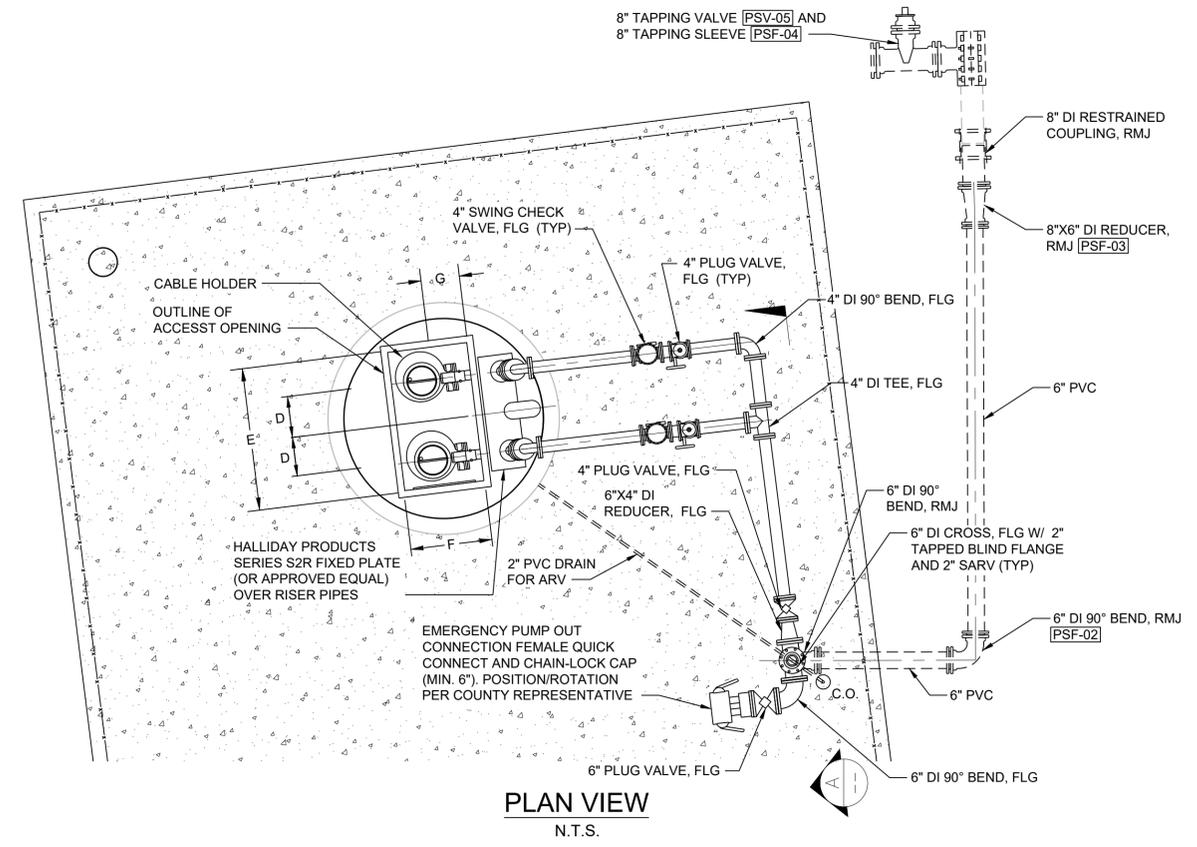

DESIGN SPECIFICATIONS

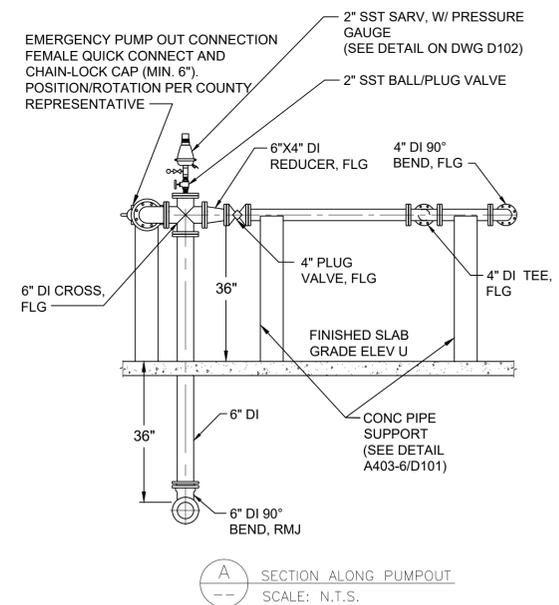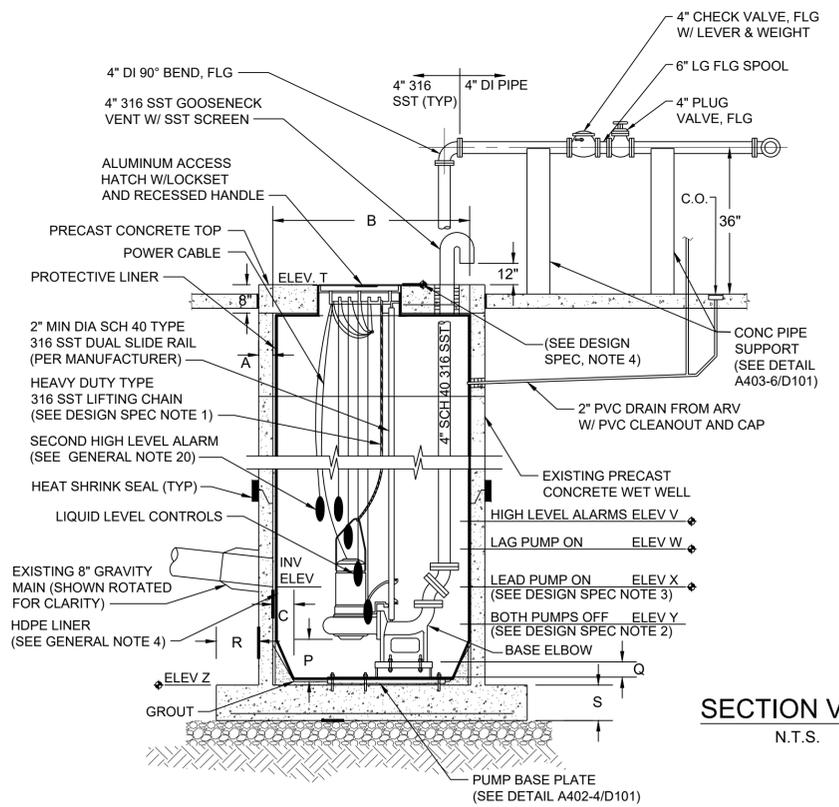MANUFACTURER: ABS
 MODEL: XFP
 IMP: 100E CB1.3
 DIA: 225 MM
 SPEED: 1750 RPM
 DISCHARGE SIZE: 4 IN

VOLTAGE: 230V
 PHASE: 3
 H.P.: 14.1
 MAX. SOLID SIZE (3 IN MIN): 3.00 IN
 CURVE NUMBER: PE105/4 E 60HZ

SHUT OFF HEAD: 95.0 FEET TDH
 HIGH HEAD CONDITION: 280 GPM AT 71 FEET TDH
 MINIMUM HEAD CONDITION: 525 GPM AT 60 FEET TDH

DESCRIPTION	SYMBOL	DIMENSION	ELEVATION
THICKNESS OF WALL	A	EXISTING	--
DIAMETER OF WET WELL	B	6'	--
WIDTH OF BOTTOM FILLET	C	SEE NOTE 1	--
C/L OF WET WELL TO C/L OF PIPES	D	SEE NOTE 1	--
LENGTH OF PUMP ACCESS OPENING	E	SEE NOTE 1	--
WIDTH OF PUMP ACCESS OPENING	F	SEE NOTE 1	--
CENTER OF WET WELL TO EDGE OF HATCH	G	SEE NOTE 1	--
HATCH OPENING	I	4'-8"	--
LIP WIDTH OF WETWELL BASE	R	EXISTING	--
THICKNESS OF WETWELL BASE	S	EXISTING	--
TOP OF WET WELL	T	--	83.20
SLAB GRADE	U	--	83.12
INFLUENT PIPE INVERT			68.05
HIGH LEVEL ALARMS	V	--	68.00
LAG PUMP ON	W	--	67.50
LEAD PUMP ON	X	--	67.00
PUMPS OFF (TOP OF PUMP VOLUTE)	Y	--	64.50
BOTTOM OF PUMP TO FLOOR OF WET WELL	P	--	--
STEP HEIGHT (IF REQUIRED)	Q	--	--
FLOOR OF WET WELL	Z	--	61.18

NOTES:
 1. PER PUMP MANUFACTURER'S REQUIREMENTS
 2. DIMENSION P AND ELEVATIONS Y AND Z MUST MEET BOTH FLYGT AND ABS REQUIREMENTS.
 3. ELEVATION X - ELEVATION Z ≥ 5 FEET
 4. TOP ELEVATION OF WET WELL SHALL BE A MINIMUM OF 1' ABOVE THE 100 YEAR FLOOD ELEVATION AND THE ELEVATION OF THE CROWN OF THE ROAD.
 5. SYMBOLS SHOWN IN TABLE ARE USED ON SECTION DRAWINGS ON THIS SHEET.

DESIGN SPECIFICATIONS

MANUFACTURER: FLYGT
 MODEL: NP3127 HT3
 IMP: 488
 DIA: 215 MM
 SPEED: 1780 RPM
 DISCHARGE SIZE: 4 IN

VOLTAGE: 230V
 PHASE: 3
 H.P.: 10
 MAX. SOLID SIZE (3 IN MIN): 3.00 IN
 CURVE NUMBER: 488

SHUT OFF HEAD: 83.2 FEET TDH
 HIGH HEAD CONDITION: 241 GPM AT 64.9 FEET TDH
 MINIMUM HEAD CONDITION: 460 GPM AT 51 FEET TDH

DESCRIPTION	SYMBOL	DIMENSION	ELEVATION
THICKNESS OF WALL	A	EXISTING	--
DIAMETER OF WET WELL	B	6'	--
WIDTH OF BOTTOM FILLET	C	SEE NOTE 1	--
C/L OF WET WELL TO C/L OF PIPES	D	SEE NOTE 1	--
LENGTH OF PUMP ACCESS OPENING	E	SEE NOTE 1	--
WIDTH OF PUMP ACCESS OPENING	F	SEE NOTE 1	--
CENTER OF WET WELL TO EDGE OF HATCH	G	SEE NOTE 1	--
HATCH OPENING	I	4'-8"	--
LIP WIDTH OF WETWELL BASE	R	EXISTING	--
THICKNESS OF WETWELL BASE	S	EXISTING	--
TOP OF WET WELL	T	--	83.20
SLAB GRADE	U	--	83.12
INFLUENT PIPE INVERT			68.05
HIGH LEVEL ALARMS	V	--	68.00
LAG PUMP ON	W	--	67.50
LEAD PUMP ON	X	--	67.00
PUMPS OFF (TOP OF PUMP VOLUTE)	Y	--	64.50
BOTTOM OF PUMP TO FLOOR OF WET WELL	P	--	--
STEP HEIGHT (IF REQUIRED)	Q	--	--
FLOOR OF WET WELL	Z	--	61.18

NOTES:
 1. PER PUMP MANUFACTURER'S REQUIREMENTS
 2. DIMENSION P AND ELEVATIONS Y AND Z MUST MEET BOTH FLYGT AND ABS REQUIREMENTS.
 3. ELEVATION X - ELEVATION Z ≥ 5 FEET
 4. TOP ELEVATION OF WET WELL SHALL BE A MINIMUM OF 1' ABOVE THE 100 YEAR FLOOD ELEVATION AND THE ELEVATION OF THE CROWN OF THE ROAD.
 5. SYMBOLS SHOWN IN TABLE ARE USED ON SECTION DRAWINGS ON THIS SHEET.



REV	DATE	DESCRIPTION	BY
C	05/2019	ISSUED FOR BID	AJM
B	10/2018	90% DRAWINGS	AJM
A	08/2018	60% DRAWINGS	AJM

Issue Certification

Designed	ARS
Drawn	AJM
Checked	MDP
Reviewed	JRV
Approved	MDP

Melanie D. Peckham, P.E.
 Florida P.E. No. 66478

Scale: 1" = 1'-0"

ORANGE COUNTY
 R/R PACKAGE 22 PUMP STATIONS
 MECHANICAL
 PUMP STATION 3325 - MEADOW WOODS 1
 PLAN AND SECTIONS

PROJECT NO.: 110034

SCALE: NOTED

DRAWING NO.: P500

REVISION: C

SHEET NO.: 24 OF 47

REISS ENGINEERING, INC.
 1016 SPRING VILLAS PT.
 WINTER SPRINGS, FL 32708
 (407) 679-5358
 CERTIFICATE OF AUTH. 8181

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 Parent Sheet Set: 1100340C_PK022PS Rev/Plot by: JAY MILLER

DATE: July 2014 **BEDDING AND TRENCHING - TYPE A** **FIGURE A101**

NOTES:

- INITIAL BACKFILL: SELECT COMMON FILL COMPACTED TO 95% (98% UNDER PAVEMENT) OF THE MAXIMUM DENSITY AS PER AASHTO T-180.
- TRENCH BACKFILL: COMMON FILL COMPACTED TO 95% (98% UNDER PAVEMENT) OF THE MAXIMUM DENSITY AS PER AASHTO T-180.
- TYPE A BEDDING MATERIAL SHALL CONFORM TO FDOT NO. 57 AGGREGATE.
- 15" MAX. (12" MIN.) FOR PIPE DIAMETER LESS THAN 24" AND 24" MAX (12" MIN) FOR PIPE DIAMETER 24" AND LARGER.
- WATER SHALL NOT BE PERMITTED IN THE TRENCH DURING CONSTRUCTION.
- ALL PIPE TO BE INSTALLED WITH BELL FACING UPSTREAM TO THE DIRECTION OF THE FLOW.
- BEDDING DEPTH SHALL BE 4" MINIMUM FOR PIPE DIAMETER UP TO 12" AND 6" MINIMUM FOR PIPE DIAMETER 16" AND LARGER.
- DEPTH FOR REMOVAL OF UNSUITABLE MATERIAL SHALL GOVERN DEPTH OF BEDDING ROCK BELOW THE PIPE. UTILITIES SHALL DETERMINE IN THE FIELD REQUIRED REMOVAL OF UNSUITABLE MATERIAL TO REACH SUITABLE FOUNDATION.
- FINAL RESTORATION IN IMPROVED AREAS SHALL BE IN COMPLIANCE WITH ALL APPLICABLE REGULATIONS OF GOVERNING AGENCIES. SURFACE RESTORATION WITHIN ORANGE COUNTY RIGHT-OF-WAY SHALL COMPLY WITH REQUIREMENTS OF R/W UTILIZATION REGULATIONS AND ROAD CONSTRUCTION SPECIFICATIONS.

DATE: July 2014 **RESTRAINED PIPE TABLE** **FIGURE A104-1**
WATER AND RECLAIMED WATER MAINS

TYPE	PIPE SIZE									
	PVC					DIP				
	4"	6"	8"	10"	12"	16"	20"	24"	30"	36"
90° BEND	25	36	46	55	64	65	77	89	105	120
45° BEND	10	15	19	23	26	27	32	37	44	50
22-1/2° BEND	5	8	9	11	13	13	15	18	21	24
11-1/4° BEND	3	4	5	6	8	7	8	9	10	12
PLUG OR BRANCH OF TEE	53	74	97	117	135	138	166	194	231	265
VALVE	27	38	49	59	68	69	83	97	116	133
REDUCER	VARIES BY SIZE; TO BE DETERMINED BY THE DESIGN ENGINEER.									

NOTES:

- FITTINGS SHALL HAVE RESTRAINED JOINTS UNLESS OTHERWISE INDICATED.
- INSTALL FULL LENGTH JOINTS WITH TOTAL LENGTH EQUAL TO OR GREATER THAN LENGTH SHOWN IN THE TABLE.
- WHERE TWO OR MORE FITTINGS ARE IN SERIES, SELECT FITTING RESTRAINT LENGTH THAT YIELDS THE LONGEST RESTRAINT DISTANCE.
- ALL INLINE VALVES SHALL BE RESTRAINED.
- WHERE INTERNAL RESTRAINED JOINTS ARE USED, THE ENTIRE BELL SHALL BE PAINTED RED.
- LENGTHS SHOWN IN THE TABLE WERE CALCULATED IN ACCORDANCE WITH PROCEDURES OUTLINED IN "THRUST RESTRAINT DESIGN FOR DUCTILE IRON PIPE" GUIDELINES PUBLISHED BY DIPRA, USING THE ASSUMPTIONS SHOWN BELOW:

WORKING PRESSURE: 150 PSI
 SOIL DESIGNATION: SM (SAND SILT)
 LAYING CONDITIONS: 3
 DEPTH OF COVER: 3 FT
 SAFETY FACTOR: 1.5
 CONVERSION FACTOR FOR PVC PIPE: 1.25

THE DESIGN ENGINEER SHALL INCREASE THE VALUES IN THE TABLE AS WARRANTED BY SITE-SPECIFIC SOIL DESIGNATIONS, LAYING CONDITIONS, PIPE MATERIAL, ETC. FOR DIP ENCASED IN POLYETHYLENE, INCREASE THE GIVEN VALUE BY A FACTOR OF 1.25.

DATE: July 2014 **RESTRAINED PIPE TABLE** **FIGURE A104-2**
WASTEWATER FORCE MAINS

TYPE	PVC PIPE SIZE									
	4"	6"	8"	10"	12"	16"	20"	24"	30"	36"
	90° BEND	18	24	31	38	43	55	65	75	88
45° BEND	8	10	13	15	18	23	26	31	38	43
22-1/2° BEND	4	5	6	8	9	11	13	15	18	20
11-1/4° BEND	2	3	4	5	6	8	9	10	11	13
PLUG OR BRANCH OF TEE	38	50	65	79	90	117	139	163	194	223
VALVE	19	25	32	40	45	59	70	82	98	112
REDUCER	VARIES BY SIZE; TO BE DETERMINED BY THE DESIGN ENGINEER.									

NOTES:

- FITTINGS SHALL HAVE RESTRAINED JOINTS UNLESS OTHERWISE INDICATED.
- INSTALL FULL LENGTH JOINTS WITH TOTAL LENGTH EQUAL TO OR GREATER THAN LENGTH SHOWN IN THE TABLE.
- WHERE TWO OR MORE FITTINGS ARE IN SERIES, SELECT FITTING RESTRAINT LENGTH THAT YIELDS THE LONGEST RESTRAINT DISTANCE.
- ALL INLINE VALVES SHALL BE RESTRAINED.
- WHERE INTERNAL RESTRAINED JOINTS ARE USED, THE ENTIRE BELL SHALL BE PAINTED RED.
- LENGTHS SHOWN IN THE TABLE WERE CALCULATED IN ACCORDANCE WITH PROCEDURES OUTLINED IN "THRUST RESTRAINT DESIGN FOR DUCTILE IRON PIPE" GUIDELINES PUBLISHED BY DIPRA, USING THE ASSUMPTIONS SHOWN BELOW:

WORKING PRESSURE: 100 PSI
 SOIL DESIGNATION: SM (SAND SILT)
 LAYING CONDITIONS: 3
 DEPTH OF COVER: 3 FT
 SAFETY FACTOR: 1.5
 CONVERSION FACTOR FOR PVC PIPE: 1.25

THE DESIGN ENGINEER SHALL INCREASE THE VALUES IN THE TABLE AS WARRANTED BY SITE-SPECIFIC PARAMETERS, SUCH AS SOIL DESIGNATIONS AND LAYING CONDITIONS.

DATE: July 2014 **PLUG VALVE AND BOX** **FIGURE A109**
WASTEWATER

NOTES:

- PVC PIPE OR DUCTILE IRON PIPE EXTENSIONS SHALL NOT BE USED ON VALVE BOX INSTALLATION.
- THE VALVE ACTUATING NUT SHALL BE EXTENDED TO BE WITHIN 3" OF FINISHED GRADE.
- PROVIDE A PLASTIC DEBRIS SHIELD / ALIGNMENT RING WHICH INSTALLS BELOW THE VALVE ACTUATING NUT. THIS SHIELD SHALL CENTER THE RISER PIPE BOX OVER THE ACTUATING NUT AND MINIMIZE INFILTRATION.
- LOCATING WIRE SHALL BE CONTINUOUS WITH NO SPLICES AND SHALL EXTEND 12" ABOVE TOP OF COLLAR. WIRE SHALL BE COLOR CODED TO MATCH THE UTILITY INSTALLED.
- FOR NEW CONSTRUCTION, THE VALVE BOX SHALL BE ADJUSTED TO MIDRANGE TO ALLOW FOR FUTURE BOX ADJUSTMENTS.
- REFER TO FIGURE A111 FOR INSTALLATIONS AT A DEPTH OF 6' OR GREATER.

DATE: July 2014 **TYPICAL VALVE BOX COVER** **FIGURE A110**

NOTE:

- LOCKING LIDS ARE REQUIRED ON ALL VALVE BOXES.

DATE: July 2014 **VALVE BOX PAD** **FIGURE A112**

NOTES:

- BRONZE (OR STAINLESS STEEL) IDENTIFICATION DISC SHALL BE REQUIRED FOR ALL VALVES, EXCEPT HYDRANT VALVES.
- IN LIEU OF PRECAST CONCRETE PAD, A 6" THICK X 24" (ROUND OR SQUARE) POURED CONCRETE PAD WITH TWO #4 REBAR AROUND PERIMETER MAY BE USED.

DATE: July 2014 **PIPE LOCATING WIRE** **FIGURE A114**

NOTES:

- ALL PIPE SHALL REQUIRE INSULATED LOCATING WIRE (10 GAUGE SOLID COPPER) CAPABLE OF DETECTION BY A CABLE LOCATOR AND SHALL BE WRAPPED WITH NYLON STRAPS TO TOP CENTERLINE OF THE PIPE.
- LOCATING WIRE SHALL BE CONTINUOUS INSIDE VALVE BOXES AND SHALL EXTEND 12" ABOVE TOP OF COLLAR.
- WIRE INSULATION SHALL BE COLOR CODED FOR THE TYPE OF PIPE BEING INSTALLED.

DATE: July 2014 **SEPARATION REQUIREMENTS FOR** **FIGURE A116**
WATER, WASTEWATER AND RECLAIMED WATER MAINS

PROPOSED UTILITY	HORIZONTAL & VERTICAL SEPARATION REQUIREMENTS							
	POTABLE WATER		RECLAIMED WATER		WASTEWATER (GRAVITY & FM)		STORM SEWER	
	HORIZ	VERT	HORIZ	VERT	HORIZ	VERT	HORIZ	VERT
POTABLE WATER	3' NOTE 1	12"	3' NOTE 1 & 3	12" NOTE 3	6' NOTE 3	12" NOTE 3	3' NOTE 1 & 3	12"/18" NOTE 2 & 3
RECLAIMED WATER	3' NOTE 1 & 3	12" NOTE 3	3' NOTE 1	12"	3' NOTE 1	12"	3' NOTE 1	12"/18" NOTE 2
WASTEWATER (GRAVITY AND FM)	6' NOTE 3	12" NOTE 3	3' NOTE 1	12"	3' NOTE 1	12"	3' NOTE 1	12"/18" NOTE 2
RIGHT OF WAY	3' NOTE 1	N/A	3' NOTE 1	N/A	3' NOTE 1	N/A	N/A	N/A

NOTES:

- THIS SEPARATION REQUIREMENT IS TO PROVIDE ACCESSIBILITY FOR CONSTRUCTION AND MAINTENANCE. THREE FEET OF HORIZONTAL SEPARATION IS THE MINIMUM FOR PIPES WITH THREE FEET OF COVER. FOR PIPES INSTALLED AT GREATER DEPTHS, PROVIDE AN ADDITIONAL FOOT OF SEPARATION FOR EACH ADDITIONAL FOOT OF DEPTH.
- THE 18-INCH SEPARATION REQUIREMENT APPLIES WHEN THE STORM PIPE CROSSES ABOVE THE OCU MAIN, AND WHEN THE STORM PIPE HAS A DIAMETER EQUAL TO OR GREATER THAN 24 INCHES. OTHERWISE, THE REQUIRED SEPARATION IS 12 INCHES.
- THIS SEPARATION REQUIREMENT COMPLIES WITH MINIMUM FDEP SEPARATION REQUIREMENTS OUTLINED IN 62-555.314, FAC. VARIANCES FROM THE FDEP REQUIREMENTS MUST COMPLY WITH 62-555.314(5), FAC AND MUST BE APPROVED INDIVIDUALLY BY BOTH FDEP AND OCU.
- DISTANCES GIVEN ARE FROM OUTSIDE OF PIPE TO OUTSIDE OF PIPE.
- NO WATER PIPE SHALL PASS THROUGH OR COME IN CONTACT WITH ANY PART OF SANITARY OR STORM WATER MANHOLE OR STRUCTURE.



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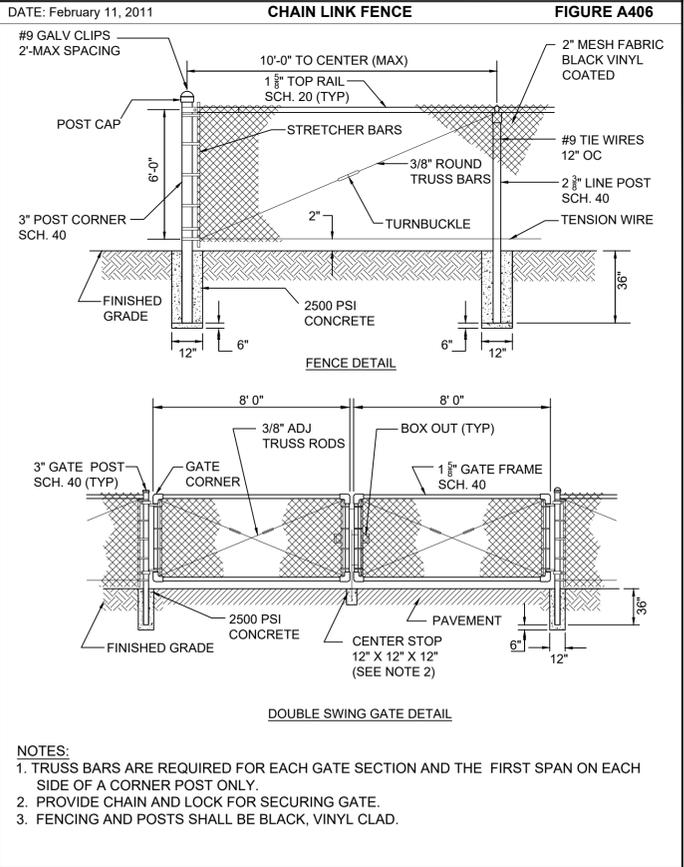
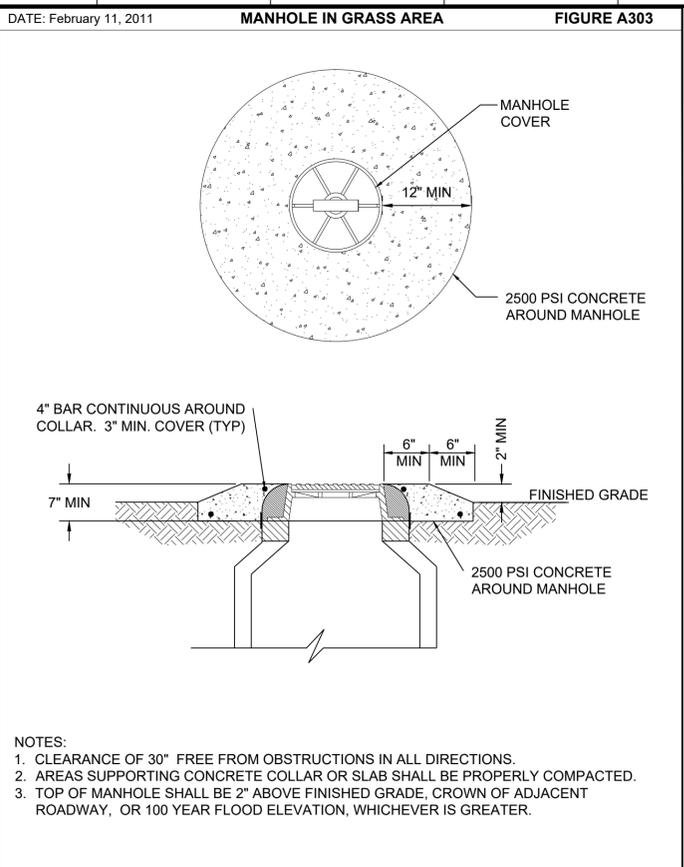
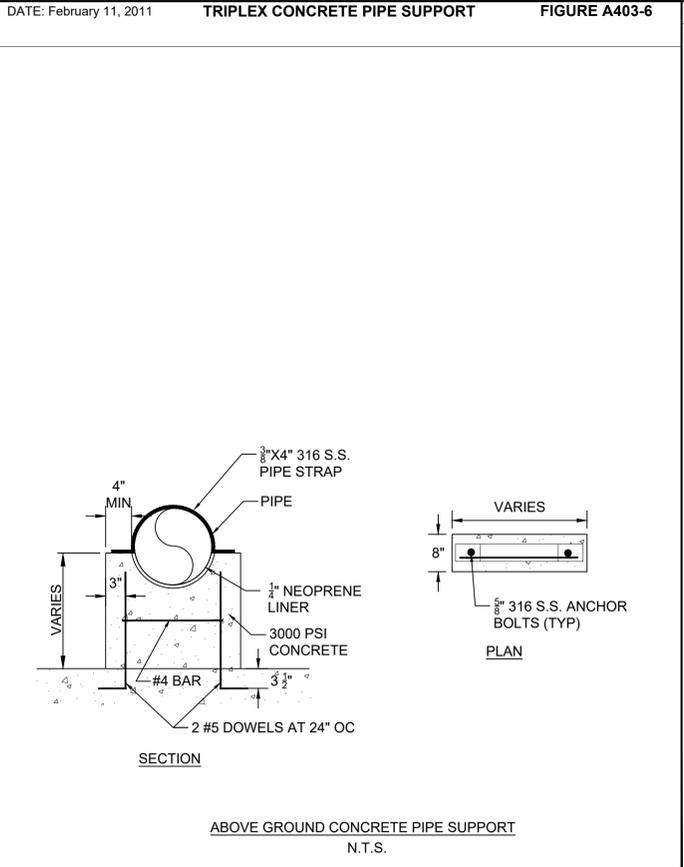
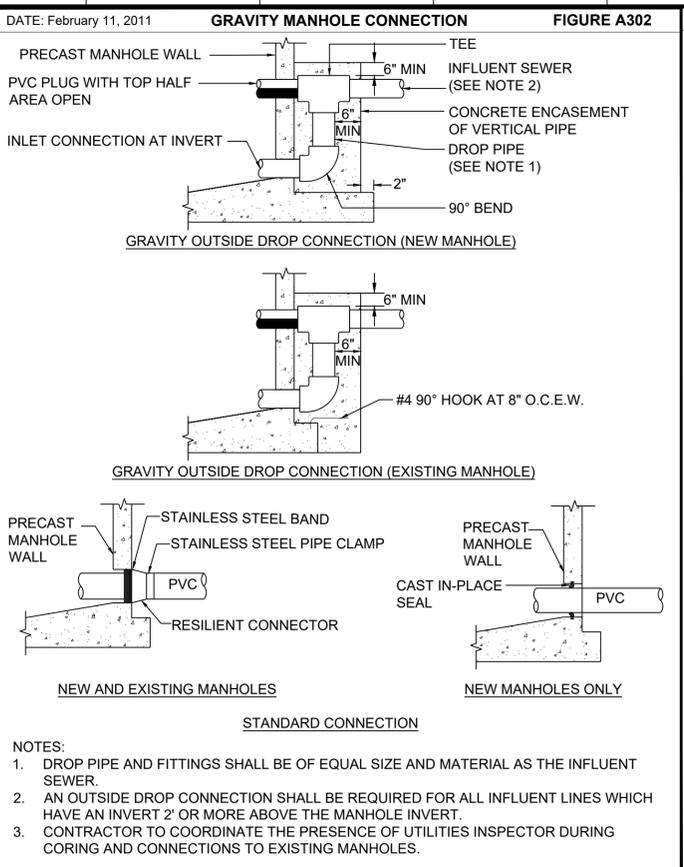
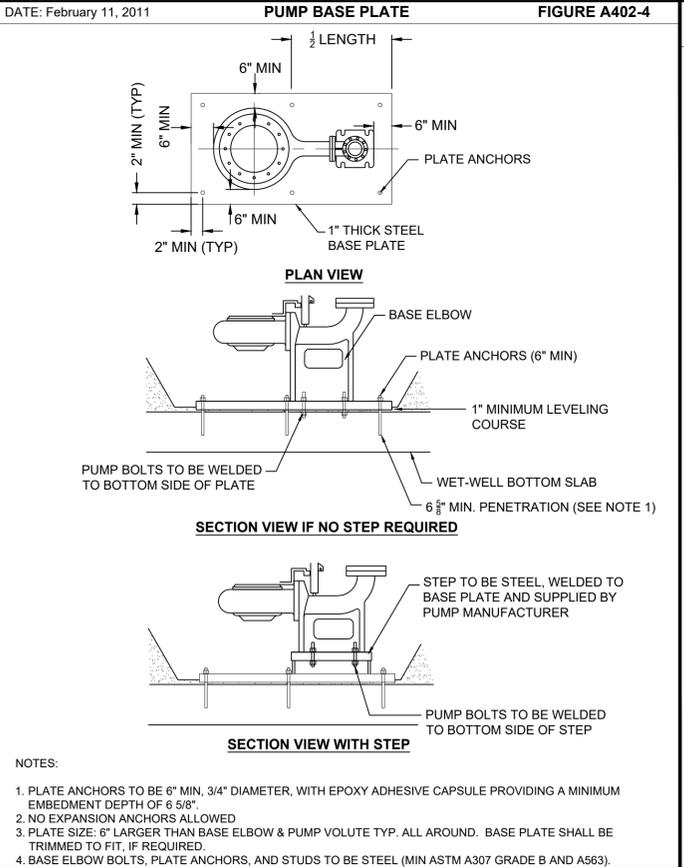
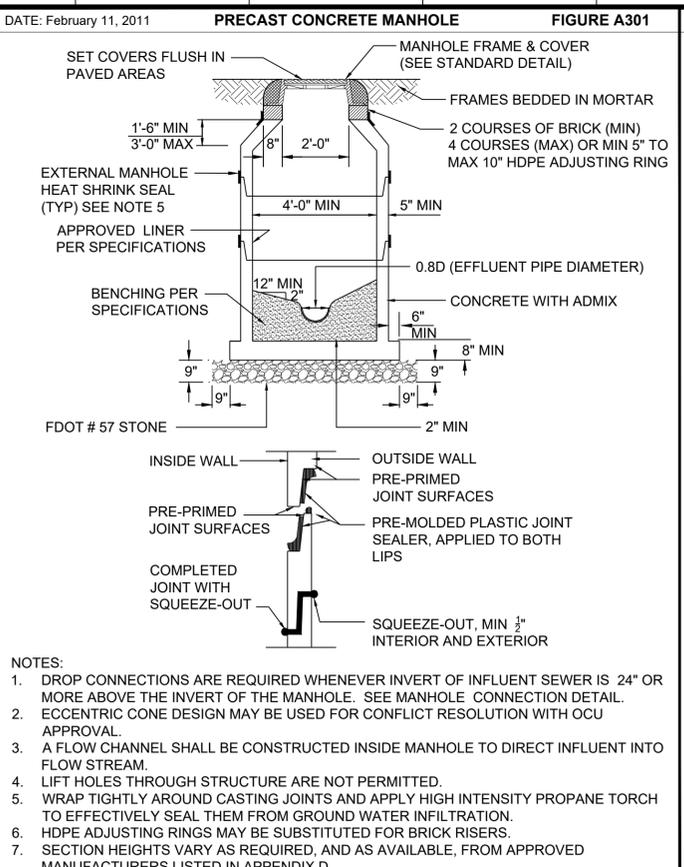
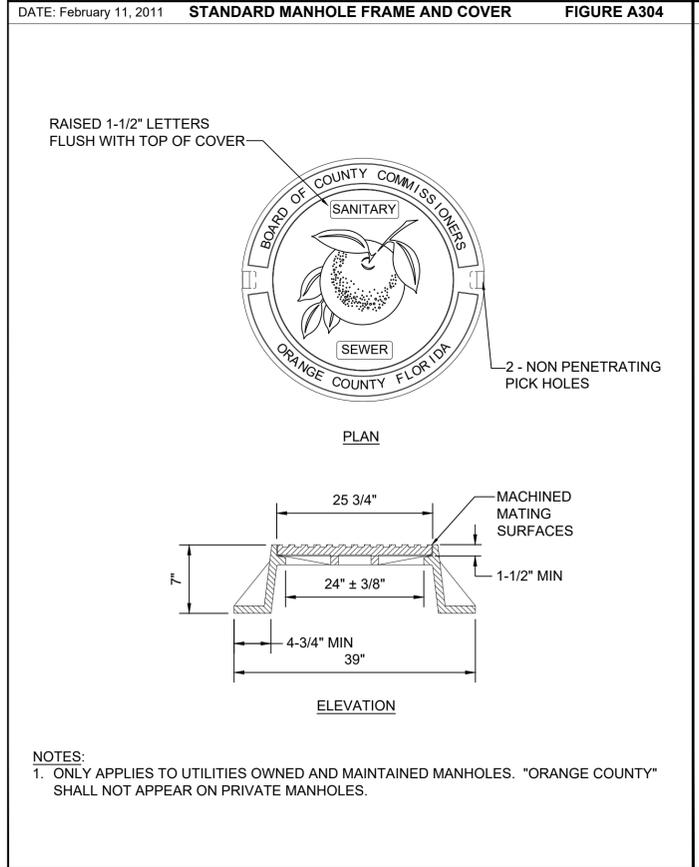
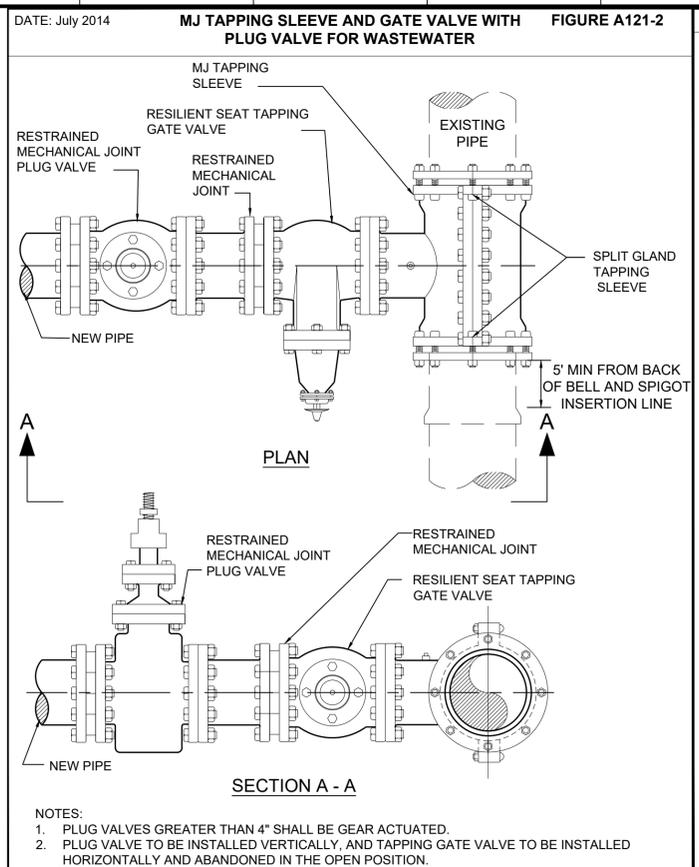
Designed	ARS
Drawn	AJM
Checked	MDP
Reviewed	JRV
Approved	MDP

ORANGE COUNTY
 R/R PACKAGE 22 PUMP STATIONS
 MECHANICAL & CIVIL DETAILS
 OCU STANDARD MECHANICAL AND CIVIL DETAILS

PROJECT NO.:	110034
SCALE:	NOTED
REVISION:	C
DRAWING NO.:	D100
SHEET NO.:	25 OF 47



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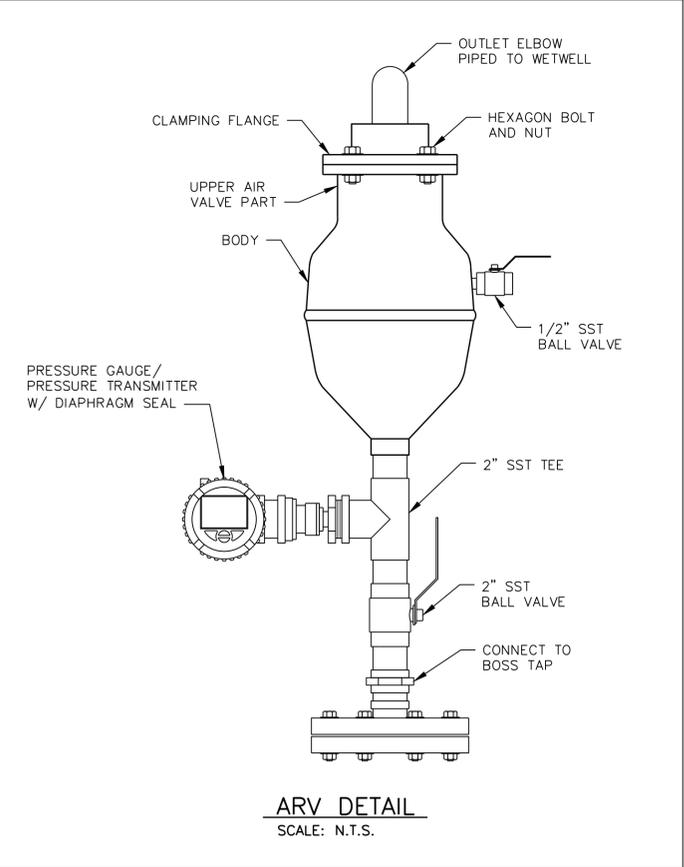
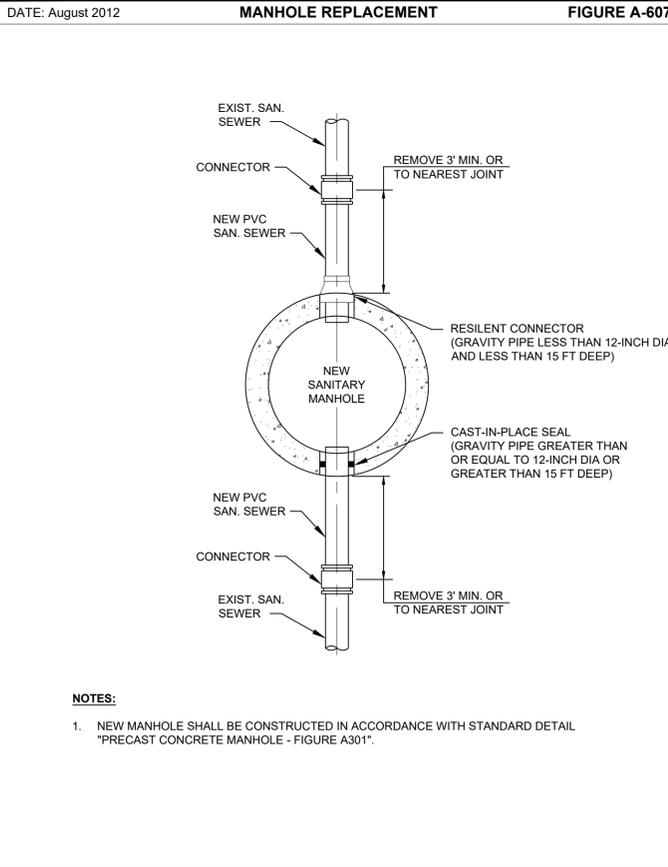
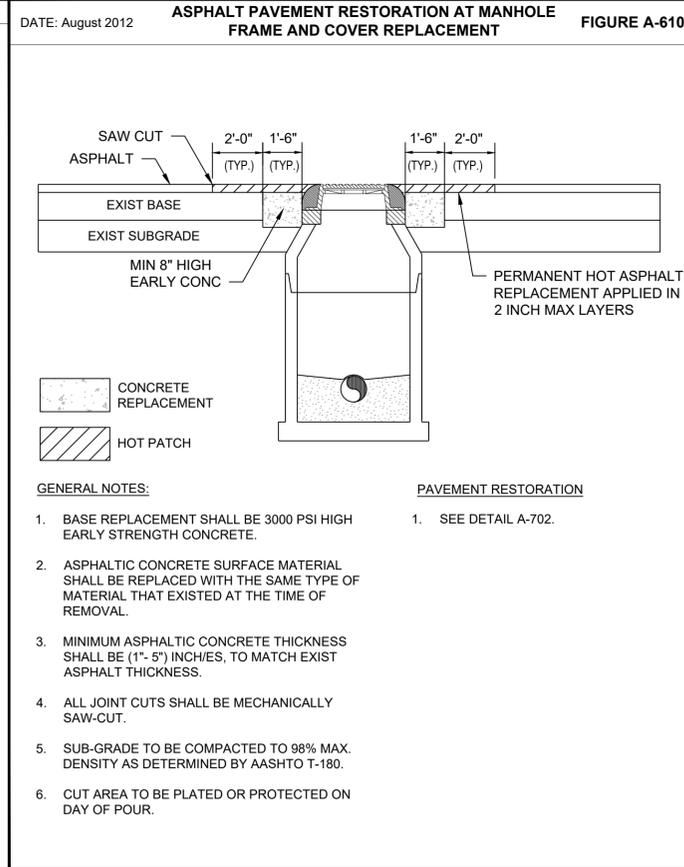
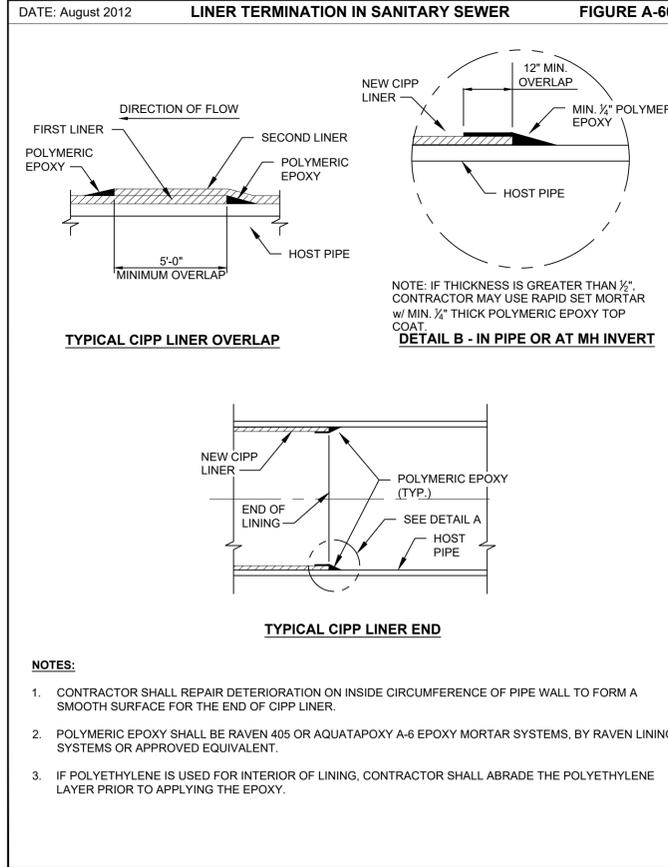
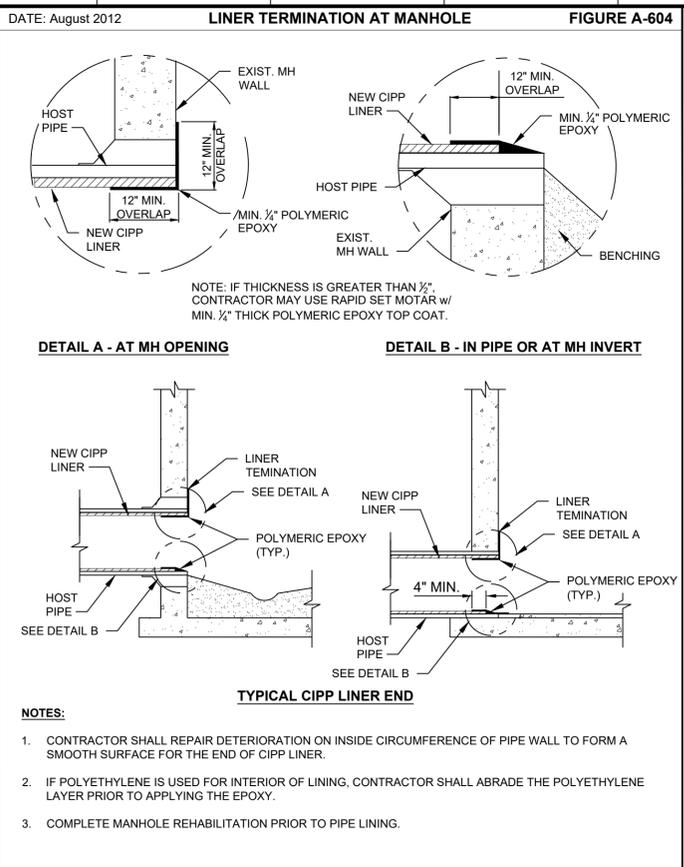
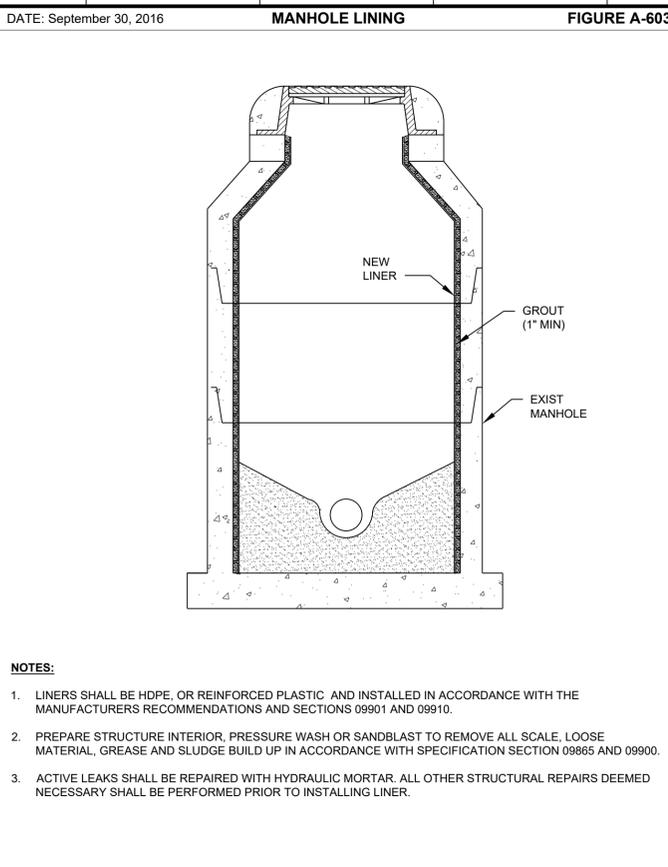
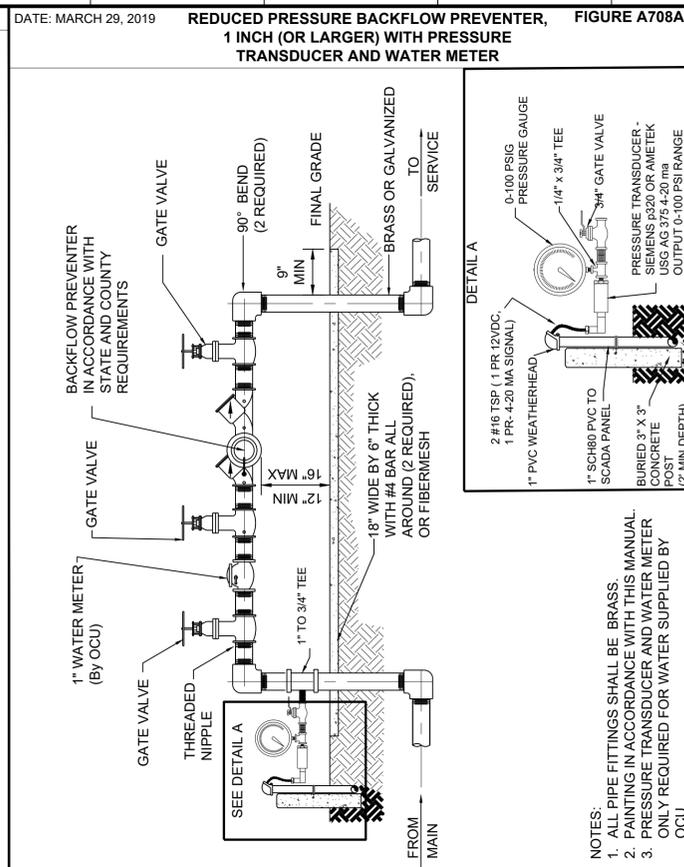
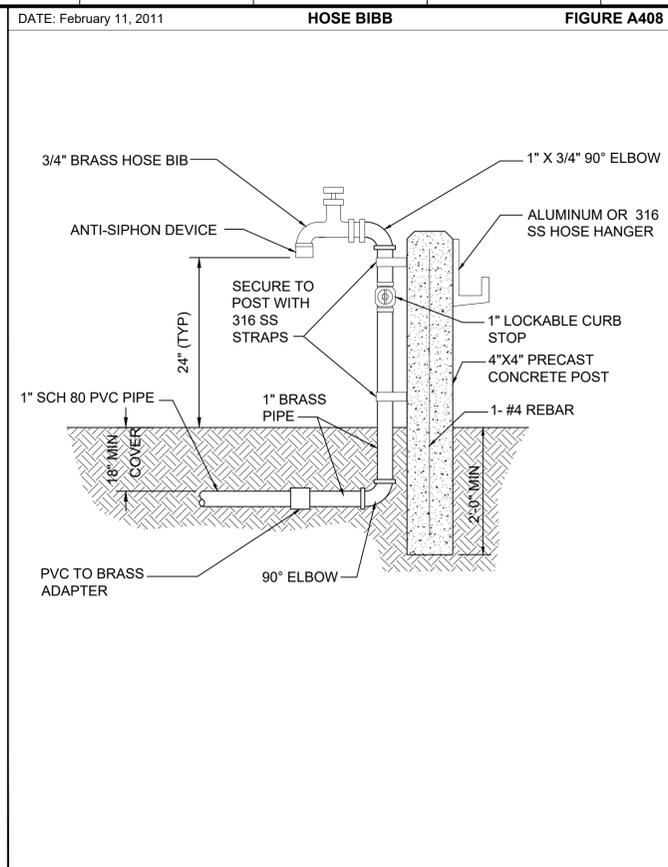
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ORANGE COUNTY
R/R PACKAGE 22 PUMP STATIONS
 MECHANICAL & CIVIL DETAILS
OCU STANDARD MECHANICAL AND CIVIL DETAILS

PROJECT NO.:	110034
SCALE:	NOTED
REVISION:	C
DRAWING NO.:	D101
SHEET NO.:	26 OF 47

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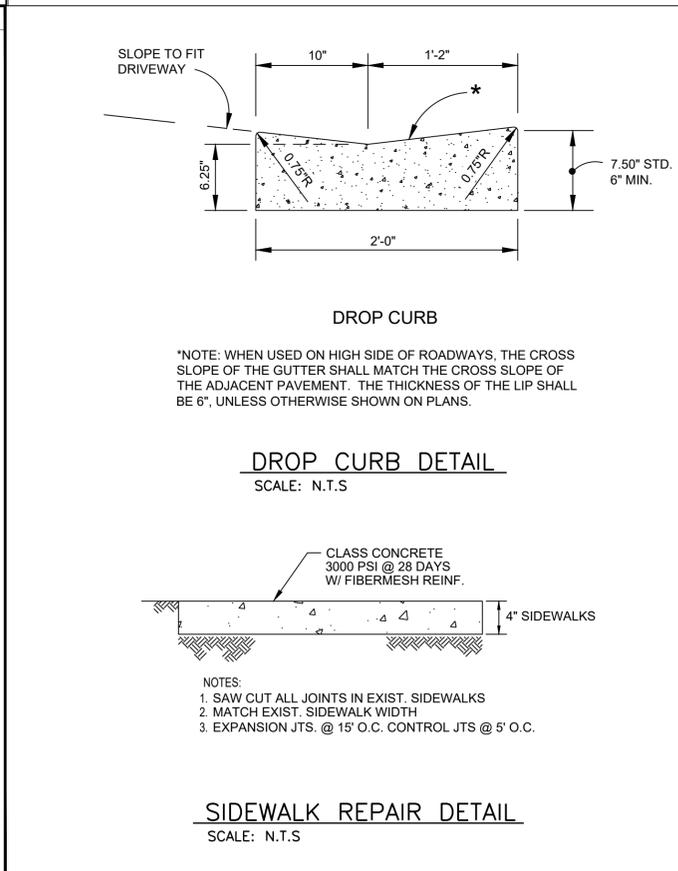
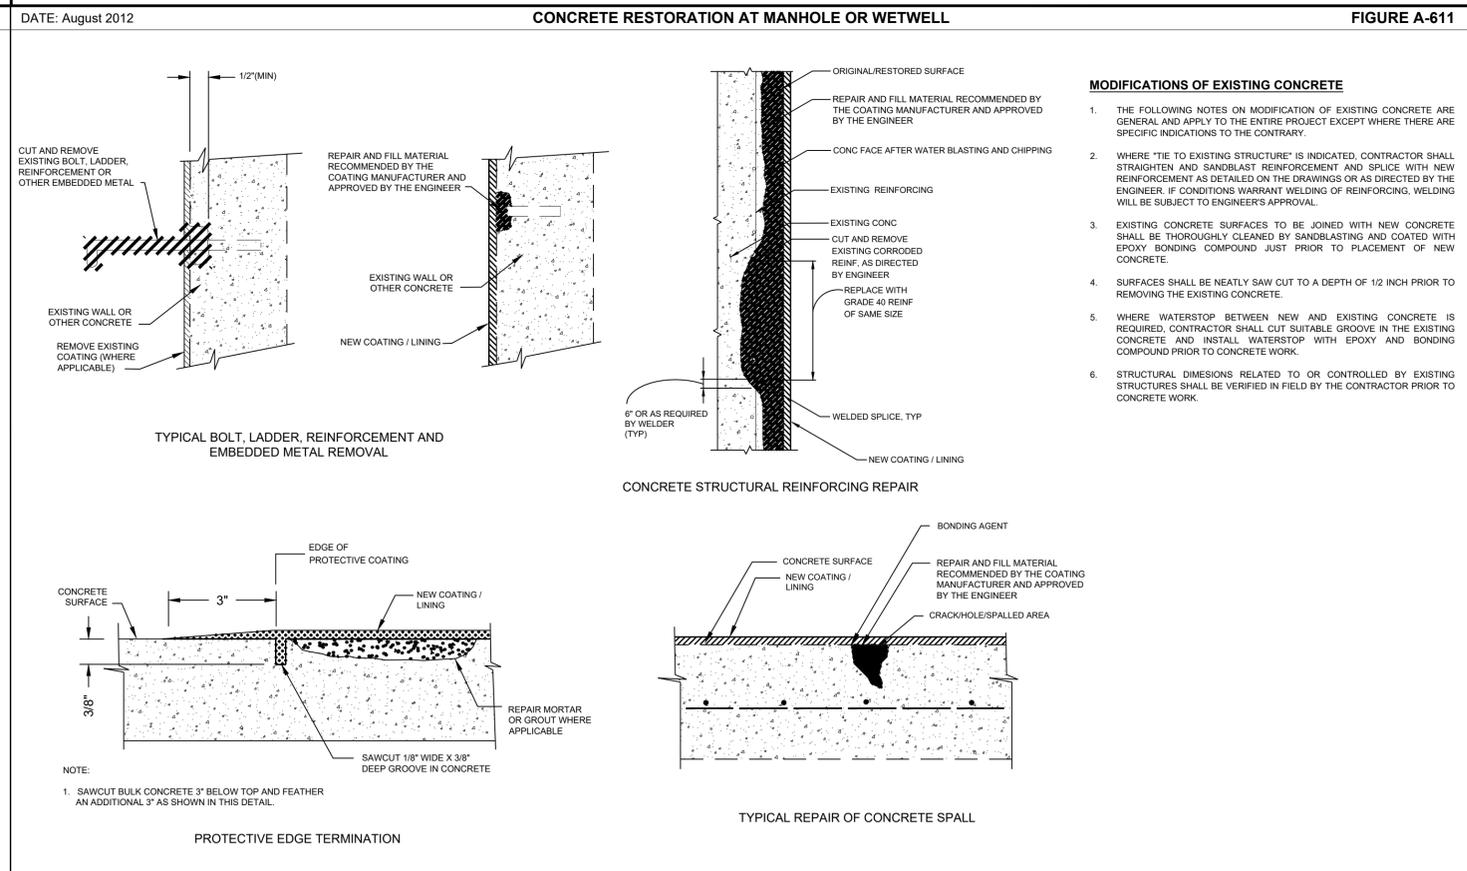
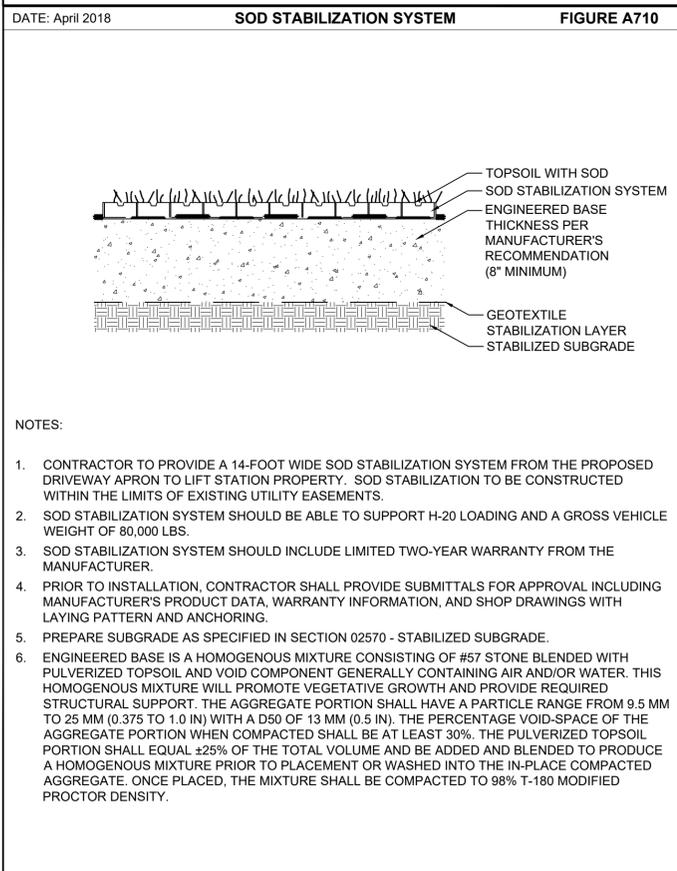
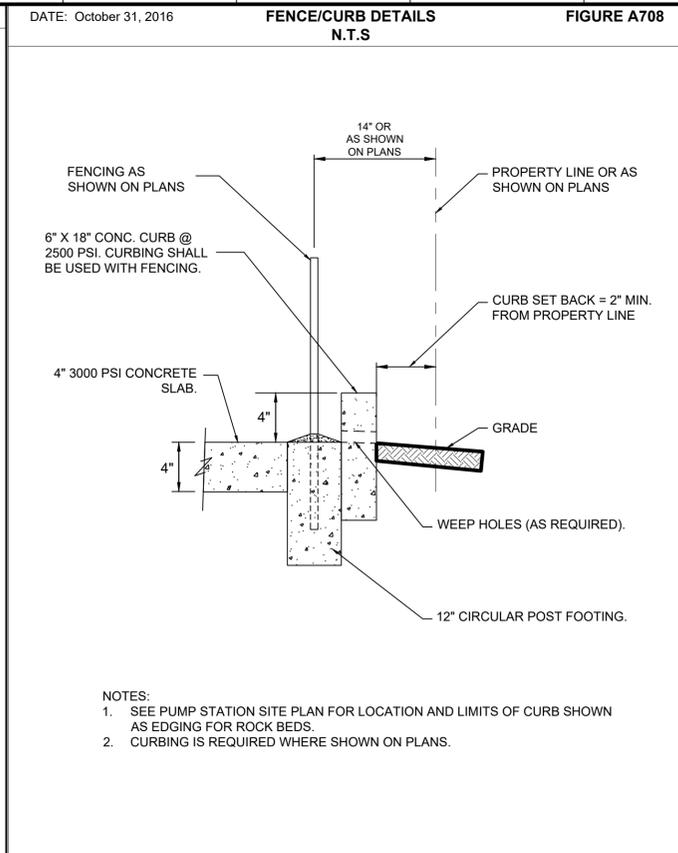
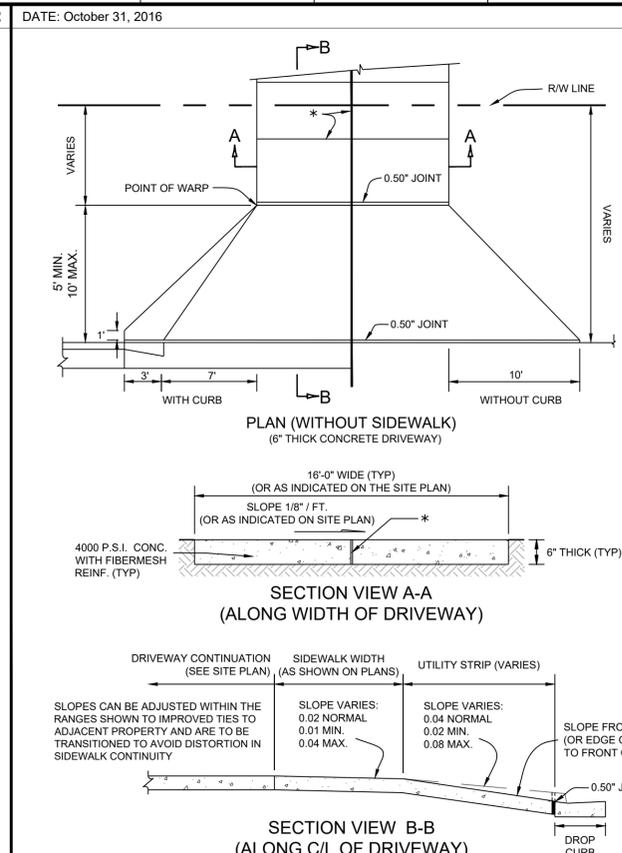
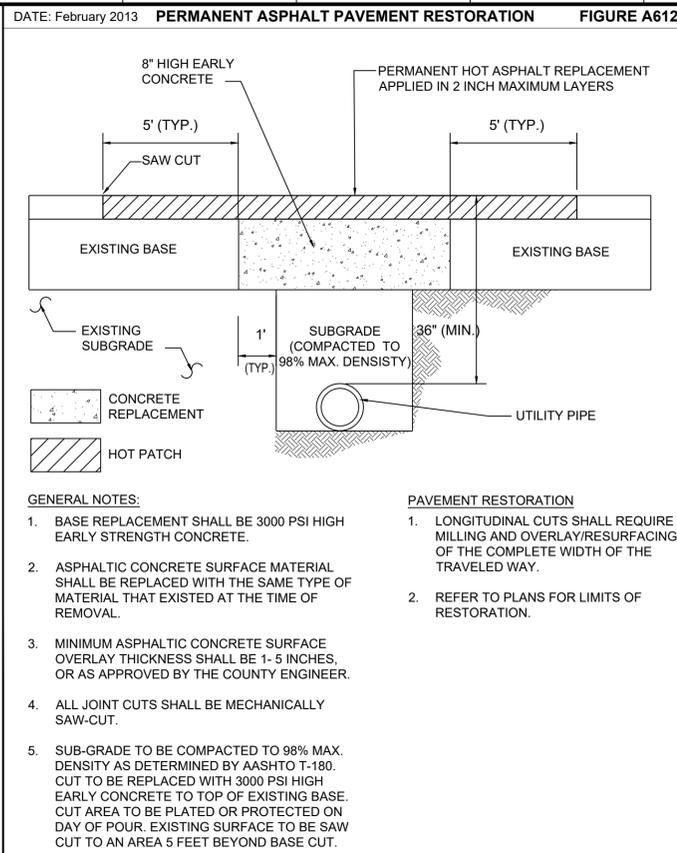
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ORANGE COUNTY
 R/R PACKAGE 22 PUMP STATIONS
 MECHANICAL & CIVIL DETAILS
 OCU STANDARD MECHANICAL AND CIVIL DETAILS

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SCALE: NOTED	REVISION: C
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ORANGE COUNTY
R/R PACKAGE 22 PUMP STATIONS
MECHANICAL & CIVIL DETAILS
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PLAN SYMBOLS

	HOME RUN TO PANELBOARD. NO. OF ARROWS INDICATE NO. OF CIRCUITS, HASH MARKS INDICATE NO. OF #12 AWG. CONDUCTORS. NO HASH MARKS INDICATE 2 #12 CONDUCTORS.
	CONDUIT CONCEALED IN WALL, IN SLAB ABOVE, OR ABOVE CEILING
	CONDUIT CONCEALED IN OR BELOW FLOOR OR UNDERGROUND.
	CONDUIT RUN EXPOSED. RUN PARALLEL OR PERPENDICULAR TO STRUCTURE OR WALL.
	FLEXIBLE CONDUIT WITH EQUIPMENT CONNECTION.
	POLE MOUNTED LIGHTING FIXTURE.
	ELECTRIC A.C. MOTOR, NO. INDICATES HORSEPOWER.
	ELECTRIC HEATER
	FLOW ELEMENT
	LEVEL ELEMENT
	LIMIT SWITCH
	PRESSURE SWITCH
	SOLENOID VALVE
	LEVEL INDICATING TRANSMITTER
	LIQUID LEVEL SWITCH
	FLOAT SWITCH
	FLOW INDICATING TRANSMITTER

RISER & CONTROL DIAGRAM SYMBOLS

	VOLTMETER
	AMMETER
	THREE PHASE VOLT SWITCH
	THREE PHASE AMP SWITCH
	GROUND FAULT INTERRUPTER
	FUSE
	MOLDED CASE CIRCUIT BREAKER
	SERVICE OR EQUIPMENT GROUND.
	OTHERWISE INDICATED.
	CURRENT TRANSFORMERS
	POTENTIAL TRANSFORMERS
	DUPLEX RECEPTACLE
	NORMALLY OPEN CONTACT
	NORMALLY CLOSED CONTACT
	FLOAT SWITCH, NORMALLY OPEN
	FLOAT SWITCH, NORMALLY CLOSED
	FLOW SWITCH, NORMALLY OPEN
	FLOW SWITCH, NORMALLY CLOSED
	TEMPERATURE SWITCH, NORMALLY OPEN
	TEMPERATURE SWITCH, NORMALLY CLOSED

RISER & CONTROL DIAGRAM SYMBOLS

	NORMALLY OPEN, TIMED TO CLOSE CONTACT
	NORMALLY CLOSED, TIMED TO OPEN CONTACT
	NORMALLY CLOSED, TIMED TO CLOSE CONTACT
	NORMALLY OPEN, TIMED TO OPEN CONTACT
	LIMIT SWITCH
	TORQUE SWITCH
	PRESSURE SWITCH
	ZERO SPEED SWITCH
	SOLENOID VALVE
	LIQUID LEVEL SWITCH
	VIBRATION SWITCH
	ALARM RELAY
	ALARM TIMER
	CONTROL RELAY
	MOTOR STARTER
	TIMING RELAY
	ALARM INDICATING LIGHT
	RUN INDICATING LIGHT
	MOMENTARY CONTACT PUSHBUTTON
	MOMENTARY BREAK PUSHBUTTON OR RESET
	KEYED SWITCH
	MAINTAINED CONTACT ON-OFF SWITCH
	START/STOP(S/S) CONTROL SWITCH MAINTAINED CONTACT
	THREE POSITION MAINTAINED CONTACT SELECTOR SWITCH
	CONTROL POWER TRANSFORMER
	REMOTE TERMINAL BLOCK POINT
	MINI-POWER ZONE

ABBREVIATIONS

A	AMPERES
AFF	ABOVE FINISHED FLOOR
AH	ALARM HORN
AIC	AMPS INTERRUPTING CURRENT
AL	ALARM LIGHT
ATS	AUTOMATIC TRANSFER SWITCH
ASB	ALTERNATOR TEST SWITCH
BKR	BREAKER
CCB	CONTROL CIRCUIT BREAKER
CCT	CONTROL CIRCUIT TRANSFORMER
CP	CONTROL PANEL
CPT	CONTROL POWER TRANSFORMER
CU	COPPER
DE	DUKE ENERGY
DH	DATA HIGHWAY
DISC	DISCONNECT
DR	DUPLEX RECEPTACLE
ELEC	ELECTRICAL
ELR	EMERGENCY LOCK-OUT RELAY
EM	EMERGENCY
ENCL	ENCLOSURE
EP	EXPLOSION PROOF
ESB	ENERGY SAVING BALLAST
ETM	ELAPSED TIME METER
EXH	EXHAUST
EXIST	EXISTING
F	FUSE
FL	FLASHER
FVNR	FULL VOLTAGE NON-REVERSING GENERATOR
GEN	GENERATOR
GFR	GROUND FAULT RECEPTACLE
GFI	GROUND FAULT INTERRUPTER
GND	GROUND
GRS	GALVANIZED RIGID STEEL
HOA	HAND-OFF-AUTOMATIC
HOLR	HAND-OFF-LOCAL-REMOTE
HOR	HAND-OFF-REMOTE
HP	HORSEPOWER
HPS	HIGH PRESSURE SODIUM
HSS	HORN SILENCE SWITCH
HWY	HIGHWAY
KVA	KILO VOLT-AMPERES
KW	KILOWATT
LA	LIGHTNING ARRESTOR
LF	LINEAR FEET
LTG	LIGHTING
MAX	MAXIMUM
MB	MOTOR BREAKER
MCB	MAIN CIRCUIT BREAKER
MPZ	MINI POWER ZONE
MIN	MINIMUM
MLO	MAIN LUGS ONLY
MTD	MOUNTED
MS	MOTOR STARTER
NEC	NATIONAL ELECTRICAL CODE
N	NEUTRAL
NTS	NOT TO SCALE
OCU	ORANGE COUNTY UTILITIES
OUC	ORLANDO UTILITIES COMMISSION
OH	OVERHEAD
OL	OVERLOAD HEATER
P	POLE
PA	POWER AVAILABLE LIGHT
PCP	PUMP CONTROL PANEL
PL	PILOT LIGHT
PM	PHASE MONITOR
PNL	PANEL
PRI	PRIMARY
PVC	POLYVINYL CHLORIDE
R	RELAY
RL	RUNNING LIGHT
PRI	PRIMARY
SC	SURGE CAPACITOR
SEC	SECONDARY
SH	SHIELDED
SS	STAINLESS STEEL
STR	STARTER
SUPP	SUPPRESSOR
SW	SWITCH
TBR	TO BE REMOVED
TC	TIME CLOCK
TLS	TROUBLE LIGHT SWITCH
TS	TERMINAL STRIP
TTS	THERMAL TERMINAL STRIP
TYP	TYPICAL
UG	UNDERGROUND
V	VOLT
W	WATT
W/	WITH
WP	WEATHERPROOF
Ø	PHASE

NOTES

- ELECTRICAL CONTRACTOR SHALL SUPPLY AND INSTALL ALL NEW ELECTRICAL WORK INDICATED.
- ELECTRICAL CONTRACTOR SHALL VISIT JOB SITE AND FAMILIARIZE HIMSELF WITH ALL CONDITIONS AFFECTING ELECTRICAL INSTALLATION AND MAKE PROVISIONS AS TO THE COST THEREOF. EXISTING CONDITIONS OF ELECTRICAL EQUIPMENT, LIGHT FIXTURES, ETC... THAT ARE PART OF THE FINAL SYSTEM SHALL BE VERIFIED BY THE CONTRACTOR PRIOR TO SUBMITTING HIS BID.
- ALL WORK SHALL BE DONE IN ACCORDANCE WITH THE FLORIDA BUILDING CODE 6TH EDITION (2017) (F.B.C.), THE NFPA 70, 2014 NATIONAL ELECTRICAL CODE (N.E.C.) (F.B.C. ADOPTED DECEMBER 31, 2017), ORANGE COUNTY STANDARDS AND SHALL COMPLY WITH ALL LOCAL RULES AND ORDINANCES.
- MINIMUM WIRE SIZE SHALL BE #12 A.W.G. EXCLUDING CONTROL WIRING, UNLESS OTHERWISE NOTED. ALL CONDUCTORS SHALL BE COPPER.
- IT IS NOT THE INTENT OF THESE PLANS TO SHOW EVERY MINOR DETAIL OF CONSTRUCTION. THE CONTRACTOR IS EXPECTED TO FURNISH AND INSTALL ALL ITEMS FOR A COMPLETE ELECTRICAL SYSTEM AND PROVIDE ALL REQUIREMENTS NECESSARY FOR THE EQUIPMENT TO BE PLACED IN PROPER WORKING ORDER.
- ELECTRICAL SYSTEM SHALL BE COMPLETE AND EFFECTIVELY GROUNDED AS REQUIRED BY THE 2014 EDITION OF THE N.E.C. OR LOCAL CODES. ALL CONDUITS SHALL HAVE A BOND WIRE SIZED PER TABLE 250 OF THE NATIONAL ELECTRICAL CODE.
- ALL MATERIALS SHALL BE NEW AND BEAR UNDERWRITERS' LABELS WHERE APPLICABLE.
- ALL WORK SHALL BE PERFORMED BY A LICENSED ELECTRICAL CONTRACTOR IN A FIRST CLASS WORKMANLIKE MANNER. THE COMPLETED SYSTEM SHALL BE FULLY OPERATIVE AND ACCEPTED BY ENGINEER/OWNER.
- CONTRACTOR SHALL GUARANTEE ALL MATERIALS AND WORKMANSHIP FREE FROM DEFECTS FOR A PERIOD OF NOT LESS THAN TWO YEARS FROM DATE OF ACCEPTANCE.
- CORRECTION OF ANY DEFECTS SHALL BE COMPLETED WITHOUT ADDITIONAL CHARGE AND SHALL INCLUDE REPLACEMENT OR REPAIR OF ANY OTHER PHASE OF THE INSTALLATION WHICH MAY HAVE BEEN DAMAGED.
- THE ELECTRICAL INSTALLATION SHALL MEET ALL STANDARD REQUIREMENTS OF THE NATIONAL ELECTRICAL CODE AND THE FLORIDA BUILDING CODE.
- CONTRACTOR SHALL BE RESPONSIBLE FOR ALL CUTTING AND PATCHING REQUIRED OF HIS WORK.
- ELECTRICAL CONTRACTOR SHALL LABEL ALL PANELS W/ TYPEWRITTEN DIRECTORIES (NEW & EXISTING).
- ALL ELECTRICAL WIRING SHALL BE THE RESPONSIBILITY OF THE ELECTRICAL CONTRACTOR.
- DO NOT SCALE THE ELECTRICAL DRAWINGS. REFER TO THE MECHANICAL DRAWINGS & THE APPROVED MANUFACTURER'S SHOP DRAWINGS FOR THE EXACT LOCATION OF ALL EQUIPMENT.
- SHADED TEXT DENOTES EXISTING EQUIPMENT OR STRUCTURES. NON-SHADED TEXT DENOTES NEW EQUIPMENT, STRUCTURES AND WORK. *SLANTED TEXT (NOT SHADED)* DENOTES FUTURE EQUIPMENT, STRUCTURES AND WORK.



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C	05/2019	ISSUED FOR BID	RRM
B	10/2018	90% DRAWINGS	RRM
A	08/2018	60% DRAWINGS	RRM

Issue Certification	
Designed	LMR
Drawn	RRM
Checked	WCN
Reviewed	LMR
Approved	MDP
 William C. Nelson, P.E. Florida P.E. No. 42017	

Scale	1" = 1" AT FULL SIZE
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ORANGE COUNTY
R-R PACKAGE 22 PUMP STATIONS
ELECTRICAL

ELECTRICAL NOTES, SYMBOLS AND ABBREVIATIONS

PROJECT NO.: 110034	
SCALE: NOTED	REVISION: C
DRAWING NO. E001	SHEET NO.: 29 OF 47


6965 PIAZZA GRANDE AVE., STE. 412
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PHONE: (407) 745-5604
FAX: (407) 745-5603
C.O.A. No. 8079

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OCU ADDRESS:
 PUMP STATION #3337
 3307 WHISPER LAKES BLVD

DUKE ADDRESS:
 PUMP STATION #3337
 3337 WHISPER LAKES BLVD
 DUKE ENERGY CONTACT:
 BRAD VAN GILDER
 BRADLEY.VANGILDER@DUKE-ENERGY.COM




**PS NO. 3337 DEMOLITION
 SINGLE LINE DIAGRAM**
 SCALE: N.T.S.

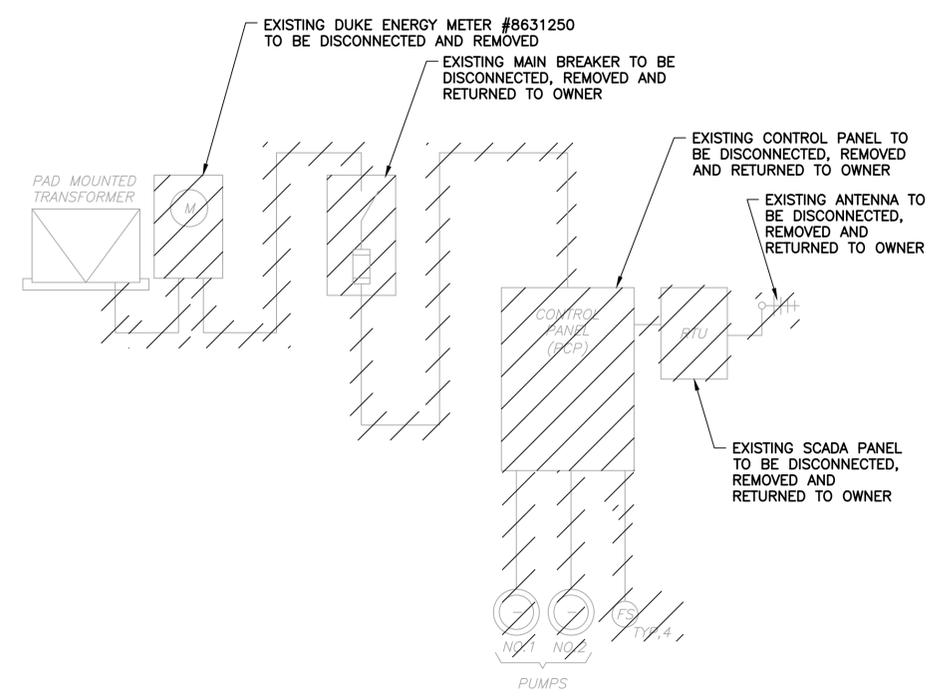LOAD TABULATION - PS 3337
SERVICE VOLTAGE: 480V-3φ

DESCRIPTION	LOAD	AMPACITY
PUMPS	2 @ 12.1 HP EACH	= 42.00 AMPS
MISCELLANEOUS LOADS		= 5.00 AMPS
CONNECTED LOAD		= 47.00 AMPS
①② SERVICE ENTRANCE = 47.00 AMPS + (.25)(21.00) =		52.25 AMPS

NOTES:

- SERVICE ENTRANCE MINIMUM SIZE AS PER ARTICLE 230 OF THE NATIONAL ELECTRICAL CODE.
- SERVICE ENTRANCE MINIMUM SIZE FOR ORANGE COUNTY IS 100 AMPS.

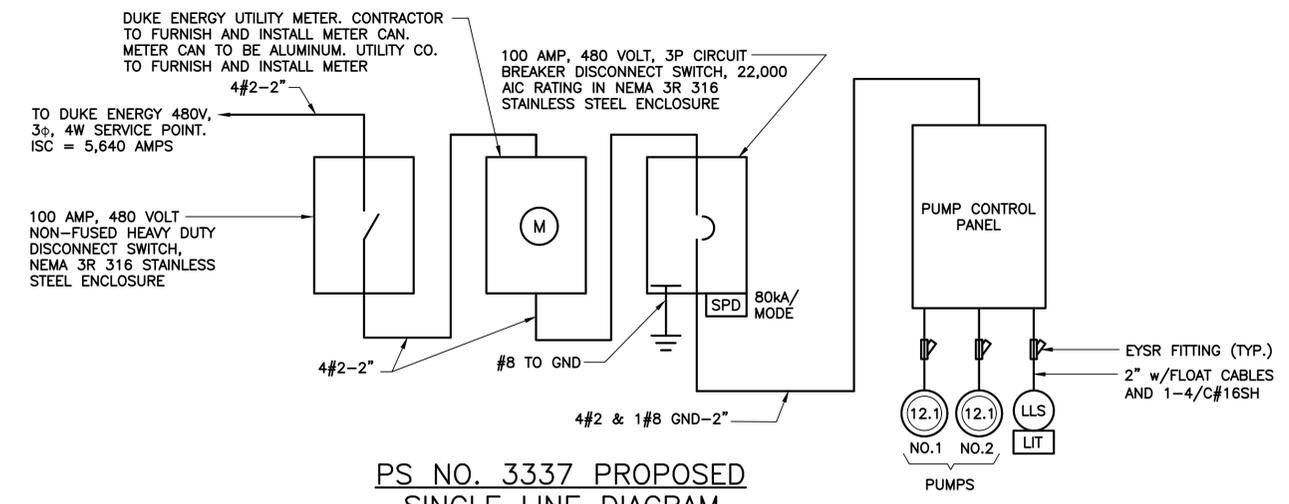

**PS NO. 3337 PROPOSED
 SINGLE LINE DIAGRAM**
 SCALE: N.T.S.

EDA
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 ORLANDO, FLORIDA 32835
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 FAX: (407) 745-5603
 C.O.A. No. 8079



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Issue Certification
 William C. Nelson, P.E.
 Florida P.E. No. 42017

Designed LMR
 Drawn RRM
 Checked WCN
 Reviewed LMR
 Approved MDP


ORANGE COUNTY
 R-R PACKAGE 22 PUMP STATIONS
 ELECTRICAL
 PUMP STATION 3337 - WHISPER LAKES 7 SINGLE LINE DIAGRAM

PROJECT NO.: 110034


SCALE: NOTED	REVISION: C
DRAWING NO. E100	SHEET NO.: 30 OF 47

RE
 REISS ENGINEERING, INC.
 1016 SPRING VILLAS PT.
 WINTER SPRINGS, FL 32708
 (407) 679-5358

Parent Sheet Set: 110034DC_Pkg22PS Rev/Plot by: WOLET VANATTA Rev on: 5/24/2019 8:45 AM Individual File Path: R:\PROJECTS\110034 - ORANGE COUNTY R-R PACKAGE 22 PUMP STATIONS\DESIGN\DRAWINGS\FINAL\DESIGN\E-101 PS 3337 DEMO.DWG

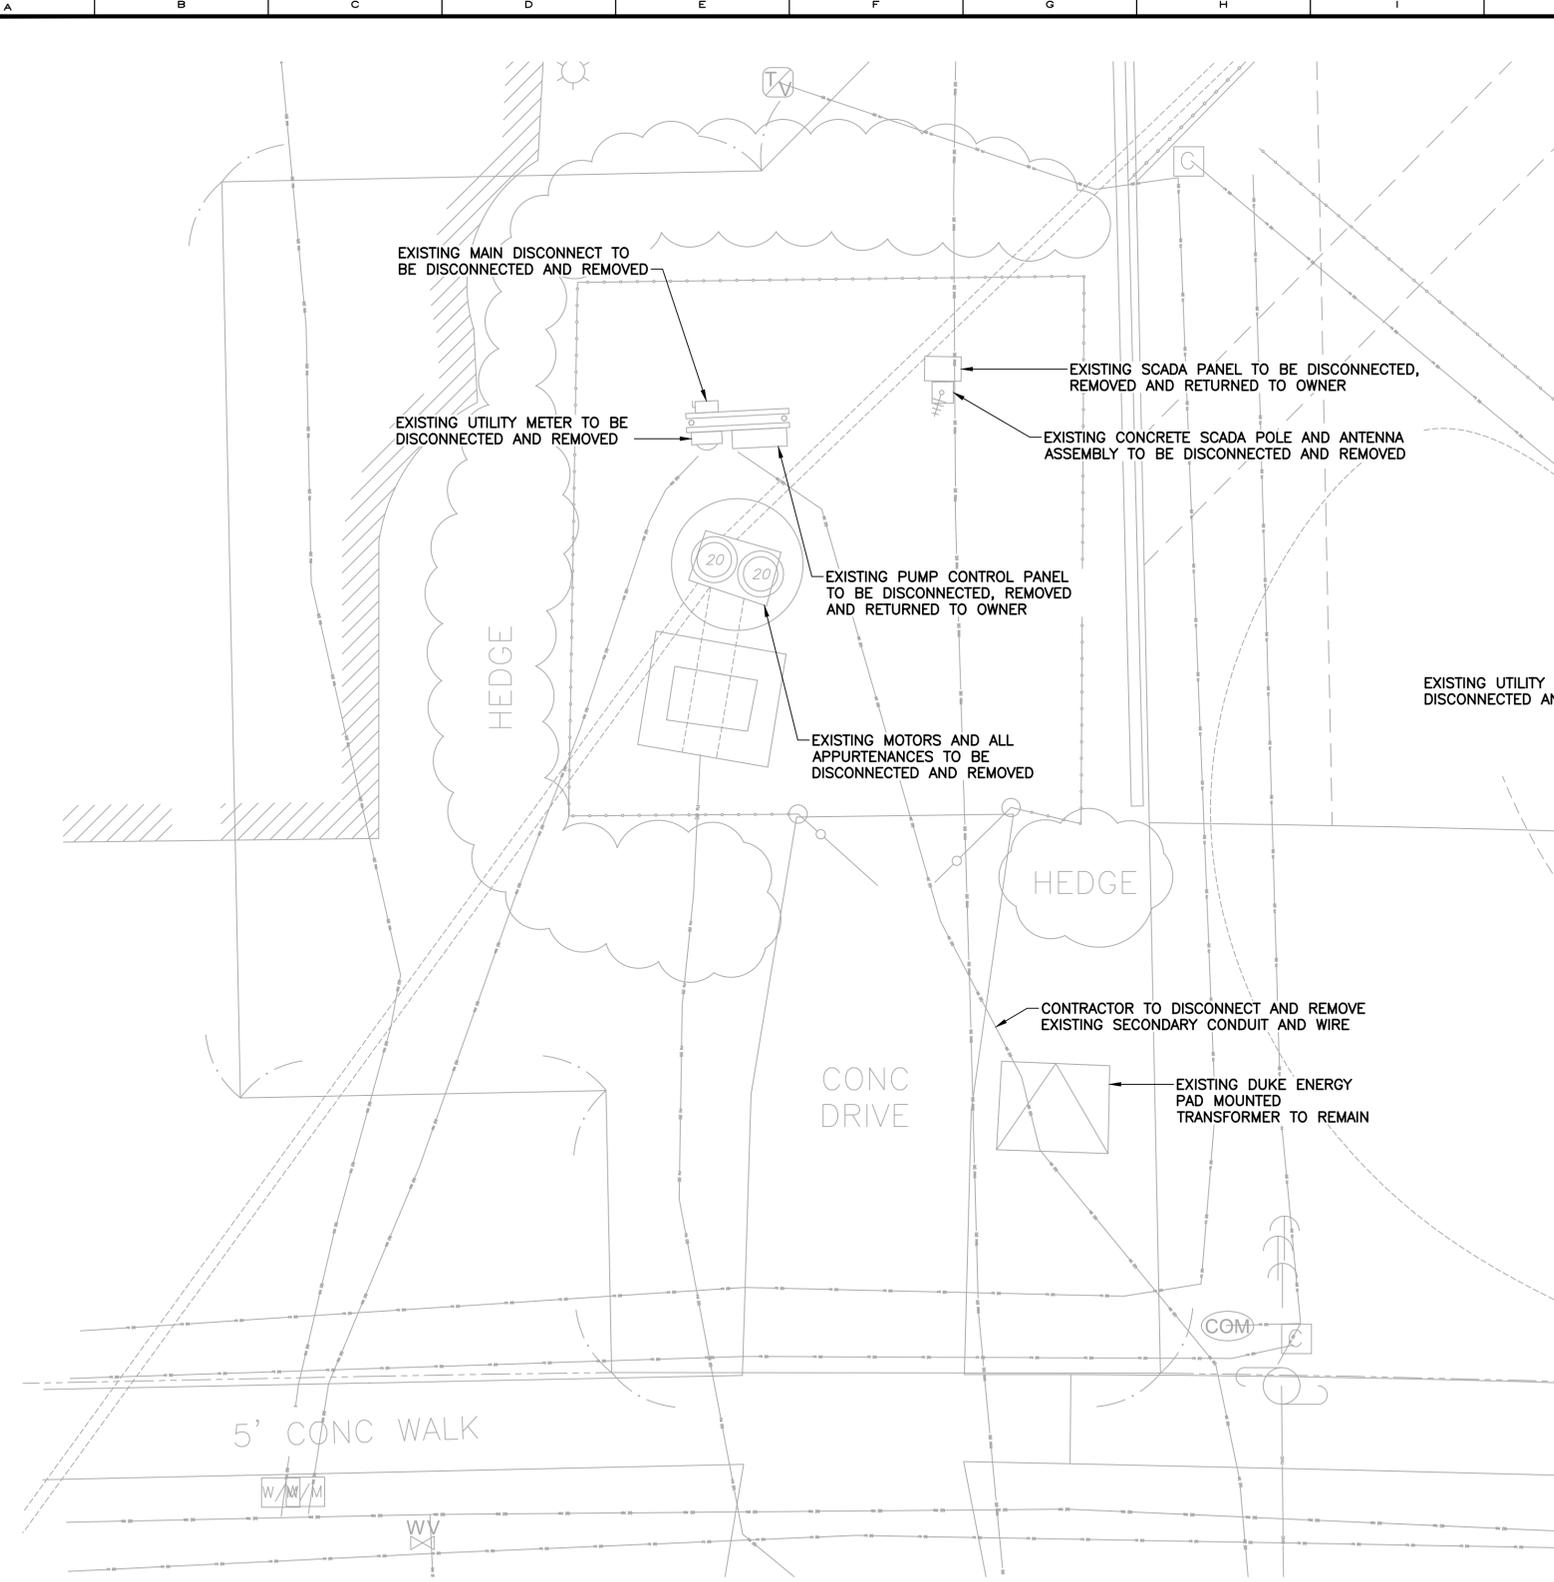

PS 3337 ELECTRICAL DEMOLITION PLAN

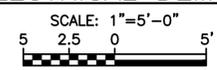

OCU ADDRESS:
 PUMP STATION #3337
 3307 WHISPER LAKES BLVD.

DUKE ADDRESS:
 PUMP STATION #3337
 3337 WHISPER LAKES BLVD
 DUKE ENERGY CONTACT:
 BRAD VAN GILDER
 BRADLEY.VANGILDER@DUKE-ENERGY.COM



PS 3337 FIGURE NO. 1
SCALE: N.T.S.



PS 3337 FIGURE NO. 2
SCALE: N.T.S.



PS 3337 FIGURE NO. 3
SCALE: N.T.S.



REV	DATE	DESCRIPTION	BY
C	05/2019	ISSUED FOR BID	RRM
B	10/2018	90% DRAWINGS	RRM
A	08/2018	60% DRAWINGS	RRM

Issue Certification	
Designed	LMR
Drawn	RRM
Checked	WCN
Reviewed	LMR
Approved	MDP
William C. Nelson, P.E. Florida P.E. No. 42017	


ORANGE COUNTY R-R PACKAGE 22 PUMP STATIONS ELECTRICAL
PUMP STATION 3337 - WHISPER LAKES 7 ELECTRICAL DEMOLITION PLAN

PROJECT NO.: 110034
SCALE: NOTED
REVISION: C
DRAWING NO. E101
SHEET NO.: 31 OF 47

6965 PIAZZA GRANDE AVE., STE. 412 ORLANDO, FLORIDA 32835 PHONE: (407) 745-5604 FAX: (407) 745-5603 C.O.A. No. 8079
--



Parent Sheet Set: 110034OC_PK022PS Rev/Plot by: VIOLET VANATTA Rev on: 5/24/2019 8:45 AM Individual File Path: R:\PROJECTS\110034 - ORANGE COUNTY R-R PACKAGE 22 PUMP STATIONS\DESIGN\DRAWINGS\FINAL\DESIGN\E-102 PS 3337 PLAN.DWG

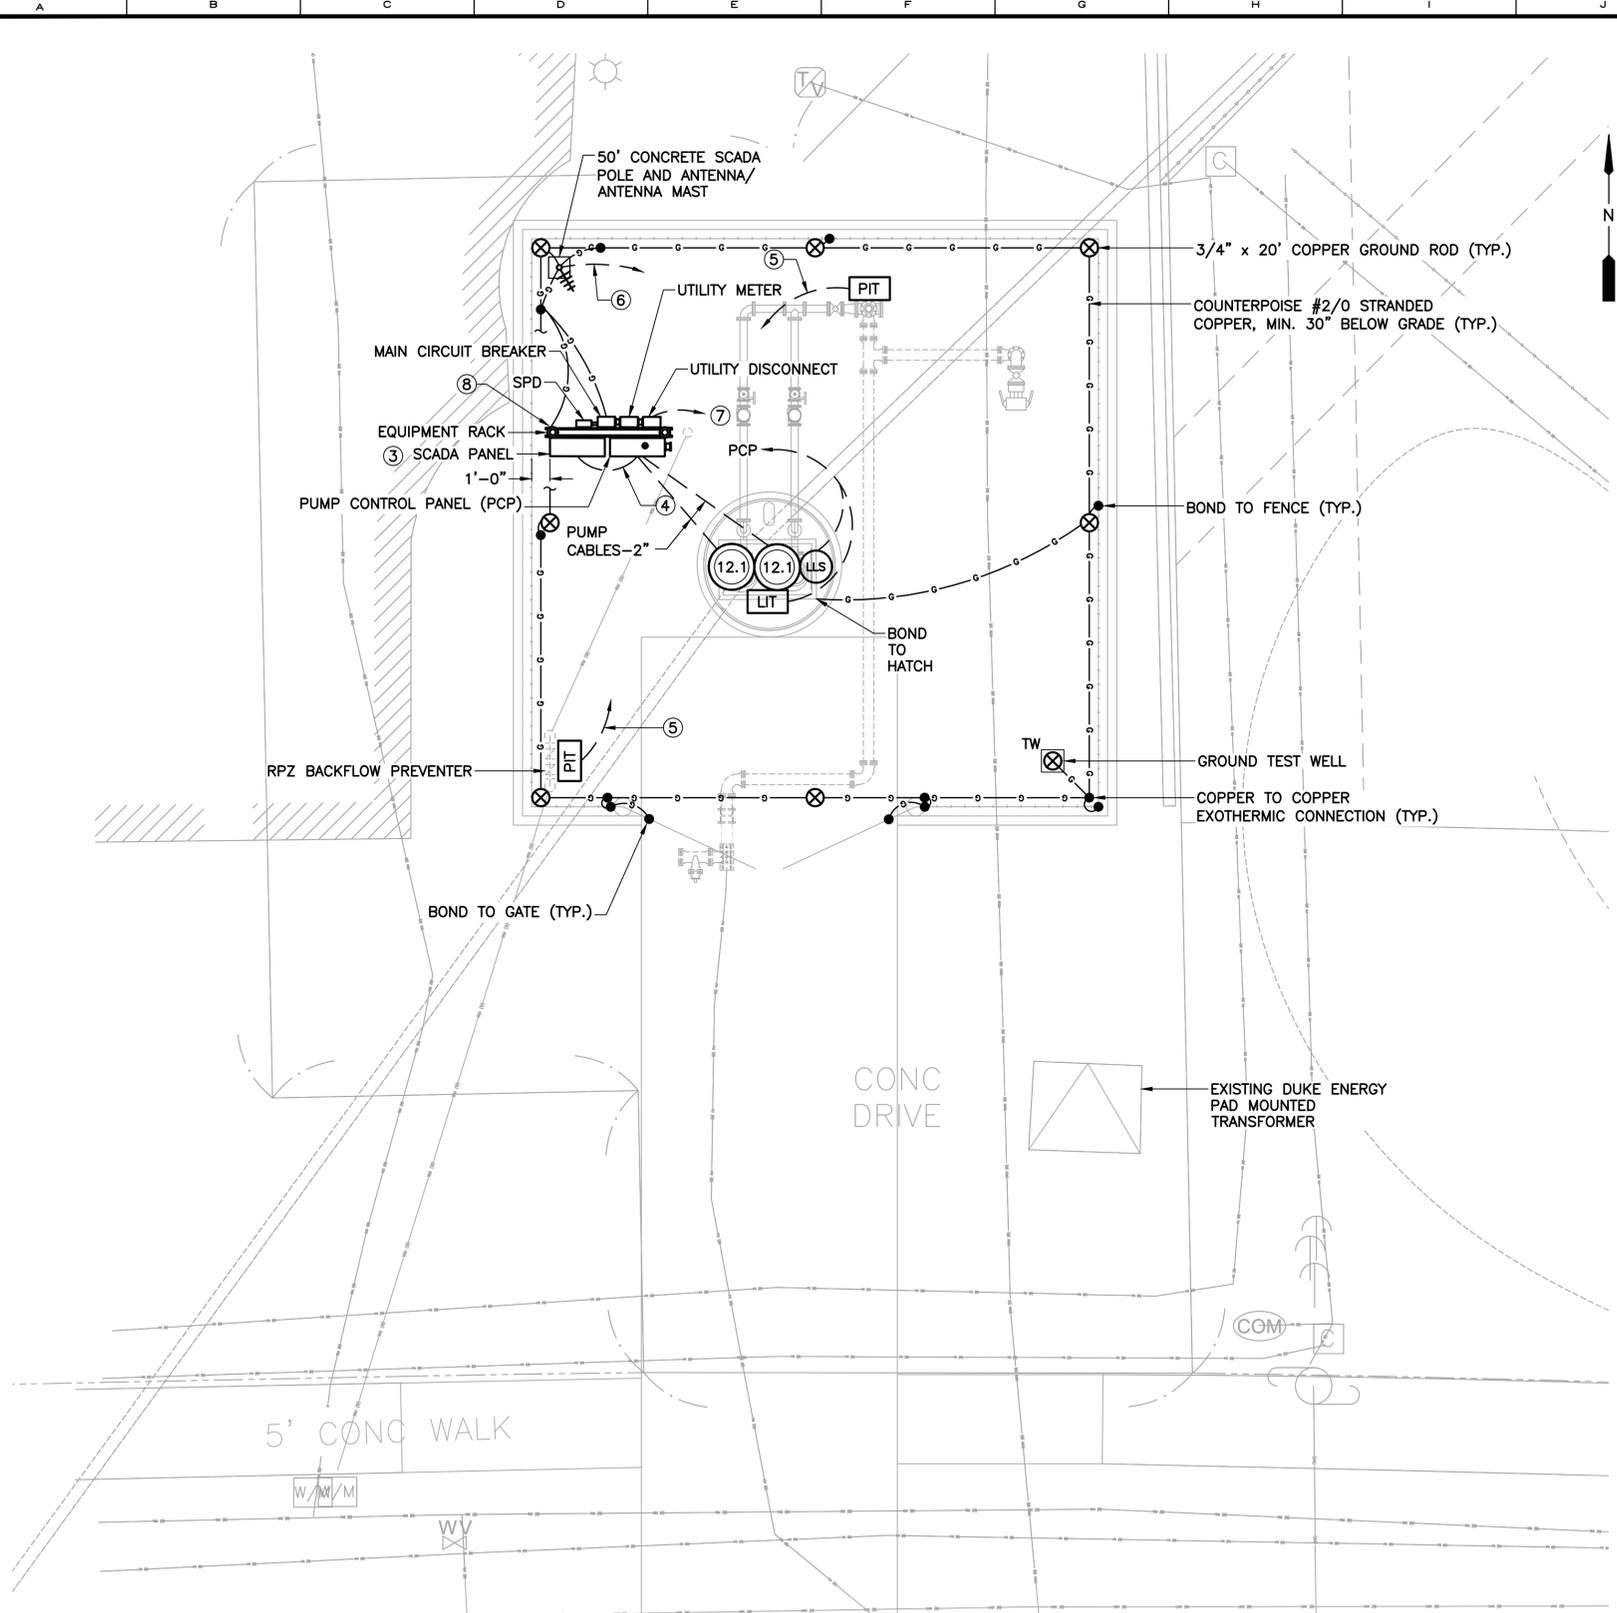


OCU ADDRESS:
 PUMP STATION #3337
 3307 WHISPER LAKES BLVD.

DUKE ADDRESS:
 PUMP STATION #3337
 3337 WHISPER LAKES BLVD
 DUKE ENERGY CONTACT:
 BRAD VAN GILDER
 BRADLEY.VANGILDER@DUKE-ENERGY.COM

- NOTES:**
- ① REFER TO SHEET E-001 FOR ELECTRICAL NOTES, SYMBOLS AND ABBREVIATIONS.
 - ② REFER TO SINGLE LINE DIAGRAM FOR CONDUIT AND WIRE REQUIREMENTS.
 - ③ CONTRACTOR TO FURNISH AND INSTALL ANTENNA MAST, SCADA PANEL, ANTENNA, AND ANTENNA CABLE. CONTRACTOR TO PROVIDE THE INTERCONNECTION BETWEEN THE PCP AND THE SCADA PANEL, INCLUDING TERMINATION OF THE ANTENNA.
 - ④ CONTRACTOR TO FURNISH AND INSTALL CONDUITS WITH CABLING FROM THE SCADA PANEL TO THE PCP.
 - ⑤ 1" WITH CABLING TO SCADA PANEL.
 - ⑥ 2" WITH CABLING TO SCADA PANEL.
 - ⑦ TO 480V-3φ SERVICE POINT.
 - ⑧ BOND EQUIPMENT RACK TO GROUND GRID.

PS 3337 ELECTRICAL PLAN

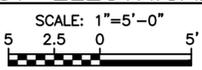

REV	DATE	DESCRIPTION	BY
C	05/2019	ISSUED FOR BID	RRM
B	10/2018	90% DRAWINGS	RRM
A	08/2018	60% DRAWINGS	RRM

Issue Certification

William C. Nelson, P.E.
 Florida P.E. No. 42017

Designed LMR
 Drawn RRM
 Checked WCN
 Reviewed LMR
 Approved MDP

ORANGE COUNTY
 R-R PACKAGE 22 PUMP STATIONS
 ELECTRICAL
 PUMP STATION 3337 - WHISPER LAKES 7 ELECTRICAL PLAN


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SCALE: NOTED	REVISION: C
DRAWING NO. E102	SHEET NO.: 32 OF 47



Parent Sheet Set: 110034DC_PKG22PS Rev/Plot by: VIOLET VANATTA Rev on: 5/24/2019 9:32 AM Individual File Path: R:\PROJECTS\110034 - ORANGE COUNTY R-R PACKAGE 22 PUMP STATIONS\DESIGN\DRAWINGS\FINAL\DESIGN\E-200 PS_3351_SLD.DWG

OCU ADDRESS:
 PUMP STATION #3351
 2243 WHISPER LAKES BLVD

DUKE ADDRESS:
 PUMP STATION #3351
 3351 WHISPER LAKES BLVD
 DUKE ENERGY CONTACT:
 BRAD VAN GILDER
 BRADLEY.VANGILDER@DUKE-ENERGY.COM

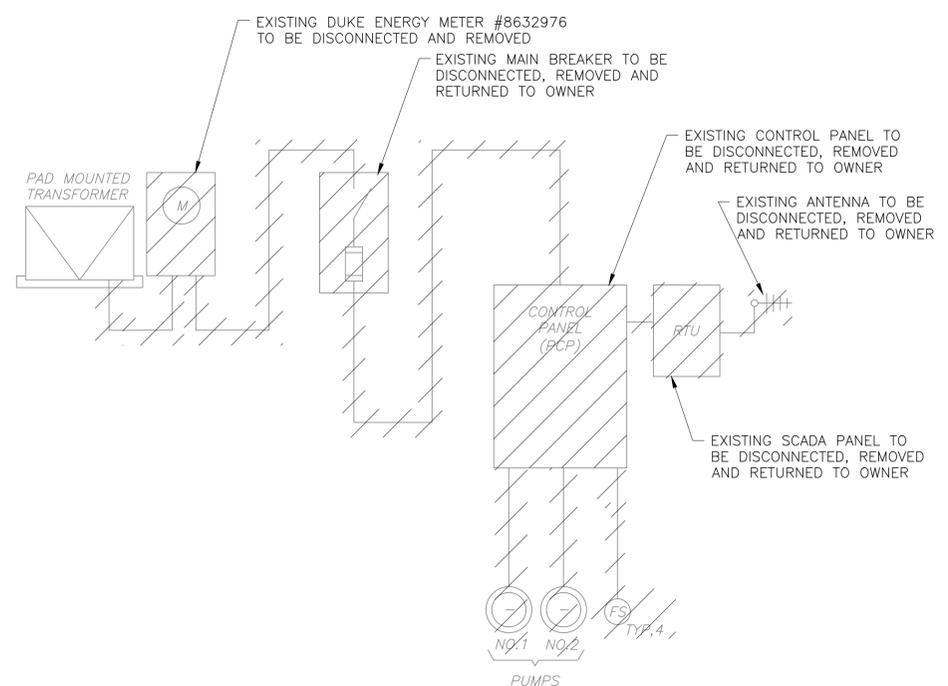

**PS NO. 3351 DEMOLITION
 SINGLE LINE DIAGRAM**
 SCALE: N.T.S.

LOAD TABULATION - PS 3351


SERVICE VOLTAGE: 480V-3φ

DESCRIPTION	LOAD	AMPACITY
PUMPS	2 @14.1 HP EACH	= 42.00 AMPS
MISCELLANEOUS LOADS		= 5.00 AMPS
CONNECTED LOAD		= 47.00 AMPS

①② SERVICE ENTRANCE = 47.00 AMPS + (.25)(21.00) = **52.25 AMPS**

NOTES:

- SERVICE ENTRANCE MINIMUM SIZE AS PER ARTICLE 230 OF THE NATIONAL ELECTRICAL CODE.
- SERVICE ENTRANCE MINIMUM SIZE FOR ORANGE COUNTY IS 100 AMPS.

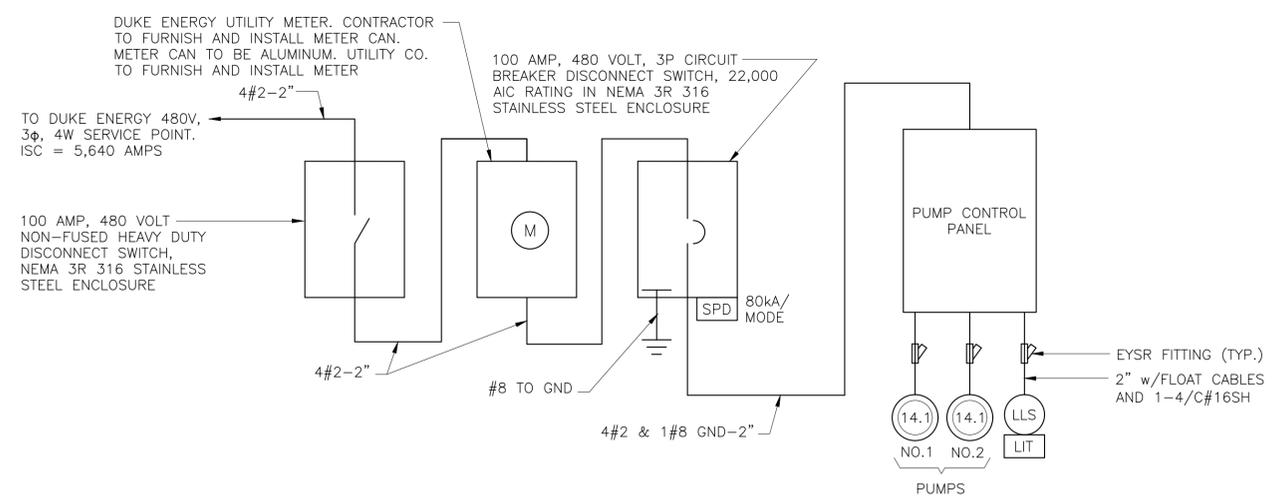

**PS NO. 3351 PROPOSED
 SINGLE LINE DIAGRAM**
 SCALE: N.T.S.

EDA
 Electrical Design Associates
 6965 PIAZZA GRANDE AVE., STE. 412
 ORLANDO, FLORIDA 32835
 PHONE: (407) 745-5604
 FAX: (407) 745-5603
 C.O.A. No. 8079



REV	DATE	DESCRIPTION	BY
C	05/2019	ISSUED FOR BID	RRM
B	10/2018	90% DRAWINGS	RRM
A	08/2018	60% DRAWINGS	RRM

Issue Certification
 William C. Nelson, P.E.
 Florida P.E. No. 42017

Designed LMR
 Drawn RRM
 Checked WCN
 Reviewed LMR
 Approved MDP


ORANGE COUNTY
 R-R PACKAGE 22 PUMP STATIONS
 ELECTRICAL
PUMP STATION 3351 - WHISPER LAKES 4 SINGLE LINE DIAGRAM

PROJECT NO.: 110034

SCALE: NOTED	REVISION: C
DRAWING NO. E200	SHEET NO.: 33 OF 47

RE
 REISS ENGINEERING, INC.
 1016 SPRING VILLAS PT.
 WINTER SPRINGS, FL 32708
 (407) 679-5358

Parent Sheet Set: 110034DC_Pkg22PS Rev/Plot by: VIOLET VANATTA Rev on: 5/24/2019 8:45 AM Individual File Path: R:\PROJECTS\110034 - ORANGE COUNTY R-R PACKAGE 22 PUMP STATIONS\DESIGN\DRAWINGS\FINAL\DESIGN\E-201 PS 3351 DEMO.DWG

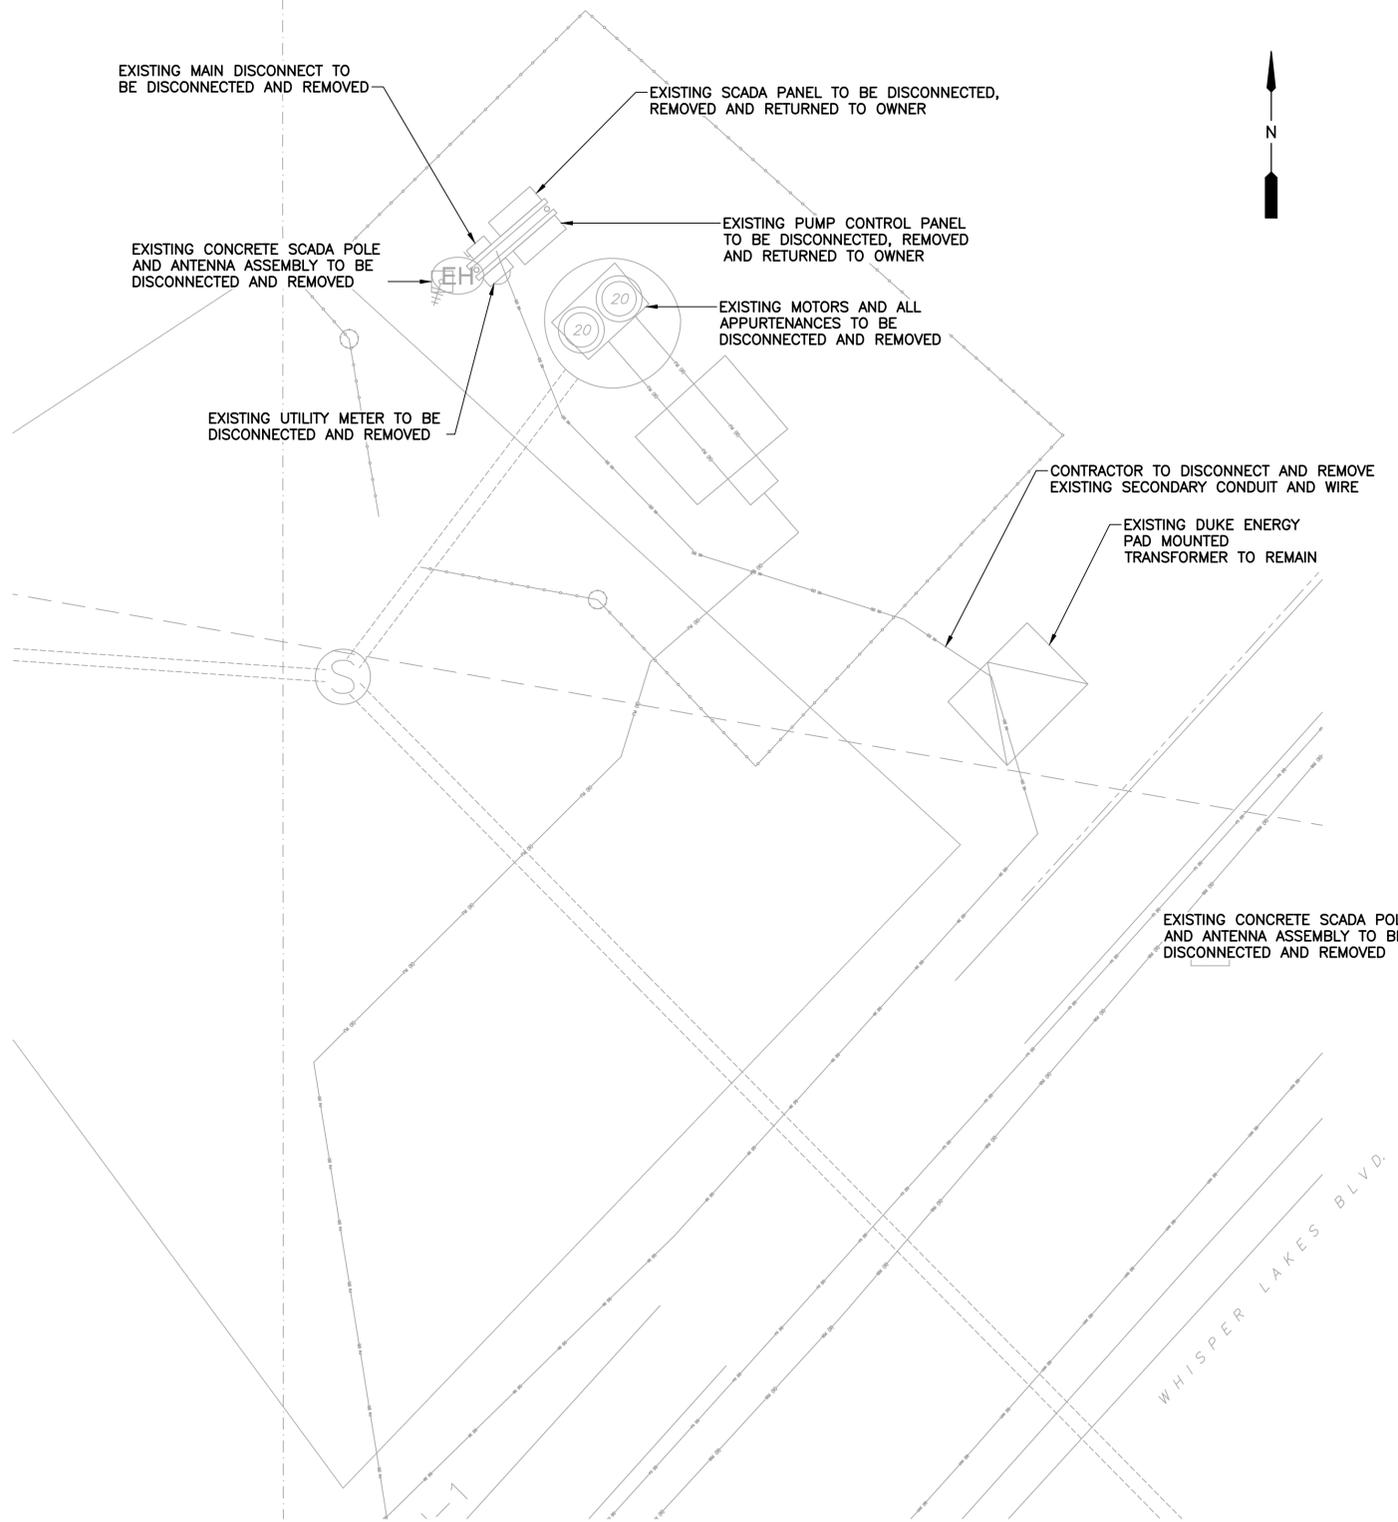

PS 3351 ELECTRICAL DEMOLITION PLAN

SCALE: 1"=5'-0"
 5 2.5 0 5'

OCU ADDRESS:
 PUMP STATION #3351
 2243 WHISPER LAKES BLVD.

DUKE ADDRESS:
 PUMP STATION #3351
 3351 WHISPER LAKES BLVD
 DUKE ENERGY CONTACT:
 BRAD VAN GILDER
 BRADLEY.VANGILDER@DUKE-ENERGY.COM



EXISTING UTILITY METER TO BE DISCONNECTED AND REMOVED

PS 3351 FIGURE NO. 1
 SCALE: N.T.S.

EXISTING PUMP CONTROL PANEL TO BE DISCONNECTED, REMOVED AND RETURNED TO OWNER



EXISTING PUMP CONTROL PANEL TO BE DISCONNECTED, REMOVED AND RETURNED TO OWNER

PS 3351 FIGURE NO. 2
 SCALE: N.T.S.



EXISTING SCADA PANEL TO BE DISCONNECTED, REMOVED AND RETURNED TO OWNER

EXISTING MAIN DISCONNECT TO BE DISCONNECTED AND REMOVED

PS 3351 FIGURE NO. 3
 SCALE: N.T.S.

EDA
 Electrical Design Associates
 6965 PIAZZA GRANDE AVE., STE. 412
 ORLANDO, FLORIDA 32835
 PHONE: (407) 745-5604
 FAX: (407) 745-5603
 C.O.A. No. 8079



REV	DATE	DESCRIPTION	BY
C	05/2019	ISSUED FOR BID	RRM
B	10/2018	90% DRAWINGS	RRM
A	08/2018	60% DRAWINGS	RRM

Issue Certification	
Designed	LMR
Drawn	RRM
Checked	WCN
Reviewed	LMR
Approved	MDP
William C. Nelson, P.E. Florida P.E. No. 42017	

LINE IS 1" AT FULL SIZE

ORANGE COUNTY
 R-R PACKAGE 22 PUMP STATIONS
 ELECTRICAL
 PUMP STATION 3351 - WHISPER LAKES 4
 ELECTRICAL DEMOLITION PLAN


PROJECT NO.:	110034
SCALE:	NOTED
REVISION:	C
DRAWING NO.:	E201
SHEET NO.:	34 OF 47

RE
 REISS ENGINEERING, INC.
 1016 SPRING VILLAS PT.
 WINTER SPRINGS, FL 32708
 (407) 679-5358

Parent Sheet Set: 110034OC_PK022PS Rev/Plot by: VIOLET VANATTA Rev on: 5/24/2019 8:45 AM Individual File Path: R:\PROJECTS\110034 - ORANGE COUNTY R-R PACKAGE 22 PUMP STATIONS\DESIGN\DRAWINGS\FINAL\DESIGN\E-202 PS 3351 PLAN.DWG


OCU ADDRESS:
 PUMP STATION #3351
 2243 WHISPER LAKES BLVD.

DUKE ADDRESS:
 PUMP STATION #3351
 3351 WHISPER LAKES BLVD
 DUKE ENERGY CONTACT:
 BRAD VAN GILDER
 BRADLEY.VANGILDER@DUKE-ENERGY.COM

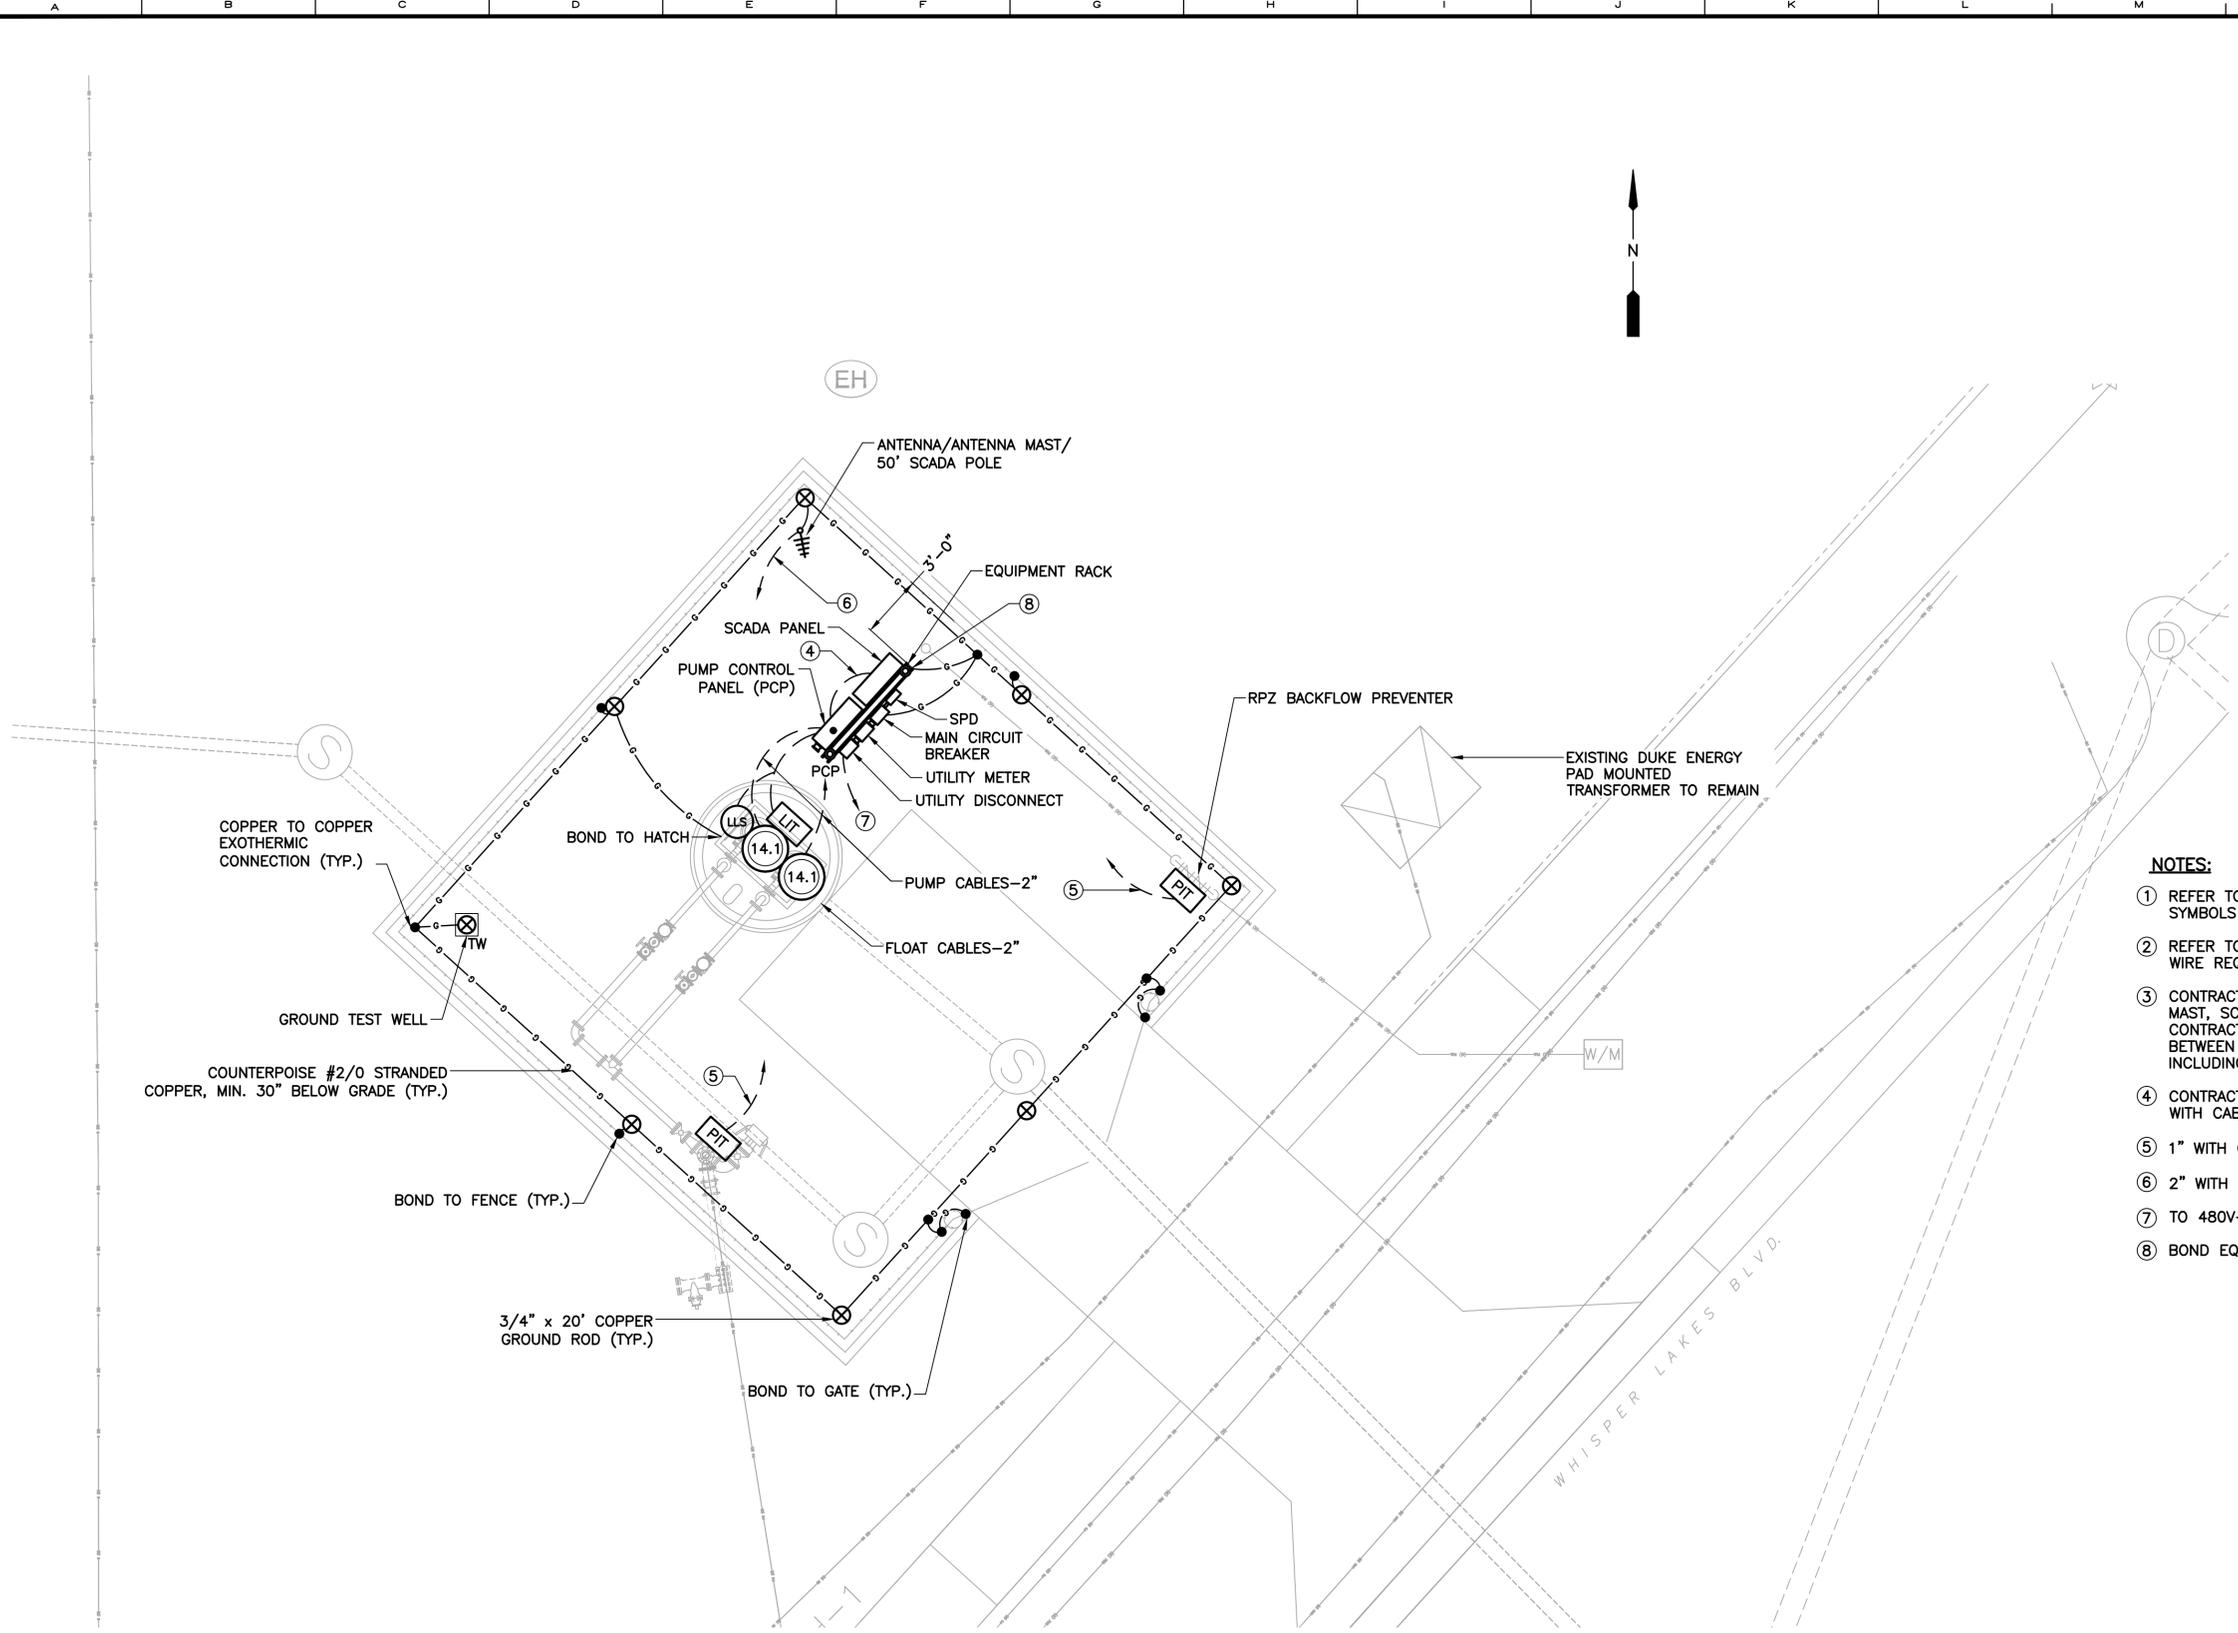

- NOTES:**
- ① REFER TO SHEET E-001 FOR ELECTRICAL NOTES, SYMBOLS AND ABBREVIATIONS.
 - ② REFER TO SINGLE LINE DIAGRAM FOR CONDUIT AND WIRE REQUIREMENTS.
 - ③ CONTRACTOR TO FURNISH AND INSTALL ANTENNA MAST, SCADA PANEL, ANTENNA, AND ANTENNA CABLE. CONTRACTOR TO PROVIDE THE INTERCONNECTION BETWEEN THE PCP AND THE SCADA PANEL, INCLUDING TERMINATION OF THE ANTENNA.
 - ④ CONTRACTOR TO FURNISH AND INSTALL CONDUITS WITH CABLING FROM THE SCADA PANEL TO THE PCP.
 - ⑤ 1" WITH CABLING TO SCADA PANEL.
 - ⑥ 2" WITH CABLING TO SCADA PANEL.
 - ⑦ TO 480V-3 ϕ SERVICE POINT.
 - ⑧ BOND EQUIPMENT RACK TO GROUND GRID.

PS 3351 ELECTRICAL PLAN

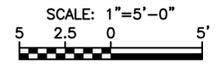

EDA
 Electrical Design Associates
 6965 PIAZZA GRANDE AVE., STE. 412
 ORLANDO, FLORIDA 32835
 PHONE: (407) 745-5604
 FAX: (407) 745-5603
 C.O.A. No. 8079



REV	DATE	DESCRIPTION	BY
C	05/2019	ISSUED FOR BID	RRM
B	10/2018	90% DRAWINGS	RRM
A	08/2018	60% DRAWINGS	RRM

Issue Certification	
BY	DATE
William C. Nelson, P.E. Florida P.E. No. 42017	

Designed	LMR
Drawn	RRM
Checked	WCN
Reviewed	LMR
Approved	MDP

ORANGE COUNTY
 R-R PACKAGE 22 PUMP STATIONS
 ELECTRICAL
PUMP STATION 3351 - WHISPER LAKES 4 ELECTRICAL PLAN


PROJECT NO.: 110034	
SCALE: NOTED	REVISION: C
DRAWING NO. E202	SHEET NO.: 35 OF 47

RE
 REISS ENGINEERING, INC.
 1016 SPRING VILLAS PT.
 WINTER SPRINGS, FL 32708
 (407) 679-5358

Parent Sheet Set: 1100340C_PKG22PS Rev/Plot by: VIOLET VANATTA Rev on: 5/24/2019 8:45 AM Individual File Path: R:\PROJECTS\110034 - ORANGE COUNTY R-R PACKAGE 22 PUMP STATIONS\DESIGN\DRAWINGS\FINAL\DESIGN\E-300 PS 3301 SLD.DWG

OCU ADDRESS:
 PUMP STATION #3301
 12156 URACUS STREET

DUKE ADDRESS:
 PUMP STATION #3301
 0 PEPPERMILL BLVD.
 DUKE ENERGY CONTACT:
 BRAD VAN GILDER
 BRADLEY.VANGILDER@DUKE-ENERGY.COM

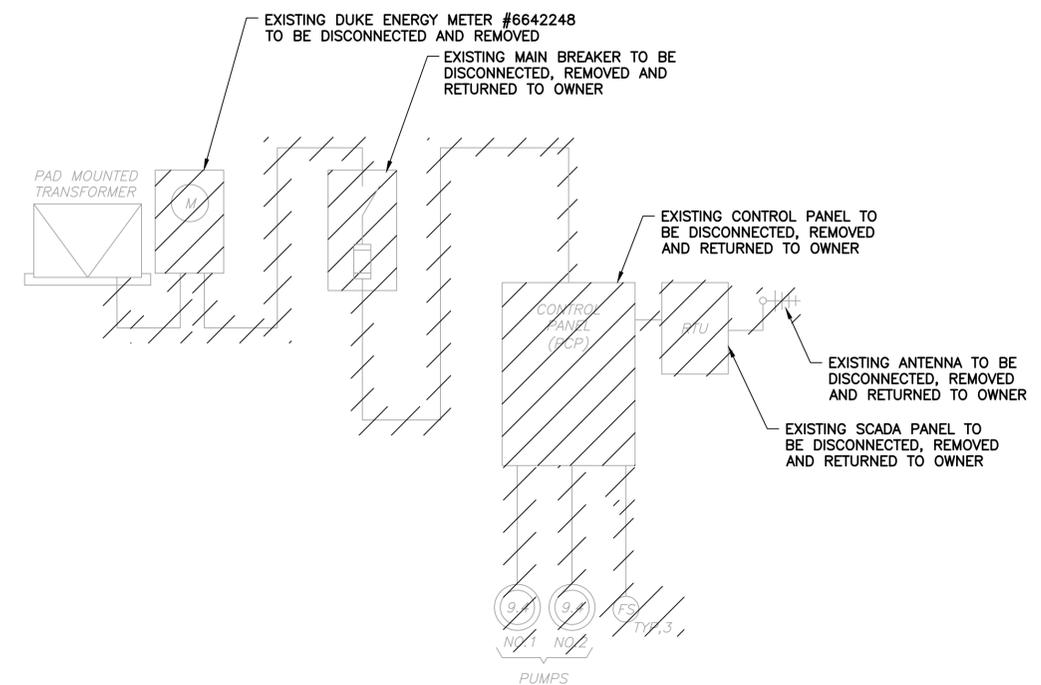

**PS NO. 3301 DEMOLITION
 SINGLE LINE DIAGRAM**
 SCALE: N.T.S.


LOAD TABULATION - PS 3301
SERVICE VOLTAGE: 240V-3 ϕ

DESCRIPTION	LOAD	AMPACITY
PUMPS	2 @ 7.5 HP EACH	= 44.00 AMPS
MISCELLANEOUS LOADS		= 5.00 AMPS
CONNECTED LOAD		= 49.00 AMPS

①② SERVICE ENTRANCE = 49.00 AMPS + (.25)(22.0) = **54.50 AMPS**

NOTES:

- SERVICE ENTRANCE MINIMUM SIZE AS PER ARTICLE 230 OF THE NATIONAL ELECTRICAL CODE.
- SERVICE ENTRANCE MINIMUM SIZE FOR ORANGE COUNTY IS 100 AMPS.

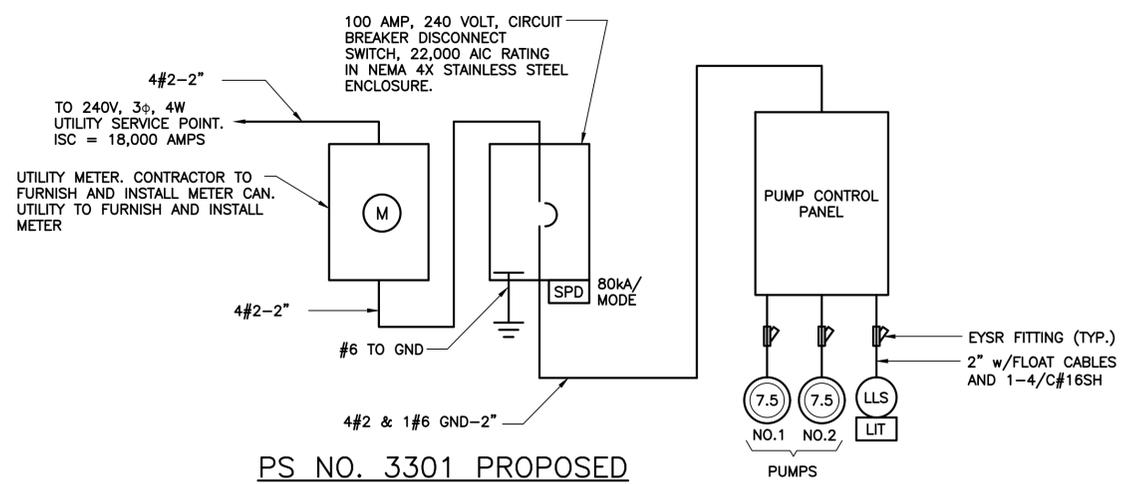

**PS NO. 3301 PROPOSED
 SINGLE LINE DIAGRAM**
 SCALE: N.T.S.

EDA
 Electrical Design Associates
 6965 PIAZZA GRANDE AVE., STE. 412
 ORLANDO, FLORIDA 32835
 PHONE: (407) 745-5604
 FAX: (407) 745-5603
 C.O.A. No. 8079



REV	DATE	DESCRIPTION	BY
C	05/2019	ISSUED FOR BID	RRM
B	10/2018	90% DRAWINGS	RRM
A	08/2018	60% DRAWINGS	RRM

Issue Certification
 William C. Nelson, P.E.
 Florida P.E. No. 42017

Designed LMR
 Drawn RRM
 Checked WCN
 Reviewed LMR
 Approved MDP
 LINE IS 1" AT FULL SIZE


ORANGE COUNTY
 R-R PACKAGE 22 PUMP STATIONS
 ELECTRICAL
 PUMP STATION 3301 - PEPPER MILL 4 SINGLE LINE DIAGRAM

PROJECT NO.: 110034



SCALE: NOTED	REVISION: C
DRAWING NO. E300	SHEET NO.: 36 OF 47

RE
 REISS ENGINEERING, INC.
 1016 SPRING VILLAS PT.
 WINTER SPRINGS, FL 32708
 (407) 679-5358

Parent Sheet Set: 110034DC_PK622PS Rev/Plot by: VIOLET VANATTA Rev on: 5/24/2019 8:45 AM Individual File Path: R:\PROJECTS\110034 - ORANGE COUNTY R-R PACKAGE 22 PUMP STATIONS\DESIGN\DRAWINGS\FINAL\DESIGN\E-301 PS 3301 DEMO.DWG

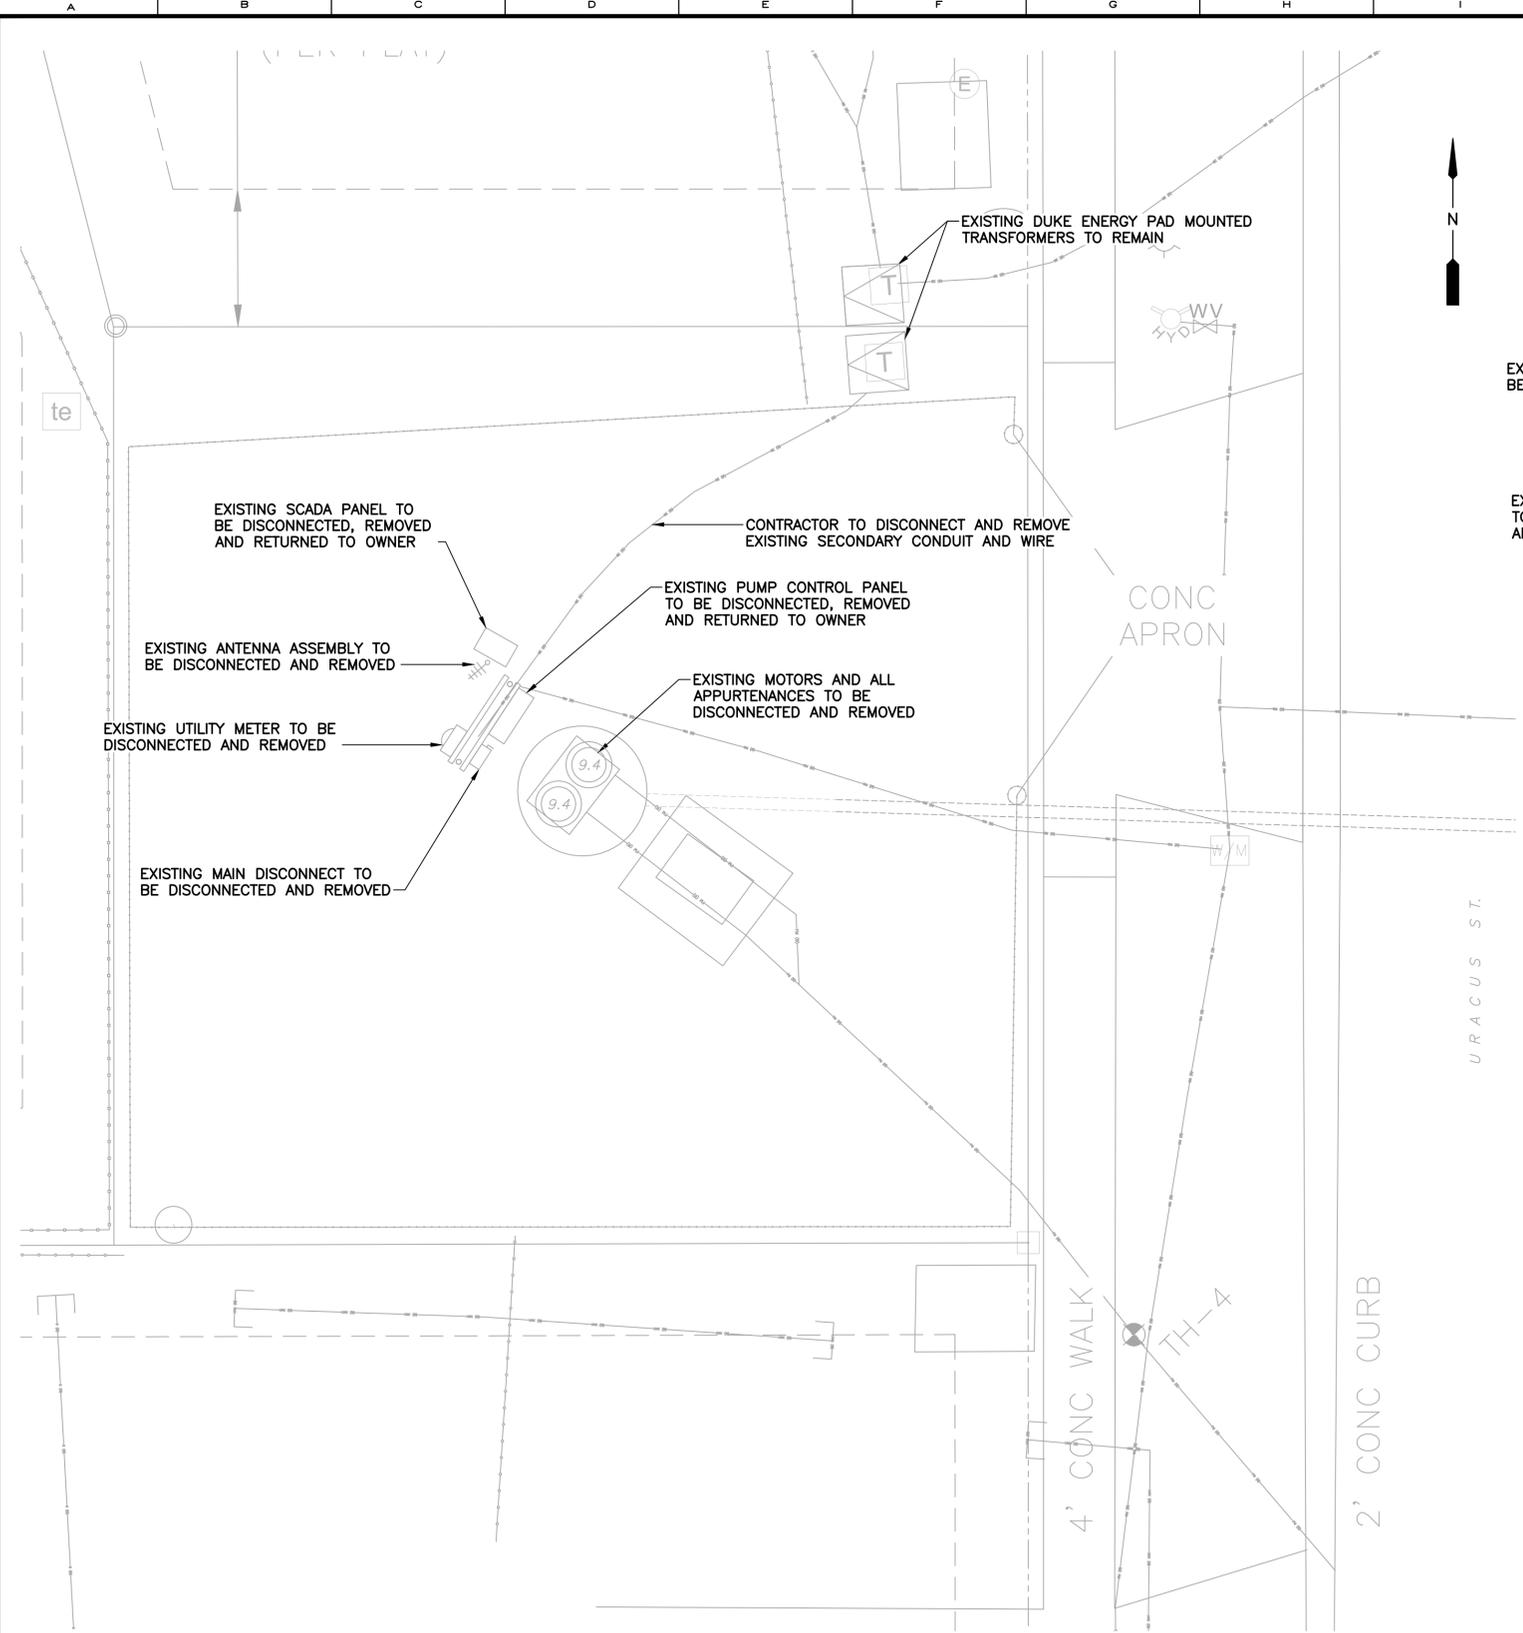

PS 3301 ELECTRICAL DEMOLITION PLAN

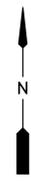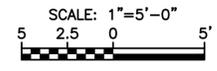

OCU ADDRESS:
 PUMP STATION #3301
 12156 URACUS STREET

DUKE ADDRESS:
 PUMP STATION #3301
 0 PEPPERMILL BLVD.
 DUKE ENERGY CONTACT:
 BRAD VAN GILDER
 BRADLEY.VANGILDER@DUKE-ENERGY.COM

EXISTING LIGHT FIXTURE ASSEMBLY TO BE DISCONNECTED AND REMOVED



EXISTING MAIN DISCONNECT TO BE DISCONNECTED AND REMOVED

EXISTING PUMP CONTROL PANEL TO BE DISCONNECTED, REMOVED AND RETURNED TO OWNER

EXISTING ANTENNA ASSEMBLY TO BE DISCONNECTED AND REMOVED

EXISTING SCADA PANEL TO BE DISCONNECTED, REMOVED AND RETURNED TO OWNER

PS 3301 FIGURE NO. 1
SCALE: N.T.S.

EXISTING PAD MOUNTED TRANSFORMER TO REMAIN



PS 3301 FIGURE NO. 2
SCALE: N.T.S.

EXISTING SCADA PANEL TO BE DISCONNECTED, REMOVED AND RETURNED TO OWNER



EXISTING UTILITY METER TO BE DISCONNECTED AND REMOVED

PS 3301 FIGURE NO. 3
SCALE: N.T.S.

EDA
 Electrical Design Associates
 6965 PLAZA GRANDE AVE., STE. 412
 ORLANDO, FLORIDA 32835
 PHONE: (407) 745-5604
 FAX: (407) 745-5603
 C.O.A. No. 8079



REV	DATE	DESCRIPTION	BY
C	05/2019	ISSUED FOR BID	RRM
B	10/2018	90% DRAWINGS	RRM
A	08/2018	60% DRAWINGS	RRM

Issue Certification	
Designed	LMR
Drawn	RRM
Checked	WCN
Reviewed	LMR
Approved	MDP
William C. Nelson, P.E. Florida P.E. No. 42017	


LINE IS 1" AT FULL SIZE

ORANGE COUNTY
 R-R PACKAGE 22 PUMP STATIONS
 ELECTRICAL
 PUMP STATION 3301 - PEPPERMILL 4
 ELECTRICAL DEMOLITION PLAN

PROJECT NO.: 110034	
SCALE: NOTED	REVISION: C
DRAWING NO. E301	SHEET NO.: 37 OF 47

RE
 REISS ENGINEERING, INC.
 1016 SPRING VILLAS PT.
 WINTER SPRINGS, FL 32708
 (407) 679-5358

Parent Sheet Set: 1100340C_Pkg22PS Rev/Plot by: VIOLET VANATTA Rev on: 5/24/2019 8:45 AM Individual File Path: R:\PROJECTS\110034 - ORANGE COUNTY R-R PACKAGE 22 PUMP STATIONS\DESIGN\DRAWINGS\FINAL\DESIGN\E-302 PS 3301 PLAN.DWG

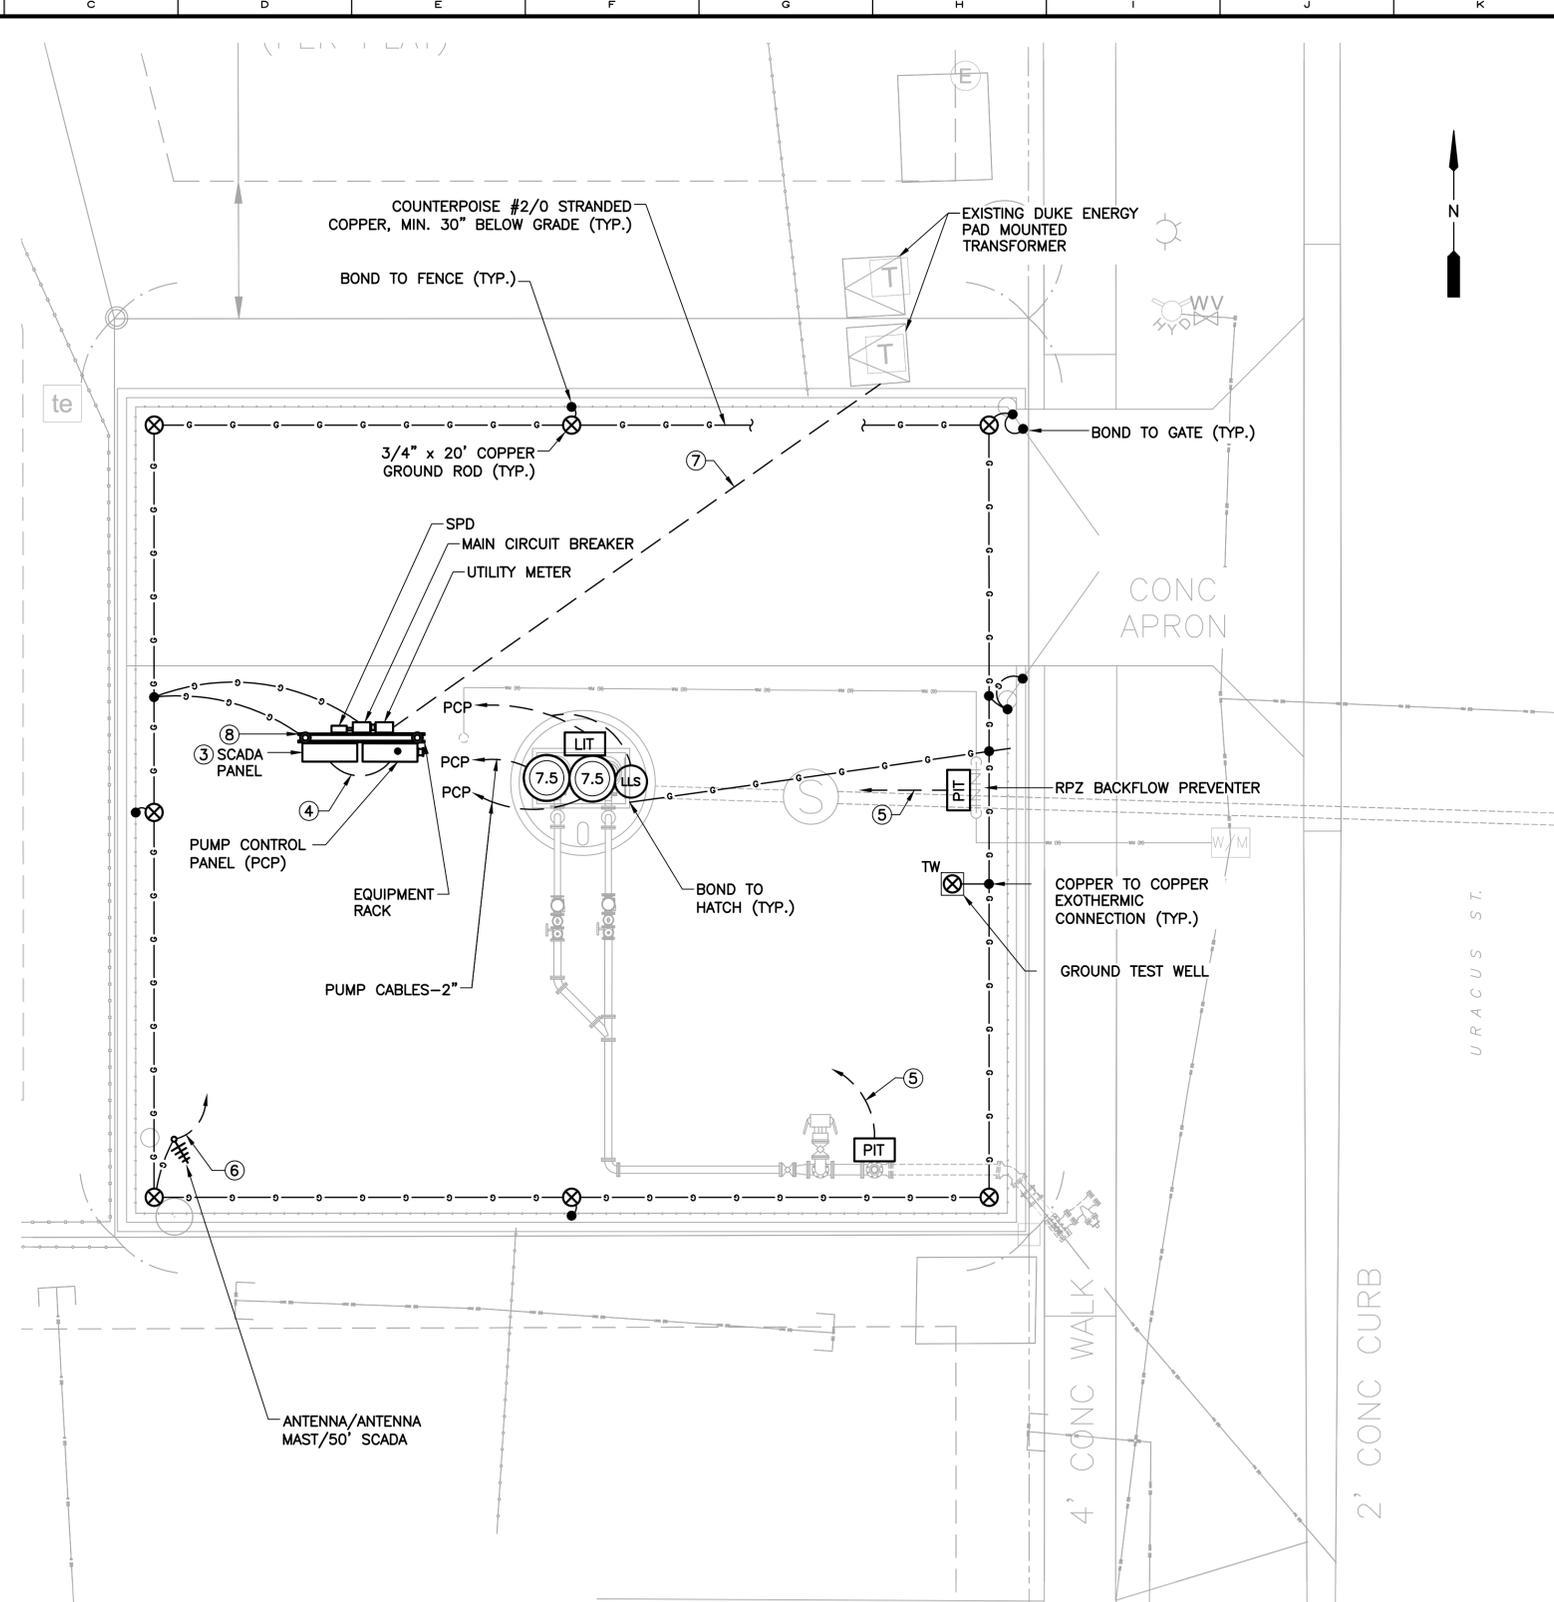


OCU ADDRESS:
 PUMP STATION #3301
 12156 URACUS STREET

DUKE ADDRESS:
 PUMP STATION #3301
 0 PEPPERMILL BLVD.
 DUKE ENERGY CONTACT:
 BRAD VAN GILDER
 BRADLEY.VANGILDER@DUKE-ENERGY.COM

- NOTES:**
- ① REFER TO SHEET E-001 FOR ELECTRICAL NOTES, SYMBOLS AND ABBREVIATIONS.
 - ② REFER TO SINGLE LINE DIAGRAM FOR CONDUIT AND WIRE REQUIREMENTS.
 - ③ CONTRACTOR TO FURNISH AND INSTALL ANTENNA MAST, SCADA PANEL, ANTENNA, AND ANTENNA CABLE. CONTRACTOR TO PROVIDE THE INTERCONNECTION BETWEEN THE PCP AND THE SCADA PANEL, INCLUDING TERMINATION OF THE ANTENNA.
 - ④ CONTRACTOR TO FURNISH AND INSTALL CONDUITS WITH CABLING FROM THE SCADA PANEL TO THE PCP.
 - ⑤ 1" WITH CABLING TO SCADA PANEL.
 - ⑥ 2" WITH CABLING TO SCADA PANEL.
 - ⑦ TO 240V-3 ϕ SERVICE POINT.
 - ⑧ BOND EQUIPMENT RACK TO GROUND GRID.

PS 3301 ELECTRICAL PLAN

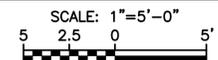

REV	DATE	DESCRIPTION	BY
C	05/2019	ISSUED FOR BID	RRM
B	10/2018	90% DRAWINGS	RRM
A	08/2018	60% DRAWINGS	RRM

Issue Certification	
Designed	LMR
Drawn	RRM
Checked	WCN
Reviewed	LMR
Approved	MDP
William C. Nelson, P.E. Florida P.E. No. 42017	

ORANGE COUNTY R-R PACKAGE 22 PUMP STATIONS ELECTRICAL
PUMP STATION 3301 - PEPPER MILL 4 ELECTRICAL PLAN


PROJECT NO.: 110034	
SCALE: NOTED	REVISION: C
DRAWING NO. E302	SHEET NO.: 38 OF 47



Parent Sheet Set: 1100340C_PKG22PS Rev/Plot by: VIOLET VANATTA Rev on: 5/24/2019 8:45 AM Individual File Path: R:\PROJECTS\110034 - ORANGE COUNTY R-R PACKAGE 22 PUMP STATIONS\DESIGN\DRAWINGS\FINAL\DESIGN\E-400 PS 3390_SLD.DWG

OCU ADDRESS:
PUMP STATION #3390
11809 OTTAWA AVE.

DUKE ADDRESS:
PUMP STATION #3390
11806 OTTAWA AVE.
DUKE ENERGY CONTACT:
BRAD VAN GILDER
BRADLEY.VANGILDER@DUKE-ENERGY.COM

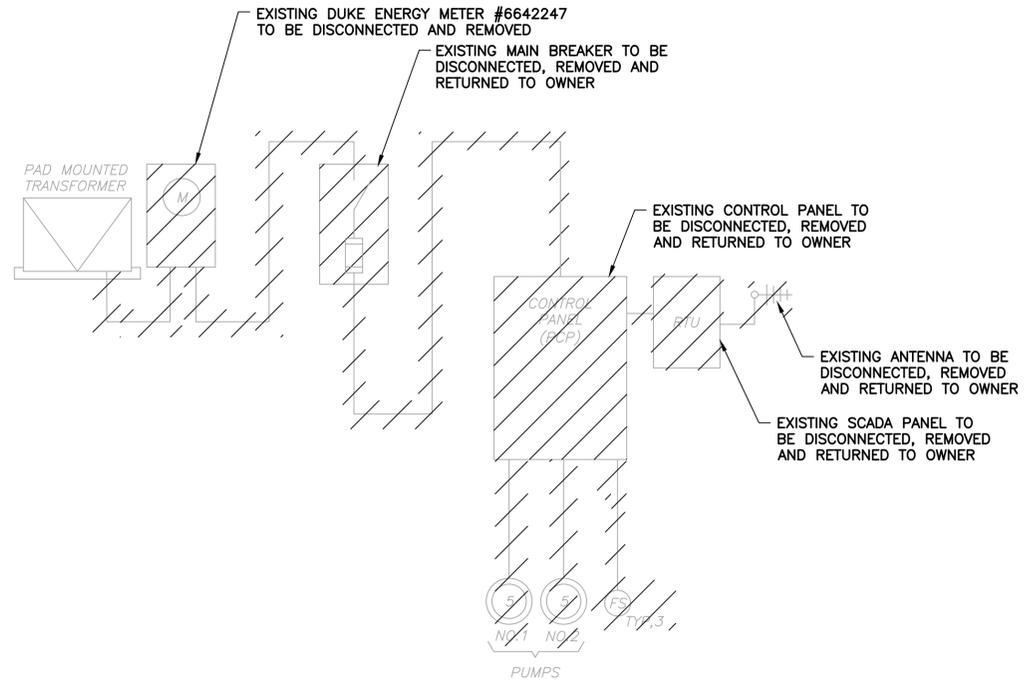


**PS NO. 3390 DEMOLITION
SINGLE LINE DIAGRAM**
SCALE: N.T.S.

LOAD TABULATION — PS 3390
SERVICE VOLTAGE: 240V-3φ

DESCRIPTION	LOAD	AMPACITY
PUMPS	2 @ 5.0 HP EACH	= 30.40 AMPS
MISCELLANEOUS LOADS		= 5.00 AMPS
CONNECTED LOAD		= 35.40 AMPS
①② SERVICE ENTRANCE = 35.40 AMPS + (.25)(15.2) =		39.20 AMPS

NOTES:

- SERVICE ENTRANCE MINIMUM SIZE AS PER ARTICLE 230 OF THE NATIONAL ELECTRICAL CODE.
- SERVICE ENTRANCE MINIMUM SIZE FOR ORANGE COUNTY IS 100 AMPS.

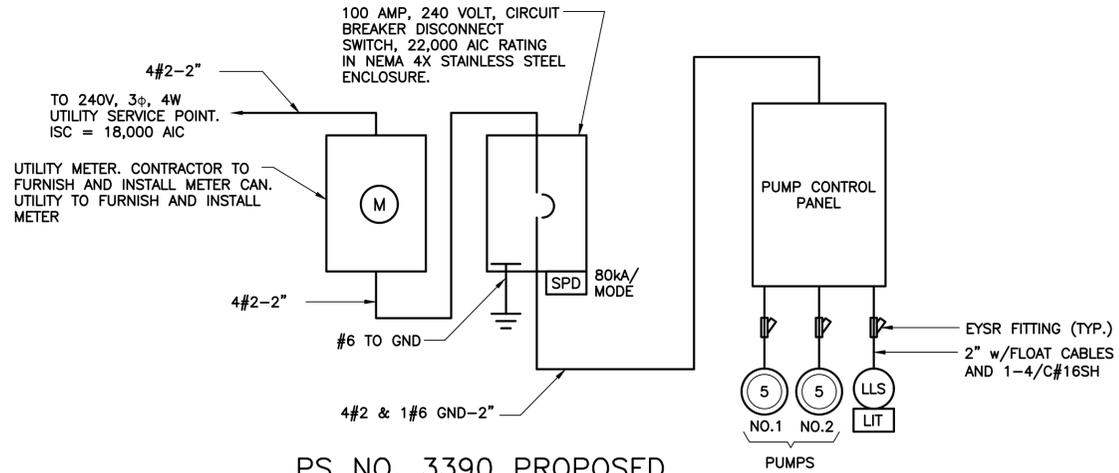

**PS NO. 3390 PROPOSED
SINGLE LINE DIAGRAM**
SCALE: N.T.S.

EDA
Electrical Design Associates
6965 PLAZA GRANDE AVE., STE. 412
ORLANDO, FLORIDA 32835
PHONE: (407) 745-5604
FAX: (407) 745-5603
C.O.A. No. 8079



REV	DATE	DESCRIPTION	BY
C	05/2019	ISSUED FOR BID	RRM
B	10/2018	90% DRAWINGS	RRM
A	08/2018	60% DRAWINGS	RRM

Issue Certification

William C. Nelson, P.E.
Florida P.E. No. 42017

Designed LMR
Drawn RRM
Checked WCN
Reviewed LMR
Approved MDP

LINE IS 1" AT FULL SIZE

ORANGE COUNTY
R-R PACKAGE 22 PUMP STATIONS
ELECTRICAL

PUMP STATION 3390 — WHISPER LAKES 8 SINGLE LINE DIAGRAM

PROJECT NO.: 110034


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REVISION: C

DRAWING NO. E400
SHEET NO.: 39 OF 47

RE


REISS ENGINEERING, INC.
1016 SPRING VILLAS PT.
WINTER SPRINGS, FL 32708
(407) 679-5358

Parent Sheet Set: 1100340C_PK22PS Rev/Plot by: VOLET VANATTA Rev on: 5/24/2019 8:45 AM Individual File Path: R:\PROJECTS\110034 - ORANGE COUNTY R-R PACKAGE 22 PUMP STATIONS\DESIGN\DRAWINGS\FINAL\DESIGN\E-401 PS_3390 DEMO.DWG

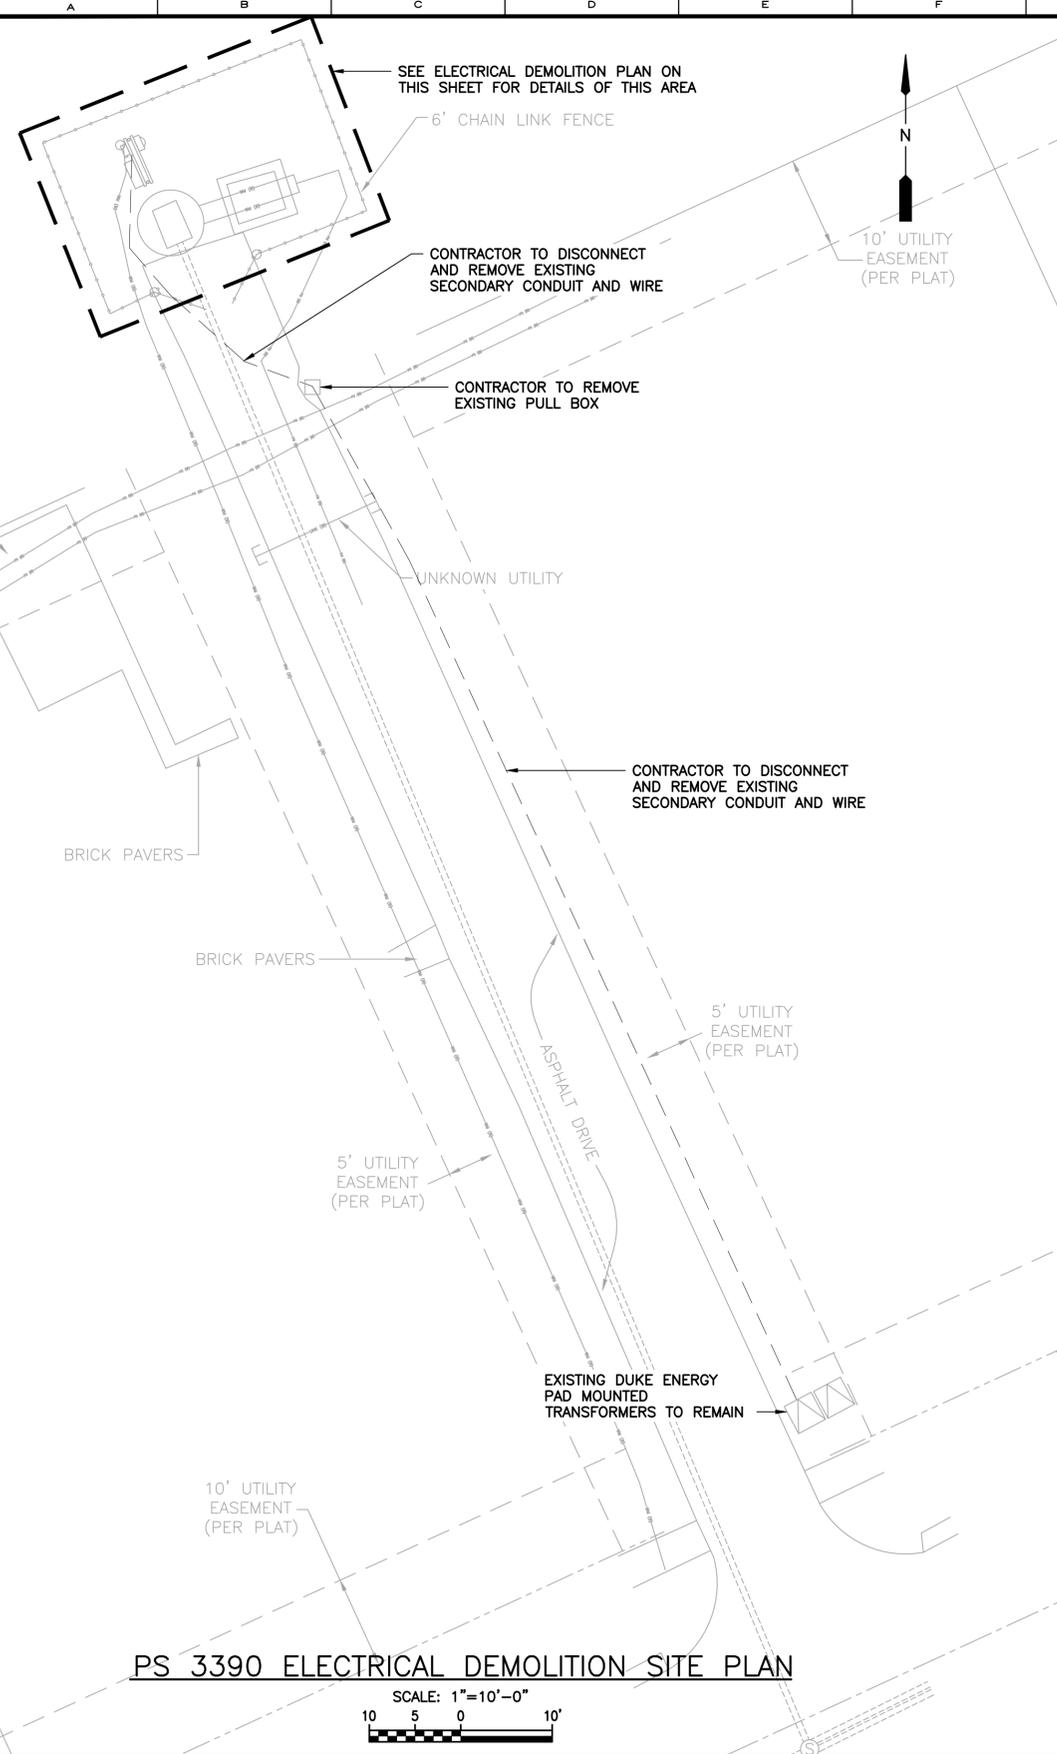

PS 3390 ELECTRICAL DEMOLITION SITE PLAN

SCALE: 1"=10'-0"
 10 5 0 10'

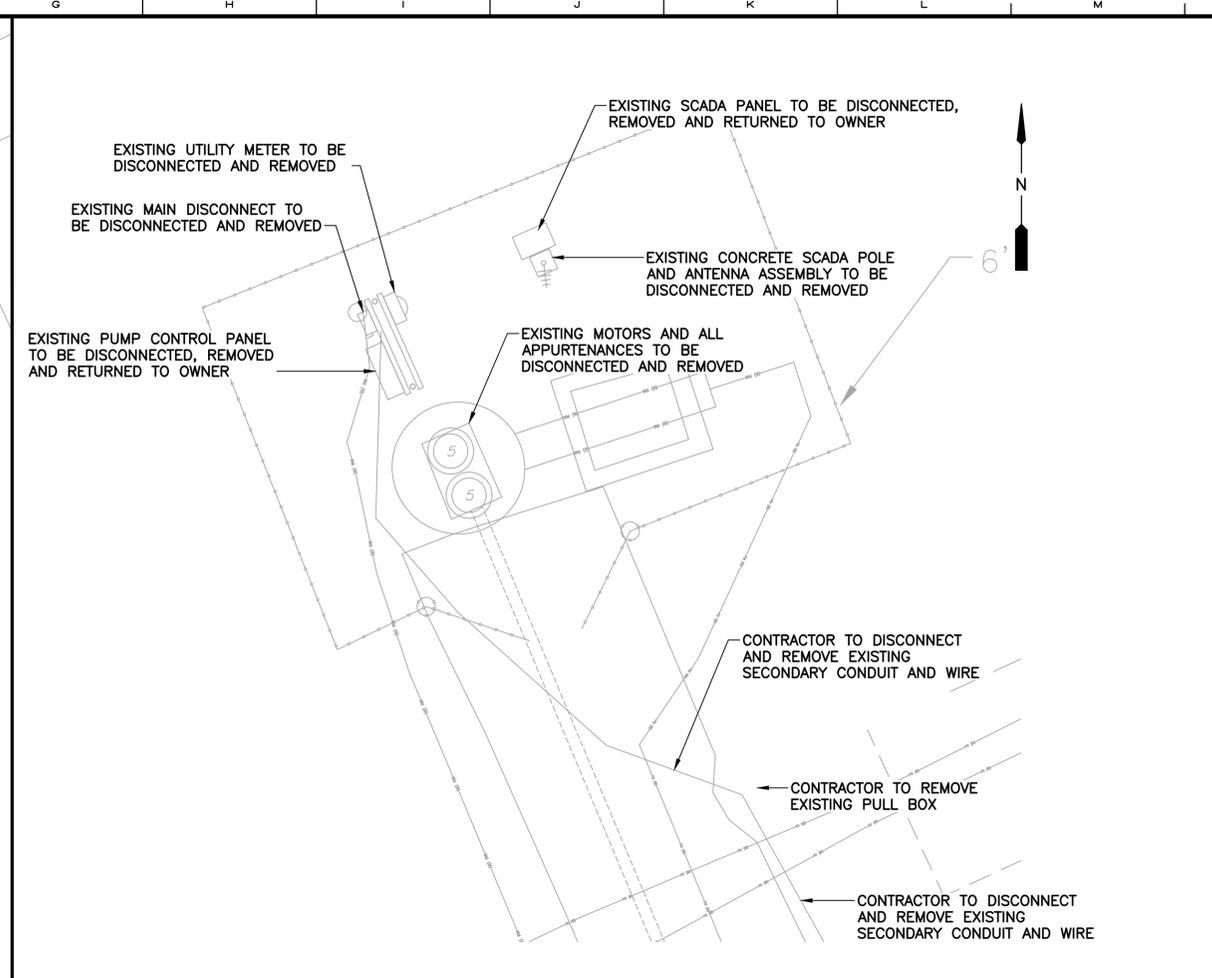


PS 3390 ELECTRICAL DEMOLITION PLAN

SCALE: 1"=5'-0"
 5 2.5 0 5'



PS 3390 FIGURE NO. 1

SCALE: N.T.S.

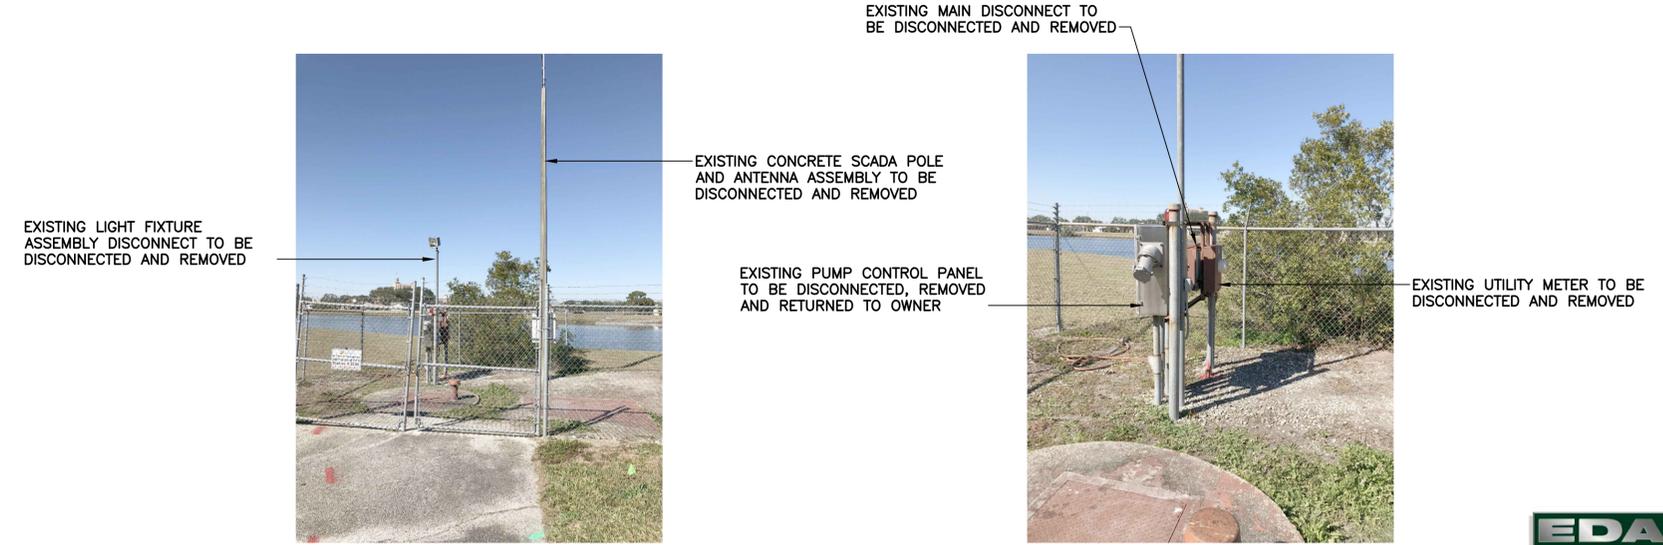

PS 3390 FIGURE NO. 2

SCALE: N.T.S.

PS 3390 FIGURE NO. 3

SCALE: N.T.S.



REV	DATE	DESCRIPTION	BY
C	05/2019	ISSUED FOR BID	RRM
B	10/2018	90% DRAWINGS	RRM
A	08/2018	60% DRAWINGS	RRM

Issue Certification	
BY	DATE
William C. Nelson, P.E. Florida P.E. No. 42017	

Designed	LMR
Drawn	RRM
Checked	WCN
Reviewed	LMR
Approved	MDP


ORANGE COUNTY
 R-R PACKAGE 22 PUMP STATIONS
 ELECTRICAL
 PUMP STATION 3390 - WHISPER LAKES 8
 ELECTRICAL DEMOLITION PLANS

PROJECT NO.: 110034	
SCALE: NOTED	REVISION: C
DRAWING NO. E401	SHEET NO.: 40 OF 47


EDA
 Electrical Design Associates
 6965 PIAZZA GRANDE AVE., STE. 412
 ORLANDO, FLORIDA 32835
 PHONE: (407) 745-5604
 FAX: (407) 745-5603
 C.O.A. No. 8079

REISS ENGINEERING, INC.
 1016 SPRING VILLAS PT.
 WINTER SPRINGS, FL 32708
 (407) 679-5358


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PS 3390 ELECTRICAL SITE PLAN

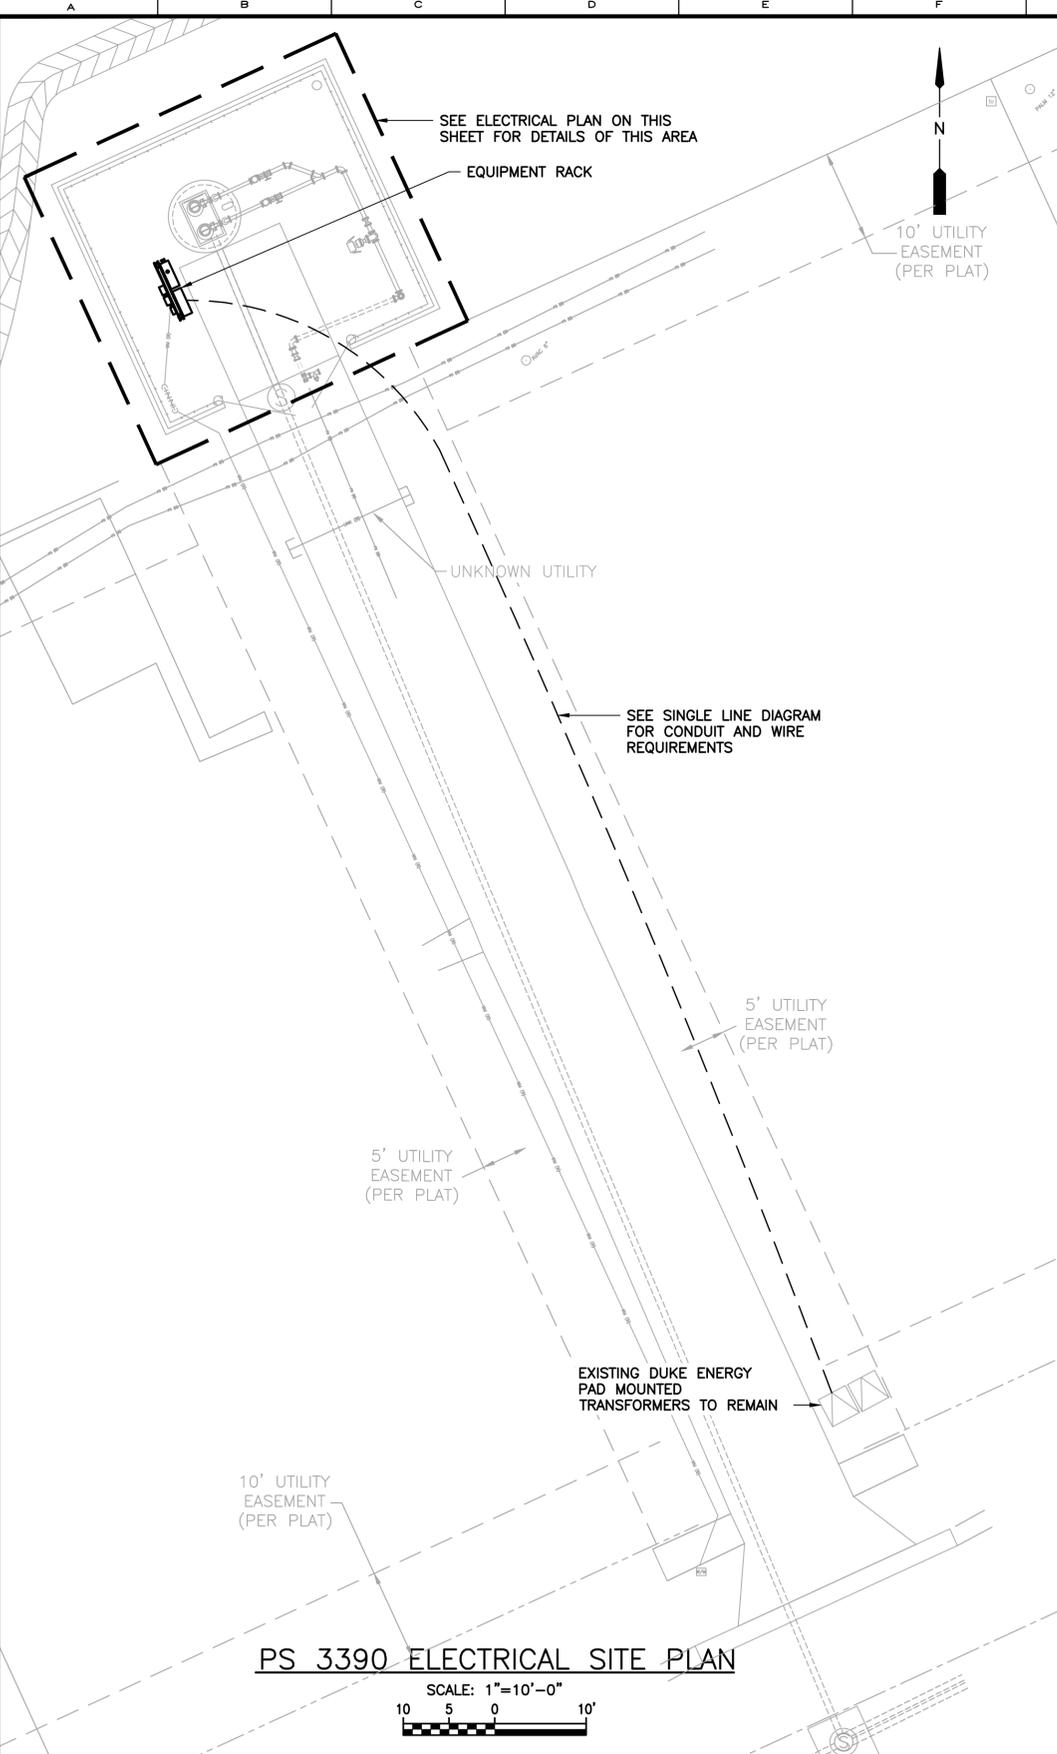

PS 3390 ELECTRICAL PLAN

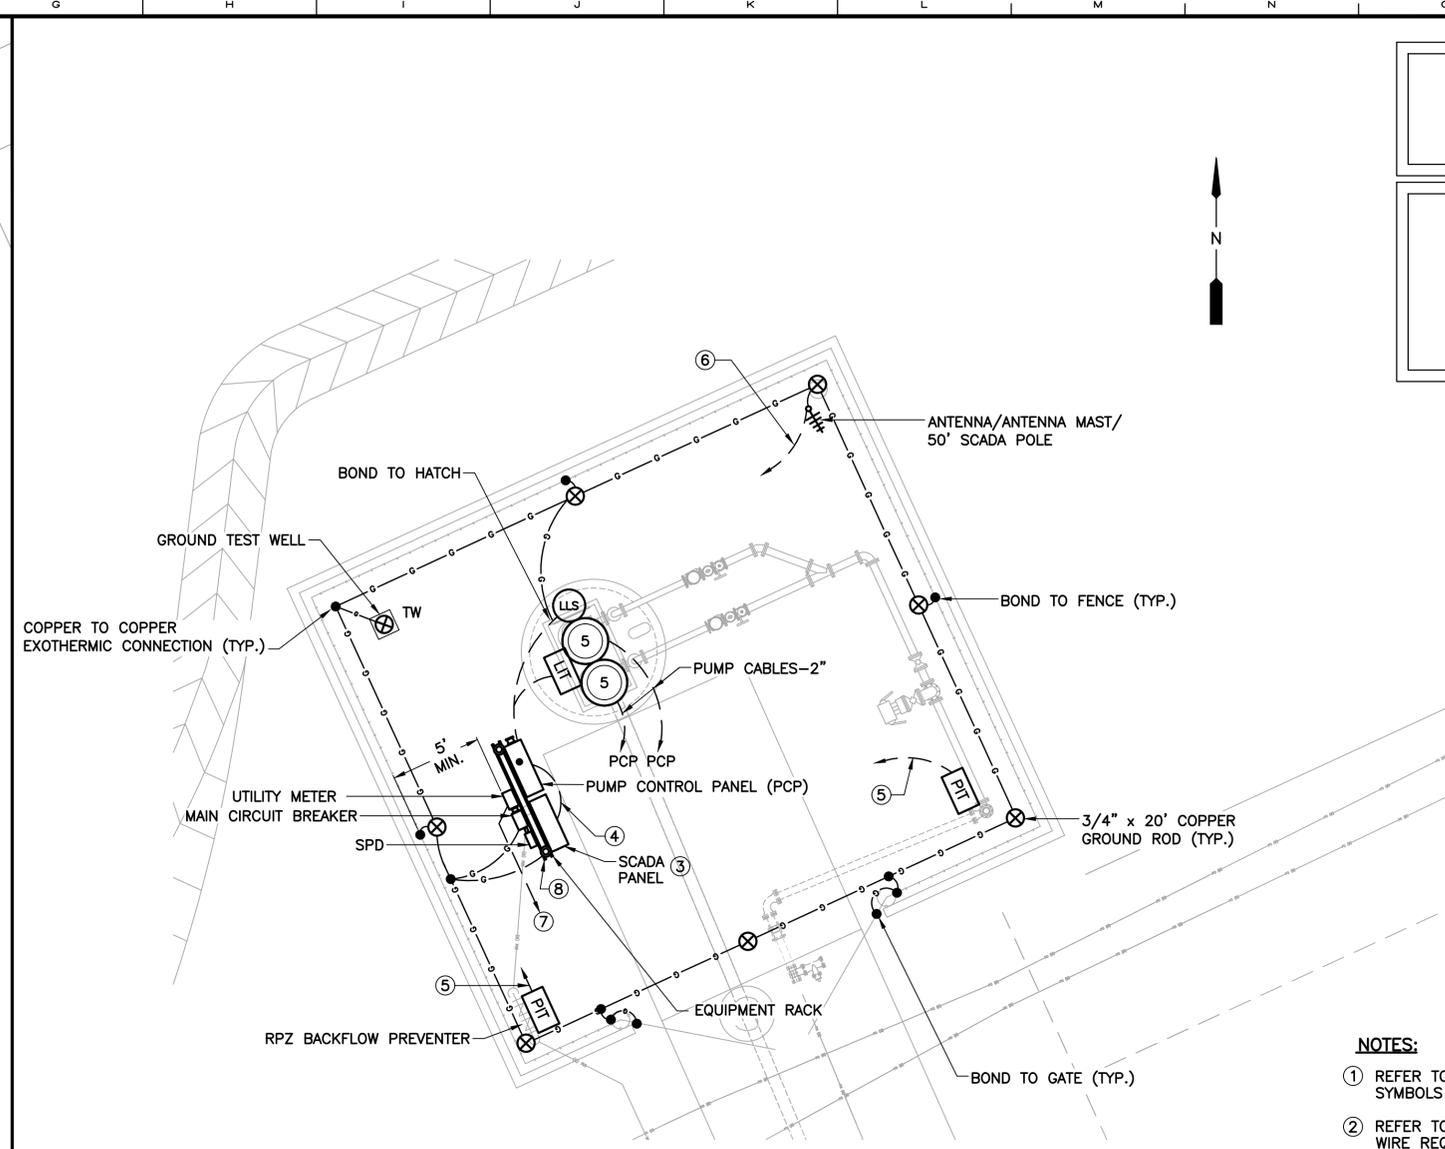

OCU ADDRESS:
 PUMP STATION #3390
 11809 OTTAWA AVENUE

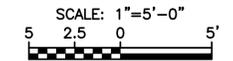DUKE ADDRESS:
 PUMP STATION #3390
 11806 OTTAWA AVE.
 DUKE ENERGY CONTACT:
 BRAD VAN GILDER
 BRADLEY.VANGILDER@DUKE-ENERGY.COM

NOTES:

- ① REFER TO SHEET E-001 FOR ELECTRICAL NOTES, SYMBOLS AND ABBREVIATIONS.
- ② REFER TO SINGLE LINE DIAGRAM FOR CONDUIT AND WIRE REQUIREMENTS.
- ③ CONTRACTOR TO FURNISH AND INSTALL ANTENNA MAST, SCADA PANEL, ANTENNA, AND ANTENNA CABLE. CONTRACTOR TO PROVIDE THE INTERCONNECTION BETWEEN THE PCP AND THE SCADA PANEL, INCLUDING TERMINATION OF THE ANTENNA.
- ④ CONTRACTOR TO FURNISH AND INSTALL CONDUITS WITH CABLING FROM THE SCADA PANEL TO THE PCP.
- ⑤ 1" WITH CABLING TO SCADA PANEL.
- ⑥ 2" WITH CABLING TO SCADA PANEL.
- ⑦ TO 240V-3 ϕ SERVICE POINT.
- ⑧ BOND EQUIPMENT RACK TO GROUND GRID.

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A	08/2018	60% DRAWINGS	RRM

Issue Certification

William C. Nelson, P.E.
 Florida P.E. No. 42017

Designed LMR
 Drawn RRM
 Checked WCN
 Reviewed LMR
 Approved MDP

LINE IS 1" AT FULL SIZE

ORANGE COUNTY
 R-R PACKAGE 22 PUMP STATIONS
 ELECTRICAL
 PUMP STATION 3390 - WHISPER LAKES 8 ELECTRICAL PLAN


PROJECT NO.: 110034
 SCALE: NOTED
 REVISION: C
 DRAWING NO. E402
 SHEET NO.: 41 OF 47

RE
 REISS ENGINEERING, INC.
 1016 SPRING VILLAS PT.
 WINTER SPRINGS, FL 32708
 (407) 679-5358

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OCU ADDRESS:
 PUMP STATION #3325
 850 CALIFORNIA WOODS CR.


DUKE ADDRESS:
 PUMP STATION #3325
 852 CALIFORNIA WOODS CR.
 DUKE ENERGY CONTACT:
 ALEX ARENAS
 ALEX.ARENAS@DUKE-ENERGY.COM

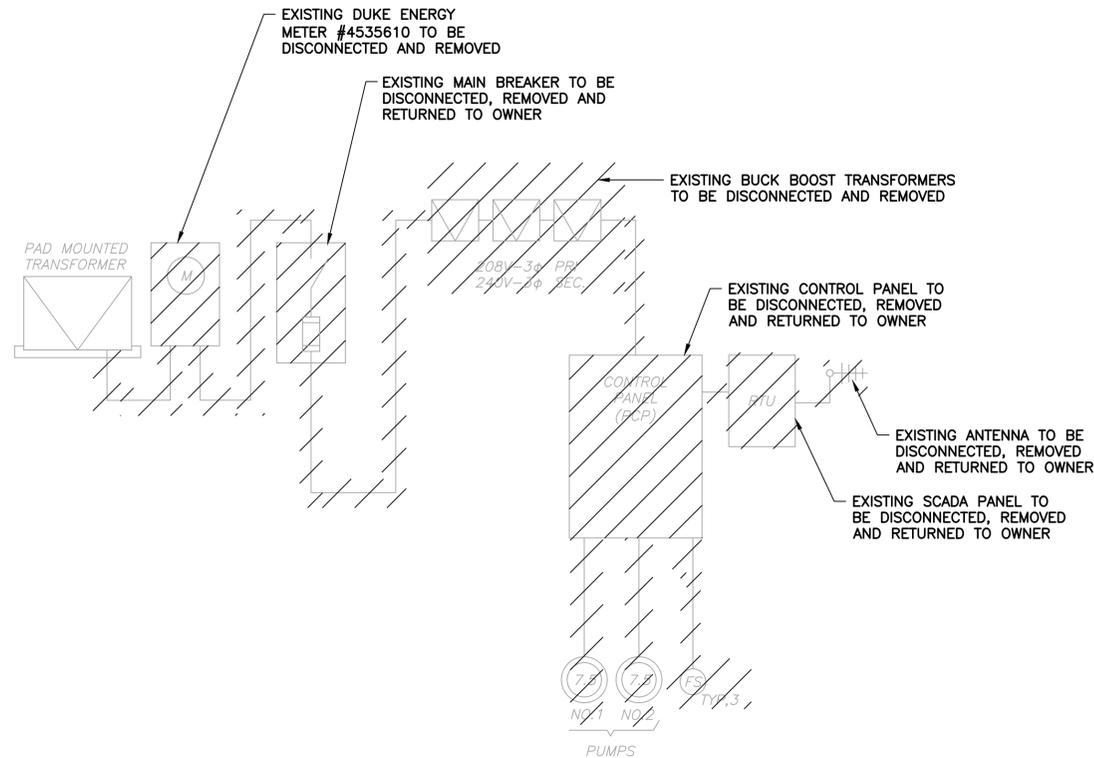

**PS NO. 3325 DEMOLITION
 SINGLE LINE DIAGRAM**

SCALE: N.T.S.

LOAD TABULATION - PS 3325		
SERVICE VOLTAGE: 120/240V-3φ		
DESCRIPTION	LOAD	AMPACITY
PUMPS	2 @14.1HP EACH	= 84.00 AMPS
MISCELLANEOUS LOADS		= 5.00 AMPS
CONNECTED LOAD		= 89.00 AMPS
①② SERVICE ENTRANCE = 89.00 AMPS+(.25)(42.00) = 99.50 AMPS		
NOTES:		
① SERVICE ENTRANCE MINIMUM SIZE AS PER ARTICLE 230 OF THE NATIONAL ELECTRICAL CODE.		
② SERVICE ENTRANCE MINIMUM SIZE FOR ORANGE COUNTY IS 100 AMPS.		

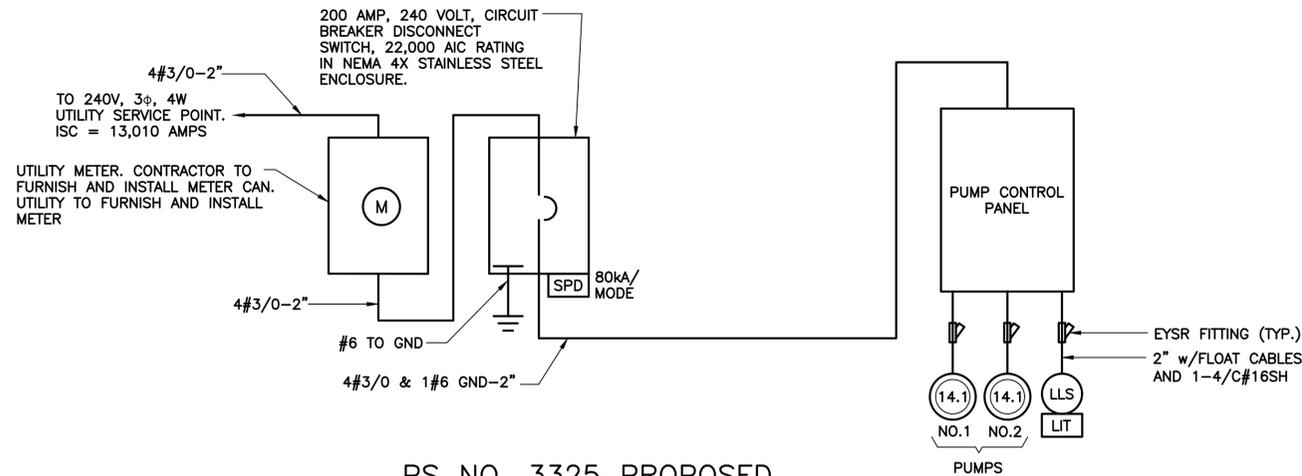

**PS NO. 3325 PROPOSED
 SINGLE LINE DIAGRAM**

SCALE: N.T.S.



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 C.O.A. No. 8079



REV	DATE	DESCRIPTION	BY
C	05/2019	ISSUED FOR BID	RRM
B	10/2018	90% DRAWINGS	RRM
A	08/2018	60% DRAWINGS	RRM

Issue Certification	
Designed	LMR
Drawn	RRM
Checked	WCN
Reviewed	LMR
Approved	MDP
William C. Nelson, P.E. Florida P.E. No. 42017	



ORANGE COUNTY R-R PACKAGE 22 PUMP STATIONS ELECTRICAL
PUMP STATION 3325 - MEADOW WOODS 1 SINGLE LINE DIAGRAM

PROJECT NO.: 110034
SCALE: NOTED
REVISION: C
DRAWING NO. E500
SHEET NO.: 42 OF 47



REISS ENGINEERING, INC.
 1016 SPRING VILLAS PT.
 WINTER SPRINGS, FL 32708
 (407) 679-5358

Parent Sheet Set: 1100340C_PKG22PS Rev/Plot by: VIOLET VANATTA Rev on: 5/24/2019 8:45 AM Individual File Path: R:\PROJECTS\110034 - ORANGE COUNTY R-R PACKAGE 22 PUMP STATIONS\DESIGN\DRAWINGS\FINAL\DESIGN\E-501 PS 3325 DEMO.DWG

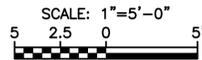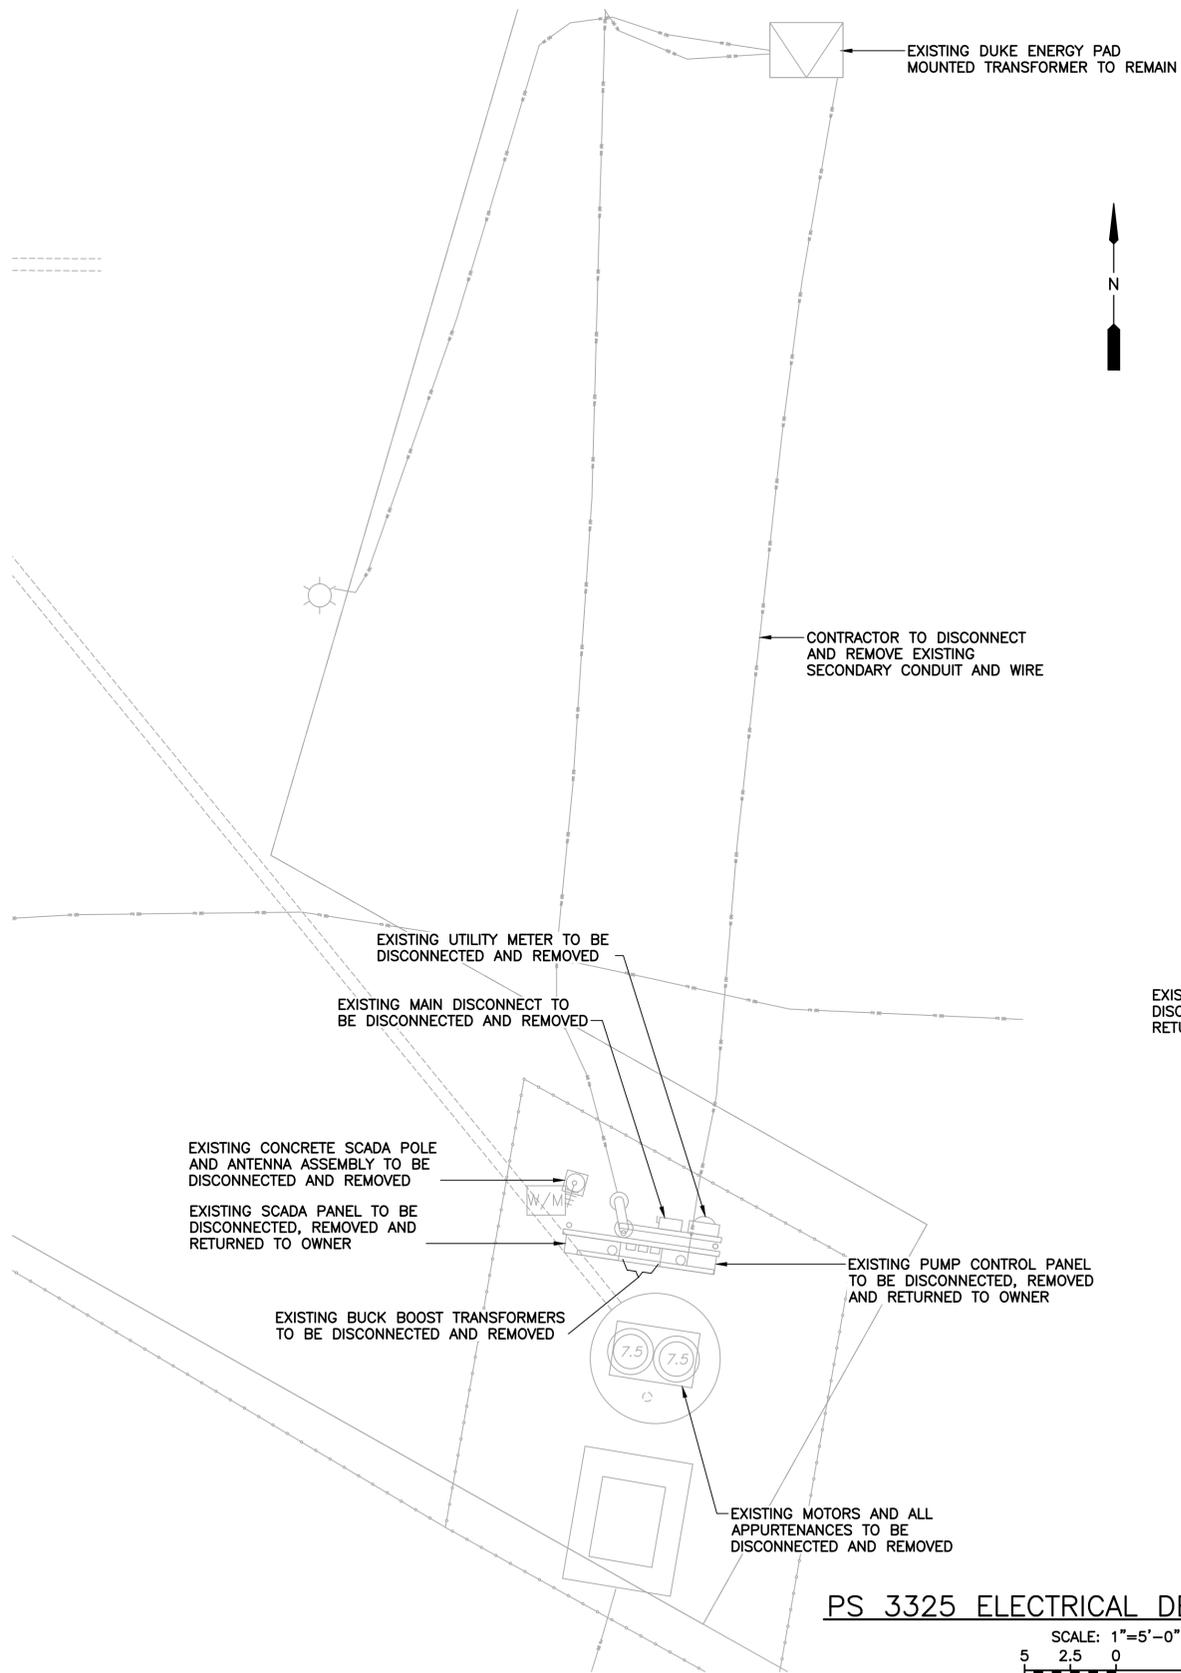

PS 3325 ELECTRICAL DEMOLITION PLAN



EXISTING PAD MOUNTED TRANSFORMER TO REMAIN

PS 3325 FIGURE NO. 1
SCALE: N.T.S.



EXISTING SCADA PANEL TO BE DISCONNECTED, REMOVED AND RETURNED TO OWNER

EXISTING BUCK BOOST TRANSFORMERS TO BE DISCONNECTED AND REMOVED

EXISTING PUMP CONTROL PANEL TO BE DISCONNECTED, REMOVED AND RETURNED TO OWNER

PS 3325 FIGURE NO. 2
SCALE: N.T.S.



EXISTING PUMP CONTROL PANEL TO BE DISCONNECTED, REMOVED AND RETURNED TO OWNER

PS 3325 FIGURE NO. 3
SCALE: N.T.S.

OCU ADDRESS:
 PUMP STATION #3325
 850 CALIFORNIA WOODS CR.
 DUKE ADDRESS:
 PUMP STATION #3325
 852 CALIFORNIA WOODS CR.
 DUKE ENERGY CONTACT:
 ALEX ARENAS
 ALEX.ARENAS@DUKE-ENERGY.COM

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 ORLANDO, FLORIDA 32835
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B	10/2018	90% DRAWINGS	RRM
A	08/2018	60% DRAWINGS	RRM

Issue Certification
 William C. Nelson, P.E.
 Florida P.E. No. 42017


Designed LMR
 Drawn RRM
 Checked WCN
 Reviewed LMR
 Approved MDP
 LINE IS 1" AT FULL SIZE

ORANGE COUNTY
 R-R PACKAGE 22 PUMP STATIONS
 ELECTRICAL
 PUMP STATION 3325 - MEADOW WOODS 1
 ELECTRICAL DEMOLITION PLAN

PROJECT NO.: 110034
 SCALE: NOTED
 DRAWING NO. E501
 REVISION: C
 SHEET NO.: 43 OF 47

RE
 REISS ENGINEERING, INC.
 1016 SPRING VILLAS PT.
 WINTER SPRINGS, FL 32708
 (407) 679-5358


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OCU ADDRESS:
 PUMP STATION #3325
 850 CALIFORNIA WOODS CR.

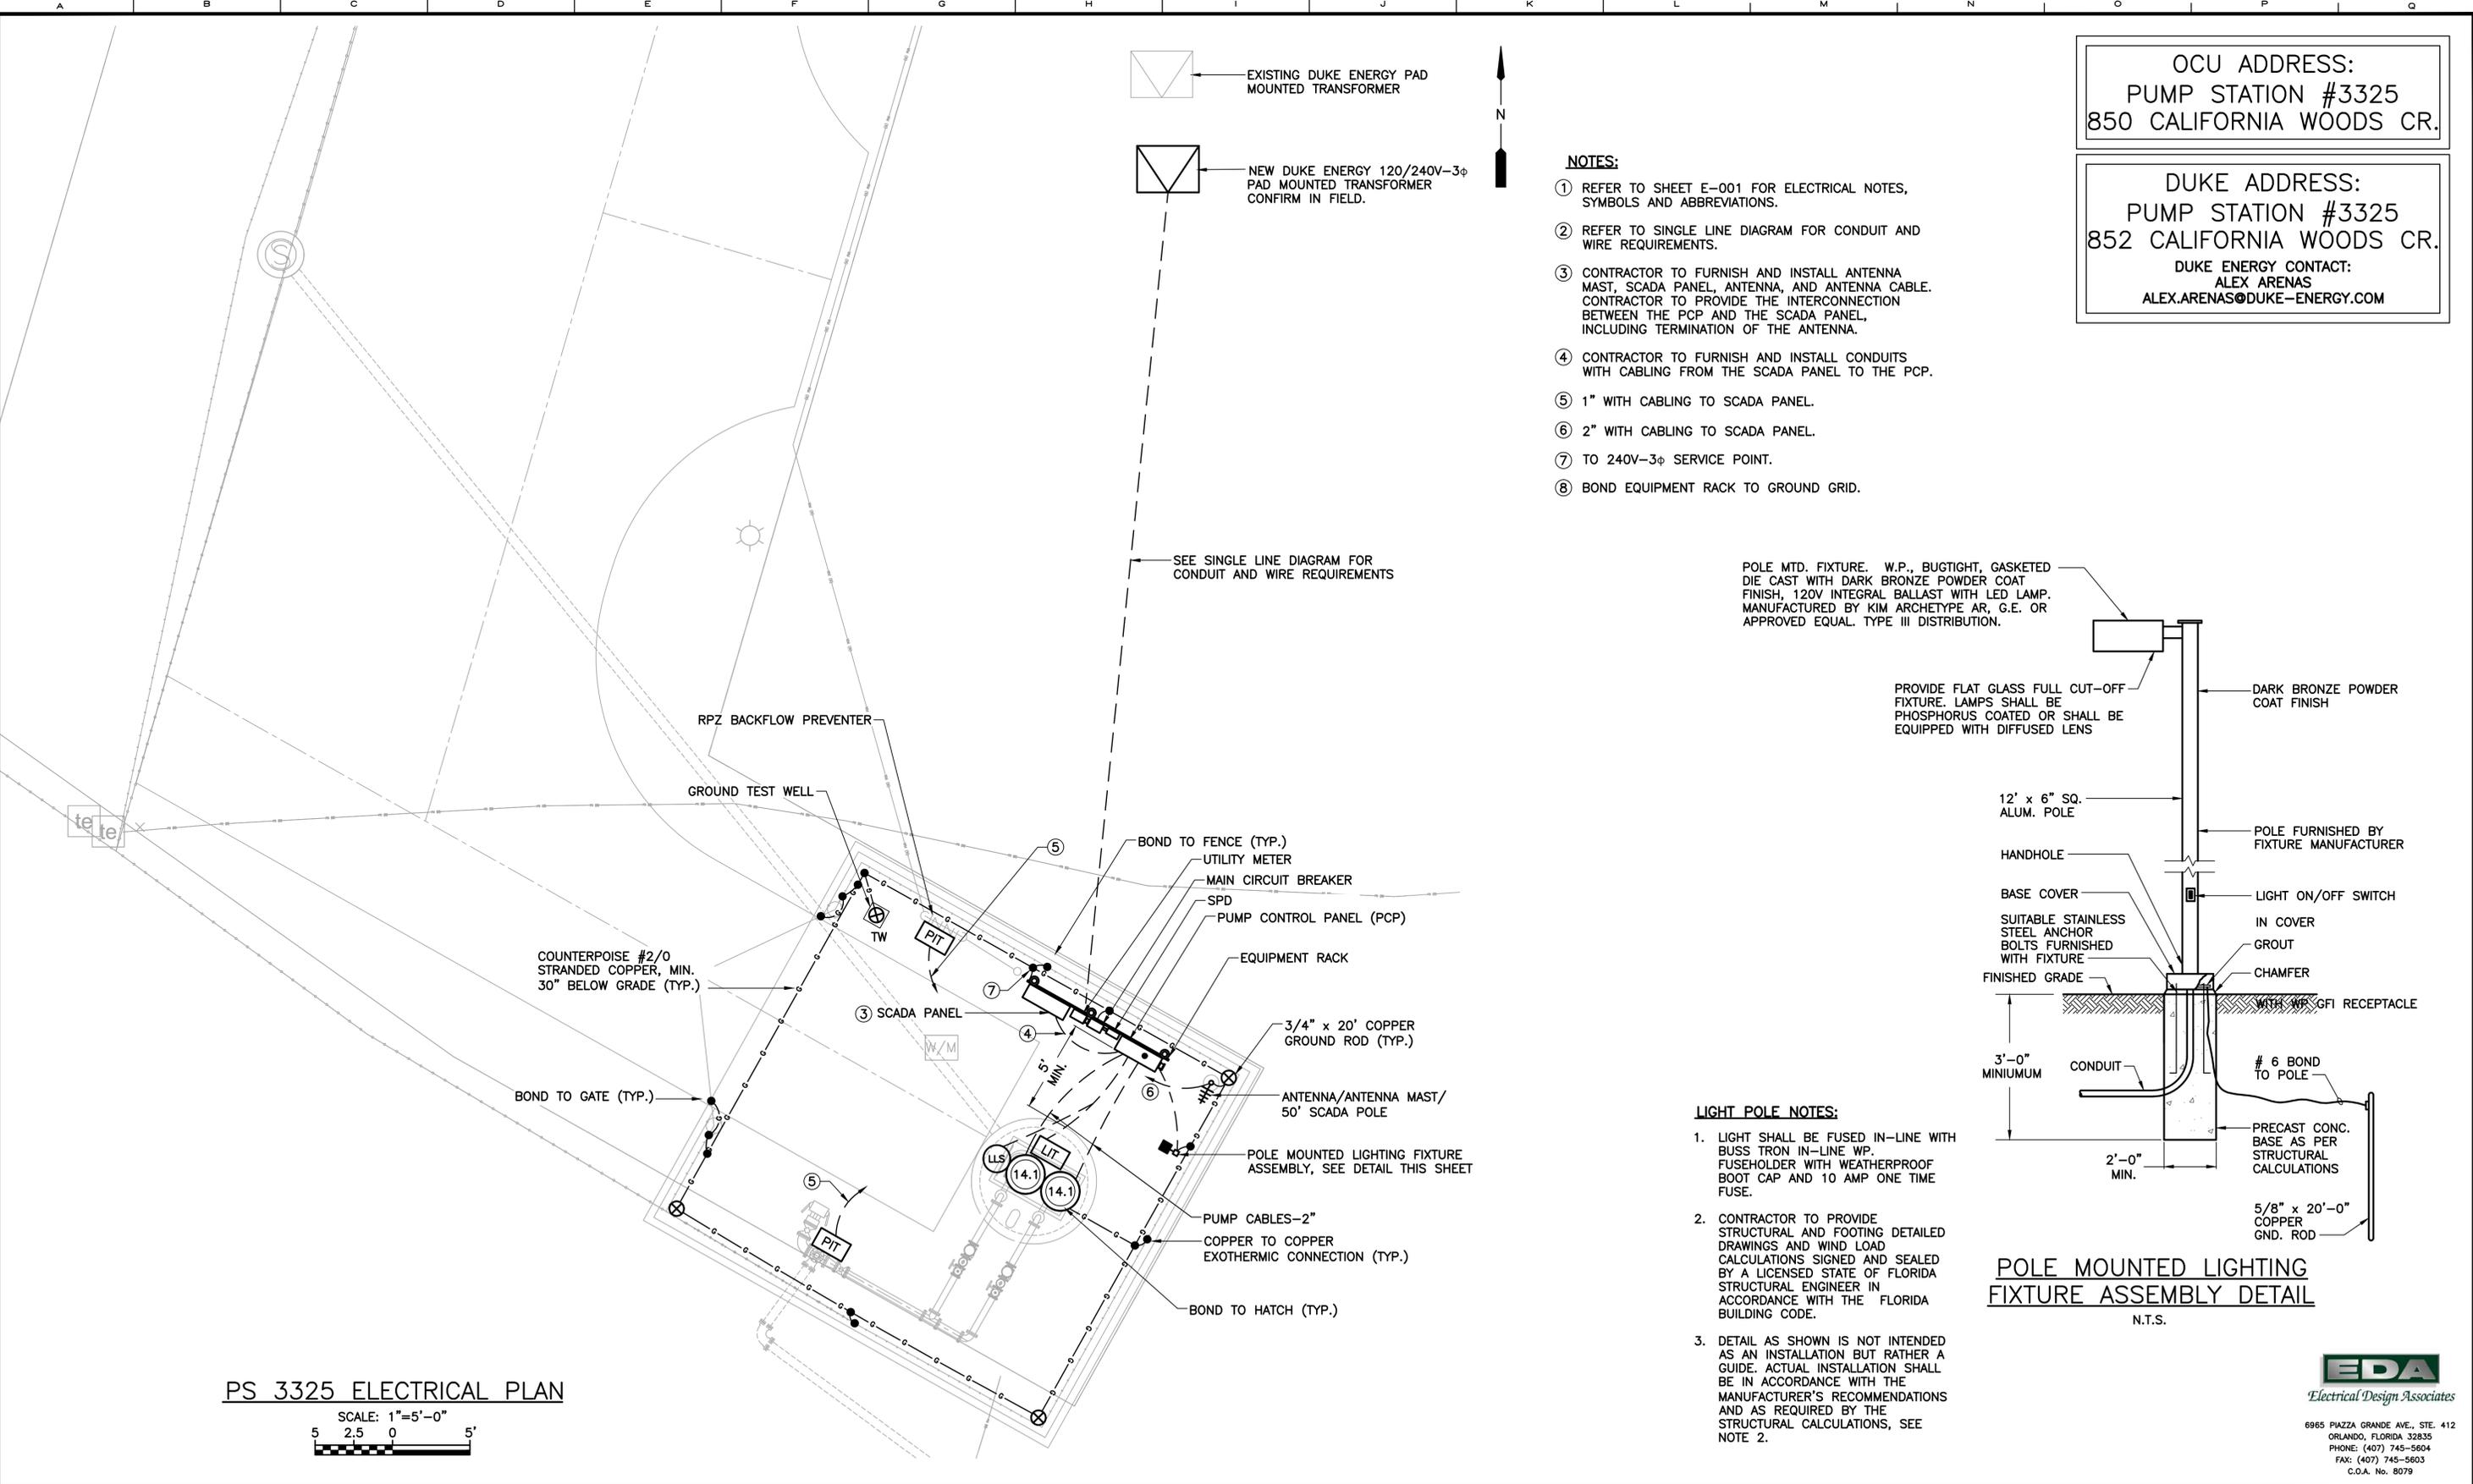
DUKE ADDRESS:
 PUMP STATION #3325
 852 CALIFORNIA WOODS CR.
 DUKE ENERGY CONTACT:
 ALEX ARENAS
 ALEX.ARENAS@DUKE-ENERGY.COM

- NOTES:**
- REFER TO SHEET E-001 FOR ELECTRICAL NOTES, SYMBOLS AND ABBREVIATIONS.
 - REFER TO SINGLE LINE DIAGRAM FOR CONDUIT AND WIRE REQUIREMENTS.
 - CONTRACTOR TO FURNISH AND INSTALL ANTENNA MAST, SCADA PANEL, ANTENNA, AND ANTENNA CABLE. CONTRACTOR TO PROVIDE THE INTERCONNECTION BETWEEN THE PCP AND THE SCADA PANEL, INCLUDING TERMINATION OF THE ANTENNA.
 - CONTRACTOR TO FURNISH AND INSTALL CONDUITS WITH CABLING FROM THE SCADA PANEL TO THE PCP.
 - 1" WITH CABLING TO SCADA PANEL.
 - 2" WITH CABLING TO SCADA PANEL.
 - TO 240V-3 ϕ SERVICE POINT.
 - BOND EQUIPMENT RACK TO GROUND GRID.



- LIGHT POLE NOTES:**
- LIGHT SHALL BE FUSED IN-LINE WITH BUSS TRON IN-LINE WP. FUSEHOLDER WITH WEATHERPROOF BOOT CAP AND 10 AMP ONE TIME FUSE.
 - CONTRACTOR TO PROVIDE STRUCTURAL AND FOOTING DETAILED DRAWINGS AND WIND LOAD CALCULATIONS SIGNED AND SEALED BY A LICENSED STATE OF FLORIDA STRUCTURAL ENGINEER IN ACCORDANCE WITH THE FLORIDA BUILDING CODE.
 - DETAIL AS SHOWN IS NOT INTENDED AS AN INSTALLATION BUT RATHER A GUIDE. ACTUAL INSTALLATION SHALL BE IN ACCORDANCE WITH THE MANUFACTURER'S RECOMMENDATIONS AND AS REQUIRED BY THE STRUCTURAL CALCULATIONS, SEE NOTE 2.

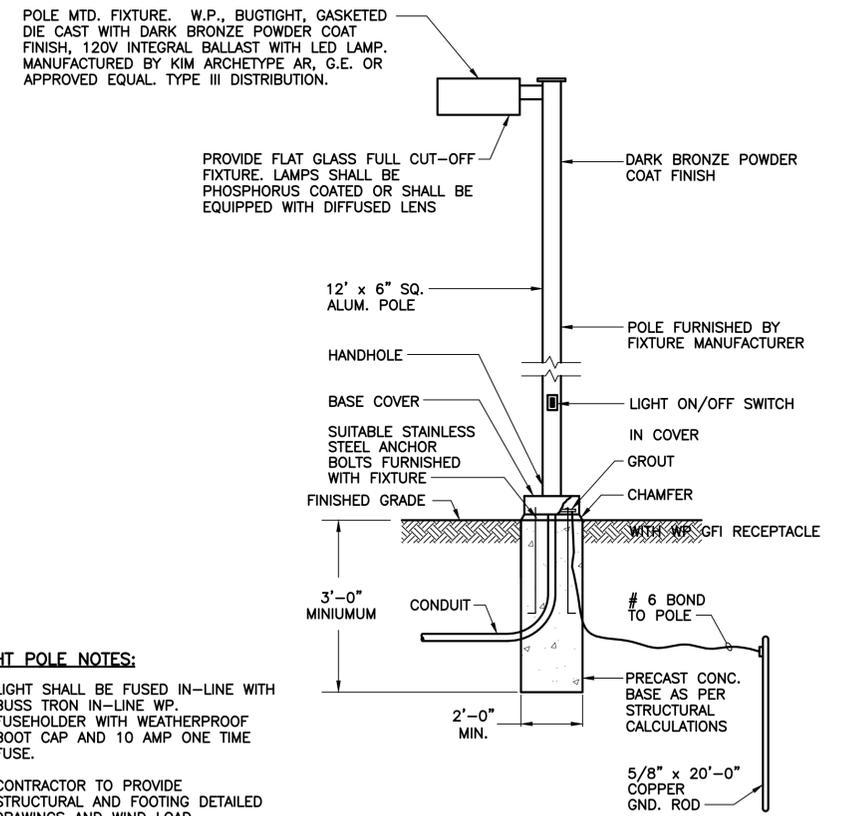PS 3325 ELECTRICAL PLAN

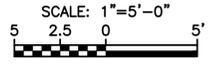

REV	DATE	DESCRIPTION	BY
C	05/2019	ISSUED FOR BID	RRM
B	10/2018	90% DRAWINGS	RRM
A	08/2018	60% DRAWINGS	RRM

Issue Certification	
Designed	LMR
Drawn	RRM
Checked	WCN
Reviewed	LMR
Approved	MDP

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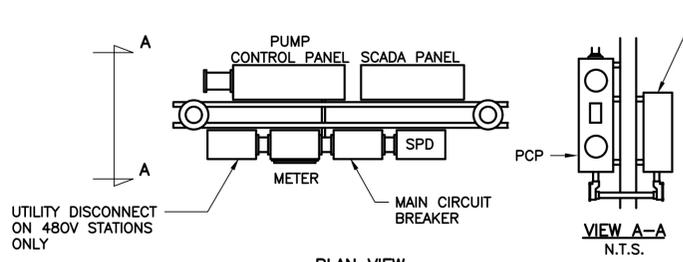
ORANGE COUNTY
 R-R PACKAGE 22 PUMP STATIONS
 ELECTRICAL
 PUMP STATION 3325 - MEADOW WOODS 1 ELECTRICAL PLAN

PROJECT NO.:	110034
SCALE:	NOTED
REVISION:	C
DRAWING NO.:	E502
SHEET NO.:	44 OF 47

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RE
 REISS ENGINEERING, INC.
 1016 SPRING VILLAS PT.
 WINTER SPRINGS, FL 32708
 (407) 679-5358



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PANEL & SEAL-OFF MOUNTING HEIGHTS


DIST "Y"	DIST "X"	PANEL HEIGHT
18"	36"	36"
15"	30"	42"
12"	24"	48"
12"	24"	60"

FOR PANELS NOT LISTED ADJUST MOUNTING HEIGHTS ACCORDINGLY




- ON COVERS WITH MULTIPLE DOORS, PROVIDE BRAID FROM FRAME TO DOOR ON EACH DOOR
- PROVIDE WATERPROOF CAULKING WHERE GROUND CABLE AND CONDUIT PENETRATES WETWELL TO PREVENT INTRUSION OF GROUND WATER AND ESCAPE OF VAPORS FROM WETWELL.
- INSTALL GROUND WIRE SO THAT IT WILL NOT CROSS CLEAR OPENING OR PREVENT OR IMPEDE NORMAL METHOD OF REMOVING FLOATS OR PUMPS.

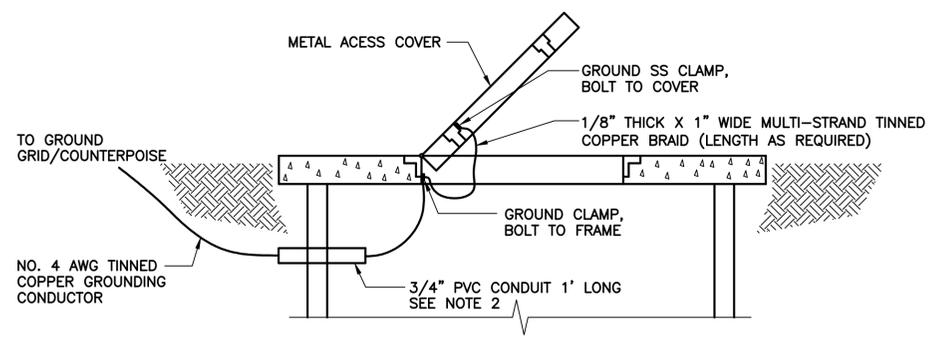
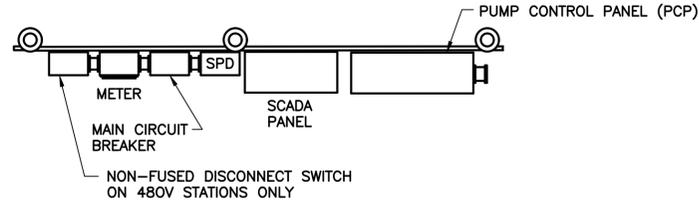
A419-2
COVER & DOOR GROUNDING DETAIL
N.T.S.

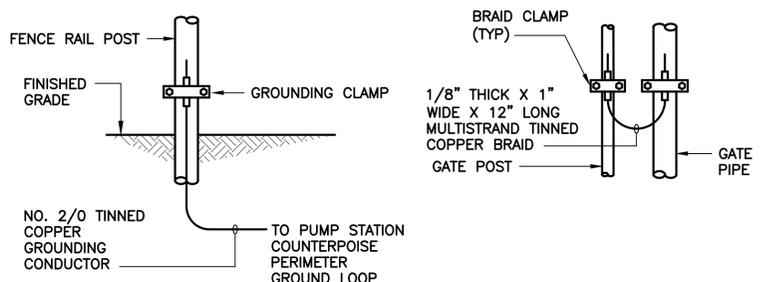


A419-4
FENCE POST GROUNDING
N.T.S.

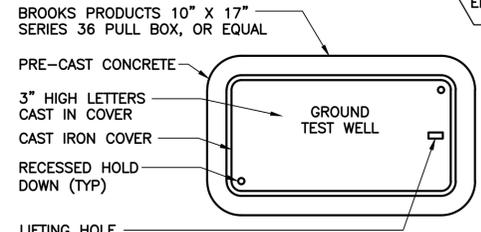

A419-3
GROUND TEST WELL
N.T.S.

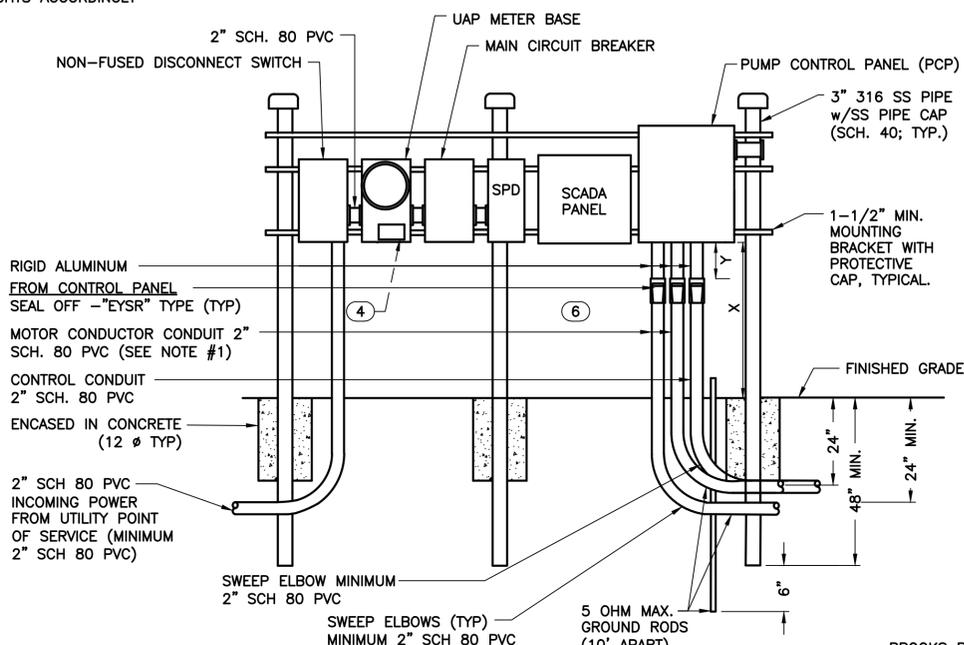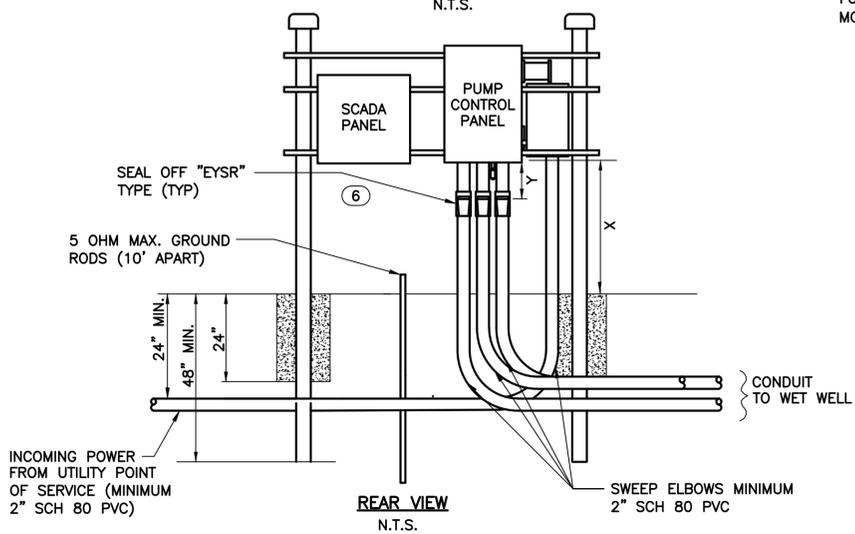

2
SIDE BY SIDE EQUIPMENT RACK
N.T.S.

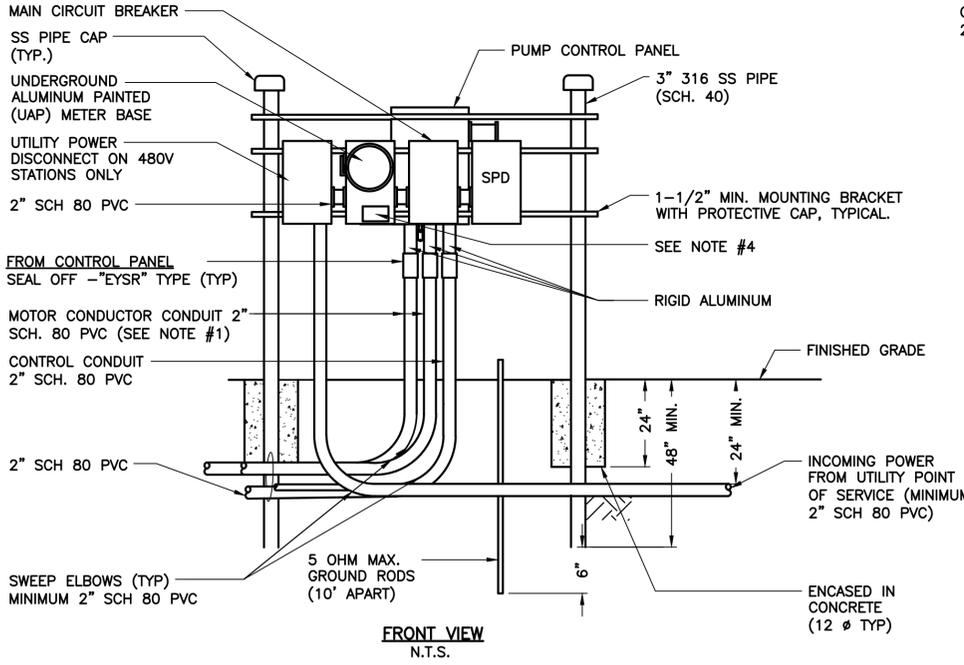

1
A413-1 & A413-2
BACK TO BACK EQUIPMENT RACK
N.T.S.

PANEL INSTALLATION NOTES:

- PUMP MOTOR CONDUIT SHALL BE SIZED TO ACCOMMODATE 40% CONDUIT FILL. MINIMUM CONDUIT SIZE TO BE 2" SCH 80 PVC.
- POWER SUPPLY SHALL BE UNDERGROUND ON THE LIFT STATION SITE AND SHALL BE 3-PHASE, FROM A 3-PHASE SOURCE ONLY.
- AN ELECTRICAL GROUNDING SYSTEM SHALL BE INSTALLED AS PER THE NATIONAL ELECTRICAL CODE, LOCAL CODES AND ORDINANCES, AN UNDERGROUND PERIMETER CABLE GROUNDING SYSTEM SHALL BE INSTALLED WITH CONNECTIONS TO AT LEAST WET WELL COVER, VALVE VAULT COVER, CONTROL PANELS, UTILITY COMPANY TRANSFORMER, MANUAL DISCONNECT SWITCH AND METAL FENCE. REFER TO GROUNDING DETAILS.
- THE STATION NAME, ORANGE COUNTY I.D. NUMBER, AND ADDRESS SHALL BE AFFIXED TO THE FRONT OF THE METER CABINET.
- ALL MOUNTING HARDWARE, BRACKETS AND ELECTRICAL ENCLOSURES SHALL BE 316 STAINLESS STEEL.
- REFER TO SCADA PANEL AND POLE DETAILS FOR CONDUIT REQUIREMENTS.

EDA
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C.O.A. No. 8079



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A	08/2018	60% DRAWINGS	RRM

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	Drawn RRM
	Checked WCN
	Reviewed LMR
	Approved MDP
William C. Nelson, P.E. Florida P.E. No. 42017	


ORANGE COUNTY R-R PACKAGE 22 PUMP STATIONS ELECTRICAL

PROJECT NO.: 110034
SCALE: NOTED
DRAWING NO.: ED100
REVISION: C
SHEET NO.: 45 OF 47

ELECTRICAL DETAILS - 1



Parent Sheet Set: 1100340C_PK622PS Rev/Plot by: VIOLET VANATTA Rev on: 5/24/2019 8:45 AM Individual File Path: R:\PROJECTS\110034 - ORANGE COUNTY R-R PACKAGE 22 PUMP STATIONS\DESIGN\DRAWINGS\FINAL\DESIGN\ED-101 DTL.S.DWG

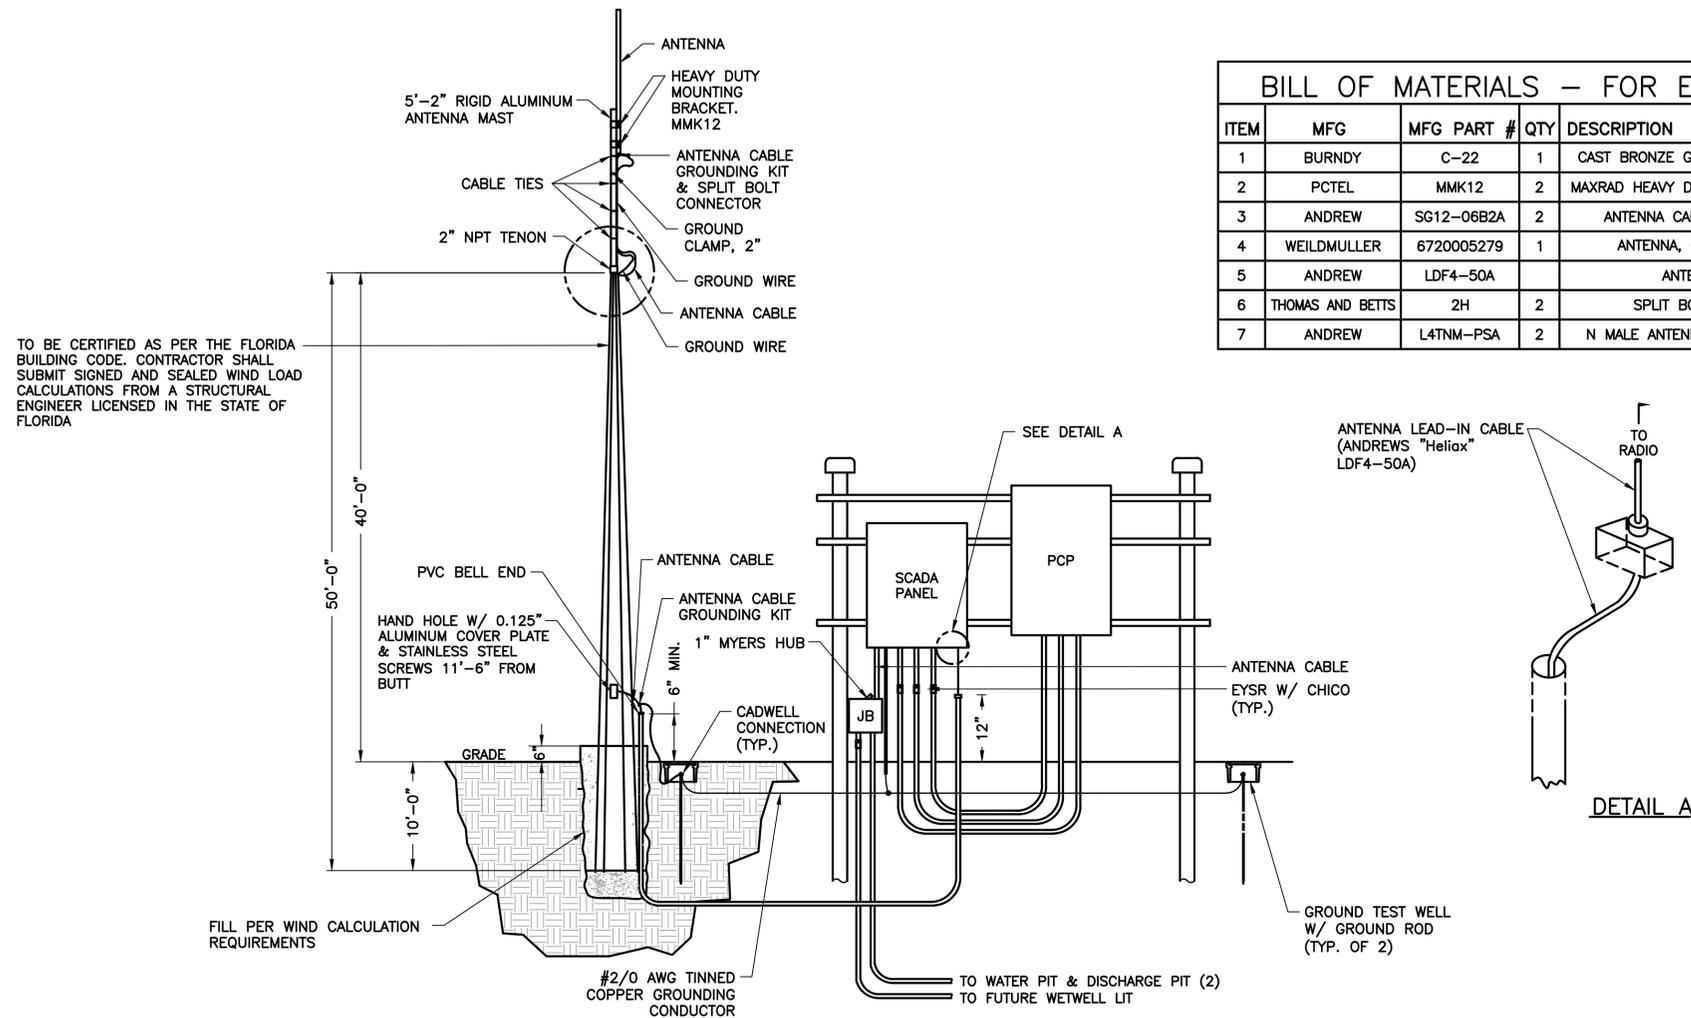

BILL OF MATERIALS - FOR EACH LOCATION						
ITEM	MFG	MFG PART #	QTY	DESCRIPTION	REMARKS	
1	BURNDY	C-22	1	CAST BRONZE GROUND CLAMP, 1 1/4"		
2	PCTEL	MMK12	2	MAXRAD HEAVY DUTY MOUNTING BRACKET		
3	ANDREW	SG12-06B2A	2	ANTENNA CABLE GROUNDING KIT		
4	WEILDMULLER	6720005279	1	ANTENNA, OMNI DIRECTIONAL		
5	ANDREW	LDF4-50A		ANTENNA CABLE	VERIFY LENGTH	
6	THOMAS AND BETTS	2H	2	SPLIT BOLT CONNECTOR		
7	ANDREW	L4TNM-PSA	2	N MALE ANTENNA CABLE CONNECTOR		

- NOTES:**
1. THE ANTENNA AND STRUCTURE SHALL BE PROVIDED BY THE INSTRUMENTATION SUPPLIER AS SPECIFIED UNDER 13300. THE CONTRACTOR SHALL BE RESPONSIBLE FOR THE INSTALLATION OF THE ANTENNA AND STRUCTURE, 2 GROUND RODS, 5/8"x 10' SHALL BE INSTALLED AROUND THE ANTENNA STRUCTURE. A #2/0 TINNED COPPER WIRE SHALL CONNECT THE GROUND RODS AND TIE INTO THE ELECTRICAL SYSTEM GROUND SYSTEM.
 2. NOT ALL CONDUITS ARE SHOWN.
 3. REFER TO EQUIPMENT RACK DETAILS FOR ADDITIONAL REQUIREMENTS.
 4. ANTENNA FURNISHED WITH SCADA PANEL.



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Issue Certification

William C. Nelson, P.E.
Florida P.E. No. 42017

Designed LMR
 Drawn RRM
 Checked WCN
 Reviewed LMR
 Approved MDP

LINE IS 1" AT FULL SIZE

ORANGE COUNTY
 R-R PACKAGE 22 PUMP STATIONS
 ELECTRICAL
 ELECTRICAL DETAILS - 2

PROJECT NO.: 110034	
SCALE: NOTED	REVISION: C
DRAWING NO. ED101	SHEET NO.: 46 OF 47

EDA
 Electrical Design Associates
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 C.O.A. No. 8079

RE
 REISS ENGINEERING, INC.
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 (407) 679-5358

Parent Sheet Set: 1100340C_PKG22PS Rev/Plot by: JAY MILLER Rev on: 4/24/2019 11:55 AM Individual File Path: R:\Projects\110034 - Orange County R-R Package 22 Pump Stations\Design\Drawings\FinalDesign\X100.dwg

VALVE ASSET TABLE																
ID Number	Utilities Asset Number	Plan Sheet #	Easting	Northing	Elevation	Valve Type	Main Type	Valve Size	Valve Manufacturer	Valve Model #	# of Turns to Close	Gear Actuator	Gear Ratio	Side Actuator	Actuator Manufacturer	Comments
PSV-011		C101				Gate	Force Main	6"								Tapping Valve
PSV-02		C201				Gate	Force Main	6"								Tapping Valve
PSV-03		C301				Gate	Force Main	6"								Tapping Valve
PSV-04		C401				Gate	Force Main	6"								Tapping Valve
PSV-05		C501				Gate	Force Main	6"								Tapping Valve

MANHOLE ASSET TABLE															
ID Number	Utilities Asset Number	Plan Sheet #	Easting	Northing	Rim Elevation	Invert Elv N	Invert Elv NE	Invert Elv E	Invert Elv SE	Invert Elv S	Invert Elv SW	Invert Elv W	Invert Elv NW	Manufacturer	Comments
PSMH-3351-01		C201													PS #3351
PSMH-3351-02		C201													PS #3351
PSMH-3351-03		C201													PS #3351
PSMH-3301-01		C301													PS#3301
PSMH-3390-01		C401													PS#3390

FITTING ASSET TABLE								
ID Number	Utilities Asset Number	Plan Sheet #	Easting	Northing	Elevation	Main Type	Fitting Type	Comments
PSF-01		C301				Force Main	Tapping Sleeve	6" Pipe Diameter
PSF-02		P500				Force Main	Bend 90°	6" Pipe Diameter
PSF-03		P500				Force Main	Reducer	6"x 8" Pipe Diameter
PSF-04		P500				Force Main	Tapping Sleeve	8" Pipe Diameter

PROPERTY CORNER/EASEMENT ASSET TABLE							
ID Number	Utilities Asset Number	Plan Sheet #	Easting	Northing	Elevation	Boundary Corner Type	Comments
PSPC-01		C101				Pump Station Tract	PS #3337 Property Corner
PSPC-02		C101				Pump Station Tract	PS #3337 Property Corner
PSPC-03		C101				Pump Station Tract	PS #3337 Property Corner
PSPC-04		C101				Pump Station Tract	PS #3337 Property Corner
PSPC-05		C101				Pump Station Tract	PS #3337 Property Corner
PSPC-06		C101				Pump Station Tract	PS #3337 Property Corner
PSPC-07		C101				Pump Station Tract	PS #3337 Property Corner
PSPC-08		C201				Property	PS #3351 Property Corner
PSPC-09		C201				Property	PS #3351 Property Corner
PSPC-10		C201				Property	PS #3351 Property Corner
PSPC-11		C301				Pump Station Tract	PS #3301 Property Corner
PSPC-12		C301				Pump Station Tract	PS #3301 Property Corner
PSPC-13		C301				Pump Station Tract	PS #3301 Property Corner
PSPC-14		C301				Pump Station Tract	PS #3301 Property Corner
PSPC-15		C401				Pump Station Tract	PS #3390 Property Corner
PSPC-16		C401				Pump Station Tract	PS #3390 Property Corner
PSPC-17		C401				Pump Station Tract	PS #3390 Property Corner
PSPC-18		C401				Pump Station Tract	PS #3390 Property Corner
PSPC-19		C401				Pump Station Tract	PS #3390 Property Corner
PSPC-20		C401				Pump Station Tract	PS #3390 Property Corner
PSPC-21		C401				Pump Station Tract	PS #3390 Property Corner
PSPC-22		C401				Pump Station Tract	PS #3390 Property Corner
PSPC-23		C501				Easement	PS #3325 Easement Corner
PSPC-24		C501				Easement	PS #3325 Easement Corner
PSPC-25		C501				Easement	PS #3325 Easement Corner
PSPC-26		C501				Easement	PS #3325 Easement Corner
PSPC-27		C501				Easement	PS #3325 Easement Corner
PSPC-28		C501				Easement	PS #3325 Easement Corner
PSPC-29		C501				Easement	PS #3325 Easement Corner

PUMP STATION OUTER LIMITS ASSET TABLE							
ID Number	Utilities Asset Number	Plan Sheet #	Easting	Northing	Elevation	Boundary Corner Type	Comments
PSOL-01		C101				Pump Station Tract	PS #3337 Pump Station Outer Limit
PSOL-02		C101				Pump Station Tract	PS #3337 Pump Station Outer Limit
PSOL-03		C101				Pump Station Tract	PS #3337 Pump Station Outer Limit
PSOL-04		C101				Pump Station Tract	PS #3337 Pump Station Outer Limit
PSOL-05		C201				Pump Station Tract	PS #3351 Pump Station Outer Limit
PSOL-06		C201				Pump Station Tract	PS #3351 Pump Station Outer Limit
PSOL-07		C201				Pump Station Tract	PS #3351 Pump Station Outer Limit
PSOL-08		C201				Pump Station Tract	PS #3351 Pump Station Outer Limit
PSOL-09		C301				Pump Station Tract	PS #3301 Pump Station Outer Limit
PSOL-10		C301				Pump Station Tract	PS #3301 Pump Station Outer Limit
PSOL-11		C301				Pump Station Tract	PS #3301 Pump Station Outer Limit
PSOL-12		C301				Pump Station Tract	PS #3301 Pump Station Outer Limit
PSOL-13		C401				Pump Station Tract	PS #3390 Pump Station Outer Limit
PSOL-14		C401				Pump Station Tract	PS #3390 Pump Station Outer Limit
PSOL-15		C401				Pump Station Tract	PS #3390 Pump Station Outer Limit
PSOL-16		C401				Pump Station Tract	PS #3390 Pump Station Outer Limit
PSOL-17		C501				Pump Station Tract	PS #3325 Pump Station Outer Limit
PSOL-18		C501				Pump Station Tract	PS #3325 Pump Station Outer Limit
PSOL-19		C501				Pump Station Tract	PS #3325 Pump Station Outer Limit
PSOL-20		C501				Pump Station Tract	PS #3325 Pump Station Outer Limit

PUMP STATION ASSET TABLE						
ID Number	Utilities Asset Number	Plan Sheet #	Easting	Northing	Elevation	Comments
PSWW-01		C101				PS #3337
PSWW-02		C201				PS #3351
PSWW-03		C301				PS #3301
PSWW-04		C401				PS #3390
PSWW-05		C501				PS #3325



REV	DATE	DESCRIPTION	BY
C	05/2019	ISSUED FOR BID	AJM
B	10/2018	90% DRAWINGS	AJM
A	08/2018	60% DRAWINGS	AJM

Designed	ARS
Drawn	AJM
Checked	MDP
Reviewed	JRV
Approved	MDP

ORANGE COUNTY
 R/R PACKAGE 22 PUMP STATIONS
 ASSET ATTRIBUTE TABLES
ASSET TABLES

LINE IS 1" AT FULL SIZE

PROJECT NO.: 110034	
SCALE: NOTED	REVISION: C
DRAWING NO. X100	SHEET NO.: 47 OF 47

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 CERTIFICATE OF AUTH. 8181