
# ORANGE COUNTY CAPITAL PROJECT DIVISION 400 E. SOUTH STREET, 5th FLOOR ORLANDO, FL 32801

# ORANGE COUNTY MAYOR HONORABLE TERESA JACOBS

# COMMISSIONER DISTRICT 1 **BETSY VANDERLEY**

# COMMISSIONER DISTRICT 2 **BRYAN NELSON**

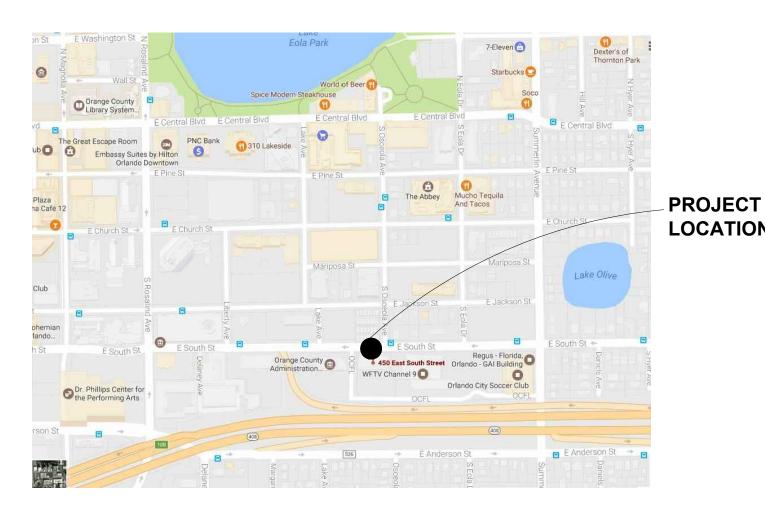







# **INTERNAL OPERATIONS CENTER - I RESTROOM UPGRADES - ALL FLOORS** 450 E. SOUTH STREET ORLANDO, FL 32801

**ARCHITECTURAL DESIGN** COLLABORATIVE

ARCHITECT 945 N. PENNSYLVANIA AVENUE WINTER PARK, FLORIDA 32789 (407) 629-1188 CONTACT: KAREN ANDERSON




# SGM ENGINEERING

**MEP ENGINEER** 935 LAKE BALDWIN LANE ORLANDO, FL 32814 (407)767-5188 CONTACT: JOHN J BONOTTO

LOCATION

**ORANGE COUNTY IOC - TOWER I** 

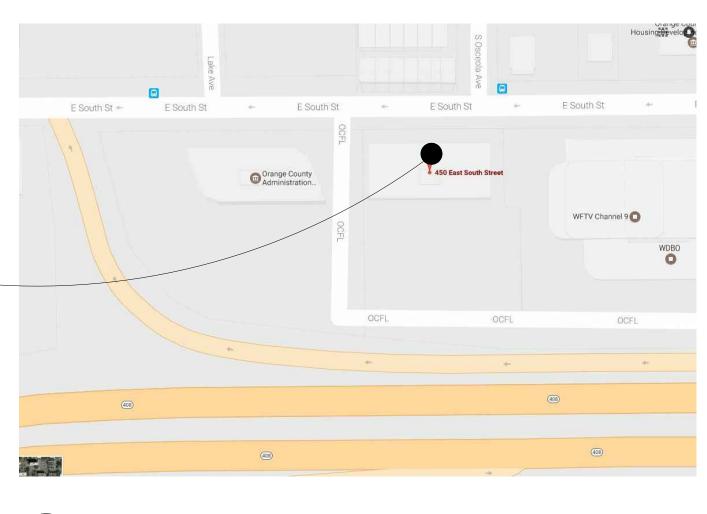



# COMMISSIONER DISTRICT 3 PETE CLARKE

# COMMISSIONER DISTRICT 4 JENNIFER THOMPSON

**COMMISSIONER DISTRICT 5** EMILY BONILLA

COMMISSIONER DISTRICT 6 VICTORIA P. SIPLIN

PERMIT ISSUE SET 04-27-2018

	CHITECTURAL				
•		G		R	
CCES COUS	ACCESSORY ACOUSTIC(AL)	GA GFRC	GAUGE GLASS FIBER REINFORCED	RDR RECES	READER RECESSED
FF HJ	ABOVE FINISHED FLOOR	GFRG	CONCRETE GLASS FIBER REINFORCED	RECPT REF	RECEPTACLE REFER(ENCE)
T	ALUMINUM ALTERNATE	GFRP	GYPSUM GLASS FIBER REINFORCED	REFL REFR	REFLECTED REFRIGERATOR
NUNC	ANNUNCIATOR ANODIZED	GL	PLASTER GLASS	REQD	REQUIRED RESIST(ANT)(IVE)
PL	APPLIANCE	GR	GRAD(E)(ING)	REINF	REINFORCE(D)(ING)(MENT)
RCH JTO	ARCHITECT(URAL) AUTOMATIC	GYP	GYPSUM	RESIL RFG	RESILIENT ROOFING
VG	AVERAGE AND	H		RM RO	ROOM
		HD HDWD	HEAD HARDWOOD	S	
DG	BUILDING	HDWE HM	HARDWARE HOLLOW METAL	SCR SECUR	SCRIBE SECURITY
)LLD )	BOLLARD BOARD	HORIZ HVAC	HORIZONTAL HEATING, VENTILATING, AND	SF SGL	SQUARE FEET SINGLE
KG RDLM	BLOCKING BROADLOOM		AIR CONDITIONING	SHORG	SHORING
J	BUILT UP	 		SIM SST	SIMILAR STAINLESS STEEL
		INFO INSTRUM	INFORMATION INSTRUMENT(ATION)	STD STL	STANDARD STEEL
\В РТ	CABINET CARPET	INSUL INTLK	INSULATION INTERLOCK(ING)	STRFR STRUCT	STOREFRONT STRUCTURAL
.M	CEMENT(ITIOUS)	INT INFILTR	INTERIOR INFILTRATION	SURF SUSP	SURFACE SUSPENDED
ER LG	CERAMIC CEILING	J		SYS	SYSTEM(S)
)ATG )ILG	COATING COILING	JAN	JANITOR	T	
)NC )NSTR	CONCRETE		UANTON	THK TLT	THICK TOILET
)NT )NTR	CONTINUOUS(ATION) CONTRACT(OR)	K		TRAF	TRAFFIC
)V 1U	COVER CONCRETE MASONRY UNIT	KIT	KITCHEN	TRANS TRTD	TRANSPARENT TREATED
-		L		T&G TYP	TONGUE AND GROOVE TYPICAL
L	DOUBLE	LAV	LAVATORY	U	
PT S	DEPARTMENT DESIGN(ED)	LB £	POUND BRITISH POUND (CURRENCY)		UNDERLAYMENT
Т	DETAIL	LT LVLG	LIGHT LEVELING	UTIL UNO	UTILITY UNLESS NOTED OTHERWISE
4	DRINKING FOUNTAIN DIAMETER	LVR	LOUVER	V	
F	DIFFUSER DIMENSION	M		VEH	VEHICLE
SP V	DISPENSER DIVISION	MAX MFD	MAXIMUM MANUFACTURED	VERT VIF	VERTICAL VERIFY IN FIELD
	DOWN DOLLAR (US CURRENCY)	MFR MECH	MANUFACTURER MECHANICAL		
CON	DOOR DISCONNECT	MET MEMB	METAL MEMBRANE	<b>W</b>	
/R	DRAWER	MEZZ MIN	MEZZANINE MINIMUM	W/ WC	WITH WATER CLOSET
		MISC MLWK	MISCELLANEOUS MILLWORK	WD WDW	WOOD WINDOW
.AST .EC	ELASTOMERIC ELECTRICAL	MOIST MOT	MOISTURE MOTOR(IZED)	W/O WT	WITHOUT WEIGHT
ibed Igr	EMBEDD(ED)(ING) ENGINEER(ED)	MTD	MOUNTED	WTRPRF	WATERPROOFING
ITR	ENTRANCE	Ν			
Q QUIP	EQUAL EQUIPMENT	NIC	NOT IN CONTRACT		
KIST KP JT	EXISTING EXPANSION JOINT	NO NTS	NUMBER NOT TO SCALE		
XPS XT	EXPOSE(D) EXTERIOR	0			
		ORNA	ORNAMENTAL		
AB	FABRICATION	OVFL OVHD	OVERFLOW OVERHEAD		
) - -	FLOOR DRAIN FIRE EXTINGUISHER	opng opr	OPENING(S) OPERABLE		
3 <b>&amp;</b> C	FIRE EXTINGUISHER AND CABINET	Ρ			
C	FIRE HOSE CABINET	PTN	PARTITION		
)G _C	FOLDING FIREPLACE	PEDTR PBD	PEDESTRIAN PARTICLE BOARD		
	FIRE RAT(ING)(ED)	PjM PNL	PROJECT MANAGER PANEL		
MG D	FRAMING FIXED	POLYST	POLYSTYRENE PORTABLE		
TR R	FIXTURE FLOOR(ING)	PREFIN	PREFINISHED		
RN T	FURNITURE FUTURE	PREFAB PLAM	PREFABRICATED PLASTIC LAMINATE		
VC IT	FABRIC WALL COVERING FUTURE	PLAS PLSTC	PLASTER PLASTIC		
I	IUIUIL	PLYWD PRTECN	PLYWOOD PROTECTION		

INTED ON: Apr 23, 2018 - 2:03pn

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WHERE EXISTING WORK IS DAMAGED IN THE EXECUTION OF THIS CONTRACT, OR WHERE OPENINGS ARE LEFT DUE TO THE REMOVAL OF PIPES, EQUIPMENT OR APPARATUS, THE SAME SHALL BE REPAIRED OR CLOSED TO CORRESPOND IN MATERIAL, QUALITY, SHAPE AND FINISH WITH THAT OF SIMILAR AND ADJOINING WORK, UNLESS OTHERWISE CALLED FOR. WHERE DAMAGE IS IRREPARABLE, NEW ITEMS OR EQUIPMENT SHALL BE PROVIDED. CONTRACTOR SHALL PROVIDE ALL NECESSARY WATERPROOFING, FIRE STOPPING AND SEALING OF PENETRATIONS LEFT FROM REMOVED EQUIPMENT OR PRODUCED BY THIS WORK.

# OPE

### CT NARRATIVE/SCOPE OF WORK ROJECT WILL CONSIST OF THE LIFECYCLE UPGRADES TO RES, TOILET PARTITIONS AND RESTROOM ACCESSORIES IN ALL STROOMS LOCATED WITHIN THE INTERNAL OPERATIONS R - I . ALL UPGRADED PLUMBING FIXTURES ARE TO BE LED IN EXACT LOCATION OF EXISTING.

NG WILL BE OCCUPIED DURING LIFECYCLE UPGRADES; FORE, WORK WILL BE PERFORMED IN PHASES TO MINIMIZE PTION TO DAILY OPERATIONS. GC TO COORDINATE WITH OCPM TO START TO DEVELOP PHASING SCHEDULE.

XISTING CERAMIC FLOOR TILE AND CERAMIC WALL TILE TO N, PROVIDE DEEP CLEANING OF TILE AND GROUT.

### OF WORK NOTES:

RK THAT IS NOT STATED HEREIN NOR SHOWN IN THESE IS NOT PART OF THE SCOPE OF WORK FOR THIS PROJECT.

NITIONAL WORK REQUIRED THAT WOULD ALTER THE NTED SCOPE OF WORK SHALL BE SUBJECT TO A REVISION OF DOCUMENTS AND MAY BE REQUIRED TO BE REVIEWED BY THE NG DEPARTMENT HAVING JURISDICTION.

# NERAL DEMO NOTES

OVE EXISTING RECEPTACLES, TELEPHONES, SWITCHES, AND ANY CTRICAL DEVICES IN WALLS TO BE DEMOLISHED. RELOCATE THESE CES AS INDICATED OR REQUIRED BY THE DRAWINGS, ARCHITECT, OR ER REPRESENTATIVE. PROVIDE ARCHITECT WITH AS-BUILT DRAWINGS OF L INSTALLATION FOR RECORD PURPOSES. CONTRACTOR IS NOTIFIED T NOT ALL EXISTING DEVICES MAY HAVE BEEN INDICATED ON THE WINGS AND THAT SOME EXISTING ELECTRICAL DEVICES MAY NOT HAVE N SHOWN IN THEIR ACTUAL LOCATION. CONTRACTOR IS REQUIRED TO SITE AND BECOME FAMILIAR WITH THE EXISTING CONDITIONS PRIOR TO ERMINING THE WORK THAT NEEDS TO BE ACCOMPLISHED AS PART OF HER BID.

WORK SHALL INCLUDE THE FURNISHING OF ALL MATERIALS, CUTTING, ENDING, CONNECTING, REPAIRING, ADAPTING, AND OTHER COINCIDENTAL EX TOGETHER WITH SUCH TEMPORARY INSTALLATIONS AS MAY BE ESSARY TO SATISFY THE DEMOLITION PROGRAM. APPROVAL SHALL BE JRED FROM THE OWNER/PROJECT MANAGER PRIOR TO CUTTING/DRILLING STRUCTURAL SUPPORT.

UILDING CONSTRUCTION AFFECTED BY THE REMOVAL, RELOCATION, ALLATION OF ANY PIECE OF EQUIPMENT SHALL BE REPAIRED AND HED AS REQUIRED TO MATCH EXISTING CONDITION OR AS DIRECTED BY ARCHITECTURAL DRAWINGS, SPECIFICATIONS, OR PROJECT MANAGER.

N ELECTRICAL DEVICES ARE PRESENT IN PARTITIONS OR CEILINGS TO BE OVED, THE ELECTRICAL CONTRACTOR SHALL DISCONNECT THEM UP TO NEXT OUTLET TO REMAIN OR BACK TO PANEL BOARD. IF EXISTING TO AIN OUTLETS ARE FED THROUGH DEMOLISHED PARTITIONS OR CEILINGS, CIRCUIT SHALL BE REARRANGED TO MAINTAIN CIRCUIT CONTINUITY. E SHALL BE REMOVED BACK TO SOURCE FROM INACCESSIBLE RACEWAYS REUSED. INSTALL BLANK PLATES ON FLUSH OUTLETS NOT REUSED. TE COLOR SHALL MATCH ADJACENT SURFACE AS NEAR AS POSSIBLE IN SHED AREAS.

ER TO ELECTRICAL ENGINEERING FOR WORK TO BE REMOVED FROM JCTURE. OTHER ELECTRICAL ITEMS ASSOCIATED WITH THIS WORK SHALL EMOVED IF NOT REQUIRED FOR NEW EQUIPMENT TO CONTINUE IN /ICE.

TRACTOR SHALL DEMOLISH ANY INTERIOR FINISHES TO COMPLETE THE ESSARY AND PROPOSED WORK AS DIRECTED BY THE ARCHITECTURAL WINGS, INTERIOR DESIGN DRAWINGS, SPECIFICATIONS, OR BY PROJECT AGER.

TING FIXTURES, EQUIPMENT, AND ALL DEBRIS WHICH ARE REQUIRED TO EMOVED SHALL BE REMOVED BY THE CONTRACTOR. CONTRACTOR TO RDINATE WITH PROJECT MANAGER PRIOR TO REMOVAL OF SUCH.

ELECTRICAL AND PLUMBING LINES WHICH REQUIRE REMOVAL OR RATION ARE TO BE DONE SO BY THE CONTRACTOR. LINES TO BE PED AND PREPARED FOR REMOVAL OR RE-ROUTING AS SPECIFIED.

OVE ALL UTILITIES IN DEMOLITION AREAS AND CONSTRUCTION AREAS IN A NER, AND IN THE TIME, SATISFACTORY TO THE UTILITY COMPANY. IF TY COMPANY DESIRES TO EFFECT THE REMOVAL OF THE MATERIALS, ' SHALL BE PERMITTED TO DO SO.

ER ITEMS AS SPECIFIED BY OWNER/PROJECT MANAGER TO PROTECT I DUST AND DEBRIS.

AGED MATERIALS SHALL BE REMOVED, CLEANED, AND PREPARED FOR ISTALLATION. OWNER MAINTAINS OWNERSHIP OF ALL MATERIALS ISS OTHERWISE SPECIFIED.

RE EXISTING WALLS, CEILINGS, AND FIXTURES HAVE BEEN REMOVED, S SHALL BE PATCHED TO MATCH EXISTING FINISHES, OR FINISHES TO BE D AS PER PLANS, INTERIOR DESIGNER, OR AS PER OWNER.

- 14 INTERRUPTION OF EXISTING SERVICES AND/OR OPERATION OF FACILITIES SHALL BE KEPT TO A MINIMUM. CONTRACTOR SHALL FURNISH ALL MATERIALS REQUIRED WHENEVER TEMPORARY CONNECTIONS ARE NECESSARY TO MAINTAIN CONTINUITY OF SERVICE. INTERRUPTION OF EXISTING SERVICES, THE INSTALLATION OF TEMPORARY FACILITIES, AND THE WORK OF MAKING FINAL CONNECTIONS TO THE NEW WORK SHALL BE DONE ONLY AT SUCH TIMES PERMITTED AND SCHEDULED IN ADVANCE BY THE ARCHITECT/OWNER WITHOUT ADDITIONAL COST. CARE MUST BE USE IN REMOVING SERVICES TO AREAS BEING DEMOLISHED SO THAT SERVICES TO OTHER AREAS WHICH MIGHT BE SERVED THROUGH THESE AREAS WILL NOT BE INTERRUPTED.
- 15 WHERE DEMOLITION WORK REQUIRES TEMPORARY INTERRUPTION OF ELECTRICAL, TELEPHONE, TV, ALARM OR COMMUNICATION SERVICES, RESPECTIVE UTILITIES AND/OR COMPANY REPRESENTATIVES SHALL BE NOTIFIED AS NECESSARY, AND ALL WORK DONE SHALL BE UNDER SUPERVISION AND THEIR ESTABLISHE STANDARDS.
- 16 ALL LIGHTING FIXTURES, RECEPTACLES, SWITCHES, WIRING DEVICES, SPECIAL OUTLETS, TELEPHONE CABLES, TV CABLES, MISCELLANEOUS SYSTEM WIRING, POWER CONDUCTORS, CONDUITS, ELECTRICAL BOXES, RACEWAYS AND ANY OTHER ELECTRICAL SYSTEM COMPONENTS LOCATED IN THE AREAS SHOWN AS BEING DEMOLISHED OR NOT USED AFTER WORK IS COMPLETED SHALL BE REMOVED UNLESS OTHERWISE NOTED AS EXISTING TO REMAIN OR BE RELOCATED. CONDUITS RUNNING IN SLAB AT FINISHED AREAS SHALL BE CUT FLUSH, PLUGGED AND ABANDONED AFTER CONDUCTORS ARE REMOVED. NO WIRING SHALL BE LEFT ABANDONED AFTER WORK IS COMPLETED.
- 17 ALL DEMOLITION, RENOVATION, AND CONSTRUCTION TO COMPLY WITH CURRENT NFPA REQUIREMENTS.
- 18 DEBRIS SHALL BE REMOVED FROM THE SITE DAILY.
- 19 THE GC SHALL THOROUGHLY INVESTIGATE EXISTING CONDITIONS INCLUDING GENERAL PLAN LAYOUT/CONFIGURATION AND EXISTING STRUCTURAL COMPONENTS VISIBLE OR CONCEALED (IN WALL AND/OR ABOVE CEILING), THAT COULD IMPACT THE WORK. THE GC SHALL FIELD VERIFY EXISTING DIMENSIONS, MATERIALS AND METHODS OF CONSTRUCTION, AND STRUCTURE, AND COORDINATE EACH WITH THE CONTRACT DOCUMENTS. THE GC SHALL NOTIFY THE ARCHITECT OF DISCREPANCIES BETWEEN EXISTING CONDITIONS AND THE CONTRACT DOCUMENTS PRIOR TO COMMENCING WORK. **AS BUILT DRAWINGS:**
- 1 GC TO PROVIDE ARCHITECT WITH FULL SIZED RED-LINED AND CLOUDED MARKED-UP/AS BUILT DRAWINGS AT EVERY SITE VISIT. DRAWINGS SHOULD SHOW ANY FIELD MODIFICATIONS THAT DIFFER FROM CONSTRUCTION DOCUMENTS.
- 2 THE ABOVE REFERENCED RUNNING SET OF AS-BUILTS WILL BE USED AT COMPLETION OF PROJECT TO PROVIDE THE CLIENT WITH AN ACCURATE SET OF RECORD DRAWINGS.

# **PROJECT INFORMATION**

### APPLICABLE CODES

FLORIDA BUILDING CODE - (6th EDITION 2017) FLORIDA BUILDING CODE ACCESSIBILITY (6th EDITION 2017) FLORIDA BUILDING CODE - EXISTING BUILDING- (6th EDITION 2017) FLORIDA FIRE PREVENTION CODE - (6th EDITION) BASED ON: NFPA 1 FIRE CODE - 2015 EDITION AND NFPA 101 - LIFE SAFETY CODE 2015 WITH FLORIDA AMENDMENTS NFPA 1- UNIFORM FIRE CODE 2015 WITH FLORIDA AMENDMENTS NFPA 70 - NATIONAL ELECTRICAL CODE - 2014 FLORIDA BUILDING CODE - ENERGY CONSERVATION CODE - 2017 FLORIDA BUILDING CODE - MECHANICAL CODE - 2017 FLORIDA BUILDING CODE - PLUMBING CODE - 2017 FLORIDA BUILDING CODE - ELECTRICAL CODE - 2017

CITY OF ORLANDO JURISDICTION

UTILITY SINK

(1 SERVICE SINK)

IALL	OCCUPANCY GROUP CLASSIFICATION: BU	SINESS - B
IE CT TO O	PROJECT SIZE 1ST FLOOR OVERALL GROSS SQ.FT. : 2ND FLOOR OVERALL GROSS SQ.FT. : 3RD FLOOR OVERALL GROSS SQ.FT. : TOTAL OVERALL GROSS SQ.FT. OCCUPANT LOAD (1 PER 100S.F.)	12,188 S.F. 13,953 S.F. 37,679 S.F.
IN A	1ST FLOOR AREA OF ALTERATION: 2ND FLOOR AREA OF ALTERATION: 3RD FLOOR AREA OF ALTERATION: TOTAL AREA OF ALTERATION:	300 S.F.
R	CONSTRUCTION TYPE: SPRINKLERED or NONSPRINKLERED: HEIGHT: CLASSIFICATION OF WORK:	EXISTING - TYPE IIB SPRINKLERED BUILDING EXISTING ALTERATION - LEVEL 1
) BE	WATER CLOSETS (1 PER 25 FOR FIRST 50)	(9) REQUIRED (20) PROVIDED
CT, ENT	(1 PER 50 FOR REMAINDER EXCEEDING 5	
	(1 PER 40 FOR FIRST 80) (1 PER 80 FOR REMAINDER EXCEEDING 8	(20) PROVIDED
TOR	DRINKING FOUNTAINS	(4) REQUIRED (6) PROVIDED

(1) REQUIRED

(3) PROVIDED

# **DRAWING INDEX**

### ARCHITECTURAL

		COVER SHEET
SED	A00.00	INDEX
	A00.01	GRAPHIC SYMBOLS
	A00.40	ACCESSIBILITY INFORMATION
	A02.01	DEMOLITION & CONSTRUCTION PLAN
		FIRST FLOOR
	A02.02	DEMOLITION & CONSTRUCTION PLAN
		SECOND FLOOR
	A02.03	DEMOLITION & CONSTRUCTION PLAN
ED		THIRD FLOOR
	A05.01	FINISH PLAN - FIRST FLOOR
ES,	A05.02	FINISH PLAN - SECOND FLOOR
US	A05.03	FINISH PLAN - THIRD FLOOR
•••	A08.01A	ENLARGED RESTROOM PLAN & ELEVATIONS
	A08.01B	ENLARGED RESTROOM PLAN & ELEVATIONS

### PLUMBING

ᇇ		
LL	P0.01	PLUMBING SYMBOLS
	P02.01	PLUMBING DEMO & RENO FIRST FLOOR
RK	P02.02	PLUMBING DEMO & RENO SECOND FLOOR
	P02.03	PLUMBING DEMO & RENO THIRD FLOOR
	P06.01	DETAILS

### ELECTRICAL

E0.01	SYMBOLS LEGEND
E02.01	ELECTRICAL DEMO & RENO FIRST FLOOR
E02.02	ELECTRICAL DEMO & RENO SECOND FLOOR
E02.03	ELECTRICAL DEMO & RENO THIRD FLOOR

	RCHITECT	URAL DESIGN CO	DLLABORATIV	E
		A AVENUE		
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<b>UNN</b> 0	8.25.17 0.16.17	90% CD SET 100% CD SET	PG / JS PG / JS	MF AC
	4.27.18	PERMIT SET	PG / JS	AC
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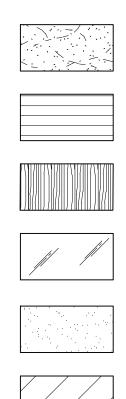
INDEX



# **GRAPHIC SYMBOLS (CONT.)**

STONE

# **ELEVATION INDICATIONS**



BRICK/CONCRETE BLOCK
FINISHED WOOD
GLASS

QUARTZ

RESIN

# SECTION INDICATIONS

and a state of the second state of the second state and the second state of the second state of the second state and a state of the second state

SAND OR GROUT EARTH OR NATURAL GROUND POROUS FILL (GRAVEL) STONE CONCRETE BRICK CONCRETE MASONRY UNIT METAL NON-FERROUS ALUMINUM PLYWOOD

WOOD (FINISH)

WOOD (CONTINUOUS)

WOOD (BLOCKING) INTERRUPTED MEMBER

INSULATION (LOOSE OR BATT)

INSULATION (RIGID)

GLASS (LARGE SCALE)


GYPSUM BOARD

PLASTER WITH LATH

ACOUSTICAL TILE

CARPET

FABRIC WRAPPED PANEL

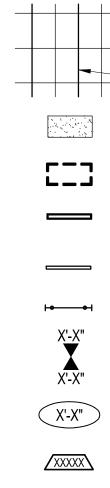

SD HST +  $(\mathbb{S})$  $\leq$  $\square$ 

 $\otimes$ 

R



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\_\_\_\_(XXXXX)-

(XXXXX) XXXXXX

Ċ, с,  $\Box$ 

# **GRAPHIC SYMBOLS (CONT.)**

## **REFLECTED CEILING**

ACOUSTICAL CEILING AND GRID
MAIN RUNNER
GYPSUM BOARD SOFFIT
EXISTING TO BE REMOVED
SURFACE MOUNTED FLUORESCENT LIGHT FIXTURE
FLUORESCENT STRIP FIXTURE
FLUORESCENT PENDANT FIXTURE
CEILING HEIGHT CHANGE
DIMENSION OF CEILING ABOVE FINISH FLOOR
CEILING FINISH
CEILING MOUNTED EXIT SIGN, SHOWS QUANTITY OF FACE(S) AND DIRECTION OF ARROW(S)
SMOKE DETECTOR
STROBE
FIRE SPRINKLER
SPEAKER
ACCESS DOOR
SECURITY CAMERA
THERMOSTAT
LIGHT SWITCH DIMMER SWITCH
RETURN AIR
SUPPLY AIR
LINEAR DIFFUSER
DENOTES EXISTING TO REMAIN

- WALL FINISH - BASE FINISH EXTENT OF FINISH

WALL FINISH EXTENT OF FINISH

> WALL FINISH - WAINSCOT FINISH - BASE FINISH

SPECIAL FINISH

FLOOR FINISH

CHANGE IN FLOOR FINISH

# **GRAPHIC SYMBOLS (CONT.)**

### **POWER & COMMUNICATION**

WALL MOUNTED DUPLEX


Φ

φ	WALL MOUNTED DUPLEX
<b>+</b>	WALL MOUNTED FOURPLEX
<b>\</b>	QUADRAPLEX ISOLATED
<b>¢</b>	WALL MOUNTED SEPARATE DUPLEX
	WALL MOUNTED DEDICATED DUPLEX
÷	WALL MOUNTED DEDICATED FOURPLEX
•	WALL MOUNTED HALF DEDICATED FOURPLEX
•	WALL MOUNTED SPECIAL OUTLET
	WALL MOUNTED TELEPHONE RECEPTACLE
	WALL MOUNTED TELE/DATA RECEPTACLE
₃▲	WALL MOUNTED 1 TELE/2 DATA RECEPTACLE - QUAD FACEPLATE TERMINAL IN SINGLE-GANG, DUPLEX J-BOX.
Δ	WALL MOUNTED DATA RECEPTACLE
AV	WALL MOUNTED A/V RECEPTACLE
_	
TV	WALL MOUNTED TV/CAMERA RECEPTACLE - 3" SQUARE.
	FLUSH FLOOR MOUNTED TELEPHONE RECEPTACLE
	FLUSH FLOOR MOUNTED TELE/DATA RECEPTACLE
3	FLUSH FLOOR MOUNTED 1 TELE/2 DATA RECEPTACLE
$\bigcirc$	FLUSH FLOOR MOUNTED DATA RECEPTACLE
ullet	FLUSH FLOOR MOUNTED DUPLEX
$\bigoplus$	FLUSHFLOOR MOUNTED FOURPLEX
	FLUSH FLOOR MOUNTED DEDICATED DUPLEX
•	
+	FLUSH FLOOR MOUNTED DEDICATED FOURPLEX
<b>O</b>	FLUSH FLOOR MOUNTED SEPARATE DUPLEX
۲	FLUSH FLOOR MOUNTED SEPARATE FOURPLEX
	FLUSH FLOOR MOUNTED DUPLEX WITH TELE/DATA RECEPTACLE
	FLUSH FLOOR MOUNTED DEDICATED DUPLEX WITH TELE/DATA RECEPTACLE
$\bigcirc$	
	FLUSH FLOOR MOUNTED SEPARATE DUPLEX WITH TELE/DATA RECEPTACLE
$\bigcirc$	
$\mathbb{A}$	FLUSH FLOOR MOUNTED A/V RECEPTACLE
	FLUSH FLOOR MOUNTED TV RECEPTACLE
	POKE-THRU TEL. MONUMENT
	POKE-THRU TELE/DATA MONUMENT
$\square$	POKE-THRU DATA POWER MONUMENT
	POKE-THRU DUPLEX POWER MONUMENT
<b></b>	POKE-THRU FOURPLEX POWER MONUMENT
Ο	POKE-THRU DEDICATED DUPLEX POWER MONUMENT
•	POKE-THRU DEDICATED FOURPLEX POWER MONUMENT
	POKE-THRU SEPARATE DUPLEX POWER MONUMENT
	POKE-THRU SEPARATE FOURPLEX POWER MONUMENT
AV	POKE-THRU A/V MONUMENT
TV	POKE-THRU TV MONUMENT
J	FLUSH WALL MOUNTED POWER JUNCTION BOX
Ũ	WITH HARDWIRE CONNECTION
J	FLOOR POKE-THRU JUNCTION BOX WITH HARDWIRE CONNECTION
	COMBINATION FLOOR POKE-THRU JUNCTION BOX
AO	WITH HARDWIRE CONNECTION
CR	CARD READER
ID	INTERCOM DEVICE
DR	DOOR RELEASE BUTTON
РВ	DOOR BELL PUSH BUTTON TO READ "PUSH TO EXIT" PER NFPA 7.2.1.6.2 (4)
Μ	MONITOR
PD	PHONE DIRECTORY
H	
EL	ELECTRIC LOCKSET (SEE HARDWARE SCHEDULE) MAGNETIC LOCK (SEE HARDWARE SCHEDULE)
	SECURITY SYSTEM DOOR MONITOR CONTACT
MC	(SEE HARDWARE SCHEDULE)
A	INTRUSION ALARM (SEE SECURITY DRAWINGS)
KS	KEY SWITCH (SEE SECURITY DRAWINGS)
CP	CONTROL PANEL
BG	491 EMERGENCY BREAK GLASS STATION; SECURITY DOOR CONTROLS WALL MOUNTED SIMON BOARD, POWER & DATA
SB	TO BE COORDINATED WITH VENDOR
$\langle \! \! \! \! \! \! \! \! \! \! \! \! \! \! \! \! \! \! \!$	EQUIPMENT ITEM - SEE SCHEDULE
FS	FIRE WARDEN STATION
FP	FIRE ALARM PULL BOX
SM	SECURITY MONITOR
	A/V FOR PROJECTION SYSTEM
	CAMERA REFER TO REFLECTED CEILING PLAN FOR LOCATION
с Ш	
GFI	RECESSED POWER. DATA & COAX OUTLET, SEE PLAN FOR HT
P	GROUND FAULT INTERCEPTOR

### GRA

## CONS


GRAPHIC S	SYMBOLS		
CONSTRUCTIO	ON	ARCHITECTURAL DESIGN	COLLABORATIVE
		945 N. PENNSYLVANIA AVENUE WINTER PARK, FLORIDA 32789	
		OFFICE: (407) 629-1188 FAX: (407) 388-1220 WWW. ADCINTERNATIONAL.NET	
	COLUMN GRID	WWW. ADCINTERNATIONAL.NET	
	NEW PARTITION		AROUNDAND SO
	REFERENCE TO PARTITION TYPE	STATE OF FLORIDA	AA-C001315
	1 HR. RATED PARTITION	ALBERT JOSEPH COOPER III, R.A. Architect • Seal/Signature	AR-0010460
	1 1/2 HR. RATED PARTITION	Project Documents for:	
	2 HR. RATED PARTITION 3 HR. RATED PARTITION	<b>O</b> RAN	GT
			YH,
	4 HR. RATED PARTITION		
	SMOKE PARTITION		
OFFICE - 04F06	- ROOM NAME - ROOM NUMBER	Project:	
(XXXXXX)	DOOR NUMBER (WITH SCHEDULE) "N" PREFIX DENOTES DOOR AT NON-DT OPTION ONLY	INTERNAL OPERATIONS CEN RESTROOM UPGRADES - ALL 450 E. SOUTH STREET ORLANDO, FL 32801	
ALIGN	ALIGN WITH ESTABLISHED SURFACES	Issue Date & Issue Description	Drawn By Checked By
$\otimes$	SHEET NOTE	04.28.17 60% CD SET 08.25.17 90% CD SET 10.16.17 100% CD SET 04.27.18 PERMIT SET	PG / JS MF PG / JS MF
	REVISION REFERENCE	04.27.18 PERMIT SET	PG / JS AC
	EXTERIOR ELEVATION INDICATION	SPL	
XX AXX XX	- ROW ON ELEVATION SHEET WHERE SHOWN - DIRECTION OF ELEVATION - SHEET WHERE SHOWN		
	INTERIOR ELEVATION INDICATION		
A	- LOCATION ON ROW WHERE SHOWN		
XX A11.01 XXXX	<ul> <li>DIRECTION OF ELEVATION</li> <li>ROW ON ELEVATION SHEET WHERE SHOWN</li> <li>SHEET WHERE SHOWN</li> </ul>	• Client Information	
	- DETAIL NUMBER	W ORANGE COUNTY CAPITAL P 400 E SOUTH STREET 5th FLOOR CORLANDO, FL 32801	ROJECTS DIVISION
FL12.NW SIM	SHEET WHERE SHOWN	• ORLANDO, FL 32801	
	<ul> <li>DESCRIPTION OF SIMILAR OR OPPOSITE</li> <li>FLOOR LEVEL AND AREA OR PHASE</li> </ul>	비 Project Number	Issue Date
	- AREA TO BE DETAILED		04/27/2018
	- MILLWORK	Project Number 16319 Drawn By PG / JS Checked By	Project Status PERMIT ISSUE SET
	MILLWORK SCHEDULE TAG (IF USED)	AC Checked By	Scale NTS
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FEC	FIRE EXTINGUISHER CABINET	File Name	
(FV) EV/C	FIRE VALVE WITHOUT CABINET	X:\dwgs\16319 IOC I-II Restrooms\CAI A00.01_IOC I_GRAPHIC SYMBOLS.d	
FVC	FIRE VALVE CABINET		
		Consultant   Seal/Signature	
		Sheet Title:	
		GRAPHIC SYM	BOLS
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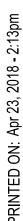


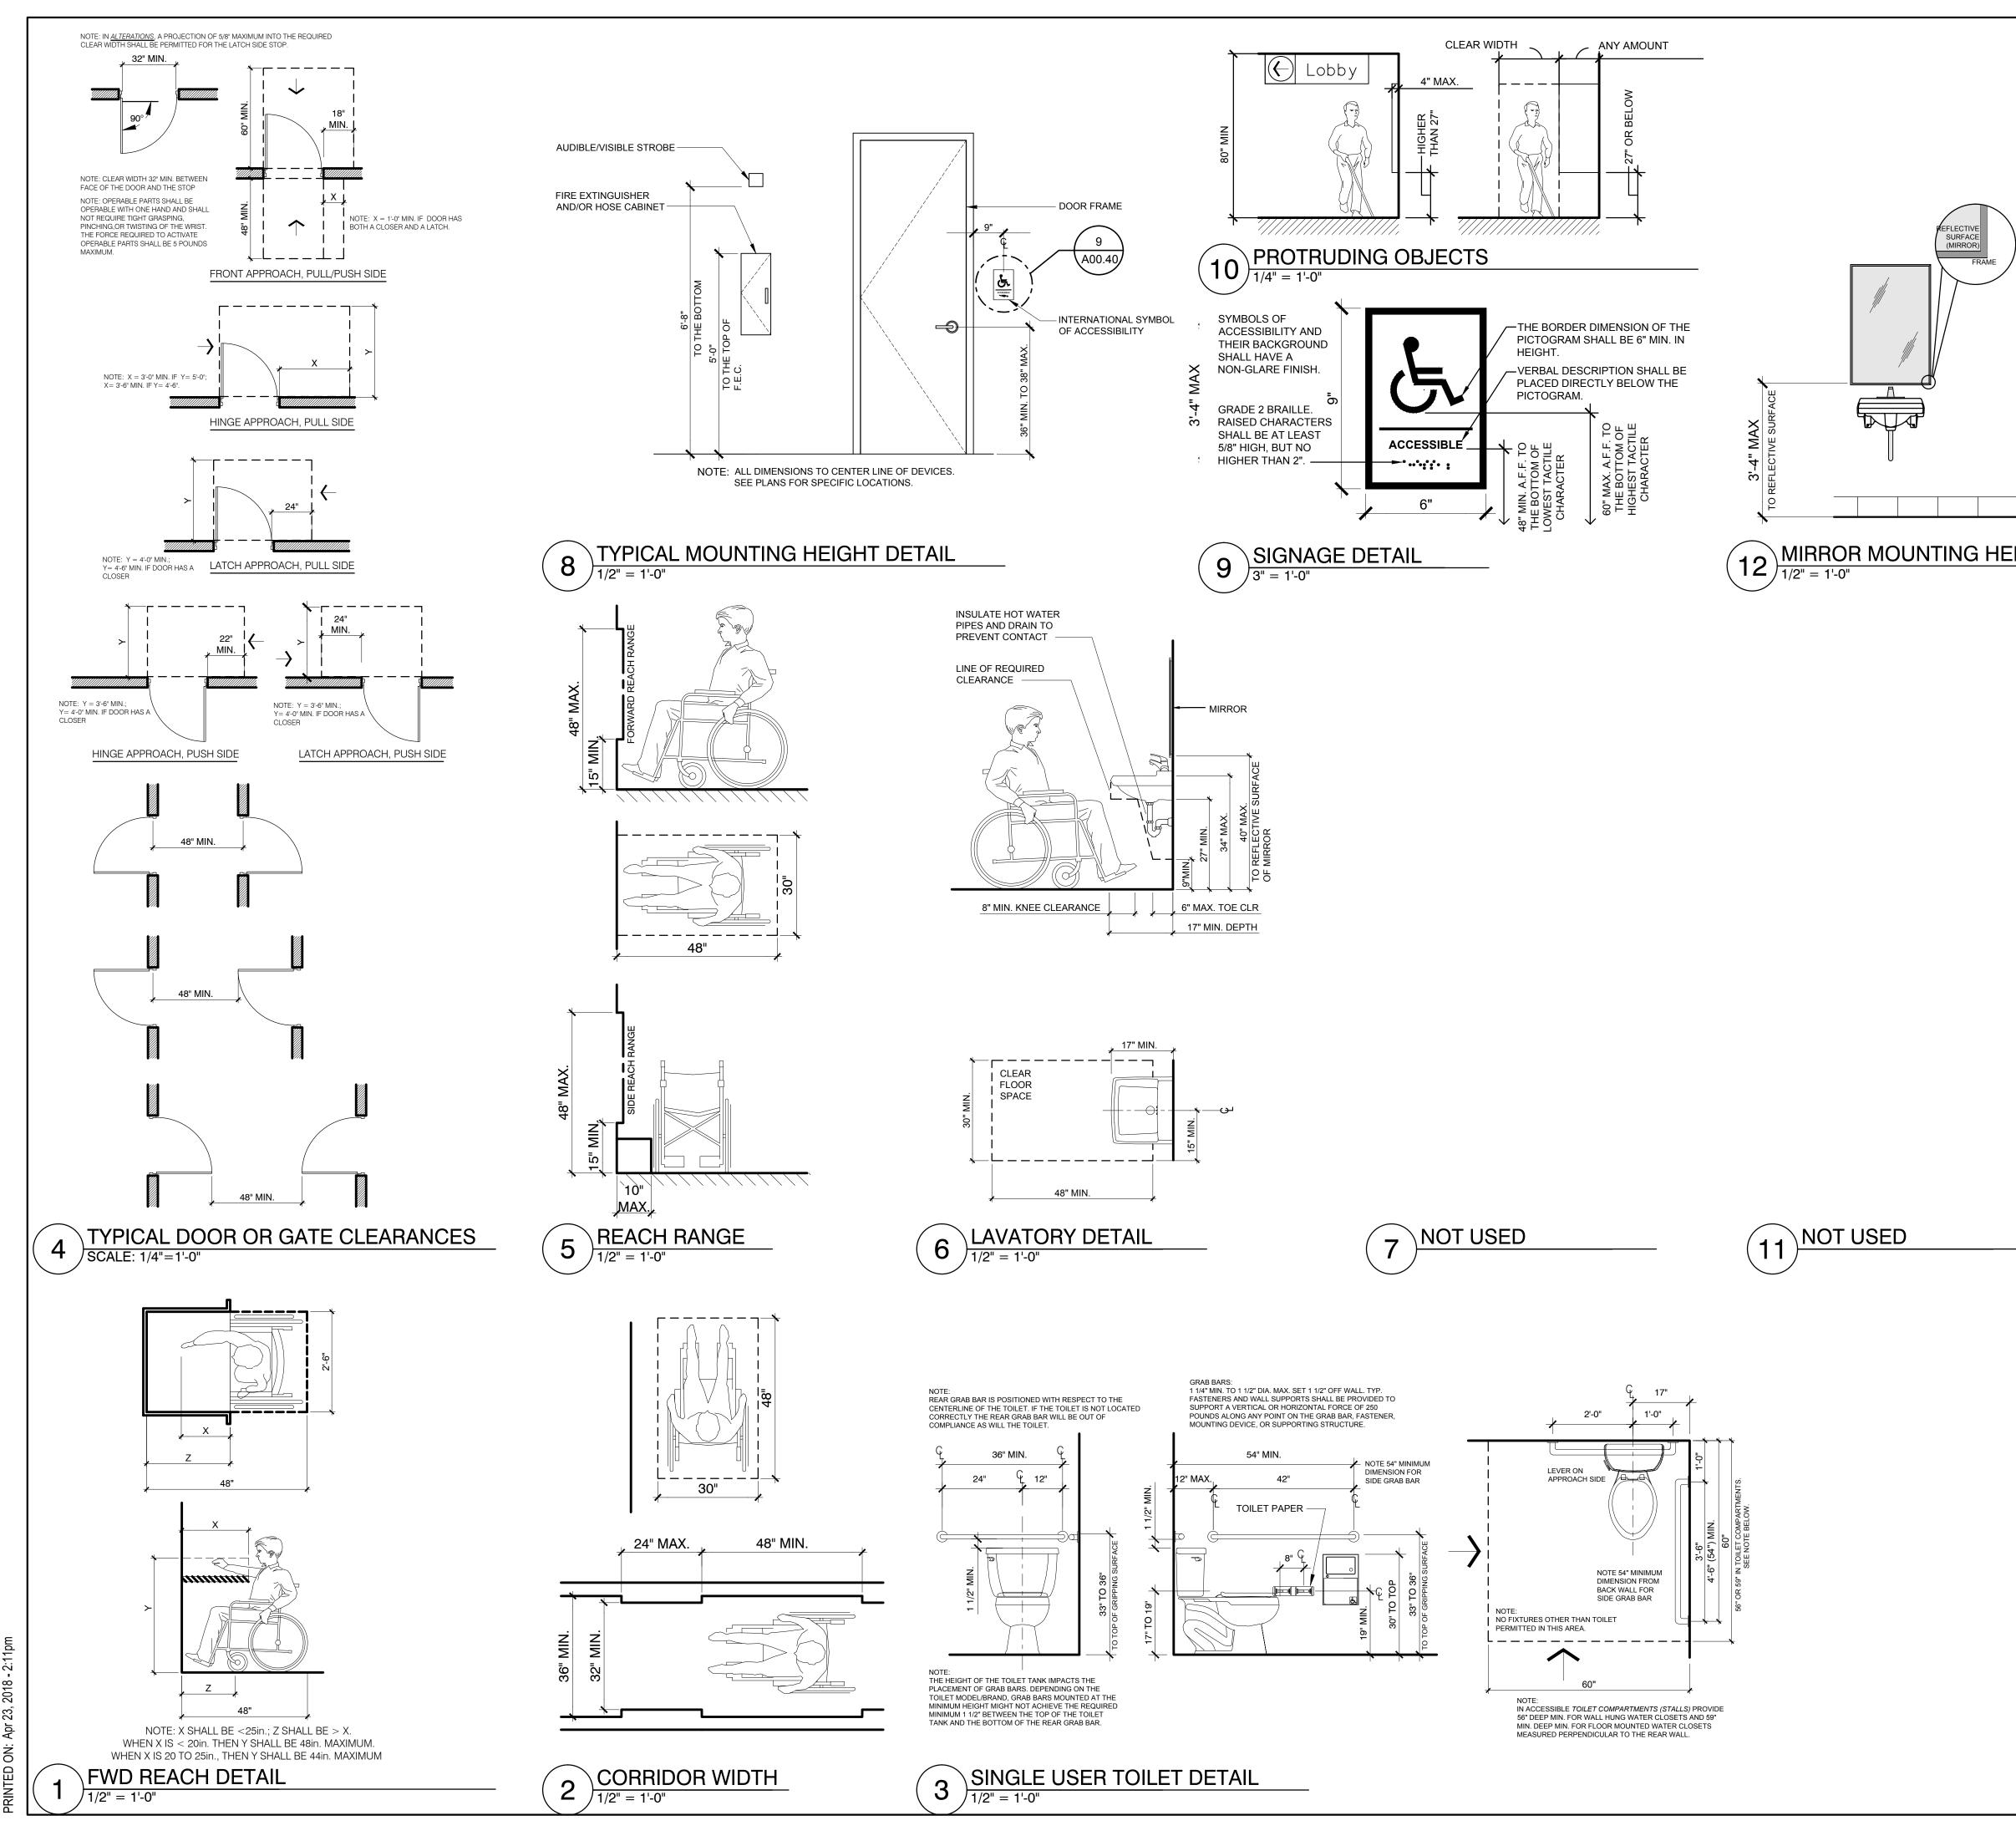
		ARCHITECTURAL DESIGN CO	LLABORATIVE
	1. FOR RESTROOMS ACCESSIBLE TO THE PUBLIC. THE WALLS AND FLOORS OF TOILET, BATHING AND SHOWER ROOMS SHALL HAVE A SMOOTH, HARD, NONABSORBENT SURFACE. THE INTERSECTIONS OF SUCH FLOORS WITH WALLS SHALL HAVE A		
	SMOOTH, HARD, NONABSORBENT VERTICAL BASE THAT EXTENDS UPWARD ONTO THE WALLS AT LEAST 4 INCHES. WALLS AND PARTITIONS WITHIN 2 FEET OF URINALS AND WATER CLOSETS	945 N. PENNSYLVANIA AVENUE	
	SHALL HAVE A SMOOTH, HARD, NONABSORBENT SURFACE, TO A HEIGHT OF 4 FEET ABOVE THE FLOOR, AND EXCEPT FOR STRUCTURAL ELEMENTS, THE MATERIALS USED IN SUCH WALLS	WINTER PARK, FLORIDA 32789 OFFICE: (407) 629-1188 FAX: (407) 388-1220	
	SHALL BE OF A TYPE THAT IS NOT ADVERSELY AFFECTED BY MOISTURE. ACCESSORIES SUCH AS GRAB BARS, TOWEL BARS, PAPER	WWW. ADCINTERNATIONAL.NET	A COM
	DISPENSERS AND SOAP DISHES, PROVIDED ON OR WITHIN WALLS, SHALL BE INSTALLED AND SEALED TO PROTECT STRUCTURAL ELEMENTS FROM MOISTURE.		AR0010460
	2. ALL DIMENSIONS ARE ABOVE FINISHED FLOOR (A.F.F.). DIMENSIONS THAT ARE NOT STATED AS "MAXIMUM" OR "MINIMUM"	Ę	RED ARCHING
	ARE ABSOLUTE. 3. ALL DIMENSIONS ARE TO FINISH SURFACES AND SHALL BE CONFIDENCE FARE DIMENSIONS THE ACCESSION FOR FORT	STATE OF FLORIDA	AA-C001315
	CONSIDERED "CLEAR" DIMENSIONS. THE ACCESSIBLE 5 FOOT TURNING CIRCLE IS A "CLEAR" DIMENSION CONTINUOUS FROM THE FLOOR AND UP THE WALLS. THE FINISHED BASE AND/OR TRIM MATERIALS SHALL NOT DIMINISH THE REQUIRED 5 FOOT	ALBERT JOSEPH COOPER III, R.A. Architect • Seal/Signature	AR-0010460
	DIMENSION AT THE FLOOR OR THE WALLS OF THE ROOM. GC SHALL LAY OUT THE WORK TO ACCOMMODATE THE THICKNESS OF MATERIALS AND ALLOW FOR VARIATIONS IN EXISTING AND NEW	Project Documents for:	
	SURFACES AND MATERIALS TO PROVIDE THE REQUIRED "CLEAR" DIMENSIONS.	<b>ORANG</b>	
	4. IF TOILETS ARE UPGRADED FOR ACCESSIBILITY COMPLIANCE REFER TO SHEET A08.01A & A08.01B FOR ADDITIONAL ACCESSIBILITY DETAILS, NOTES AND THE ACCESSORIES AND		
	FIXTURE SCHEDULES. 5. DETAILS SUPERSEDE PLANS. IN THE EVENT OF CONFLICTING		
	INFORMATION GC TO CONTACT ARCHITECT IMMEDIATELY. 6. FLOOR SURFACES SHALL BE SLIP-RESISTANT.		V
_	7. EVERY CORRIDOR AND AISLE SERVING AN OCCUPANT LOAD OF 10 OR MORE SHALL BE NOT LESS THAN 44" IN WIDTH.	<b>L'OUN'I</b>	
-	8. ABRUPT CHANGES IN LEVEL ALONG ANY ACCESSIBLE ROUTE SHALL NOT EXCEED 1/2" IN HEIGHT. LEVEL CHANGES NOT EXCEEDING 1/4" MAY BE VERTICAL. BEVEL OTHERS WITH A	F L O R I	D A
HT	SLOPE NO GREATER THAN 1:2 9. LATCHING AND LOCKING DOORS THAT ARE HAND ACTIVATED	Project: INTERNAL OPERATIONS CENTE	
	AND WHICH ARE IN A PATH OF TRAVEL SHALL BE OPERABLE WITH A SINGLE EFFORT BY LEVER TYPE HARDWARE, PANIC BARS, PUSH-PULL ACTIVATING BARS, OR OTHER HARDWARE	RESTROOM UPGRADES - ALL FI 450 E. SOUTH STREET	LOORS
	DESIGNED TO PROVIDE PASSAGE WITHOUT REQUIRING THE ABILITY TO GRASP THE OPENING HARDWARE. MOUNT DOOR OPENING HARDWARE BETWEEN 30" AND 44" ABOVE FLOOR	ORLANDO, FL 32801	
	FINISH. 10. MAXIMUM PULL OR PUSH EFFORT TO OPERATE DOORS SHALL NOT EXCEED 8.5 POUNDS FOR EXTERIOR DOORS AND	· · · · · · · · · · · · · · · · · · ·	Drawn By Checked By
	5 POUNDS FOR INTERIOR DOORS, MEASURED AT RIGHT ANGLES TO HINGED DOORS AND AT CENTER PLANE OF SLIDING OR FOLDING DOORS. CORRESPONDING DEVICES	04.28.17         60% CD SET           08.25.17         90% CD SET	PG / JS MF PG / JS MF
	OR AUTOMATIC DOOR OPERATORS MAY BE UTILIZED TO MEET THE ABOVE STANDARDS. MAXIMUM EFFORT TO OPERATE REQUIRED FIRE DOORS MAY BE INCREASED NOT	08.25.17         90% CD SET           10.16.17         100% CD SET           04.27.18         PERMIT SET	PG/JS AC PG/JS AC
	TO EXCEED 15 POUNDS. 11. THE BOTTOM 10" OF ALL DOORS (EXCEPT SLIDING AND		
	AUTOMATIC) SHALL HAVE A SMOOTH UNINTERRUPTED SURFACE TO ALLOW THE DOOR TO BE OPENED BY A WHEELCHAIR FOOTREST WITHOUT CREATING A TRAP OR HAZARDOUS CONDITION. PROVIDE A 10" HIGH SMOOTH PANEL ON THE PUSH SIDE OF NARROW FRAME DOORS.	• SPA	
	12. EVERY REQUIRED ENTRANCE OR PASSAGE DOORWAY SHALL BE NOT LESS THAN 3' IN WIDTH AND NOT LESS THAN 6'-8" IN HEIGHT. DOORS SHALL BE CAPABLE OF OPENING AT LEAST 90 DEGREES AND SHALL BE SO MOUNTED THAT THE CLEAR WIDTH OF THE DOORWAY IS NOT LESS THAN 32".		
	13. WHERE A PAIR OF DOORS IS UTILIZED, AT LEAST ONE OF THE DOORS SHALL PROVIDE A CLEAR, UNOBSTRUCTED OPENING WIDTH OF 32" WITH THE LEAF POSITIONED AT AN ANGLE OF 90 DEGREES FROM ITS CLOSED POSITION.		
	14. IDENTIFY ACCESSIBLE ENTRANCES WITH AT LEAST ONE STANDARD SIGN AND WITH ADDITIONAL DIRECTIONAL SIGNS, AS REQUIRED, VISIBLE FROM APPROACHING PEDESTRIAN	Client Information	
	WAYS. 15. FOR DOOR CLEARANCES REFER TO DETAIL 4 ON THIS	ORANGE COUNTY CAPITAL PRO	JECTS DIVISION
	SHEET. 16. FLOORS OR LANDINGS SHALL BE NOT MORE THAN 1/2"	400 E SOUTH STREET 5th FLOOR ORLANDO, FL 32801 ●	
	LOWER THAN THE THRESHOLD OF THE DOORWAY. CHANGE IN LEVEL BETWEEN 1/4" AND 1/2" SHALL BE BEVELED WITH A SLOPE NO GREATER THAN 1:2.		
	17. TO ALERT THE VISUALLY IMPAIRED, MARK THE UPPER APPROACH AND THE LOWER TREAD OF EACH INTERIOR STAIR WITH A STRIP OF CLEARLY CONTRASTING COLOR AT	Project Number 16319 Drawn By PG/JS Checked By	<b>Issue Date</b> 04/27/2018
	LEAST 2" WIDE, PLACED PARALLEL TO AND NOT MORE THAN 1" FROM THE NOSE OF THE STEP OR LANDING. THE STRIP SHALL BE OF A MATERIAL THAT IS SLIP RESISTANT AS THE	Drawn By PG/JS	Project Status
	OTHER TREADS OF THE STAIR. 18. CENTER ELECTRICAL RECEPTACLE OUTLETS NOT LESS	AC Checked By	Scale VARIES
	THAN 15" ABOVE THE FLOOR OR WORKING PLATFORM. 19. SANITARY FACILITIES LOCATED ON AN ACCESSIBLE FLOOR		VANIES
	OF A BUILDING SHALL BE ACCESSIBLE TO THE PHYSICALLY HANDICAPPED. 20. ENTRY TO SANITARY FACILITIES:	File Name X:\dwgs\16319 IOC I-II Restrooms\CAD\IC	OC-I\SHEETS\
	20. ENTRY TO SANTARY FACILITIES. A. 44" CLEAR AISLES OR CORRIDORS WHERE OCCUPANT LOAD IS 10 OR MORE. B. DOORWAYS TO HAVE A 32" CLEAR OPENING.	A00.40_IOC I_ACCESSIBILITY INFO AL.	
	C. ON APPROACH SIDE, PROVIDE A 60" CLEAR LEVEL SPACE WHEN DOOR SWINGS TOWARD APPROACH AND 44" SPACE WHEN DOOR SWINGS AWAY FROM		
	APPROACH. REFER TO ADA DRAWING FOR CLEARANCES BASED ON DIFFERENT APPROACHES.	Consultant   Seal/Signature	
	21. THE AMERICANS WITH DISABILITIES ACT (A.D.A.) PROVIDES THAT ALTERATIONS TO A FACILITY MUST BE MADE IN SUCH A MANNER THAT, TO THE MAXIMUM EXTENT FEASIBLE, THE ALTERED POPULANS OF THE FACILITY APE READILY		
	ALTERED PORTIONS OF THE FACILITY ARE READILY ACCESSIBLE TO INDIVIDUALS WITH DISABILITIES. GENERAL CONTRACTOR ACKNOWLEDGES THAT THE REQUIREMENTS OF A.D.A. WILL BE SUBJECT TO VARIOUS AND POSSIBLY		
	CONTRADICTORY INTERPRETATIONS. THE ARCHITECT THEREFORE, WILL USE ITS BEST PROFESSIONAL EFFORTS TO INTERPRET A.D.A. REQUIREMENTS AND OTHER		
	FEDERAL, STATE AND LOCAL LAWS, RULES, CODES, ORDINANCES AND REGULATIONS AS THEY APPLY TO THE PROJECT. THE ARCHITECT, HOWEVER, CANNOT AND DOES		
	NOT WARRANT OR GUARANTEE THAT OWNER WILL COMPLY WITH ALL INTERPRETATIONS OF THE A.D.A. REQUIREMENTS AND/ OR THE OTHER FEDERAL, STATE AND LOCAL LAWS,		
	RULES, CODES, ORDINANCES AND REGULATIONS AS THEY APPLY TO THE PROJECT.		
	22. THE SCOPE OF WORK INDICATED ON THESE DRAWINGS IS FOR SPECIFIC ITEMS SELECTED BY OWNER FOR CUSTOMER ACCESS TO GOODS AND SERVICES; NOTE THAT		
	SOME AREAS OF ACCESS HAVE NOT BEEN MODIFIED TO MEET ACCESSIBILITY REQUIREMENTS. ALL OTHER AREAS OF A.D.A. UPGRADE THAT MAY BE REQUIRED AT THIS TIME ADD NOT IN THIS CONTRACT AND ADD NOT INDICATED ON		
	ARE NOT IN THIS CONTRACT AND ARE NOT INDICATED ON THESE DOCUMENTS. SEE OWNER FOR ADDITIONAL	Sheet Title:	
	INFORMATION CONCERNING OTHER AREAS OF ACCESSIBILITY SCOPE OF WORK.		

NOTE THE DETAILS ON THIS SHEET SUPERSEDE INFORMATION/DETAILS SHOWN IN THE PLANS. IN THE EVENT OF CONFLICTING INFORMATION CONTACT OWNER IMMEDIATELY.





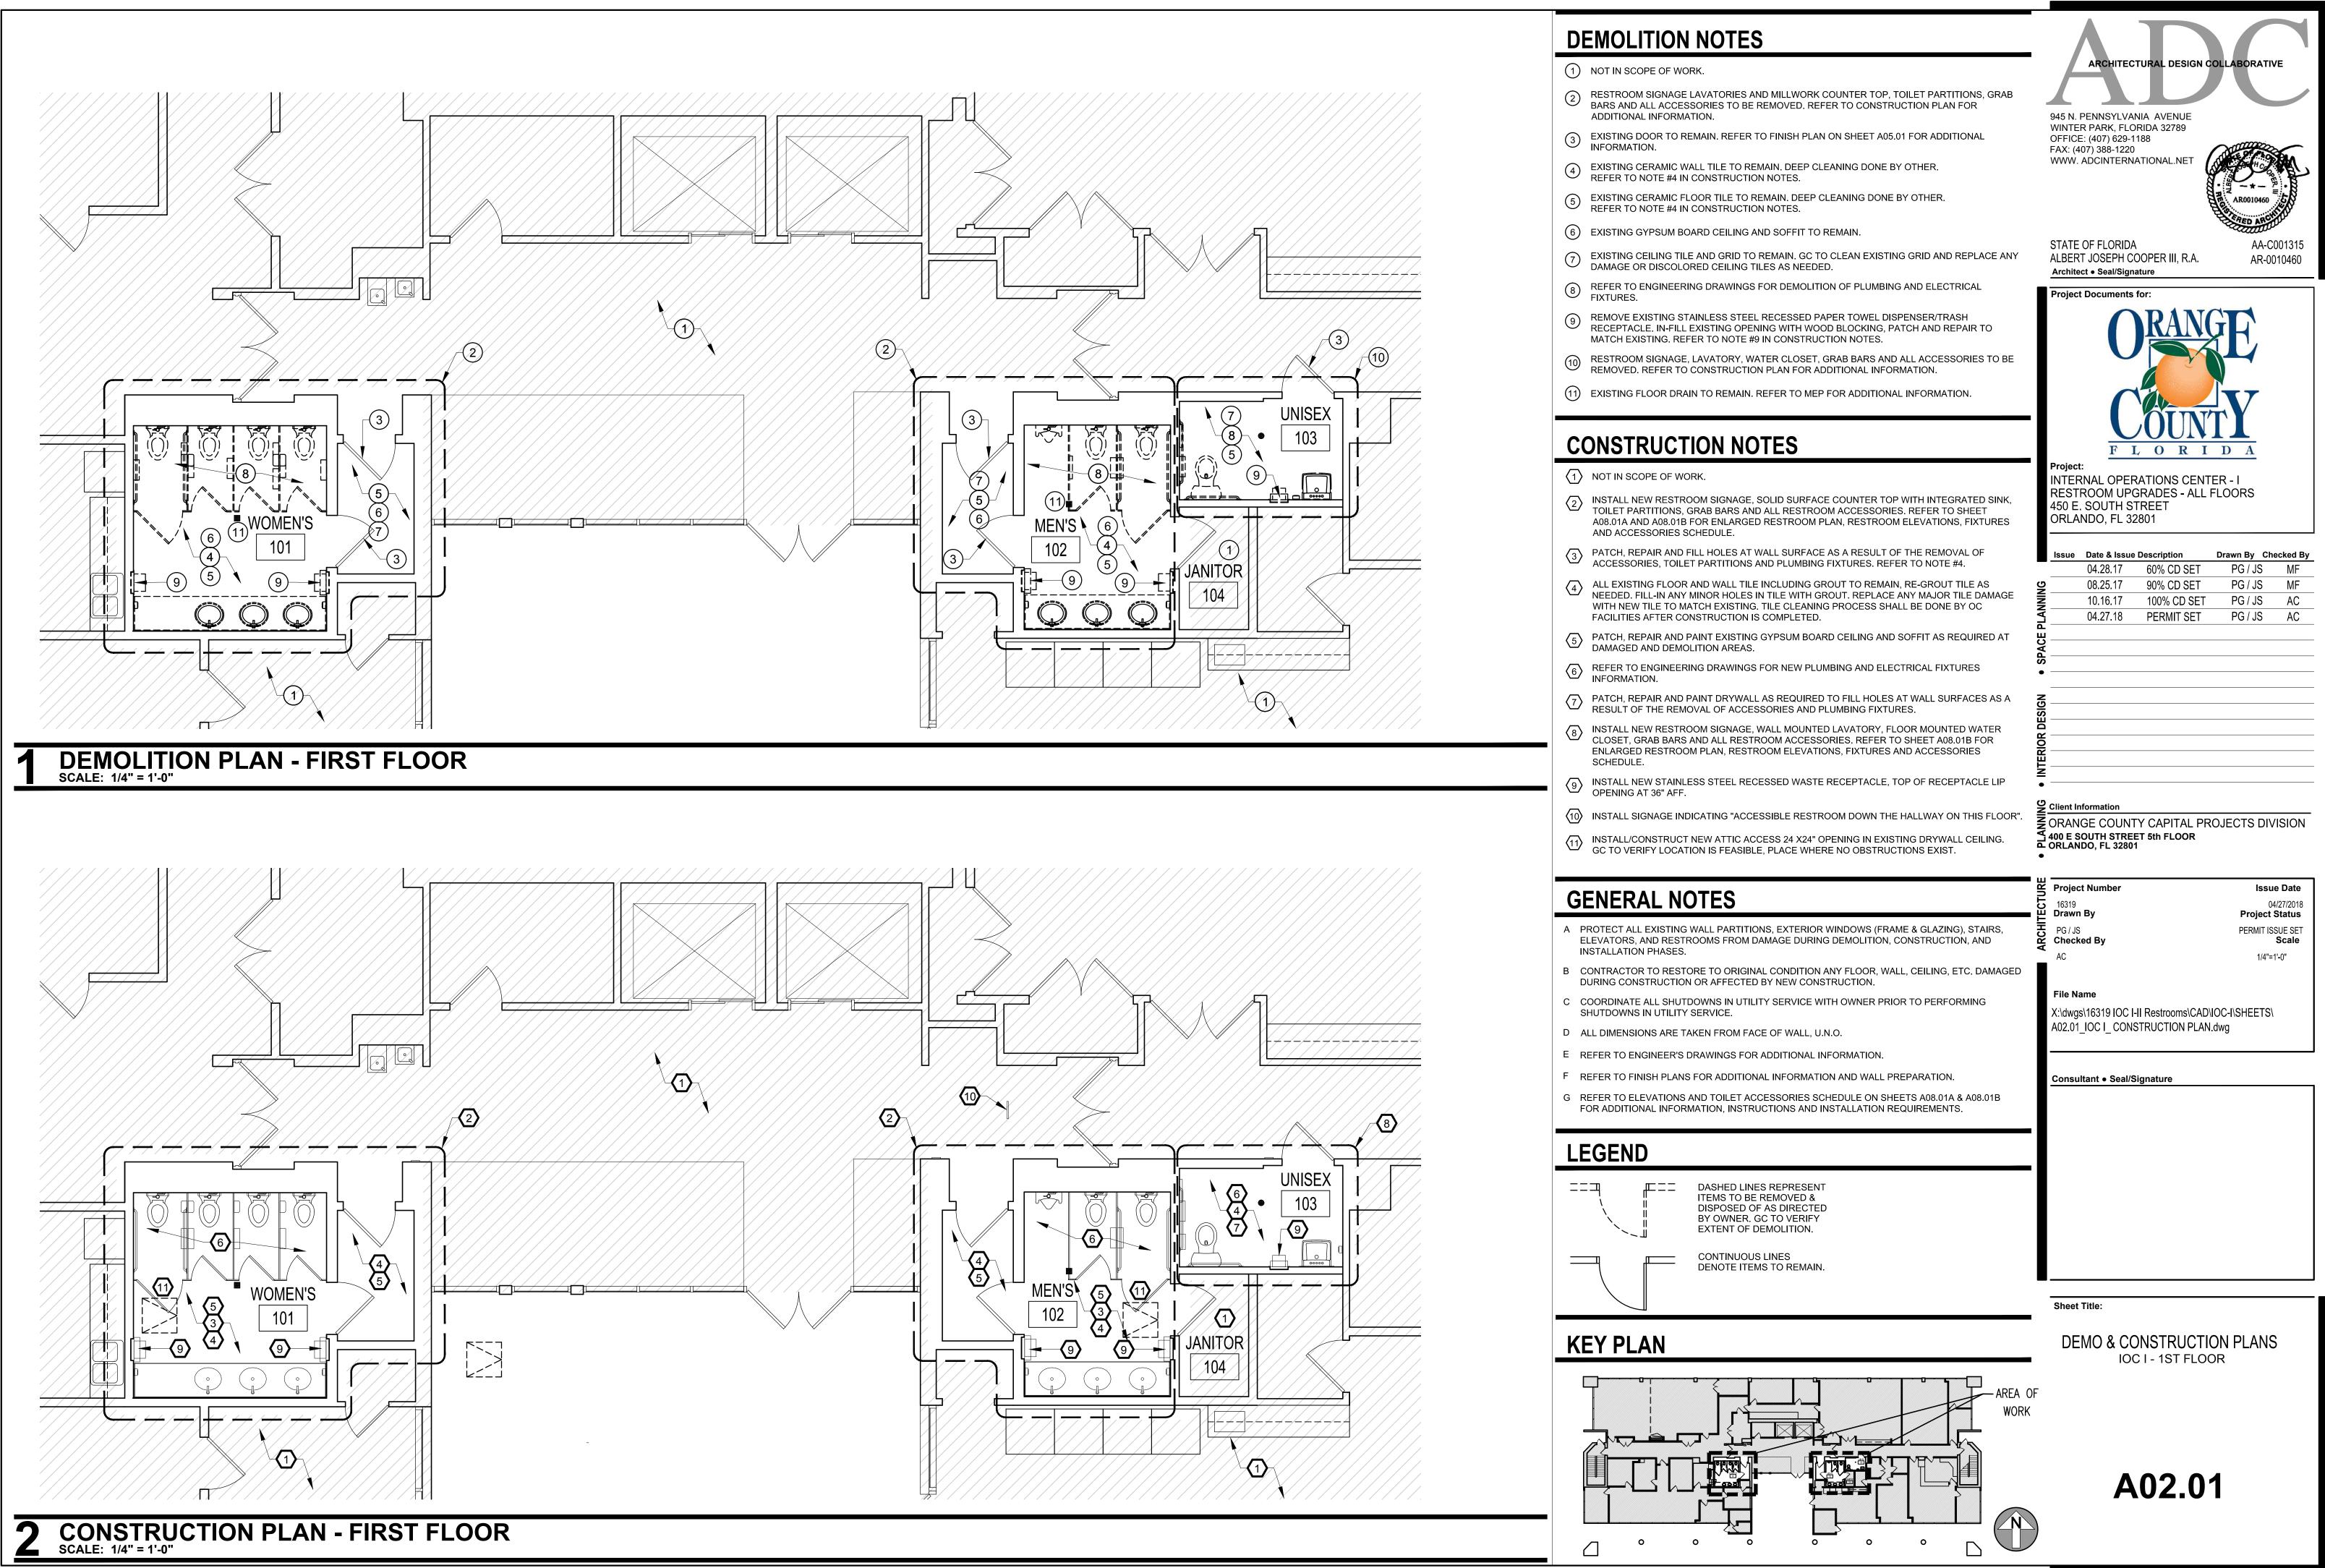

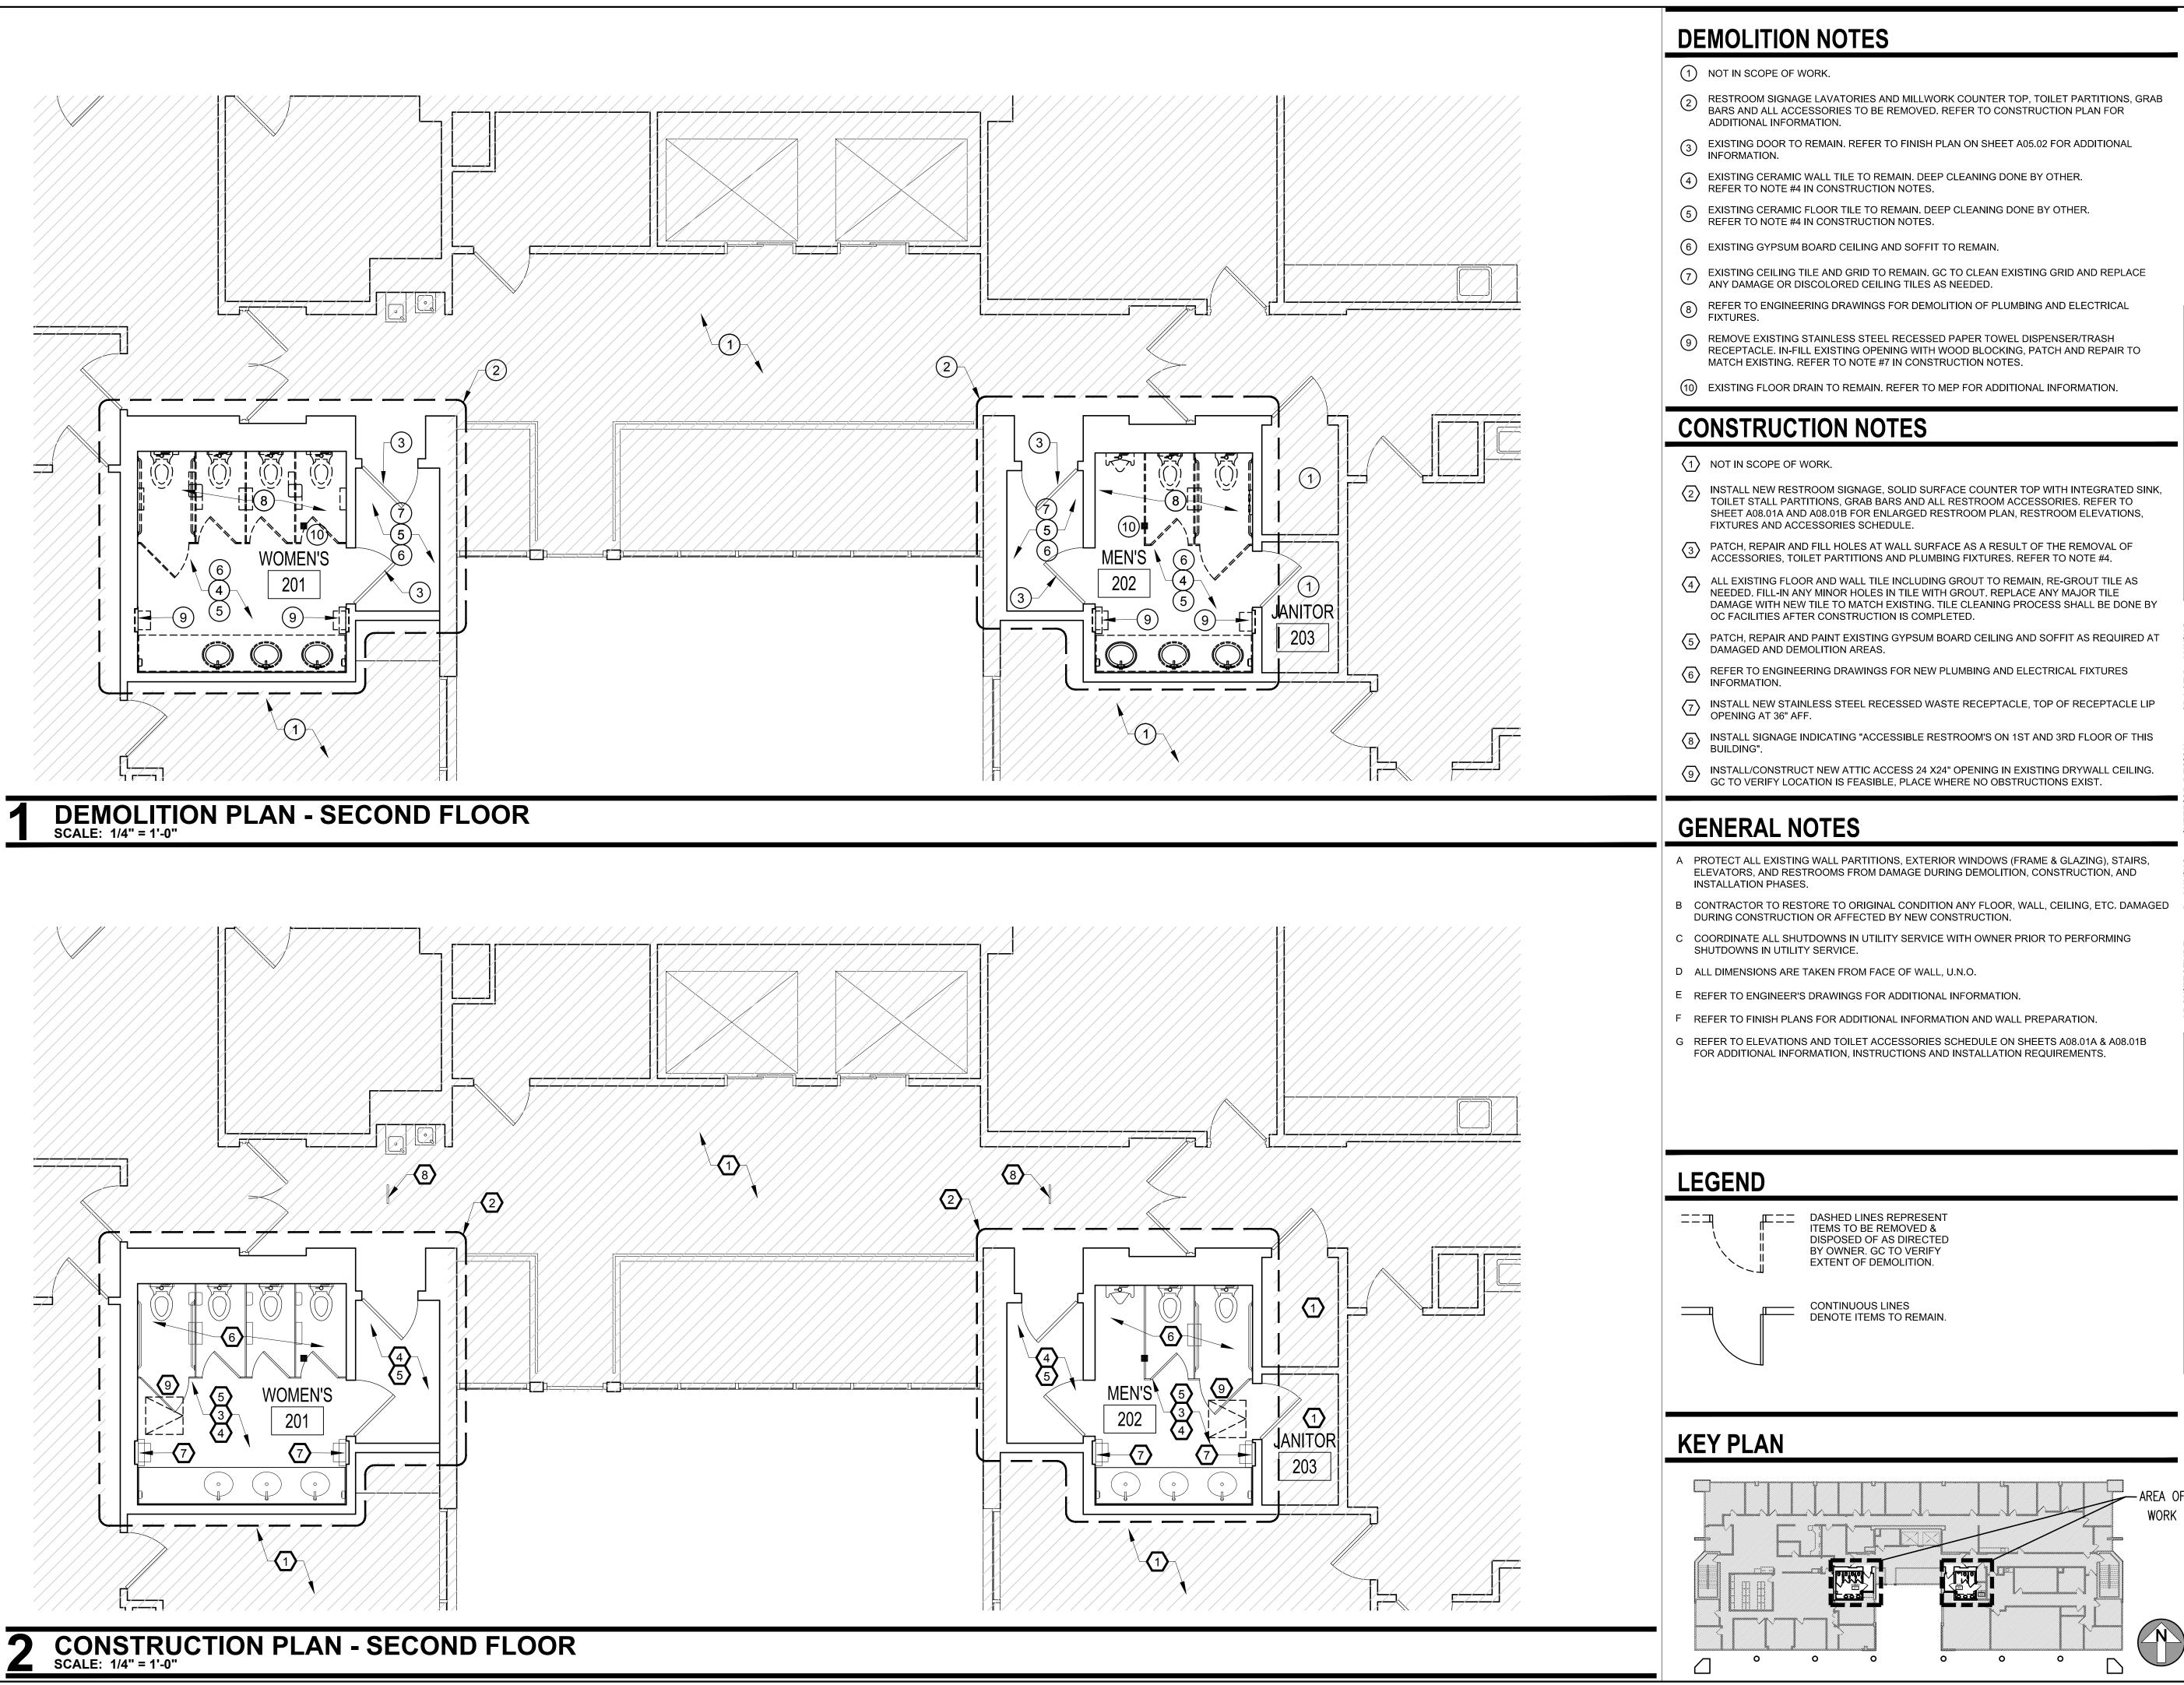

STATE OF FLORIDA AA-C001315 ALBERT JOSEPH COOPER III, R.A. AR-0010460 Architect 

Seal/Signature Project Documents for: FLORIDA Project: **INTERNAL OPERATIONS CENTER - I** RESTROOM UPGRADES - ALL FLOORS 450 E. SOUTH STREET ORLANDO, FL 32801 Issue Date & Issue Description Drawn By Checked By 04.28.17 60% CD SET PG/JS MF 08.25.17 90% CD SET PG/JS MF PG/JS AC 10.16.17 100% CD SET 04.27.18 PERMIT SET PG/JS AC Client Information

**ARCHITECTURAL DESIGN COLLABORATIVE** 

945 N. PENNSYLVANIA AVENUE

WINTER PARK, FLORIDA 32789

WWW. ADCINTERNATIONAL.NE

OFFICE: (407) 629-1188 FAX: (407) 388-1220

ORANGE COUNTY CAPITAL PROJECTS DIVISION 400 E SOUTH STREET 5th FLOOR CORLANDO, FL 32801

### Project Number 16319 Drawn By

PG / JS Checked By

Issue Date 04/27/2018 Project Status PERMIT ISSUE SET Scale 1/4"=1'-0"

Restrooms\CAD\IOC-I\SHEETS\ A02.02 IOC I CONSTRUCTION PLAN.dwg


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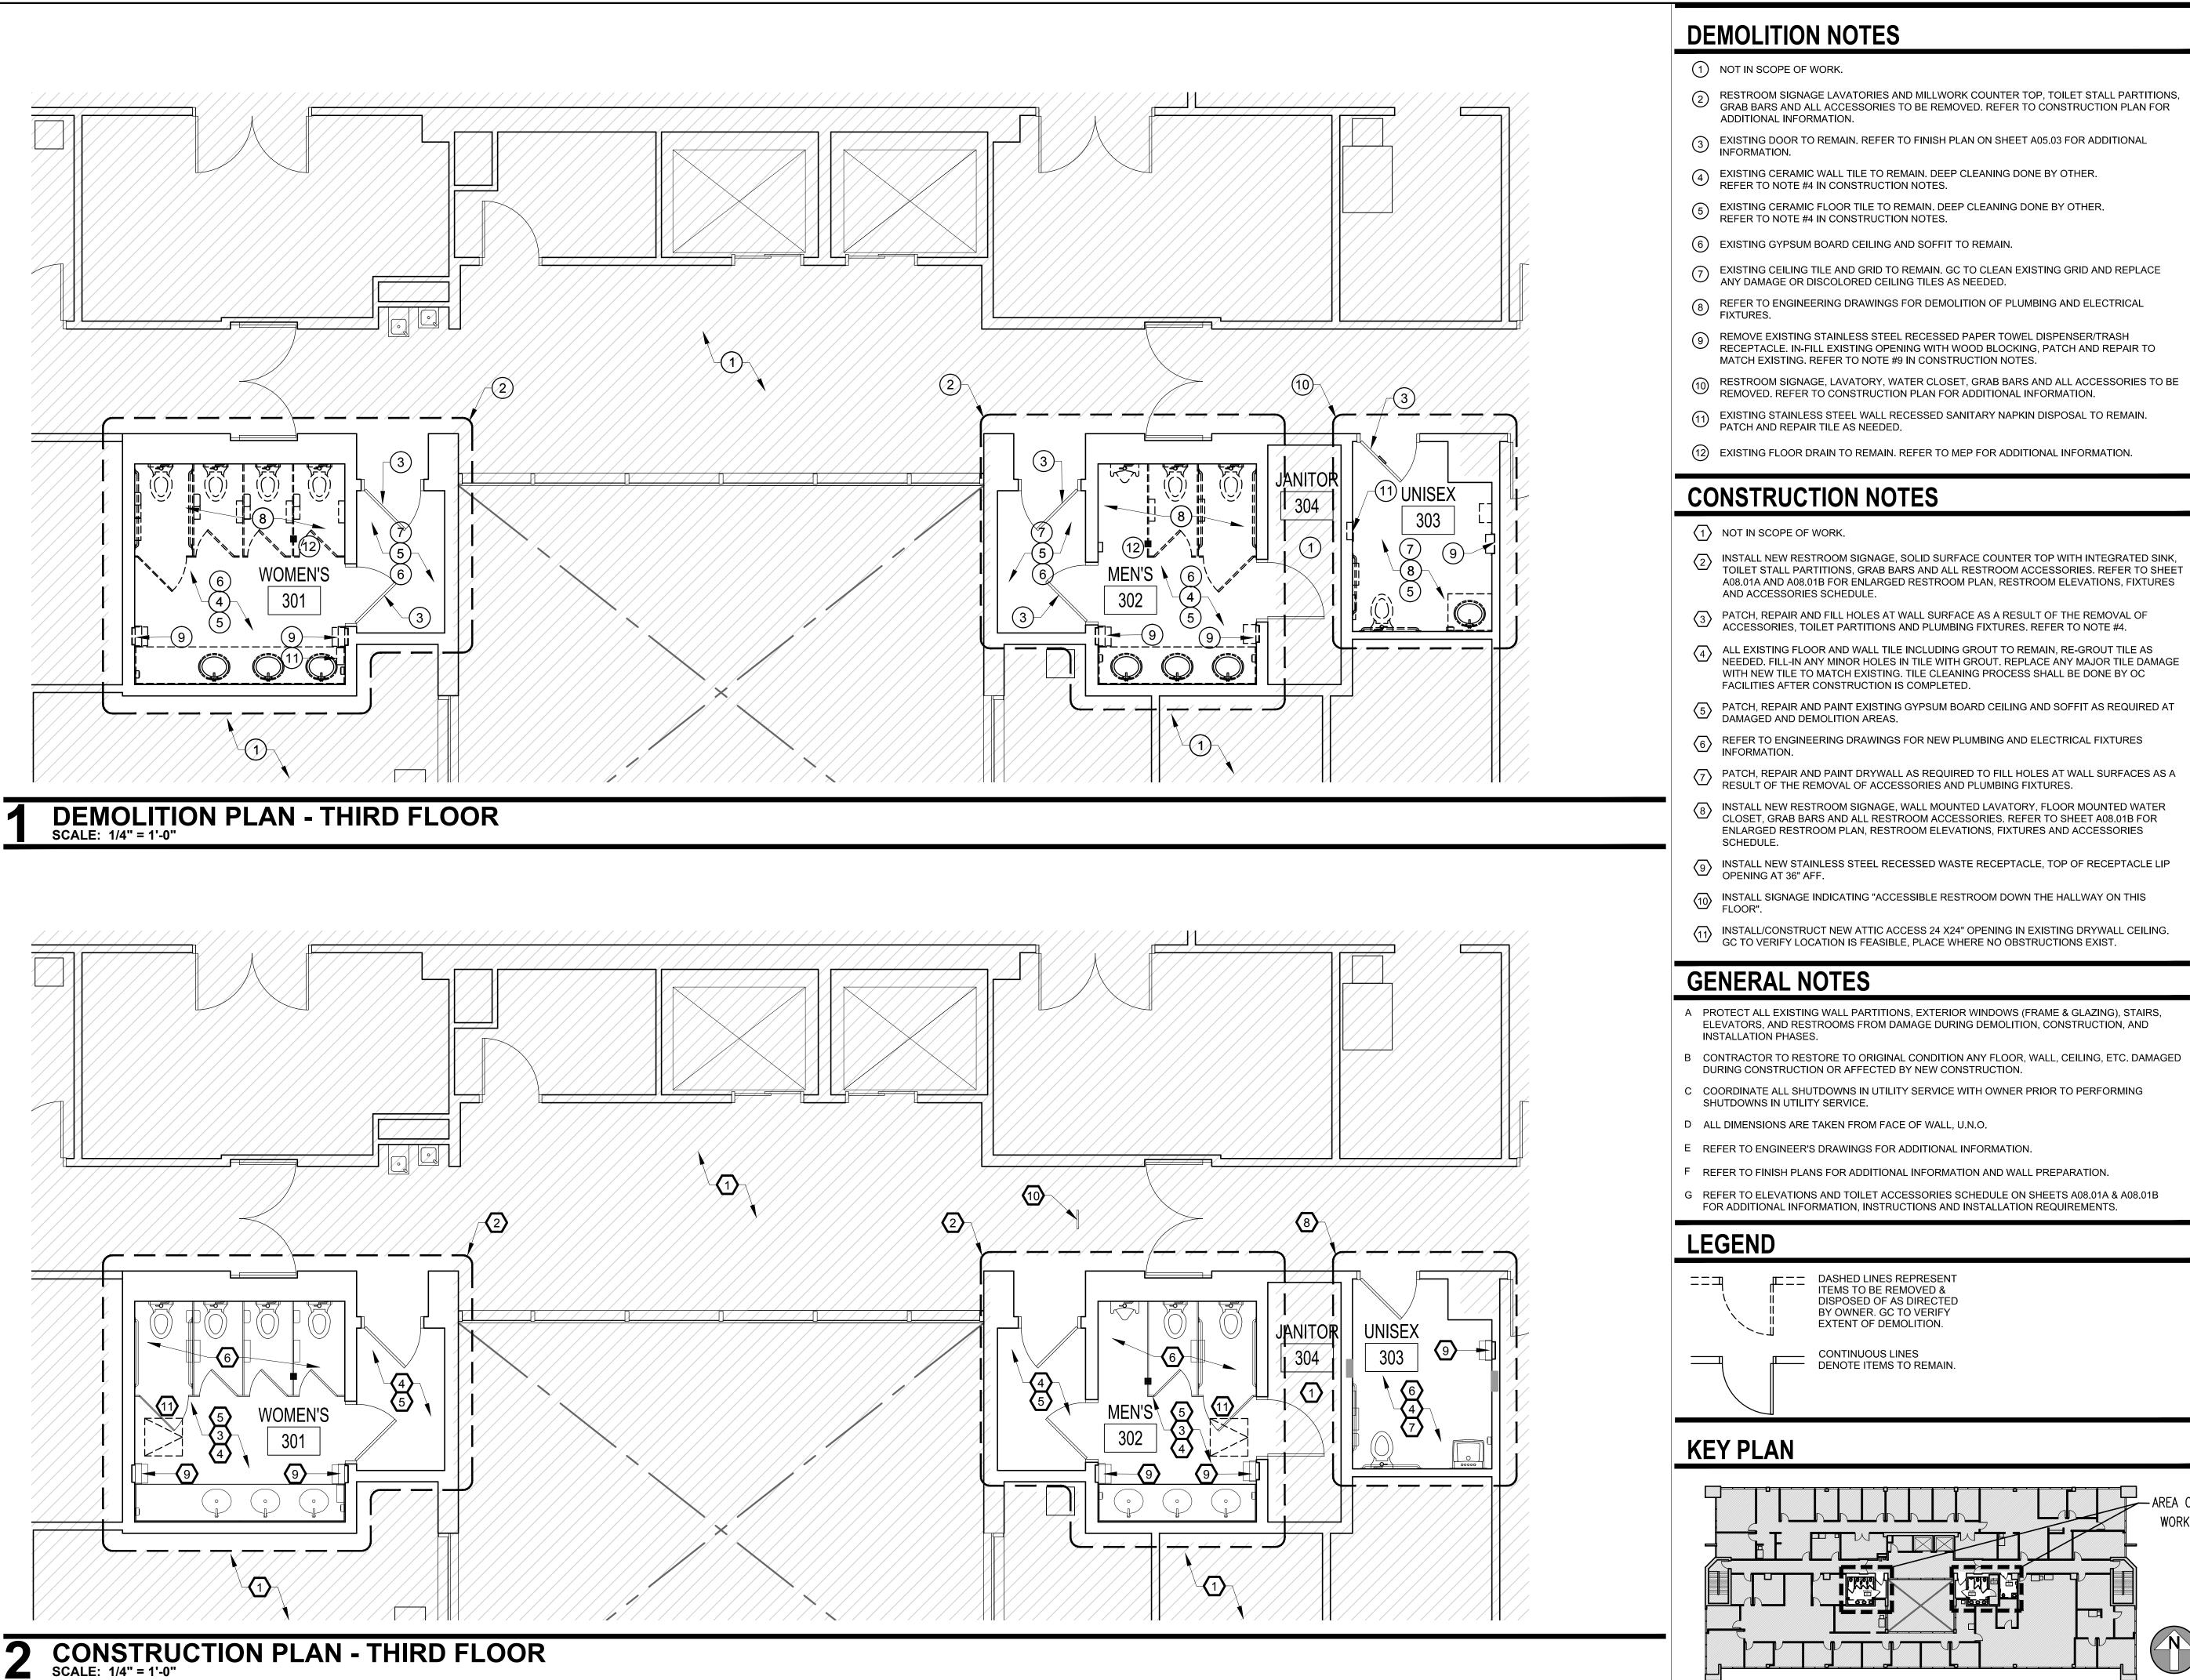
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**DEMO & CONSTRUCTION PLANS** IOC I - 2ND FLOOR

A02.02

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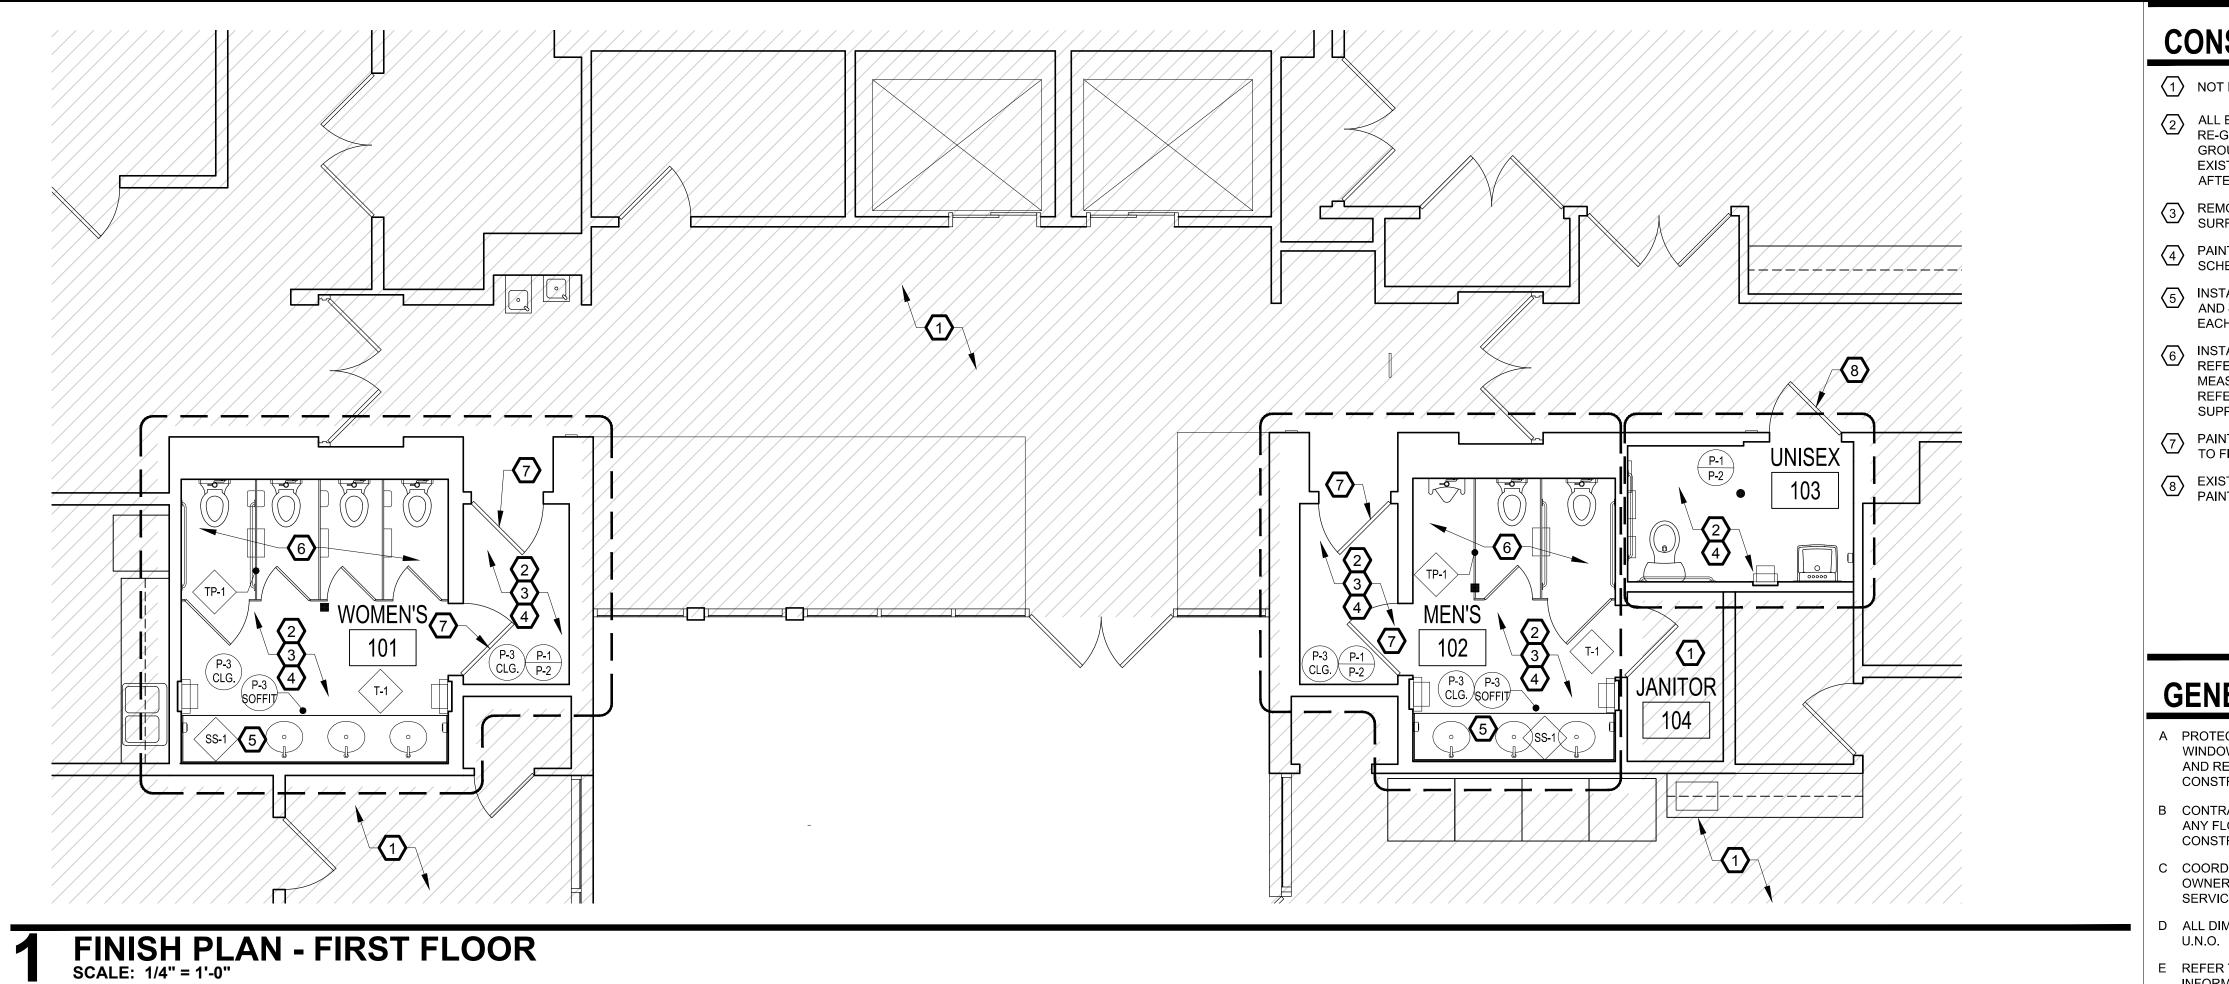
DASHED LINES REPRESENT
ITEMS TO BE REMOVED & DISPOSED OF AS DIRECTED
BY OWNER. GC TO VERIFY
EXTENT OF DEMOLITION.

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	ARCHITE	CTURAL DESIGN (	COLLABORATIV	E
	945 N. PENNSYLVA WINTER PARK, FL	ORIDA 32789		
	OFFICE: (407) 629- FAX: (407) 388-122	1188 0		<b>.</b>
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	STATE OF FLORID		AA-C0	
	ALBERT JOSEPH ( Architect • Seal/Sign		AR-00	10460
	Project Documents	s for:		
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	RESTROOM UP 450 E. SOUTH S	STREET	FLOORS	
	ORLANDO, FL 3	2801		
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### Sheet Title:

**DEMO & CONSTRUCTION PLANS** IOC I - 3RD FLOOR
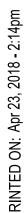
# A02.03



# FINISH SCHEDULE

2	FINISH SCALE:	SCHEDULE				
SS-1	MANUF:	DUPONT	P-1	MANUF:	SHERWIN WILLIAMS	
	STYLE:	CORIAN - PRIVATE COLLECTION		STYLE:	INTERIOR SATIN LATEX	
	COLOR:	WITCH HAZEL		COLOR:	SW9109 NATURAL LINEN	
	AREA:	RESTROOM COUNTER TOPS & 4" BACKSPLASH		AREA:	GENERAL WALL PAINT	
	INSTALLATION:	INTEGRATED SINK BOWL-GLACIER ICE		FINISH:	EGGSHELL FINISH	
	NOTES:	FINISHES ARE NOTED AS THE DESIGN INTENT, GC MY PROVIDE ALTERNATE EQUAL.		NOTES:	FINISHES ARE NOTED AS THE DESIGN INTENT, GC MY PROVIDE ALTERNATE EQUAL. GC TO PAINT MOCK UP FOR FACILITY APPROVAL AFTER NEW LED LIGHTS HAVE BEEN	
TP-1	MANUF:	BRADLEY			INSTALLED. D RATING: CLASS A	
	STYLE:	BRADMAR SOLID PLASTIC (HDPE)		FLAME SPREAL	DRATING. CLASS A	
	COLOR:	LINEN (M242)	P-2	MANUF:	SHERWIN WILLIAMS	
	AREA:	RESTROOM TOILET PARTITIONS		STYLE:	INTERIOR SATIN LATEX	
	INSTALLATION:	CEILING MOUNT		COLOR:	SW6069 FRENCH ROAST	
	NOTES:	FINISHES ARE NOTED AS THE DESIGN INTENT.		AREA:	DOOR, DOOR FRAMES & TRIM ONLY	
	NOTES.	GC MY PROVIDE ALTERNATE EQUAL.		FINISH:	EGGSHELL FINISH	
		PROVIDE HEAVY-DUTY WALL BRACKETS AND DOOR HINGES.			NOTES:	FINISHES ARE NOTED AS THE DESIGN INTENT, GC MY PROVIDE ALTERNATE EQUAL. GC TO PAINT MOCK UP FOR FACILITY APPROVAL AFTER NEW LED LIGHTS HAVE BEEN
T-1	MANUF:	DALTILE			INSTALLED.	
	STYLE:	KEYSTONES - MOSAIC COLORBODY		FLAME SPREAD	D RATING: CLASS A	
	COLOR:	PROCELAIN ALMOND - D335	P-3	MANUF:	SHERWIN WILLIAMS	
	AREA:	WALL TILE		STYLE:	INTERIOR SATIN LATEX	
	SIZE:	2" X 2"		COLOR:	SW7757 HIGH REFLECTIVE WHITE	
	NOTES:	FINISHES ARE NOTED AS THE DESIGN INTENT,		AREA:	CEILING AND SOFFIT ONLY	
		GC MY PROVIDE ALTERNATE EQUAL. GC TO MATCH EXISTING TILE AND GROUT		FINISH:	EGGSHELL FINISH	
		WHERE IN-FILL AND REPLACEMENT IS REQUIRED.		NOTES:	FINISHES ARE NOTED AS THE DESIGN INTENT, GC MY PROVIDE ALTERNATE EQUAL. GC TO PAINT MOCK UP FOR FACILITY APPROVAL AFTER NEW LED LIGHTS HAVE BEEN INSTALLED.	
				FLAME SPREAD	D RATING: CLASS A	

# **CONSTRUCTION NOTES**

 $\left< 1 \right>$  NOT IN SCOPE OF WORK.

ALL EXISTING FLOOR AND WALL TILE INCLUDING GROUT TO REMAIN, RE-GROUT TILE AS NEEDED. FILL-IN ANY MINOR HOLES IN TILE WITH GROUT. REPLACE ANY MAJOR TILE DAMAGE WITH NEW TILE TO MATCH EXISTING. TILE CLEANING PROCESS SHALL BE DONE BY OC FACILITIES AFTER CONSTRUCTION IS COMPLETED.

(3) REMOVE ANY REMAINING WALLCOVERING, SAND, AND SKIM WALL SURFACE FOR A SMOOTH FINISH.

4 PAINT ALL GYPSUM BOARD WALLS, SOFFITS, CEILING. REFER TO FINISH SCHEDULE FOR ADDITIONAL INFORMATION.

5 INSTALL NEW SOLID SURFACE COUNTER TOP WITH INTEGRATED SINKS AND 4" BACKSLASH AND SIDES. VENDOR TO MEASURE AND TEMPLATE EACH RESTROOM BEFORE MANUFACTURING.

6 INSTALL NEW CEILING MOUNTED SOLID PLASTIC TOILET PARTITIONS. REFER TO INTERIOR ELEVATIONS. GC / VENDOR TO VERIFY MEASUREMENTS IN EACH RESTROOM BEFORE MANUFACTURING. REFER TO STRUCTURAL DRAWINGS FOR ADDITIONAL ABOVE CEILING SUPPORT.

7 PAINT EXISTING DOOR AND DOOR FRAMES, SAND AND PRIME. REFER TO FINISH SCHEDULE FOR ADDITIONAL INFORMATION.

8 EXISTING DOOR FINISH TO REMAIN AT UNISEX RESTROOM ONLY. PAINT DOOR FRAME.

# **GENERAL NOTES**

A PROTECT ALL EXISTING WALL PARTITIONS, EXTERIOR WINDOWS (FRAME & GLAZING), STAIRS, ELEVATORS, AND RESTROOMS FROM DAMAGE DURING DEMOLITION, CONSTRUCTION, AND INSTALLATION PHASES.

B CONTRACTOR TO RESTORE TO ORIGINAL CONDITION ANY FLOOR, WALL, CEILING, ETC. DAMAGED DURING CONSTRUCTION OR AFFECTED BY NEW CONSTRUCTION.


C COORDINATE ALL SHUTDOWNS IN UTILITY SERVICE WITH OWNER PRIOR TO PERFORMING SHUTDOWNS IN UTILITY SERVICE.

D ALL DIMENSIONS ARE TAKEN FROM FACE OF WALL,


E REFER TO INTERIOR ELEVATIONS FOR ADDITIONAL INFORMATION.

		DESIGN COLLABORATIVE
	945 N. PENNSYLVANIA AVE WINTER PARK, FLORIDA 32	
	OFFICE: (407) 629-1188 FAX: (407) 388-1220 WWW. ADCINTERNATIONAL	
	WWW. ADCINTERNATIONAL	
		AR0010460
		ERED ARCINUS
	STATE OF FLORIDA ALBERT JOSEPH COOPER I	AA-C001315 II, R.A. AR-0010460
	Architect   Seal/Signature	
	Project Documents for:	
	<b>A</b> R	ANGE
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	Project: INTERNAL OPERATION	
	RESTROOM UPGRADE 450 E. SOUTH STREET	S - ALL FLOORS
	ORLANDO, FL 32801	
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	Client Information ORANGE COUNTY CAP 400 E SOUTH STREET 5th FI ORLANDO, FL 32801 Project Number 16319 Drawn By PG / JS Checked By AC File Name X:\dwgs\16319 IOC I-II Restro A05.01_IOC I_ FINISH PLAN.	LOOR Issue Date 04/27/2018 Project Status PERMIT ISSUE SET Scale 1/4"=1'-0"
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.

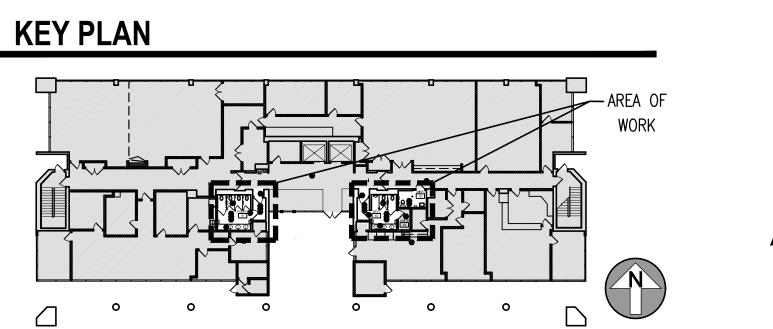

A05.01

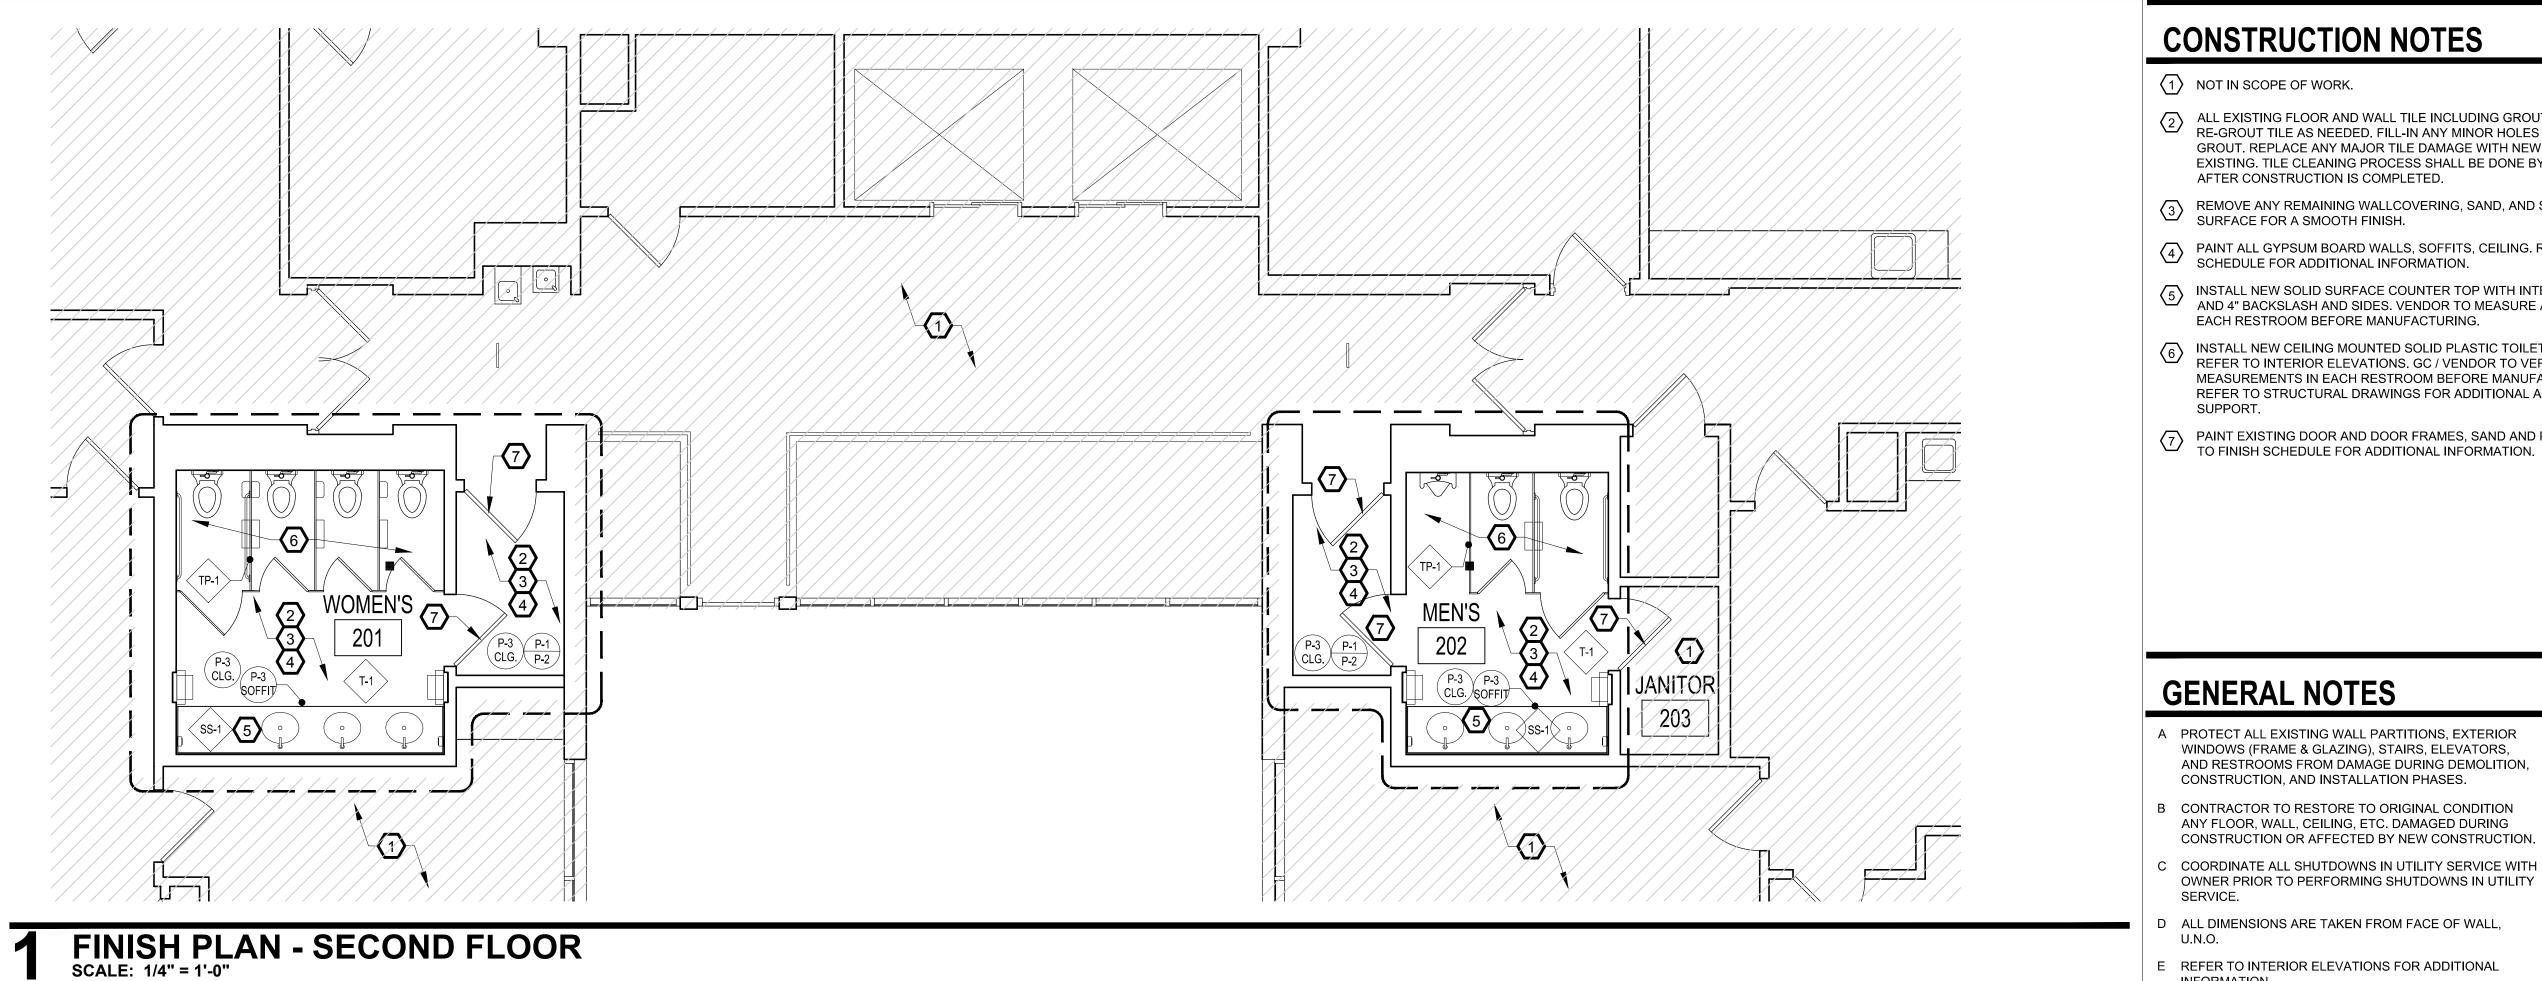

# FINISH SCHEDULE

2	FINISH SCALE:	SCHEDULE			
SS-1	MANUF:	DUPONT	P-1	MANUF:	SHERWIN WILLIAMS
	STYLE:	CORIAN - PRIVATE COLLECTION		STYLE:	INTERIOR SATIN LATEX
	COLOR:	WITCH HAZEL		COLOR:	SW9109 NATURAL LINEN
	AREA:	RESTROOM COUNTER TOPS & 4" BACKSPLASH		AREA:	GENERAL WALL PAINT
	INSTALLATION:	INTEGRATED SINK BOWL-GLACIER ICE		FINISH:	EGGSHELL FINISH
	NOTES:	FINISHES ARE NOTED AS THE DESIGN INTENT, GC MY PROVIDE ALTERNATE EQUAL.		NOTES:	FINISHES ARE NOTED AS THE DESIGN INTENT, GC MY PROVIDE ALTERNATE EQUAL. GC TO PAINT MOCK UP FOR FACILITY APPROVAL AFTER NEW LED LIGHTS HAVE BEEN
TP-1	MANUF:	BRADLEY			INSTALLED. D RATING: CLASS A
	STYLE:	BRADMAR SOLID PLASTIC (HDPE)		T LAWL OF REAL	CRATING. CLASS A
	COLOR:	LINEN (M242)	P-2	MANUF:	SHERWIN WILLIAMS
	AREA:	RESTROOM TOILET PARTITIONS		STYLE:	INTERIOR SATIN LATEX
	INSTALLATION:	CEILING MOUNT		COLOR:	SW6069 FRENCH ROAST
	NOTES:	FINISHES ARE NOTED AS THE DESIGN INTENT,		AREA:	DOOR, DOOR FRAMES & TRIM ONLY
	NOTEO.	GC MY PROVIDE ALTERNATE EQUAL. PROVIDE HEAVY-DUTY WALL BRACKETS AND DOOR HINGES.		FINISH: NOTES:	EGGSHELL FINISH FINISHES ARE NOTED AS THE DESIGN INTENT,
				Notes.	GC MY PROVIDE ALTERNATE EQUAL. GC TO PAINT MOCK UP FOR FACILITY APPROVAL AFTER NEW LED LIGHTS HAVE BEEN
T-1	MANUF:	DALTILE			INSTALLED.
	STYLE:	KEYSTONES - MOSAIC COLORBODY PROCELAIN		FLAME SPREAD	D RATING: CLASS A
	COLOR:	ALMOND - D335	P-3	MANUF:	SHERWIN WILLIAMS
	AREA:	WALL TILE		STYLE:	INTERIOR SATIN LATEX
	SIZE:	2" X 2"		COLOR:	SW7757 HIGH REFLECTIVE WHITE
	NOTES:	FINISHES ARE NOTED AS THE DESIGN INTENT,		AREA:	CEILING AND SOFFIT ONLY
		GC MY PROVIDE ALTERNATE EQUAL. GC TO MATCH EXISTING TILE AND GROUT		FINISH:	EGGSHELL FINISH
		WHERE IN-FILL AND REPLACEMENT IS REQUIRED.		NOTES:	FINISHES ARE NOTED AS THE DESIGN INTENT, GC MY PROVIDE ALTERNATE EQUAL. GC TO PAINT MOCK UP FOR FACILITY APPROVAL AFTER NEW LED LIGHTS HAVE BEEN INSTALLED.
				FLAWE SPREAL	D RATING: CLASS A

E REFER TO INTERIOR ELEVATIONS FOR ADDITIONAL INFORMATION.





# **CONSTRUCTION NOTES**

1 NOT IN SCOPE OF WORK.

ALL EXISTING FLOOR AND WALL TILE INCLUDING GROUT TO REMAIN, RE-GROUT TILE AS NEEDED. FILL-IN ANY MINOR HOLES IN TILE WITH GROUT. REPLACE ANY MAJOR TILE DAMAGE WITH NEW TILE TO MATCH EXISTING. TILE CLEANING PROCESS SHALL BE DONE BY OC FACILITIES AFTER CONSTRUCTION IS COMPLETED.

(3) REMOVE ANY REMAINING WALLCOVERING, SAND, AND SKIM WALL SURFACE FOR A SMOOTH FINISH.

4 PAINT ALL GYPSUM BOARD WALLS, SOFFITS, CEILING. REFER TO FINISH SCHEDULE FOR ADDITIONAL INFORMATION.

5 INSTALL NEW SOLID SURFACE COUNTER TOP WITH INTEGRATED SINKS AND 4" BACKSLASH AND SIDES. VENDOR TO MEASURE AND TEMPLATE EACH RESTROOM BEFORE MANUFACTURING.

6 INSTALL NEW CEILING MOUNTED SOLID PLASTIC TOILET PARTITIONS. REFER TO INTERIOR ELEVATIONS. GC / VENDOR TO VERIFY MEASUREMENTS IN EACH RESTROOM BEFORE MANUFACTURING. REFER TO STRUCTURAL DRAWINGS FOR ADDITIONAL ABOVE CEILING SUPPORT.

7 PAINT EXISTING DOOR AND DOOR FRAMES, SAND AND PRIME. REFER TO FINISH SCHEDULE FOR ADDITIONAL INFORMATION.

# ARCHITECTURAL DESIGN COLLABORATIVE 945 N. PENNSYLVANIA AVENUE WINTER PARK, FLORIDA 32789 OFFICE: (407) 629-1188 FAX: (407) 388-1220 WWW. ADCINTERNATIONAL.NE AA-C001315 STATE OF FLORIDA ALBERT JOSEPH COOPER III, R.A. AR-0010460 Architect Seal/Signature Project Documents for: FLORIDA Project: INTERNAL OPERATIONS CENTER - I RESTROOM UPGRADES - ALL FLOORS 450 E. SOUTH STREET ORLANDO, FL 32801 Issue Date & Issue Description Drawn By Checked By 60% CD SET PG/JS MF 04.28.17 08.25.17 90% CD SET PG/JS MF PG/JS AC 10.16.17 100% CD SET 04.27.18 PERMIT SET PG/JS AC Client Information ORANGE COUNTY CAPITAL PROJECTS DIVISION 400 E SOUTH STREET 5th FLOOR ORLANDO, FL 32801 Project Number Issue Date 16319 Drawn By 04/27/2018 Project Status PG / JS **Checked By** PERMIT ISSUE SET Scale 1/4"=1'-0" AC File Name X:\dwgs\16319 IOC I-II Restrooms\CAD\IOC-I\SHEETS\ A05.02\_IOC I\_ FINISH PLAN.dwg


Consultant • Seal/Signature

Sheet Title:

**KEY PLAN** - AREA OF WORK ο 0 0 0 0 0  $\square$ 

FINISH PLAN IOC I - 2ND FLOOR

# A05.02

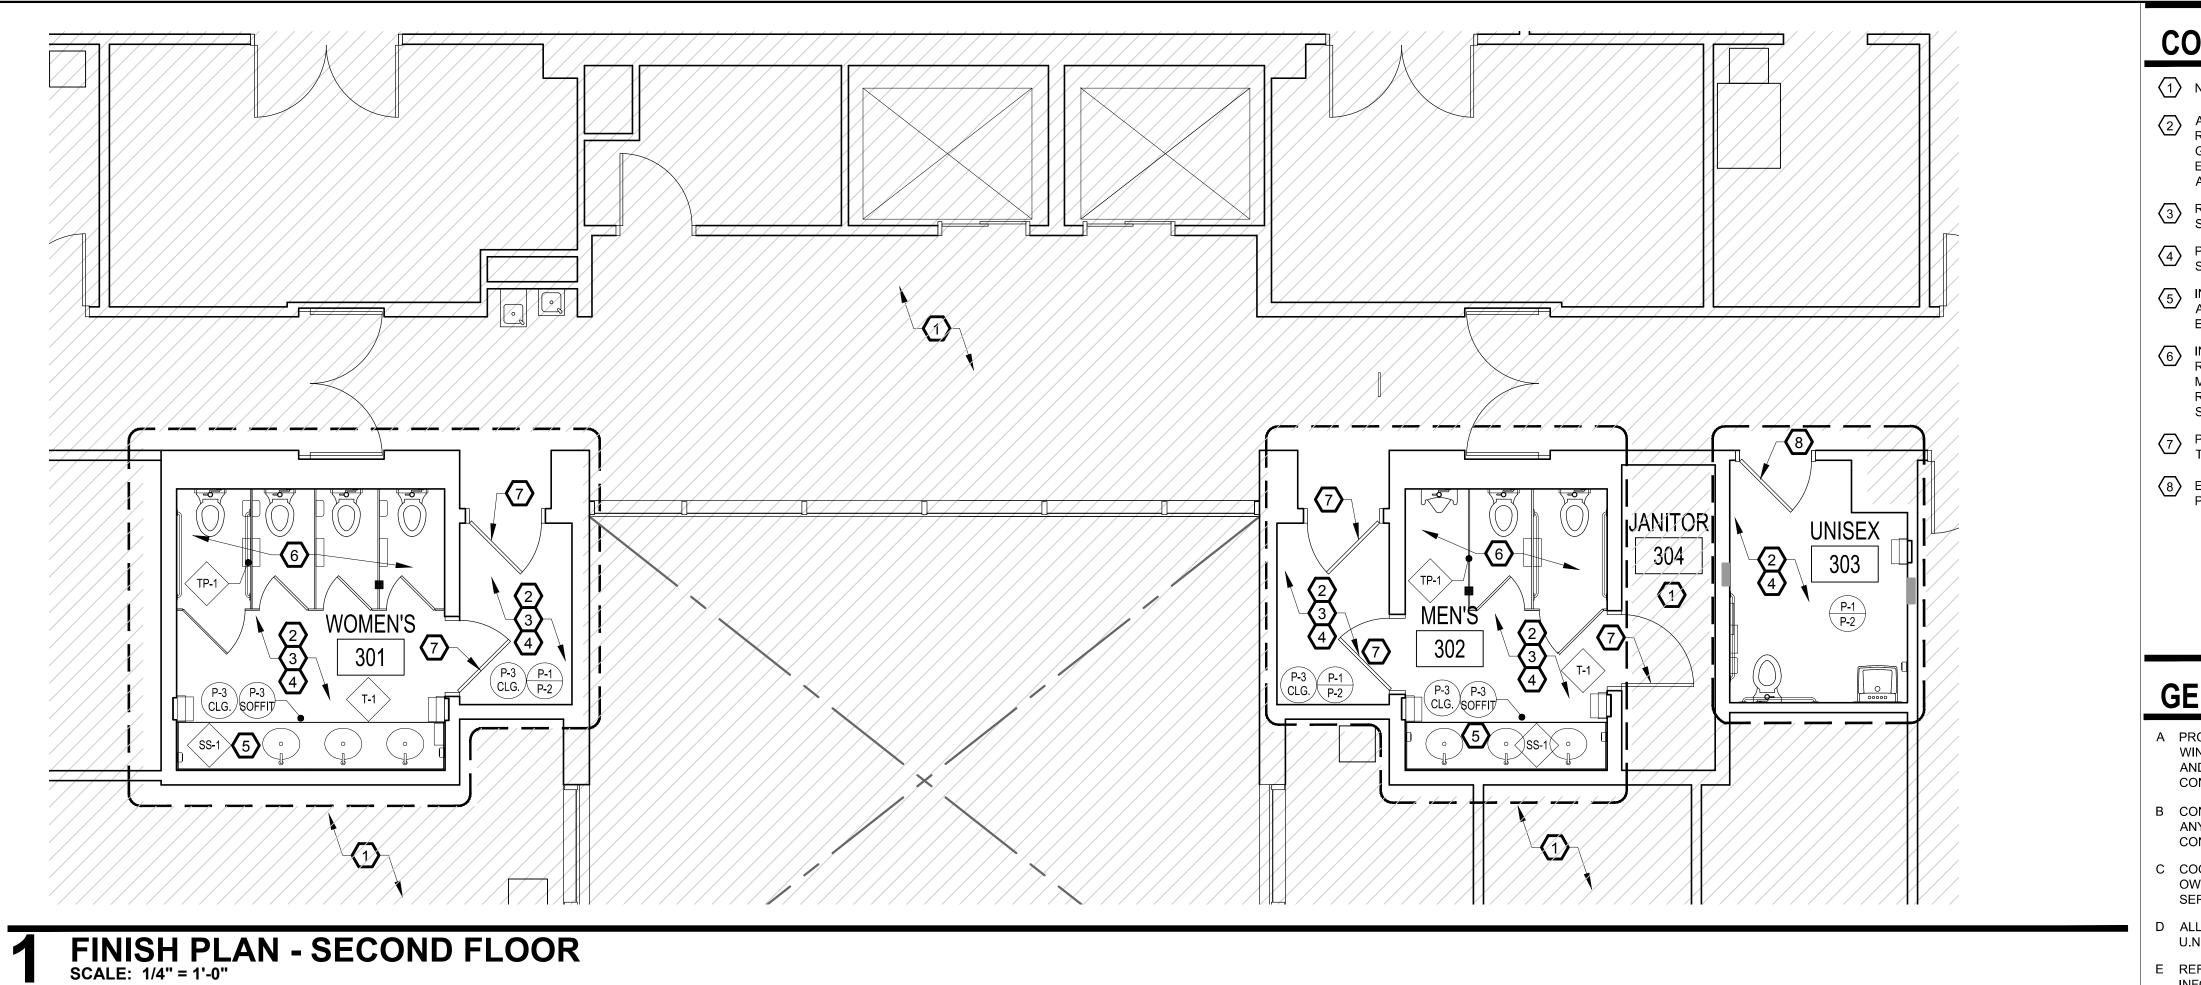


# 2 FINISH SCHEDULE SCALE:

	SCALE:				
 SS-1	MANUF: STYLE: COLOR: AREA: INSTALLATION: NOTES:	DUPONT CORIAN - PRIVATE COLLECTION WITCH HAZEL RESTROOM COUNTER TOPS & 4" BACKSPLASH INTEGRATED SINK BOWL-GLACIER ICE FINISHES ARE NOTED AS THE DESIGN INTENT,	P-1	MANUF: STYLE: COLOR: AREA: FINISH: NOTES:	SHERWIN WILLIAMS INTERIOR SATIN LATEX SW9109 NATURAL LINEN GENERAL WALL PAINT EGGSHELL FINISH FINISHES ARE NOTED AS THE DESIGN INTENT,
TP-1	MANUF: STYLE:	GC MY PROVIDE ALTERNATE EQUAL. BRADLEY BRADMAR SOLID PLASTIC (HDPE)		FLAME SPREAD	GC MY PROVIDE ALTERNATE EQUAL. GC TO PAINT MOCK UP FOR FACILITY APPROVAL AFTER NEW LED LIGHTS HAVE BEEN INSTALLED. PRATING: CLASS A
	COLOR:	LINEN (M242)	P-2	MANUF:	SHERWIN WILLIAMS
	AREA:	RESTROOM TOILET PARTITIONS		STYLE:	INTERIOR SATIN LATEX
	INSTALLATION:	CEILING MOUNT		COLOR:	SW6069 FRENCH ROAST
	NOTES:	FINISHES ARE NOTED AS THE DESIGN INTENT,		AREA:	DOOR, DOOR FRAMES & TRIM ONLY
	NOTEO.	GC MY PROVIDE ALTERNATE EQUAL.		FINISH: NOTES:	EGGSHELL FINISH FINISHES ARE NOTED AS THE DESIGN INTENT,
		PROVIDE HEAVY-DUTY WALL BRACKETS AND DOOR HINGES.		NOTES.	GC MY PROVIDE ALTERNATE EQUAL. GC TO PAINT MOCK UP FOR FACILITY APPROVAL AFTER NEW LED LIGHTS HAVE BEEN
T-1	MANUF:	DALTILE			INSTALLED.
	STYLE:	KEYSTONES - MOSAIC COLORBODY PROCELAIN		FLAME SPREAD	) RATING: CLASS A
	COLOR:	ALMOND - D335	P-3	MANUF:	SHERWIN WILLIAMS
	AREA:	WALL TILE		STYLE:	INTERIOR SATIN LATEX
	SIZE:	2" X 2"		COLOR:	SW7757 HIGH REFLECTIVE WHITE
	NOTES:	FINISHES ARE NOTED AS THE DESIGN INTENT,		AREA:	CEILING AND SOFFIT ONLY
		GC MY PROVIDE ALTERNATE EQUAL.		FINISH:	EGGSHELL FINISH
		GC TO MATCH EXISTING TILE AND GROUT WHERE IN-FILL AND REPLACEMENT IS REQUIRED.		NOTES: FLAME SPREAD	FINISHES ARE NOTED AS THE DESIGN INTENT, GC MY PROVIDE ALTERNATE EQUAL. GC TO PAINT MOCK UP FOR FACILITY APPROVAL AFTER NEW LED LIGHTS HAVE BEEN INSTALLED. D RATING: CLASS A

RINTED ON: Apr 23, 2018 - 2:16pm

U.N.O. E REFER TO INTERIOR ELEVATIONS FOR ADDITIONAL INFORMATION.

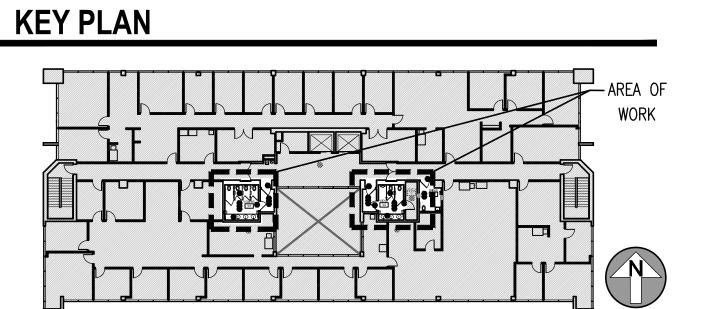

# **CONSTRUCTION NOTES**

1 NOT IN SCOPE OF WORK.

ALL EXISTING FLOOR AND WALL TILE INCLUDING GROUT TO REMAIN, RE-GROUT TILE AS NEEDED. FILL-IN ANY MINOR HOLES IN TILE WITH GROUT. REPLACE ANY MAJOR TILE DAMAGE WITH NEW TILE TO MATCH EXISTING. TILE CLEANING PROCESS SHALL BE DONE BY OC FACILITIES AFTER CONSTRUCTION IS COMPLETED.

3 REMOVE ANY REMAINING WALLCOVERING, SAND, AND SKIM WALL SURFACE FOR A SMOOTH FINISH.

A PAINT ALL GYPSUM BOARD WALLS, SOFFITS, CEILING. REFER TO FINISH SCHEDULE FOR ADDITIONAL INFORMATION.

5 INSTALL NEW SOLID SURFACE COUNTER TOP WITH INTEGRATED SINKS AND 4" BACKSLASH AND SIDES. VENDOR TO MEASURE AND TEMPLATE EACH RESTROOM BEFORE MANUFACTURING.

6 INSTALL NEW CEILING MOUNTED SOLID PLASTIC TOILET PARTITIONS. REFER TO INTERIOR ELEVATIONS. GC / VENDOR TO VERIFY MEASUREMENTS IN EACH RESTROOM BEFORE MANUFACTURING. REFER TO STRUCTURAL DRAWINGS FOR ADDITIONAL ABOVE CEILING SUPPORT.

PAINT EXISTING DOOR AND DOOR FRAMES, SAND AND PRIME. REFERTO FINISH SCHEDULE FOR ADDITIONAL INFORMATION.

8 EXISTING DOOR FINISH TO REMAIN AT UNISEX RESTROOM ONLY. PAINT DOOR FRAME.

# **GENERAL NOTES**

A PROTECT ALL EXISTING WALL PARTITIONS, EXTERIOR WINDOWS (FRAME & GLAZING), STAIRS, ELEVATORS, AND RESTROOMS FROM DAMAGE DURING DEMOLITION, CONSTRUCTION, AND INSTALLATION PHASES.


B CONTRACTOR TO RESTORE TO ORIGINAL CONDITION ANY FLOOR, WALL, CEILING, ETC. DAMAGED DURING CONSTRUCTION OR AFFECTED BY NEW CONSTRUCTION.

C COORDINATE ALL SHUTDOWNS IN UTILITY SERVICE WITH OWNER PRIOR TO PERFORMING SHUTDOWNS IN UTILITY SERVICE.


D ALL DIMENSIONS ARE TAKEN FROM FACE OF WALL, U.N.O.

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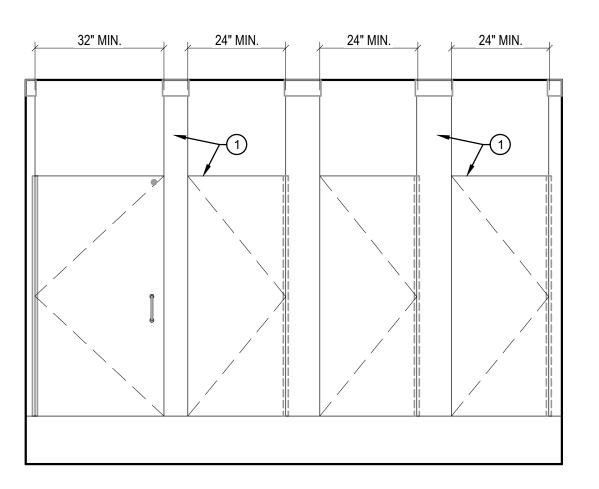
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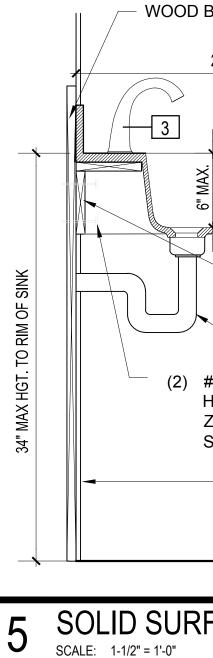


PRINTED ON: Apr 23, 2018 - 2:18pm

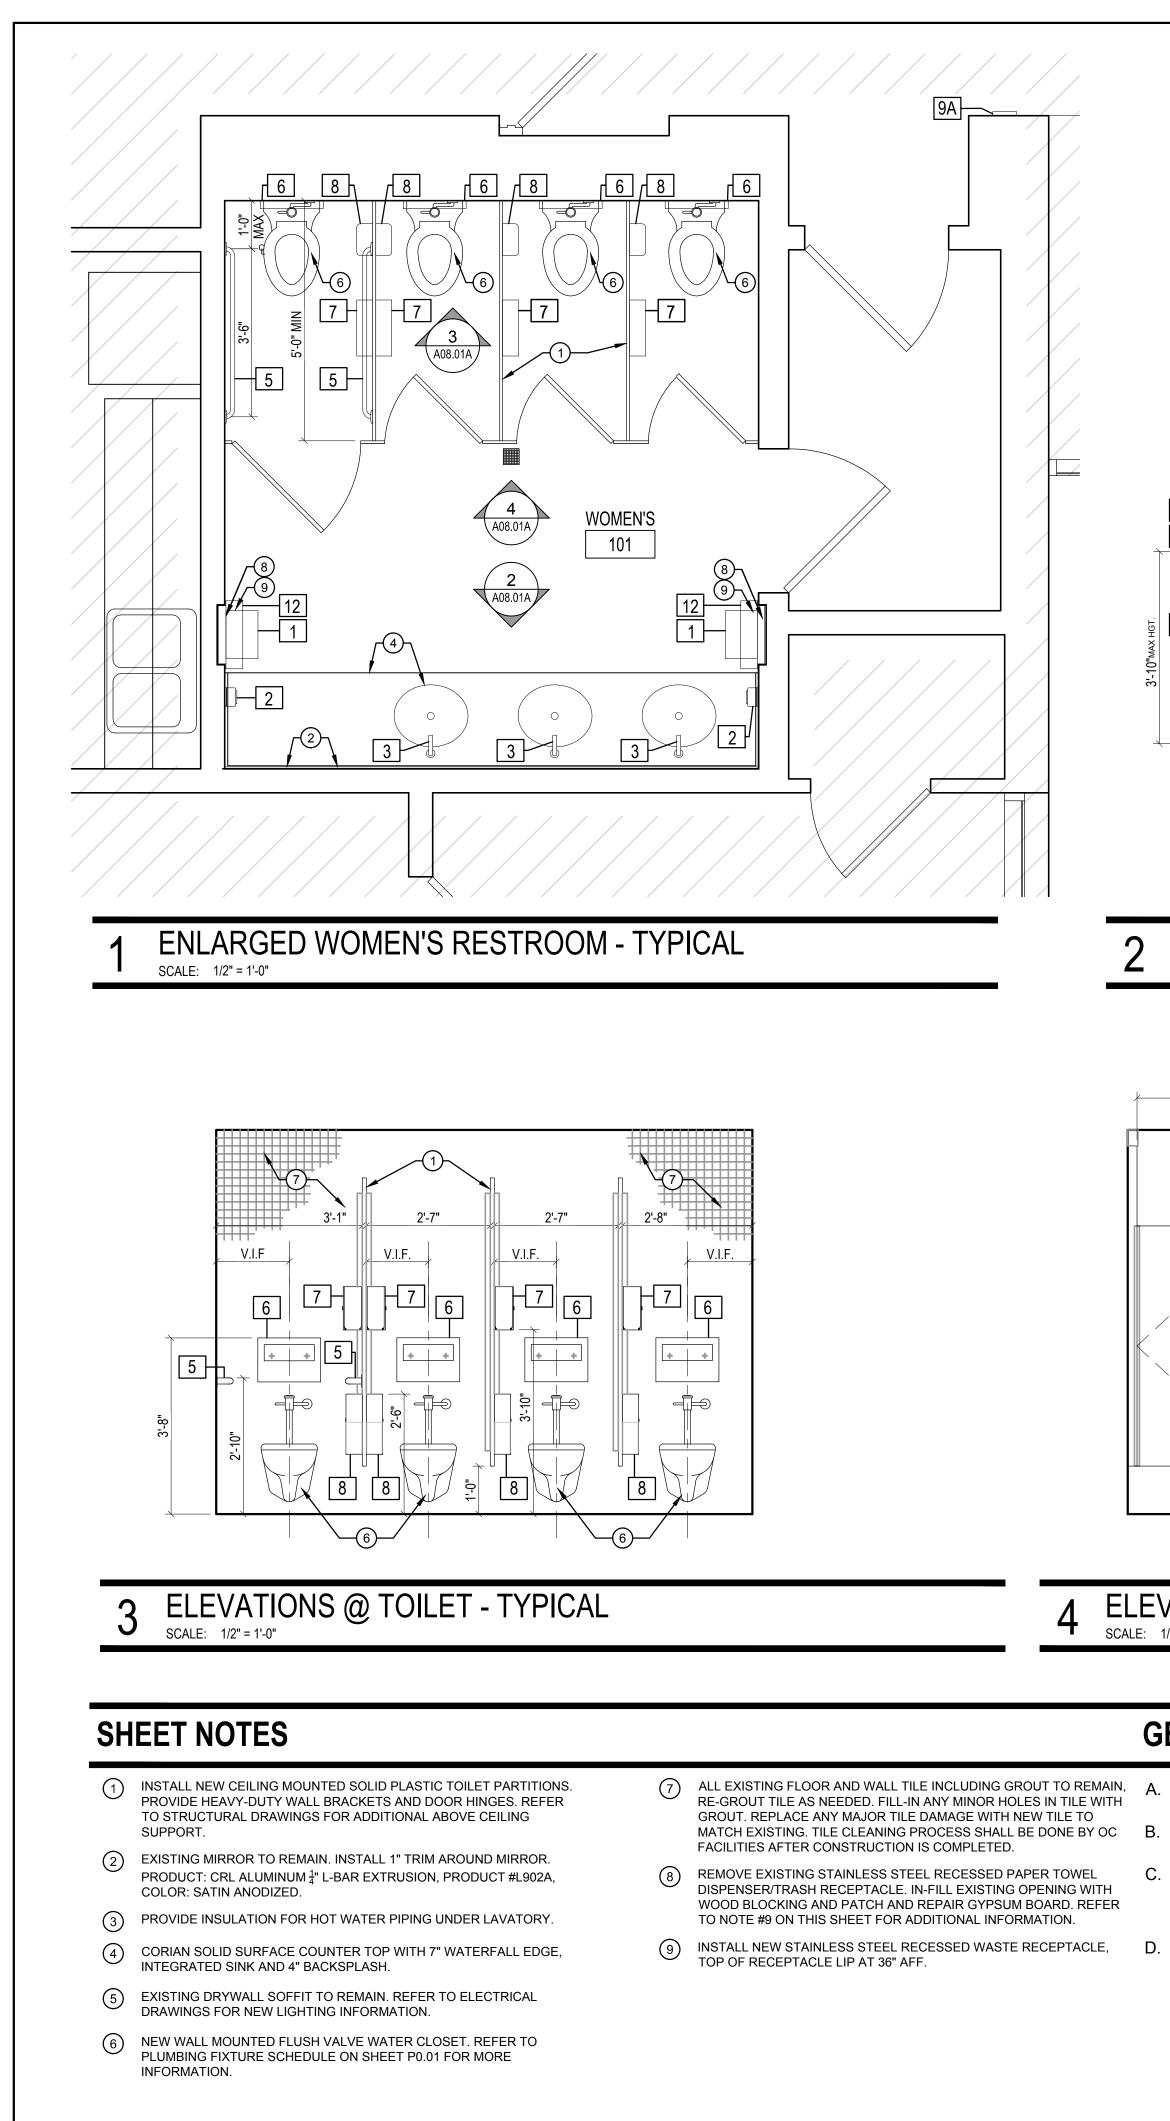

# 2 ELEVATIONS @ SINK - TYPICAL SCALE: 1/2" = 1'-0"

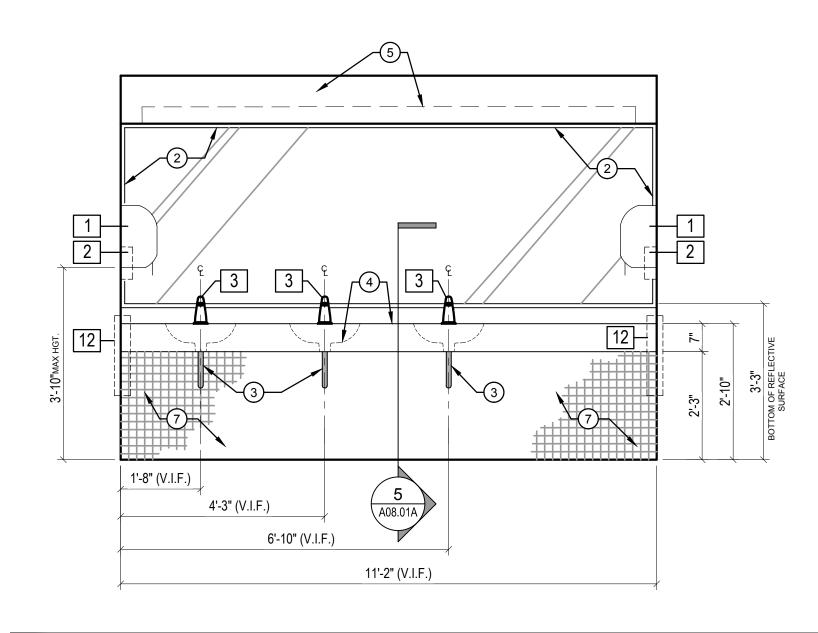



# 4 ELEVATIONS @ TOILET PARTITIONS - TYPICAL SCALE: 1/2" = 1'-0"

# GENERAL NOTES


- A. REFER TO SHEET A00.40 MOUNTING HEIGHTS AND DETAIL INFORMATION.
- 3. REFER TO ELECTRICAL AND PLUMBING DRAWINGS FOR ADDITIONAL INFORMATION.
- C. CONTRACTOR TO PROVIDE IN WALL BLOCKING FOR RESTROOM ACCESSORIES, SOLID SURFACE COUNTER, SINK AND TOILET AS REQUIRED.
- D. USE WATER RESISTANT GYPSUM BOARD BEHIND SINKS AND TOILETS AS REQUIRED WHEN PATCHING AND REPAIRING EXISTING WALL.

# **TOILET ACCESSORIES SCHEDULE**

	MANUFACTURE	ITEM	TAG
86800	WAUSAU	OPTISERV - PAPER TOWEL DISPENSER	1
1919-04	GOJO	GOJO LXT-12 SOAP DISPENSER - TOUCH FREE	2
Z6913-XL	ZURN	ZURN AQUASENSE BATTERY POWERED FAUCET	3
B-5806 x 36	BOBRICK	GRAB BAR, 36" LONG (UNISEX ADA RESTROOM ONLY)	4
B-5806 x 42	BOBRICK	GRAB BAR, 42" LONG	5
B-221	BOBRICK	SEAT COVER DISPENSER	6
88400	WAUSAU	TOILET PAPER DISPENSER	7
B-254	BOBRICK	SANITARY NAPKIN DISPOSAL (WOMEN'S & UNISEX RR ONLY)	8
5303	EAGLESTONE OR EQ.	RESTROOM SIGN - WOMEN	9A
5301	EAGLESTONE OR EQ.	RESTROOM SIGN - MEN	9B
5306	EAGLESTONE OR EQ.	RESTROOM SIGN - UNISEX ACCESSIBLE	10
B-165-2436	BOBRICK	MIRROR (UNISEX ADA RESTROOM ONLY)	11
B-3644	BOBRICK	RECESSED WASTE RECEPTACLE	12


NOTE: GC TO WALK EACH FLOOR AND EACH RESTROOM TO INVENTORY EXISTING ACCESSORIES. IF E ONSITE; REMOVE AND SAVE ALL ACCESSORIES THAT ARE IN GOOD CONDITION INORDER TO RE-INS REPLACE / ORDER NEW ACCESSORIES THAT ARE DAMAGED OR NOT APPROVED ORANGE COUNTY


	ARCHITECTURAL DESIGN COLLABORATIVE 945 N. PENNSYLVANIA AVENUE WINTER PARK, FLORIDA 32789 OFFICE: (407) 629-1188 FAX: (407) 388-1220 WWW. ADCINTERNATIONAL.NET STATE OF FLORIDA AA-CO01315 ALBERT JOSEPH COOPER III, R.A. AA-C001315 AR-0010460 AR-0010460
	Project Documents for:         ORANGE COUNTER         COUNTER         F L O R I D A         Project:         INTERNAL OPERATIONS CENTER - I         RESTROOM UPGRADES - ALL FLOORS         450 E. SOUTH STREET         ORLANDO, FL 32801         Issue Date & Issue Description         Drawn By Checked By         04.28.17         06% CD SET         PG / JS
	08.25.17         90% CD SET         PG / JS         MF           10.16.17         100% CD SET         PG / JS         AC           04.27.18         PERMIT SET         PG / JS         AC
BLOCKING AS REQUIRED	
24" CORIAN SOLID SURFACE COUNTER TOP WITH WATER EDGE, BACKSPLASH AND INTEGRATED SINK NOTE: FIELD MEASURE FO COUNTER TOP LENG REFER TO INTERIOR	RFALL
ELEVATIONS FOR D SPECS. PROVIDE SUPPORT BRACKETS AT OPENING FOR SINK DRAIN #10 X 2 <sup>1</sup> / <sub>2</sub> " HEAVY DUTY ZINC WOOD SCREW INSULATED PIPING AS REQUIRED BY CODE	Project Number     Issue Date       16319     04/27/2018       Drawn By     Project Status       PG / JS     PERMIT ISSUE SET       Checked By     Scale       AC     Ac   File Name X:\dwgs\16319 IOC I-II Restrooms\CAD\IOC-I\SHEETS\ A08.01A_IOC I_INTERIOR ELEVATIONS.dwg
EXISTING WALL TILE	
	Consultant • Seal/Signature
FACE COUNTER TOP W/ ADA ACCES	SS
HEDULE	
MODEL NO.     REMARKS       BLACK TRANSLUCENT     BLACK AND SILVER	Sheet Title: ENLARGED RESTROOM PLAN
CHROME COLOR, BATTERY POWERED FAUCET SATIN STAINLESS STEEL SATIN STAINLESS STEEL STAINLESS STEEL SURFACE MOUNTED SILHOUETTE WAGON WHEEL DISPENSER, TRANSLUCENT SMOKE WOMEN'S & UNISEX RESTROOM ONLY; SATIN FINISH STAINLESS WHITE ON BLACK	
WHITE ON BLACK WHITE ON BLACK	
6 MIRROR WITH STAINLESS STEEL CHANNEL FRAME SATIN STAINLESS STEEL - TOP OF RECEPTACLE LIP SHOULD BE	@ 36" AFF <b>A08.01A</b>
BRAND NEW ACCESSORY ALREADY EXISTS ISTALL AFTER CONSTRUCTION IS COMPLETE. Y STANDARD'S AS LISTED ABOVE.	

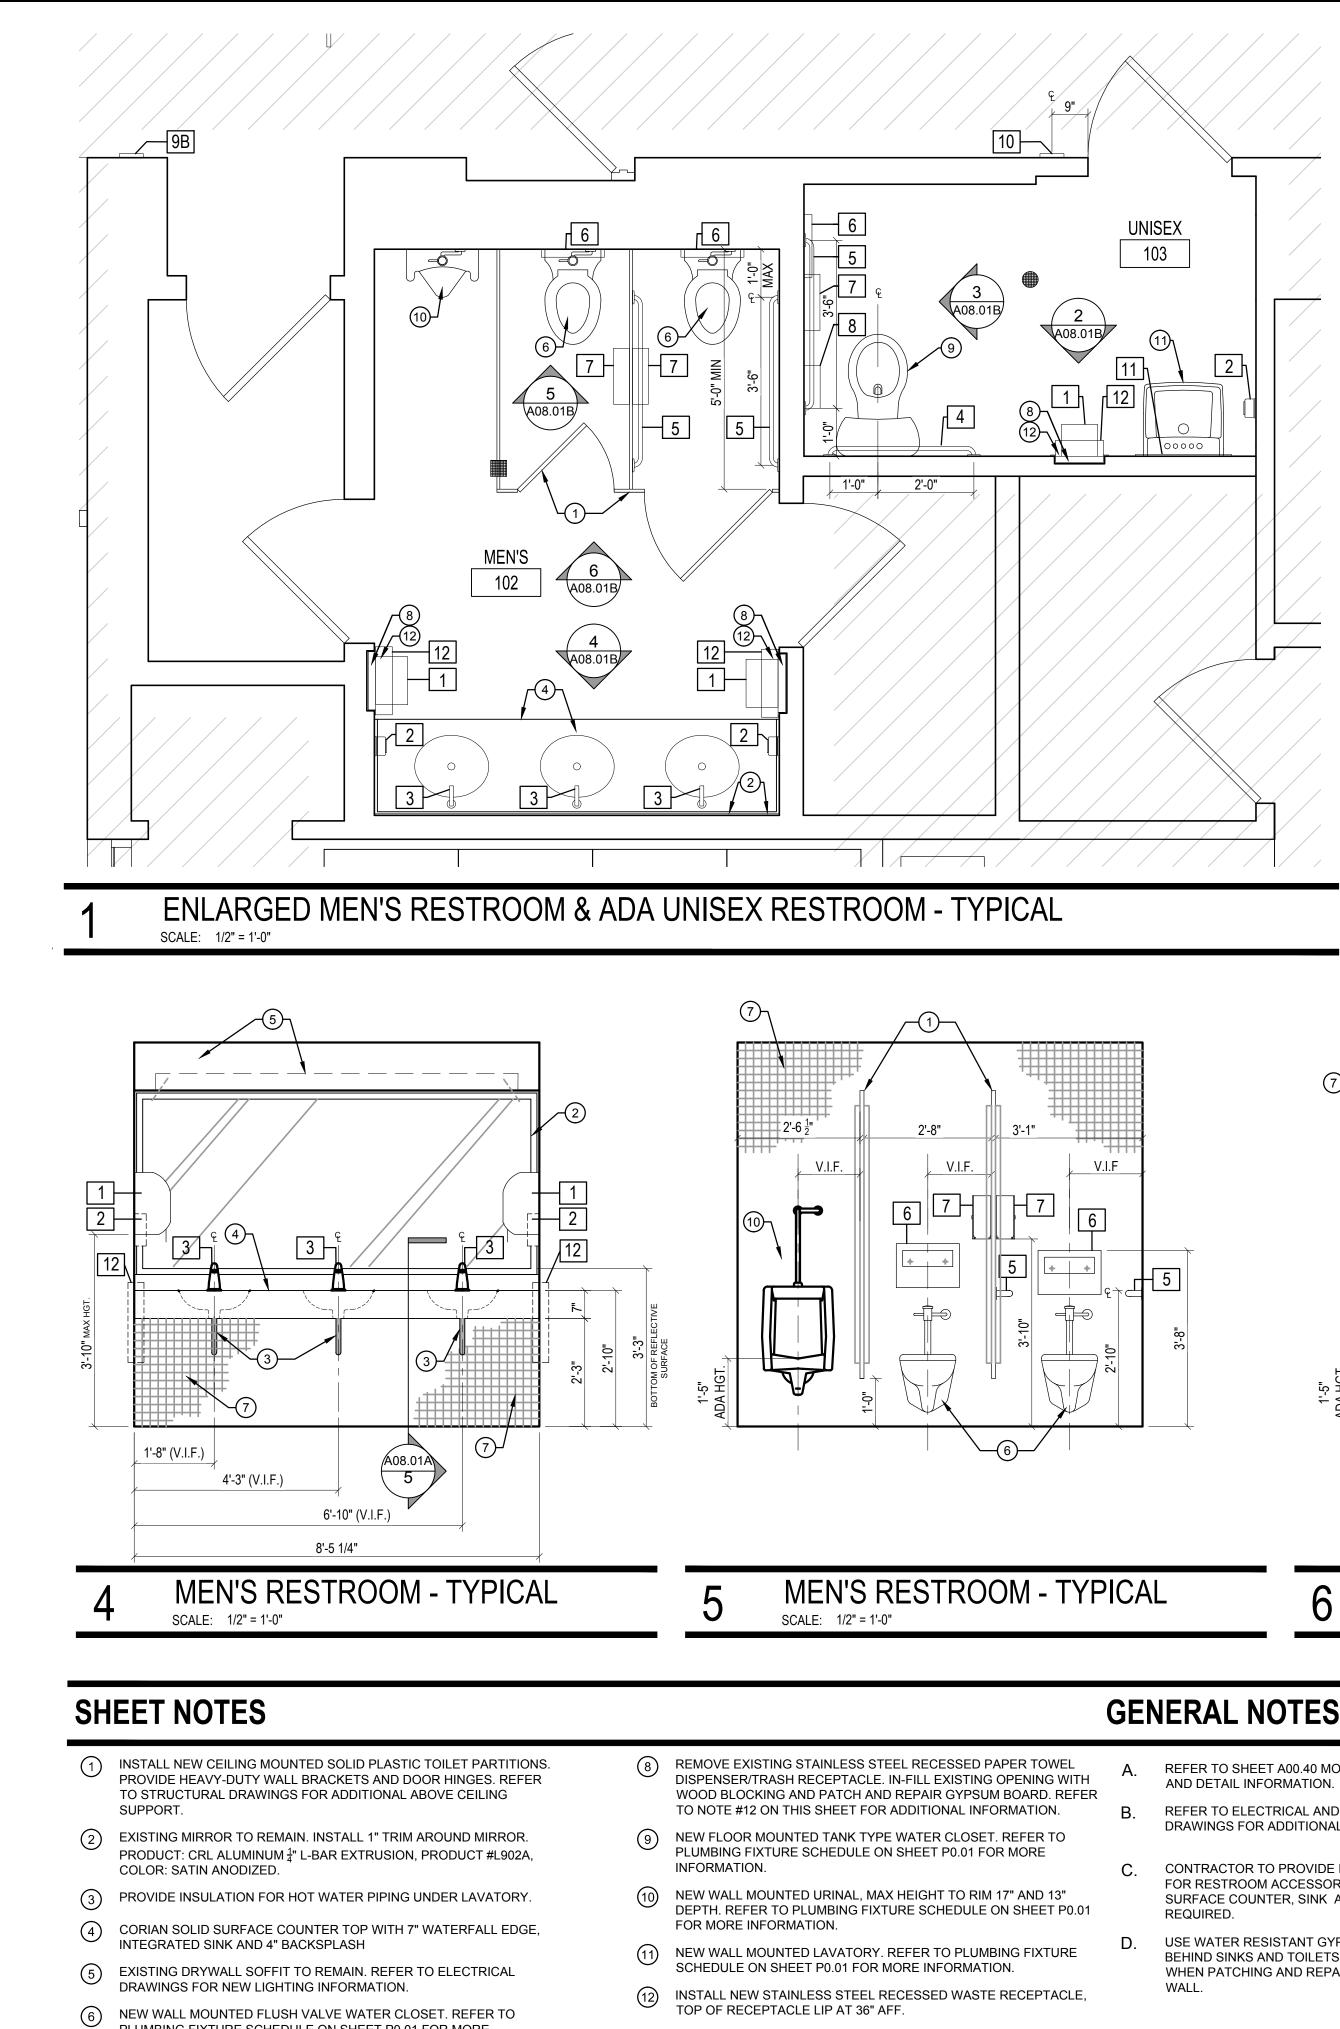

INFORMATION. 7 ALL EXISTING FLOOR AND WALL TILE INCLUDING GROUT TO REMAIN, RE-GROUT TILE AS NEEDED. FILL-IN ANY MINOR HOLES IN TILE WITH GROUT. REPLACE ANY MAJOR TILE DAMAGE WITH NEW TILE TO MATCH EXISTING. TILE CLEANING PROCESS SHALL BE DONE BY OC FACILITIES AFTER CONSTRUCTION IS COMPLETED.

PLUMBING FIXTURE SCHEDULE ON SHEET P0.01 FOR MORE

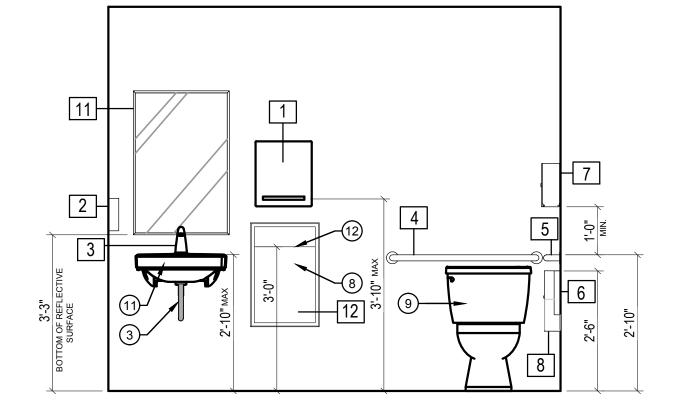

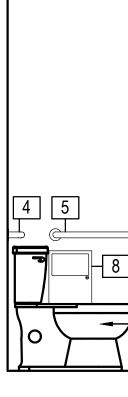





24" MIN. 32" MIN. (7)10 1'-5" DA HG

### MEN'S RESTROOM - TYPICAL SCALE: 1/2" = 1'-0"

# **GENERAL NOTES**


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- CONTRACTOR TO PROVIDE IN WALL BLOCKING FOR RESTROOM ACCESSORIES, SOLID SURFACE COUNTER, SINK AND TOILET AS
- USE WATER RESISTANT GYPSUM BOARD BEHIND SINKS AND TOILETS AS REQUIRED WHEN PATCHING AND REPAIRING EXISTING

# TOILET ACCESSORIES SCHEDULE

		TOILET ACCES	SORIES SCHE
TAG	ITEM	MANUFACTURE	
1	OPTISERV - PAPER TOWEL DISPENSER	WAUSAU	86800
2	GOJO LXT-12 SOAP DISPENSER - TOUCH FREE	GOJO	1919-04
3	ZURN AQUASENSE BATTERY POWERED FAUCET	ZURN	Z6913-XL
4	GRAB BAR, 36" LONG (UNISEX ADA RESTROOM ONLY)	BOBRICK	B-5806 x 36
5	GRAB BAR, 42" LONG	BOBRICK	B-5806 x 42
6	SEAT COVER DISPENSER	BOBRICK	B-221
7	TOILET PAPER DISPENSER	WAUSAU	88400
8	SANITARY NAPKIN DISPOSAL (WOMEN'S & UNISEX RR ONLY)	BOBRICK	B-254
9A	RESTROOM SIGN - WOMEN	EAGLESTONE OR EQ.	5303
9B	RESTROOM SIGN - MEN	EAGLESTONE OR EQ.	5301
10	RESTROOM SIGN - UNISEX ACCESSIBLE	EAGLESTONE OR EQ.	5306
11	MIRROR (UNISEX ADA RESTROOM ONLY)	BOBRICK	B-165-2436
12	RECESSED WASTE RECEPTACLE	BOBRICK	B-3644
DTE: A	LL TOILET ACCESSORIES ARE AS SPECIFIED OR APP	ROVED EQUAL.	

NOTE: ALL TOILET ACCESSORIES ARE AS SPECIFIED OR APPROVED EQUAL. NOTE: GC TO WALK EACH FLOOR AND EACH RESTROOM TO INVENTORY EXISTING ACCESSORIES. IF I ONSITE; REMOVE AND SAVE ALL ACCESSORIES THAT ARE IN GOOD CONDITION INORDER TO RE-IN REPLACE / ORDER NEW ACCESSORIES THAT ARE DAMAGED OR NOT APPROVED ORANGE COUNTY

		ARCHITECTURAL DESIGN CO 945 N. PENNSYLVANIA AVENUE WINTER PARK, FLORIDA 32789	LLABORATIVE
		OFFICE: (407) 629-1188 FAX: (407) 388-1220 WWW. ADCINTERNATIONAL.NET	AR0010460
		STATE OF FLORIDA ALBERT JOSEPH COOPER III, R.A. Architect • Seal/Signature	AA-C001315 AR-0010460
		Project Documents for:	
≁		04.28.17         60% CD SET           08.25.17         90% CD SET           10.16.17         100% CD SET           04.27.18         PERMIT SET	Drawn ByChecked ByPG / JSMFPG / JSMFPG / JSACPG / JSAC
ISEX RE	ESTROOM - TYPICAL	• SPACE	
		Client Information ORANGE COUNTY CAPITAL PRO 400 E SOUTH STREET 5th FLOOR ORLANDO, FL 32801 • Project Number	JECTS DIVISION
		16319 Drawn By PG / JS Checked By AC File Name	04/27/2018 <b>Project Status</b> PERMIT ISSUE SET <b>Scale</b> 1/2" = 1'-0"
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		Consultant • Seal/Signature	
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IEDULE MODEL NO.	REMARKS	Sheet Title:	
	BLACK TRANSLUCENT BLACK AND SILVER	ENLARGED FLOOR	PLAN
6 2	CHROME COLOR, BATTERY POWERED FAUCET SATIN STAINLESS STEEL SATIN STAINLESS STEEL STAINLESS STEEL SURFACE MOUNTED SILHOUETTE WAGON WHEEL DISPENSER, TRANSLUCENT SMOKE, ITEM # G1-CT405-1 WOMEN'S & UNISEX RESTROOM ONLY; SATIN FINISH STAINLESS STEEL WHITE ON BLACK WHITE ON BLACK	& ELEVATION	S
)	WHITE ON BLACK WHITE ON BLACK MIRROR WITH STAINLESS STEEL CHANNEL FRAME SATIN STAINLESS STEEL - TOP OF RECEPTACLE LIP SHOULD BE @ 36" AFF	A08.01	B
ISTALL AFTER	ACCESSORY ALREADY EXISTS CONSTRUCTION IS COMPLETE. AS LISTED ABOVE.		

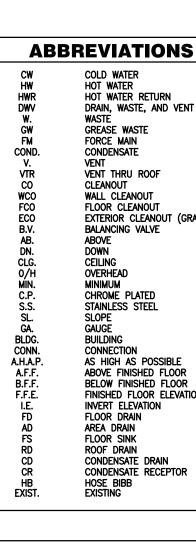

MARK	<u>Fixtur</u> i
<u>WC-1</u>	WALL MOUN Flush va Water Clo
<u>WC-2</u>	Wall Moui Flush Va Water Clo A.d.a.
<u>WC-3</u>	FLOOR MOU Tank—Ty Water Clo A.D.A.
<u>WC-4</u>	FLOOR MOU FLUSH VA WATER CLC A.D.A.
<u>U–1</u>	WALL HU URINAL
<u>L-1</u>	integral coui Lavator A.d.a.
<u>L–2</u>	WALL HU LAVATOR A.D.A.
UMBING	i Fixture notes:
FIXTL	IRES AND EQUIP IITTED FOR CON
. WHEF	RE COLOR/FINISH CHASE AND INST/
. Verii	TY SINK DIMENSI
. Refe	R TO ARCHITECT
. Prov	IDE TOILETS AND
	JRES FOR USE E
А. В. С.	INSTALL IN ACC THE FORCE RE FLUSH ACTIVATO
D. E.	THE FAUCET CO REQUIRING AN ACCESSIBLE FIX CODE.

ONS	PLUMBING	SYSTEM LEGEND
TURN AND VENT OF		<ul> <li>SOIL OR WASTE LINE (BELOW GRADE)</li> <li>SOIL OR WASTE LINE (ABOVE GRADE)</li> <li>FORCE MAIN LINE (BELOW GRADE)</li> <li>FORCE MAIN LINE (ABOVE GRADE)</li> <li>CONDENSATE DRAIN PIPING</li> <li>GREASE WASTE PIPING (BELOW GRADE)</li> <li>VENT PIPING</li> <li>STORM DRAIN LINE (BELOW GRADE)</li> </ul>
T		<ul> <li>STORM DRAIN LINE (ABOVE GRADE)</li> <li>OVERFLOW STORM DRAIN (ABOVE GRADE)</li> <li>DOMESTIC COLD WATER PIPING</li> <li>HOT WATER PIPING</li> <li>HOT WATER RETURN PIPING</li> <li>TEMPERED WATER PIPING</li> <li>GAS PIPING</li> <li>COMPRESSED AIR PIPING</li> </ul>
D EL		
DSSIBLE D FLOOR D FLOOR R ELEVATION ON		
RAIN		

PL	UME	BING	FIX	TUR	E SC	HEDULE
E	<u>SOIL</u>	WASTE	VENT	нw	<u>cw</u>	MANUFACTURER
nted Lve Dset	4"		2"		1"	AMERICAN STANDARD MODEL 3351.660 WITH MODEL 3351.101 'AFWALL' BOWL AND MODEL 6065.161 1.6 GPF BATTERY POWERED EXPOSED FLUSH VALVE, CENTOCO #500CC SEAT WITH S.S. HINGE POSTS. MOUNT WITH SEAT 15" A.F.F. SEE NOTE '1' BELOW.
nted Lve Jset	4"		2"		1"	AMERICAN STANDARD MODEL 3351.660 WITH MODEL 3351.101 'AFWALL' BOWL AND MODEL 6065.161 1.6 GPF BATTERY POWERED EXPOSED FLUSH VALVE, CENTOCO #500CC SEAT WITH S.S. HINGE POSTS. MOUNT WITH SEAT 17" A.F.F. SEE NOTES '1' AND '6' BELOW.
inted Pe Dset	4"		2"		1/2"	AMERICAN STANDARD MODEL 2467.106 'CADET' 16½" TALL PRESSURE-ASSISTED TOILET, 1.6 GPF, CENTOCO #500CC SEAT WITH S.S. HINGE POSTS. MOUNT WITH SEAT 17½" A.F.F. SEE NOTES '1' AND '6' BELOW.
inted Lve Dset	4"		2*		1"	AMERICAN STANDARD MODEL 3461.660 WITH MODEL 3461.001 'MADERA' 16½" TALL BOWL AND MODEL 6065.161 1.6 GPF BATTERY POWERED EXPOSED FLUSH VALVE, CENTOCO #500CC SEAT WITH S.S. HINGE POSTS. MOUNT WITH SEAT 17½" A.F.F. SEE NOTES '1' AND '6' BELOW.
NG	2"		2"		3/4"	AMERICAN STANDARD #6590.525 'WASHBROOK', WITH 0.125 GPF #6063.013 BATTERY POWERED EXPOSED FLUSH VALVE AND CARRIER. SEE NOTES '1' AND '6' BELOW.
ntertop Y		1 1/4"	1 1/2"	1/2"	1/2"	CUSTOM COUNTERTOP WITH 3 INTEGRAL LAVATORY SINKS WITH FAUCET FIXTURES, SEE ARCHITECTURAL DRAWINGS FOR REQUIREMENTS. PROVIDE FOR EACH INTEGRAL SINK: ZURN MODEL Z6913-XL BATTERY POWERED FAUCET WITH VANDAL RESISTANT 0.5 GPM AERATOR, TEMPERATURE MIXING VALVE, MIXING VALVE SUPPLY HOSES, McGUIRE #155WC C.P. OFFSET OPEN GRID DRAIN WITH 17 GA. TAILPIECE, #8872 17 GA. C.P. 'P' TRAP WITH WALL BEND, #H2165LK C.P. SUPPLIES WITH LOOSE KEY STOPS, AND TRUEBRO #103 INSULATION KIT. PROVIDE CONNECTIONS FOR 3 COMPLETE FAUCETS AND DRAINS. SEE NOTES '1' AND '6' BELOW.
NG YY		1 1/4"	2"	1/2"	1/2"	AMERICAN STANDARD MODEL 0356.421 'LUCERNE' WALL MOUNTED LAVATORY, ZURN MODEL Z6913-XL BATTERY POWERED FAUCET WITH VANDAL RESISTANT 0.5 GPM AERATOR, TEMPERATURE MIXING VALVE, MIXING VALVE SUPPLY HOSES, McGUIRE #155WC C.P. OFFSET OPEN GRID DRAIN WITH 17 GA. TAILPIECE, #8872 17 GA. C.P. 'P' TRAP WITH WALL BEND, #H2165LK C.P. SUPPLIES WITH LOOSE KEY STOPS, AND TRUEBRO #103 INSULATION KIT. SEE NOTES '1' AND '6' BELOW.

VIPMENT LISTED ABOVE ARE THE BASIS OF DESIGN. ADDITIONAL FIXTURES AND EQUIPMENT CAN BE DNSIDERATION AS ACCEPTABLE EQUALS.

IISH OPTIONS ARE AVAILABLE FOR FIXTURES, SELECTIONS SHALL BE SUBMITTED TO THE ARCHITECT PRIOR TO ISTALLATION.

ISIONS WITH ARCHITECT, RE: MILLWORK.

CTURAL DRAWINGS FOR MOUNTING HEIGHTS OF ALL FIXTURES.

AND URINALS WITH 'EVERCLEAN' SURFACES.

e by the disabled:

ACCORDANCE WITH A.D.A., STATE, AND LOCAL REQUIREMENTS. REQUIRED TO ACTIVATE FLUSH VALVES SHALL BE 5 LBS MAXIMUM. (ATOR SHALL BE LOCATED ON WIDE SIDE OF THE STALL. " CONTROLS AND THE OPERATING MECHANISM (OPERABLE WITH ONE HAND) SHALL BE OF THE TYPE NOT AN OPERATING FORCE EXCEEDING 5 LBS, OR TIGHT GRASPING, PINCHING OR TWISTING OF THE WRIST. FIXTURES FOR CHILDREN SHALL COMPLY WITH FLORIDA BUILDING CODE 423.4.4 AND THE FLORIDA ACCESSIBILITY

_	ABBREVIATION	PLUMBING SYMBOL LEGEN DESCRIPTION	SYMBOL
	cv	CHECK VALVE	
	GV	GATE VALVE	 M
	BV	BALL VALVE	
	SV	SOLENOID VALVE	_ıδı 
·	-	SHUT-OFF COCK	
	BV	BALANCING VALVE	
	PRV	PRESSURE REGULATING VALVE	
	DN	ROLL DOWN	
	DN	ELBOW TURNED DOWN	
	UP	ELBOW TURNED UP	
	UP	TEE TURNED UP	
	UF	P-TRAP	
	– DN	TEE TURNED DOWN	
	CO	PLUG OR WALL CLEAN OUT	-0
	FCO		
	ECO	FLOOR CLEAN OUT	
	ЕСО Т&Р	PRESSURE & TEMPERATURE RELIEF VALVE	
	VTR	VENT THROUGH ROOF	VTR
	VIK		
	-		⊣ ⊢
	FD	FLOOR DRAIN	⊠ Ø ⊞∃
	DD	PROMENADE DRAIN	
	FS	FLOOR SINK	
	RD	ROOF DRAIN	$\odot$
	-	UTILITY FLOOR BOX	#
	WH	WALL HYDRANT	-#
	HB	HOSE BIBB	+
	-	FLOW ARROW	4
	SA	SHOCK ARRESTER	
	POD	POINT OF DEMOLITION	$\Theta$
	POC	POINT OF CONNECTION	$\mathbf{\Theta}$
	XX-1	PLUMBING FIXTURE DESIGNATION	<u>XX-1</u>
	СР	CIRCULATING PUMP	ф <u> </u>
	-	PRESSURE GAGE	<u><u> </u></u>
	-	THERMOMETER	
	-	EXPANSION LOOP	
	RPDA	REDUCED PRESSURE DETECTOR ASSEMBLY	
	-	GREASE TRAP	0 0
	м	WATER METER	-M)
	ELEV	FLOOR SLAB ELEVATION	L (-15'-0")
		INDICATES RISER/DETAIL NUMBER, SHEET FOUND, AND RISER VIEW, (IF APPLICABLE)	

SECONDARY TRAP SEAL PROTECTION DEVICE SCHEDULE
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<u>PIPE</u> <u>SIZE</u>	<u>PIPE</u> MATERIAL	INSTALLATION TYPE	MANUFACTURER
2"	PVC OR C.I.	F.D. OUTLET	J.R. SMITH #2692.02; PROSET #TG22G; SURESEAL #SS2009
3"	PVC OR C.I.	F.D. OUTLET	J.R. SMITH #2692.02; PROSET #TG33G; SURESEAL #SS3000
4"	PVC OR C.I.	F.D. OUTLET	J.R. SMITH #2692.02; PROSET #TG34G; SURESEAL #SS4009

TRAP SEAL PROTECTION DEVICE NOTES: 1. SIZE AND INSTALL PER MANUFACTURER'S RECOMMENDATIONS IN EXISTING DRAINS.

EXISTING WALL CLEANOUT SCHEDULE					
MARK	APPLICATION	MANUFACTURER			
WCO	RESTROOMS	J.R. SMITH #4472T; WATTS #CO-590-RD; ZURN #Z-1468			
NOTES: 1 REPLACE EXISTI	NG WALL CLEANOUT WITH NEW BRASS PLU	IG AND STAINIESS STEEL ACCESS COVER			

I. REPLACE EXISTING WALL CLEANOUT WITH NEW BRASS PLUG AND STAINLESS STEEL ACCESS COVER.

EXISTING FLOOR	DRAIN SCHEDULE
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MARK	BODY	GRATE OR STRAINER	MANUFACTURER
<u>FD-R</u>	CAST IRON	POLISHED NICKEL BRONZE, ROUND TO MATCH EXISTING	J.R. SMITH TYPE 'A-NB' STRAINER WATTS TYPE 'A' STRAINER ZURN TYPE 'B' STRAINER
<u>FD-S</u>	CAST IRON	POLISHED NICKEL BRONZE SQUARE TO MATCH EXISTING	J.R. SMITH #2005-A06-NB WATTS TYPE 'M' STRAINER ZURN TYPE TYPE 'S' STRAINER
<u>Floor Drain</u> 1. Furnish		Condary trap seals for all existing f	LOOR DRAINS.

### PLUMBING GENERAL NOTES

REFERENCE THE SPECIFICATIONS FOR MATERIALS AND EQUIPMENT STANDARDS. THE INSTALLATION OF THE PLUMBING SYSTEMS AND EQUIPMENT SHALL COMPLY WITH ALL APPLICABLE CODES INCLUDING BUT NOT LIMITED TO STATE AND LOCAL CODES.

THE CONTRACTOR SHALL COORDINATE THE INTERRUPTION OF ALL UTILITY SERVICES WITH OWNER'S REPRESENTATIVE. PROVIDE A MINIMUM OF FIVE WORKING DAYS ADVANCED NOTICE, OR PER PLUMBING SPECIFICATIONS, OF SCHEDULED UTILITY DISCONNECTION. PROVIDE ANY ADDITIONAL FITTINGS REQUIRED FOR PROPER INSTALLATION AND TO MAINTAIN PROPER CLEARANCES. COORDINATE WITH ALL TRADES AND OTHER POTENTIAL OBSTRUCTIONS AND ROUTE PIPING TO AVOID INTERFERENCES.

CONCEAL PIPING ABOVE CEILINGS, WITHIN WALLS OR CHASES EXCEPT IN MECHANICAL ROOMS OR AS SPECIFICALLY NOTED.

. FIRESTOP ALL PENETRATIONS THROUGH RATED WALLS, CEILINGS, AND FLOORS WITH LISTED ASSEMBLIES AND SLEEVE WHERE REQUIRED. FIRESTOP ASSEMBLIES SHALL BE EQUAL OR EXCEED THE RATING OF THE WALL OR FLOOR. ALL FIRESTOP ASSEMBLIES SHALL MEET ASTM E-814 REQUIREMENTS. SEE ARCHITECTURAL DRAWINGS FOR FINAL FINISHES AND ADDITIONAL PIPE PENETRATION REQUIREMENTS.

PROVIDE ACCESS PANELS TO ALL VALVES LOCATED WITHIN CHASES OR NON-ACCESSIBLE CEILINGS. REFER TO ARCHITECTURAL DRAWINGS FOR CEILING TYPES. ALL VALVES SHALL BE ACCESSIBLE.


REFER TO ARCHITECTURAL DRAWINGS FOR FIXTURE LOCATIONS AND MOUNTING HEIGHTS. ALL FLOOR DRAINS SHALL BE INSTALLED WITH GRATES FLUSH TO THE FINISHED FLOOR. ). UNLESS NOTED OTHERWISE, SLOPE ALL SANITARY DWV PIPING 3" PIPE SIZE & LARGER A MINIMUM OF 1/8" PER FT. OF RUN, AND 2" PIPE SIZE AND SMALLER A MINIMUM 1/4" PER FT. OF RUN. SLOPE VENT PIPING DOWN & BACK TO FIXTURES.

. PROVIDE ALL NECESSARY VALVES, TRAPS, STOPS, TAILPIECES, ETC, IF NOT FURNISHED WITH EQUIPMENT.

2. PROVIDE SUPPLY STOPS ON HOT AND COLD WATER PIPE SUPPLYING ALL FIXTURES AND EQUIPMENT. 3. REFER TO THE ARCHITECTURAL PLANS FOR ADDITIONAL DETAILS AND SPECIFICATIONS RELATING TO PLUMBING FIXTURE SELECTIONS, COLOR, FINISHES, AND PIPING ROUTING.

ALBERT JOSEPH	A	AA-C	0013
Architect   Seal/Sig		AR-00	)1046 
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Issue Date & Issu	e Description		ecked
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### **DEMOLITION GENERAL NOTES:**

- a. ALL WORK SHALL BE PERFORMED IN ACCORDANCE WITH THE FLORIDA BUILDING CODE 5TH EDITION (2014) AND THE FLORIDA BUILDING CODE 5TH EDITION (2014), PLUMBING.
- EXISTING FIXTURES SHOWN ON THE DRAWINGS ARE BASED ON THE b. LIMITED AS-BUILT INFORMATION OBTAINED FROM A LIMITED VISUAL INSPECTION. THE CONTRACTOR SHALL INCLUDE A SUFFICIENT ALLOWANCE TO COVER ADDITIONAL INCIDENTAL DEMOLITION WORK AT NO ADDITIONAL COST TO THE OWNER.
- c. AS PART OF THE DEMOLITION WORK, THE CONTRACTOR SHALL PREPARE A LOG OF THE EXISTING TOILET AND URINALS, WHICH INCLUDES THE MAKE, MODEL, AND ROUGH-IN DIMENSIONS (WATER SUPPLY, SANITARY OUTLET) FOR EACH FIXTURE ON ALL FLOORS.
- d. AS PART OF THE DEMOLITION WORK, THE CONTRACTOR SHALL PREPARE A LOG OF THE EXISTING WALL CLEANOUTS AND FLOOR DRAINS, WHICH INCLUDES THE MAKE, MODEL, SHAPE, SIZE AND ROUGH-IN DIMENSIONS FOR EACH CLEANOUT OR DRAIN ON ALL FLOORS.
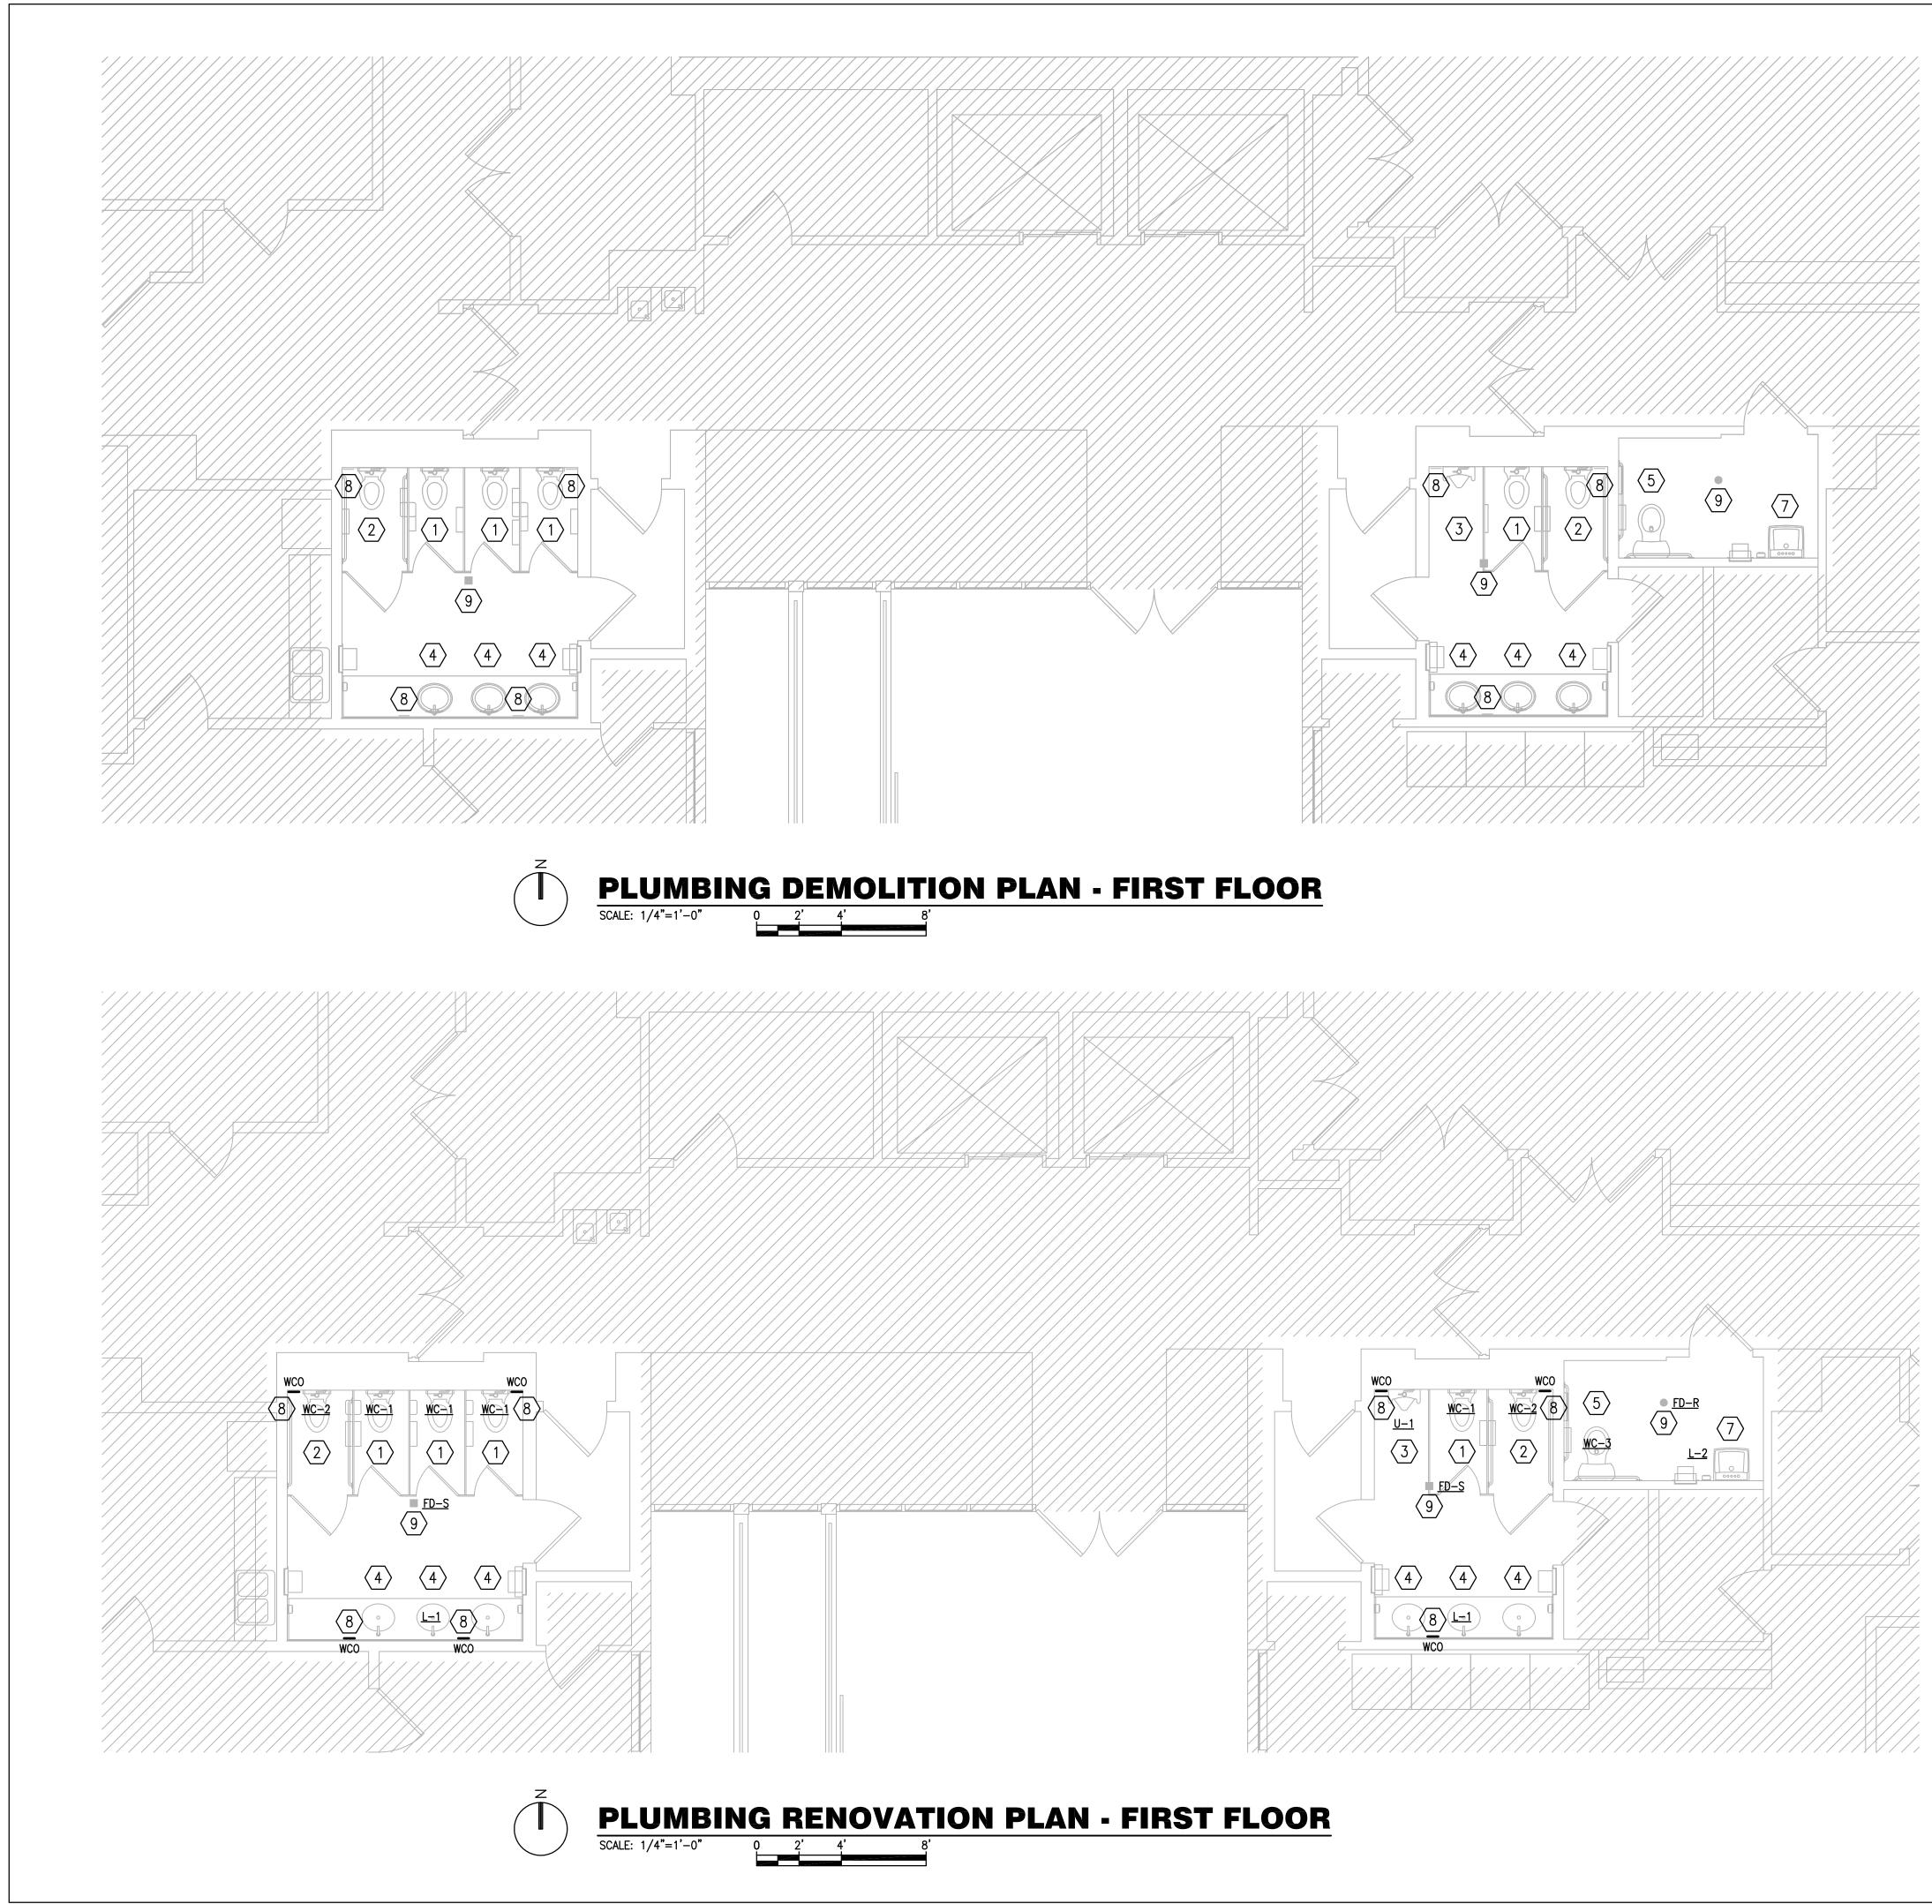
# **DEMOLITION PLAN KEY NOTES:** (#)

- REMOVE EXISTING WALL MOUNTED TOILET AND TEMPORARILY CAP EXISTING FIXTURE POTABLE WATER AND SANITARY PIPING TO ALLOW FOR FUTURE RENOVATION WORK. SEE RENOVATION DRAWINGS FOR ADDITIONAL INFORMATION.
- 2. REMOVE EXISTING WALL MOUNTED HANDICAPPED HEIGHT TOILET AND TEMPORARILY CAP EXISTING FIXTURE POTABLE WATER AND SANITARY PIPING TO ALLOW FOR FUTURE RENOVATION WORK. SEE RENOVATION DRAWINGS FOR ADDITIONAL INFORMATION.
- 3. REMOVE EXISTING WALL MOUNTED URINAL AND TEMPORARILY CAP EXISTING FIXTURE POTABLE WATER AND SANITARY PIPING TO ALLOW FOR FUTURE RENOVATION WORK. SEE RENOVATION DRAWINGS FOR ADDITIONAL INFORMATION.
- 4. REMOVE EXISTING COUNTER MOUNTED LAVATORY AND TEMPORARILY CAP EXISTING FIXTURE POTABLE WATER AND SANITARY PIPING TO ALLOW FOR FUTURE RENOVATION WORK. SEE RENOVATION DRAWINGS FOR ADDITIONAL INFORMATION.
- 5. REMOVE EXISTING FLOOR MOUNTED TANK-TYPE TOILET AND TEMPORARILY CAP EXISTING FIXTURE POTABLE WATER AND SANITARY PIPING TO ALLOW FOR FUTURE RENOVATION WORK. SEE RENOVATION DRAWINGS FOR ADDITIONAL INFORMATION.
- 6. NOT USED.
- 7. REMOVE EXISTING WALL MOUNTED LAVATORY AND TEMPORARILY CAP EXISTING FIXTURE POTABLE WATER AND SANITARY PIPING TO ALLOW FOR FUTURE RENOVATION WORK. SEE RENOVATION DRAWINGS FOR ADDITIONAL INFORMATION.
- 8. EXISTING WALL CLEANOUT TO REMAIN, REMOVE EXISTING ACCESS PANEL. SEE RENOVATION DRAWINGS FOR ADDITIONAL INFORMATION.
- 9. EXISTING FLOOR DRAIN TO REMAIN, REMOVE EXISTING FLOOR DRAIN STRAINER. SEE RENOVATION DRAWINGS FOR ADDITIONAL INFORMATION.


### **RENOVATION GENERAL NOTES:**

- a. ALL WORK SHALL BE PERFORMED IN ACCORDANCE WITH THE FLORIDA BUILDING CODE 5TH EDITION (2014) AND THE FLORIDA BUILDING CODE 5TH EDITION (2014), PLUMBING.
- b. THE CONTRACTOR SHALL USE THE TOILET AND URINAL FIXTURE LOG PREPARED DURING DEMOLITION AS NOTED ABOVE TO CONFIRM THE SUBMITTED TOILET AND URINAL FIXTURES WILL MATCH THE EXISTING FIXTURE ROUGH-IN DIMENSIONS AND CAN BE INSTALLED WITHOUT SUBSTANTIAL MODIFICATIONS.
- c. THE CONTRACTOR SHALL USE THE WALL CLEANOUT AND FLOOR DRAIN LOG PREPARED DURING DEMOLITION AS NOTED ABOVE TO CONFIRM THE SUBMITTED WALL CLEANOUTS AND FLOOR DRAIN STRAINERS WILL MATCH THE EXISTING CONDITIONS AND CAN BE INSTALLED WITHOUT SUBSTANTIAL MODIFICATIONS.

# **RENOVATION PLAN KEY NOTES:** (#)

- 1. INSTALL NEW WALL MOUNTED TOILET. CONNECT TO EXISTING POTABLE WATER AND SANITARY PIPING.
- 2. INSTALL NEW WALL MOUNTED HANDICAPPED HEIGHT TOILET. CONNECT TO EXISTING POTABLE WATER AND SANITARY PIPING.
- 3. INSTALL NEW WALL MOUNTED URINAL. CONNECT TO EXISTING POTABLE WATER AND SANITARY PIPING.
- 4. INSTALL NEW FAUCET AND DRAINAGE ACCESSORIES ON NEW INTEGRAL COUNTERTOP LAVATORY. CONNECT TO EXISTING POTABLE WATER AND SANITARY PIPING.
- 5. INSTALL NEW FLOOR MOUNTED HANDICAPPED HEIGHT TANK-TYPE TOILET. CONNECT TO EXISTING POTABLE WATER AND SANITARY PIPING.
- 6. NOT USED.
- 7. INSTALL NEW WALL MOUNTED HANDICAPPED HEIGHT LAVATORY. CONNECT TO EXISTING POTABLE WATER AND SANITARY PIPING.
- 8. INSTALL NEW CLEANOUT PLUG AND ACCESS COVER. EXISTING CLEANOUT TEE TO REMAIN.
- 9. INSTALL NEW STRAINER AND SECONDARY TRAP PROTECTION DEVICE IN EXISTING FLOOR DRAIN. STRAINER SHALL MATCH EXISTING FLOOR DRAIN.

### KEY PLAN

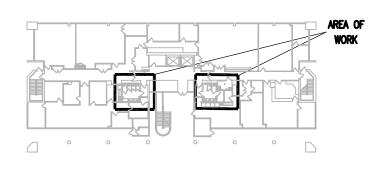




ALBERT JOSEPH COOPER III, R.A. Architect • Seal/Signature  Project Documents for:  Project: INTERNAL OPERATIONS CENTER - I RESTROOM UPGRADES - ALL FLOORS 450 E. SOUTH STREET ORLANDO, FL 32801  Issue Date & Issue Description Drawn By Checkee 08.18.17 90% CD SET MB/JJB JL 10.16.17 100% CD SET MB/JJB JL 04.27.18 PERMIT SET MB/JB JL 04.27.18				
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WILLIAM R HAYGOOD-FL39503



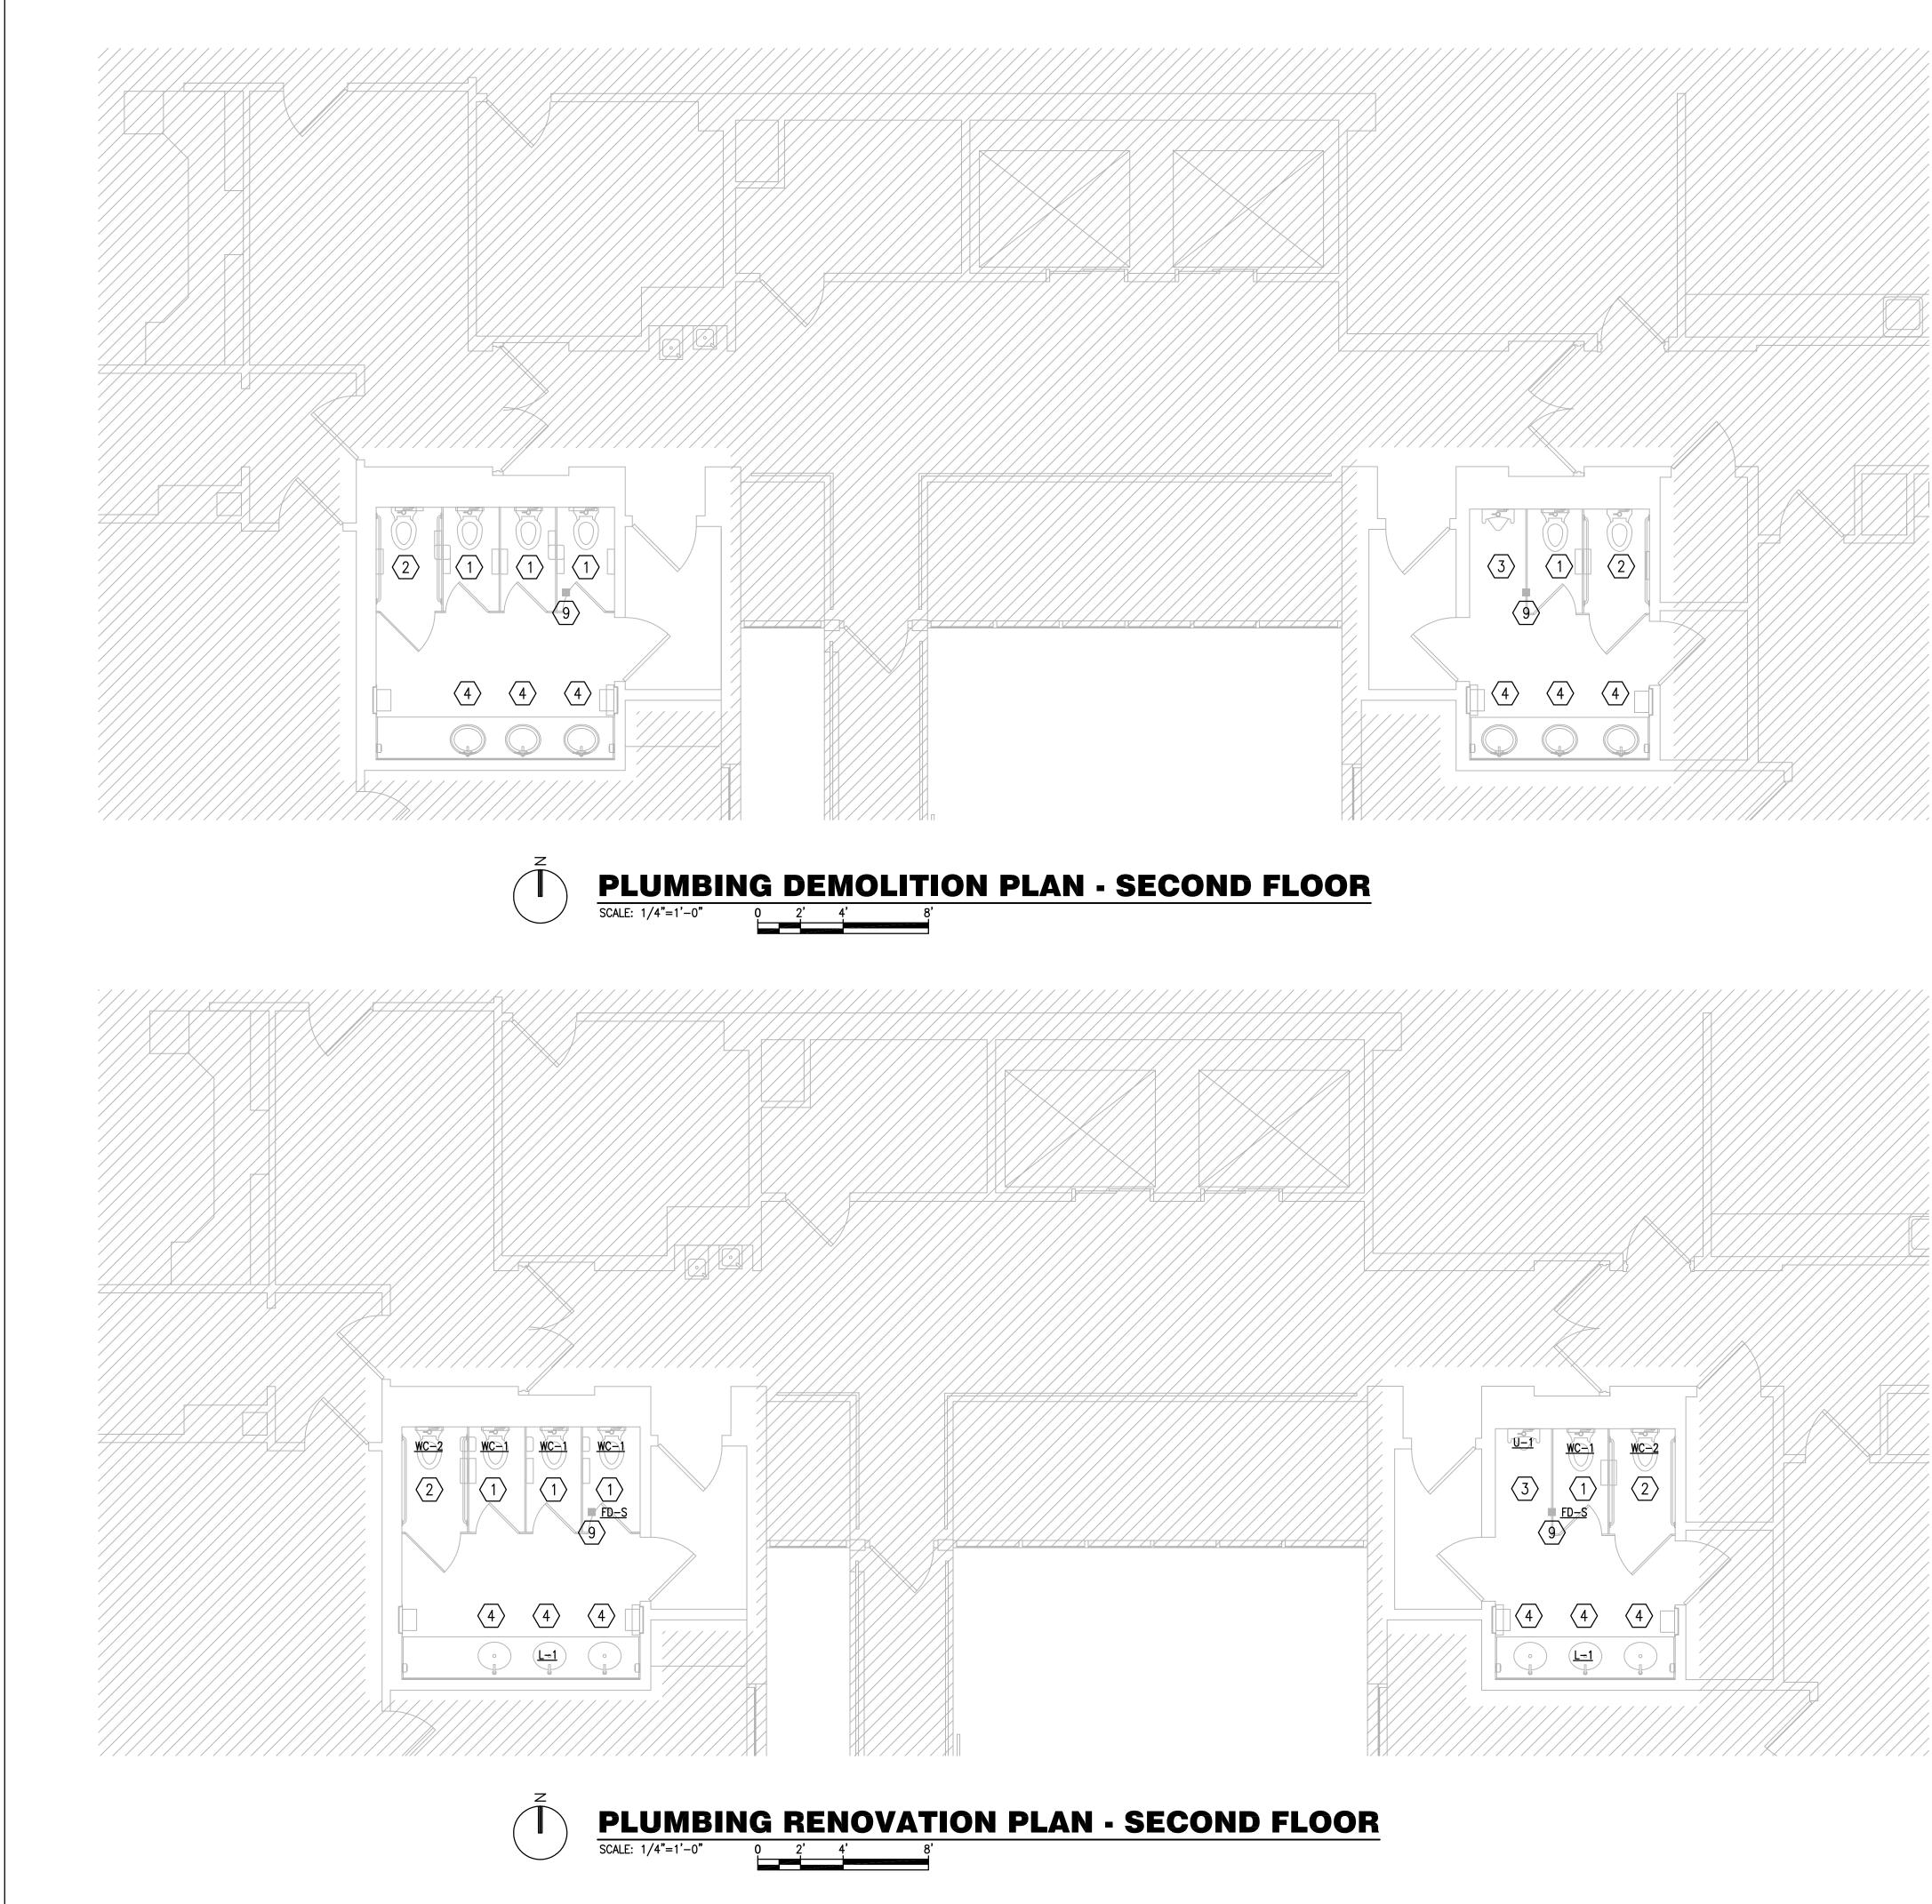

### **DEMOLITION GENERAL NOTES:**

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# **DEMOLITION PLAN KEY NOTES:**

- 1. REMOVE EXISTING WALL MOUNTED TOILET AND TEMPORARILY CAP EXISTING FIXTURE POTABLE WATER AND SANITARY PIPING TO ALLOW FOR FUTURE RENOVATION WORK. SEE RENOVATION DRAWINGS FOR ADDITIONAL INFORMATION.
- 2. REMOVE EXISTING WALL MOUNTED HANDICAPPED HEIGHT TOILET AND TEMPORARILY CAP EXISTING FIXTURE POTABLE WATER AND SANITARY PIPING TO ALLOW FOR FUTURE RENOVATION WORK. SEE RENOVATION DRAWINGS FOR ADDITIONAL INFORMATION.
- 3. REMOVE EXISTING WALL MOUNTED URINAL AND TEMPORARILY CAP EXISTING FIXTURE POTABLE WATER AND SANITARY PIPING TO ALLOW FOR FUTURE RENOVATION WORK. SEE RENOVATION DRAWINGS FOR ADDITIONAL INFORMATION.
- 4. REMOVE EXISTING COUNTER MOUNTED LAVATORY AND TEMPORARILY CAP EXISTING FIXTURE POTABLE WATER AND SANITARY PIPING TO ALLOW FOR FUTURE RENOVATION WORK. SEE RENOVATION DRAWINGS FOR ADDITIONAL INFORMATION.
- 5. NOT USED.
- 6. NOT USED.
- 7. NOTE USED.
- 8. NOT USED.
- 9. EXISTING FLOOR DRAIN TO REMAIN, REMOVE EXISTING FLOOR DRAIN STRAINER. SEE RENOVATION DRAWINGS FOR ADDITIONAL INFORMATION.


### **RENOVATION GENERAL NOTES:**

- a. ALL WORK SHALL BE PERFORMED IN ACCORDANCE WITH THE FLORIDA BUILDING CODE 5TH EDITION (2014) AND THE FLORIDA BUILDING CODE 5TH EDITION (2014), PLUMBING.
- b. THE CONTRACTOR SHALL USE THE TOILET AND URINAL FIXTURE LOG PREPARED DURING DEMOLITION AS NOTED ABOVE TO CONFIRM THE SUBMITTED TOILET AND URINAL FIXTURES WILL MATCH THE EXISTING FIXTURE ROUGH-IN DIMENSIONS AND CAN BE INSTALLED WITHOUT SUBSTANTIAL MODIFICATIONS.
- c. THE CONTRACTOR SHALL USE THE WALL CLEANOUT AND FLOOR DRAIN LOG PREPARED DURING DEMOLITION AS NOTED ABOVE TO CONFIRM THE SUBMITTED WALL CLEANOUTS AND FLOOR DRAIN STRAINERS WILL MATCH THE EXISTING CONDITIONS AND CAN BE INSTALLED WITHOUT SUBSTANTIAL MODIFICATIONS.

# **RENOVATION PLAN KEY NOTES:**

- 1. INSTALL NEW WALL MOUNTED TOILET. CONNECT TO EXISTING POTABLE WATER AND SANITARY PIPING.
- 2. INSTALL NEW WALL MOUNTED HANDICAPPED HEIGHT TOILET. CONNECT TO EXISTING POTABLE WATER AND SANITARY PIPING.
- 3. INSTALL NEW WALL MOUNTED URINAL. CONNECT TO EXISTING POTABLE WATER AND SANITARY PIPING.
- 4. INSTALL NEW FAUCET AND DRAINAGE ACCESSORIES ON NEW INTEGRAL COUNTERTOP LAVATORY. CONNECT TO EXISTING POTABLE WATER AND SANITARY PIPING.
- 5. NOT USED.
- 6. NOT USED.
- 7. NOT USED.
- 8. NOT USED.
- 9. INSTALL NEW STRAINER AND SECONDARY TRAP PROTECTION DEVICE IN EXISTING FLOOR DRAIN. STRAINER SHALL MATCH EXISTING FLOOR DRAIN.


### KEY PLAN

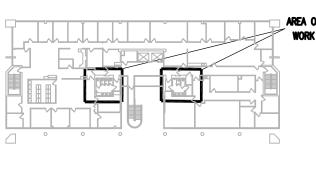



	ARCHITECTURAL DE 945 N. PENNSYLVANIA AVEN WINTER PARK, FLORIDA 3278 OFFICE: (407) 629-1188 FAX: (407) 388-1220 WWW. ADCINTERNATIONAL.I	39
	STATE OF FLORIDA ALBERT JOSEPH COOPER III Architect • Seal/Signature	AA-C001315 R.A. AR-0010460
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	ORLANDO, FL 32801	
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## **DEMOLITION GENERAL NOTES:**

- a. ALL WORK SHALL BE PERFORMED IN ACCORDANCE WITH THE FLORIDA BUILDING CODE 5TH EDITION (2014) AND THE FLORIDA BUILDING CODE 5TH EDITION (2014), PLUMBING.
- b. EXISTING FIXTURES SHOWN ON THE DRAWINGS ARE BASED ON THE LIMITED AS-BUILT INFORMATION OBTAINED FROM A LIMITED VISUAL INSPECTION. THE CONTRACTOR SHALL INCLUDE A SUFFICIENT ALLOWANCE TO COVER ADDITIONAL INCIDENTAL DEMOLITION WORK NO ADDITIONAL COST TO THE OWNER.
- c. AS PART OF THE DEMOLITION WORK, THE CONTRACTOR SHALL PREPARE A LOG OF THE EXISTING TOILET AND URINALS, WHICH INCLUDES THE MAKE, MODEL, AND ROUGH-IN DIMENSIONS (WATER SUPPLY, SANITARY OUTLET) FOR EACH FIXTURE ON ALL FLOORS.
- d. AS PART OF THE DEMOLITION WORK, THE CONTRACTOR SHALL PREPARE A LOG OF THE EXISTING WALL CLEANOUTS AND FLOOR DRAINS, WHICH INCLUDES THE MAKE, MODEL, SHAPE, SIZE AND ROUGH-IN DIMENSIONS FOR EACH CLEANOUT OR DRAIN ON ALL FLOORS.
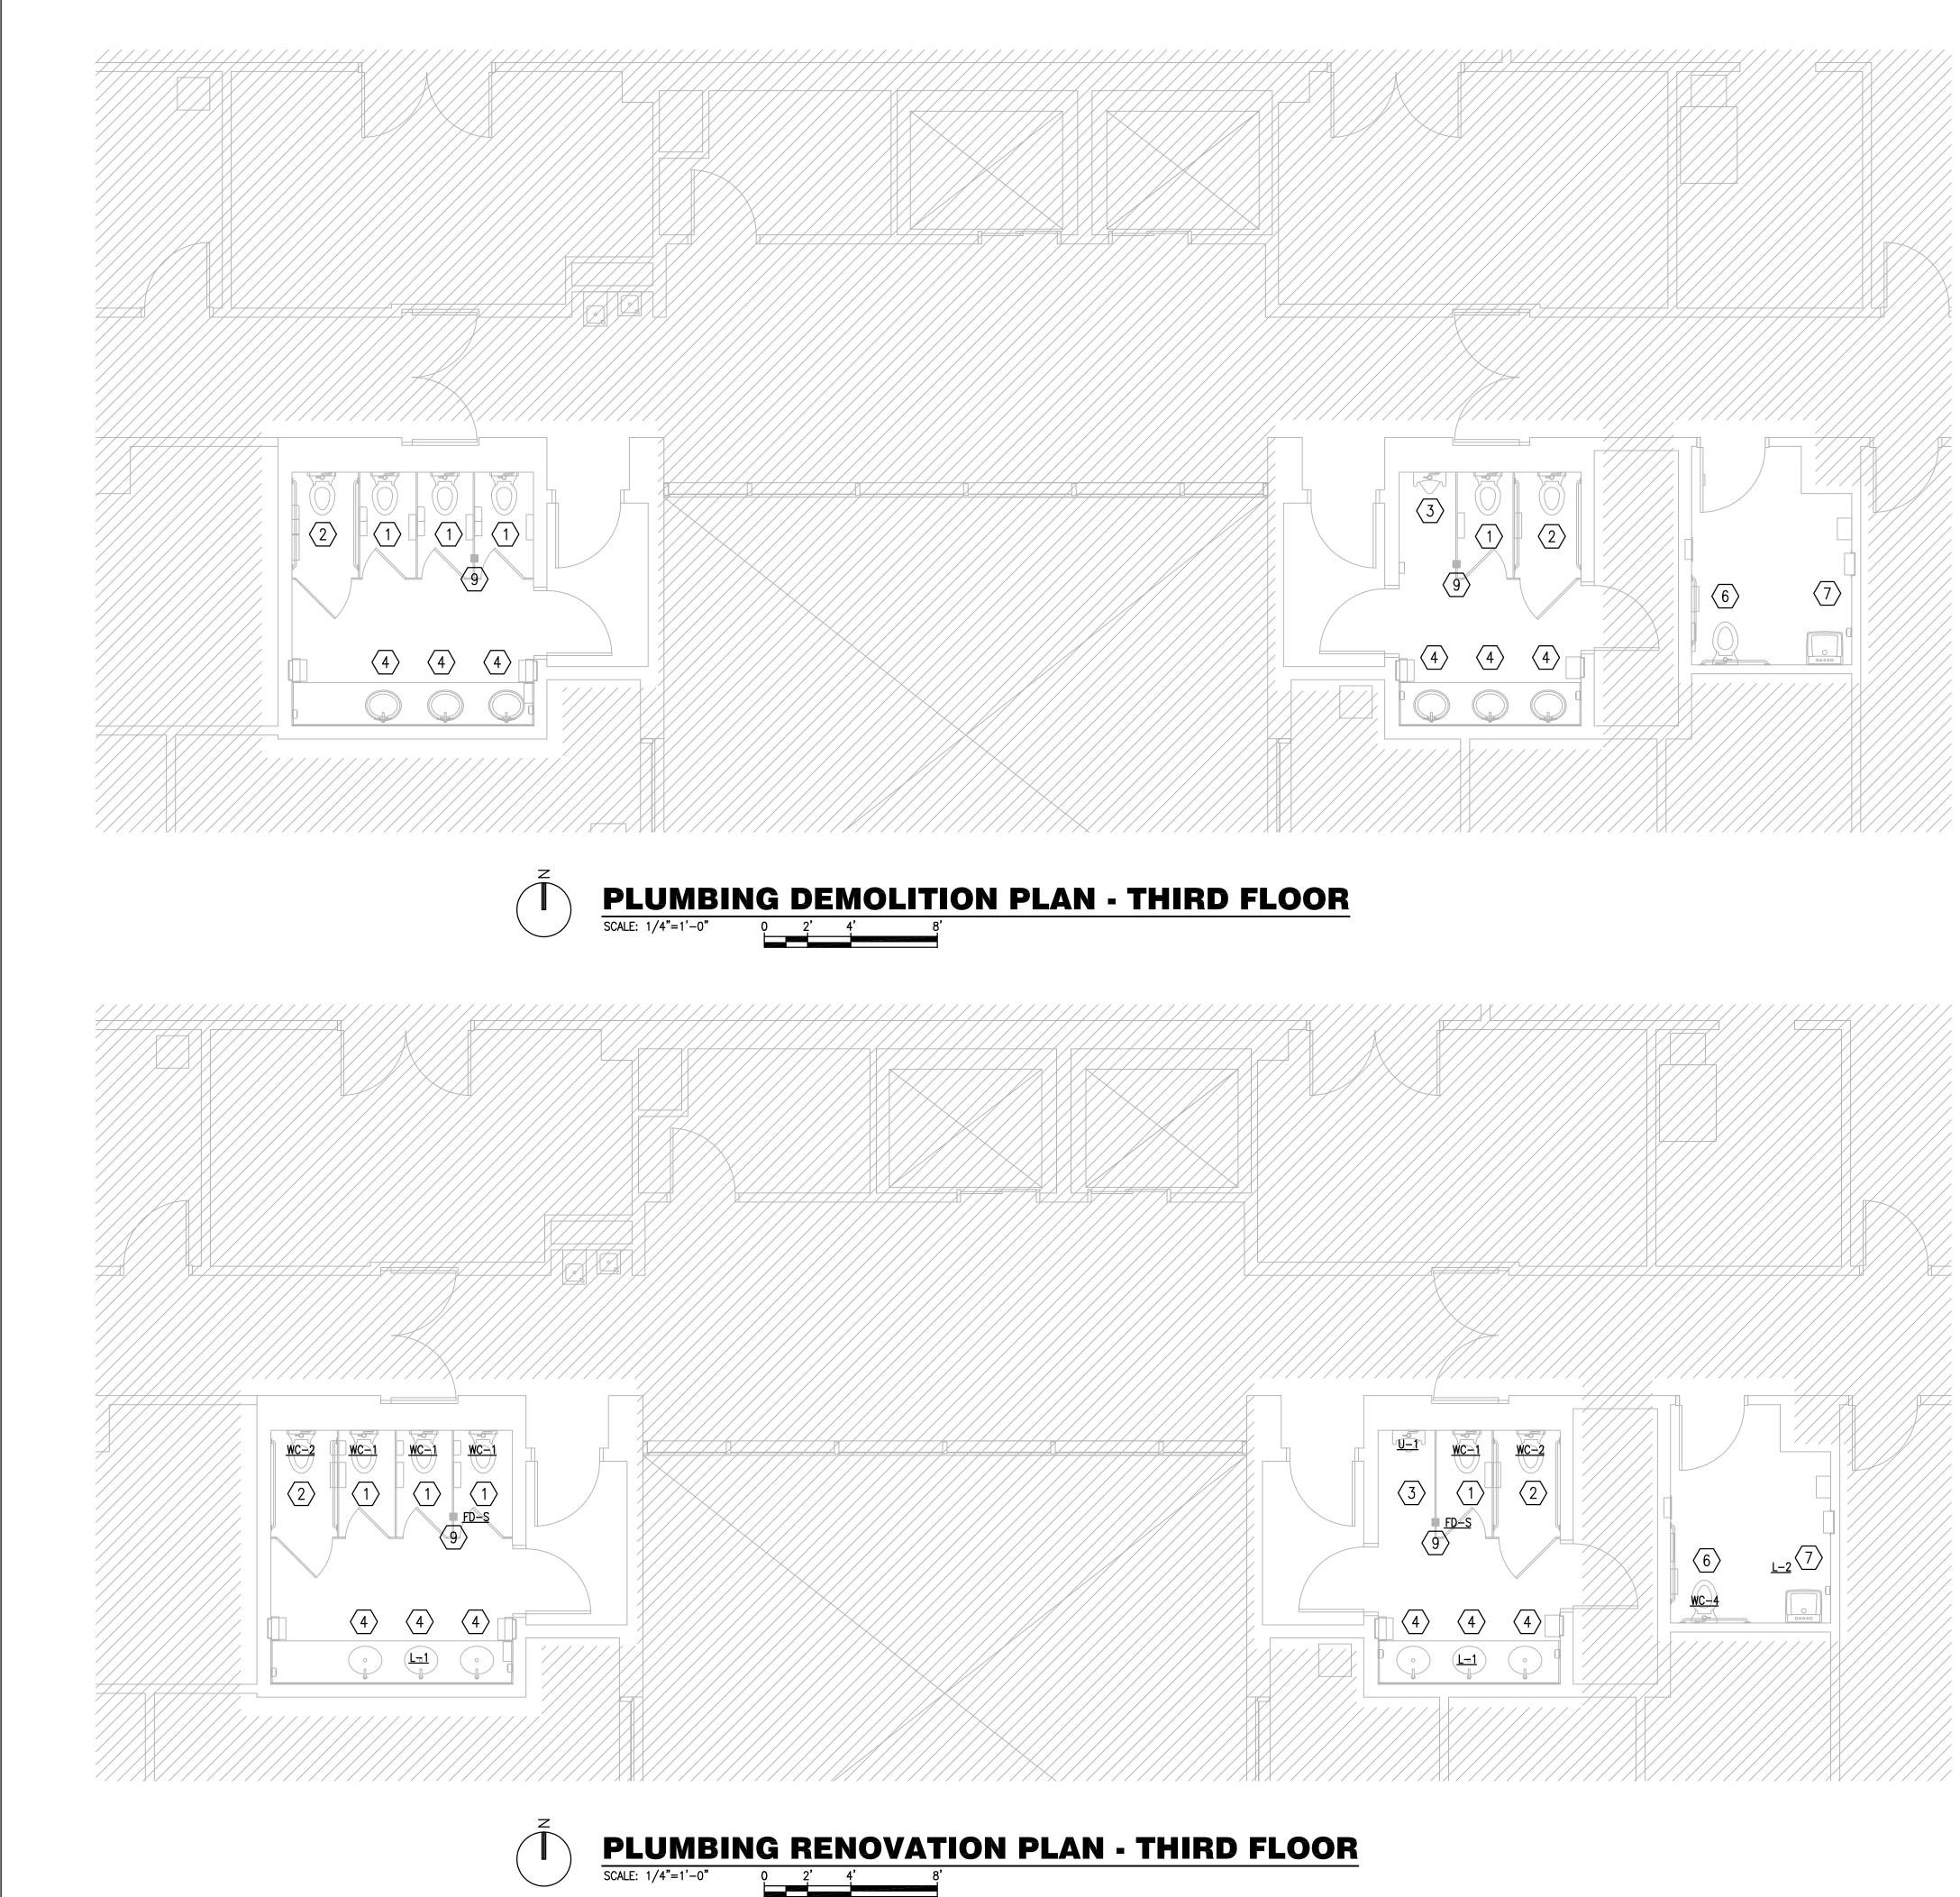
## **DEMOLITION PLAN KEY NOTE**

- 1. REMOVE EXISTING WALL MOUNTED TOILET AND TEMPORARILY CAP EXISTING FIXTURE POTABLE WATER AND SANITARY PIPING TO ALLOW FUTURE RENOVATION WORK. SEE RENOVATION DRAWINGS FOR ADDITION INFORMATION.
- 2. REMOVE EXISTING WALL MOUNTED HANDICAPPED HEIGHT TOILET AND TEMPORARILY CAP EXISTING FIXTURE POTABLE WATER AND SANITARY PIPING TO ALLOW FOR FUTURE RENOVATION WORK. SEE RENOVATION DRAWINGS FOR ADDITIONAL INFORMATION.
- 3. REMOVE EXISTING WALL MOUNTED URINAL AND TEMPORARILY CAP EXISTING FIXTURE POTABLE WATER AND SANITARY PIPING TO ALLOW FUTURE RENOVATION WORK. SEE RENOVATION DRAWINGS FOR ADDITION INFORMATION.
- 4. REMOVE EXISTING COUNTER MOUNTED LAVATORY AND TEMPORARILY EXISTING FIXTURE POTABLE WATER AND SANITARY PIPING TO ALLOW FUTURE RENOVATION WORK. SEE RENOVATION DRAWINGS FOR ADDITION INFORMATION.
- 5. NOT USED.
- 6. REMOVE EXISTING FLOOR MOUNTED TOILET AND TEMPORARILY CAP EXISTING FIXTURE POTABLE WATER AND SANITARY PIPING TO ALLOW FUTURE RENOVATION WORK. SEE RENOVATION DRAWINGS FOR ADDITI INFORMATION.
- 7. REMOVE EXISTING WALL MOUNTED LAVATORY AND TEMPORARILY CAP EXISTING FIXTURE POTABLE WATER AND SANITARY PIPING TO ALLOW FUTURE RENOVATION WORK. SEE RENOVATION DRAWINGS FOR ADDITION INFORMATION.
- 8. NOT USED.
- 9. EXISTING FLOOR DRAIN TO REMAIN, REMOVE EXISTING FLOOR DRAIN STRAINER. SEE RENOVATION DRAWINGS FOR ADDITIONAL INFORMATION

### **RENOVATION GENERAL NOTE**

- a. ALL WORK SHALL BE PERFORMED IN ACCORDANCE WITH THE FLO BUILDING CODE 5TH EDITION (2014) AND THE FLORIDA BUILDING 5TH EDITION (2014), PLUMBING.
- b. THE CONTRACTOR SHALL USE THE TOILET AND URINAL FIXTURE L PREPARED DURING DEMOLITION AS NOTED ABOVE TO CONFIRM TH SUBMITTED TOILET AND URINAL FIXTURES WILL MATCH THE EXISTIN FIXTURE ROUGH-IN DIMENSIONS AND CAN BE INSTALLED WITHOUT SUBSTANTIAL MODIFICATIONS.
- c. THE CONTRACTOR SHALL USE THE WALL CLEANOUT AND FLOOR D LOG PREPARED DURING DEMOLITION AS NOTED ABOVE TO CONFIRM THE SUBMITTED WALL CLEANOUTS AND FLOOR DRAIN STRAINERS MATCH THE EXISTING CONDITIONS AND CAN BE INSTALLED WITHOUT SUBSTANTIAL MODIFICATIONS.

# **RENOVATION PLAN KEY NOTE**

- 1. INSTALL NEW WALL MOUNTED TOILET. CONNECT TO EXISTING POTABL WATER AND SANITARY PIPING.
- 2. INSTALL NEW WALL MOUNTED HANDICAPPED HEIGHT TOILET. CONNECT EXISTING POTABLE WATER AND SANITARY PIPING.
- 3. INSTALL NEW WALL MOUNTED URINAL. CONNECT TO EXISTING POTABI WATER AND SANITARY PIPING.
- 4. INSTALL NEW FAUCET AND DRAINAGE ACCESSORIES ON NEW INTEGRA COUNTERTOP LAVATORY. CONNECT TO EXISTING POTABLE WATER AND SANITARY PIPING.
- 5. NOT USED.
- 6. INSTALL NEW FLOOR MOUNTED TOILET. CONNECT TO EXISTING POTAB WATER AND SANITARY PIPING.
- 7. INSTALL NEW WALL MOUNTED HANDICAPPED HEIGHT LAVATORY. CONN TO EXISTING POTABLE WATER AND SANITARY PIPING.
- 8. NOT USED.
- 9. INSTALL NEW STRAINER AND SECONDARY TRAP PROTECTION DEVICE EXISTING FLOOR DRAIN. STRAINER SHALL MATCH EXISTING FLOOR DR

KEY PLAN

2014), PLUMBING.	945 N. PENNSYLVANIA AVENUE WINTER PARK, FLORIDA 32789
THE DRAWINGS ARE BASED ON THE OBTAINED FROM A LIMITED VISUAL SHALL INCLUDE A SUFFICIENT NAL INCIDENTAL DEMOLITION WORK AT OWNER.	OFFICE: (407) 629-1188 FAX: (407) 388-1220 WWW. ADCINTERNATIONAL.NET
WORK, THE CONTRACTOR SHALL ING TOILET AND URINALS, WHICH AND ROUGH—IN DIMENSIONS (WATER R EACH FIXTURE ON ALL FLOORS.	STATE OF FLORIDA AA-C001315
WORK, THE CONTRACTOR SHALL ING WALL CLEANOUTS AND FLOOR MAKE, MODEL, SHAPE, SIZE AND ACH CLEANOUT OR DRAIN ON ALL	ALBERT JOSEPH COOPER III, R.A. AR-0010460 Architect • Seal/Signature Project Documents for:
AN KEY NOTES: <	
D TOILET AND TEMPORARILY CAP R AND SANITARY PIPING TO ALLOW FOR RENOVATION DRAWINGS FOR ADDITIONAL	U
D HANDICAPPED HEIGHT TOILET AND URE POTABLE WATER AND SANITARY RENOVATION WORK. SEE RENOVATION RMATION.	F L O R I D A
d Urinal and temporarily cap ir and sanitary piping to allow for renovation drawings for additional	Project: INTERNAL OPERATIONS CENTER - I RESTROOM UPGRADES - ALL FLOORS
NTED LAVATORY AND TEMPORARILY CAP R AND SANITARY PIPING TO ALLOW FOR RENOVATION DRAWINGS FOR ADDITIONAL	450 E. SOUTH STREET ORLANDO, FL 32801 Issue Date & Issue Description Drawn By Checked By
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ED TOILET AND TEMPORARILY CAP R AND SANITARY PIPING TO ALLOW FOR RENOVATION DRAWINGS FOR ADDITIONAL	10.16.17         100% CD SET         MB/JJB         JLM           04.27.18         PERMIT SET         MB/JJB         JLM
D LAVATORY AND TEMPORARILY CAP R AND SANITARY PIPING TO ALLOW FOR RENOVATION DRAWINGS FOR ADDITIONAL	• SPACE
IN, REMOVE EXISTING FLOOR DRAIN WINGS FOR ADDITIONAL INFORMATION.	
ENERAL NOTES:	•
IED IN ACCORDANCE WITH THE FLORIDA 2014) AND THE FLORIDA BUILDING CODE G.	ORANGE COUNTY CAPITAL PROJECTS DIVISION 400 E SOUTH STREET 5th FLOOR
THE TOILET AND URINAL FIXTURE LOG AS NOTED ABOVE TO CONFIRM THE FIXTURES WILL MATCH THE EXISTING S AND CAN BE INSTALLED WITHOUT	ORLANDO, FL 32801  Project Number Issue Date
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NDICAPPED HEIGHT TOILET. CONNECT TO ANITARY PIPING.	
INAL. CONNECT TO EXISTING POTABLE	Consultant • Seal/Signature
AGE ACCESSORIES ON NEW INTEGRAL T TO EXISTING POTABLE WATER AND	No. 39503 STATE OF ZORIDA
OILET. CONNECT TO EXISTING POTABLE	No. 39503
NDICAPPED HEIGHT LAVATORY. CONNECT D SANITARY PIPING.	STATE OF ZORIDA
CONDARY TRAP PROTECTION DEVICE IN R SHALL MATCH EXISTING FLOOR DRAIN.	WILLIAM R HAYGOOD-FL39503
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Y PLAN	- PLUMBING DEMO
	AREA OF & RENO THIRD FLOOR PLAN
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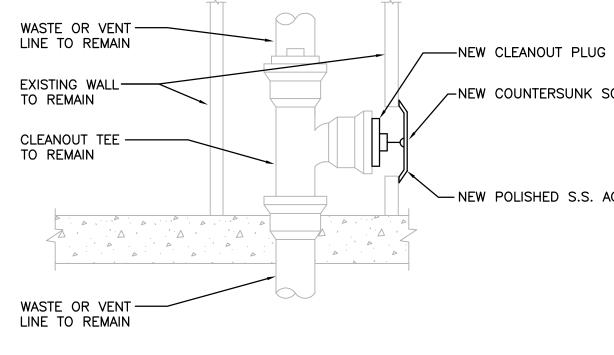
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μυυυυυι **EXISTING FLOOR DRAIN DETAIL** No Scale

20 26,

> NO

— REPLACE EXISTING SQUARE OR ROUND STRAINER



NOTE: SEE DRAWING P02.01 FOR QUANTITY AND LOCATIONS.

**EXISTING WALL CLEANOUT DETAIL** NOT TO SCALE

NEW POLISHED S.S. ACCESS COVER

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	945 N. PENNSYLVANIA AVENUE WINTER PARK, FLORIDA 32789 OFFICE: (407) 629-1188 FAX: (407) 388-1220 WWW. ADCINTERNATIONAL.NET
	STATE OF FLORIDA AA-C001315 ALBERT JOSEPH COOPER III, R.A. AR-0010460 Architect • Seal/Signature
	Project Documents for:
• SPACE PLANNING	Issue     Date & Issue Description     Drawn By     Checked By       08.18.17     90% CD SET     MB/JJB     JLM       10.16.17     100% CD SET     MB/JJB     JLM       04.27.18     PERMIT SET     MB/JJB     JLM
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	1'x4' FLUORESCENT FIXTURE 2'x2' FLUORESCENT FIXTURE 2'x4' FLUORESCENT FIXTURE	 ⊕ ⊕ ₩	SINGLE RECEPTACLE DUPLEX RECEPTACLE
•		and the second sec	
	Z X4 FLOURESCENT FIATURE	e=	DOUBLE DUPLEX RECEPTACLE ABOVE COUNTER DUPLEX RECEPTACLE
<u> </u>	4' WALL MOUNT FLUORESCENT LUMINAIRE	₽	DUPLEX RECEPTACLE, HALF SWITCHED
	4' WALL MOUNT FLUORESCENT LUMINAIRE, EMERGENCY	0	SPECIAL PURPOSE RECEPTACLE
	1'x4' FLUORESCENT FIXTURE, BATTERY/EMERGENCY	Ç⊕-	BLACK DUPLEX RECEPTACLE FOR COMPUTER WORKSTATION
	2'x2' FLUORESCENT FIXTURE, BATTERY/EMERGENCY	c <sub>∰</sub>	BLACK QUAD RECEPTACLE FOR COMPUTER WORKSTATION
	2'x4' FLUORESCENT FIXTURE, BATTERY/EMERGENCY	÷	CEILING MOUNTED RECEPTACLE
		Ð	RECESSED FLOOR RECEPTACLE
	4' FLUORESCENT STRIP FIXTURE 4' FLUORESCENT STRIP FIXTURE, BATTERY/EMERGENCY	 	DUPLEX RECEPTACLE, GROUND FAULT
	4' FLUORESCENT STRIP FIXTURE, WALL MOUNTED	8	DUPLEX RECEPTACLE, GROUND FAULT, ABOVE COUNTER
	4' FLUORESCENT STRIP FIXTURE, WALL MOUNTED,	<b>=</b>	QUAD RECEPTACLE, GROUND FAULT
	BATTERY/EMERGENCY	PP	POWER POLE
	TRACK FIXTURE CEILING MOUNTED RECESSED, DOWN LIGHT		DISCONNECT SWITCH
-	CEILING MOUNTED RECESSED, EMERGENCY DOWN LIGHT	J	JUNCTION BOX
	CEILING MOUNTED RECESSED, WALL WASHER (ARROW	Ū	FLOOR MOUNTED JUNCTION BOX
-	NDICATES DIRECTION OF WASH)	 [C]	EQUIPMENT CONNECTION
	SURFACE MOUNTED LIGHTING FIXTURE	•	DOOR BELL PUSH BUTTON
	WALL MOUNTED SCONCE FIXTURE, BATTERY/EMERGENCY EMERGENCY LIGHT FIXTURE	T	TRANSFORMER
		_⊂H	DOOR BELL
	SINGLE FACE EXIT LIGHT FIXTURE ARROW INDICATES DIRECTION OF EGRESS	$\overline{\mathcal{O}}$	MOTOR
	DOUBLE FACE EXIT LIGHT FIXTURE ARROW INDICATES DIRECTION OF EGRESS		GROUND BUS BAR
SWITCHE			
	SWITCH	FIRE AL	ARM SYSTEM
\$2 s \$3 s	SWITCH, 2 POLE		
Ş3 S	SWITCH, 3-WAY	P	MANUAL FIRE ALARM PULL STATION
<u> </u>	Motor Rated Switch Dimmer Switch	Sd	FIRE ALARM COMBINATION SPEAKER/STROBE DEVICE (75 CANDELA MINIMUM, 110 CANDELA WHERE NOTED)
ŦŬ	G CONTROL DEVICES		FIRE ALARM COMBINATION HORN/STROBE DEVICE (75 CANDELA MINIMUM, 110 CANDELA WHERE NOTED)
		ŀФ	FIRE ALARM STROBE ONLY, 75 CANDELA MINIMUM
	*PIR-CEILING MOUNT SENSOR 24 VDC/VAC, 11mA, WATTSTOPPER CI-205 OR EQUAL.	•	FIRE ALARM SPEAKER - CEILING MOUNTED
	*DUAL ULTRASONIC/PIR-CEILING MOUNT SENSOR, 24	€ ⊐⊲	FIRE ALARM SPEAKER - WALL MOUNTED
_	VDC/VAC, 35mA. WATTSTOPPER DT-305 OR EQUAL.		135" HEAT DETECTOR
	*DUAL ULTRASONIC/PIR-WALL MOUNT SENSOR, 24 VAC/VDC, 35mA. WATTSTOPPER DT-205 OR EQUAL.	© <sub>F</sub> ⊕ <sub>R</sub>	HEAT DETECTOR - RATE OF RISE ONLY
	*ULTRASONIC-CEILING CORRIDOR MOTION SENSOR, 24		
Ť (	VDC/VAC, 40mA. WATTSTOPPER WT-2250 OR EQUAL. PIR-WALL SWITCH DECORATOR MOTION SENSOR, 120/277 VAC,	() <sub>R/F</sub>	HEAT DETECTOR - COMBINATION: RATE OF RISE AND FIXED TEMP
الحا	800/1200W. WATTSTOPPER PW-100 OR EQUAL.	(2)	SMOKE DETECTOR
	DUAL ULTRASONIC/PIR-WALL SWITCH DECORATOR MOTION SENSOR, 120/277VAC, 800/1200W. WATTSTOPPER DW-100 OR EQUAL.	<sup>s</sup> @=-	DUCT SMOKE DETECTOR - "R" = RETURN, "S" = SUPPLY. PROVIDE LED SUPERVISORY INDICATOR FOR BOTH DETECTORS IN AN ACCESSIBLE LOCATION AND CLEARLY LABELED.
N IN	DUAL ULTRASONIC/PIR-DUAL RELAY WALL SWITCH DECORATOR MOTION SENSOR, 120/277VAC, 800/1200W. WATTSTOPPER	-®2	DUCT SMOKE DETECTOR REMOTE TEST INDICATOR
	DW-200 OR EQUAL. DUAL ULTRASONIC/PIR-MULTI-WAY WALL SWITCH DECORATOR	AM	ADDRESSABLE INPUT MODULE
	WOTION SENSOR, 120/277VAC, 800/1200W. WATTSTOPPER DW-103 OR EQUAL	<b>A00</b>	ADDRESSABLE OUTPUT MODULE
	POWER PACK 120/277 VAC; 20 AMPS, 225mA SECONDARY.	MM	MONITOR MODULE
	WATTSTOPPER BZ-150 OR EQUAL.	CM	CONTROL MODULE RELAY
F	*FOR LOW VOLTAGE OCCUPANCY SENSORS, PROVIDE POWER PACK(S) 120/277 VAC; 20 AMPS, 225mA SECONDARY AS NEEDED FOR ZONE/AREA CONTROL. WATTSTOPPER BZ-150 OR	<u>, WF</u> ,	WEATHERPROOF WATER FLOW SWITCH MONITOR MODULE CONNECTED TO SPRINKLER SYSTEM
	EQUAL.	<u>, VS</u> ,	WEATHERPROOF TAMPER SWITCH MONITOR MODULE CONNECTED TO FIRE SPRINKLER SYSTEM
POWER [	DISTRIBUTION	"FACU"	FIRE ALARM CONTROL UNIT "FACU"
	20/208V PANELBOARD, RECESSED	<u>"FAAP"</u>	FIRE ALARM ANNUNCIATOR PANEL "FAAP"
	20/208V PANELBOARD, SURFACE MOUNT	<u>"FAIC"</u>	FIRE ALARM TERMINAL CABINET "FATC", NEMA 1 RATED
	277/480V PANELBOARD, SURFACE MOUNT	<u>"FACP"</u>	FIRE ALARM CONTROL PANEL "FACP"
	277/480V PANELBOARD, RECESSED FEEDER OR BRANCH CIRCUIT CONCEALED IN WALL,	_	
	CEILING OR FLOOR	PREMIS	E DISTRIBUTION SYSTEM
1R1-1 C	HOMERUN CONSISTING OF ONE SINGLE-PHASE, 1-POLE CIRCUIT: (2) 12 AWG + (1) 12 AWG GND IN 3/4" CONDUIT, JNLESS OTHERWISE NOTED. PANELBOARD AND CIRCUIT DESIGNATION ARE INDICATED.		<ul> <li>MOUNTING 3" ABOVE COUNTER OR BACK SPLASH</li> <li>X = MOUNTING (F)LUSH, (S)URFACE, (M)ODULAR FURNITURE ADAPT (P)OLE, (R)ACEWAY, (D)OUBLE GANG FLUSH, (PD) PEDESTAL</li> </ul>
1M1-1:5 C	HOMERUN CONSISTING OF ONE SINGLE-PHASE, 2-POLE CIRCUIT: (2) 12 AWG + (1) 12 AWG GND IN 3/4" CONDUIT, JNLESS OTHERWISE NOTED. PANELBOARD AND CIRCUIT		— N = # OF DATA JACKS COMMUNICATIONS "INFORMATION OUTLET" MOUNTED. AT RECEPTA
D	DESIGNATIONS ARE INDICATED. HOMERUN CONSISTING OF TWO SINGLE—PHASE CIRCUITS: (3)	° <b>⊲</b> × Ň	HEIGHT UNLESS OTHERWISE NOTED. MODULE AND FACEPLATE <u>SPECIAL NOTES:</u>
1R1-1,3 1 C A	2 AWG + (1) 12 AWG GND IN 3/4" CONDUIT, UNLESS DTHERWISE NOTED. PANELBOARD AND CIRCUIT DESIGNATION ARE INDICATED.		1. DATA JACKS: EACH RJ45 CAT6 JACK FOR DATA SHALL BE CONNECTED TO A DEDICATED UTP 4 PR CAT6 CABLE
1R1–1,3,5 (	HOMERUN CONSISTING OF THREE SINGLE—PHASE CIRCUITS: (4) 12 AWG + (1) 12 AWG GND IN 3/4" CONDUIT, UNLESS DTHERWISE NOTED. PANELBOARD AND CIRCUIT DESIGNATIONS ARE INDICATED.		WALL TELEPHONE OUTLET FOR HOUSE PHONE. MOUNTED AT 52" AE FINISHED FLOOR TO TOP. WALL DATA OUTLET. SURFACE MOUNTED AT 48" ABOVE FINISHED
1M1-1:3:5 H	HOMERUN CONSISTING OF ONE THREE-PHASE CIRCUITS: (3) 12 AWG + (1) 12 AWG GND IN 3/4" CONDUIT, UNLESS 14 DITHERWISE NOTED. PANELBOARD AND CIRCUIT DESIGNATIONS		FLOOR TO TOP OF BACKBOX. $X = #$ OF DATA JACKS FLOOR BOX DATA OUTLET. DATA OUTLET INSTALLED IN FLOOR BOX
	ARE INDICATED.		UTP HOMERUN TO COMM ROOM. $X = #$ OF DATA JACKS 3/4" PLYWOOD BACKBOARD. BY DIVISION 16
		TV	TELEVISION OUTLET MOUNTED AT 96" ABOVE FINISHED FLOOR. PRO' SQUARE BACKBOX, SINGLE GANG P-RING, 1" CONDUIT TO ACCESSII CEILING SPACE, AND (2) CAT-6 CABLE TO CLOSEST IDF ROOM.

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### **ABBREVIATIONS**

A	AMPERES	INC	INCANDESCENT
AE	AUDIO ENHANCEMENT	JB	JUNCTION BOX
AFC	ABOVE FINISHED CEILING	kV	KILO-VOLTS
AFF	ABOVE FINISHED FLOOR	kVA	KILO-VOLTS-AMP
AFG	ABOVE FINISHED GRADE	kvar	KILO-VOLTS-
AIC	AMPERES INTERRUPTING		AMPERES REACTIV
	CAPACITY	kW	KILO-WATTS
AL	ALUMINUM	kWH	KILO-WATT-HOUF
AWG	AMERICAN WIRE GAUGE	LTG	LIGHTING
BFC	BELOW FINISHED CEILING	m	METER
BFG	BELOW FINISHED GRADE	mm	MILLIMETER
С	CONDUIT	MAX	MAXIMUM
CAB	CABINET	MCB	MAIN CIRCUIT BR
CFCI	CONTRACTOR FURNISHED	MCC	MOTOR CONTROL
	CONTRACTOR SUPPLIED	MCP	MOTOR CIRCUIT I
CKT	CIRCUIT	MFR	MANUFACTURER
CLG	CEILING	MH	METAL HALIDE
CL	CENTERLINE	MIN	MINIMUM
CT's	CURRENT TRANSFORMERS	MISC	MISCELLANEOUS
CU	COPPER	MTR	MOTOR
DISC	DISCONNECT(ING)	MTD	MOUNTED
DWG	DRAWING(S)	MTG	MOUNTING
EA	EACH	NEC	NATIONAL ELECTR
EF	EXHAUST FAN	ofoi	OWNER FURNISHE
EMT	ELECTRICAL METALLIC TUBING		OWNER INSTALLE
EQUIP	EQUIPMENT	PNL	PANEL
EUH	ELECTRIC UNIT HEATER	PSI	PULL STATION IN
EWC	ELECTRIC WATER COOLER	PVC	POLYVINYL CHLO
EWH	ELECTRIC WATER HEATER	REC	RECEPTACLE
EXH	EXHAUST	RGS	RIGID GALVANIZE
EXIST	EXISTING	TEL	TELEPHONE
EXP	EXPLOSION PROOF	TYP	TYPICAL
FA	FIRE ALARM	UON	UNLESS OTHERWI
FLA	FULL LOAD AMPERES	V	VOLTS
FLUOR	FLUORESCENT	VA	VOLT-AMPERES
GFCI	GROUND FAULT CIRCUIT	VFD	VARIABLE FREQUE
	INTERRUPTER	Ŵ	WATTS
GFP	GROUND FAULT PROTECTION	ŴР	WEATHER PROOF
GND	GROUND	XFMR	TRANSFORMER
HGT	HEIGHT	<i>/</i>	In a non on an En
HID	HIGH INTENSITY DISCHARGE		
HPS	HIGH PRESSURE SODIUM		
HOA	HAND-OFF-AUTOMATIC		
HP	HORSEPOWER		
HVAC	HEATING/VENTILATING/		
11740	AIR CONDITIONING		
HV	HIGH VOLTAGE		

TS-AMPERES ATTS ATTS ATT-HOURS ER M IRCUIT BREAKER CONTROL CENTER CIRCUIT PROTECTOR ICTURER HALIDE ANEOUS ng Al Electrical Code Furnished Installed TATION INSIDE ACLE ALVANIZED STEEL NE OTHERWISE NOTED mperes Le frequency drive r proof Drmer

NITOR MODULE CONNECTED TO FIRE MODULE CONNECTED TO FIRE (M)ODULAR FURNITURE ADAPTER FLUSH, (PD) PEDESTAL

TLET" MOUNTED. AT RECEPTACLE MODULE AND FACEPLATE SHALL BE CONNECTED TO A PHONE. MOUNTED AT 52" ABOVE ET INSTALLED IN FLOOR BOX WITH # OF DATA JACKS


' ABOVE FINISHED FLOOR. PROVIDE 4" RING, 1" CONDUIT TO ACCESSIBLE BLE TO CLOSEST IDF ROOM.

	ARCHITEC	TURAL DESIGN C	OLLABORATIVE
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OFFICE	R PARK, FLC : (407) 629-1 )7) 388-1220		
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## **GENERAL NOTES:**

- REFER TO SYMBOL LEGEND ON DRAWING E0.01
- b. REFER TO SPECIFICATIONS IN PROJECT MANUAL.



945 N. PENNSYLVANIA AVENUE WINTER PARK, FLORIDA 32789 OFFICE: (407) 629-1188 FAX: (407) 388-1220

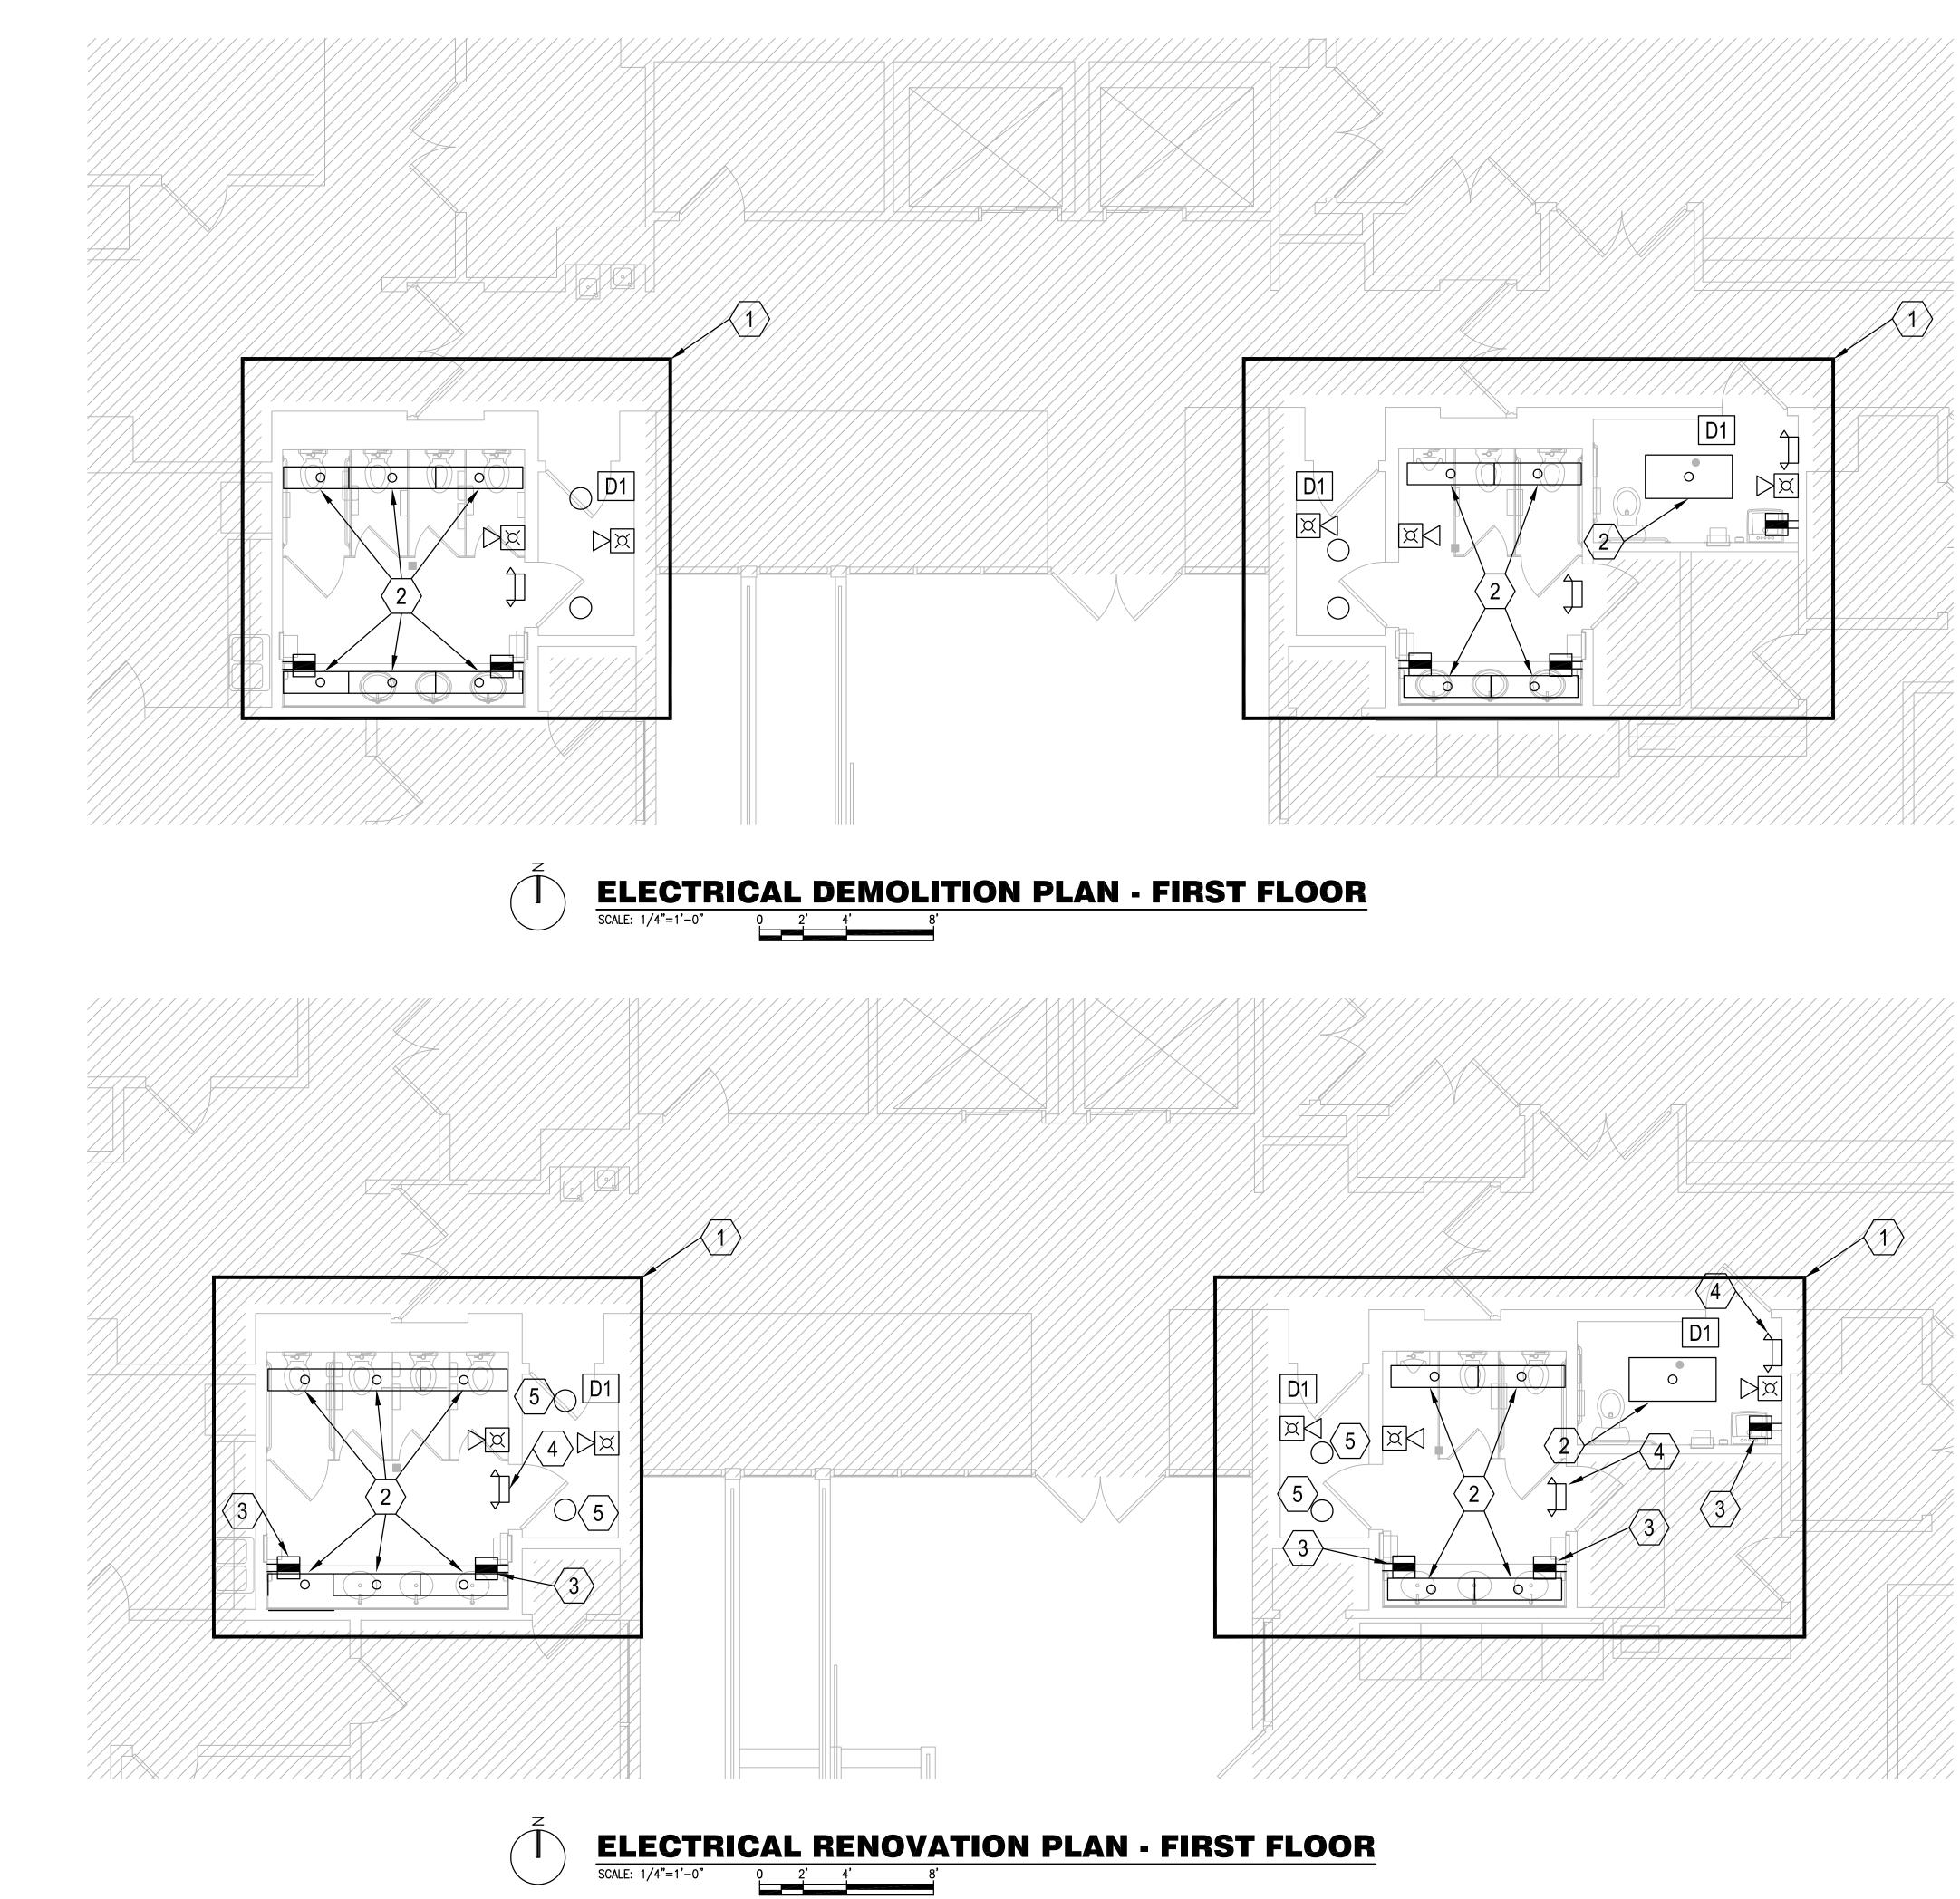
PLAN KEY NOTES DEMO: (#)

- . REMOVE ALL ELECTRICAL DEVICES/FIXTURES AS REQUIRED TO FACILITATE THE REFINISHING OF WALLS.
- 2. REMOVE EXISTING PRISMATIC LENS AND FLUORESCENT LAMPS FROM FIXTURE. PREPARE FOR REPLACING WITH NEW.

### PLAN KEY NOTES RENO: (#)


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- 3. REPLACE EXISTING GFCI RECEPTACLE WITH NEW WHITE GFCI RECEPTACLE AND NEW WALL PLATE.
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### **KEY PLAN**



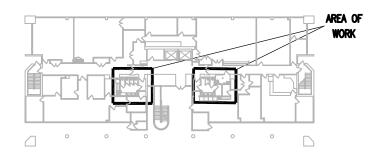


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## **GENERAL NOTES:**

- a. REFER TO SYMBOL LEGEND ON DRAWING E0.01
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PLAN KEY NOTES DEMO: (#)
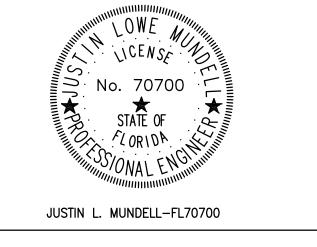
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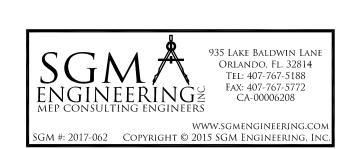
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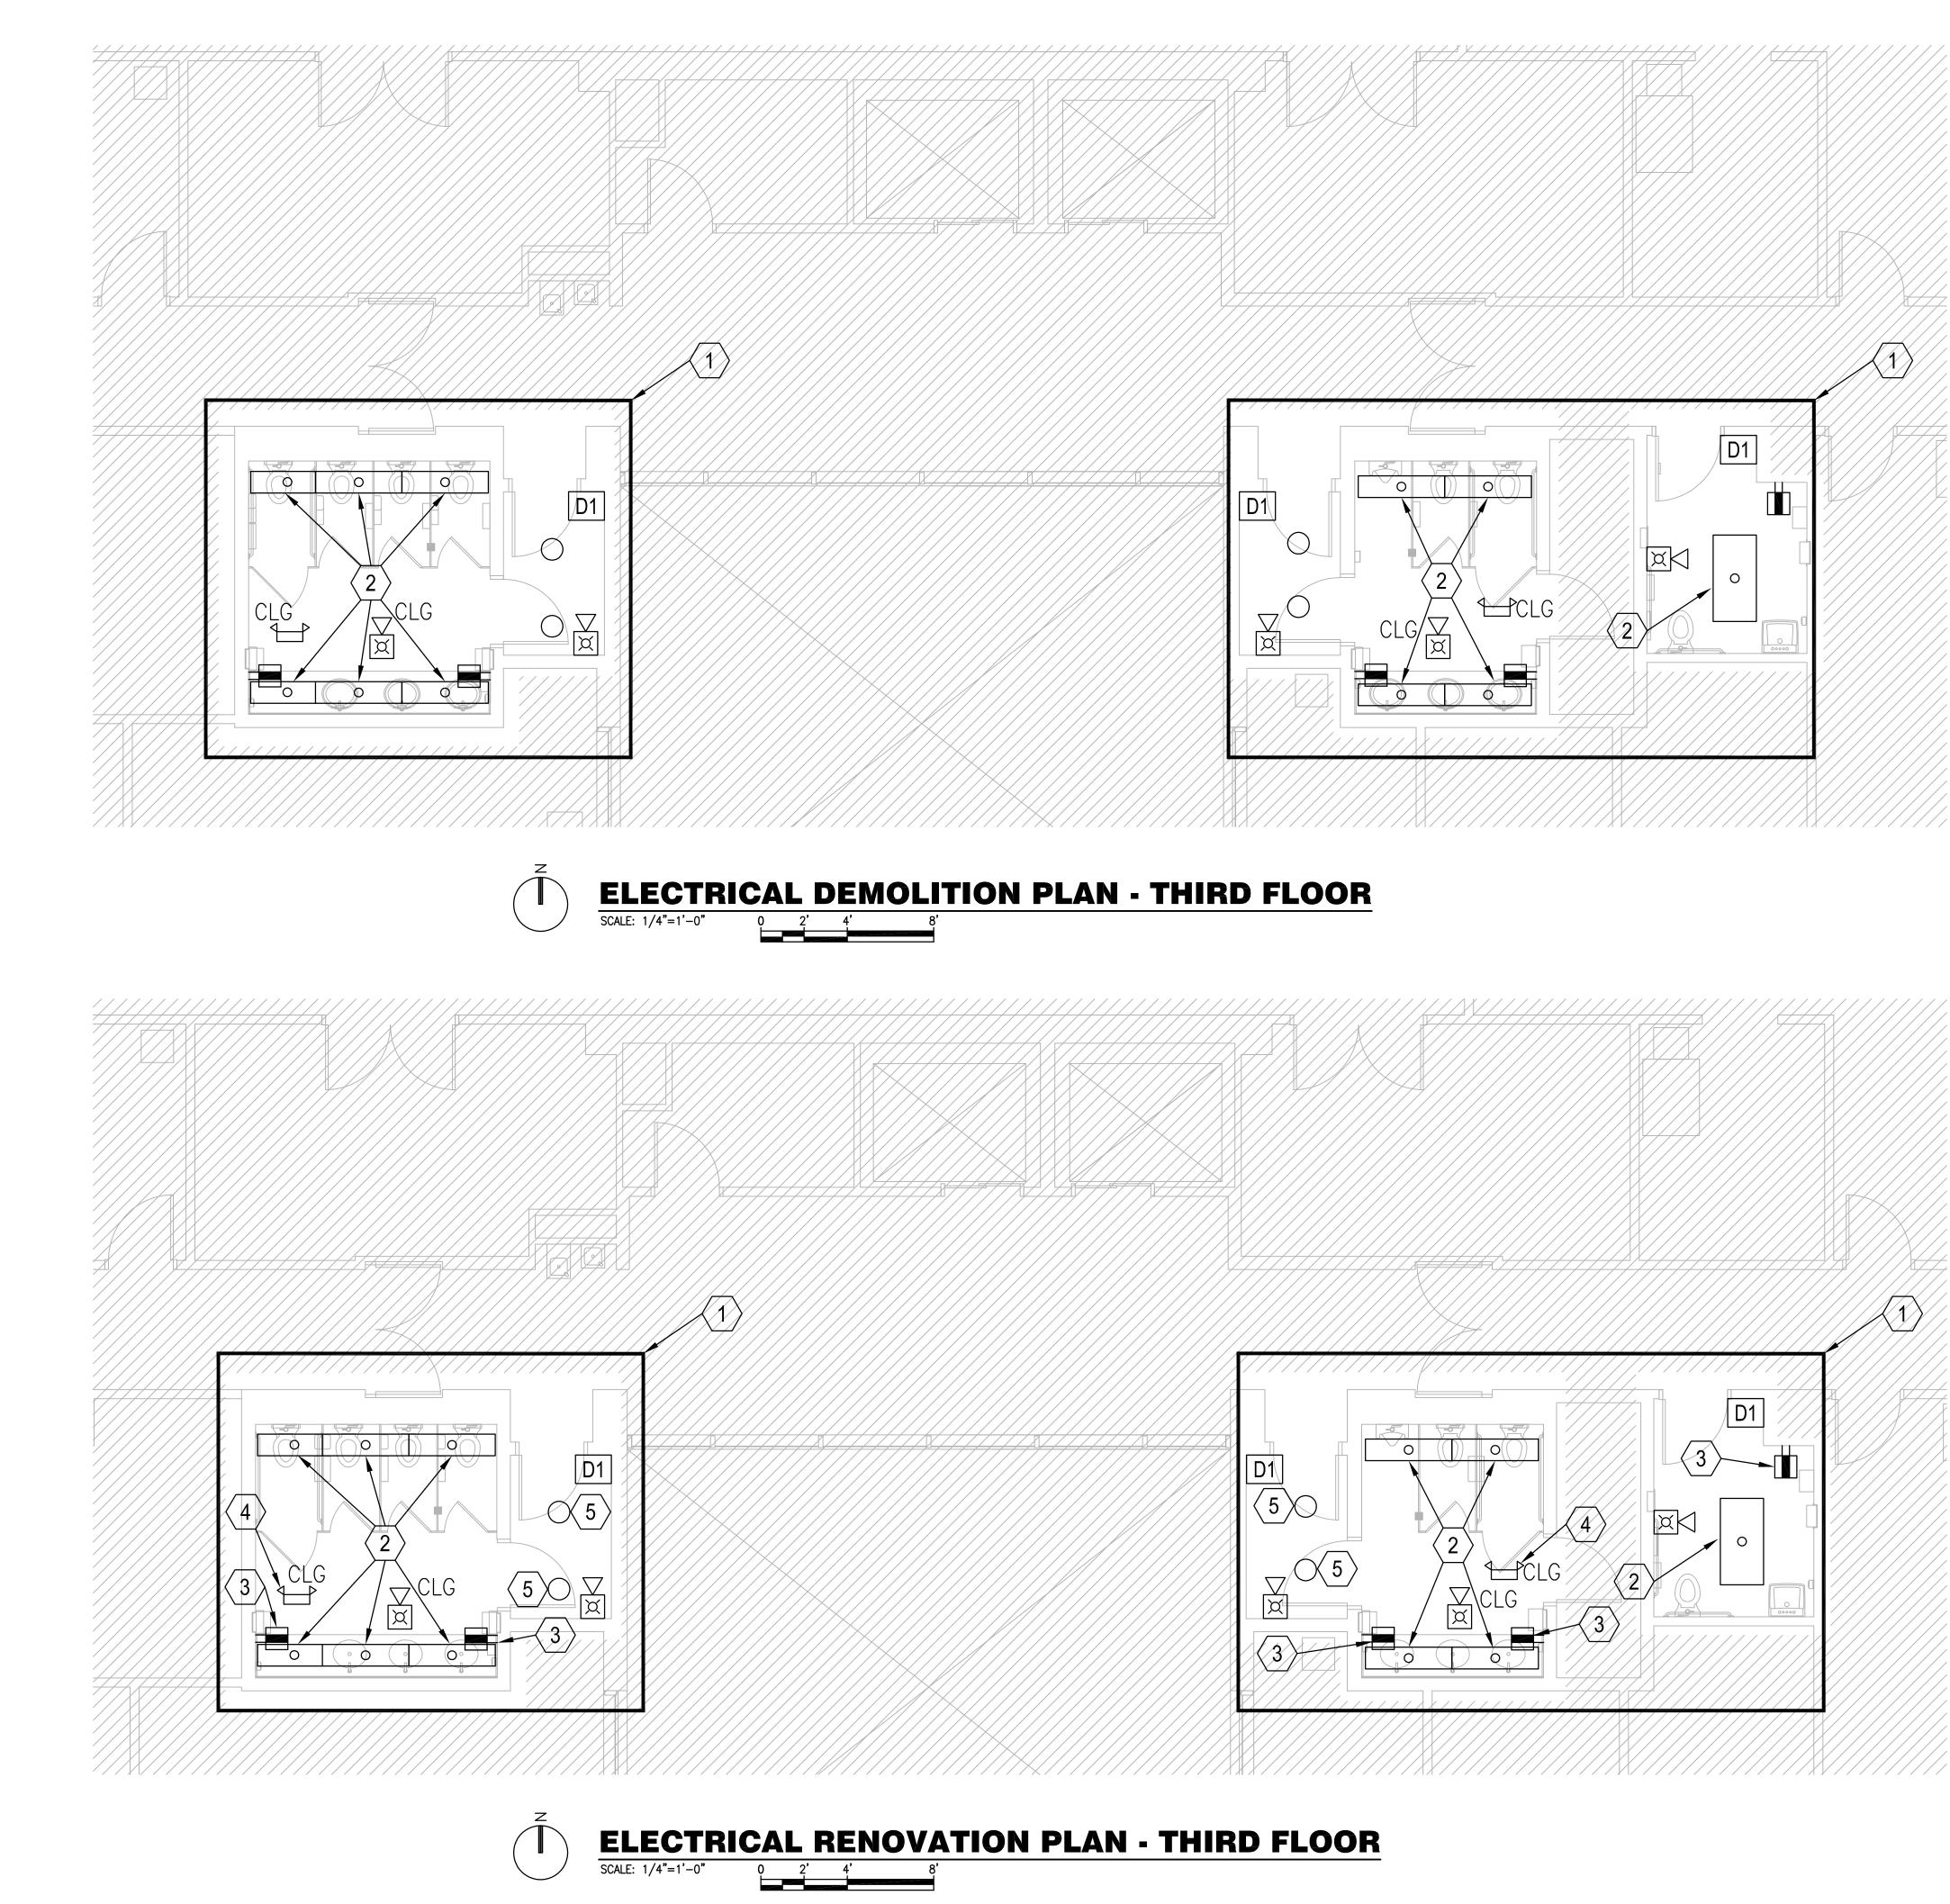
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KEY PLAN

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## **GENERAL NOTES:**

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FLOOR PLAN

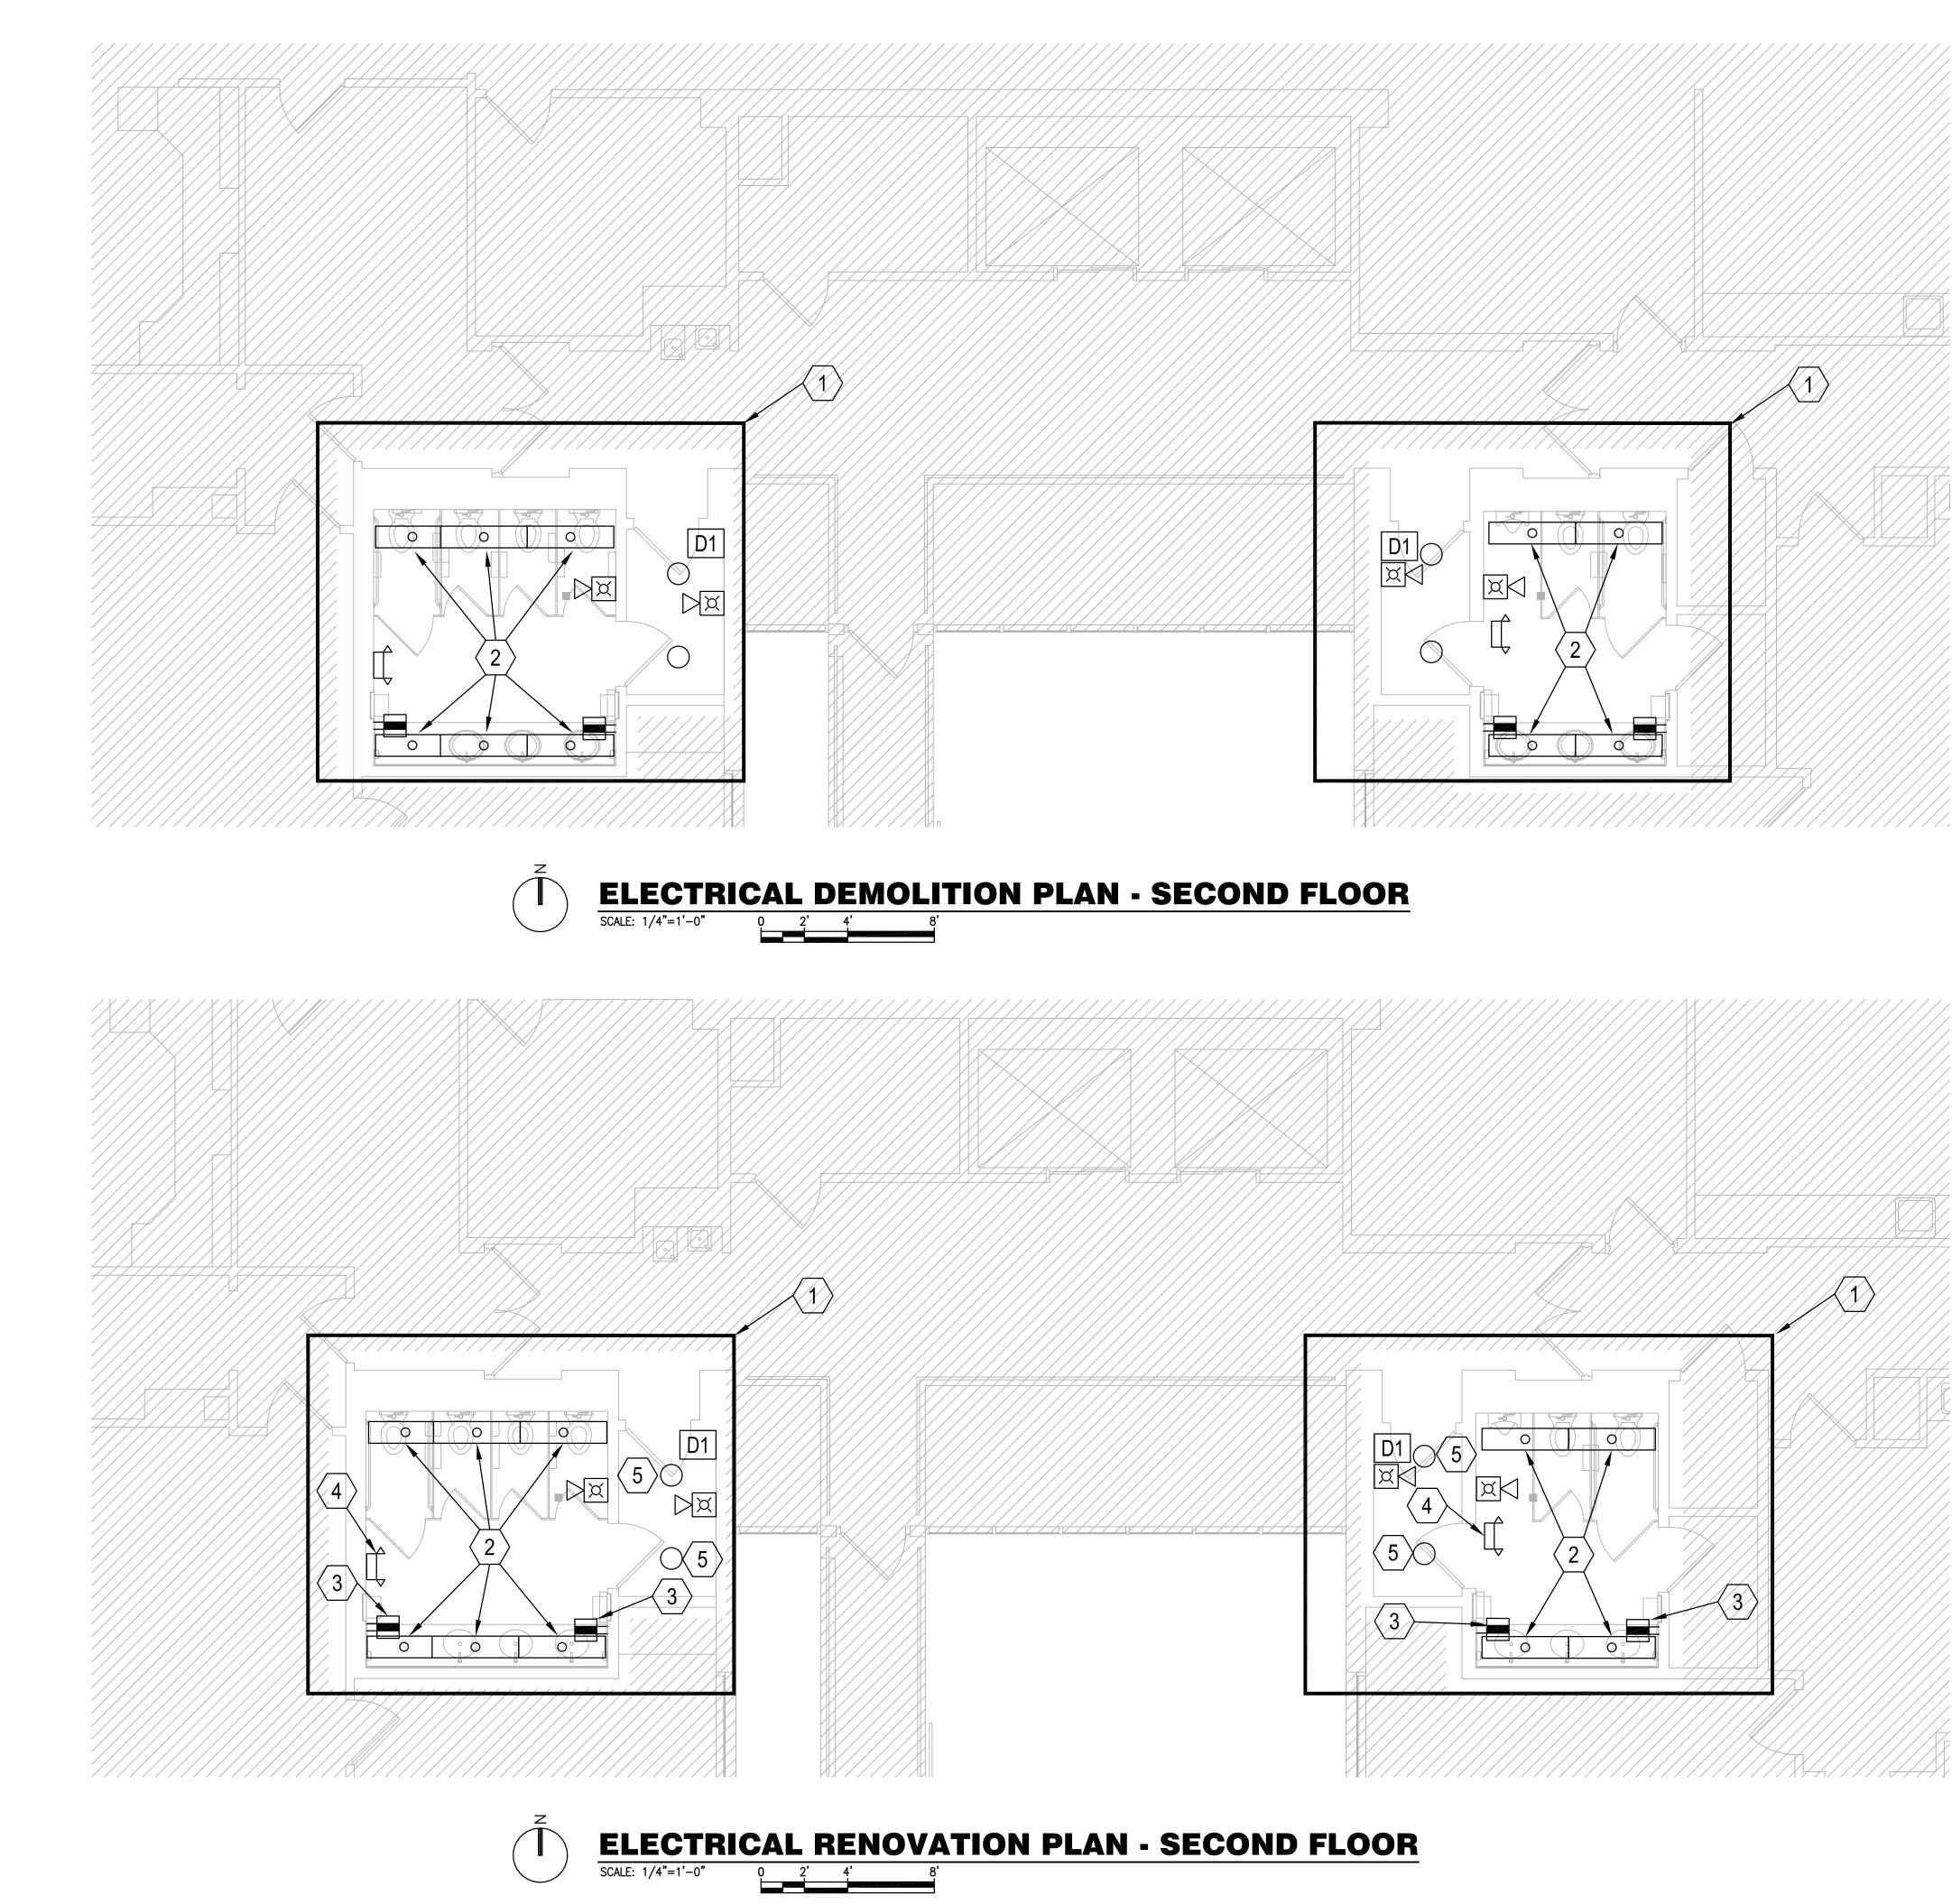