

MOUNTING FOR MULTIPLE OR LARGE ENCLOSURES

CONCRETE POST SEE DETAIL ON DRAWING SD-1 1-5/8" x 1-5/8" x 12" GA. — 316 SS UNISTRUT. B-LINE SERIES 22. NUMBER OF PIECES & LENGTHS AS REQUIRED PVC END CAP ELECTRICAL EQUIPMENT (AS REQUIRED) SEE NOTE 3 - TOP OF FINISHED GRADE

MOUNTING FOR SINGLE SMALL ENCLOSURES

NOTES:

- ALL EDGE OF UNISTRUT SHALL BE FILED SMOOTH.
- ALL FASTENING AND MOUNTING HARDWARE SHALL BE 316 SS.
- PROVIDE CONCRETE MAINTENANCE PAD EXTENDING 4 INCES BEYOND THE FRONT OF THE ELECTRICAL EQUIPMENT.

TYPICAL ELECTRICAL EQUIPMENT MOUNTING DETAILS

2605-501

VERIFY SCALE BAR IS ONE INCH ON ORIGINAL DRAWING.

0 11 1"
IF NOT ONE INCH ON THIS SHEET, ADJUST SCALES ACCORDINGLY.

CH2M HILL ENGINEERS, INC 225 EAST ROBINSON ST SUITE 505 ORLANDO, FL 32801 FL COA: 25861 FL AB: AAC001992

NEEL-SCHAFFER, INC 2301 LUCIEN WAY, SUITE 300 FL COA: 8556

MAITLAND, FLORIDA 32751

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DESIGNED EC DATE APR 2019 DRAWN DATE APR 2019 EC CHECKED DN DATE AUG 2019 DN DATE AUG 2019 APPROVED

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NEEL-SCHAFFER
SOLUTIONS YOU CAN BUILD UPON CONSTRUCTION PLANS FOR

ELECTRICAL STANDARD DETAILS ORANGE COUNTY LANDFILL CELL 11 BAY 17 - 19 EXPANSION ORANGE COUNTY SOLID WASTE DIVISION ORANGE COUNTY, FLORIDA


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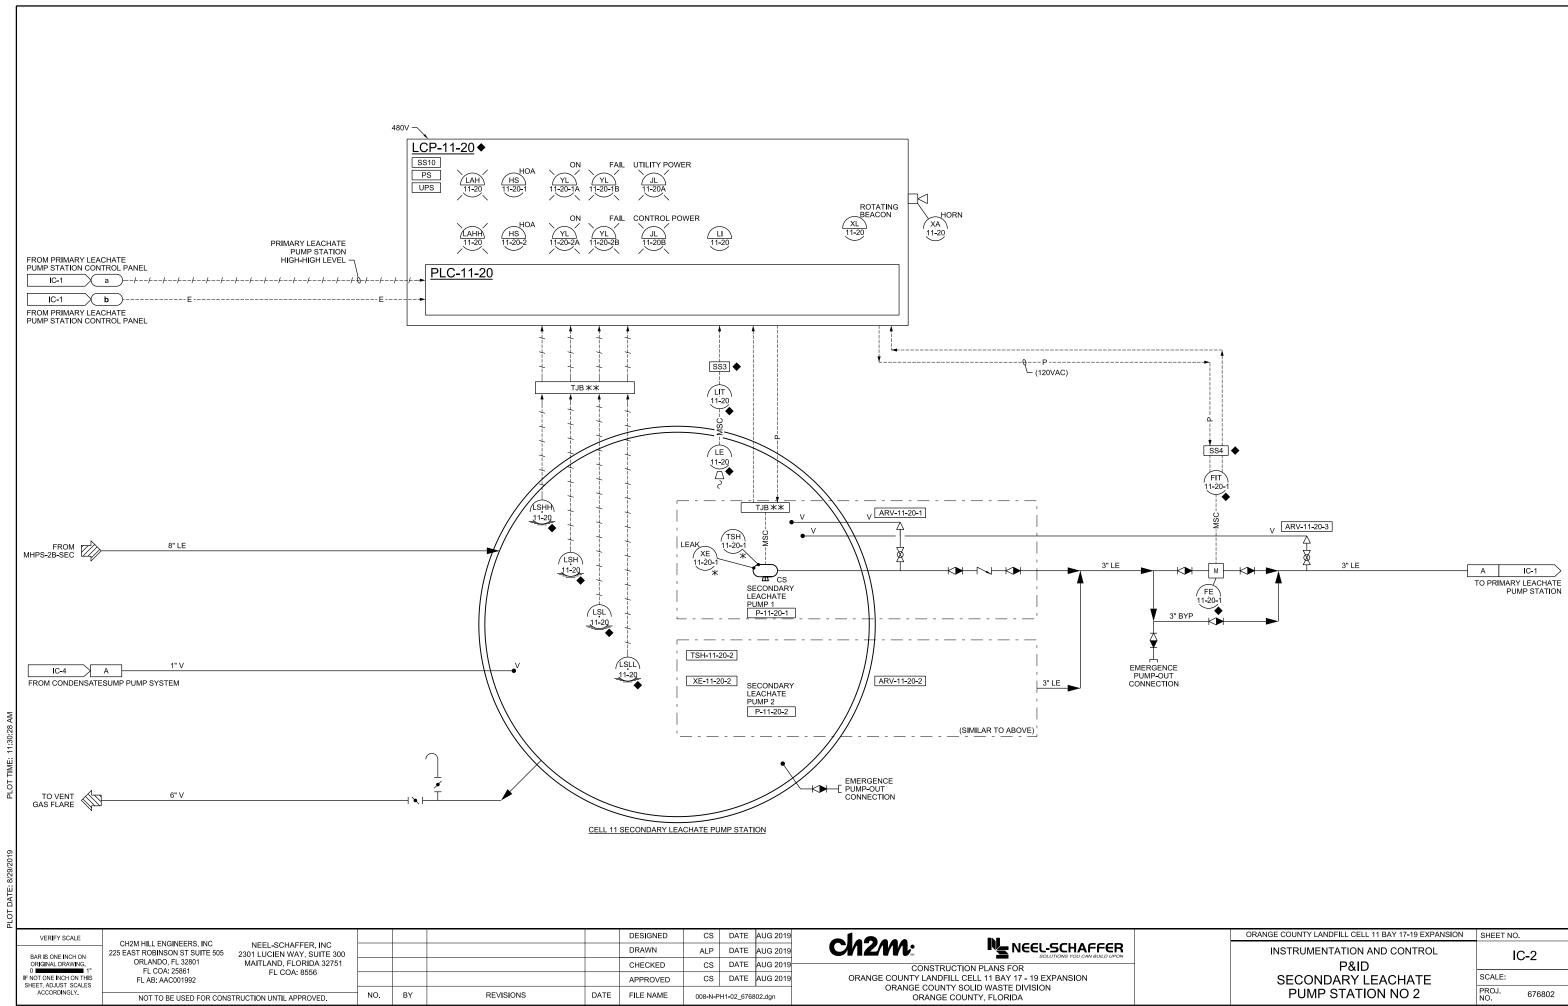
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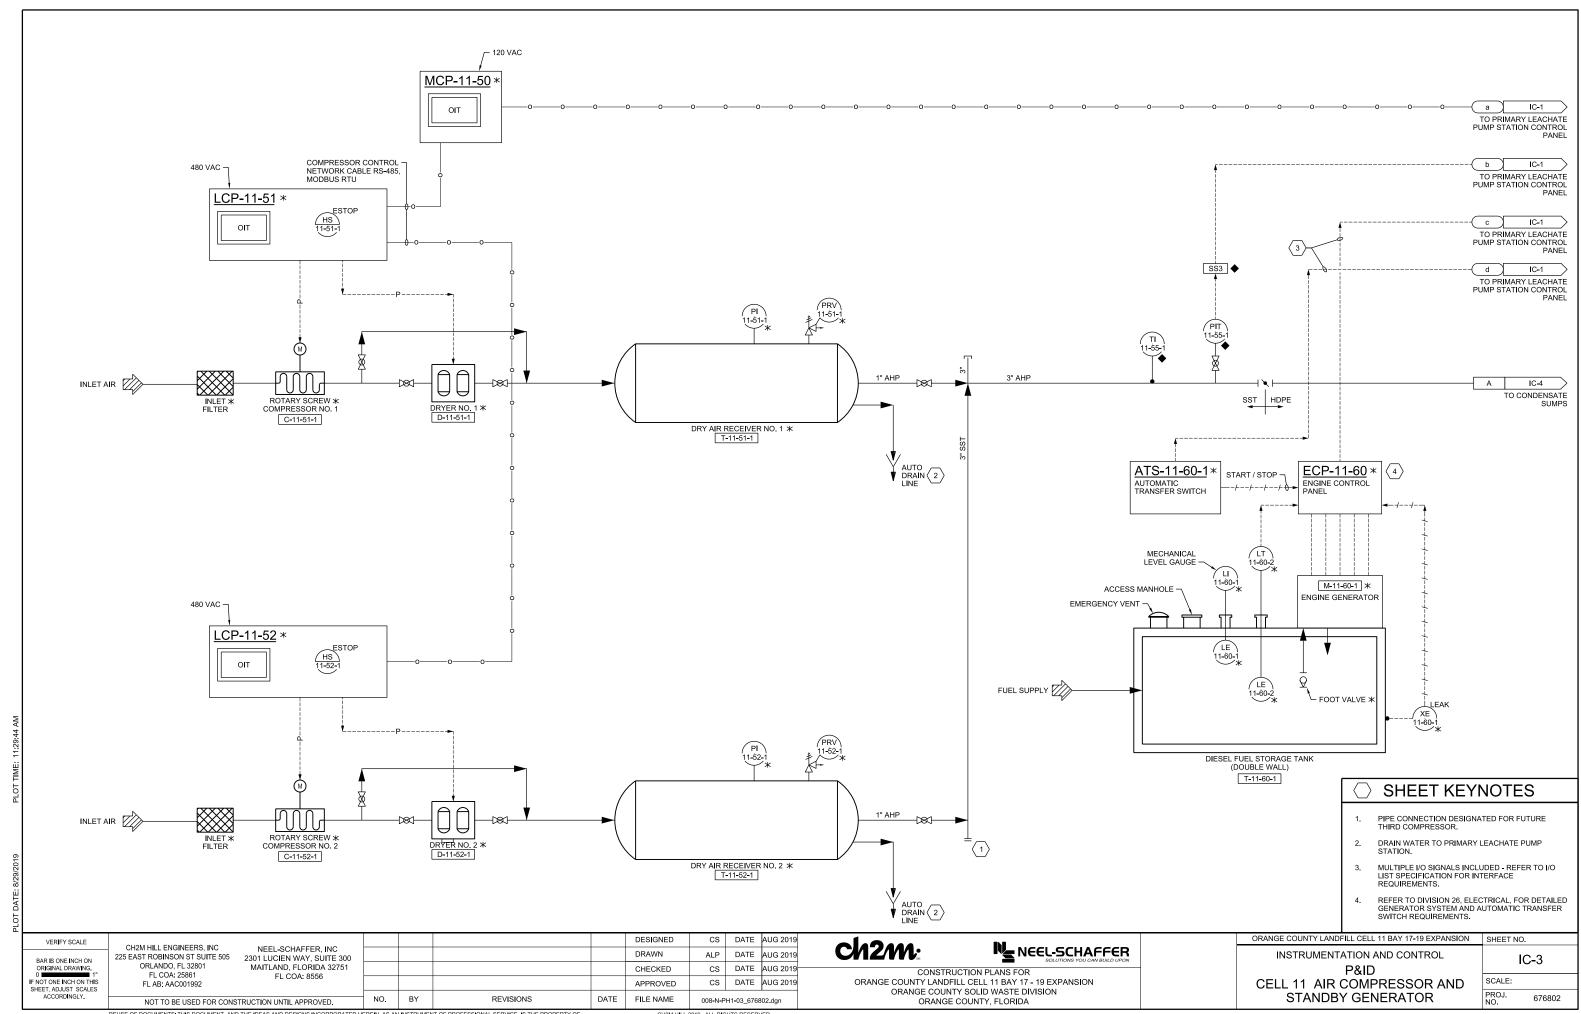
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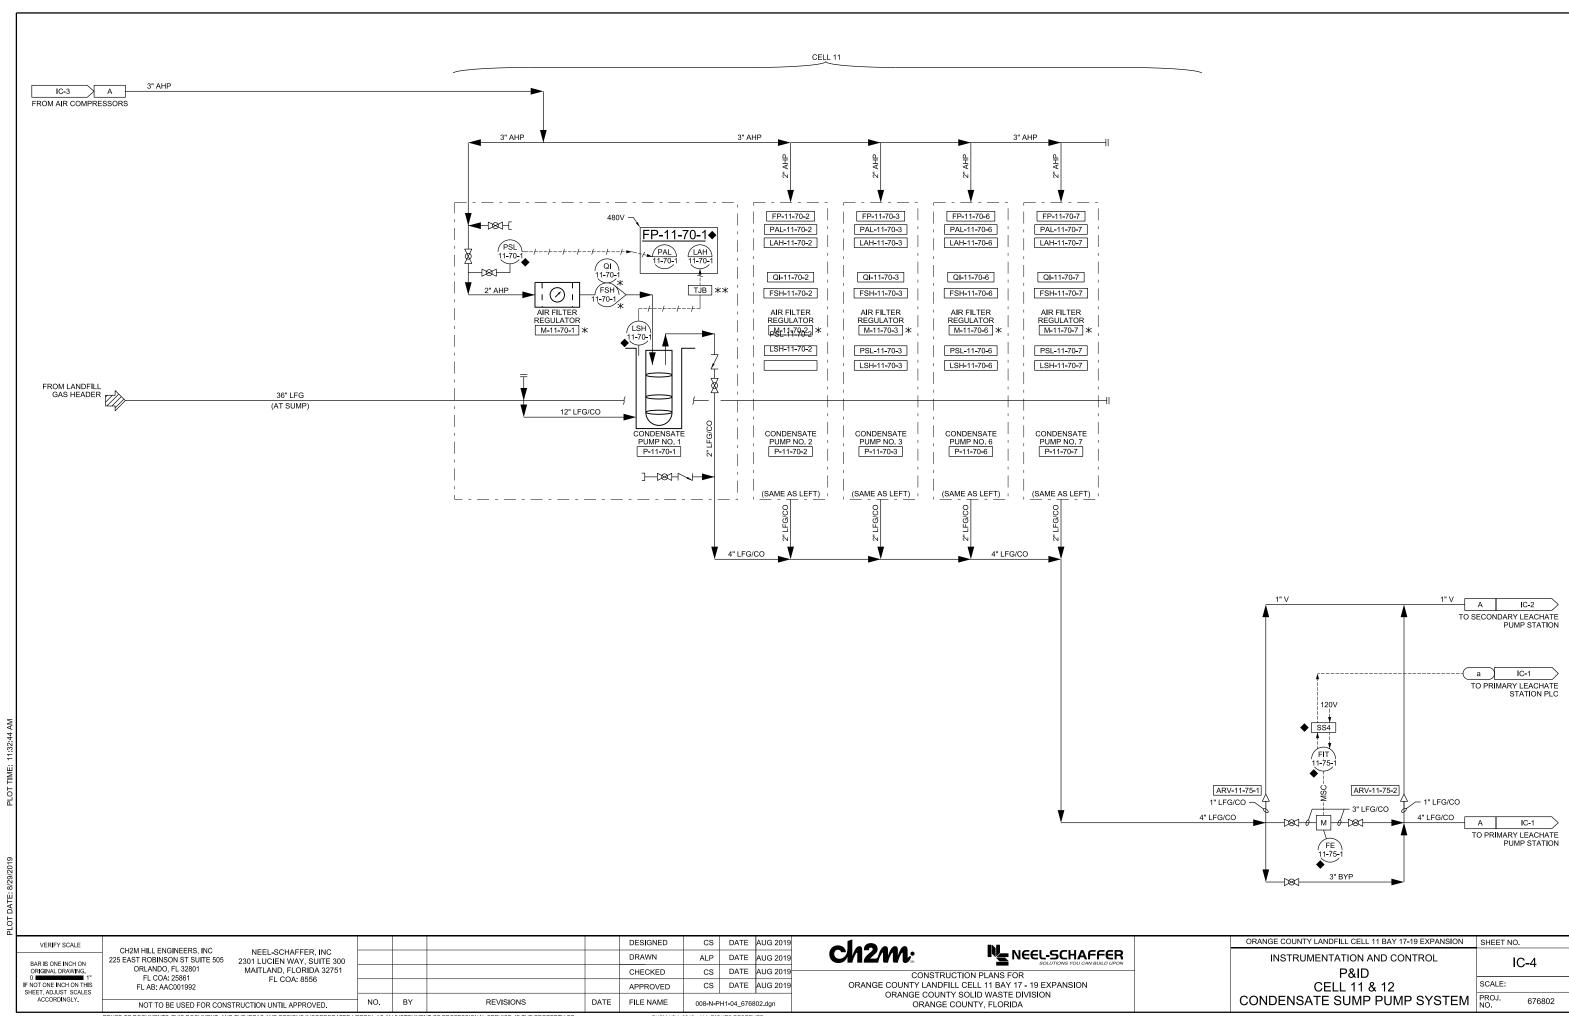
FILE NAME 095-E-5007_676802.dgn CH2M HILL 2019. ALL RIGHTS RESERVED.


DATE







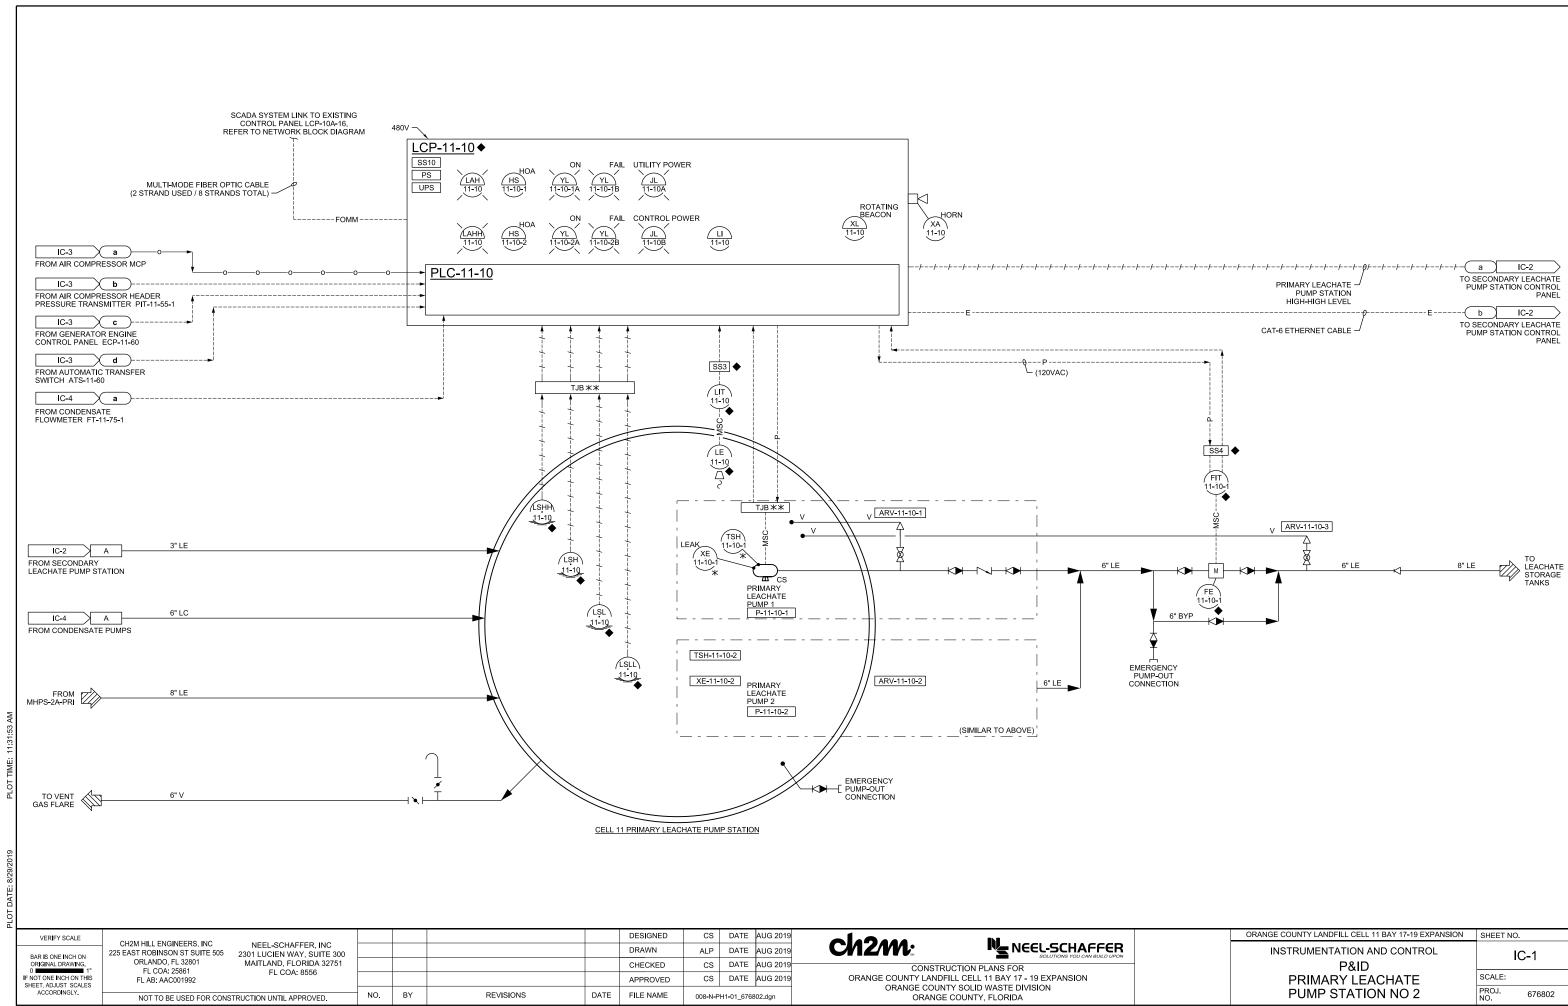

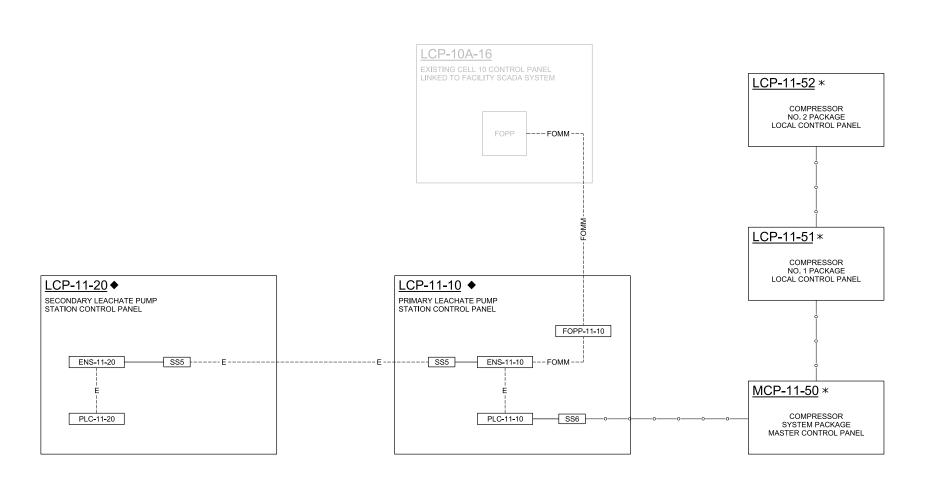

LEGEND:

ENS = ETHERNET SWITCH

FOPP = FIBER-OPTIC PATCH PANEL

LCP = LOCAL CONTROL PANEL

MCP = MASTER CONTROL PANEL

PLC = PROGRAMMABLE LOGIC CONTROLLER

SS5 = SURGE SUPPRESSOR, TYPE 5 (ETHERNET)

SS6 = SURGE SUPPRESSOR, TYPE 6 (RS-485)

CABLE LEGEND

—∘— SERIAL, RS-485 MODBUS RTU

----E---- COPPER ETHERNET, CAT-6

--- FOMM--- FIBER-OPTIC, MULTI-MODE, 62.5 MICRON

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SOLUTIONS YOU CAN BUILD UPON


CONSTRUCTION PLANS FOR ORANGE COUNTY LANDFILL CELL 11 BAY 17 - 19 EXPANSION ORANGE COUNTY SOLID WASTE DIVISION ORANGE COUNTY, FLORIDA


INSTRUMENTATION AND CONTROL P&ID NETWORK BLOCK DIAGRAM **CELL 11 SCADA SYSTEM TIE-IN**

ORANGE COUNTY LANDFILL CELL 11 BAY 17-19 EXPANSION SHEET NO. IC-5 SCALE: PROJ. NO. 676802

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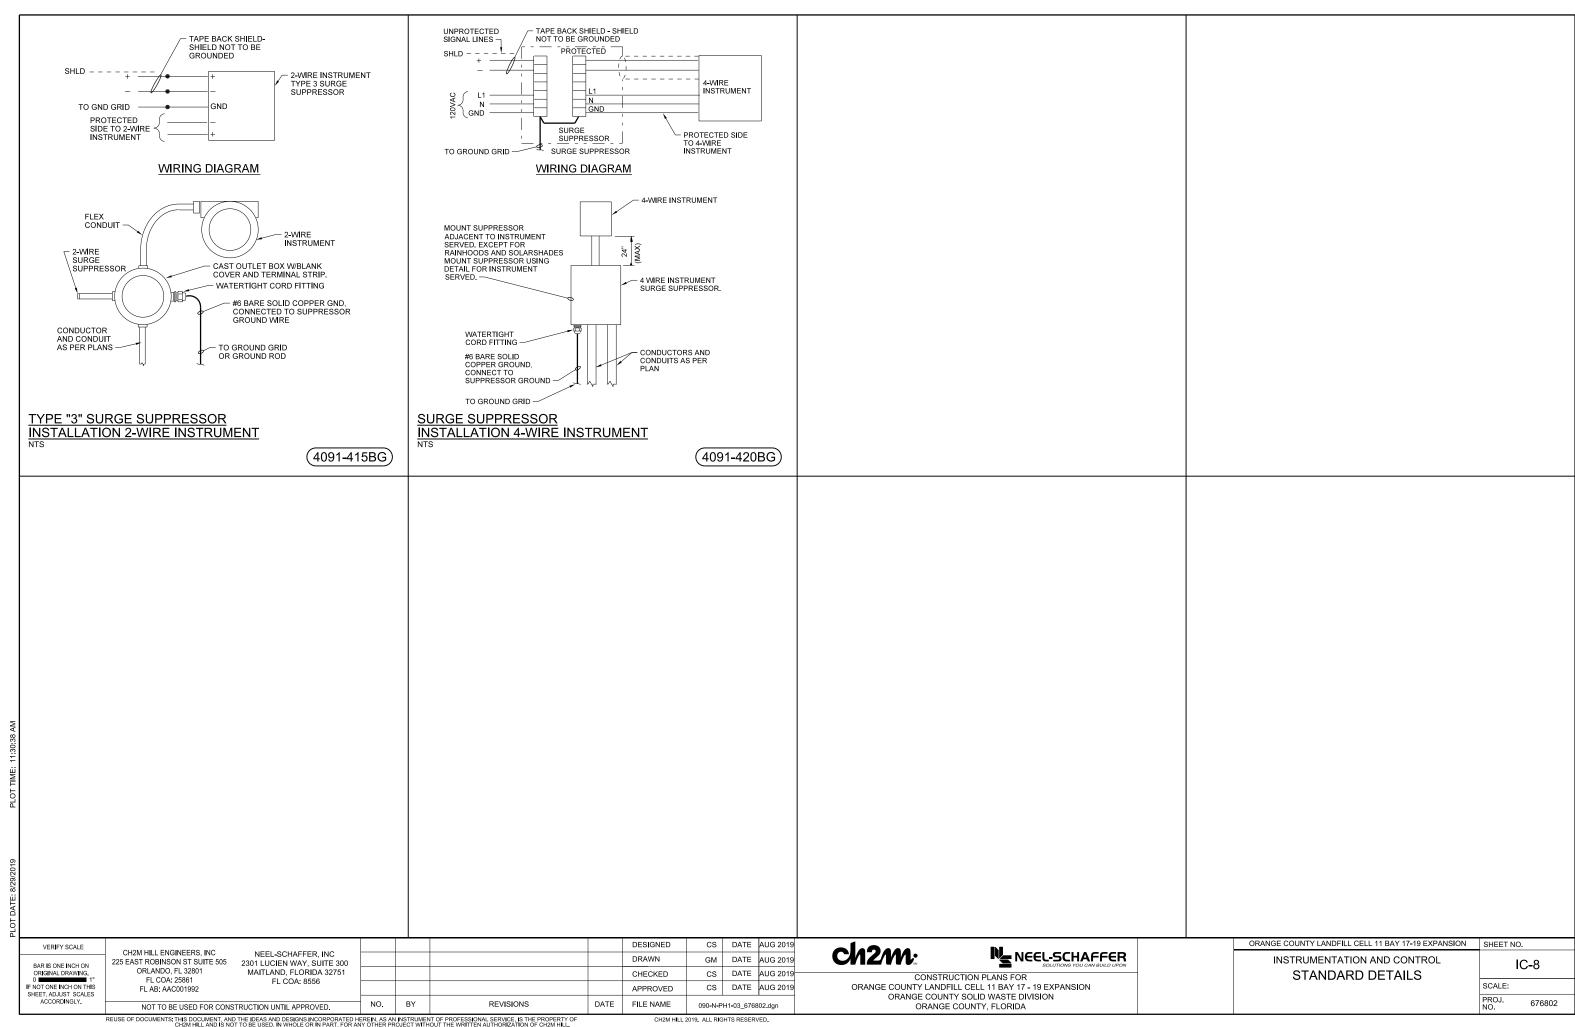
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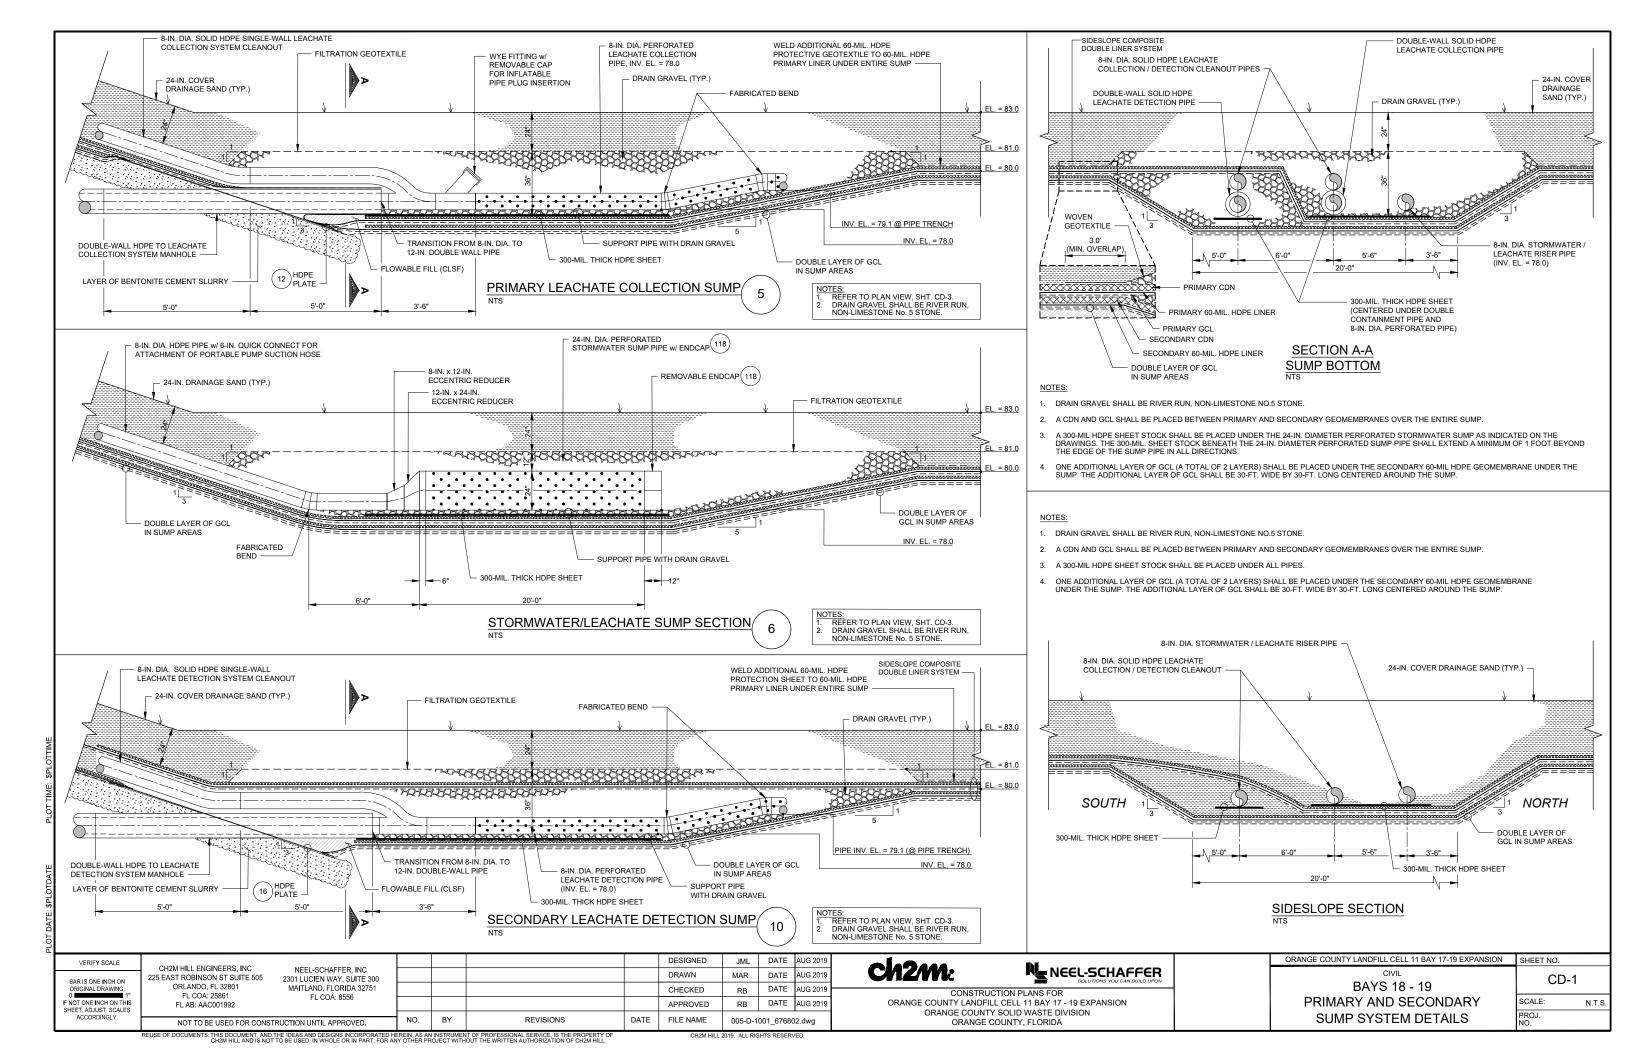


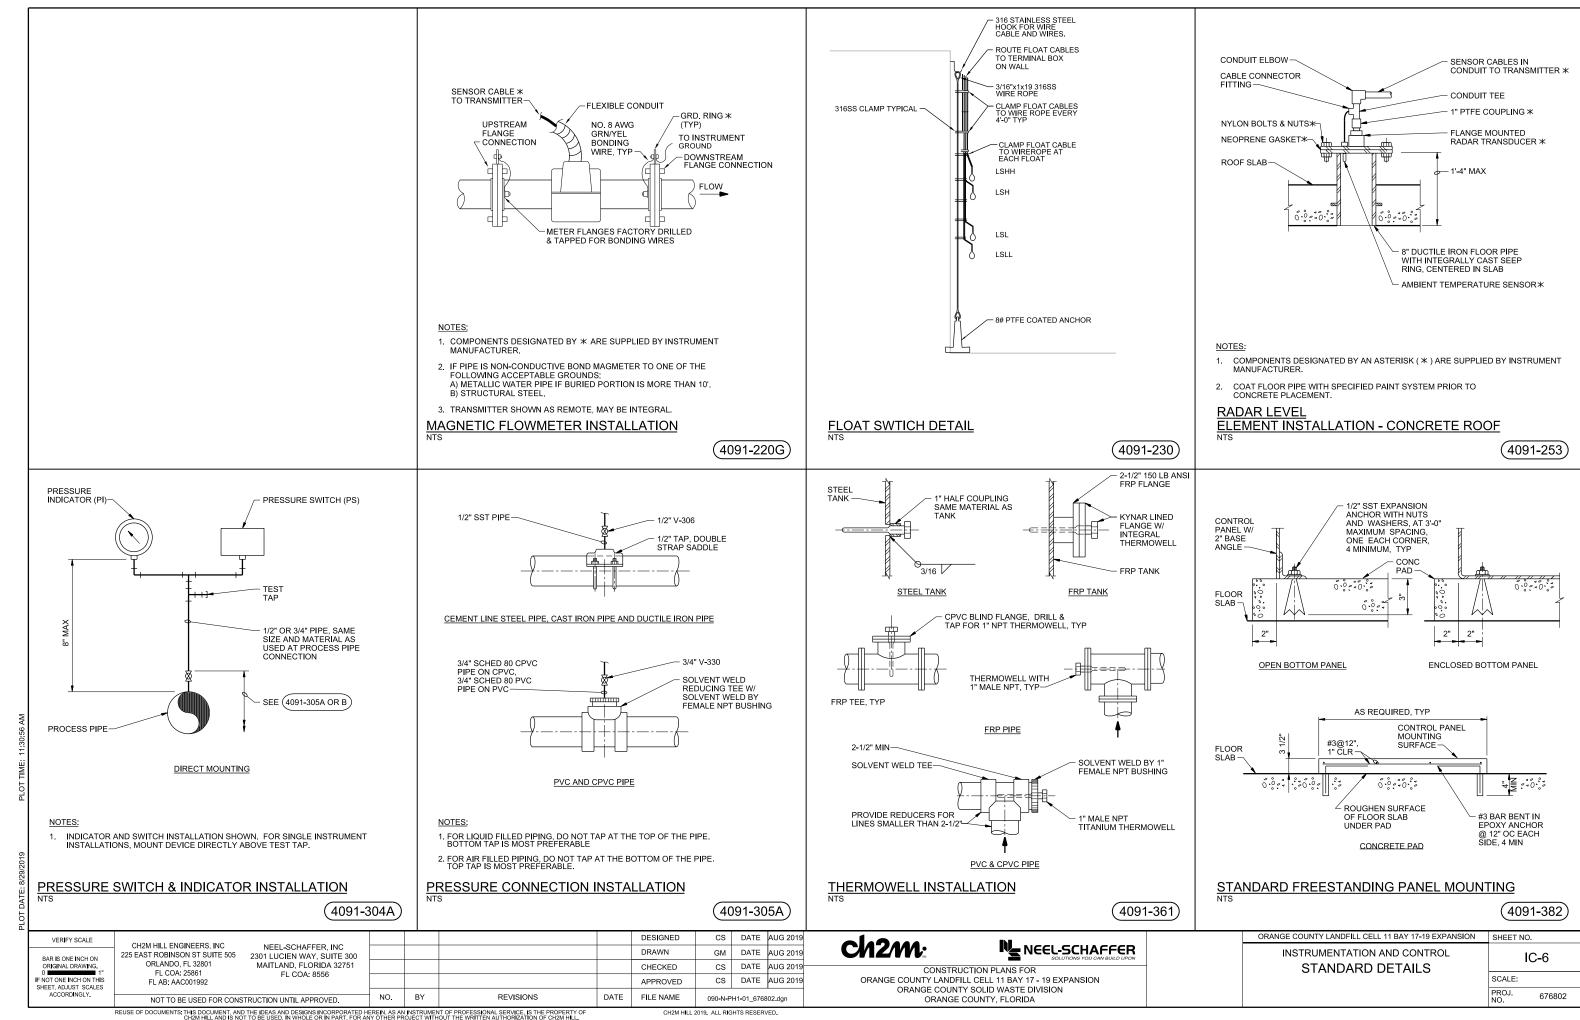



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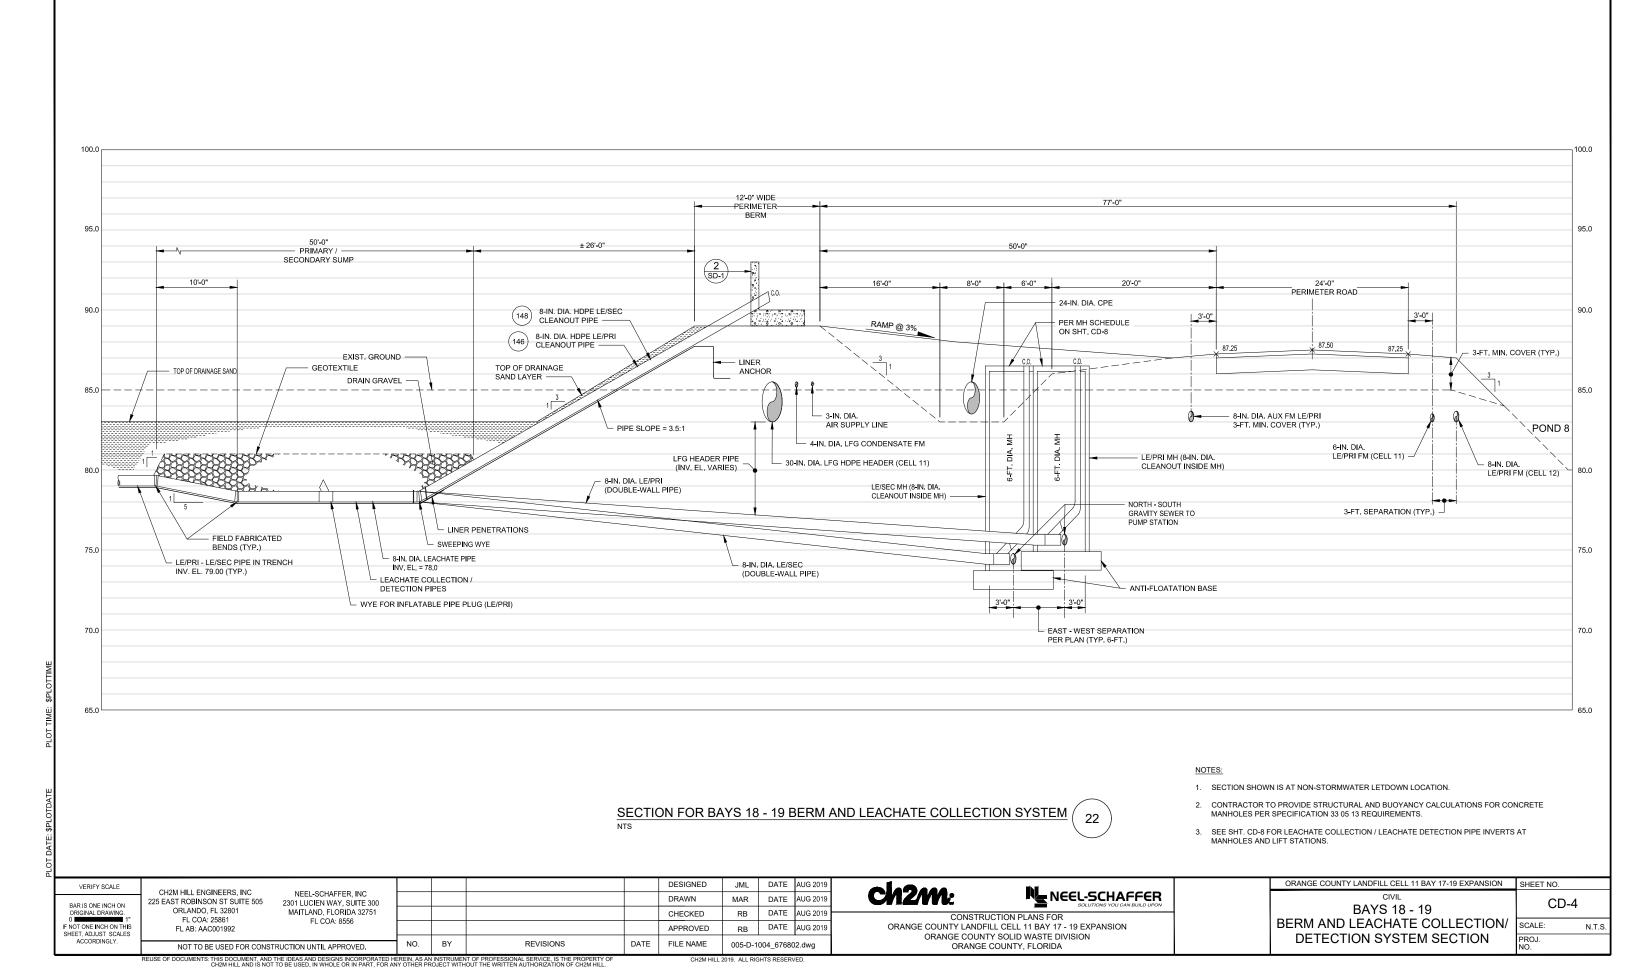
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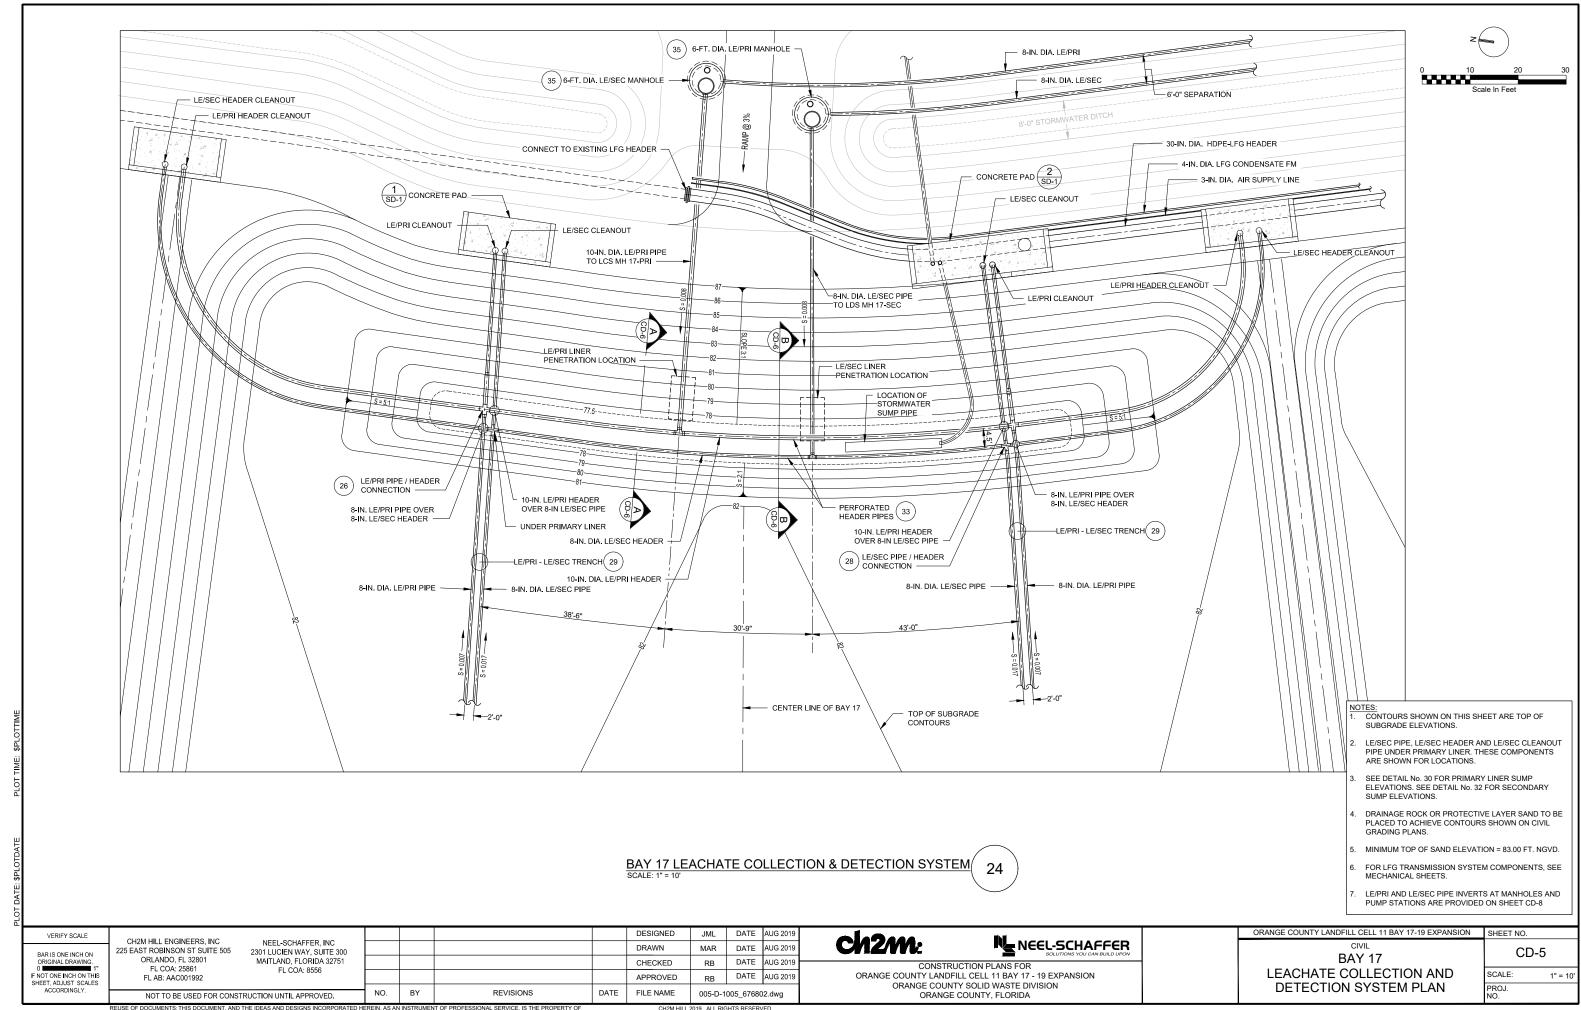


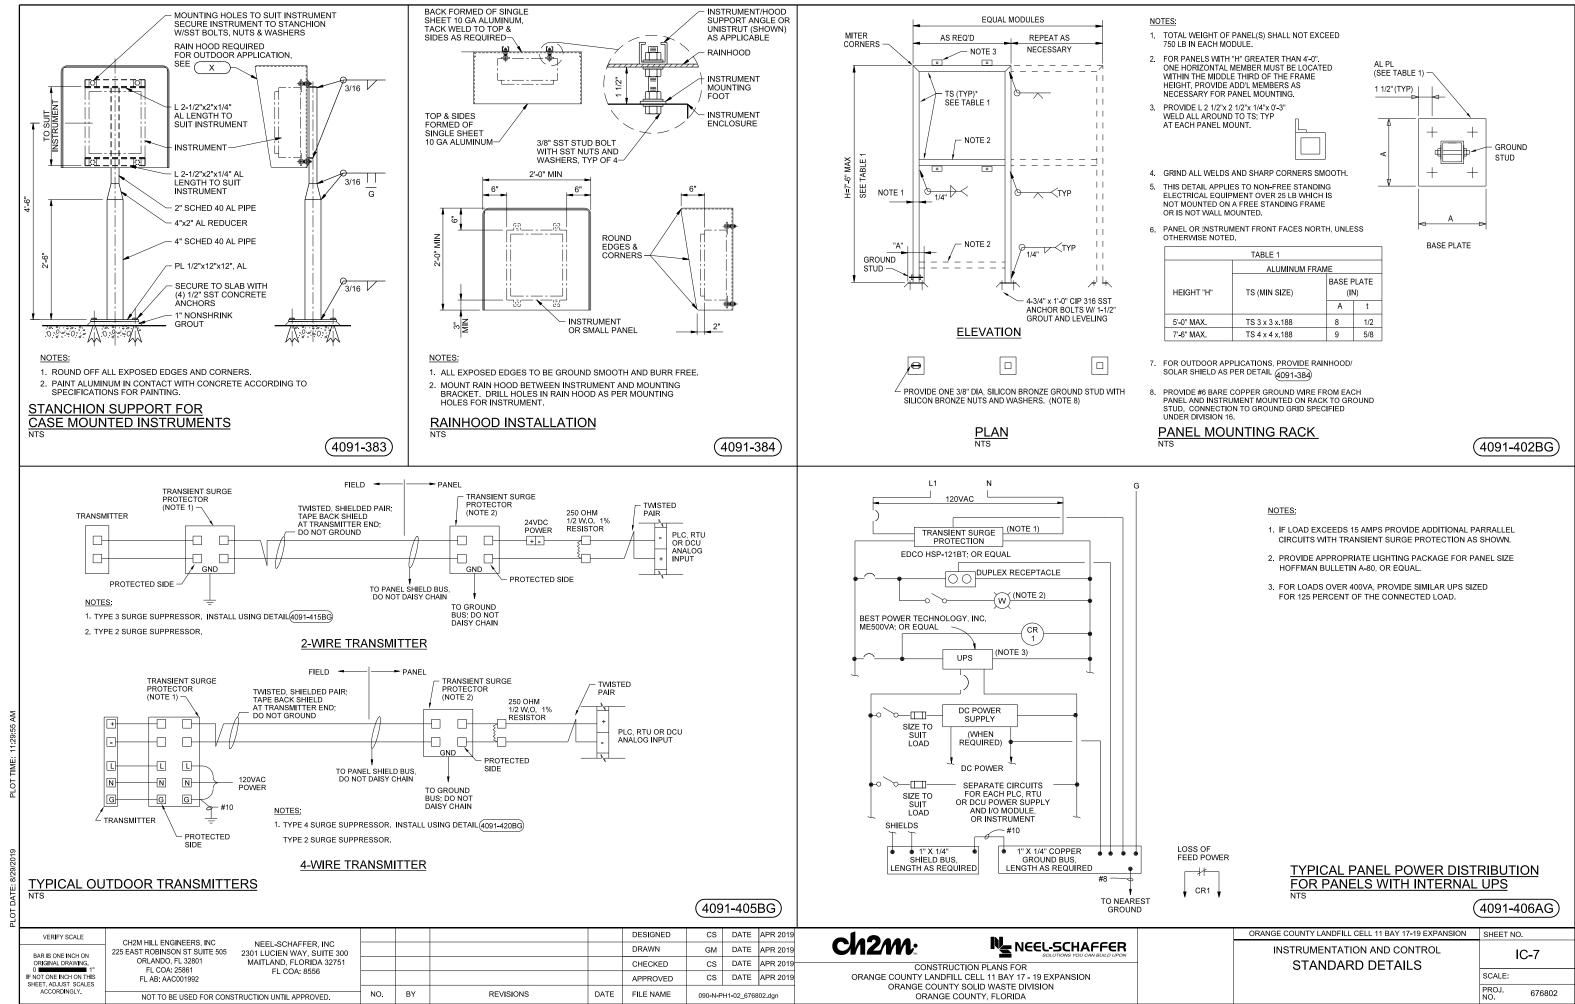








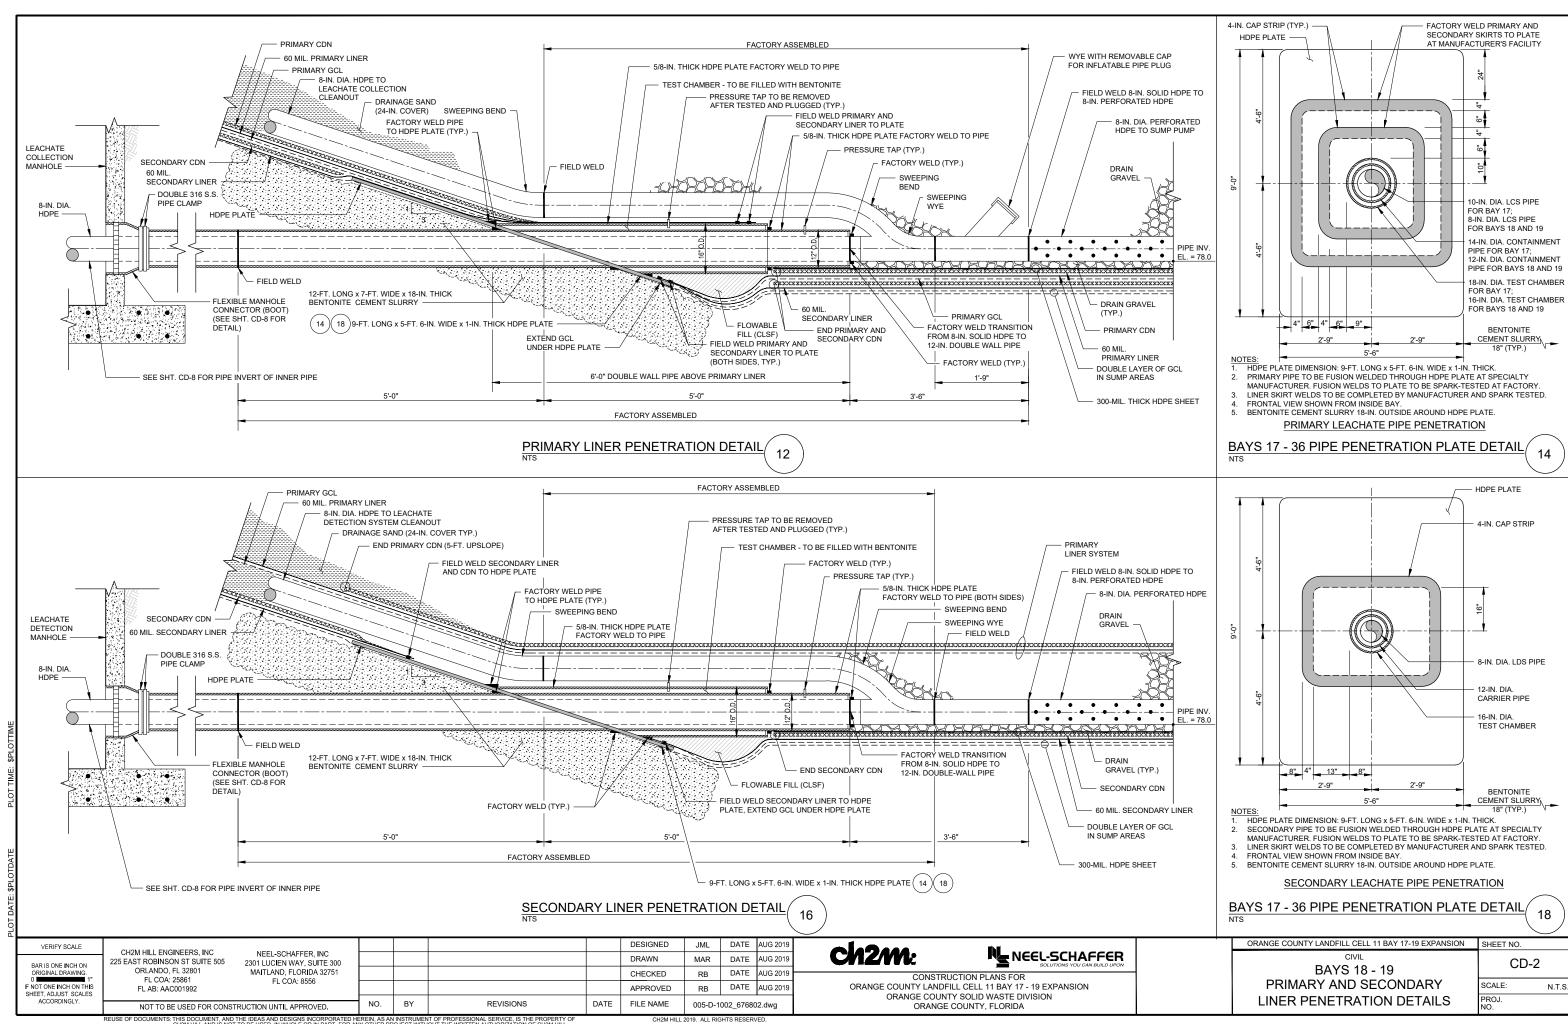

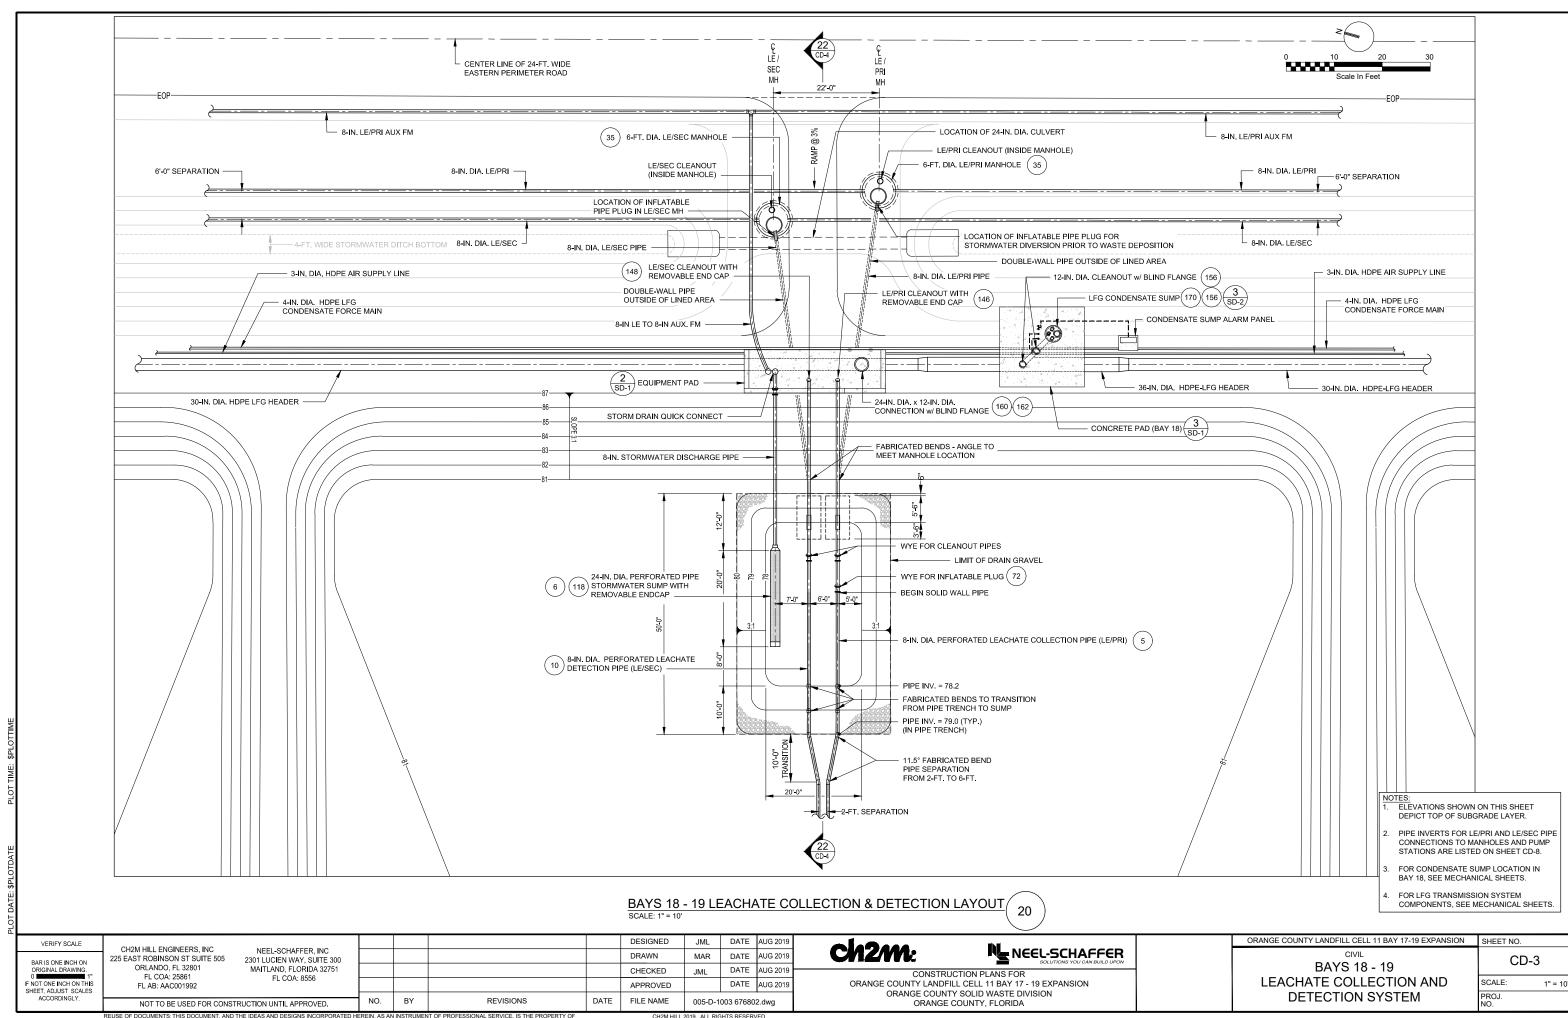

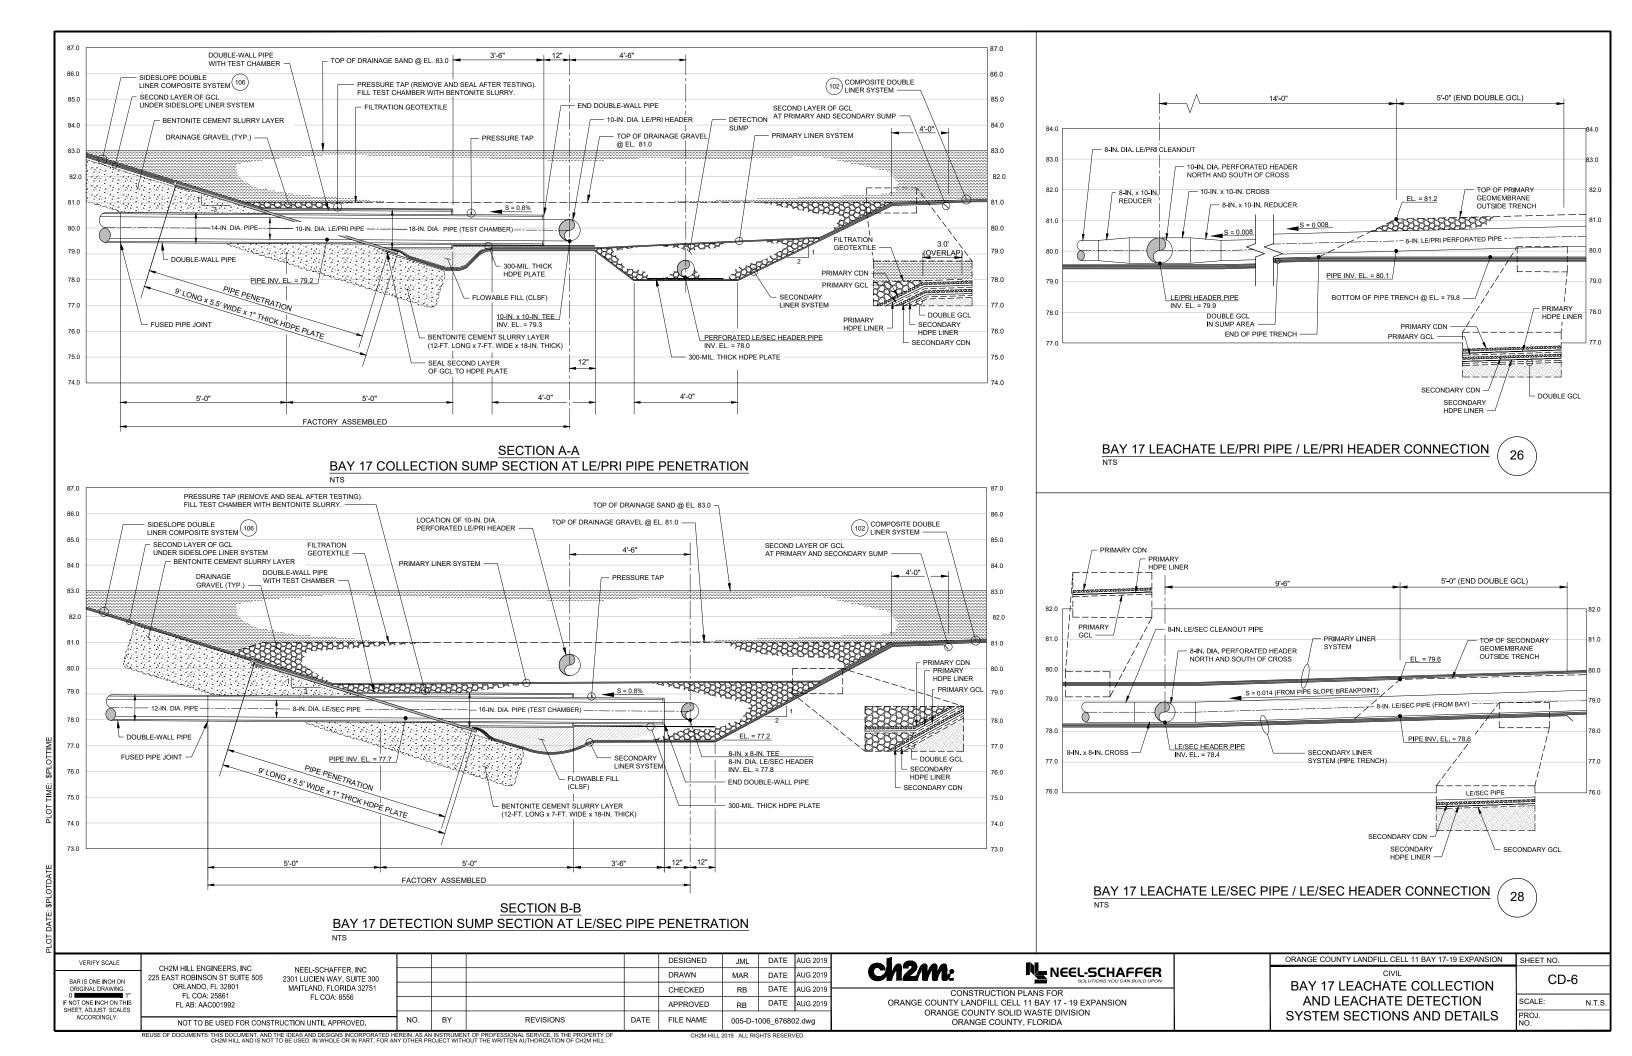

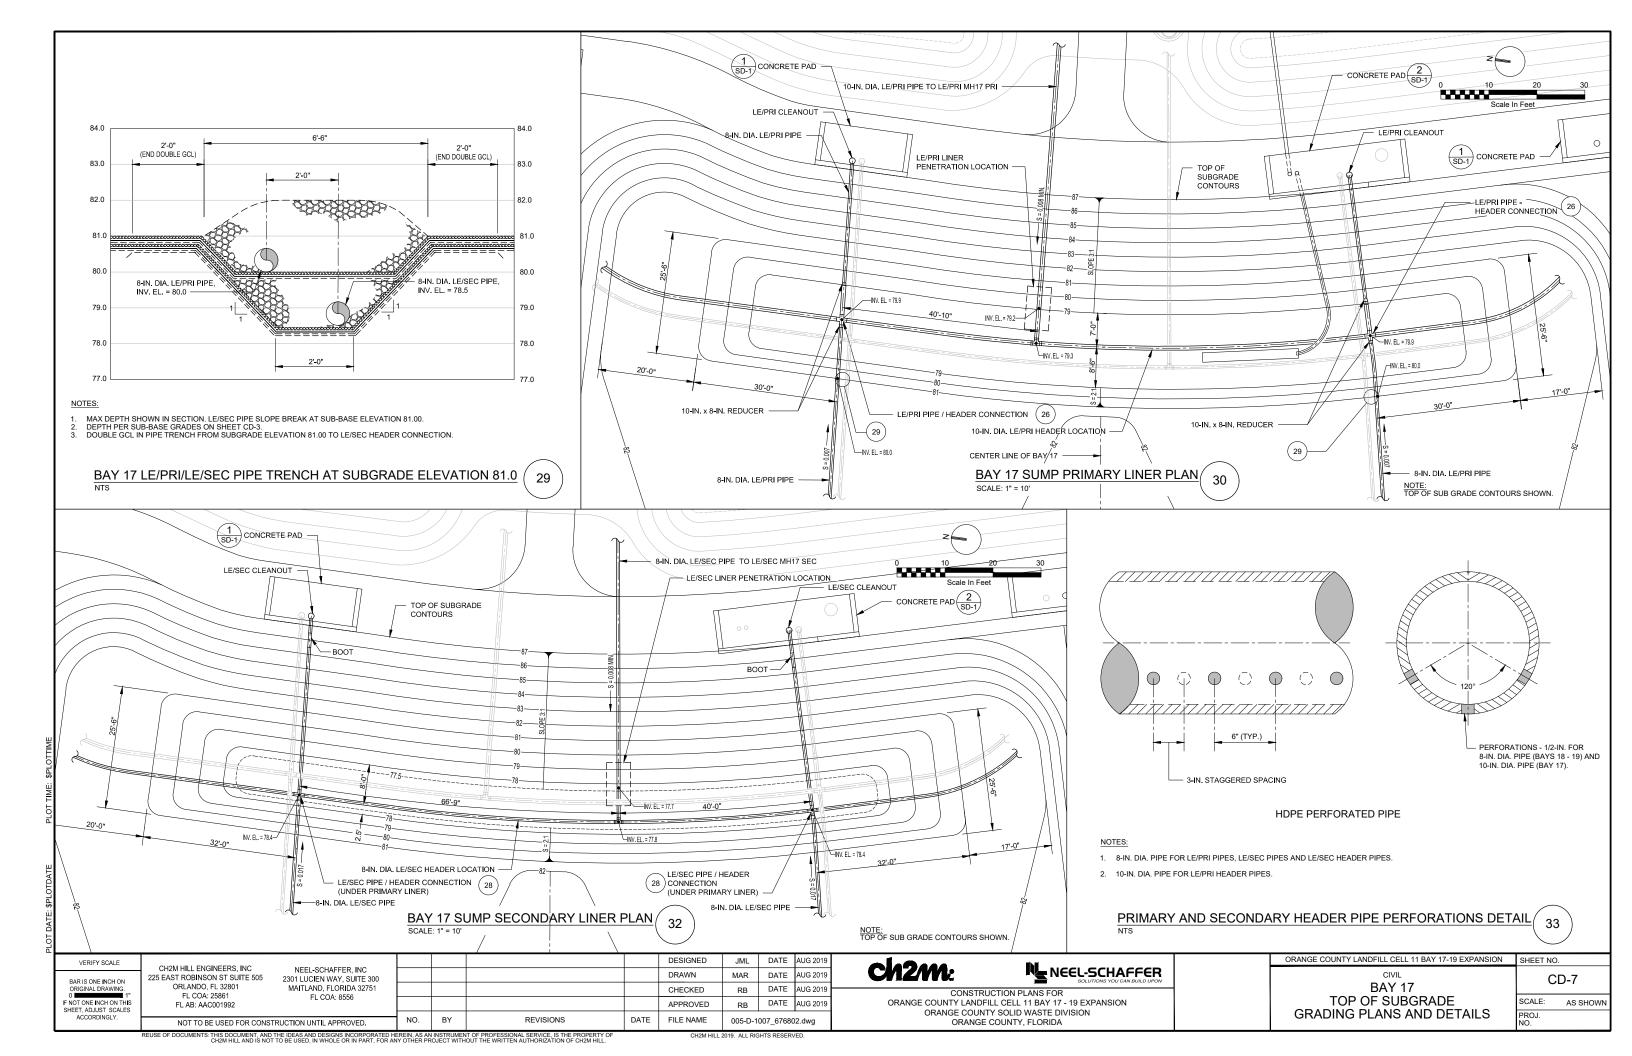

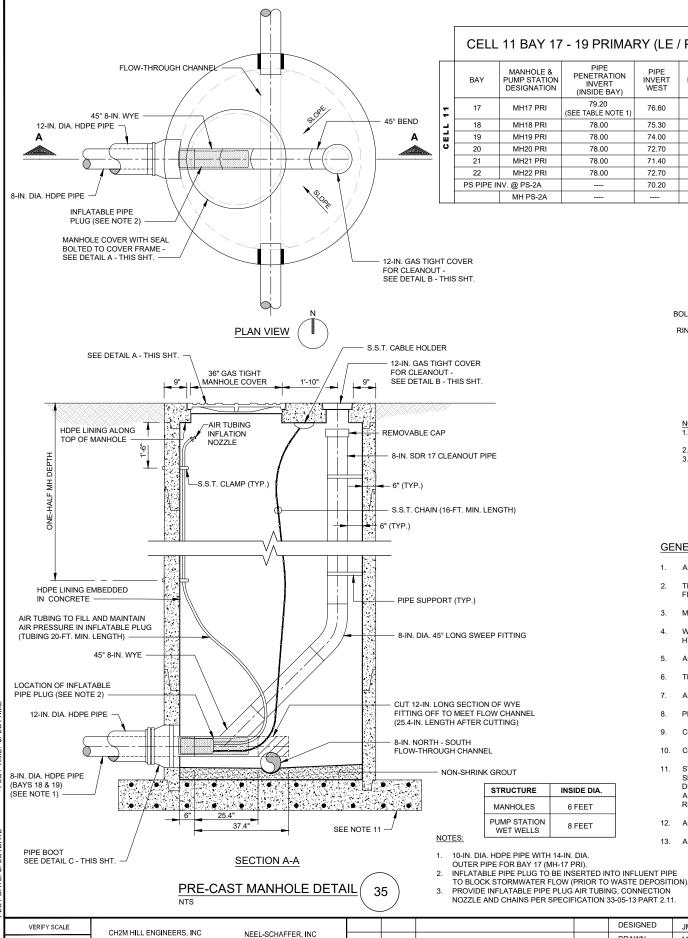

2301 LUCIEN WAY, SUITE 300

MAITLAND, FLORIDA 32751

FL COA: 8556

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NO.

BY

REVISIONS

225 EAST ROBINSON ST SUITE 505

ORLANDO, FL 32801

FL COA: 25861

BAR IS ONE INCH ON

F NOT ONE INCH ON THIS

CELL 11 BAY 17 - 19 PRIMARY (LE / PRI) GRAVITY LEACHATE COLLECTION SYSTEM


| BAY | MANHOLE & PUMP STATION DESIGNATION | PIPE PENETRATION INVERT (INSIDE BAY) | PIPE INVERT WEST | PIPE INVERT SOUTH | PIPE INVERT NORTH | PIPE INVERT EAST | TOP OF MH | MH INVERT | COORDINATE (CENTER OF MH) | | |
|----------------------|------------------------------------|---|------------------------|-------------------------|-------------------------|------------------------|--------------|--------------|------------------------------|-----------|-------|
| 17 | MH17 PRI | 79.20 (SEE TABLE NOTE 1) | 76.60 | 76.50 | | | 86.50 | 76.20 | 1503508.66 | 585408.75 | 11 |
| 18 | MH18 PRI | 78.00 | 75.30 | 75.20 | 75.40 | | 86.50 | 74.90 | 1503300.18 | 585464.12 | _ |
| 19 | MH19 PRI | 78.00 | 74.00 | 73.90 | 74.10 | | 86.50 | 73.60 | 1503082.81 | 585522.23 | 11 21 |
| 20 | MH20 PRI | 78.00 | 72.70 | 72.60 | 72.80 | | 86.50 | 72.30 | 1502865.41 | 585580.21 | ا ت |
| 21 | MH21 PRI | 78.00 | 71.40 | 71.30 | 71.50 | | 86.50 | 71.00 | 1502648.01 | 585638.20 | |
| 22 | MH22 PRI | 78.00 | 72.70 | 72.80 | 72.60 | | 86.50 | 72.30 | 1502430.61 | 585696.18 | |
| PS PIPE INV. @ PS-2A | | | 70.20 | | | | | | | | |
| | MH PS-2A | | | 70.80 | 70.80 | 70.70 | 88.00 | 70.50 | 1502546.30 | 585665.31 | |

CELL 11 - 12 - SECONDARY (LE / SEC) GRAVITY LEACHATE DETECTION SYSTEM

| | BAY | MANHOLE & PUMP STATION DESIGNATION | PIPE PENETRATION INVERT | PIPE INVERT WEST | PIPE INVERT SOUTH | PIPE INVERT NORTH | PIPE INVERT EAST | TOP OF MH | MH INVERT | COORDINATE (CENTER OF MH) | |
|----|------------|--|-------------------------------|------------------------|-------------------------|-------------------------|------------------------|--------------|--------------|------------------------------|------------|
| | | DESIGNATION | (INSIDE BAY) | WEST | 300111 | NORTH | EASI | | | NORTHING | EASTING |
| 11 | 17 | MH17 SEC | 77.70 (SEE TABLE NOTE 2) | 75.40 | 75.30 | | | 86.50 | 75.00 | 1503508.66 | 585404.70 |
| _ | 18 | MH18 SEC | 78.00 | 74.10 | 74.00 | 74.20 | | 86.50 | 73.70 | 1503319.88 | 585452.64 |
| EL | 19 | MH19 SEC | 78.00 | 72.80 | 72.70 | 72.90 | | 86.50 | 72.40 | 1503102.51 | 585510.76 |
| ပ | 20 | MH20 SEC | 78.00 | 71.50 | 71.40 | 71.60 | | 86.50 | 71.10 | 1502885.11 | 585568.74 |
| | 21 | MH21 SEC | 78.00 | 70.20 | 70.30 | 70.10 | | 86.50 | 69.80 | 1502667.71 | 585626.73 |
| | 22 | MH22 SEC | 78.00 | 71.50 | 71.60 | 71.40 | | 86.50 | 71.10 | 1502450.31 | 585684.70 |
| | PS PIPE IN | IV. @ PS-2B | | 68.80 | | | | | | | |
| | | MH PS-2B | | | 69.60 | 69.60 | 69.50 | 88.00 | 69.20 | 1502575.67 | 585 651.27 |

TABLE NOTES:

- PIPE INVERTS ARE FOR INNER PIPE PRIMARY COLLECTION SYSTEM (LE / PRI). INNER PIPE 10 INCH DIAMETER FOR BAY 17 AND 8 INCH DIAMETER FOR BAYS 18 - 22.
- SECONDARY DETECTION SYSTEM (LE / SEC) INNER PIPE IS 8 INCH DIAMETER

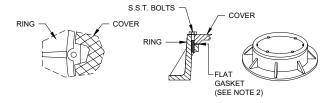

- CASTINGS ARE DRILLED AND TAPPED 1/2 ON RING AND
- 1/2 ON COVER.
 2. GASKET SEAL TO BE BUNA N (OR APPROVED EQUAL).

DETAIL B TYPE BWT COVER

GENERAL NOTES:

BOLTING LUG

COVER -

HOLES IN THE COVER.

- ALL EXPOSED METAL OUTSIDE OF THE MANHOLE SHALL BE PRIMED AND PAINTED WITH APPROVED COATING SYSTEM PER SPECIFICATIONS SECTIONS.
- THE INSIDE OF THE MANHOLE SHALL BE LINED WITH AN HDPE LINER AS LISTED IN SPECIFICATION 33 05 13. FINAL SEALS AND SEALING TO BE MADE IN THE
- MANHOLE ACCESS OPENING SHALL BE COVERED ON ALL VERTICAL SIDES WITH A PROTECTIVE HDPE LINER.
- WARNINGS TO BE LABELED ON 36-IN, MANHOLE COVER STATING: "WARNING CONFINED SPACE ENTRY" AND "WARNING COMBUSTIBLE GASES AND
- ALL HARDWARE IN THE MANHOLE SHALL BE 316 STAINLESS STEEL.
- THERE SHALL BE NO VALVES OR ELECTRICAL JUNCTION BOXES IN THE MANHOLE

S.S.T. BOLTS

 $\frac{\text{NOTES:}}{\text{1.}}$ Castings with Bolting Lugs integrated on the Ring with cored

DETAIL A

TYPE BWTL COVER


CLEARANCE OF RING OPENING IS 1 1/2-IN. AT BOLTING LUGS. GASKET SEAL TO BE BUNA N (OR APPROVED EQUAL).

FLAT GASKET

(SEE NOTE 2)-

COVER

- ALL PIPING THROUGH CONCRETE SHALL BE WATER TIGHT, CAST-IN-PLACE SLEEVES.
- PIPE SUPPORTS SHALL BE 316 STAINLESS STEEL.
- CONTRACTOR SHALL VERIFY ALL DIMENSIONS AND ELEVATIONS PRIOR TO ORDERING ANY MATERIALS OR EQUIPMENT.
- CONTRACTOR SHALL GROUT FLOOR OF MANHOLE, AS REQUIRED BY MANUFACTURER'S SPECIFICATIONS, TO ACCOMMODATE INSTALLATION OF PIPING.
- STRUCTURAL DESIGN OF THE PRE-CAST MANHOLE AND TOP SHALL BE THE RESPONSIBILITY OF THE PRE-CAST MANUFACTURER. THICKNESS OF BASE OF SLAB TO BE DETERMINED BY MANHOLE MANUFACTURER BASED ON BUOYANCY CALCULATIONS TO PREVENT UPLIFT. CONTRACTOR SHALL SUBMIT SHOP DRAWINGS FOR THE PRE-CAST MANHOLE, THE PRE-CAST MANHOLE TOP AND COVER, TO THE ENGINEER. PRECAST - MANUFACTURER TO PROVIDE SIGNED AND SEALED STRUCTURAL AND BUOYANCY CALCULATIONS WITH STRUCTURAL DESIGN. REFER TO SPECIFICATION SECTION 33-05-13 FOR SUBMITTAL
- 12. ALL MANHOLE EXTERNAL JOINTS SHALL BE COVERED WITH A HIGH STRENGTH, WATER TIGHT, PRESS-TO-SEAL TYPE TAPE.
- 13. ALL SPOOLS SHALL BE MINIMUM OF SIX INCHES WHERE SPACE ALLOWS.

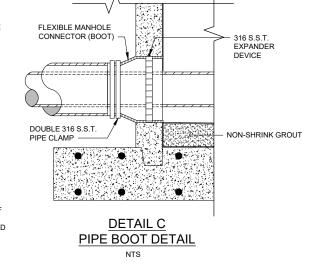

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NEEL-SCHAFFER

ORANGE COUNTY LANDFILL CELL 11 BAY 17 - 19 EXPANSION ORANGE COUNTY SOLID WASTE DIVISION ORANGE COUNTY, FLORIDA

LEACHATE MANHOLE DETAILS

ORANGE COUNTY LANDFILL CELL 11 BAY 17-19 EXPANSION SHEET NO CD-8 SCALE: N.T.S.

PROJ.

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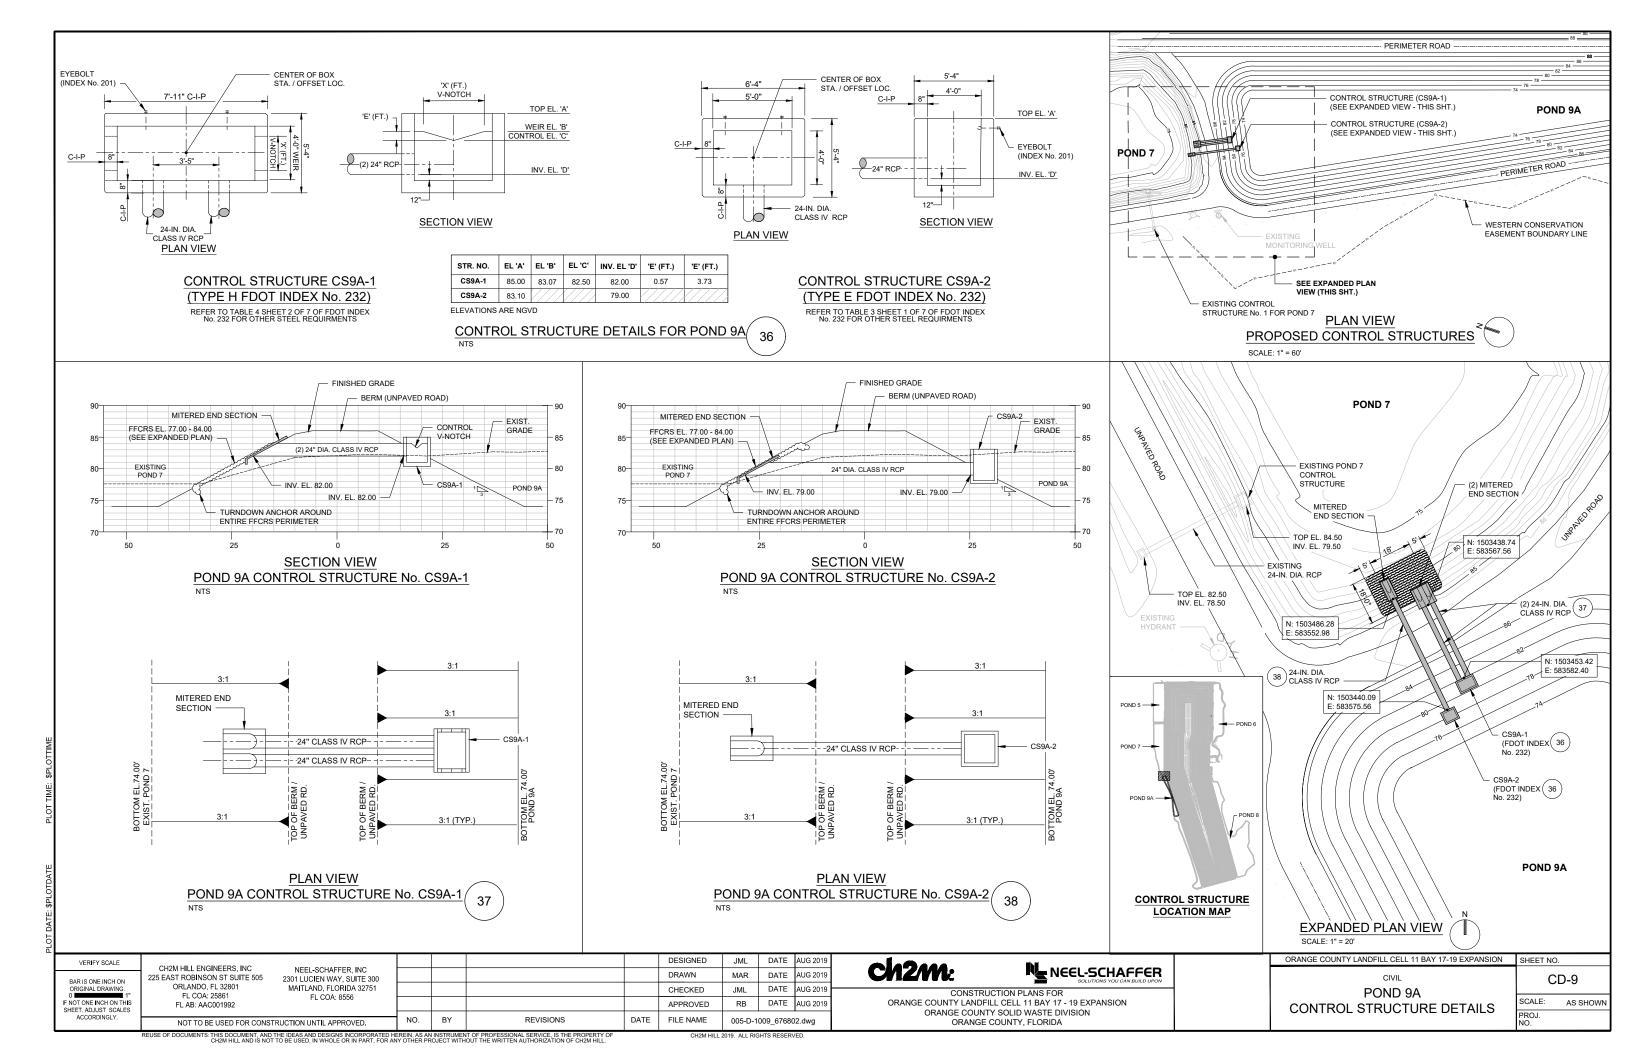
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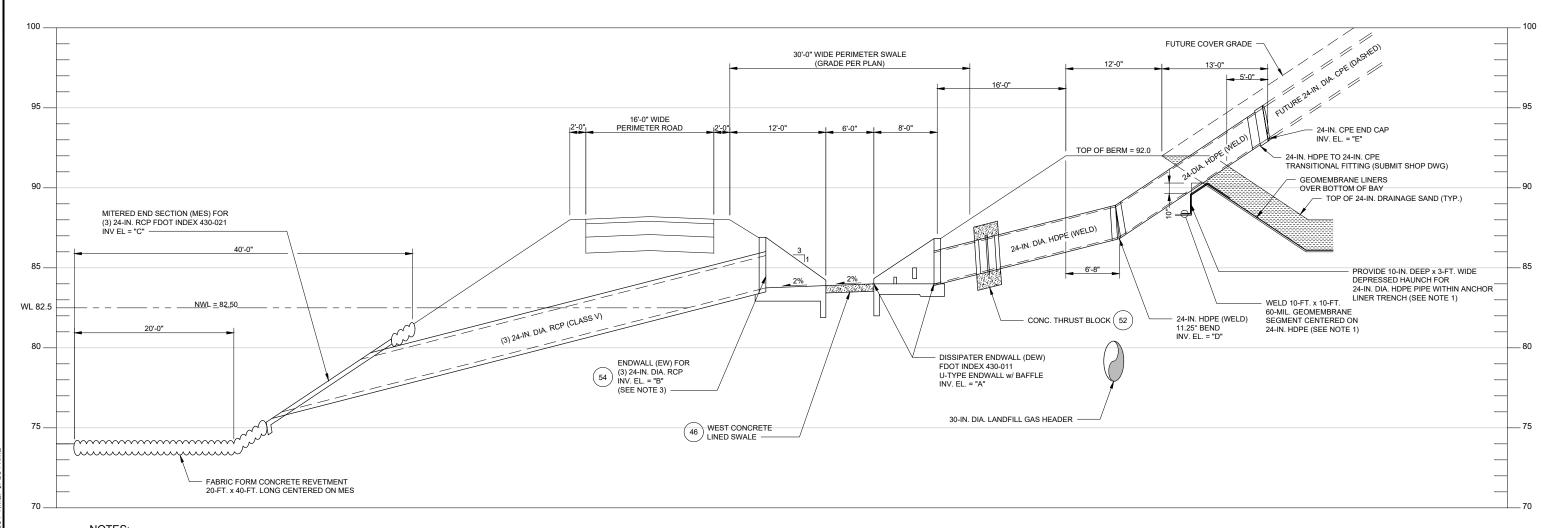
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| WEST BERM STORMWATER | | | | | | | | | |
|-----------------------------------|---|---|-------|-------|-------|--|--|--|--|
| DISSIPATER HEADWALL (DEW) # | DISSIPATER HEADWALL (DEW) INV. EL. "A" | ALL (3) 24" RCP (MES) 11.25° BEND STUB AND CA V) INV FI "B" (3) 24' RCP INV FI "D" INV FI "B" | | | | | | | |
| DEW-23 | 84.00 | 83.75 | 76.00 | 86.92 | 93.00 | | | | |
| DEW-25 | 84.00 | 83.75 | 76.00 | 86.92 | 93.00 | | | | |
| DEW-27 | 84.00 | 83.75 | 76.00 | 86.92 | 93.00 | | | | |
| DEW-29 | 84.00 | 83.75 | 76.00 | 86.92 | 93.00 | | | | |
| DEW-31 | 84.00 | 83.75 | 76.00 | 86.92 | 93.00 | | | | |
| | | | | | | | | | |



NOTES:

- 1. THE GEOMEMBRANE LINER ANCHOR TRENCH FOR THE BAYS SHALL BE INSTALLED PER DETAIL 126. TO ACCOMMODATE THE 24-IN. DIA. HDPE PIPE, THE TYPICAL ANCHOR TRENCH SHALL HAVE A DEPRESSED HAUNCH THAT IS APPROXIMATELY 10 INCHES DEEP AND 3 FEET WIDE. A 10-FT. x 10-FT. 60-MIL GEOMEMBRANE PAD (TO PROVIDE A PROTECTIVE LAYER) CENTERED ON THE 24-IN DIA HDDE SHALL PER WILL DE TO THE CENTER PANY. 24-IN. DIA. HDPE SHALL BE WELDED TO THE GEOMEMBRANE COVERING THE BAY.
- 2. BURIED UTILITIES SHALL HAVE A MINIMUM OF 4 INCHES OF SEPARATION FROM STORM PIPING AND ENCASED WITH CONCRETE PER DETAIL 50 IF THE SEPARATION IS LESS THAN 12 INCHES. THE CONCRETE ENCASEMENT SHALL EXTEND OVER THE ENTIRE WIDTH OF THE (3) 24-IN. DIA. RCP PIPES AND WHERE COVER IS LESS THAN 36 INCHES.
- DETAIL 54 IS FOR THE CONCRETE ENDWALL (EW) DISCHARGING TO THE POND. THE EW IS A MODIFIED ENDWALL PER FDOT INDEX 430-011. THE MODIFICATIONS INCLUDE ACCOMMODATING THREE PIPES (RATHER THAN ONE) AND A SLOPED APRON (RATHER THAN FLAT).

WESTERN STORMWATER SYSTEM PROFILE/



| VERIFY SCALE BAR IS ONE INCH (ORIGINAL DRAWIN 0 | CH2M HILL ENGINEERS, INC 225 EAST ROBINSON ST SUITE 505 6. ORLANDO, FL 32801 FL COA: 25861 | NEEL-SCHAFFER, INC 2301 LUCIEN WAY, SUITE 300 MAITLAND, FLORIDA 32751 FL COA: 8556 | | | | | DESIGNED DRAWN CHECKED | TM MAR JML | DATE | AUG 2019 AUG 2019 AUG 2019 |
|---|--|---|--|----|-----------|------|------------------------|------------------|-----------|----------------------------------|
| IF NOT ONE INCH ON SHEET, ADJUST SCA | THIS FLAB: AAC001992 | | | | | | APPROVED | TM | DATE | AUG 2019 |
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SOLUTIONS YOU CAN BUILD UPON CONSTRUCTION PLANS FOR

ORANGE COUNTY LANDFILL CELL 11 BAY 17 - 19 EXPANSION ORANGE COUNTY SOLID WASTE DIVISION ORANGE COUNTY, FLORIDA

CELL 11 BAYS 17 - 22 STORMWATER DRAINAGE SYSTEM PROFILE - WEST

ORANGE COUNTY LANDFILL CELL 11 BAY 17-19 EXPANSION SHEET NO.

CD-10 SCALE: AS SHOWN PROJ. NO.

| EAST BERM STORMWATER | | | | | | | | | | |
|-----------------------------------|---|---|---|--|--|--|--|--|--|--|
| DISSIPATER HEADWALL (DEW) # | DISSIPATER HEADWALL (DEW) INV. EL. "A" | ENDWALL (EW) (3) 24" RCP INV. EL. "B" | MITERED END (MES) (3) 24' RCP INV. EL. "C" | 24-IN. HDPE 11.25° BEND INV. EL. "D" | 24-IN. CPE STUB AND CAP INV. EL. "E" | | | | | |
| DEW-22 | 83.35 | 83.17 | 75.00 | 86.44 | 90.00 | | | | | |
| DEW-24 | 83.35 | 83.17 | 75.00 | 86.44 | 90.00 | | | | | |
| DEW-26 | 83.35 | 83.17 | 75.00 | 86.44 | 90.00 | | | | | |
| DEW-26.5 | 83.35 | 83.17 | 75.00 | 86.44 | 90.00 | | | | | |
| DEW-28 | 83.35 | 83.17 | 75.00 | 86.44 | 90.00 | | | | | |

VERT:Scale In Feet

CD-11

AS SHOWN

SCALE:


PROJ. NO.

ORANGE COUNTY LANDFILL CELL 11 BAY 17-19 EXPANSION SHEET NO.

CELL 11 BAYS 17 - 22

STORMWATER DRAINAGE

SYSTEM PROFILE - EAST

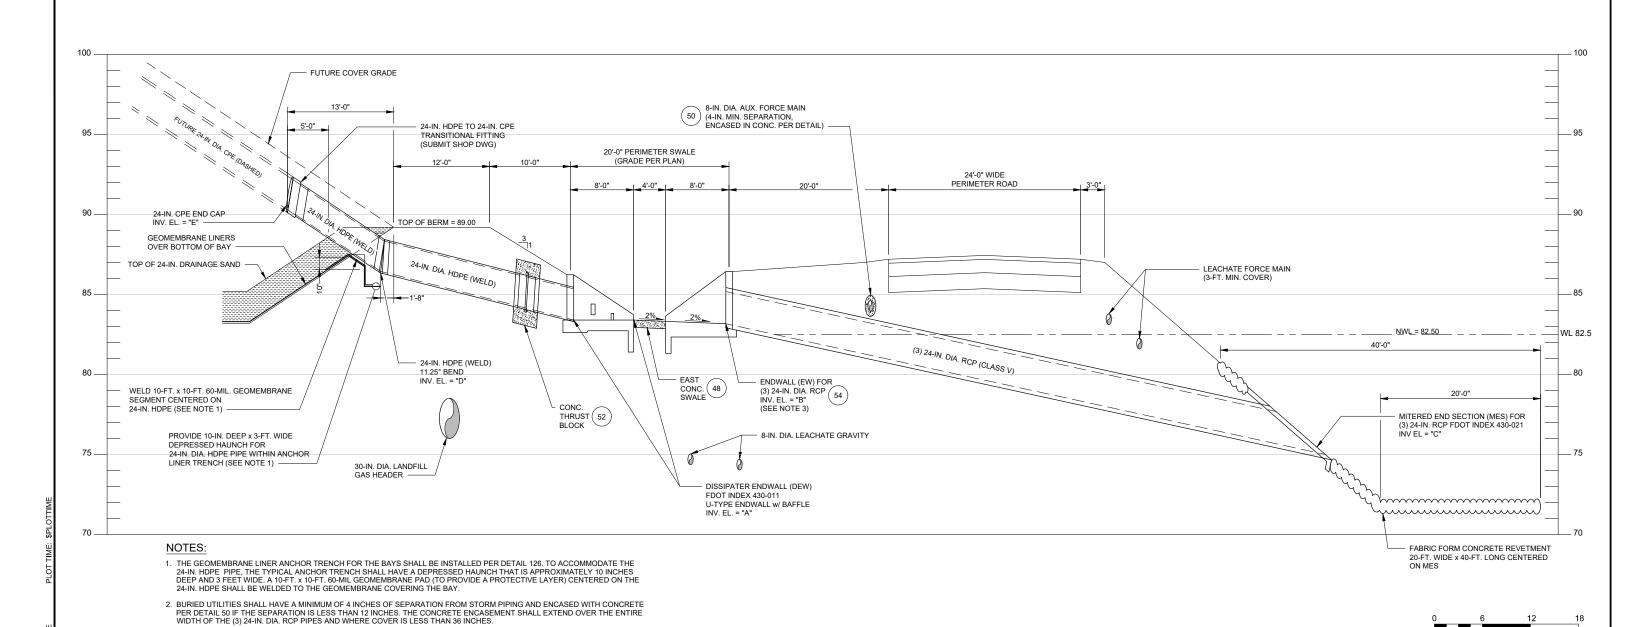

EASTERN STORMWATER SYSTEM PROFILE

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SOLUTIONS YOU GAN BUILD UPON

CONSTRUCTION PLANS FOR

ORANGE COUNTY LANDFILL CELL 11 BAY 17 - 19 EXPANSION

ORANGE COUNTY SOLID WASTE DIVISION ORANGE COUNTY, FLORIDA

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SHEET, ADJUST SCALES
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NEEL-SCHAFFER, INC.

2301 LUCIEN WAY, SUITE 300

MAITLAND, FLORIDA 32751

FL COA: 8556

VERIFY SCALE

BAR IS ONE INCH ON ORIGINAL DRAWING.

CH2M HILL ENGINEERS, INC

225 EAST ROBINSON ST SUITE 505 ORLANDO, FL 32801

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DETAIL 54 IS FOR THE CONCRETE ENDWALL (EW) DISCHARGING TO THE POND. THE EW IS A MODIFIED ENDWALL PER FDOT INDEX 430-011. THE MODIFICATIONS INCLUDE ACCOMMODATING THREE PIPES (RATHER THAN ONE) AND A SLOPED APRON (RATHER THAN FLAT).

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DATE AUG 2019

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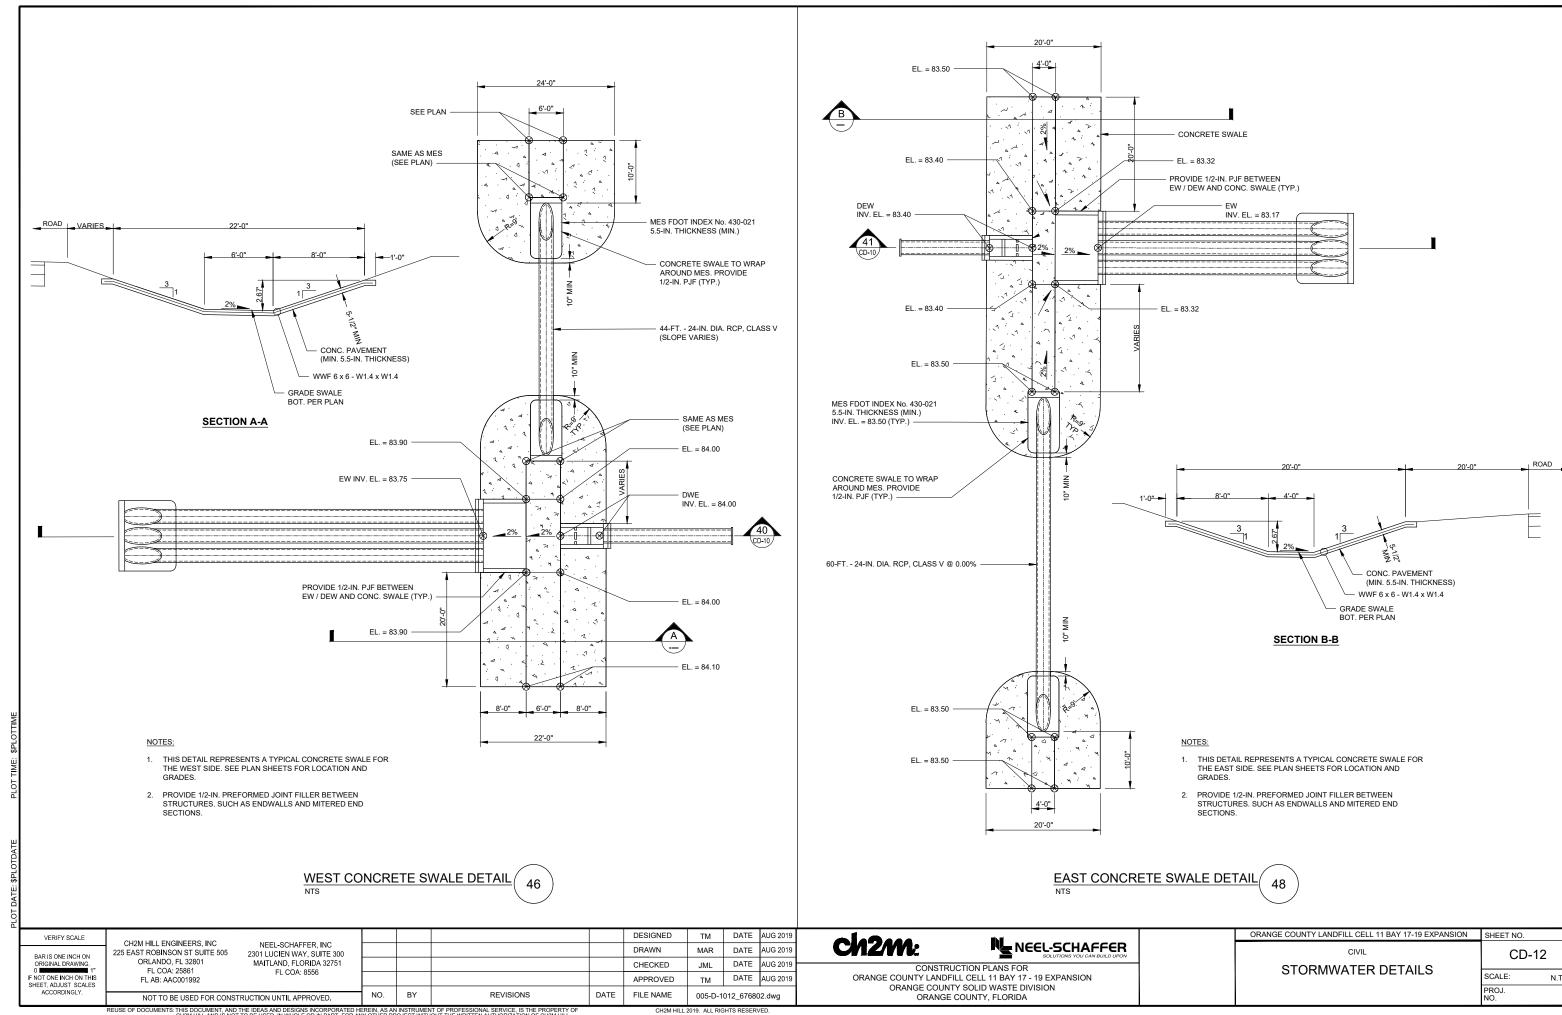
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