ORANGE COUNTY CAPITAL PROJECTS DIVISION 400 E. SOUTH STREET ORLANDO, FL 32801

ORANGE COUNTY MAYOR HONORABLE JERRY DEMINGS

COMMISSIONER DISTRICT 1 BETSY VANDERLEY

COMMISSIONER DISTRICT 2 CHRISTINE MOORE



YUCATAN PLAYGROUND COVER INVEST

6400 YUCATAN DR. ORLANDO, FL 32807

ORANGE COUNTY PROJECT MANAGER: SCOTT REEKIE



ARCHITECTURAL DESIGN COLLABORATIVE

945 N. PENNSYLVANIA AVENUE WINTER PARK, FLORIDA 32789 (407) 629-1188 CONTACT: KAREN ANDERSON



CONTACT: LAURA BARBERO-BUFFA



MAYRA URIBE

COMMISSIONER DISTRICT 4

MARIBEL GOMEZ CORDERO

COMMISSIONER DISTRICT 5 **EMILY BONILLA** 

COMMISSIONER DISTRICT 6


VICTORIA P. SIPLIN

SGM

ELECTRICAL ENGINEER

PROJECT NUMBER: 17034

02/21/2019

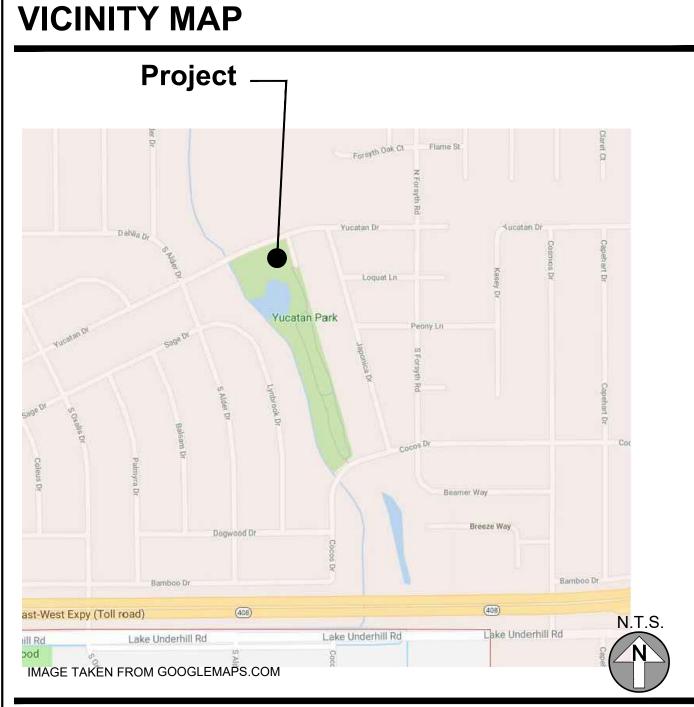

## **LOCATION MAP**



### **CODE DATA**

ALL WORK FOR THIS PROJECT SHALL COMPLY WITH THE FOLLOWING CODES:

**BUILDING CODE:** FLORIDA EXISTING BUILDING CODE - 2017 6th

Edition

FIRE PREVENTION CODE: FLORIDA FIRE PREVENTION CODE- 5th Edition

NFPA 70: NATIONAL ELECTRICAL CODE- 2014

#### PROJECT INFORMATION

**PROJECT ADDRESS:** 6400 Yucatan Dr. Orlando, FL 32807 PROJECT NAME: **Orange County** YUCATAN PLAYGROUND COVER INVEST PROJECT SIZE & TYPE: 2544 SQ.FT ----PROJECT DESCRIPTION: Pre-fabricated metal open structure **BUILDING DATA:** PROJECT OCCUPANCY: ASSEMBLY (A-5) **OVERALL GROSS SQ.FT.:** 2544 SQ.FT OCCUPANT LOAD: 2544 SQ.FT/ 100 25 TYPE OF CONSTRUCTION: V-B

NON SPRINKLERED

### **GRAPHIC SYMBOLS**


PLASTER WITH LATH

FABRIC WRAPPED PANEL

ACOUSTICAL TILE

CARPET

SPRINKLERED

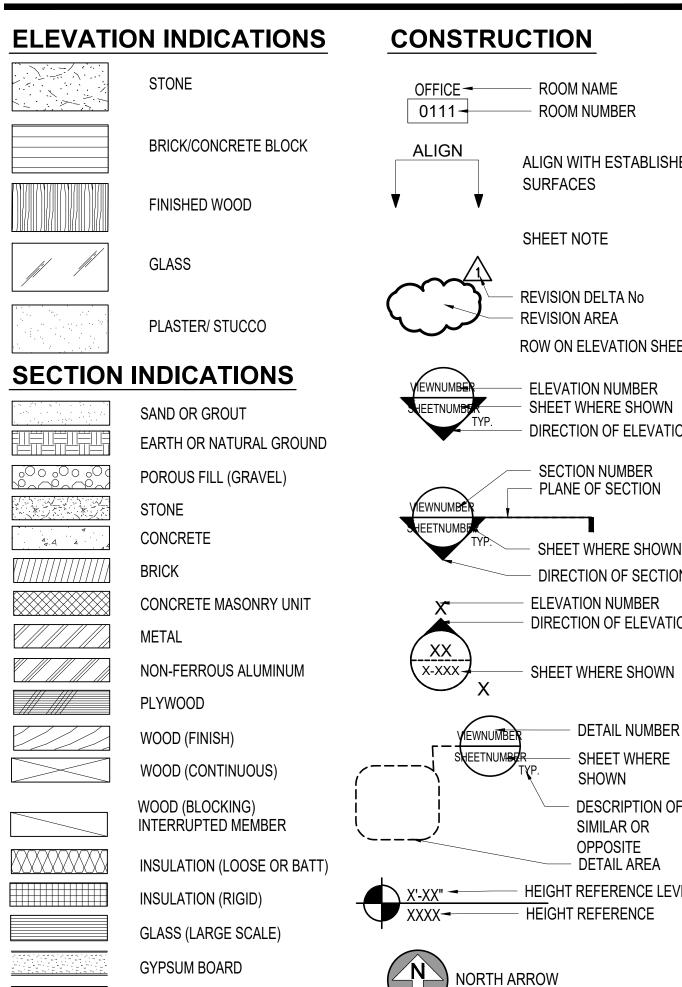

REFLECTED CEILING

AND GRID

FIXTURE

**FIXTURE** 

FIXTURE

- MAIN RUNNER

GYPSUM BOARD SOFFIT

4' X 4' FLUORESCENT LIGHT

2' X 2' FLUORESCENT LIGHT

LUNDER CABINET FLUORESCENT

FLUORESCENT STRIP FIXTURE

ACOUSTICAL CEILING

FUT FUTURE

FUT FUTURE

FLR FLOOR(ING)

FURN FURNITURE

FWC FABRIC WALL COVERING

### **ARCHITECTURAL ABBREVIATIONS**

	ACOUS AFF AHJ AL ALT	ACCESSORY ACOUSTIC(AL) ABOVE FINISHED FLOOR AUTHORITY HAVING JURISDICTION ALUMINUM ALTERNATE ANNUNCIATOR ANODIZED APPLIANCE ARCHITECT(URAL) AUTOMATIC AVERAGE AND	GA GFRC GFRG GFRP GL GR GYP HD HDWD	GAUGE GLASS FIBER REINFORCED CONCRETE GLASS FIBER REINFORCED GYPSUM GLASS FIBER REINFORCED PLASTER GLASS GRAD(E)(ING) GYPSUM  HEAD HARDWOOD	PTN PEDTR PBD PjM PNL POLYST PORT PREFIN PREFAB PLAM PLAS PLSTC PLYWD PRTECN R	PARTITION PEDESTRIAN PARTICLE BOARD PROJECT MANAGER PANEL POLYSTYRENE PORTABLE PREFINISHED PREFABRICATED PLASTIC LAMINATE PLASTIC PLYWOOD PROTECTION
	BLDG BOLLD BD BLKG BRDLM BU	BUILDING BOLLARD BOARD BLOCKING BROADLOOM BUILT UP	HDWE HM HORIZ HVAC	HARDWARE HOLLOW METAL HORIZONTAL HEATING, VENTILATING, AND AIR CONDITIONING	RDR RECES RECPT REF REFL REFR REQD	READER RECESSED RECEPTACLE REFER(ENCE) REFLECTED REFRIGERATOR REQUIRED
_	CAB CPT CEM CER CLG COATG	CABINET CARPET CEMENT(ITIOUS) CERAMIC CEILING COATING	INFO INSTRUM INSUL INTLK INT INFILTR	INFORMATION INSTRUMENT(ATION) INSULATION INTERLOCK(ING) INTERIOR INFILTRATION	RESIS REINF RESIL RFG RM RO	RESIST(ANT)(IVE) REINFORCE(D)(ING) RESILIENT ROOFING ROOM
	COILG CONC	COILING CONCRETE CONSTRUCTION CONTINUOUS(ATION) CONTRACT(OR)	JAN K	JANITOR	SCR SECUR SF SGL	SCRIBE SECURITY SQUARE FEET SINGLE
HED	COV CMU	COVER CONCRETE MASONRY UNIT	KIT L	KITCHEN	SHORG SIM SST STD STL	SHORING SIMILAR STAINLESS STEEL STANDARD STEEL
	DBL DEPT DES DET DF	DOUBLE DEPARTMENT DESIGN(ED) DETAIL DRINKING FOUNTAIN	LAV LB £ LT LVLG	LAVATORY POUND BRITISH POUND (CURRENCY) LIGHT LEVELING	STRFR STRUCT SURF SUSP SYS	STOREFRONT STRUCTURAL SURFACE SUSPENDED SYSTEM(S)
EET	DIA DIFF	DIAMETER DIFFUSER	LVR	LOUVER	T	
N	DIM DISP DIV DN \$ DR DSCON DWR	DIMENSION DISPENSER DIVISION DOWN DOLLAR (US CURRENCY) DOOR DISCONNECT DRAWER	MAX MFD MFR MECH MET MEMB MEZZ	MAXIMUM MANUFACTURED MANUFACTURER MECHANICAL METAL MEMBRANE MEZZANINE	THK TLT TRAF TRANS TRTD T&G TYP	THICK TOILET TRAFFIC TRANSPARENT TREATED TONGUE AND GROOVE TYPICAL
/N ON FION	ELAST ELEC EMBED ENGR	ELASTOMERIC ELECTRICAL EMBEDD(ED)(ING) ENGINEER(ED)	MIN MISC MLWK MOIST MOT	MINIMUM MISCELLANEOUS MILLWORK MOISTURE MOTOR(IZED)		UNDERLAYMENT UTILITY UNLESS NOTED OTHERWISE
N	ENTR EQ	ENTRANCE EQUAL	MTD	MOUNTED	٧	
ER	EQUIP EXIST EXP JT EXPS EXT	EQUIPMENT EXISTING EXPANSION JOINT EXPOSE(D) EXTERIOR	NIC NO NTS	NOT IN CONTRACT NUMBER NOT TO SCALE	VEH VERT VIF	VEHICLE VERTICAL VERIFY IN FIELD
OF	F		0		W/	WITH
EVEL	FAB FD FE FE&C FHC FIN FLDG	FABRICATION FLOOR DRAIN FIRE EXTINGUISHER FIRE EXTINGUISHER AND CABINET FIRE HOSE CABINET FINISH FOLDING	ORNA OVFL OVHD OPNG OPR	ORNAMENTAL OVERFLOW OVERHEAD OPENING(S) OPERABLE	WC WD WDW W/O WT WTRPRF	WATER CLOSET WOOD WINDOW WITHOUT WEIGHT WATERPROOFING
	FPLC FR FRMG FXD FXTR	FIREPLACE FIRE RAT(ING)(ED) FRAMING FIXED FIXTURE				

#### **INDEX**

#### **ARCHITECTURAL**

COVER A00.00 INDEX AND PROJECT INFORMATION A00.50 SITE PLAN

DEMOLITION PLAN A01.01

A02.01 TEMPORARY CONSTRUCTION FLOOR PLAN

CONSTRUCTION OF A PRE-FABRICATED METAL OPEN STRUCTURE TO

WORK THAT IS NOT STATED HEREIN NOR SHOWN IN THESE PLANS IS NOT

ADDITIONAL WORK REQUIRED THAT WOULD ALTER THE PRESENTED SCOPE

OF WORK SHALL BE SUBJECT TO A REVISION OF THESE DOCUMENTS AND TO BE REVIEWED BY THE BUILDING DEPARTMENT HAVING JURISDICTION.

ALL BIDS SHOULD INCLUDE MANUFACTURE'S WARRANTIES FOR A MINIMUM OF 5 YEARS AND INCLUDE A 5-YEAR MAINTENANCE PROGRAM TO BEGIN AT

A02.02 FLOOR PLAN

**ELEVATIONS & DETAILS** 

**SCOPE OF WORK** 

COVER AN EXISTING PLAYGROUND

NOTICE OF SUBSTANTIAL COMPLETION

PART OF THE SCOPE OF WORK FOR THIS PROJECT.

**OVERALL SCOPE OF WORK**\

**SCOPE OF WORK NOTES:** 

ARCHITECTURAL DESIGN COLLABORATIVE WINTER PARK, FLORIDA 327 OFFICE: (407) 629-1188 FAX: (407) 388-1220 ALBERT JOSEPH COOPER III STATE OF FLORIDA REGISTRATION NUMBER AA-C001315

Architect • Seal/Signature

# Project Documents for: F L O R I D A

YUCATAN PLAYGROUND COVER INVEST

6400 Yucatan Dr. Orlando, FL 32807

	Issue	Date	Issue Description	Ву	Check
_	01	05/30/2018	60% DD REVIEW SET	AA	AA
9	02	07/17/2018	90% CD REVIEW SET	AA	AA
Ź	03	11/09/2018	90% CD REVIEW SET	AA	AA
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Client Information Orange County
Capital Projects Division

400 E. SOUTH STREET ORLANDO, FL 32801

Project Number Issue Date 17034 02/21/2019 Drawn By **Project Status** ISSUED FOR PERMIT Scale AS SHOWN Checked By

File Name

Consultant • Seal/Signature

### NOTE TO CONTRACTOR

- GC IS RESPONSABLE TO RETURN THE SITE TO EXISTING CONDITIONS, RE-GRADE AND RE-SOD TO PREVIOUS CONDITIONS WHEN CONSTRUCTION IS COMPLETE"
- PATCH AND REPAIR ANY DAMAGED SURFACE AND POURED IN PLACE SAFETY
- ALL CONCRETE DEMOLITION AND REBUILD SHALL BE POURED IN FULL PANEL DIMENSIONS, JOINT TO JOINT.

Sheet Title: INDEX AND PROJECT INFORMATION

A00.00





# SITE PICTURE SCALE: N.T.S

SITE PICTURE
SCALE: N.T.S



SITE PICTURE
SCALE: N.T.S




SITE PICTURE SCALE: N.T.S

### **KEY NOTES**

- ©1) EXISTING EPDEM COVERED CONCRETE. SEE DETAILS 02 & 03 ON PAGE A09.01
- ©2 EXISTING 6'-0" CONCRETE SIDEWALK
- (03) EXISTING 8'-0" CONCRETE SIDEWALK
- (04) EXISTING FENCE GATE
- ©5 EXISTING FENCE (4'-0" HEIGHT) SEE DETAIL 04 ON PAGE A09.01
- 06 NEW PRE-FABRICATED METAL OPEN STRUCTURE TO COVER EXISTING PLAYGROUND (2,544 SF)
- 07) PROPERTY LINE



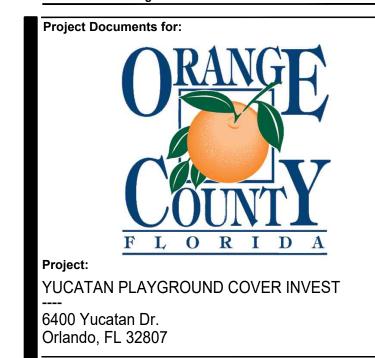

	Issue	Date	Issue Description	Ву	Check
	01	05/30/2018	60% DD REVIEW SET	AA	AA
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# **SHEET NOTES**


- 1. GC IS RESPONSIBLE TO RETURN THE SITE TO EXISTING CONDITIONS, RE-GRADE AND RE-SOD TO PREVIOUS CONDITIONS WHEN CONSTRUCTION IS COMPLETE.
  EXISTING FENCE TO BE REINSTALLED WHEN CONSTRUCTION IS COMPLETE.
  TARP COVERED CONCRETE TO BE REPAIR IF DAMAGED DURING CONSTRUCTION

04

Sheet Title: SITE PLAN

Consultant • Seal/Signature

A00.50

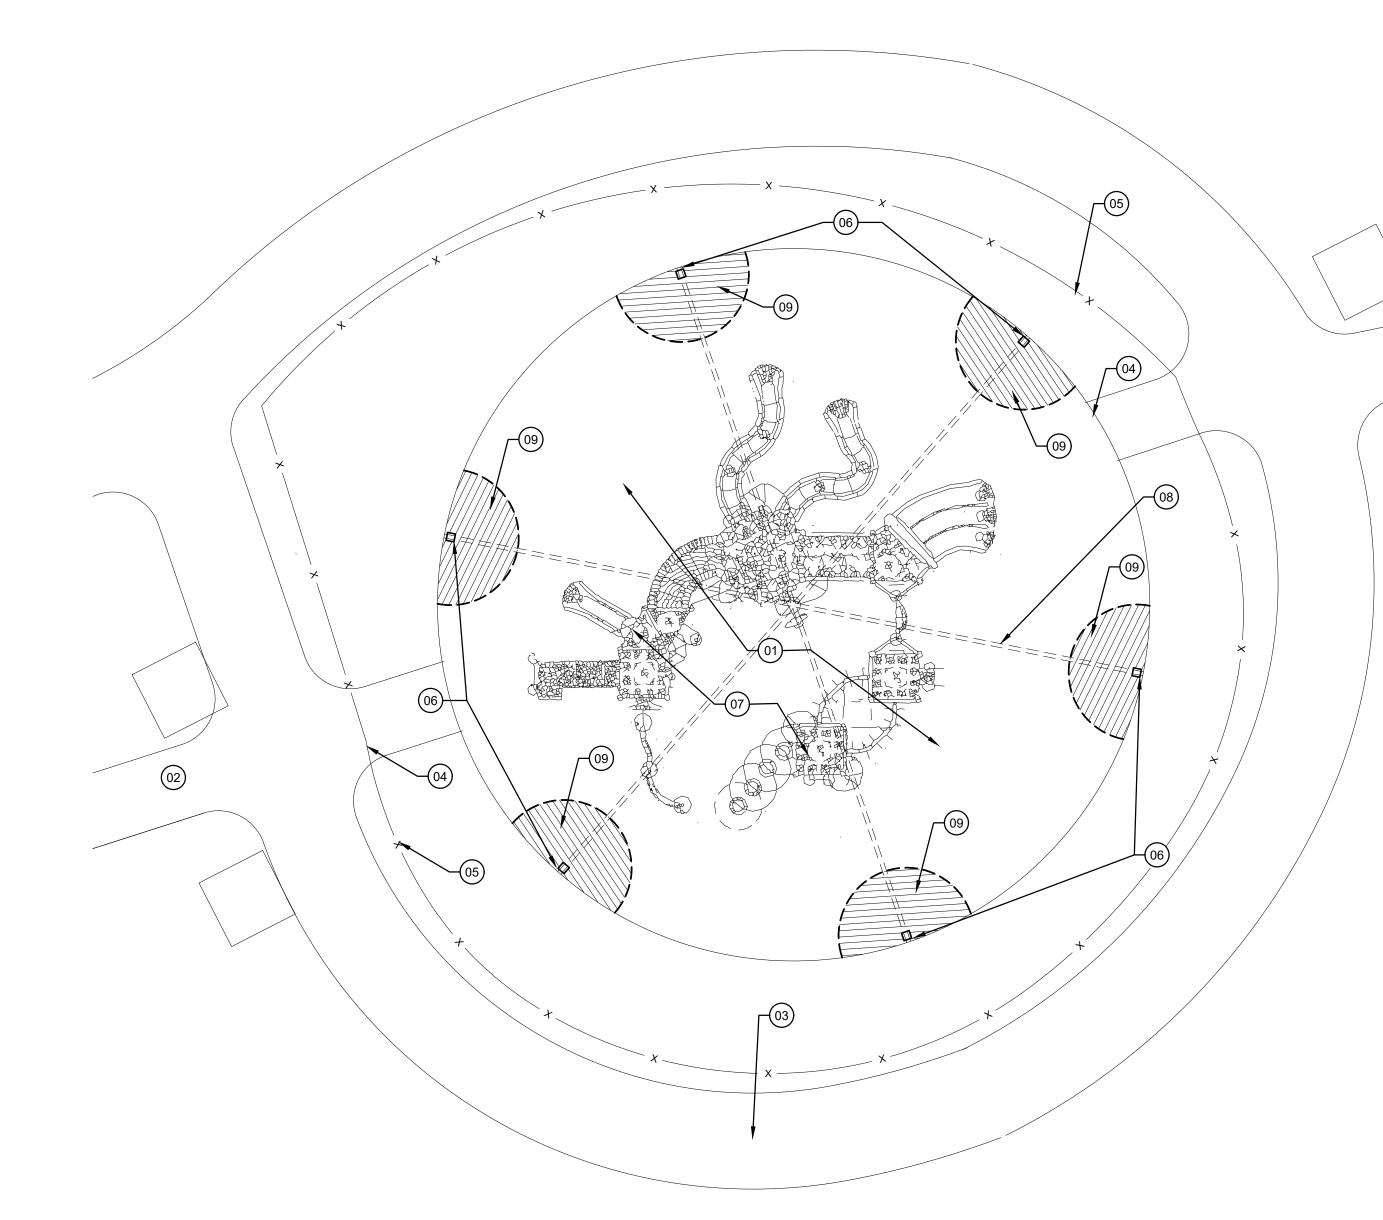

FLOOR PLAN
SCALE: 1/8" = 1'-0"

SHEET NOTES

ARCHITECTURAL DESIGN COLLABORATIVE WINTER PARK, FLORIDA OFFICE: (407) 629-1188 FAX: (407) 388-1220 WWW. ADCINTERNATION ALBERT JOSEPH COOPER III

AR-0010460
STATE OF FLORIDA REGISTRATION NUMBER AA-C001315

Architect • Seal/Signature

Project Documents for: F L O R I D A

YUCATAN PLAYGROUND COVER INVEST

6400 Yucatan Dr. Orlando, FL 32807

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	01	05/30/2018	60% DD REVIEW SET	AA	AA
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Client Information Orange County
Capital Projects Division
400 E. SOUTH STREET
ORLANDO, FL 32801

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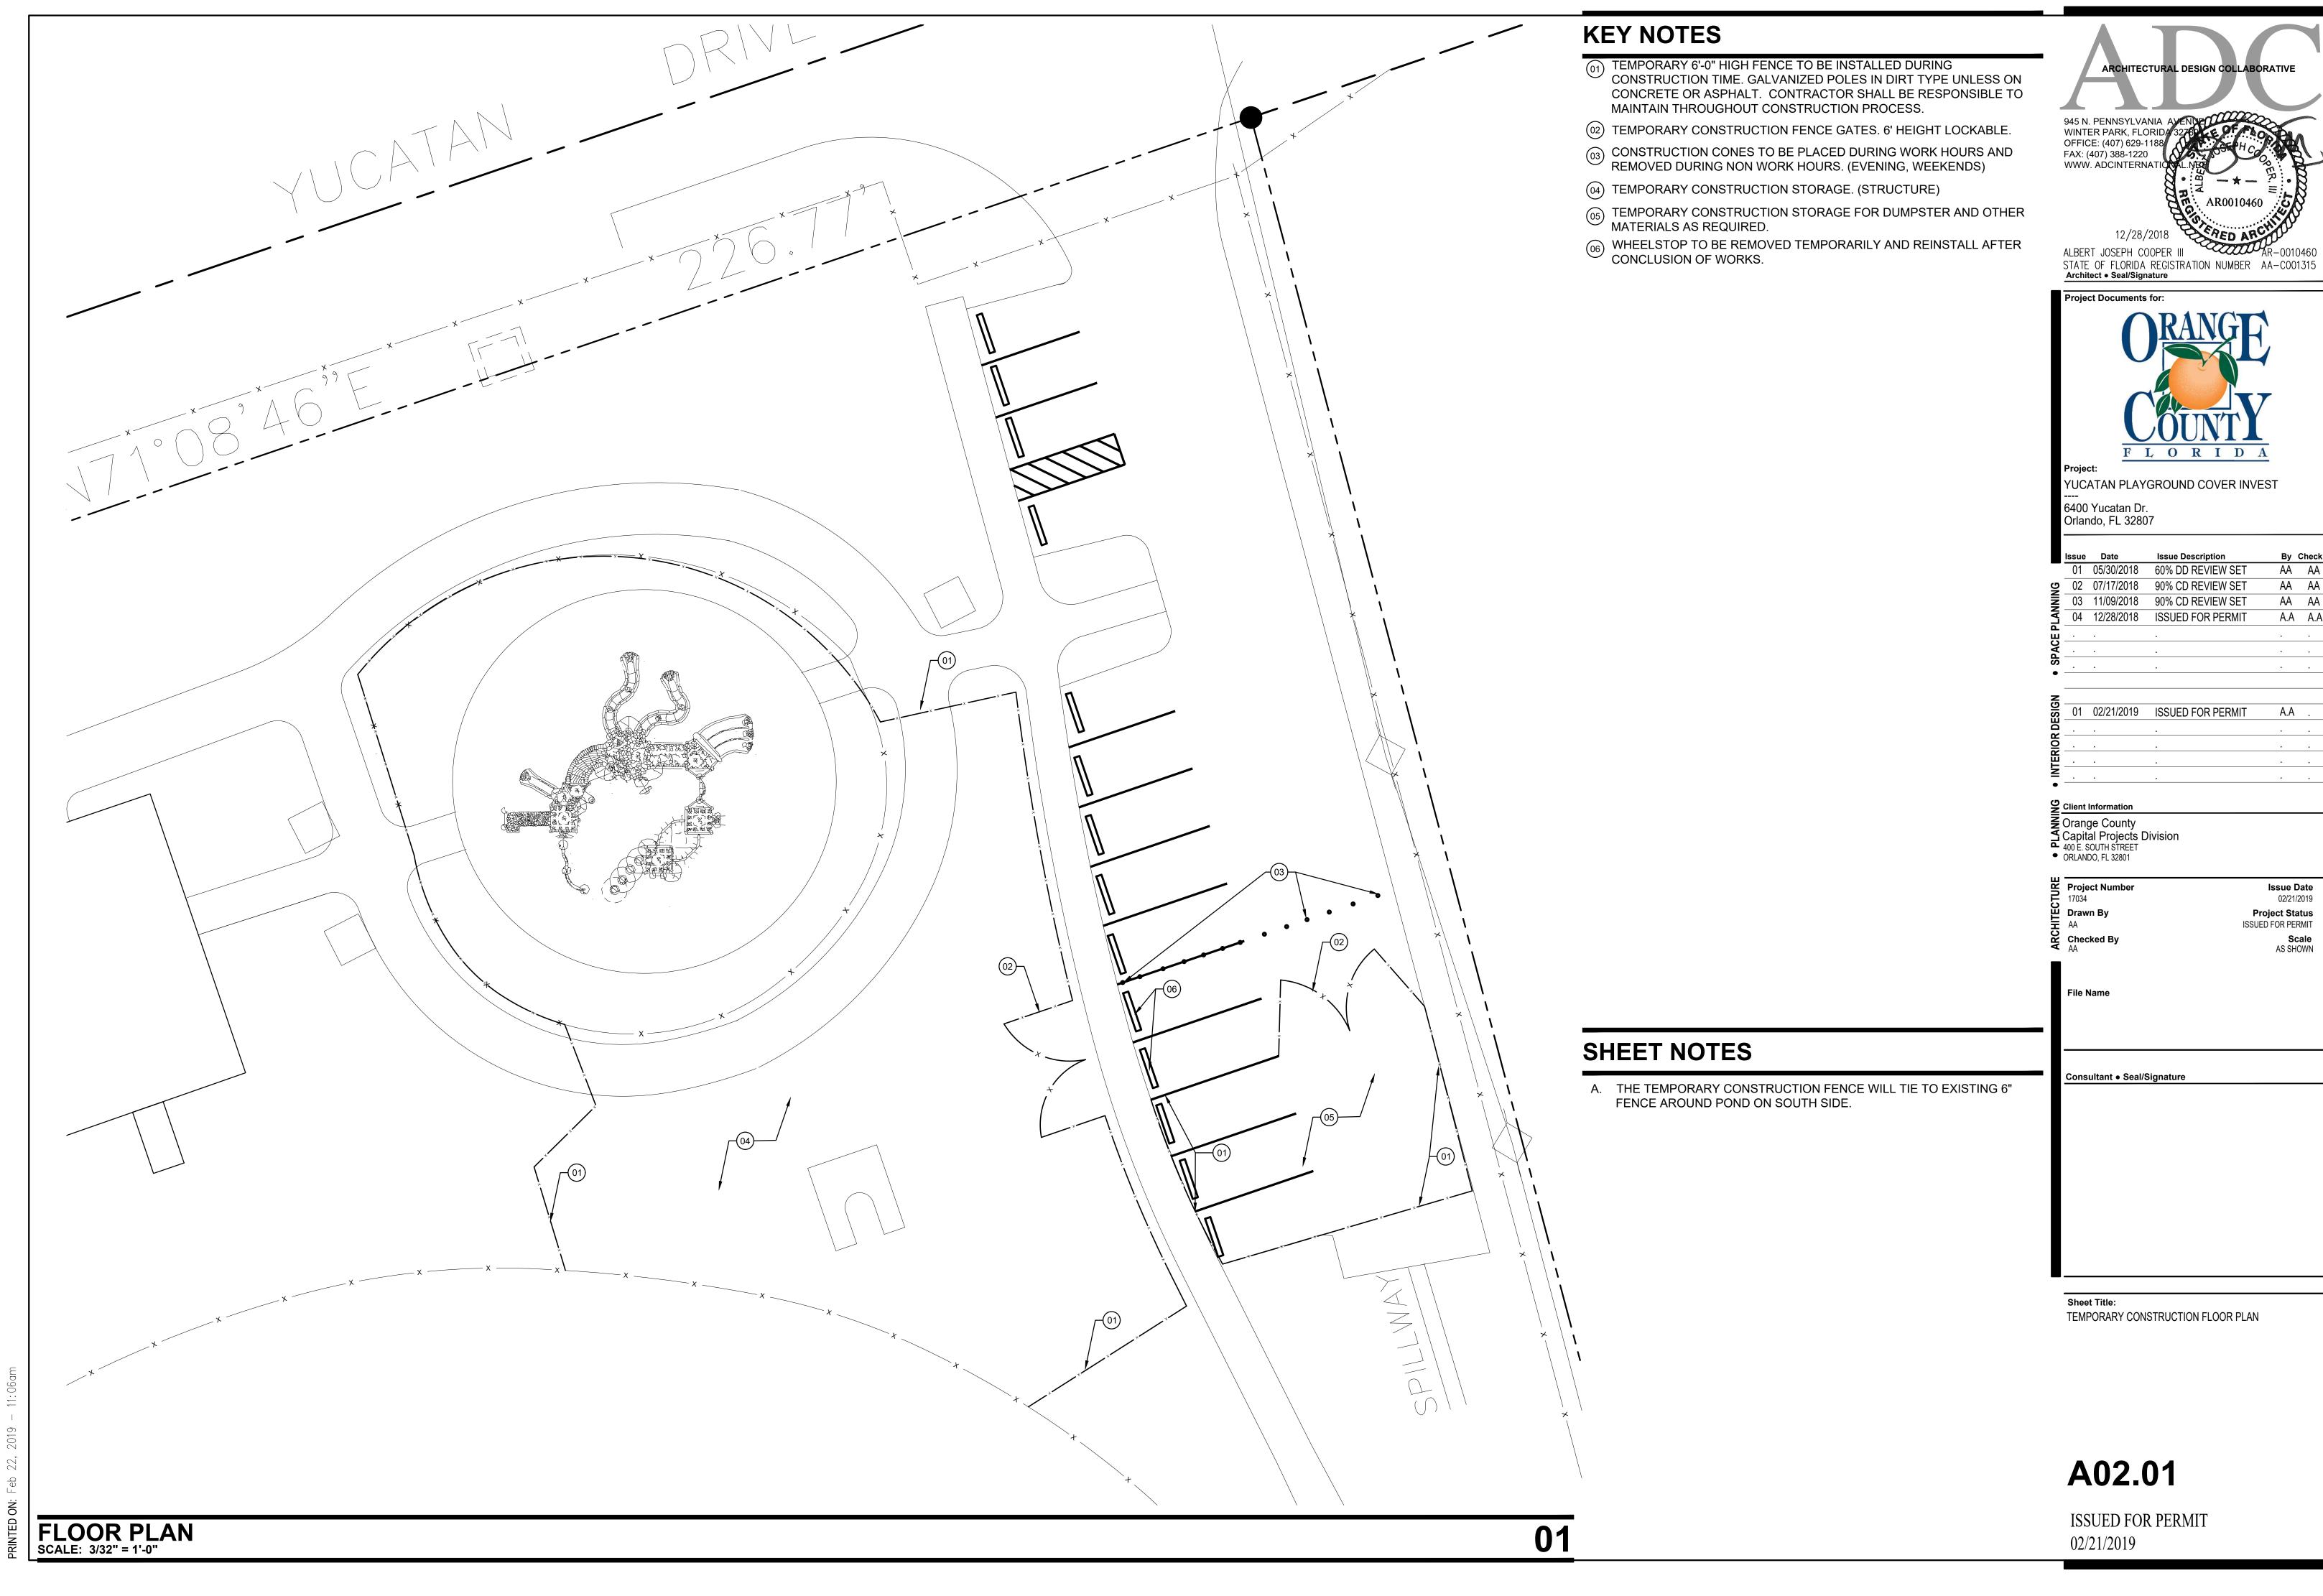
Consultant ● Seal/Signature

**KEY NOTES** 

- ©1 EXISTING SAFETY SURFACE TO REMAIN. GC TO PROTECT DURING CONSTRUCTION.
- ©2 EXISTING 6'-0" CONCRETE SIDEWALK
- (3) EXISTING 8'-0" CONCRETE SIDEWALK TO BE REMOVED AND RE-POURED AS REQUIRED TO ACCOMMODATE NEW CONCRETE FOOTINGS. COLOR AND FINISH TO MATCH EXISTING CONCRETE. ALL CONCRETE PANELS SHALL BE REPLACED WITH FULL PANEL DIMENSIONS, JOINT TO JOINT. NO PATCHES OR STRIP PATCHES ARE ALLOWED.
- ©4 EXISTING FENCE GATE TO BE REMOVED AND REINSTALLED AS REQUIRED TO ACCOMMODATE THE SITE CONSTRUCTION PROCESS.
- (05) EXISTING FENCE (4'-0" HEIGHT) TO BE REMOVED AND NEW FENCE TO BE INSTALLED AS REQUIRED TO ACCOMMODATE FOOTING EXCAVATION AND CONCRETE POUR.
- EXISTING METAL STRUCTURE TO BE DEMOLISHED. EXISTING COLUMNS AND FOOTINGS TO BE REMOVED. GC SHALL REMOVE SURFACE IN PATTERN AS SHOWN 5'-8" RADIUS FROM EDGE OF SURFACE, TO EXCAVATE AND DEMOLISH EXISTING STRUCTURE. CONTRACTOR SHALL PHOTOGRAPH THE DEMOLITION PROCESS OF THIS STRUCTURE FOR THE COMPTROLLER'S OFFICE AS REQUIRED TO ILLUSTRATE COMPLETE DESTRUCTION OF SHADE STRUCTURE.
- (07) EXISTING PLAYGROUND STRUCTURES TO BE PROTECTED DURING CONSTRUCTION.
- (08) EXISTING HEXAGON METAL SHADE STRUCTURE TO BE REMOVED.
- ©9 EXISTING POURED IN PLACE. SAFETY SURFACE AND BASE MATERIAL TO BE REMOVED IN ORDER TO ACCOMMODATE THE FOOTING EXCAVATION AND CONSTRUCTION. ALL FOOTING SPOILS SHALL BE REMOVED FROM SITE AT THE CONTRACTOR EXPENSE. SEE DETAILS 02 & 03 ON PAGE A09.01


Sheet Title: **DEMOLITION PLAN** 

A01.01



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	01	05/30/2018	60% DD REVIEW SET	AA	AA
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ROOF PLAN SCALE: 1/8" = 1'-0" **KEY NOTES** 

**SHEET NOTES** 

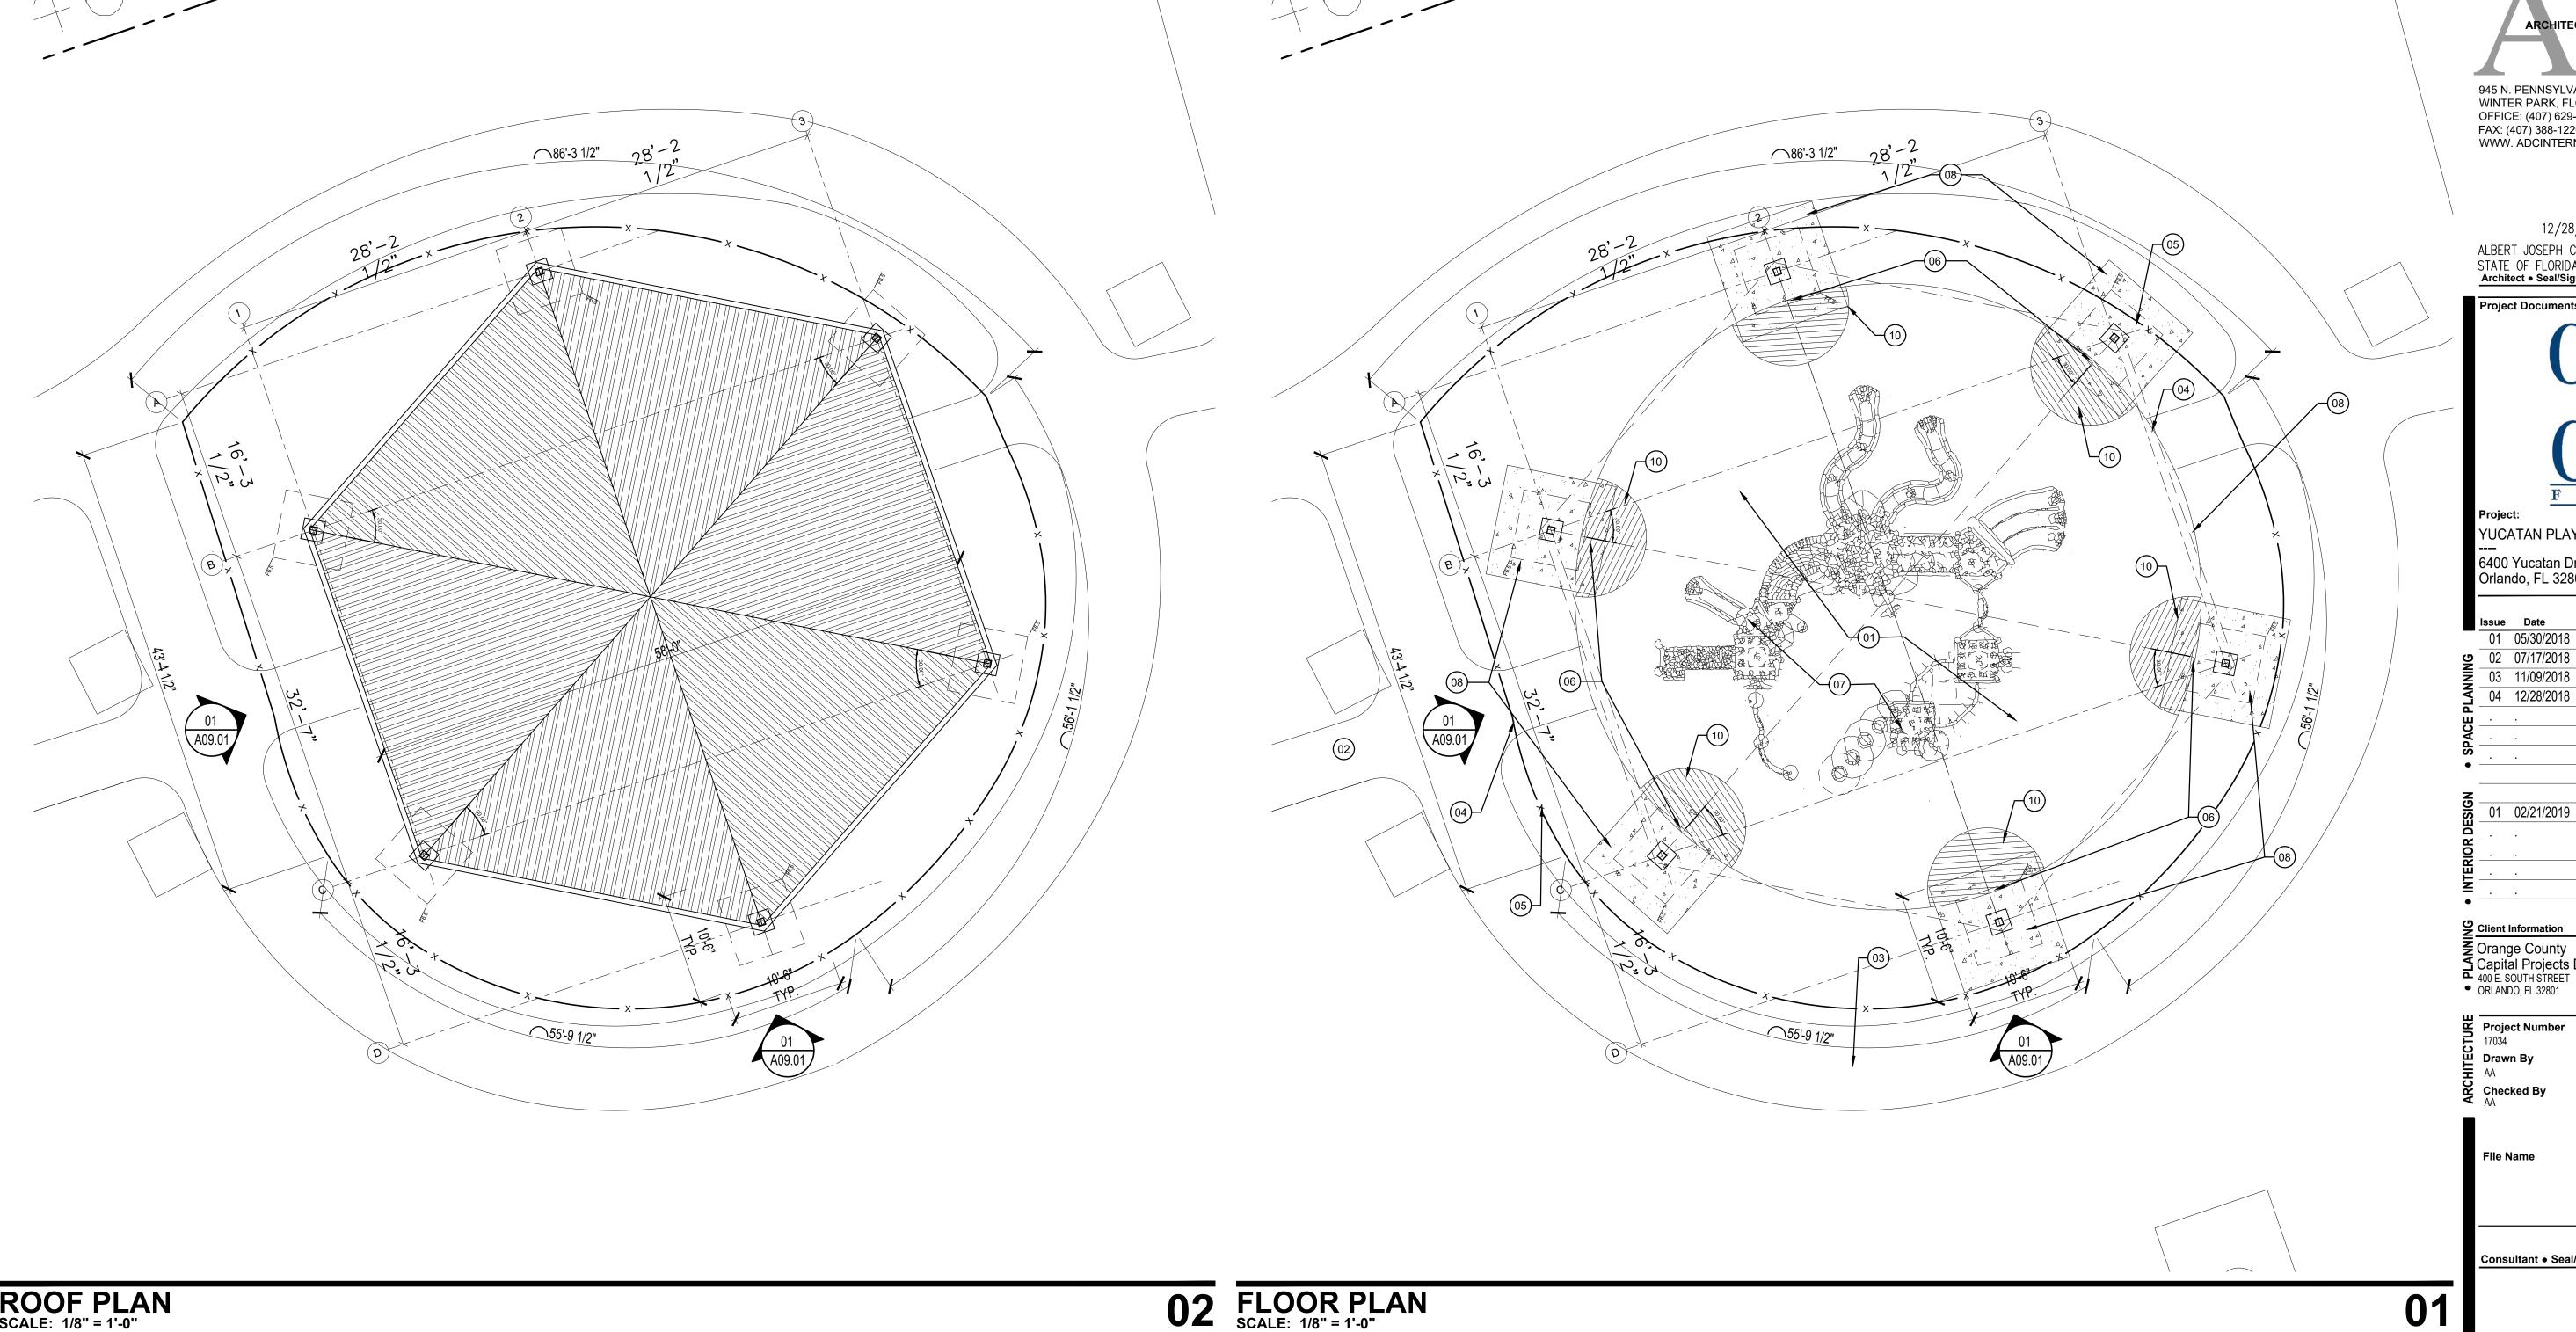(01) EXISTING SAFETY SURFACE TO BE PROTECTED DURING CONSTRUCTION.

(02) EXISTING 6'-0" CONCRETE SIDEWALK

- ©3 EXISTING 8'-0" CONCRETE SIDEWALK TO BE REMOVED AND RE-POURED AS REQUIRED TO ACCOMMODATE PROPOSED CONCRETE FOOTINGS. COLOR AND FINISH TO MATCH EXISTING CONCRETE. ALL CONCRETE PANELS SHALL BE REPLACED WITH FULL PANEL DIMENSIONS, JOINT TO JOINT. NO PATCHES OR STRIP PATCHES ARE ALLOWED.
- NEW FENCE TO BE INSTALLED. BLACK VINYL COATED CHAIN LINK WITH TOP RAIL AND BOTTOM TENSION OR WIRE. GATES LOCATED IN SAME POSITION AS IN PRE-CONSTRUCTION, DEMOLITION CONDITION.
- (05) EXISTING FENCE (4'-0" HEIGHT) TO BE REMOVED AS REQUIRED TO ACCOMMODATE FOOTING EXCAVATION AND CONCRETE POUR.
- PROPOSED SAFETY SURFACE PATCH, 5'-8" RADIUS FROM EDGE OF SURFACE.PATH TO MATCH EXISTING MATERIAL AND THICKNESS. PROPOSED PATCH COLOR BLUE. PATCHED SHALL BE EPDM 50/50 BLUE/BLACK MIX. INSTALL BASE AND SAFETY SURFACE PER DETAILS AND SPECIFICATIONS. TO MATCH EXISTING THICKNESS.
- (07) EXISTING PLAYGROUND STRUCTURES TO BE PROTECTED DURING CONSTRUCTION .
- PROPOSED HEXAGONAL SHADE PAVILION, 58 FEET WIDE, GALVALUME STANDING SEAM ROOF WITH YELLOW PINE TONGUE AND GROOVE ROOF DECKING. ROOF DECKING WITH CLEAR COAT FINISH PRIOR TO SHIPPMENT, TOUCH UP ON SITE BY GC AS REQUIRED. BLACK POWDER COATED STEEL STRUCTURE AND
- PROPOSED CONCRETE FOOTINGS, REFER TO STRUCTURAL PLANS. REMOVE EXISTING STRUCTURAL FOOTINGS TO ACCOMMODATE THE NEW PAVILION FOOTINGS
- POURED IN PLACE EPDM SAFETY SURFACE WITH FACE TO MATCH EXISTING. IF AGREGATE NEEDS TO BE USED SHALL BE #89 GRANITE WITH FILTER FABRIC TOP AND BOTTOM. CONTRACTOR SHALL CLUE SEAMS AT EXISTING MENT OF THE PROPERTY OF THE PROP  $^{\prime}$  TOP AND BOTTOM. CONTRACTOR SHALL GLUE SEAMS AT EXISTING-NEW SURFACE TRANSITION PER MANUFACTURER RECOMENDATIONS. EDGE AT GRASS TO BE TURN DOWN EDGE. SEE DETAILS ON PAGE A09.01

- A. THE PRE ENGINEERED METAL BUILDING SHALL BE DESIGNED AS A COMPLETE SYSTEM. ALL COMPONENTS OF THE SYSTEM SHALL BE SUPPLIED OR SPECIFIED BY THE SAME MANUFACTURER. REFER TO SPECIFICATION.
- B. BASIS OF DESIGN (SHOWN ON PLANS). VENDORS
  - 1. POLIGON. STRUCTURE HXE, 58', 15' HT. REP. SERVICES. (407) 831-9658. MARY LANGLEY
  - 2. ICON SHELTER. DOMINICA RECREATION PRODUCTS. (407) 331-0101. PHIL DOMICA
  - 3. AMERICANA BUILDING PRODUCTS. TOP LINE RECREATION. (800) 921-4509. ERNESTO SANTANA.

ARCHITECTURAL DESIGN COLLABORATIVE WINTER PARK, FLORIDA OFFICE: (407) 629-1188 FAX: (407) 388-1220 WWW. ADCINTERNATION ALBERT JOSEPH COOPER III

STATE OF FLORIDA REGISTRATION NUMBER AA-C001315

Architect • Seal/Signature Project Documents for:

F L O R I D A

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Orange County
Capital Projects Division

Project Number


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01

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Sheet Title: FLOOR PLAN

A02.02



10'-0" 10'-0" MAXIMUM TOP RAIL BRACE BAR #6 GAUGE VINYL COATED FABRIC - COILED SPRING REINFORCING WIRE. -TRUSS ROD 3/8" MINIMUM DIAMETER. '-6" (4' HIGH) '-6" (6' HIGH) '-6" (8' HIGH) '-0" (10' HIGH) (4' HIGH) (6' HIGH) (8' HIGH) (10' HIGH) - BRACE POST 2'-0" (4' 1 3'-0" (6' 1 3'-0" (8' 1 3'-6" (10' -CORNER POST 2'-6" ( 3'-6" ( 4'-0" ( - 3000 PSI CONCRETE LINE POST POST DIA. +10" POST DIA. +10" POST DIA. +10"

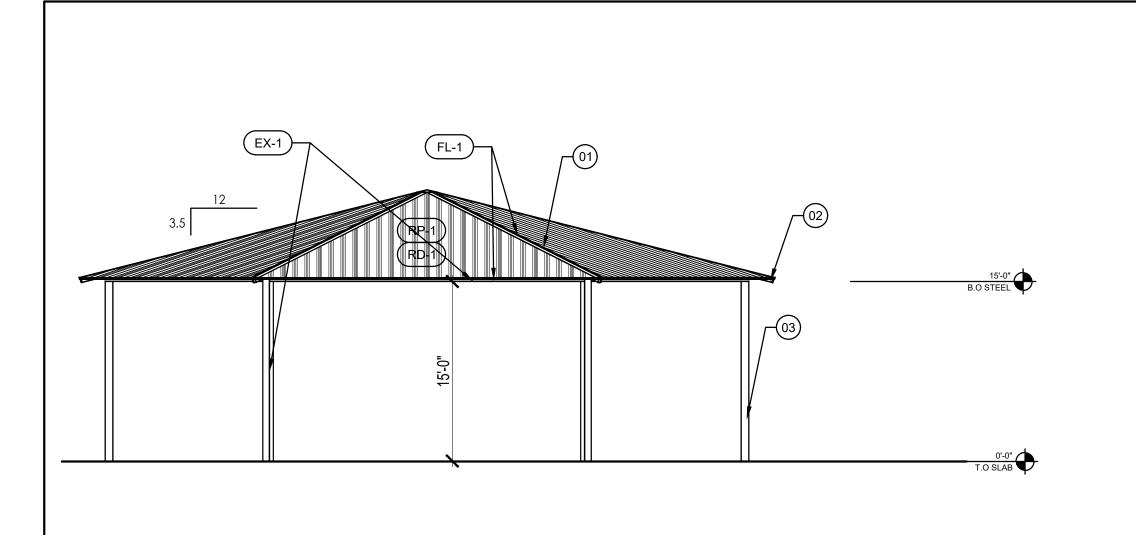TOP AND BOTTOM OF FABRIC SHALL BE TWISTED AND KNUCKLED DOWN

1. ALL CHAINLINK FENCING FABRIC SHALL BE VINYL COATED. COLOR: BLACK 2. ALL POSTS AND ACCESSORIES SHALL BE PAINTED BLACK TO MATCH FABRIC COLOR.

#### CHAIN LINK FENCE DETAIL SCALE: NOT TO SCALE

 DRILL AND EPOXY OR SOME EQUAL METHOD. - COMPACTED BACKFILL PIN PROPOSED SLAB TO EXISTING SLAB 24" O.C. W #4 SMOOTH DOWEL AND COLLAR.

DETAIL COLD JOINT CONCRETE SLAB

### **KEY NOTES**

METAL PANEL

STRUCTURE

- (1) STANDING SEAM ROOF, GALVALUME COLOR BLUE, WITH YELLOW PINE ROOF DECK CLEAR COAT FINISH FACTORY APPLIED PRIOR TO SHIPPING. REFER TO SPECIFICATIONS
- (02) PREFINISHED GALV. METAL GABLE, RIDGE
- (93) BLACK POWDER COATED STEEL STRUCTURE

**EXTERIOR FINISH SCHEDULE** 

METAL ROOFING COLOR LIGHT BLUE

ROOF DECK, TONGUE & GROOVE YELLOW PINE WITH


CLEAN COAT FINISH. FINISH TO BE FACTORY APPLIED BEFORE SHIPPING. G.C TO APPLY TOUCH UPS TON SITE

BLACK POWDER COATED STEEL STRUCTURE AND COLUMNS

METAL FLASHING COLOR BLACK

AS REQUIRED.

COLOR BLACK

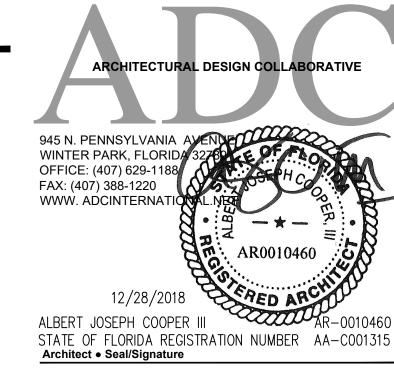



YUCATAN PLAYGROUND COVER INVEST

6400 Yucatan Dr. Orlando, FL 32807

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Client Information

Orange County
Capital Projects Division
400 E. SOUTH STREET
ORLANDO, FL 32801

Consultant • Seal/Signature

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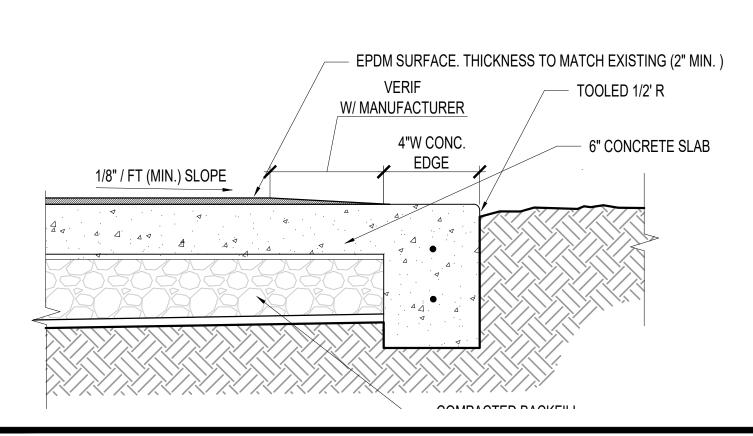
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- A. THE PRE ENGINEERED METAL BUILDING SHALL BE DESIGNED AS A COMPLET SYSTEM. ALL COMPONENTS OF THE SYSTEM SHALL BE SUPPLIED OR SPECIFIED BY THE SAME MANUFACTURER. REFER TO SPECIFICATION.
- 1. POLIGON. STRUCTURE HXE, 58', 15' HT. REP. SERVICES. (407) 831-9658. MARY LANGLEY
- ERNESTO SANTANA.

Sheet Title: **ELEVATIONS & DETAILS** 


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**ISSUED FOR PERMIT** 



ELEVATION SCALE: 1/8" = 1'-0"

EPDM/GRASS EDGE DETAIL (EXISTING)
SCALE: 1-1/2"=1'-0"

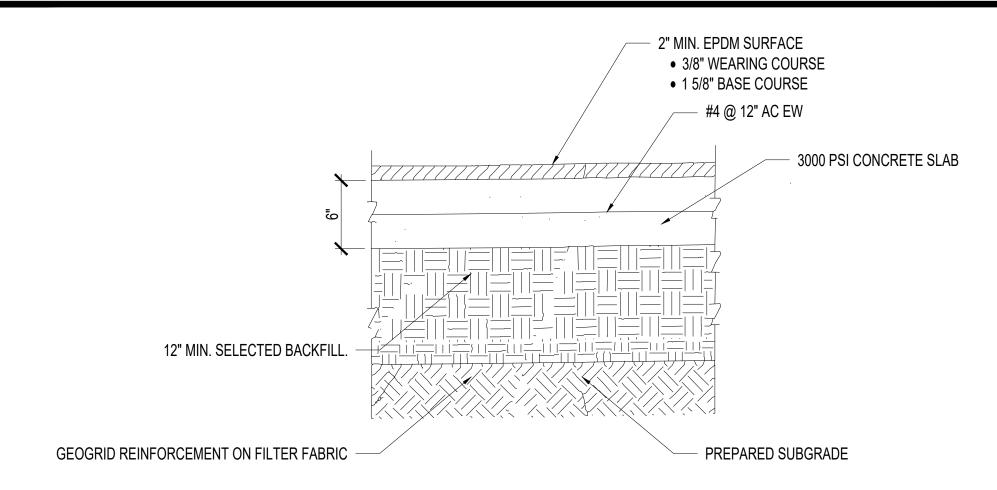

SECTION @ PLAYGROUND / TOT-LOT SURFACE SCALE: 1-1/2"=1'-0"

02

SHEET NOTES

05

B. BASIS OF DESIGN (SHOWN ON PLANS). VENDORS

2. ICON SHELTER. DOMINICA RECREATION PRODUCTS. (407) 331-0101. PHIL


3. AMERICANA BUILDING PRODUCTS. TOP LINE RECREATION. (800) 921-4509.

02/21/2019

## STRUCTURAL ABBREVIATIONS

# STRUCTURAL SYMBOLS AND LEGEND

ENGR EOOR SP EOOS SP EEXT FON FINN R FINN FILS TO GALV DG IZ HOORAS HOOS HOOS HOOS HOOS HOOS HOOS HOOS HO	EXPANSION JOINT ELECTRIC/ELECTRICAL ELEVATION ENGINEER EDGE OF DECK ENGINEER OF RECORD EDGE OF SLAB EQUAL SPACED EACH SIDE EACH WAY EXISTING EXPANSION EXTERIOR  FOUNDATION FLOOR DRAIN FOUNDATION FINISHED FLOOR FINISH FINISH GRADE FLOOR FAR SIDE FEET/FOOT FOOTING  GAGE/GAUGE GALVANIZED GRADE BEAM GENERAL CONTRACTOR GENERAL GRID LINE GALVANIZED STEEL  HOT DIPPED HOT DIPPED HOT DIPPED GALVANIZED HORIZONTAL HEADED STUD ANCHOR HOLLOW STRUCTURAL SECTION HEIGHT  MOMENT OF INERTIA	LSON TO SELECT T	LONGITUDINAL LAMINATED STRAND LUMBER LAMINATED STRAND LUMBER MATERIAL MAXIMUM MASONRY BEAM MECHANICAL MIDDLE MINIMUM MISCELLANEOUS MASONRY OPENING MILES PER HOUR NATIONAL GEODETIC VERTICAL DATUM NOT IN CONTRACT NUMBER NOT TO SCALE ON CENTERS OUTSIDE DIAMETER OUTSIDE DIAMETER OUTSIDE DIAMETER OUTSIDE DIAMETER OUTSIDE FACE OPENING OPPOSITE ORIENTED STRAND BOARD  PRECAST CONCRETE BEAM PRECAST CONCRETE BEAM PRECAST CONCRETE OLUMN POUNDS PER CUBIC FEET PRE-ENGINEERED METAL BUILDING PENETRATION PANEL JOINT CENTERLINE PLATE POUNDS PER LINEAR FOOT PLUMBING PLYWOOD PREFABRICATED POUNDS PER SQUARE FOOT POUNDS PER SQUARE INCH PARALLEL STRAND LUMBER PRESSURE TREATED  ROOF DRAIN REFERENCE REINFORCING REQUIRED REVISION ROOF TOP UNIT  SOFFIT BEAM SCHEDULE SQUARE STAINLESS STEEL STANDARD STIFFENER STEEL STRIP FOUNDATION SIMILAR SYMMETRICAL TOP OF TIE BEAM SCHEDULE STANDARD STIFFENER STEEL STRIP FOUNDATION SIMILAR SYMMETRICAL TOP OF TIE BEAM TOP AND BOTTOM TURN DOWN SLAB THICKENED EDGE TEMPERATURE TENSION THREAD/THREADED THICKE VERTICAL VOLUME  VERTICAL VOLUME
GALV GB GC GEN GL GS HD HDG HORIZ HSA HSS	GALVANIZED GRADE BEAM GENERAL CONTRACTOR GENERAL GRID LINE GALVANIZED STEEL  HOT DIPPED HOT DIPPED GALVANIZED HORIZONTAL HEADED STUD ANCHOR HOLLOW STRUCTURAL SECTION HEIGHT	TENS THD THK TOL TRANS TS T.S. TWF TYP UNO VERT	TENSION THREAD/THREADED THICK TOLERANCE TRANSVERSE TUBE STEEL THICKENED SLAB THICKENED WALL FOUNDATION TYPICAL UNLESS NOTED OTHERWISE VERTICAL

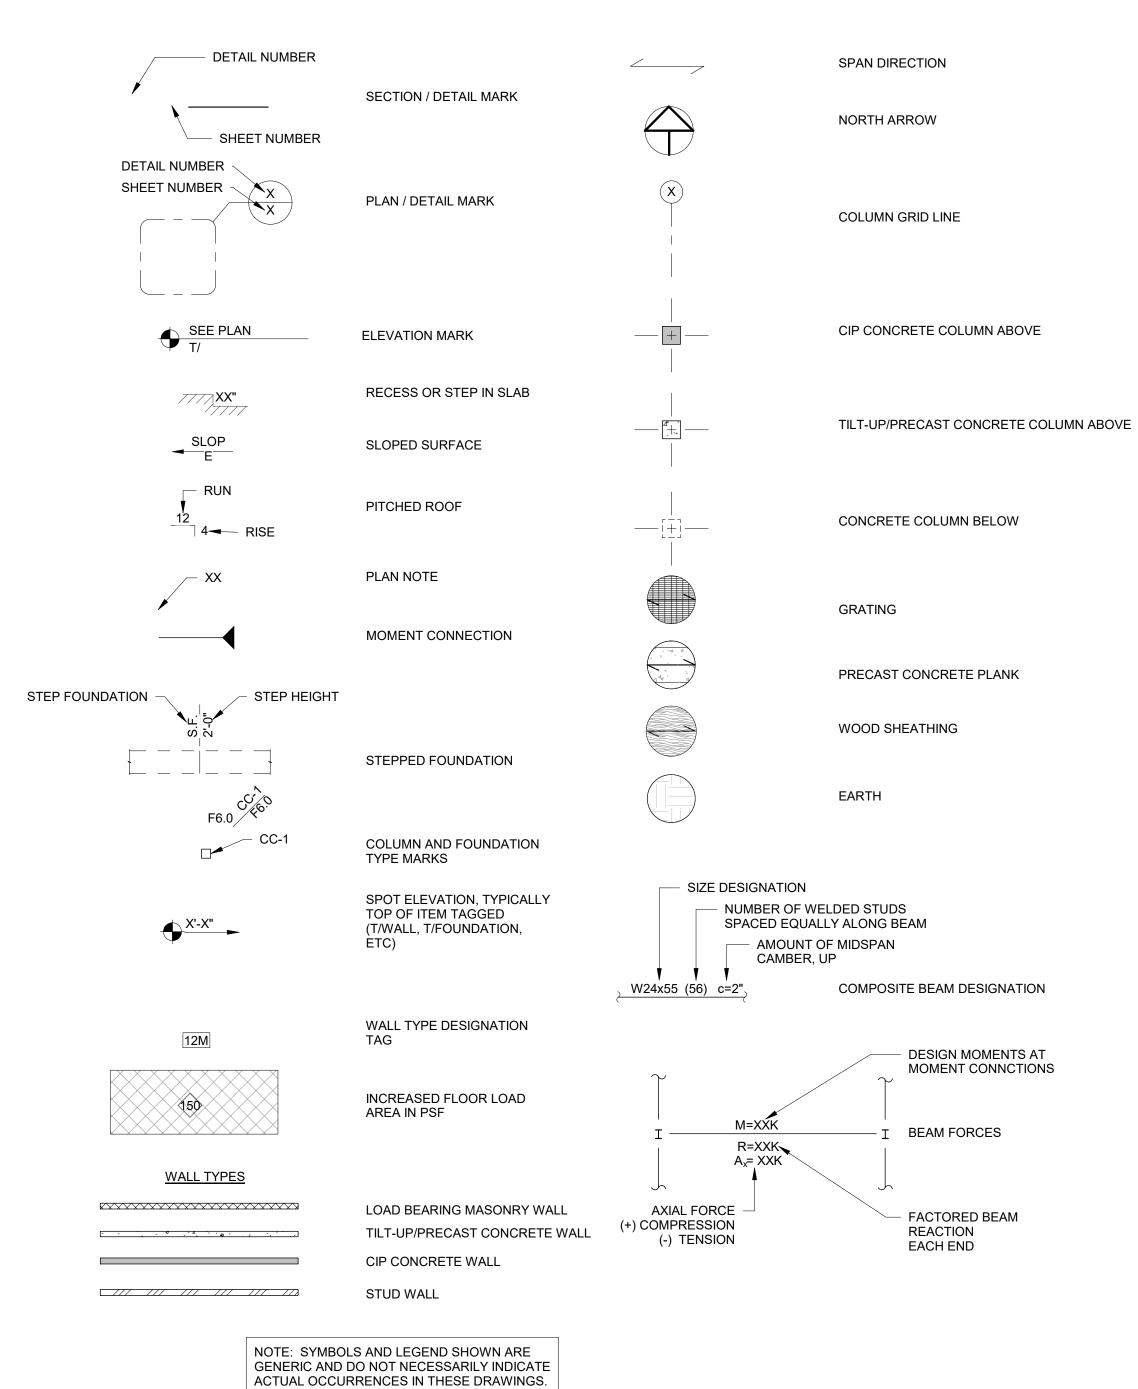

	STRUCTURAL SHEET INDEX
SHEET#	SHEET TITLE
S001	ABBREVIATIONS SYMBOLS AND SHEET INDEX
S002	STRUCTURAL GENERAL NOTES
S100	FOUNDATION PLAN
S300	SECTIONS & DETAILS




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AA-COO1315 | AR-0010536 RAYMUNDO FEITO, R.A. STATE OF FLORIDA



Project:
YUCATAN PLAYGROUND COVER INVEST

6400 Yucatan Dr. Orlando, FL 32807

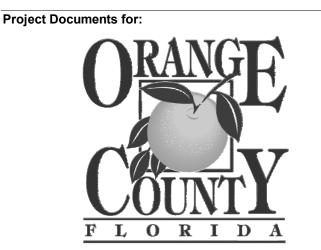Issue	Date	Issue Description	By Check
1	05/30/2018	60% SD REVIEW SET	MR LBB
2	07/17/2018	90% CD REVIEW SET	MR LBB
3 4	11/09/2018	90% CD REVIEW SET	MR LBB
<u>4</u>	12/28/2018	ISSUED FOR PERMIT	MR LBB
PACE			


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Client Information
Orange County
Capital Projects Division
400 E. SOUTH STREET
ORLANDO, FL 32801

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_	Project Number	Issue Date
$\Box$	17034	02/21/2019
	Drawn By	Project Status
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3/32" = 1'-0"
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ABBREVIATIONS SYMBOLS AND SHEET INDEX

**S001** 

#### **GENERAL NOTES**

#### A. STRUCTURAL DRAWINGS SHALL BE USED IN CONJUNCTION WITH THE ARCHITECTURAL MECHANICAL, ELECTRICAL, SHOP DRAWINGS AND SPECIFICATIONS. THE CONTRACTOR SHALL COORDINATE ALL ELEVATIONS AND DIMENSIONS, INCLUDING BUT NOT LIMITED TO THOSE FOR OPENINGS IN WALLS AND IN ROOF AND FLOOR SYSTEMS, WITH THE OTHER DISCIPLINES. THE GENERAL CONTRACTOR SHALL COMPARE ALL CONTRACT DRAWINGS AND REPORT ANY DISCREPANCY BETWEEN DISCIPLINES AND WITHIN A GIVEN DISCIPLINE TO THE ARCHITECT AND

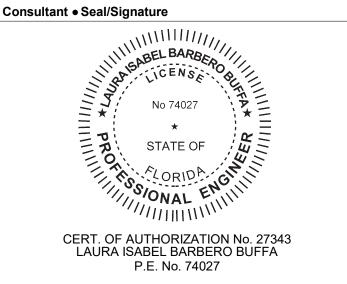- ENGINEER BEFORE PROCEEDING WITH THE AFFECTED PART OF THE WORK. B. ALL DIMENSIONS, ELEVATIONS, AND ANY OTHER CONDITIONS OF ANY EXISTING STRUCTURES OR OTHER FEATURES SHALL BE VERIFIED BY THE GENERAL CONTRACTOR AND ANY DISCREPANCIES WITH THE CONTRACT DRAWINGS REPORTED TO THE ARCHITECT AND ENGINEER BEFORE PROCEEDING WITH THE AFFECTED PART OF THE WORK. DURING THE CONSTRUCTION PROCESS, IT SHALL BE SOLELY THE CONTRACTOR'S RESPONSIBILITY TO MAINTAIN THE INTEGRITY OF THE
- EXISTING STRUCTURE AND TO PROTECT FROM DAMAGE ANY PORTIONS THAT ARE TO REMAIN. C. IT IS THE GENERAL CONTRACTOR'S RESPONSIBILITY TO OBTAIN ALL CONTRACT DOCUMENTS AND LATEST ADDENDA AND TO SUBMIT TO ALL SUBCONTRACTORS AND SUPPLIERS PRIOR TO THE SUBMITTAL OF SHOP DRAWINGS.
- D. IF A CONFLICT EXISTS AMONG THE STRUCTURAL DRAWINGS, GENERAL NOTES, OR THE SPECIFICATIONS, THE STRICTEST REQUIREMENTS, AS INDICATED BY THE ENGINEER, SHALL
- E. THE STRUCTURE IS DESIGNED TO BE SELF SUPPORTING AND STABLE AFTER THE BUILDING IS COMPLETE. THE COMPLETED LATERAL-FORCE RESISTING SYSTEMS AND DIAPHRAGMS ARE REQUIRED FOR THE STRUCTURE TO RESIST LATERAL LOADS AND PROVIDE STABILITY UNDER GRAVITY LOADS. DURING THE CONSTRUCTION PROCESS, THE CONTRACTOR SHALL PROVIDE ALL REQUIRED BRACING DURING CONSTRUCTION TO MAINTAIN THE STABILITY AND SAFETY OF ALL STRUCTURAL ELEMENTS UNTIL THE LATERAL-LOAD RESISTING OR STABILITY-PROVIDING SYSTEM IS COMPLETELY INSTALLED AND THE STRUCTURE IS COMPLETELY TIED TOGETHER. THIS ALSO INCLUDES NECESSARY SHORING, SHEETING, GUYS OR TIE DOWNS.
- UNLESS OTHERWISE NOTED, DETAILS SHOWN ON ANY DRAWING ARE TO BE CONSIDERED TYPICAL FOR ALL SIMILAR CONDITIONS. DETAILS LABELED TYPICAL DETAILS ON THE DRAWINGS SHALL APPLY TO ALL SITUATIONS OCCURRING ON THE PROJECT THAT ARE SIMILAR OR SAME TO THOSE SPECIFICALLY DETAILED. THE APPLICABILITY OF THE DETAIL TO ITS LOCATION CAN BE DETERMINED BY THE TITLE OF DETAIL. SUCH DETAILS SHALL APPLY WHETHER OR NOT THEY ARE REFERENCED AT EACH LOCATION.
- G. THE CONTRACTOR SHALL BE SOLELY RESPONSIBLE FOR ALL CONSTRUCTION MEANS AND METHODS AND FOR SAFETY PRECAUTIONS AND PROGRAMS. DURING THE CONSTRUCTION PROCESS, IT SHALL BE SOLELY THE CONTRACTOR'S RESPONSIBILITY TO MAINTAIN THE INTEGRITY OF THE EXISTING STRUCTURE AND TO PROTECT FROM DAMAGE ANY PORTIONS THAT ARE TO
- BASE CONSULTANTS, INC., SHALL NOT BE RESPONSIBLE FOR THE ACTS OR OMISSION OF THE CONTRACTOR OR FOR THEIR FAILURE TO CARRY OUT THE WORK IN ACCORDANCE WITH THE
- PERIODIC SITE OBSERVATION BY BASE CONSULTANTS, INC. IS SOLELY FOR THE PURPOSE OF DETERMINING IF THE WORK OF THE CONTRACTOR IS PROCEEDING IN ACCORDANCE WITH THE STRUCTURAL CONTRACT DOCUMENTS. THIS LIMITED SITE OBSERVATION SHALL NOT BE CONSTRUED AS EXHAUSTIVE OR CONTINUOUS TO CHECK THE QUALITY OR QUANTITY OF THE
- ALL STRUCTURES REQUIRE PERIODIC MAINTENANCE TO EXTEND LIFESPAN AND TO INSURE STRUCTURAL INTEGRITY FROM EXPOSURE TO THE ENVIRONMENT. A PLANNED PROGRAM OF MAINTENANCE SHALL BE ESTABLISHED BY THE BUILDING OWNER. THIS PROGRAM SHALL INCLUDE SUCH ITEMS SUCH AS BUT NOT LIMITED TO PAINTING OF STRUCTURAL STEEL, PROTECTIVE COATING FOR CONCRETE, SEALANTS, CAULKED JOINTS, EXPANSION JOINTS, CONTROL JOINTS, SPALLS AND CRACKS IN CONCRETE, AND PRESSURE WASHING OF EXPOSED STRUCTURAL ELEMENTS EXPOSED TO A SALT ENVIRONMENT OR OTHER HARSH CHEMICALS.
- ANY MATERIALS OR PRODUCTS SUBMITTED TO ARCHITECT/OWNER FOR APPROVAL THAT ARE DIFFERENT FROM THE MATERIAL OR PRODUCTS SPECIFIED IN THE STRUCTURAL CONTRACT DOCUMENTS WILL BE APPROVED ONLY IF THE FOLLOWING CRITERIA ARE SATISFIED:
  - A COST SAVINGS TO THE OWNER IS DOCUMENTED AND SUBMITTED WITH THE REQUEST 2. THE MATERIAL OR PRODUCT HAS BEEN APPROVED BY THE INTERNATIONAL CONFERENCE OF BUILDING OFFICIALS (ICBO) AND THE ICBO REPORT IS SUBMITTED WITH THE REQUEST.
- SUBMITTALS NOT SATISFYING THE ABOVE CRITERIA WILL NOT BE CONSIDERED. CONTRACTOR TO ISSUE REQUEST FOR INFORMATION (RFI) FOR ANY INFORMATION NOT CLEAR/NOT SHOWN IN THE DRAWINGS.
- M. DO NOT SCALE DRAWINGS
- N. NO STRUCTURAL MEMBER SHALL BE CUT, NOTCHED OR OTHERWISE ALTERED UNLESS APPROVED IN WRITING BY THE ENGINEER OF RECORD. THE CONTRACTOR SHALL BE RESPONSIBLE FOR ANY AND ALL COSTS INCURRED BY ENGINEER OF RECORD FOR THE REVIEW.

#### II. DESIGN CRITERIA A. THE CONTRACT DOCUMENTS ARE BASED ON THE REQUIREMENTS OF THE

- FLORIDA BUILDING CODE 2017.
- B. DEAD LOADS 1. MISCELLANEOUS CEILING AND HANGING MECHANICAL AND ELECTRICAL LOADS: 4 PSF

#### C. LIVE LOADS

LIVE LOADS ARE BASED ON THE MORE RESTRICTIVE OF THE UNIFORM LOAD LISTED BELOW OR THE CONCENTRATED LOAD LISTED ACTING OVER A 6.25 SQUARE FOOT AREA EXCEPT FOR PARKING GARAGES WHICH ACT OVER AN AREA OF 20 SQUARE INCHES. LIVE LOADS HAVE BEEN REDUCED AS PRESCRIBED IN THE AFOREMENTIONED BUILDING CODE.

CATEGORY	UNIFORM LOAD (PSF)	CONCENTRATED LOAD (LBS)
a. ROOFS ALL ROOF SURFACES SUBJECT TO WORKERS ORDINARY ROOF	- 20	300 -
*OR EQUIPMENT WEIGHT IF GREATER		
DESIGN WIND LOADS:		

139 MPH

OPEN

#### **BUILDING TYPE:** INTERNAL PRESSURE COEFFICIENT (GCpi):

ULTIMATE COMPONENTS AND CLADDING WIND LOADS: +18.7 PSF / -63.4 PSF (ULIMATE) +11.2 PSF / -38.0 PSF (NOMINAL)

**ULTIMATE WIND SPEED** 

**RISK CATEGORY** 

EXPOSURE

- FOUNDATION DESIGN IS BASED ON THE GEOTECHNICAL INVESTIGATION REPORT, "GEOTECHNICAL ENGINEERING REPORT, YUCATAN NEIGHBORHOOD PARK - SHADE STRUCTURE, 6400 YUCATAN DRIVE, ORANGE COUNTY, FLORIDA," TERRACON PROJECT NUMBER: H1185002, TERRACON
- B. THE GEOTECHNICAL REPORT IS AVAILABLE TO THE CONTRACTOR UPON REQUEST TO THE OWNER. STRUCTURAL ENGINEER WILL NOT BE RESPONSIBLE FOR THE ACCURACY OR APPLICABILITY OF
- C. ALL FOOTINGS SHALL BEAR ON UNDISTURBED EARTH OR ENGINEERED FILL AT ELEVATIONS SHOWN ON PLANS AND DETAILS. SEE GEOTECHNICAL REPORT FOR MORE INFORMATION. THE MOISTURE RETARDER SHALL BE PLACED BETWEEN THE STONE AND THE SLAB.
- D. SEE SOILS REPORT FOR PREPARATION OF SOILS AT BUILDING PAD. ALL SOILS WORK, INCLUDING BACKFILL OF UTILITY TRENCHES AND THE VERIFICATION OF BEARING CAPACITY OF SAME SHALL BE UNDER THE DIRECTION OF A QUALIFIED SOILS ENGINEER. PROXIMITY OF UTILITY TRENCHES TO BUILDING FOUNDATION SYSTEM SHALL BE AS APPROVED BY THE SOILS ENGINEER TO INSURE INTEGRITY OF THE BEARING SOILS.
- NO FOUNDATION CONCRETE SHALL BE INSTALLED UNTIL ALL FOUNDATION WORK HAS BEEN COORDINATED WITH UNDERGROUND UTILITIES. THE CONTRACTOR SHALL NOTIFY THE ENGINEER
- OF RECORD OF ALL CONFLICTS THAT EXIST BETWEEN FOOTINGS AND UTILITIES. F. ALL FOUNDATIONS OR PORTIONS THEREOF, BELOW GRADE MAY BE EARTH FORMED BY NEAT
- EXCAVATIONS.
- G. UNLESS OTHERWISE SHOWN, ALL FOOTINGS SHALL BE CENTERED ON WALLS AND/OR COLUMNS. H. THE CONTRACTOR SHALL DETERMINE THE EXTENT OF CONSTRUCTION DEWATERING REQUIRED FOR THE EXCAVATION. THE CONTRACTOR SHALL SUBMIT TO THE GEOTECHNICAL ENGINEER FOR REVIEW THE PROPOSED PLAN FOR CONSTRUCTION DEWATERING, PRIOR TO EXCAVATION.
- FOOTINGS SHALL NOT BE PLACED ON FROZEN SUBGRADE OR IN STANDING WATER. BACKFILL BEHIND RETAINING WALLS SHALL BE WITH AN ENGINEERED FILL CONSISTING OF CLEAN
- COARSE SAND. HEAVY EQUIPMENT SHOULD NOT BE ALLOWED WITHIN 8 FEET OF ANY EARTH RETAINING WALL. USE ONLY HAND OPERATED VIBRATORY COMPACTORS FOR COMPACTING BEHIND RETAINING WALLS.
- K. FOUNDATION TYPE 1. SPREAD FOOTING:
  - a. TOTAL LOAD: 1500 PSF NET PRESSURE.

A. CONCRETE SHALL CONFORM TO THE FOLLOWING REQUIREMENTS

CONCRETE 28 DAY COMPRESSIVE STRENGTH AND DENSITY REQUIREMENTS:

USA	GE	(PSI)	TYPE	COMME
a.	ALL CONCRETE NOT OTHERWISE SPECIFIED	3000	NWT	
b. C.	FOUNDATIONS WALLS, FOOTINGS, GRADE BEAMS PLINTHS AND PILASTERS	3000 3000	NWT NWT	
d.	SUPPORTING STEEL COLUMNS SLAB-ON-GRADE	3000	NWT	NOTE

- INDICATED CONCRETE TYPES SHALL BE PROPORTIONED FOR MAXIMUM WATER CEMENT
- NWT = NORMAL WEIGHT CONCRETE
- ALL CONCRETE SHALL HAVE ALLOWABLE UNIT SHRINKAGE OF 0.03% AT 28 DAYS. (SEE ASTM
- EXTERIOR CONCRETE SLABS SHALL HAVE 4% TO 6% ENTRAINED AIR
- B. ALL CONCRETE CONSTRUCTION SHALL CONFORM TO THE CURRENT "ACI MANUAL OF CONCRETE
- C. PORTLAND CEMENT SHALL CONFORM TO ASTM C-150, TYPE I OR II.
- D. ALL AGGREGATE FOR NORMAL WEIGHT CONCRETE SHALL MEET ASTM C 33.
- ALL REINFORCEMENT SHALL CONFORM TO THE FOLLOWING SPECIFICATIONS:
- 1. ALL REINFORCING, UNO: ASTM A615 GRADE 60
- DEFORMED BAR ANCHORS (DBA): ASTM A496 (75 KSI) WELDED WIRE REINFORCEMENT (WWR):
- a. SMOOTH WIRE: ASTM A 185 (65 KSI)
- F. REINFORCEMENT DETAILING: REINFORCEMENT SHALL BE DETAILED AND PLACED IN ACCORDANCE WITH ACI 315.
- 2. PLACEMENT OF WELDED WIRE REINFORCEMENT: WHEREVER WELDED WIRE REINFORCEMENT IS SPECIFIED AS REINFORCEMENT, IT SHALL BE
- CONTINUOUS ACROSS THE ENTIRE CONCRETE SURFACE AND NOT INTERRUPTED BY BEAMS OR GIRDERS.AP WWR ONE CROSSWIRE SPACING PLUS 2". REINFORCING STEEL COVERAGE:
- THE CONCRETE COVER FOR REINFORCEMENT LAYERS NEAREST TO THE SURFACE SHALL BE IN ACCORDANCE WITH ACI 318 UNLESS NOTED OTHERWISE IN THE SPECIFICATIONS OR ON THE DRAWINGS. DEVELOPMENT AND SPLICE LENGTHS ARE IN TENSION UNLESS OTHERWISE INDICATED.
- PROVIDE CORNER BARS AT ALL FOOTINGS AND WALL INTERSECTIONS TO MATCH HORIZONTAL REINFORCING SIZE AND SPACING. AT INTERSECTIONS OF CONTINUOUS SPREAD FOOTINGS EXTEND ALL BARS TO FAR SIDE OF INTERSECTING FOOTING.
- REINFORCEMENT SHALL BE SECURELY PLACED TO PREVENT DISPLACEMENT DURING CONCRETE PLACEMENT. PROVIDE THE FOLLOWING CONCRETE COVER FOR REINFORCING [TABLE 3.3.2.3 OF ACI 301], UNLESS SPECIFICALLY DETAILED OTHERWISE:
- PROVIDE DOWELS TO MATCH REINFORCEMENT SIZE AND SPACING INDICATED FOR ALL STRUCTURAL ELEMENTS, UNLESS OTHERWISE INDICATED.
- CONCRETE WALLS SHALL BE TEMPORARILY BRACED AGAINST EARTH PRESSURE AND OTHER FORCES UNTIL FLOOR SLABS ARE IN PLACE AND HAVE ATTAINED REQUIRED STRENGTHS.
- PROVIDE CONTROL JOINTS IN CONCRETE CANTILEVERED RETAINING WALLS AT EQUAL INTERVALS NOT TO EXCEED 25 FEET. PROVIDE EXPANSION JOINTS AT EVERY FOURTH CONTROL JOINT.
- HORIZONTAL CONSTRUCTION JOINTS IN CONCRETE POURS SHALL NOT BE USED UNLESS SHOWN ON THE DRAWINGS. THE ARCHITECT/ENGINEER SHALL APPROVE ALL DEVIATIONS OR ADDITIONAL JOINTS IN WRITING.
- SLABS AND BEAMS OR JOISTS SHALL BE CAST MONOLITHICALLY UNLESS OTHERWISE INDICATED.
- CHAMFER ALL PERMANENTLY EXPOSED CONCRETE EDGES 3/4-INCH, UNO. NO HOLES OR OPENINGS THROUGH FOUNDATION WALLS AND/OR FOOTINGS WITHOUT ENGINEER'S
- M. ALUMINUM SHALL NOT BE EMBEDDED IN ANY CONCRETE.

#### VI. POST-INSTALLED ANCHORS

- A. POST-INSTALLED ANCHORS SHALL ONLY BE USED WHERE SPECIFIED ON THE DRAWINGS.
- CONTRACTOR SHALL OBTAIN APPROVAL FROM ENGINEER OF RECORD PRIOR TO USING POST-INSTALLED ANCHORS FOR MISSING OR MISPLACED CAST-IN-PLACE ANCHORS.
- CARE SHALL BE GIVEN TO AVOID CONFLICTS WITH EXISTING REBAR. HOLES SHALL BE DRILLED AND CLEANED PER THE MANUFACTURER'S INSTRUCTIONS. ANCHORS SHALL BE INSTALLED PER THE MANUFACTURER'S INSTALLATION INSTRUCTIONS AT NOT LESS THAN MINIMUM EDGE DISTANCES AND/OR SPACINGS INDICATED IN THE MANUFACTURER'S LITERATURE. CONTACT MANUFACTURER PRIOR TO ANCHOR INSTALLATION, IF TRAINING IS REQUIRED.
- UNLESS SPECIFIED OTHERWISE, ANCHORS SHALL BE EMBEDDED IN THE APPROPRIATE SUBSTRATE WITH A MINIMUM EMBEDMENT OF 8 TIMES THE NOMINAL ANCHOR DIAMETER OR THE EMBEDMENT REQUIRED TO SUPPORT THE INTENDED LOAD.
- SUBSTITUTION REQUESTS, FOR PRODUCTS OTHER THAN THOSE LISTED BELOW, SHALL BE SUBMITTED TO THE ENGINEER WITH CALCULATIONS THAT ARE PREPARED & SEALED BY A REGISTERED PROFESSIONAL ENGINEER SHOWING THAT THE SUBSTITUTED PRODUCT WILL ACHIEVE AN EQUIVALENT CAPACITY USING THE APPROPRIATE DESIGN PROCEDURE REQUIRED BY THE BUILDING CODE FOR REVIEW AND APPROVAL.
- ACCEPTABLE PRODUCTS ARE: 1. "CRACKED CONCRETE" MECHANICAL ANCHORS:
- a. "HILTI KB-TZ" BY HILTI. "CRACKED CONCRETE" ADHESIVE ANCHORS:
- a. "HIT RE500-SD" BY HILTI.

#### XVII. SPECIALTY ENGINEERING REQUIREMENTS

THE FLORIDA STATE OF PROFESSIONAL ENGINEERS HAS ISSUED STATEMENTS ON RESPONSIBILITIES OF PROFESSIONAL ENGINEERS, IN ACCORDANCE WITH RULE 21H-19,00(3) CERTAIN COMPONENTS OF THE STRUCTURE REQUIRE THE WORK OF A SPECIALTY ENGINEER FOR THE DESIGN OF THOSE COMPONENTS.

- A. THE GENERAL CONTRACTORS SHALL REVIEW AND STAMP ALL SHOP DRAWINGS BEFORE SUBMITTING FOR REVIEW. SHOP DRAWINGS SHALL BE SUBMITTED TO THE ARCHITECT AND/OR ENGINEER AND HAVE THE ENGINEER'S SHOP DRAWING STAMP AFFIXED PRIOR TO FABRICATION. FABRICATION AND ERECTION SHALL BE FROM REVIEWED SHOP DRAWINGS.
- B. A RECORD SET OF APPROVED SHOP DRAWINGS SHALL BE KEPT IN THE FIELD BY THE GENERAL
- C. ANY DEVIATION FROM, ADDITION TO, SUBSTITUTION FOR, OR MODIFICATION TO THE STRUCTURE OR ANY PART OF THE STRUCTURE DETAILED ON THE CONTRACT DOCUMENTS SHALL BE SUBMITTED IN WRITING TO THE ENGINEER FOR REVIEW. SHOP DRAWINGS SUBMITTED FOR REVIEW DO NOT CONSTITUTE "IN-WRITING" UNLESS IT IS CLEARLY NOTED THAT SPECIFIC CHANGES ARE BEING SUGGESTED.
- D. THE FOLLOWING SHOP DRAWINGS SHALL BE SUBMITTED BY THE CONTRACTOR FOR THE ENGINEER'S REVIEW:
- 1. PREFABRICATED CANOPY STRUCTURE
- MISCELLANEOUS STEEL
- 3. CONCRETE MIX DESIGNS
- EMBEDDED ITEMS (PLATES, ANGLES, BOLTS, ETC.) OR ITEMS ATTACHED TO THE STRUCTURAL FRAME FOR BUILDING CLADDING ATTACHMENT OR FOR ATTACHMENT OF OTHER ITEMS (2)


ITEMS MARKED (1) SHALL HAVE SHOP DRAWINGS SIGNED AND SEALED BY A REGISTERED ENGINEER IN THE STATE WHERE THE PROJECT IS LOCATED. ITEMS MARKED (2) SHALL BE SUBMITTED TO ENGINEER FOR OWNER'S RECORD ONLY AND WILL NOT HAVE THE ENGINEER'S SHOP DRAWING STAMP AFFIXED. ITEMS MARKED (3) SHALL HAVE DESIGN CALCULATIONS SIGNED AND SEALED BY A REGISTERED ENGINEER IN THE STATE OF FLORIDA.

- E. THE OMISSION FROM THE SHOP DRAWINGS OF ANY MATERIALS REQUIRED BY THE CONTRACT DOCUMENTS TO BE FURNISHED SHALL NOT RELIEVE THE CONTRACTOR OF THE RESPONSIBILITY OF FURNISHING AND INSTALLING SUCH MATERIALS, REGARDLESS OF WHETHER THE SHOP DRAWINGS HAVE BEEN REVIEWED AND APPROVED.
- F. THE USE OF ELECTRONIC FILES OR REPRODUCTIONS OF THESE CONTRACT DOCUMENTS BY ANY CONTRACTOR, SUBCONTRACTOR, ERECTOR, FABRICATOR, OR MATERIAL SUPPLIER IN LIEU OF PREPARATION OF SHOP DRAWINGS SIGNIFIES THEIR ACCEPTANCE OF ALL INFORMATION SHOWN HEREON AS CORRECT, AND OBLIGATES THEMSELVES TO ANY JOB EXPENSE, REAL OR IMPLIED, ARISING DUE TO ANY ERRORS THAT MAY OCCUR HEREON.
- G. REQUEST FOR INFORMATION SHALL BE ORIGINATE WITH CONTRACTOR AND SHALL BE SUBMITTED TO THE ENGINEER VIA ARCHITECT OR DIRECTLY TO ENGINEER WHEN APPROVED BY ARCHITECT. RFI SHALL BE SUBMITTED IN A PROMPT MANNER TO AVOID DELAYS IN THE CONTRACTORS WORK.
- RFI RESPONSES ARE NOT INTENDED TO AUTHORIZE ANY INCREASE IN CONSTRUCTION COST, SCHEDULE OR CONFLICT WITH APPLICABLE STANDARDS OR CODES. IT IS TECH RESPONSIBILITY OF THE CONTRACTOR TO NOTIFY DESIGN TEAM IMMEDIATELY MANY PERCEIVED COST, SCHEDULE OR SCOPE IMPACTS.



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PLANNING	4	12/28/2018	ISSUED FOR PERMIT	MR	LBE
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01 02/21/2019 ISSUED FOR PERMIT

**Client Information** Orange County

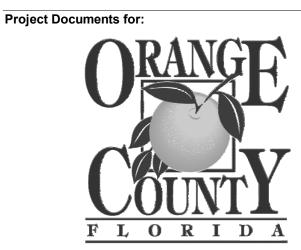☐ Capital Projects Division

🖰 400 Ė. SOUTH STREET

ORLANDO, FL 32801 **Project Number** Issue Date 17034 02/21/2019 Drawn By Project Status ISSUED FOR PERMIT MR Checked By Scale

File Name

Consultant • Seal/Signature



P.E. No. 74027

Sheet Title:

STRUCTURAL GENERAL NOTES


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**ISSUED FOR PERMIT** 02/21/2019

Engineering + Construction ICGC 1521662 CERTIFICATE OF AUTHORIZATION No. 27343

1214 E. CONCORD ST.


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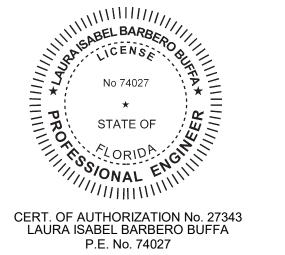
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As indicated

Issue Date

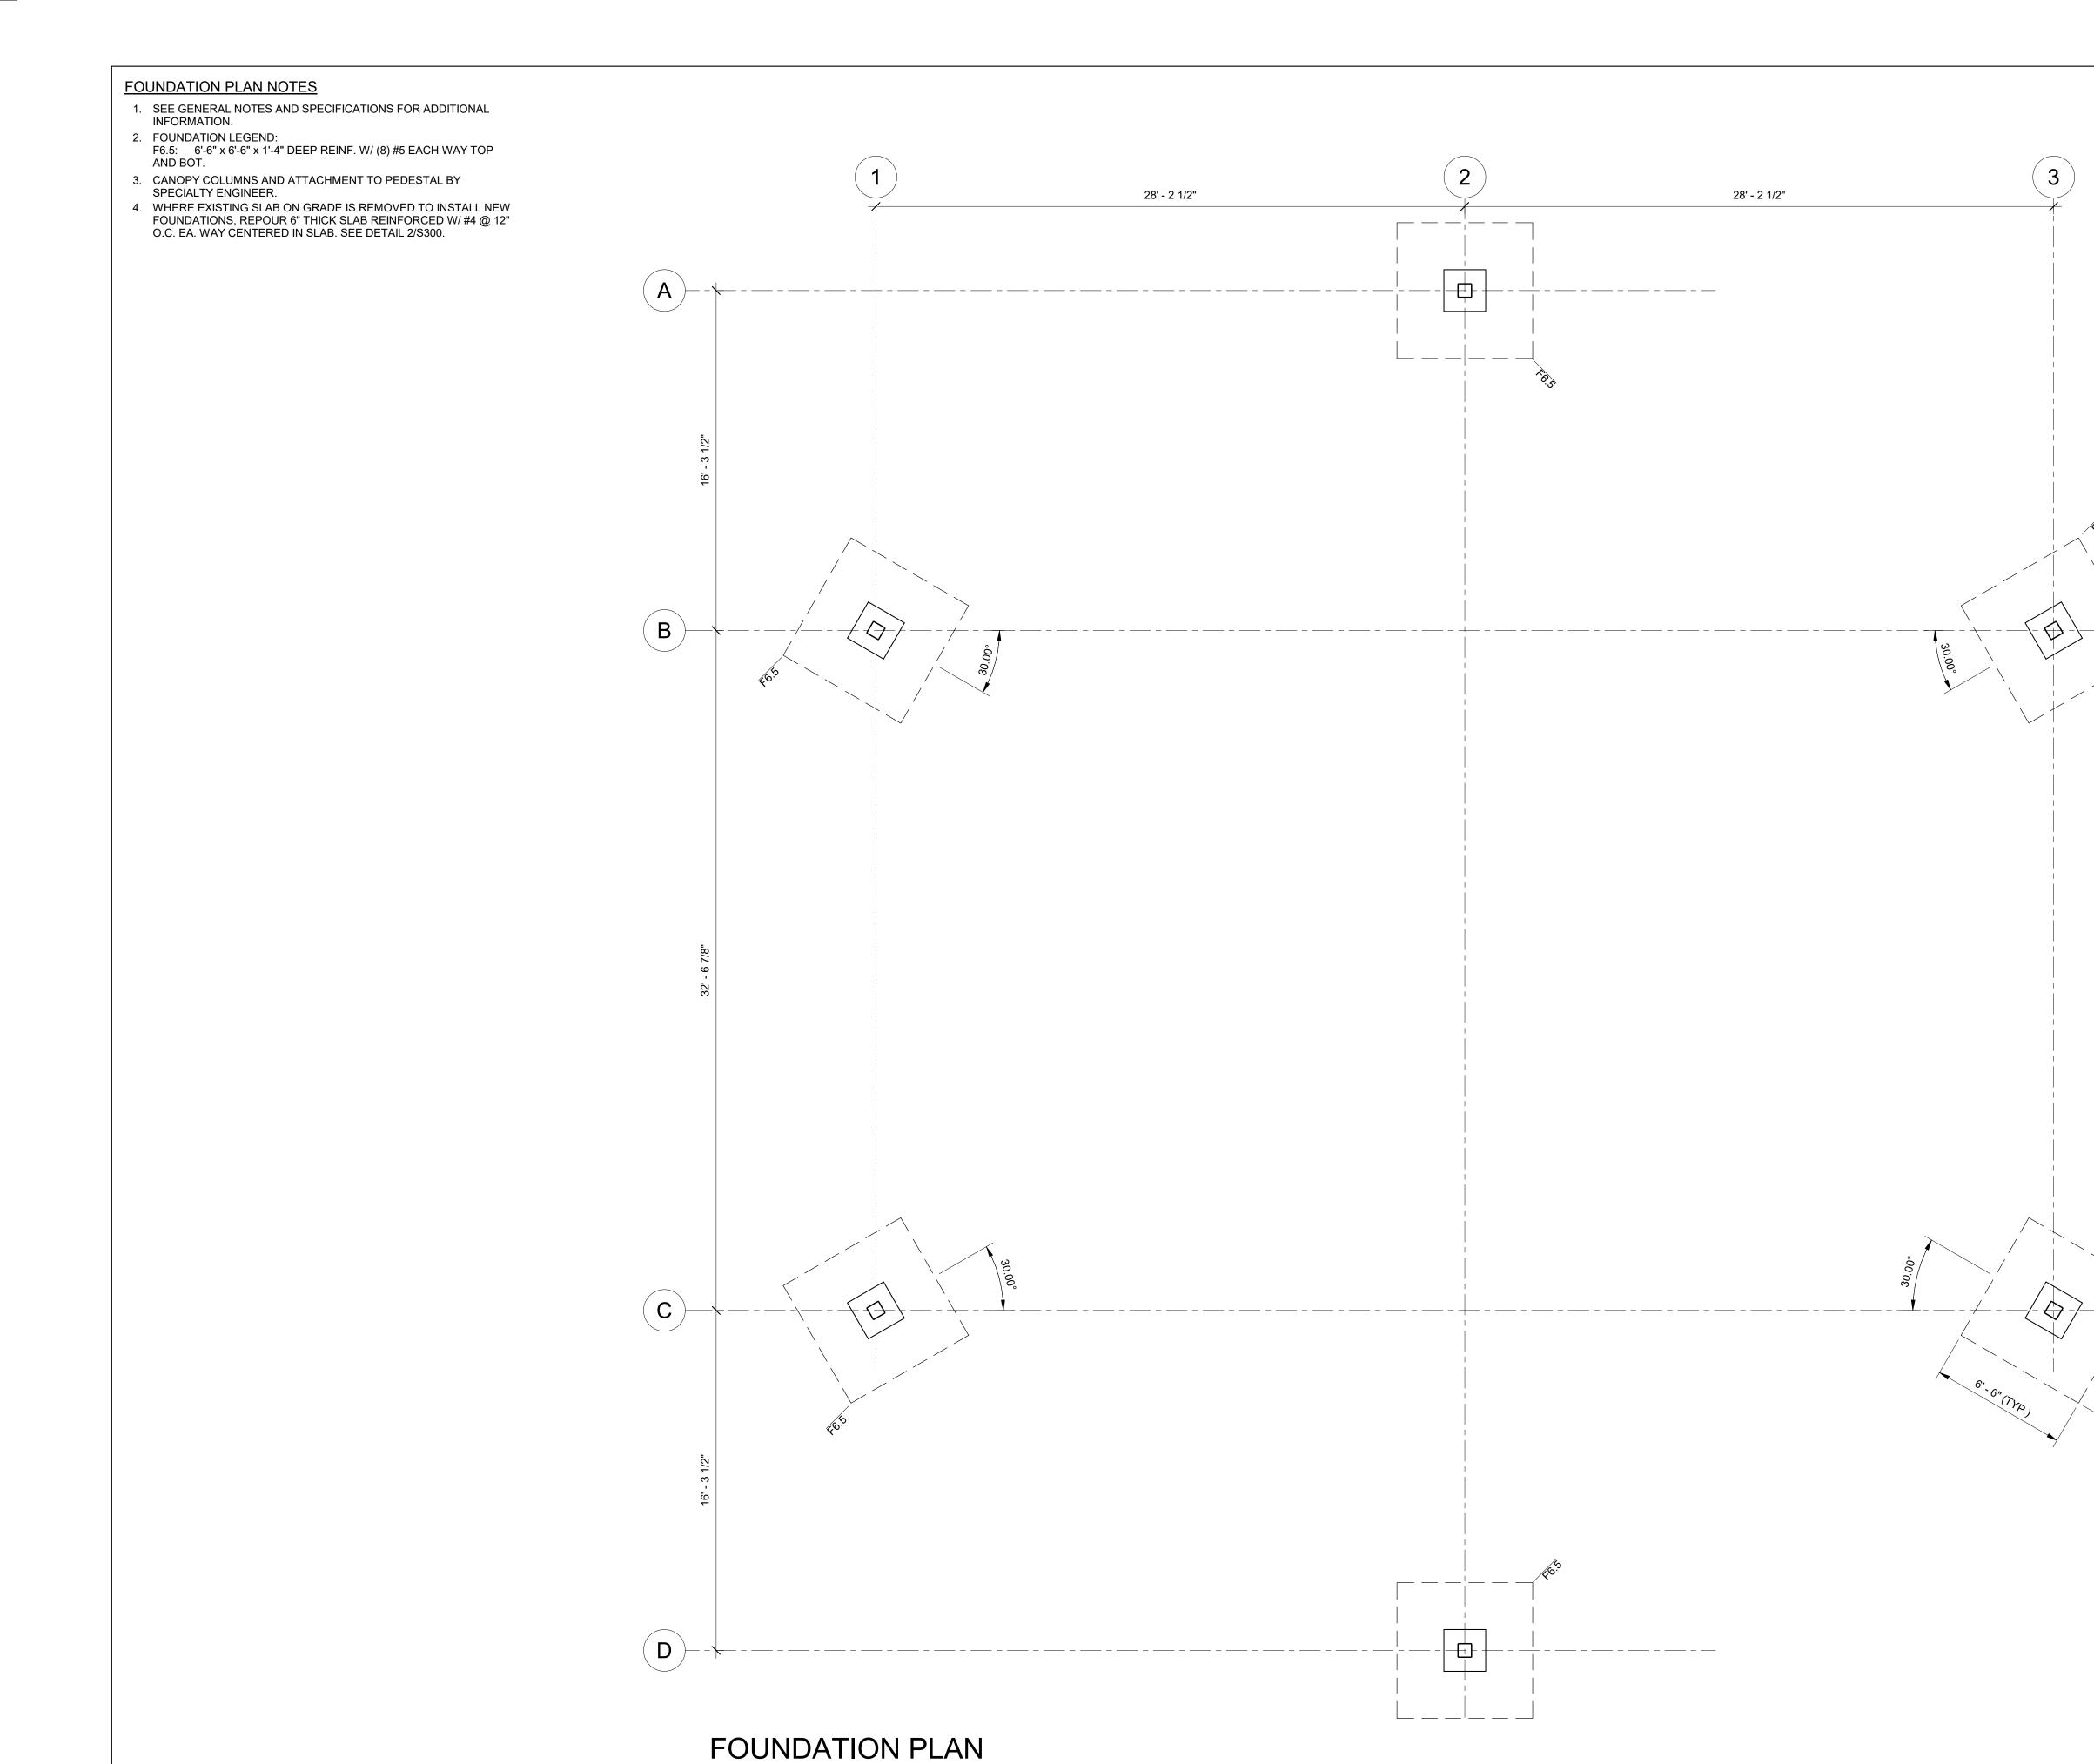File Name

Consultant • Seal/Signature

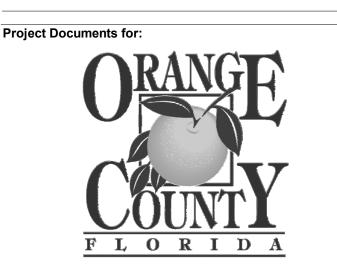

リ Sheet Title:

FOUNDATION PLAN

**S100** 


Engineering + Construction | CGC 1521662

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> ORLANDO, FLORIDA 32803 P: 407.377.7227

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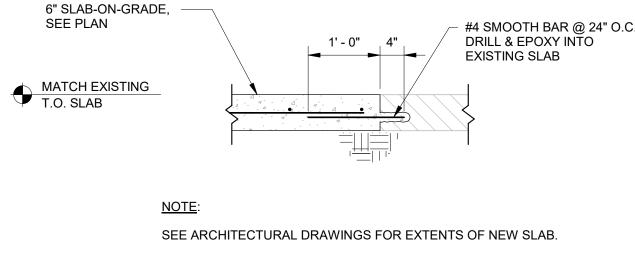
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S300

### CONCRETE PILASTER DETAILS

SCALE: N.T.S.

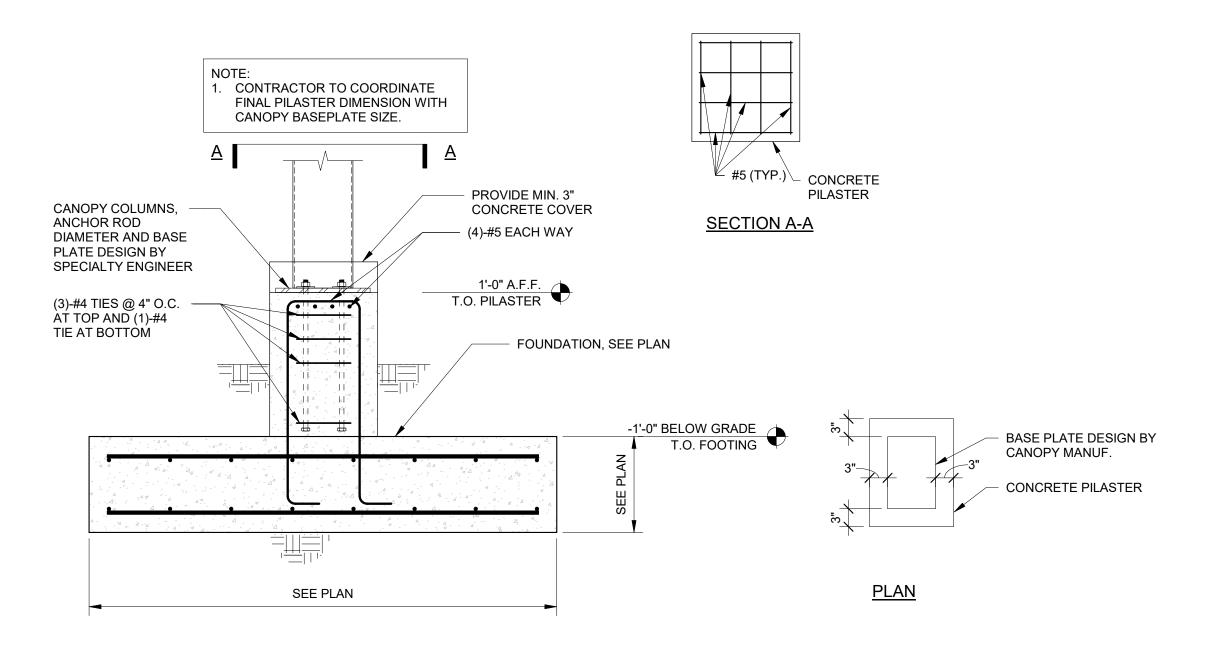


## NEW SLAB CONNECTION TO **EXISTING SLAB-ON-GRADE**

S300 SCALE: N.T.S.





AA-COO1315 | AR-0010536 RAYMUNDO FEITO, R.A. STATE OF FLORIDA

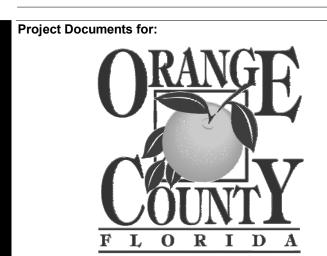

YUCATAN PLAYGROUND COVER INVEST

6400 Yucatan Dr. Orlando, FL 32807

05/30/2018 60% SD REVIEW SET 07/17/2018 90% CD REVIEW SET 11/09/2018 90% CD REVIEW SET 12/28/2018 ISSUED FOR PERMIT

01 02/21/2019 ISSUED FOR PERMIT

Client Information


Orange County
Capital Projects Division
400 E. SOUTH STREET
ORLANDO, FL 32801 Project Number

17034 Drawn By MR 02/21/2019 Project Status ISSUED FOR PERMIT Checked By 3/4" = 1'-0"

Issue Date

File Name

 $\textbf{Consultant} \bullet \textbf{Seal/Signature}$ 

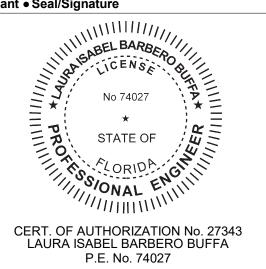

Sheet Title:

SECTIONS & DETAILS

**S300** 

