ORANGE COUNTY MAYOR HONORABLE TERESA JACOBS

COMMISSIONER DISTRICT 1 BETSY VANDERLEY

COMMISSIONER DISTRICT 2 **BRYAN NELSON**

BASE CONSULTANTS



TRUCTURAL ENGINEERS 214 CONCORD STREET ORLANDO, FL 32803 CONTACT: LAURA BARBERO-BUFFA

ORANGE COUNTY CAPITAL PROJECT DIVISION **INTERNAL OPERATIONS CENTER II** 400 E. SOUTH STREET, 5TH FLOOR ORLANDO, FL 32801



PROJECT BITHLO VEHICLE MAINTENANCE BUILDING **18715 OLD CHENEY HIGHWAY** ORLANDO, FL 32820

ORANGE COUNTY PROJECT MANAGER: SCOTT REEKIE

ARCHITECTURAL DESIGN COLLABORATIVE



ARCHITECT 945 N. PENNSYLVANIA AVENUE WINTER PARK, FLORIDA 32789 P: (407) 629-1188 CONTACT: ALBERT J. COOPER EMAIL: acooper@adcinternational.net



- SITE



COMMISSIONER DISTRICT 3 PETE CLARKE COMMISSIONER DISTRICT 4 JENNIFER THOMPSON COMMISSIONER DISTRICT 5 EMILY BONILLA

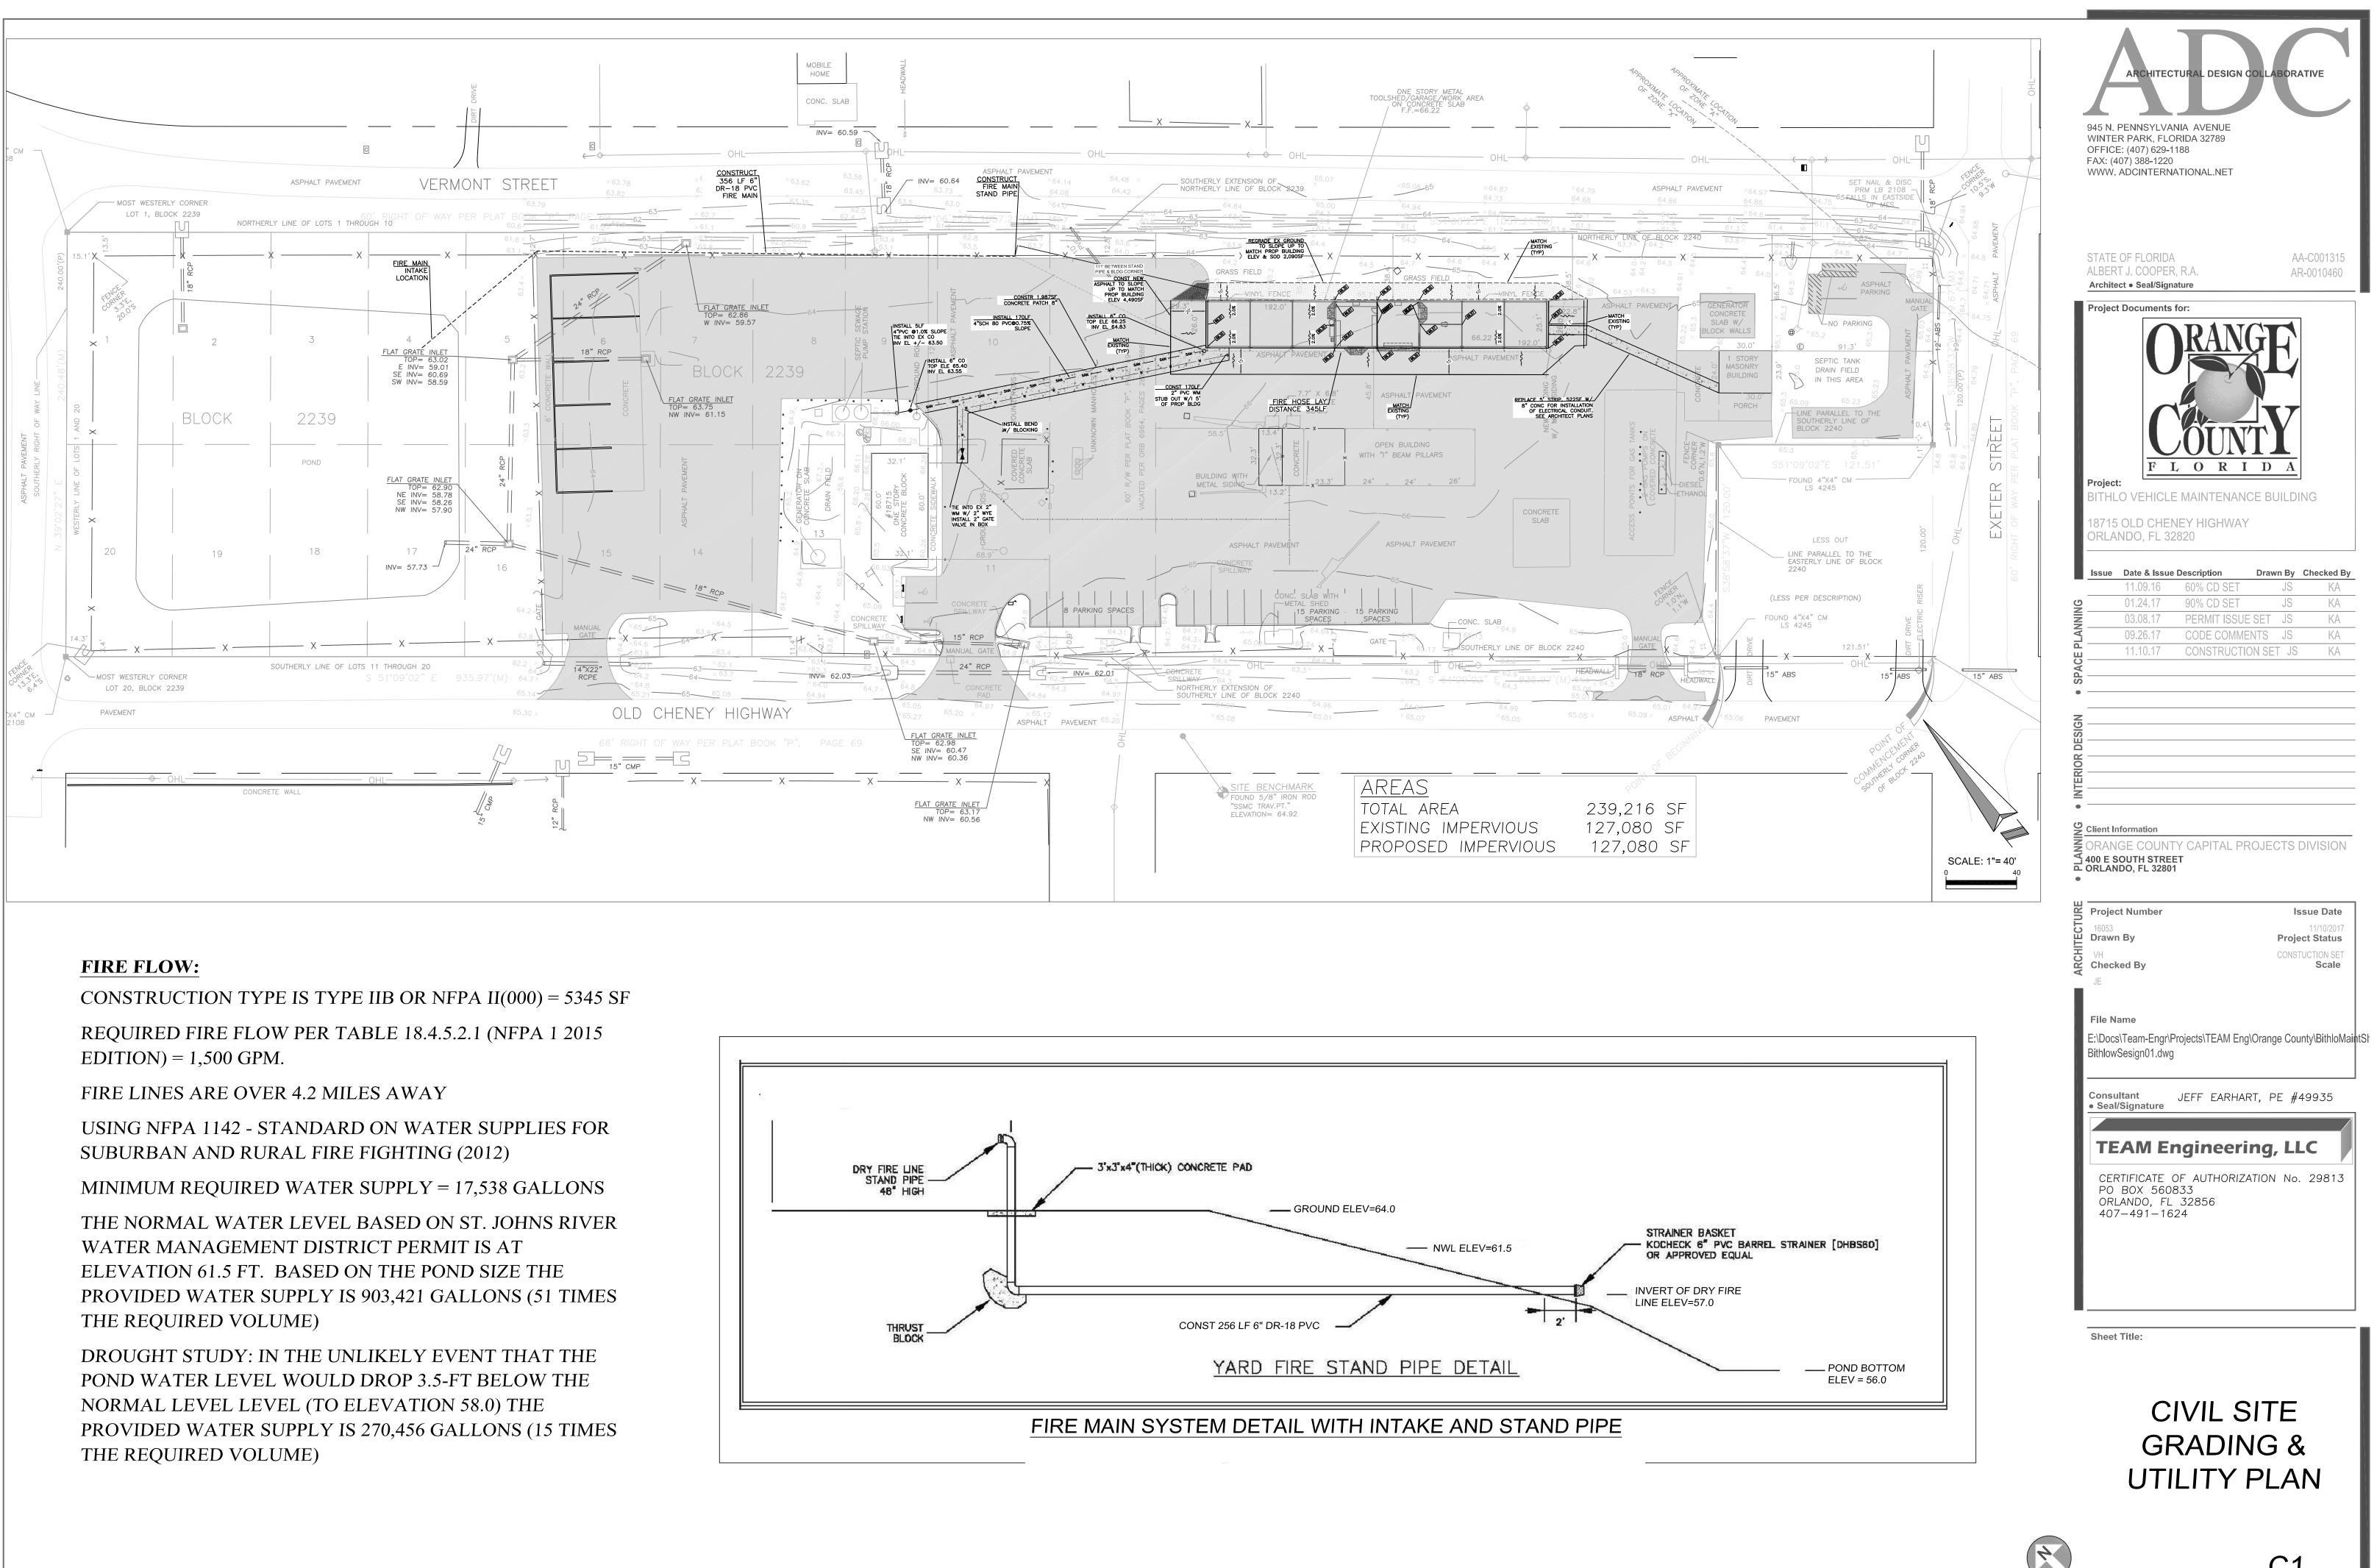
COMMISSIONER DISTRICT 6 VICTORIA P. SIPLIN

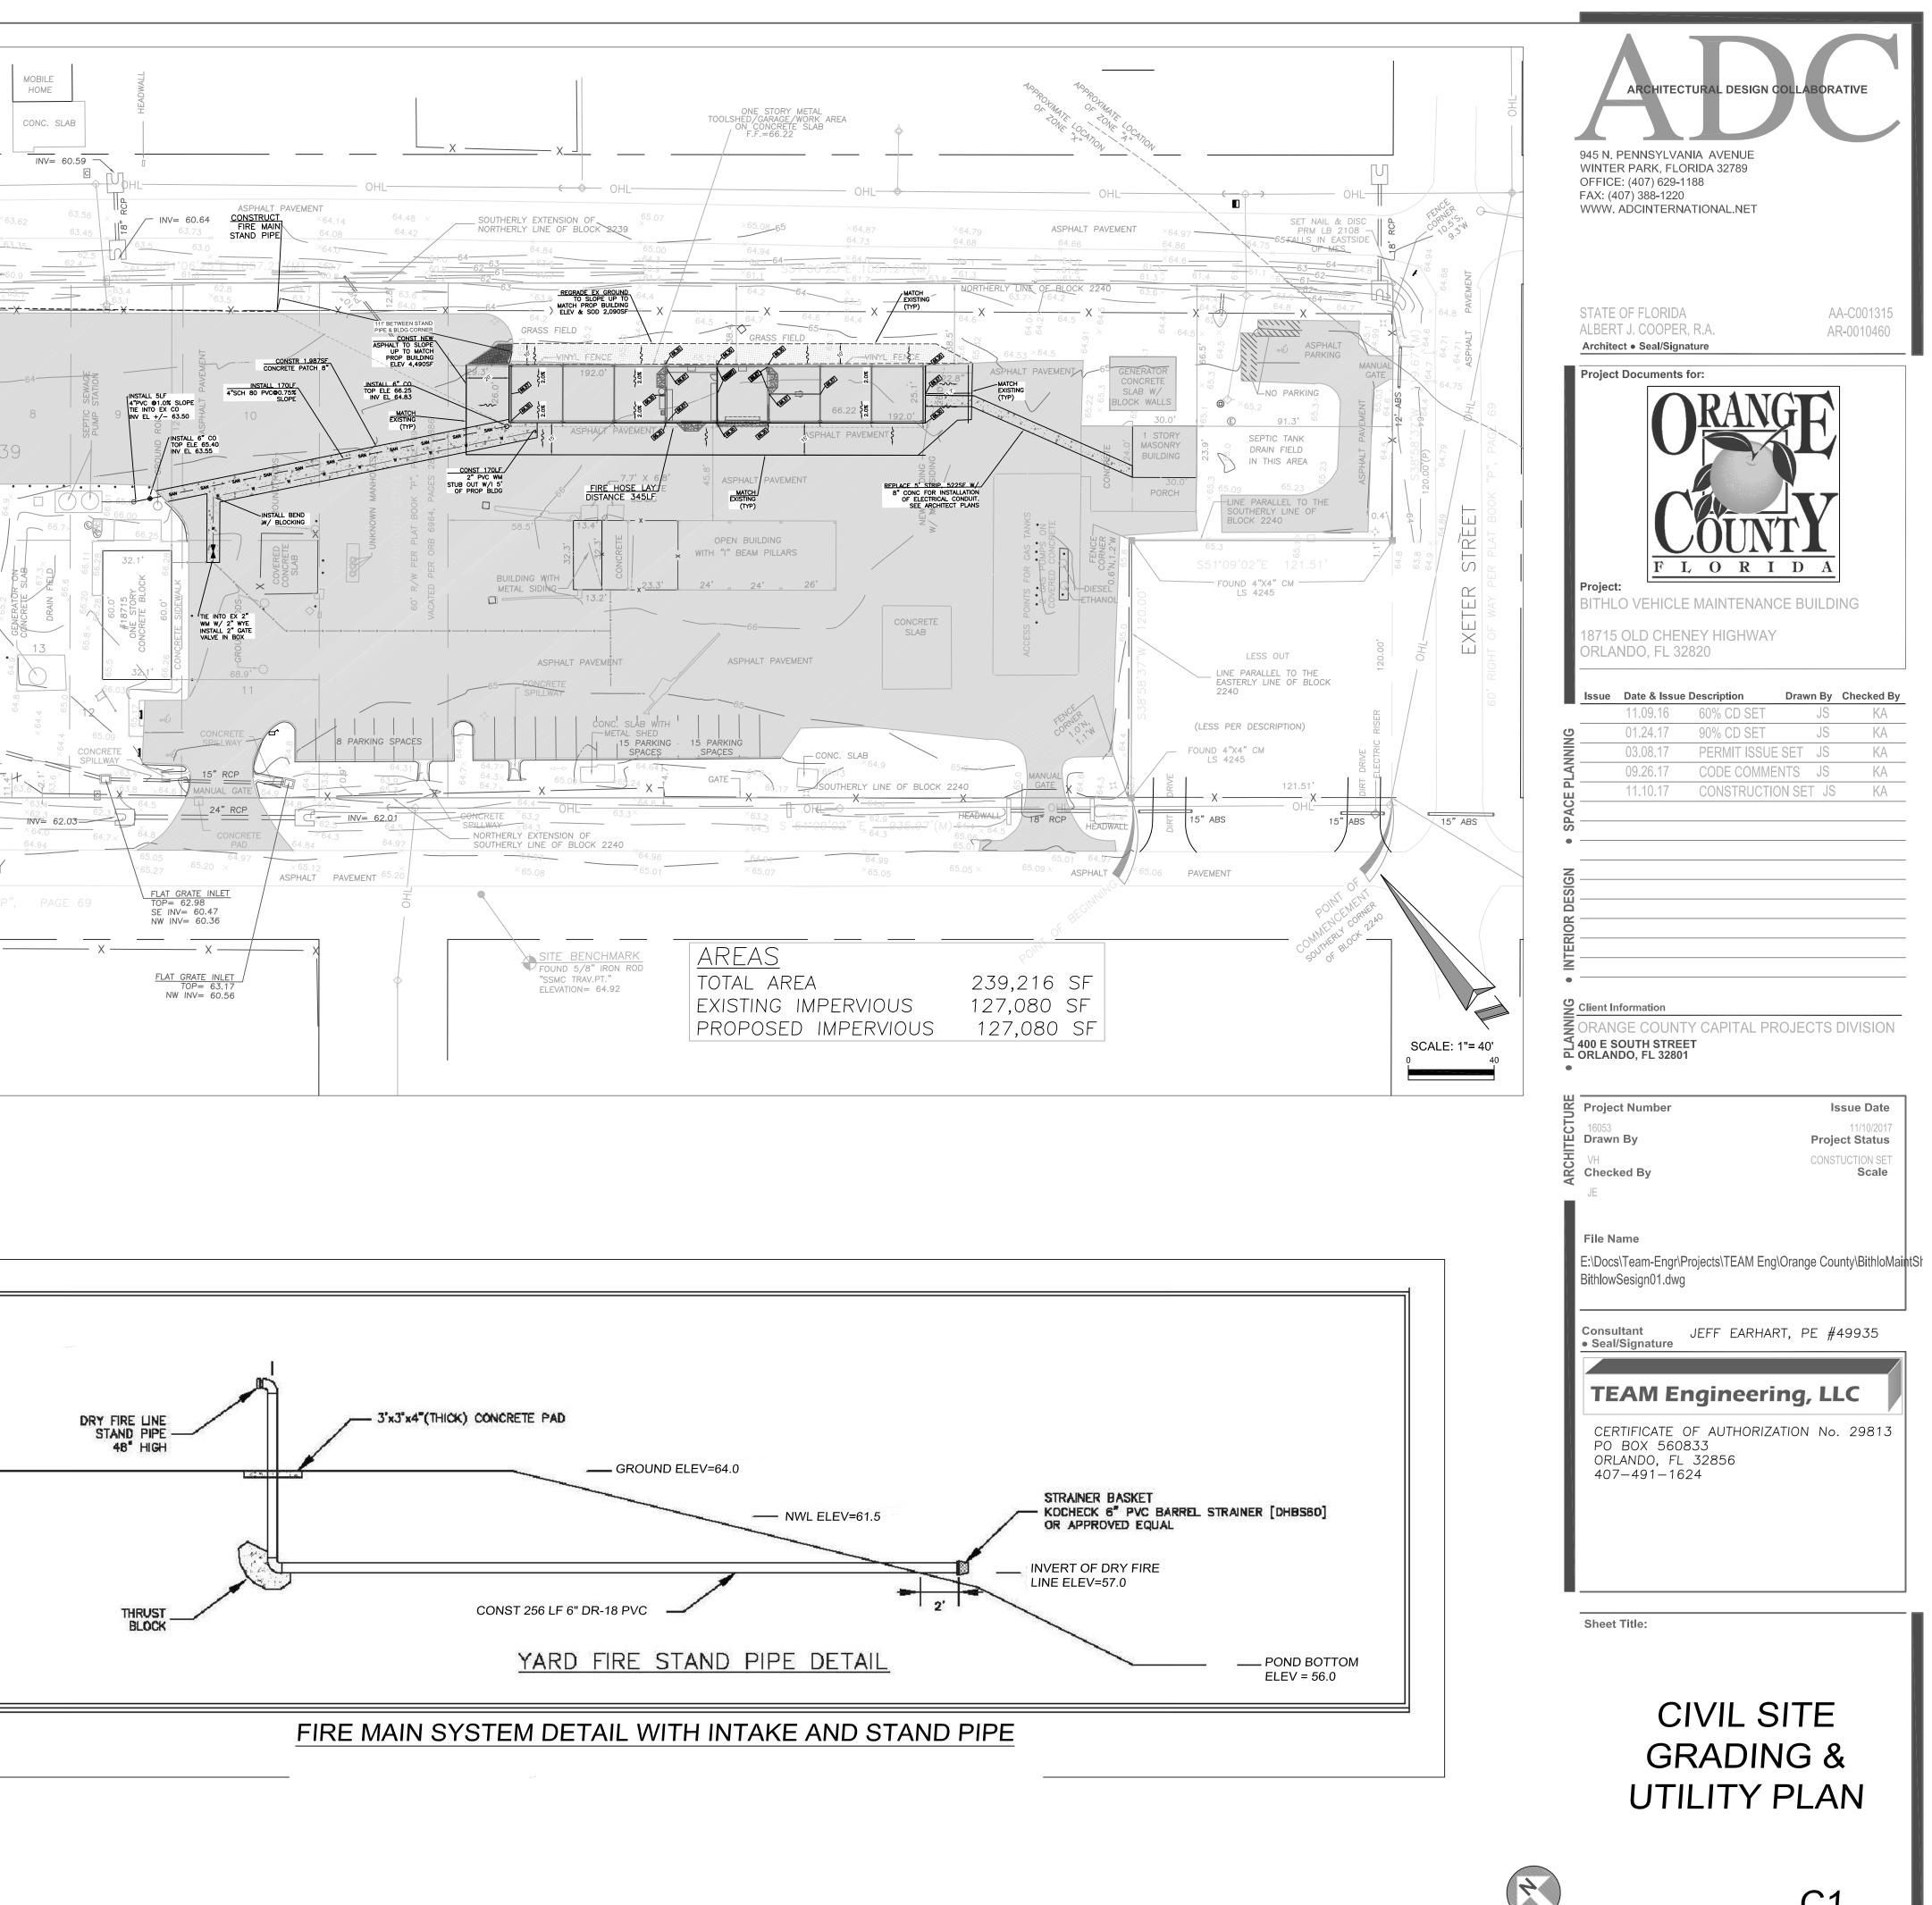
SGM ENGINEERING



MEP ENGINEER 935 LAKE BALDWIN LANE ORLANDO, FL 32814 (407)767-5188 CONTACT: JOHN J BONOTTO EMAIL: jjb@sgmengineering.com

> **CONSTRUCTION SET** 11.10.17





C1

ARCHITECTURAL ABBREVIATIONS

OWNERSHIP OF INSTRUMENTS OF SERVICE

ALL REPORTS, PLANS, SPECIFICATIONS, FIELD DATA AND NOTES AND OTHER DOCUMENTS, INCLUDING ALL DOCUMENTS ON ELECTRONIC MEDIA, PREPARED BY THE DESIGN PROFESSIONAL AS INSTRUMENTS OF SERVICE SHALL REMAIN THE PROPERTY OF THE DESIGN PROFESSIONAL

ACCES ACOUS AFF	ACCESSORY ACOUSTIC(AL) ABOVE FINISHED FLOOR	GA GFRC
AHJ AL	AUTHORITY HAVING JURISDICTION	GFRG
ALT ANNUNC	ALTERNATE ANNUNCIATOR	GFRP
ANOD APPL	ANODIZED	GL GR
ARCH AUTO	ARCHITECT(URAL) AUTOMATIC	GYP
AVG &	AVERAGE AND	Н
В		HD HDWD
BLDG	BUILDING	HDWE HM
BOLLD BD	BOLLARD BOARD	HORIZ HVAC
BLKG BRDLM	BLOCKING BROADLOOM	1
BU	BUILT UP	- INFO
		INSTRUM INSUL
CAB CPT	CABINET CARPET	INTLK INT
CEM CER	CEMENT(ITIOUS) CERAMIC	INFILTR
CLG COATG	CEILING COATING	J
COILG	COILING CONCRETE	JAN
CONSTR CONT	CONSTRUCTION CONTINUOUS(ATION)	Κ
CONTR COV	CONTRACT(OR) COVER	KIT
CMU	CONCRETE MASONRY UNIT	L
		– LAV
DBL DEPT	DOUBLE DEPARTMENT	LB £
DES DET	DESIGN(ED) DETAIL	LT LVLG
DF DIA	DRINKING FOUNTAIN DIAMETER	LVR
DIFF DIM	DIFFUSER DIMENSION	M
DISP DIV	DISPENSER DIVISION	MAX MFD
DN \$	DOWN DOLLAR (US CURRENCY)	MFR MECH
DR DSCON	DOOR DISCONNECT	MET MEMB
DWR	DRAWER	MEZZ MIN
<u>E</u>		MISC MLWK
ELAST ELEC	ELASTOMERIC	MOIST MOT
embed Engr	EMBEDD(ED)(ING) ENGINEER(ED)	MTD
ENTR EQ	ENTRANCE EQUAL	N
EQUIP EXIST	EQUIPMENT EXISTING	NIC NO
EXP JT EXPS	EXPANSION JOINT EXPOSE(D)	NTS
EXT	EXTERIOR	0
F		ORNA OVFL
FAB FD	FABRICATION FLOOR DRAIN	OVHD OPNG
FE FE&C	FIRE EXTINGUISHER FIRE EXTINGUISHER AND	opr P
FHC	CABINET FIRE HOSE CABINET	PTN
FIN FLDG	FINISH FOLDING	PEDTR PBD
FPLC FR	FIREPLACE FIRE RAT(ING)(ED)	PjM PNL
FRMG FXD	FRAMING FIXED	POLYST
FXTR FLR	FIXTURE FLOOR(ING)	PREFIN
FURN FUT	FURNITURE FUTURE	PLAM PLAS
FWC FUT	FABRIC WALL COVERING FUTURE	PLSTC
		PRTECN

5	GAUGE GLASS FIBER REINFORCED CONCRETE GLASS FIBER REINFORCED GYPSUM GLASS FIBER REINFORCED PLASTER GLASS GRAD(E)(ING) GYPSUM	
Ε	HEAD HARDWOOD HARDWARE HOLLOW METAL HORIZONTAL HEATING, VENTILATING, AND AIR CONDITIONING	
RUM L K TR	INFORMATION INSTRUMENT(ATION) INSULATION INTERLOCK(ING) INTERIOR INFILTRATION	
	JANITOR	
	KITCHEN	
;	LAVATORY POUND BRITISH POUND (CURRENCY) LIGHT LEVELING LOUVER	
H B Z K	MAXIMUM MANUFACTURED MANUFACTURER MECHANICAL METAL MEMBRANE MEZZANINE MINIMUM MISCELLANEOUS MILLWORK MOISTURE MOTOR(IZED) MOUNTED	
	NOT IN CONTRACT NUMBER NOT TO SCALE	
A - - - - - - - - - - - - - - - - - - -	ORNAMENTAL OVERFLOW OVERHEAD OPENING(S) OPERABLE	
rr T T T A B C VD E C N	PARTITION PEDESTRIAN PARTICLE BOARD PROJECT MANAGER PANEL POLYSTYRENE PORTABLE PREFINISHED PREFABRICATED PLASTIC LAMINATE PLASTER PLASTIC PLYWOOD PROTECTION	

R	
RDR RECES RECPT REF REFL REFR REQD RESIS REINF RESIL RFG RM RO	READER RECESSED RECEPTACLE REFER(ENCE) REFLECTED REFRIGERATOR REQUIRED RESIST(ANT)(IVE) REINFORCE(D)(ING)(MENT) RESILIENT ROOFING ROOM
S	
SCR SECUR SF SGL SHORG SIM SST STD STL STRFR STRUCT SURF SUSP SYS	SCRIBE SECURITY SQUARE FEET SINGLE SHORING SIMILAR STAINLESS STEEL STANDARD STEEL STOREFRONT STRUCTURAL SURFACE SUSPENDED SYSTEM(S)
Т	
THK TLT TRAF TRANS TRTD T&G TYP	THICK TOILET TRAFFIC TRANSPARENT TREATED TONGUE AND GROOVE TYPICAL
U	
UNDRLAY UTIL UNO	UNDERLAYMENT UTILITY UNLESS NOTED OTHERWISE
V	
VEH VERT VIF	VEHICLE VERTICAL VERIFY IN FIELD
W	
W/ WC WD WDW W/O	WITH WATER CLOSET WOOD WINDOW WITHOUT

WEIGHT

WTRPRF WATERPROOFING

WT

VICINITY MAP **PROJECT INFORMATION** APPLICABLE CODES FLORIDA BUILDING CODE - 2014 _____ FLORIDA BUILDING CODE ACCESSIBILITY (5th EDITION 2014) BITHLO FLORIDA FIRE PREVENTION CODE - (5th EDITION) VEHICLE NFPA 101 - LIFE SAFETY CODE 2012 WITH FLORIDA AMENDMENTS Orange County Public Works MAINTENANC NFPA 1- UNIFORM FIRE CODE 2012 WITH FLORIDA AMENDMENTS BUILDING NFPA 70 - NATIONAL ELECTRICAL CODE -2011 18758 Old FLORIDA MECHANICAL CODE - N/A

OCCUPANCY

GROUP CLASSIFICATION: OCCUPANT/SQ. FT.: SCOPE OF WORK SQ. FT .: OCCUPANT DESIGN LOAD:

MODERATE HAZARD STORAGE S 300 4,938 SQ. FT. 4,938 SQFT/300 = 16.46 OR 16 OCC

CONSTRUCTION

TYPE: SPRINKLED or NONSPRINKLED: **BUILDING HEIGHT:**

CLASSIFICATION OF WORK

NEW ENCLOSED PRE-MANUFACTURED METAL TOOL & GARAGE BUILDING WITH (6) COVERED, UN-ENCLOSED NEW METAL PRE-ENGINEERED METAL BAYS CONSTRUCTED FOR PARKING AND MAINTENANCE OF COUNTY VEHICLES.

IIΒ

17'-5"

NONSPRINKLED

PLUMBING REQUIREMENTS: N/A

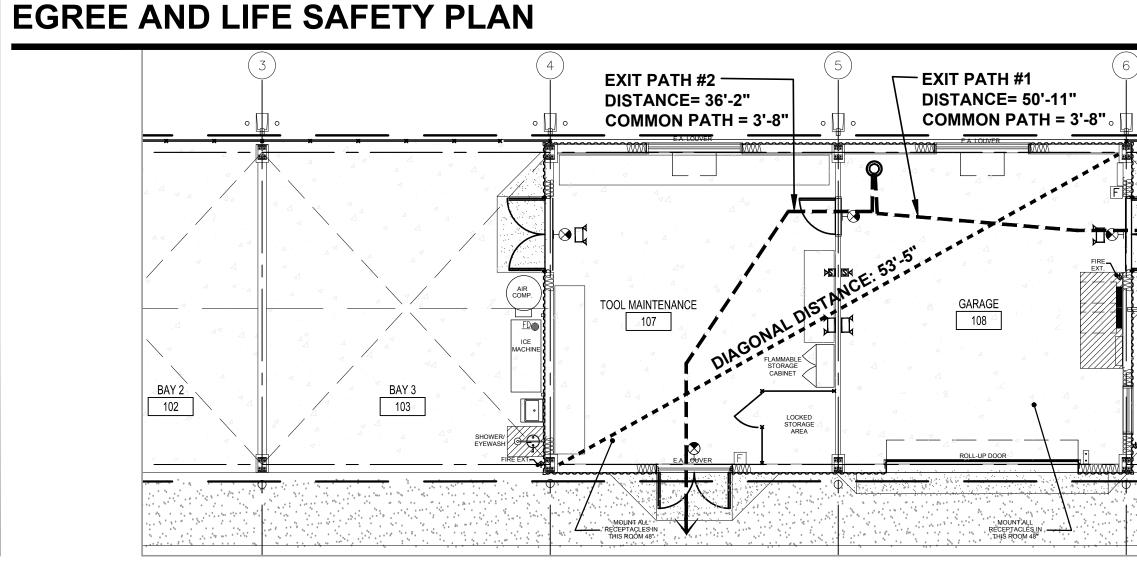
PROJECT NARRATIVE

PROJECT NARRATIVE/SCOPE OF WORK THIS PROJECT IS TO DEMOLISH THE EXISTING METAL BUILDING TOOL SHED ALONG WITH THE 5-BAY STRUCTURE ON THE NORTHSIDE OF THE OLD CHENEY HIGHWAY PROPERTY. REPLACE WITH A NEW VEHICLE MAINTENANCE BUILDING MODELED FROM THE COUNTY'S THREE POINTS MAINTENANCE FACILITY. THE NEW BUILDING WILL BE A PRE-ENGINEERED METAL BUILDING COMPOSED OF (6) 24'-0" WIDE BAYS WITH A PRE-MANUFACTURED METAL TOOL/MAINTENANCE ROOM CALLED A "HURP" AND ENCLOSED GARAGE WITH ROLL-UP DOOR. THE PURPOSE OF THIS NEW BUILDING IS FOR VEHICLE STORAGE AND MINOR MAINTENANCE, ANY MAJOR AUTO REPAIRS WILL BE TAKEN OFF-SITE AND HANDLED BY FLEET MANAGEMENT. THE EXISTING BUILDING WAS IN DISREPAIR AND IN POOR CONDITION. THE NEW BUILDING WILL BE CONSTRUCTED WEST OF THE FORMER BUILDING SITE TO ACCOMMODATE THE LONGER FOOTPRINT. AN ADDITIONAL BUILDING WILL BE DEMOLISHED NEAR THE FUEL PUMPS AND ALL POWER, DATA, AND UTILITIES WILL BE RELOCATED FROM THAT BUILDING TO THE NEW PRE-MANUFACTURED METAL BUILDING. MINOR PLUMBING IS REQUIRED FOR A NEW UTILITY SINK AND ICE MAKER. ADDITIONAL EQUIPMENT WILL BE INSTALLED SUCH AS AN AIR COMPRESSOR AND 2-TON CRANE. LASTLY, THE EXISTING WET POND WILL RECEIVE A FIRE DEPARTMENT CONNECTION (DRY HYDRANT) TO PROVIDE FIRE FLOW WATER IN CASE OF EMERGENCY.

SCOPE OF WORK NOTES:

1. WORK THAT IS NOT STATED HEREIN NOR SHOWN IN THESE PLANS IS NOT PART OF THE SCOPE OF WORK FOR THIS PROJECT.

2. ADDITIONAL WORK REQUIRED THAT WOULD ALTER THE PRESENTED SCOPE OF WORK SHALL BE SUBJECT TO A REVISION OF THESE DOCUMENTS AND MAY BE REQUIRED TO BE REVIEWED BY THE BUILDING DEPARTMENT HAVING JURISDICTION.



EXIT ROUTE **COMMON PATH** EXIT PATH #1 EXIT PATH #2 DIAGONAL DISTANCE

DESIGN WIND LOADS:

RISK CATEGORY

BUILDING TYPE:

EXPOSURE

ULTIMATE WIND SPEED

TRAVEL DISTANCE 3'-8" 50'-11" 36'-2" 53'-5"

146 MPH

PARTIALLY ENCLOSED

111

С



INTERNAL PRESSURE COEFFICIENT (GCpl) +/- 0.18

EGREE TRAVEL SUMMARY

DRAWING INDEX

COVER SHEET

COVER

CIVIL

C1

CIVIL SITE GRADING & UTILITY

ARCHITECTURAL

1	COVER	COVER SHEET
	A00.00	INDEX, CODES & PROJECT INFORMATION
	A00.01	GRAPHIC SYMBOLS
).	A00.30	DOOR SCHEDULE
	A00.31	DOOR DETAILS
	A00.40	GENERAL DETAILS
	A00.50A	ARCHITECTURAL SITE PLAN-EXISTING
	A00.50B	ARCHITECTURAL SITE PLAN-PROPOSED
	A01.01	DEMOLITION PLAN
	A02.01A	CONSTRUCTION PLAN
	A02.01B	CONSTRUCTION PLAN
	A03.01A	EXTERIOR ELEVATIONS
	A03.01B	EXTERIOR ELEVATIONS
	A04.01A	REFLECTED CEILING PLAN
	A04.01B	
	A05.01	
	A06.01	FINISH PLAN
	A12.01	WALL TYPES & DETAILS
	PLUMB	NG
	D 001	

P-001	ELECTRICAL SYMBOLS, LEGEND & GENERAL NOTES
P-201	PLUMBING FLOOR PLAN
P-601	PLUMBING DETAILS
P-701	PLUMBING RISERS

MECHANICAL


M-001	ELECTRICAL SYMBOLS, LEGEND & GENERAL NOTES
M-201	MECHANICAL PLAN
M-501	MECHANICAL SCHEDULES AND DETAILS

E-001	ELECTRICAL SYMBOLS, LEGEND
ED-101	ELECTRICAL DEMOLITION SITE PLAN
E-101	ELECTRICAL RENOVATION SITE PLAN
E-201	POWER AND SYSTEMS FLOOR PLAN
E-202	LIGHTING FLOOR PLAN
E-501	ELECTRICAL DIAGRAMS
E-601	ELECTRICAL DETAILS
E-701	ELECTRICAL SCHEDULES

STRUCTURAL

S001	ABBREVIATIONS, SYMBOLS, AND SHEET INDEX
S002	STRUCTURAL GENERAL NOTES
S201A	FOUNDATION PLAN
S201B	FOUNDATION PLAN
S300	SECTIONS AND DETAILS
S301	SECTIONS AND DETAILS

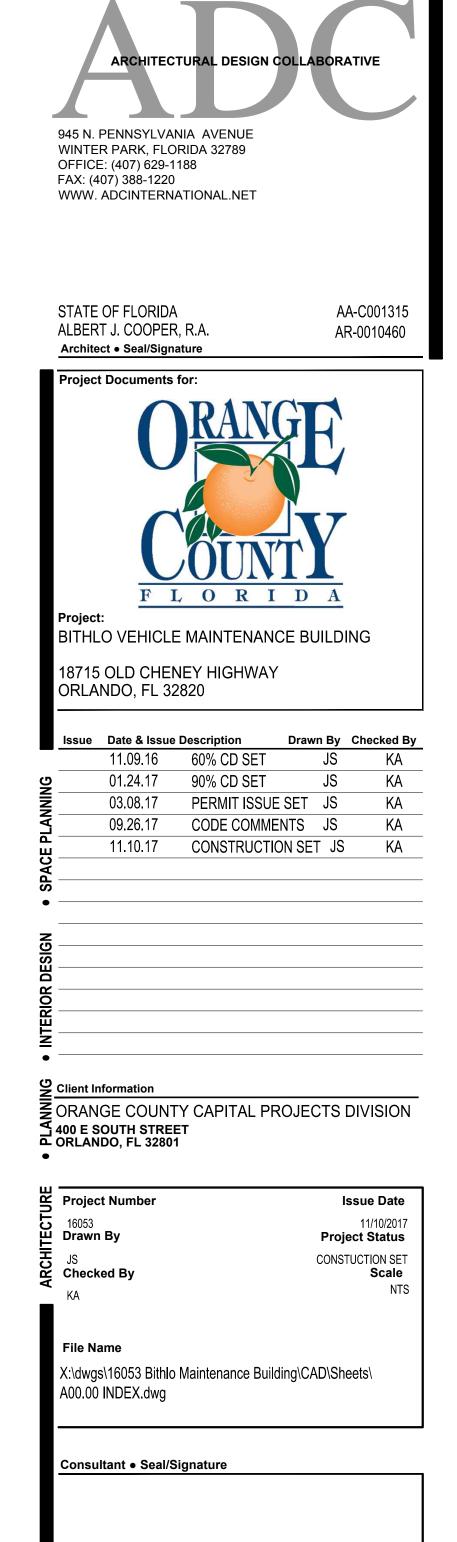104 105



Sheet Title:

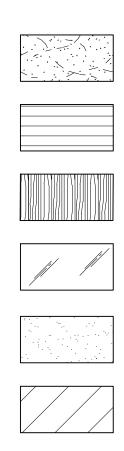
INDEX



GRAPHIC SYMBOLS (CONT.)

STONE

ELEVATION INDICATIONS



BRICK/CONCRETE BLC	CK

FINISHED WOOD

GLASS

QUARTZ

RESIN


SECTION INDICATIONS

un de la construcción de la construcción activitada en la construcción de la construcción a construcción de la construcción de la construcción a construcción de la construcción de la construcción de la	SAND OR GROUT
	EARTH OR NATURAL GROUNE
	POROUS FILL (GRAVEL)
	STONE
4.4.4.4	CONCRETE
	BRICK
	CONCRETE MASONRY UNIT
	METAL
	NON-FERROUS ALUMINUM
	PLYWOOD
	WOOD (FINISH)
	WOOD (CONTINUOUS)
	WOOD (BLOCKING) INTERRUPTED MEMBER
	INSULATION (LOOSE OR BATT
	INSULATION (RIGID)
	GLASS (LARGE SCALE)
	GYPSUM BOARD
	PLASTER WITH LATH
	ACOUSTICAL TILE
	CARPET
	FABRIC WRAPPED PANEL

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	X'-X"
\langle	X'-X"
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	(SD)
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	(s)
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	\$ ₽
	р \$

 \square \boxtimes Е R

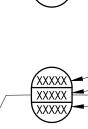FINISH



{ xxxxx }-

(XXXXX) $\langle XXXXX \rangle$

ALL REDORTS DIANS SPECIEICATIONS FIELD DATA AND NOTES AND OTHER DOCUMENTS INCLUDING ALL DOCUMENTS ON ELECTRONIC MEDIA DREBARED RV THE DESIGN DROESSIONAL AS INSTRUMENTS OF SERVICE SHALL REMAIN THE DROBERTY OF THE DESIGN DROESSIONAL

GRAPHIC	SYMBOLS (CONT.)	GRAP	PHIC SYMBOLS (CONT.)
REFLECTED	CEILING	POWER	R & COMMUNICATION
	ACOUSTICAL CEILING AND GRID	∲ + +	WALL MOUNTED DUPLEX WALL MOUNTED FOURPLEX QUADRAPLEX ISOLATED
	MAIN RUNNER GYPSUM BOARD SOFFIT	∲ ∲	WALL MOUNTED SEPARATE DUPLEX WALL MOUNTED DEDICATED DUPLEX
223	EXISTING TO BE REMOVED	\$ \$ \$	WALL MOUNTED DEDICATED FOURPLEX WALL MOUNTED HALF DEDICATED FOURPLEX WALL MOUNTED SPECIAL OUTLET
	SURFACE MOUNTED FLUORESCENT LIGHT FIXTURE		WALL MOUNTED TELEPHONE RECEPTACLE WALL MOUNTED TELE/DATA RECEPTACLE
⊦••I X'-X"	FLUORESCENT PENDANT FIXTURE	₃ ▲	WALL MOUNTED 1 TELE/2 DATA RECEPTACLE - QUAD FACEPLATE TERMINAL IN SINGLE-GANG, DUPLEX J-BOX.
XX X'-X"	CEILING HEIGHT CHANGE		WALL MOUNTED DATA RECEPTACLE WALL MOUNTED A/V RECEPTACLE
X'-X"	DIMENSION OF CEILING ABOVE FINISH FLOOR		WALL MOUNTED TV/CAMERA RECEPTACLE - 3" SQUARE. FLUSH FLOOR MOUNTED TELEPHONE RECEPTACLE
	CEILING FINISH CEILING MOUNTED EXIT SIGN,	3	FLUSH FLOOR MOUNTED TELE/DATA RECEPTACLE FLUSH FLOOR MOUNTED 1 TELE/2 DATA RECEPTACLE
۹۱	SHOWS QUANTITY OF FACE(S) AND DIRECTION OF ARROW(S)		FLUSH FLOOR MOUNTED DATA RECEPTACLE FLUSH FLOOR MOUNTED DUPLEX FLUSHFLOOR MOUNTED FOURPLEX
SD	SMOKE DETECTOR		FLUSHFLOOR MOUNTED FOURPLEX
+55)	STROBE FIRE SPRINKLER		FLUSH FLOOR MOUNTED DEDICATED FOURPLEX FLUSH FLOOR MOUNTED SEPARATE DUPLEX
Ś	SPEAKER		FLUSH FLOOR MOUNTED SEPARATE FOURPLEX
	ACCESS DOOR		FLUSH FLOOR MOUNTED DUPLEX WITH TELE/DATA RECEPTACLE
⊡ © ¢	SECURITY CAMERA THERMOSTAT		WITH TELE/DATA RECEPTACLE FLUSH FLOOR MOUNTED SEPARATE DUPLEX WITH TELE/DATA RECEPTACLE
Ψ n	LIGHT SWITCH		

AV

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MC

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SB

FS

FP

SM

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GFI

	WALL FINISH
	BASE FINISH
_	EXTENT OF FINISH

DIMMER SWITCH

RETURN AIR

SUPPLY AIR

LINEAR DIFFUSER

DENOTES EXISTING TO REMAIN

DENOTES EXISTING, RELOCATED FIXTURE

WALL FINISH EXTENT OF FINISH

WALL FINISH - WAINSCOT FINISH - BASE FINISH EXTENT OF FINISH

SPECIAL FINISH

FLOOR FINISH

CHANGE IN FLOOR FINISH

 \bigcirc POKE-THRU SEPARATE DUPLEX POWER MONUMENT POKE-THRU SEPARATE FOURPLEX POWER MONUMENT Ð AV POKE-THRU A/V MONUMENT \mathbb{N} POKE-THRU TV MONUMENT

POKE-THRU DEDICATED DUPLEX POWER MONUMENT

POKE-THRU DEDICATED FOURPLEX POWER MONUMENT

FLUSH FLOOR MOUNTED A/V RECEPTACLE

FLUSH FLOOR MOUNTED TV RECEPTACLE

POKE-THRU TEL. MONUMENT

POKE-THRU TELE/DATA MONUMENT

POKE-THRU DATA POWER MONUMENT

POKE-THRU DUPLEX POWER MONUMENT

POKE-THRU FOURPLEX POWER MONUMENT

FLUSH WALL MOUNTED POWER JUNCTION BOX J WITH HARDWIRE CONNECTION

FLOOR POKE-THRU JUNCTION BOX WITH HARDWIRE CONNECTION

AOCOMBINATION FLOOR POKE-THRU JUNCTION BOX WITH HARDWIRE CONNECTION CR ID DR CARD READER INTERCOM DEVICE DOOR RELEASE BUTTON PB DOOR BELL PUSH BUTTON TO READ "PUSH TO EXIT" PER NFPA 7.2.1.6.2 (4) MONITOR PD PHONE DIRECTORY ELECTROMAGNETIC DOOR HOLD OPEN ELECTRIC LOCKSET (SEE HARDWARE SCHEDULE) MAGNETIC LOCK (SEE HARDWARE SCHEDULE) SECURITY SYSTEM DOOR MONITOR CONTACT (SEE HARDWARE SCHEDULE) INTRUSION ALARM (SEE SECURITY DRAWINGS) KS KEY SWITCH (SEE SECURITY DRAWINGS) CP CONTROL PANEL BG 491 EMERGENCY BREAK GLASS STATION; SECURITY DOOR CONTROLS WALL MOUNTED SIMON BOARD, POWER & DATA TO BE COORDINATED WITH VENDOR \bigotimes EQUIPMENT ITEM - SEE SCHEDULE FIRE WARDEN STATION FIRE ALARM PULL BOX

SECURITY MONITOR A/V FOR PROJECTION SYSTEM

CAMERA REFER TO REFLECTED CEILING PLAN FOR LOCATION

RECESSED POWER. DATA & COAX OUTLET, SEE PLAN FOR HT

GROUND FAULT INTERCEPTOR

GRAPHIC S	SYMBOLS		ARCHITECTURAL DESIGN	
CONSTRUCTIO	DN .		ARCHITECTURAL DESIGN	COLLABORATIVE
$\begin{pmatrix} 1 \end{pmatrix}$			945 N. PENNSYLVANIA AVENUE WINTER PARK, FLORIDA 32789 OFFICE: (407) 629-1188	
	COLUMN GRID		FAX: (407) 388-1220 WWW. ADCINTERNATIONAL.NET	
	NEW PARTITION			
	REFERENCE TO PARTITION TYPE		STATE OF FLORIDA	AA-C001315
	1 HR. RATED PARTITION		ALBERT J. COOPER, R.A. Architect ● Seal/Signature	AR-0010460
	1 1/2 HR. RATED PARTITION			I
	2 HR. RATED PARTITION		Project Documents for:	
	3 HR. RATED PARTITION		I KAN	GL
	4 HR. RATED PARTITION			
	SMOKE PARTITION			
\bullet	ELEVATION DATUM POINT			
OFFICE	- ROOM NAME - ROOM NUMBER			
(XXXXX)	DOOR NUMBER (WITH SCHEDULE)		Project: BITHLO VEHICLE MAINTENA	
	"N" PREFIX DENOTES DOOR AT NON-DT OPTION ONLY		18715 OLD CHENEY HIGHWA	
ALIGN	ALIGN WITH ESTABLISHED SURFACES		Issue Date & Issue Description	Drawn By Checked By
	SHEET NOTE	PLANNING	11.09.16 60% CD SET	JS KA JS KA
	REVISION REFERENCE	SPACE PLAN	09.26.17 CODE COM 11.10.17 CONSTRUC	
	EXTERIOR ELEVATION INDICATION	SP		
XX AXX XX	ROW ON ELEVATION SHEET WHERE SHOWN DIRECTION OF ELEVATION SHEET WHERE SHOWN	• DESIGN		
		TERIOR		
A	- LOCATION ON ROW WHERE SHOWN - DIRECTION OF ELEVATION			
	ROW ON ELEVATION SHEET WHERE SHOWN	•	Client Information	
XX Ad0.01 FL12.NW/SIM	- DETAIL NUMBER		ORANGE COUNTY CAPITAL F 400 E SOUTH STREET ORLANDO, FL 32801	PROJECTS DIVISION
	SHEET WHERE SHOWN DESCRIPTION OF SIMILAR OR OPPOSITE	•		
	FLOOR LEVEL AND AREA OR PHASE	LKE	Project Number	Issue Date
	AREA TO BE DETAILED	ARCHITECTURE	16053 Drawn By	11/10/2017
	MILLWORK		Drawn By JS	Project Status CONSTUCTION SET
	MILLWORK SCHEDULE TAG (IF USED)	AR(Checked By KA	Scale NTS
FE	FIRE EXTINGUISHER WITHOUT CABINET			
FEC	FIRE EXTINGUISHER CABINET		File Name	
€ FVC	FIRE VALVE WITHOUT CABINET		X:\dwgs\16053 Bithlo Maintenance Bi A00.01 GRAPHICS.dwg	uilding\CAD\Sheets\
			Consultant • Seal/Signature	
			Sheet Title:	
			GRAPHIC SY	MBOLS
			A00.	01

A

DOOR, FRAME AND HARDWARE GROUP SCHEDULE

								SCH	EDULE - DOOR ANI	D FRAME							
			DOOR A	SSEMBLY						FRAME A	SSEMBLY			FIRE	HARDWARE	HARDWARE	
NO.	LOCATION	TYPE	WIDTH	HEIGHT	THICKNESS	MATERIAL	FINISH	MATERIAL	FINISH	HEAD DETAIL	JAMB DETAIL	TYPE	SILL DETAIL	RATING	GROUP	FUNCTION	
107A	TOOL MAINTENANCE	C	(2) 3'-0"	7'-0"	1 3/4"	HOLLOW MTL	PAINT	HOLLOW MTL	PAINT	04/A00.31	05/A00.31	V	ALUMINUM	-	1		1
107R	TOOL MAINTENANCE	C	(2) 3'-0"	7'-0"	1 3/4"	HOLLOW MTL	PAINT	HOLLOW MTL	PAINT	04/A00.31	05/A00.31		ALUMINUM		1		1
		A	3'-0"	7'-0"	1 3/4"	HOLLOW MTL	PAINT	HOLLOW MTL	PAINT	07/A00.31	08/A00.31	1	-	-	2		1
	GARAGE	C	(2) 3'-0"	7'-0"	1 3/4"	HOLLOW MTL	PAINT	HOLLOW MTL	PAINT	04/A00.31	05/A00.31	111	ALUMINUM	-	1		1
108A																	

HARDWARE GROUPS

SET 01

- LOCKSET (KEYED): MARKS 195 SERIES WITH I/C CORE PREP CYLINDRICAL LOCKSET, LEVEL, 26D FINISH

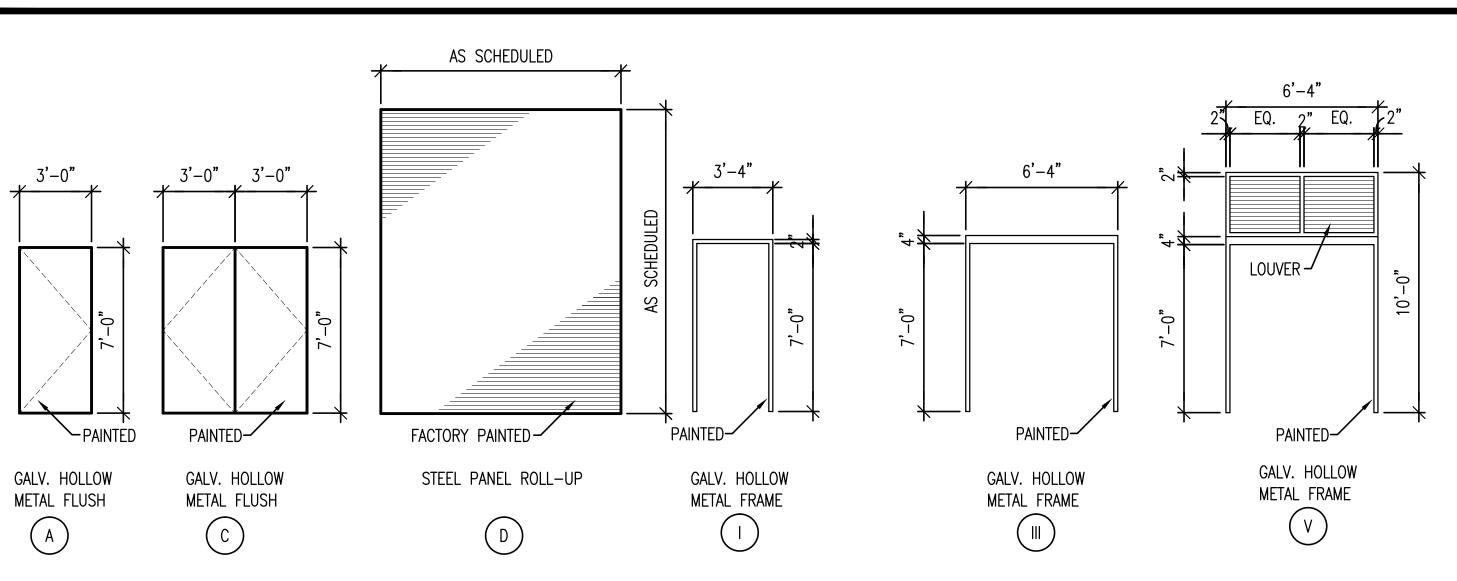
- FULL MORTISE BUTT STAINLESS HINGES, STANLEY CB 1900 4 $\frac{1}{2}$ "X4" $\frac{1}{2}$ " (3)

- DOOR STOP: FLOOR MOUNTED - DOME, ROCKWOOD 440 626 FINISH

- DOOR CLOSER: LCN - 4040XP, 626 FINISH @ PUSH SIDE - (2) 12" KICKPLATE STAINLESS (BOTH SIDES): IVES 8400, US26D FINISH

- WEATHER STRIPPING:

DOOR TYPES




SET 02


- LOCKSET (PASSAGE): MARKS 195 SERIES, LEVER, 26D FINISH FULL MORTISE BUTT STAINLESS HINGES, STANLEY CB 1900 4 ¹/₂"X4 ¹/₂" (3) DOOR STOP: FLOOR MOUNTED DOME, ROCKWOOD 440 626 FINISH
- DOOR CLOSER: LCN 4040XP, 626 FINISH @ PUSH SIDE
- (2) 12" KICKPLATE STAINLESS (BOTH SIDES): IVES 8400, US26D FINISH

	ARCHITECTURAL DESIGN	
1. NEW DOOR AND FRAME SHALL BE PAINTED COLOR P-1. REFER TO FINISH SCHEDULE ON SHEET A06.01.	945 N. PENNSYLVANIA AVENUE WINTER PARK, FLORIDA 32789 OFFICE: (407) 629-1188 FAX: (407) 388-1220 WWW. ADCINTERNATIONAL.NET	
	STATE OF FLORIDA ALBERT J. COOPER, R.A. Architect • Seal/Signature	AA-C001315 AR-0010460
GENERAL NOTES	Project Documents for:	GE
 A COORDINATE ALL HARDWARE WITH DOOR SWING. CLOSERS TO BE ON INTERIOR OF ROOMS. DOOR STOP SHALL BE FLOOR MOUNTED AND INSTALLED ON INTERIOR OF ROOMS, U.N.O. B ALL HARDWARE FINISH SHALL BE: TBD. C ALL EXISTING DOORS AND FRAMES TO BE PAINTED, REFER TO FINISH SCHEDULE FOR COLOR. D ALL DOOR HARDWARE SHALL BE LEVER TYPE MEETING REQUIREMENTS OF ADA. E CONTRACTOR SHALL COORDINATE ALL HARDWARE KEYING WITH THE OWNER AND OBTAIN OWNER'S APPROVAL PRIOR TO PLACING HARDWARE ORDER. R REFER TO SPECIFICATIONS FOR HARDWARE FINISH. G AT DOORS WHERE GLASS IS USED THE GLASS SHALL BE SAFETY GLAZED (TEMPERED) AND TESTED IN ACCORDANCE WITH ANIS-297. H PANIC HARDWARE SHALL BE PUSH-PAD TYPE TO EGRESS DIRECTION AND SHALL NOT REQUIRE MORE THAN ONE OPERATION TO UNLATCH. ALL EGRESS DOORS SHALL BE OPERABLE WITHOUT THE USE OF A KEY OR SPECIAL KNOWLEDGE. ALL DOORS TO HAVE MINIMUM 32" CLEAR OPENING WIDTH IN ACCORDANCE W/ SECTION 1008.1.1 OF THE IBC. J PROVIDE EACH ASSEMBLY WITH ALL SUPPORTS, EQUIPMENT, AND MECHANISMS NECESSARY FOR A COMPLETE OPERABLE INSTALLATION. INSTALL WEATHERSTRIPPING AFTER DOOR IS INSTALLED AND ADJUSTED. K PROVIDE ALL OTHER MATERIALS SUCH AS BRACKETS, FASTENERS, BACK-UP PLATES AND OTHER ACCESSORIES NOT SPECIFICALLY DESCRIBED BUT REQUIRED FOR A COMPLETE OPERABLE FINISH HARDWARE INSTALLATION. L EXTERIOR DOOR THRESHOLD SHALL NOT EXCEED ONE HALF INCHES (1/2') IN HEIGHT AND SHALL HAVE A 12 BEVEL. M ALL DOOR HARDWARE, AS APPLICABLE, SHALL COMPLY WITH THE REQUIREMENTS OF NFPA 101, SECTION 7.2.1.5.4. 	Project: BITHLO VEHICLE MAINTENAN 18715 OLD CHENEY HIGHWAY ORLANDO, FL 32820	NCE BUILDING AY Drawn By Checked By JS KA JS KA UE SET JS KA UE SET JS KA MENTS JS KA TION SET JS KA
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ACCESSIBILITY NOTES:

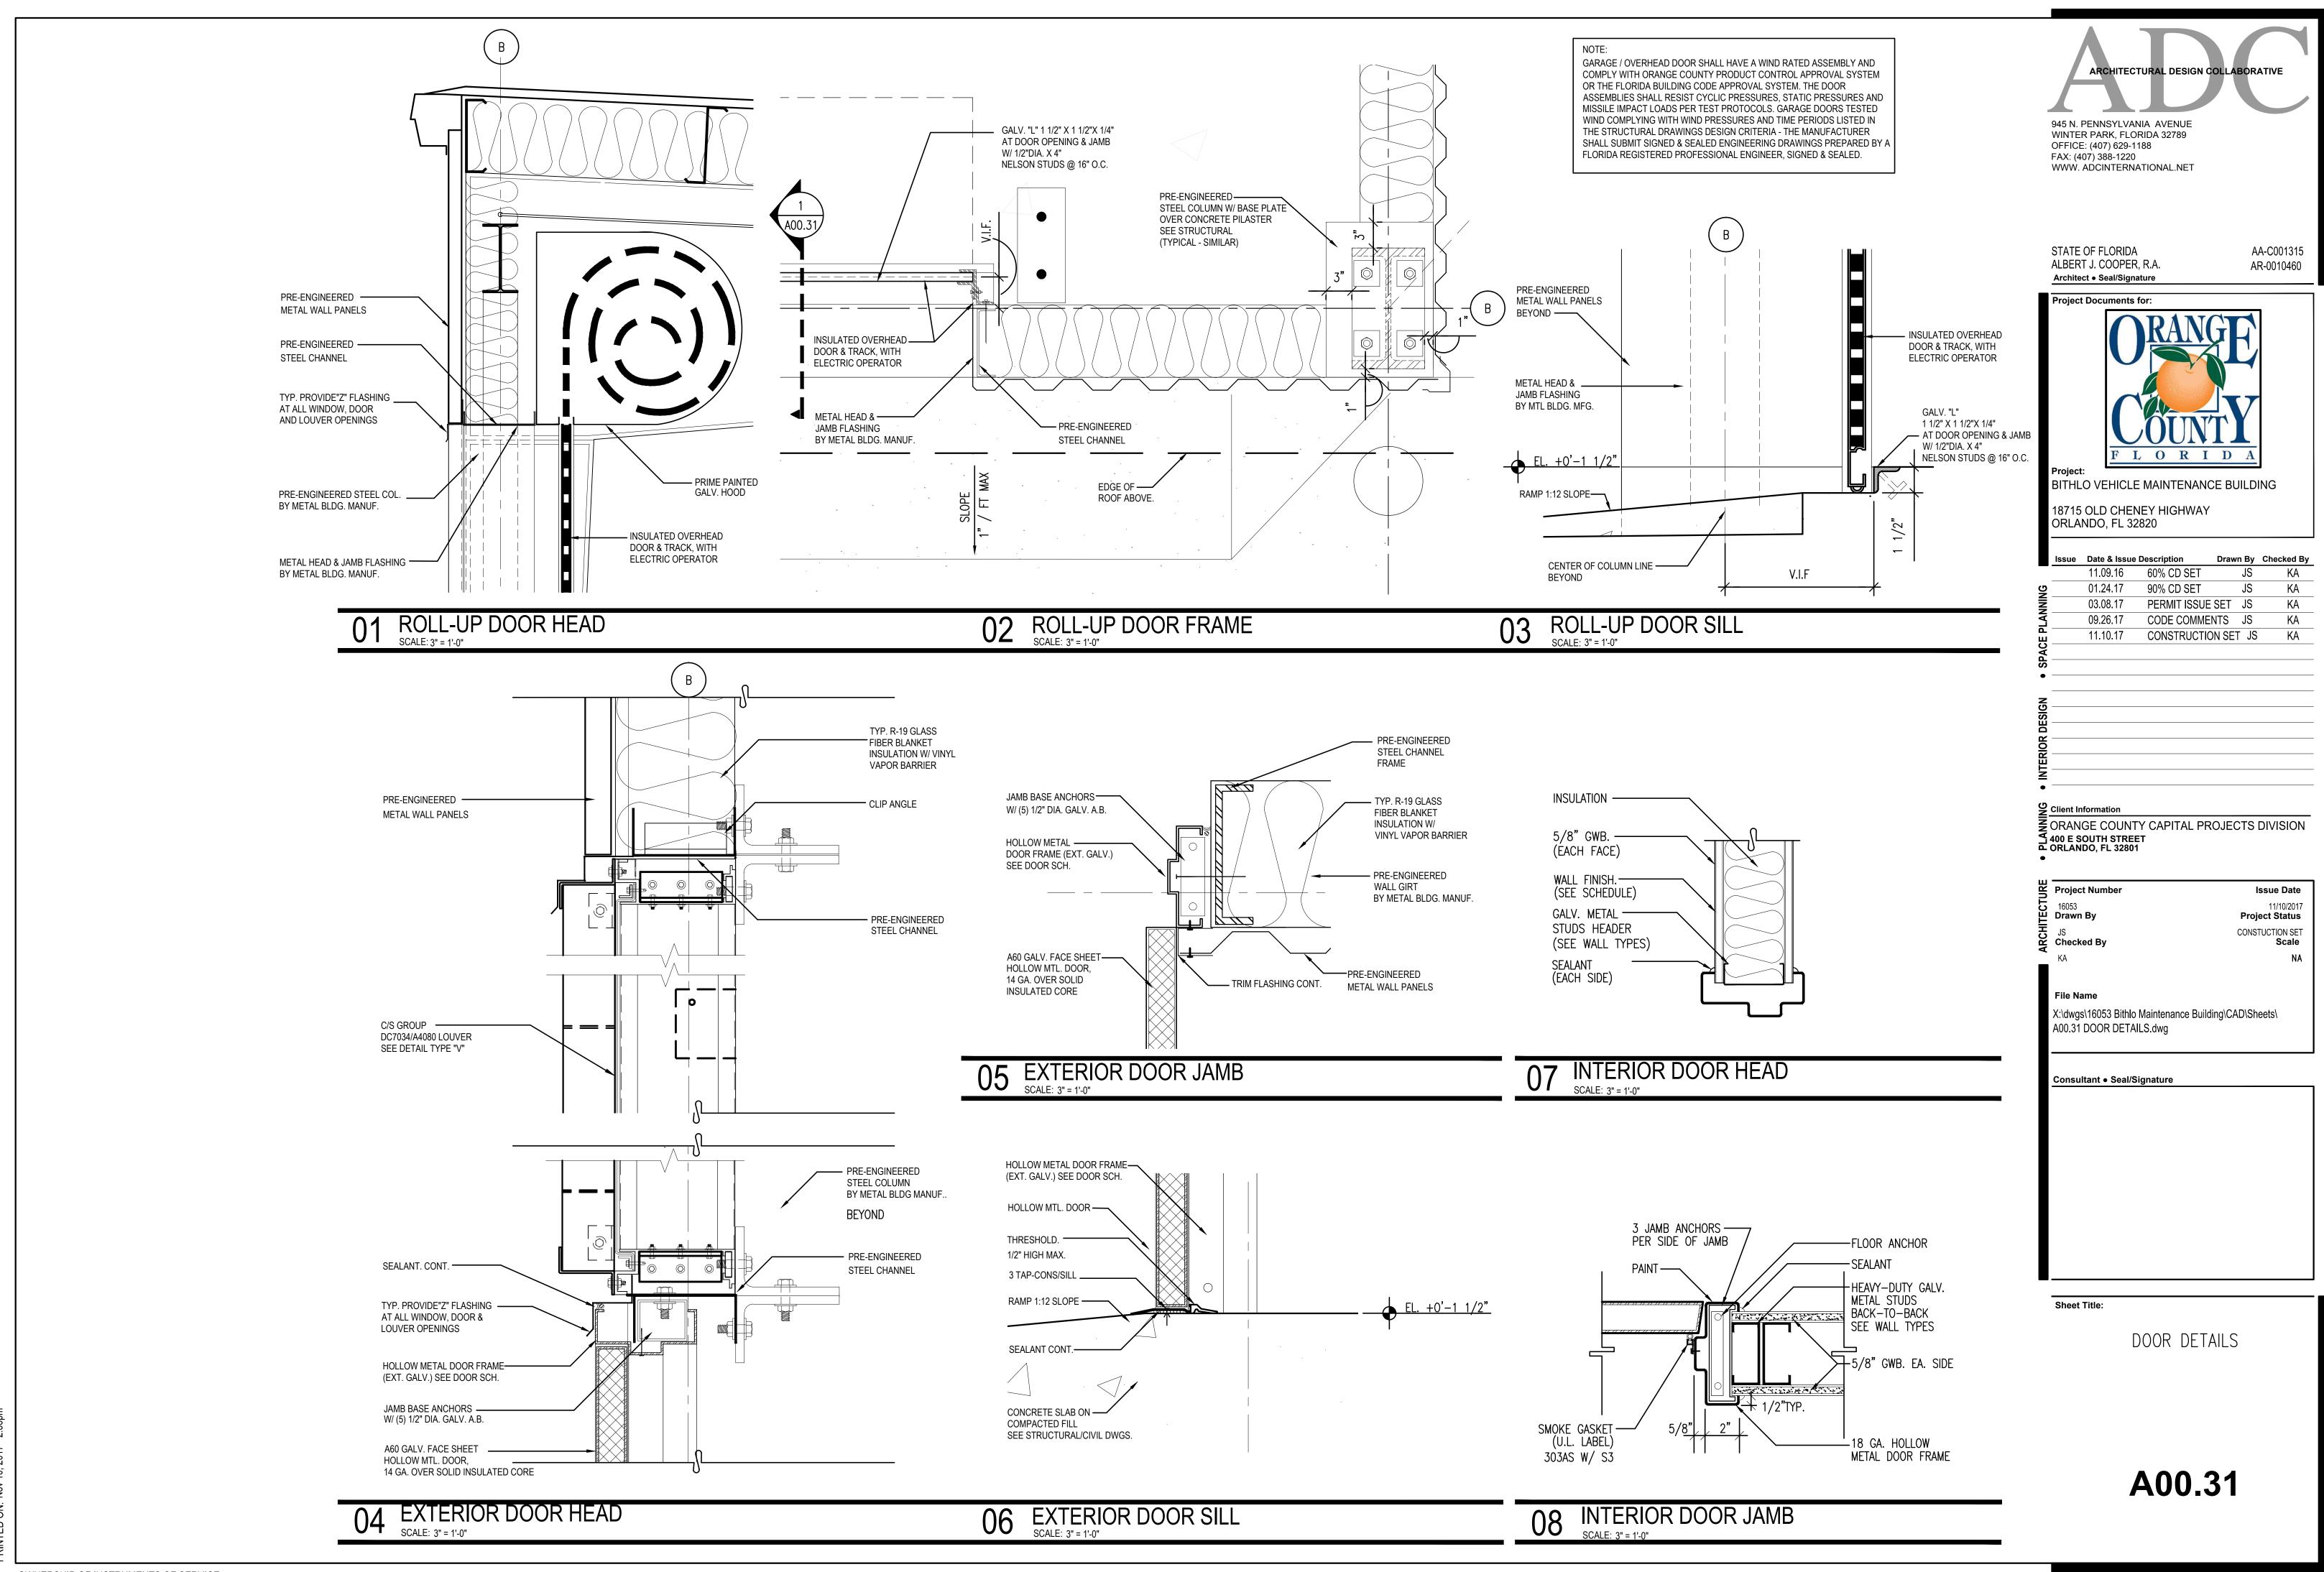1 FOR RESTROOMS ACCESSIBLE TO THE PUBLIC THE WALLS AND FLOORS OF TOILET. BATHING AND SHOWER ROOMS SHALL HAVE A SMOOTH, HARD, NONABSORBENT SURFACE. THE INTERSECTIONS OF SUCH UPWARD ON TOTOL A SMOOTH DRD, IN UPWARD ON TOTOL ADDAT LEAS, WITHIN 2 FEET OF TRIPUSSIND WATER CLOSET PD, NON NOT DENT SURFACE TO SEPT HON STRUCTURE TATION FLOORS WITH WALLS SHALL HAVE IONABSORBENT VERTICAL EAST 4 INCHES. WALLS AND R CLOSETS SHALL HAVE A RFACE, TO A HEIGHT OF 4 FEET ABOVE THE FLOOR, AND EX TURAL ELEMENTS, THE MATERIALS USED IN SUC WALLS SHALL BE OF A TYPE THAT IS NOT ADVERSELY AFFECTED BY MOISTURE. ACCESSORIES SUCH AS GRAB BARS, TOWEL BARS, PAPER DISPENSERS AND SOA DISHES, PROVIDED ON OR WITHIN WALLS, SHALL BE INSTALLED AND SEALED TO PROTECT STRUCTURAL ELEMENTS FROM MOISTURE.

- 2. ALL DIMENSIONS ARE ABOVE FINISHED FLOOR (A.F.F.). DIMENSIONS THAT ARE NOT STATED AS "MAXIMUM" OR "MINIMUM" ARE ABSOLUTE.
- 3. ALL DIMENSIONS ARE TO FINISH SURFACES AND SHALL BE CONSIDERED "CLEAR" DIMENSIONS. THE ACCESSIBLE 5 FOOT TURNING CIRCLE IS A "CLEAR" DIMENSION CONTINUOUS FROM THE FLOOR AND UP THE WALLS. THE FINISHED BASE AND/OR TRIM MATERIALS SHALL NOT DIMINISH THE REQUIRED 5 FOOT DIMENSION AT THE FLOOR OR THE WALLS OF THE ROOM. GC SHALL LAY OUT THE WORK TO ACCOMMODATE THE THICKNESS OF MATERIALS AND ALLOW FOR VARIATIONS IN EXISTING AND NEW SURFACES AND MATERIALS TO
- AND FIXTURE SCHEDUNG SIEU CETAILS, NOTES AND THE ACCESSOR
- 5. DETAILS SUPERSEDE PLANS. IN THE EVENT OF CONFLICTING INFORMATION GC TO CONTACT ARCHITECT IMMEDIATELY. 6. FLOOR SURFACES SHALL BE SLIP-RESISTANT.
- 7. EVERY CORRIDOR AND AISLE SERVING AN OCCUPANT LOAD OF 10 OR MORE SHALL BE NOT LESS THAN 44" IN WIDTH.
- 8. ABRUPT CHANGES IN LEVEL ALONG ANY ACCESSIBLE ROUTE SHALL NOT EXCEED 1/2" IN HEIGHT. LEVEL CHANGES NOT EXCEEDING 1/4" MAY BE VERTICAL. BEVEL OTHERS WITH A SLOPE NO GREATER THAN 1:2
- 9. LATCHING AND LOCKING DOORS THAT ARE HAND ACTIVATED AND WHICH ARE IN A PATH OF TRAVEL SHALL BE OPERABLE WITH A SINGLE EFFORT BY LEVER TYPE HARDWARE, PANIC BARS, PUSH-PULL ACTIVATING BARS, OR OTHER HARDWARE DESIGNED TO PROVIDE PASSAGE WITHOUT REQUIRING THE ABILITY TO GRASP THE OPENING HARDWARE. MOUNT DOOR OPENING HARDWARE BETWEEN 30" AND 44" ABOVE FLOOR FINISH.
- 10. MAXIMUM PULL OR PUSH EFFORT TO OPERATE DOORS SHALL NOT EXCEED 8.5 POUNDS FOR EXTERIOR DOORS AND 5 POUNDS FOR INTERIOR DOORS, MEASURED AT RIGHT ANGLES TO HINGED DOORS AND AT CENTER PLANE OF SLIDING OR FOLDING DOORS. CORRESPONDING DEVICES OR AUTOMATIC DOOR OPERATORS MAY BE UTILIZED TO MEET THE ABOVE STANDARDS. MAXIMUM EFFORT TO OPERATE REQUIRED FIRE DOORS MAY BE INCREASED NOT TO EXCEED 15 POUNDS.
- 11. THE BOTTOM 10" OF ALL DOORS (EXCEPT SLIDING AND AUTOMATIC) SHALL HAVE A SMOOTH UNINTERRUPTED SURFACE TO ALLOW THE DOOR TO BE OPENED BY A WHEELCHAIR FOOTREST WITHOUT CREATING A TRAP OR HAZARDOUS CONDITION. PROVIDE A 10" HIGH SMOOTH PANEL ON THE PUSH SIDE OF NARROW FRAME DOORS.
- 12. EVERY REQUIRED ENTRANCE OR PASSAGE DOORWAY SHALL BE NOT LESS THAN 3' IN WIDTH AND NOT LESS THAN 6'-8" IN HEIGHT. DOORS SHALL BE CAPABLE OF OPENING AT LEAST 90 DEGREES AND SHALL BE SO MOUNTED THAT THE CLEAR WIDTH OF THE DOORWAY IS NOT LESS THAN 32".
- 13. WHERE A PAIR OF DOORS IS UTILIZED, AT LEAST ONE OF THE DOORS SHALL PROVIDE A CLEAR, UNOBSTRUCTED OPENING WIDTH OF 32" WITH THE LEAF POSITIONED AT AN ANGLE OF 90 DEGREES FROM ITS CLOSED POSITION.
- 14. IDENTIFY ACCESSIBLE ENTRANCES WITH AT LEAST ONE STANDARD SIGN AND WITH ADDITIONAL DIRECTIONAL SIGNS, AS REQUIRED, VISIBLE FROM APPROACHING PEDESTRIAN WAYS.
- 15. THE FLOOR OR LANDING ON EACH SIDE OF AN ENTRANCE OR PASSAGE DOOR SHALL BE LEVEL AND CLEAR. THE LEVEL AND CLEAR AREA SHALL HAVE A LENGTH IN THE DIRECTION OF DOOR SWING OF AT LEAST 60" AND THE LENGTH OPPOSITE THE DIRECTION OF DOOR SWING OF 44" AS MEASURED AT RIGHT ANGLES TO THE PLANE OF THE DOOR IN ITS CLOSED POSITION. (REFER TO A.D.A. DRAWING FOR CLEARANCES BASED ON DIFFERENT APPROACHES)
- 16. FLOORS OR LANDINGS SHALL BE NOT MORE THAN 1/2" LOWER THAN THE THRESHOLD OF THE DOORWAY. CHANGE IN LEVEL BETWEEN 1/4" AND 1/2" SHALL BE BEVELED WITH A SLOPE NO GREATER THAN 1:2.
- 17. TO ALERT THE VISUALLY IMPAIRED, MARK THE UPPER APPROACH AND THE LOWER TREAD OF EACH INTERIOR STAIR WITH A STRIP OF CLEARLY CONTRASTING COLOR AT LEAST 2" WIDE, PLACED PARALLEL TO AND NOT MORE THAN 1" FROM THE NOSE OF THE STEP OR LANDING. THE STRIP SHALL BE OF A MATERIAL THAT IS SLIP RESISTANT AS THE OTHER TREADS OF THE STAIR.
- 18. CENTER ELECTRICAL RECEPTACLE OUTLETS NOT LESS THAN 15" ABOVE THE FLOOR OR WORKING PLATFORM.

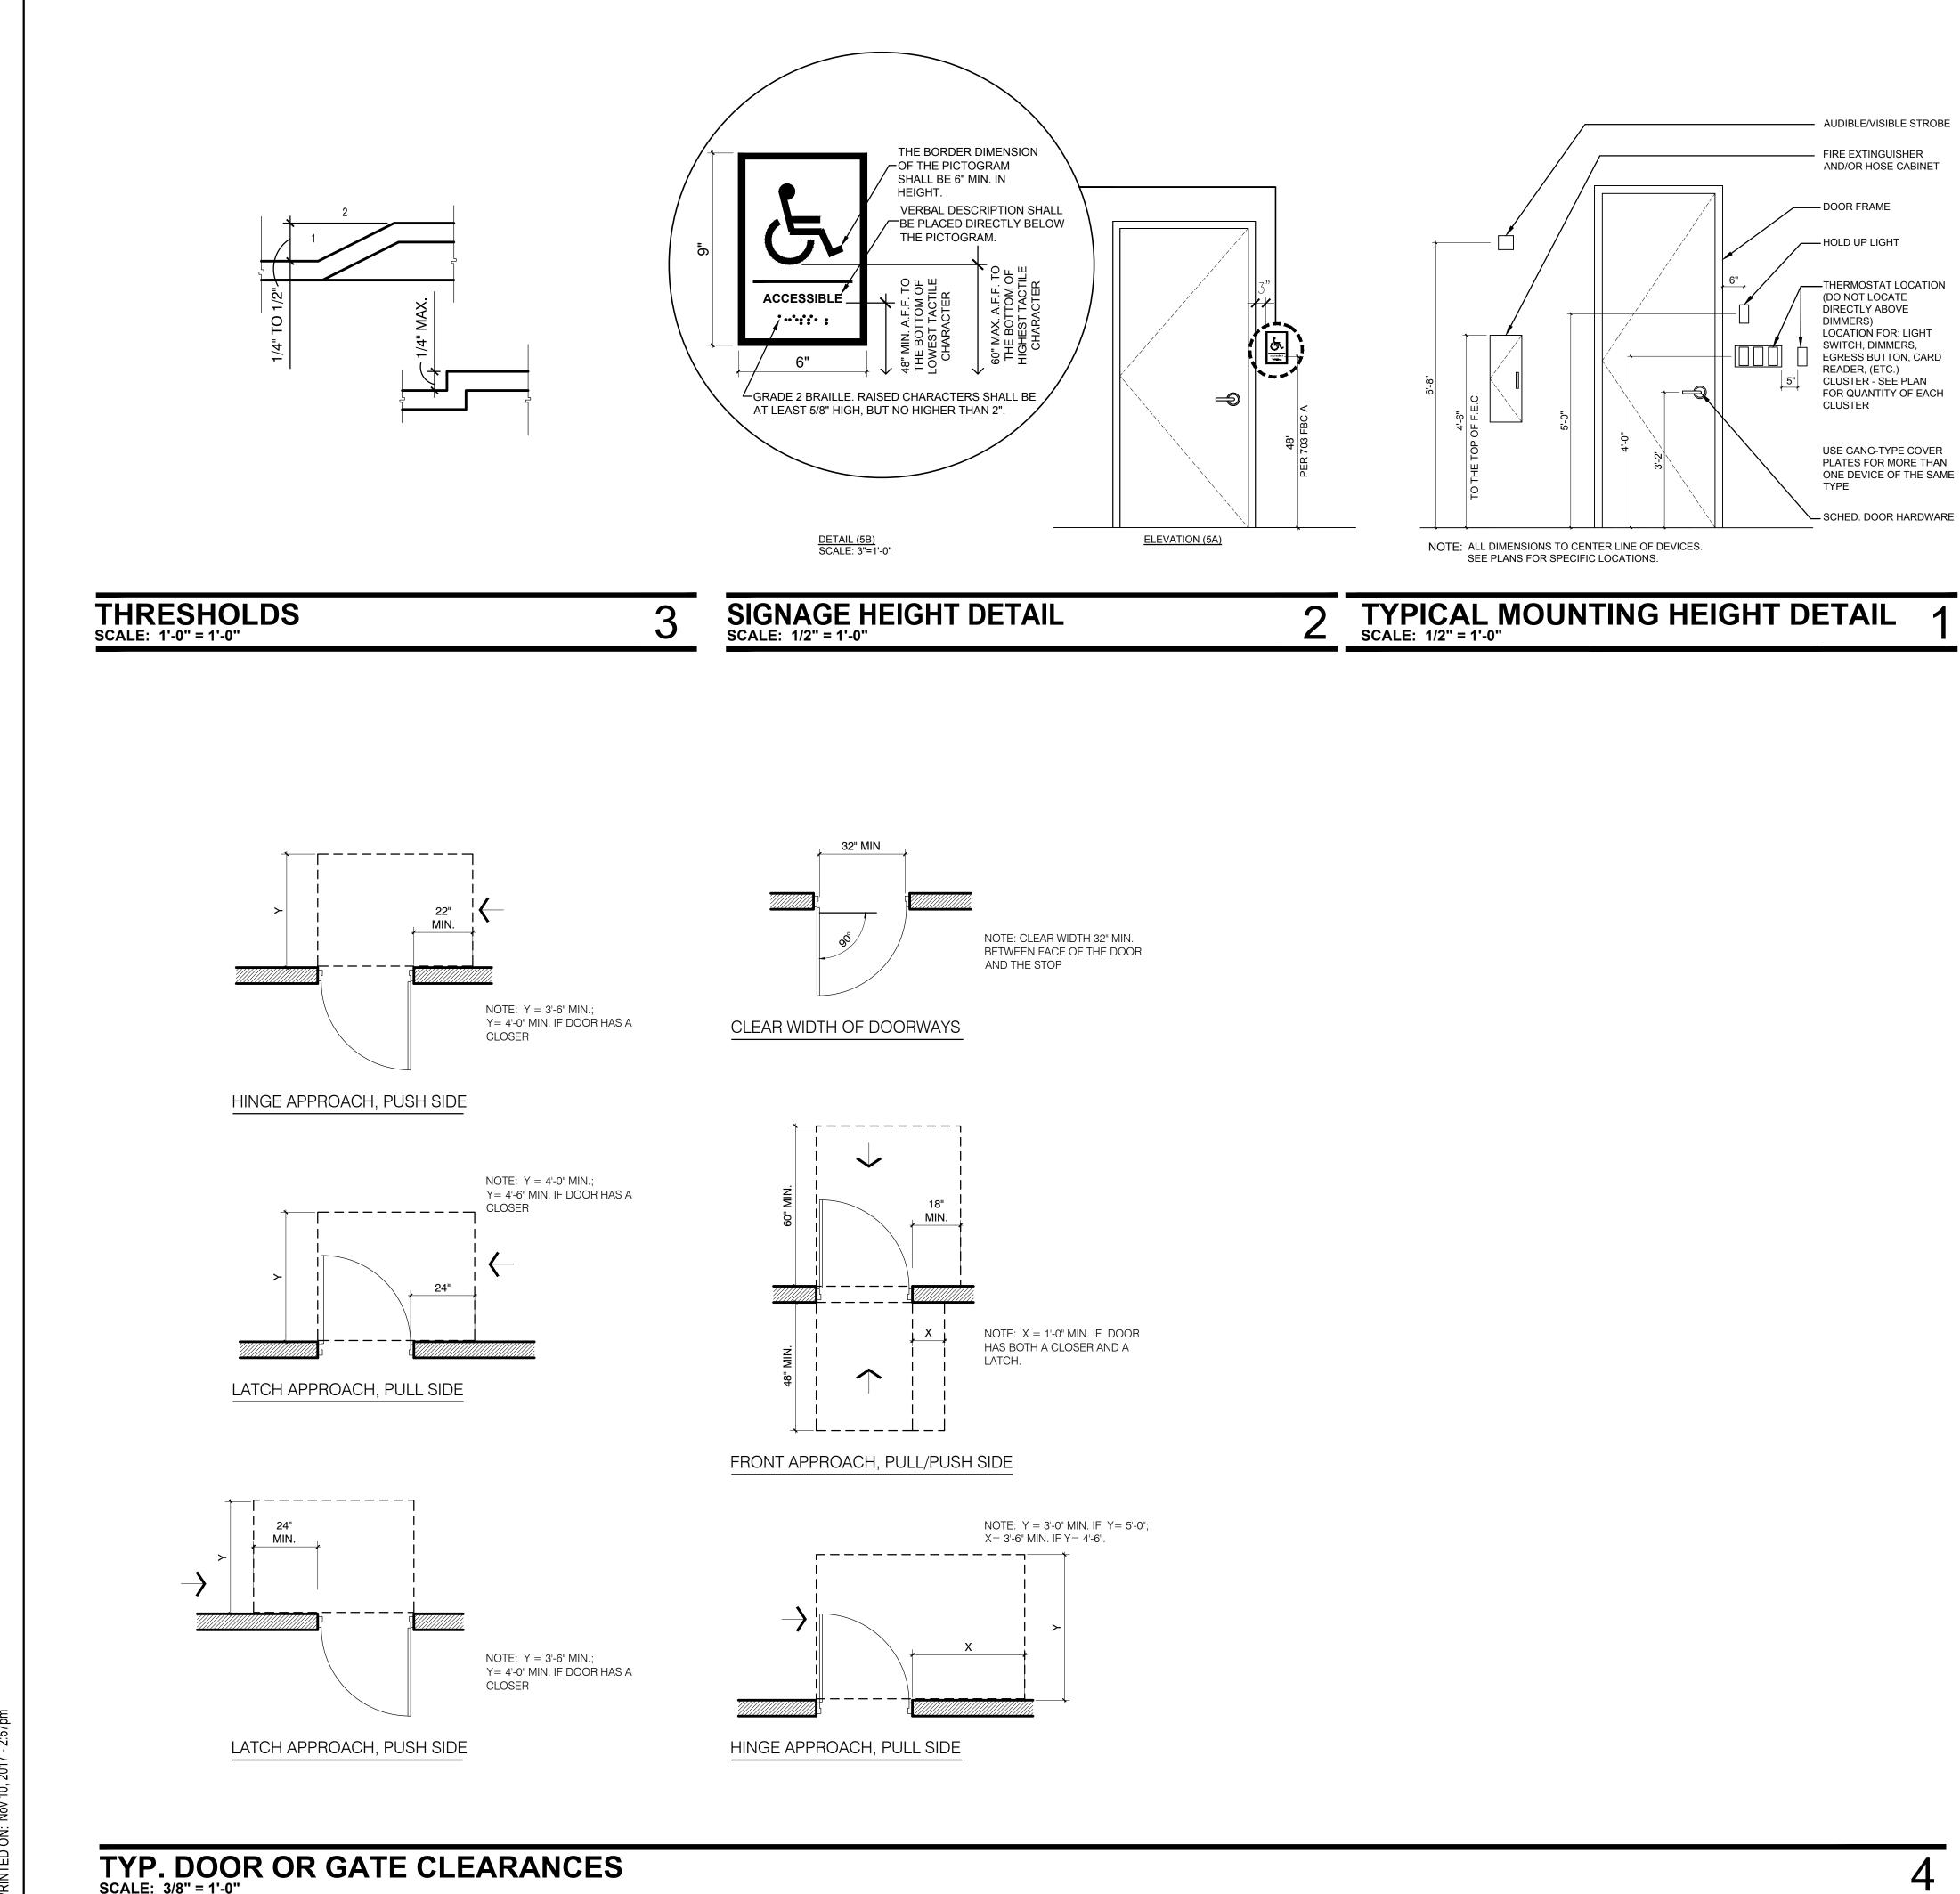FAX: (407) 388-1220 WWW. ADCINTERNATIONAL.NET STATE OF FLORIDA AA-C001315 ALBERT J. COOPER, R.A. AR-0010460 Architect • Seal/Signature Project Documents for: FLORIDA Proiect BITHLO VEHICLE MAINTENANCE BUILDING

ARCHITECTURAL DESIGN COLLABORATIVE

945 N. PENNSYLVANIA AVENUE

WINTER PARK, FLORIDA 32789

OFFICE: (407) 629-1188

18715 OLD CHENEY HIGHWAY ORLANDO, FL 32820

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PLANNING		09.26.17	CODE COMMEN	TS JS	KA
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Client Information

ORANGE COUNTY CAPITAL PROJECTS DIVISION 400 E SOUTH STREET ORLANDO, FL 32801

Project Number 16053 🖳 Drawn By Checked By

File Name

Issue Date 11/10/2017 Project Status CONSTUCTION SET Scale AS INDICATED

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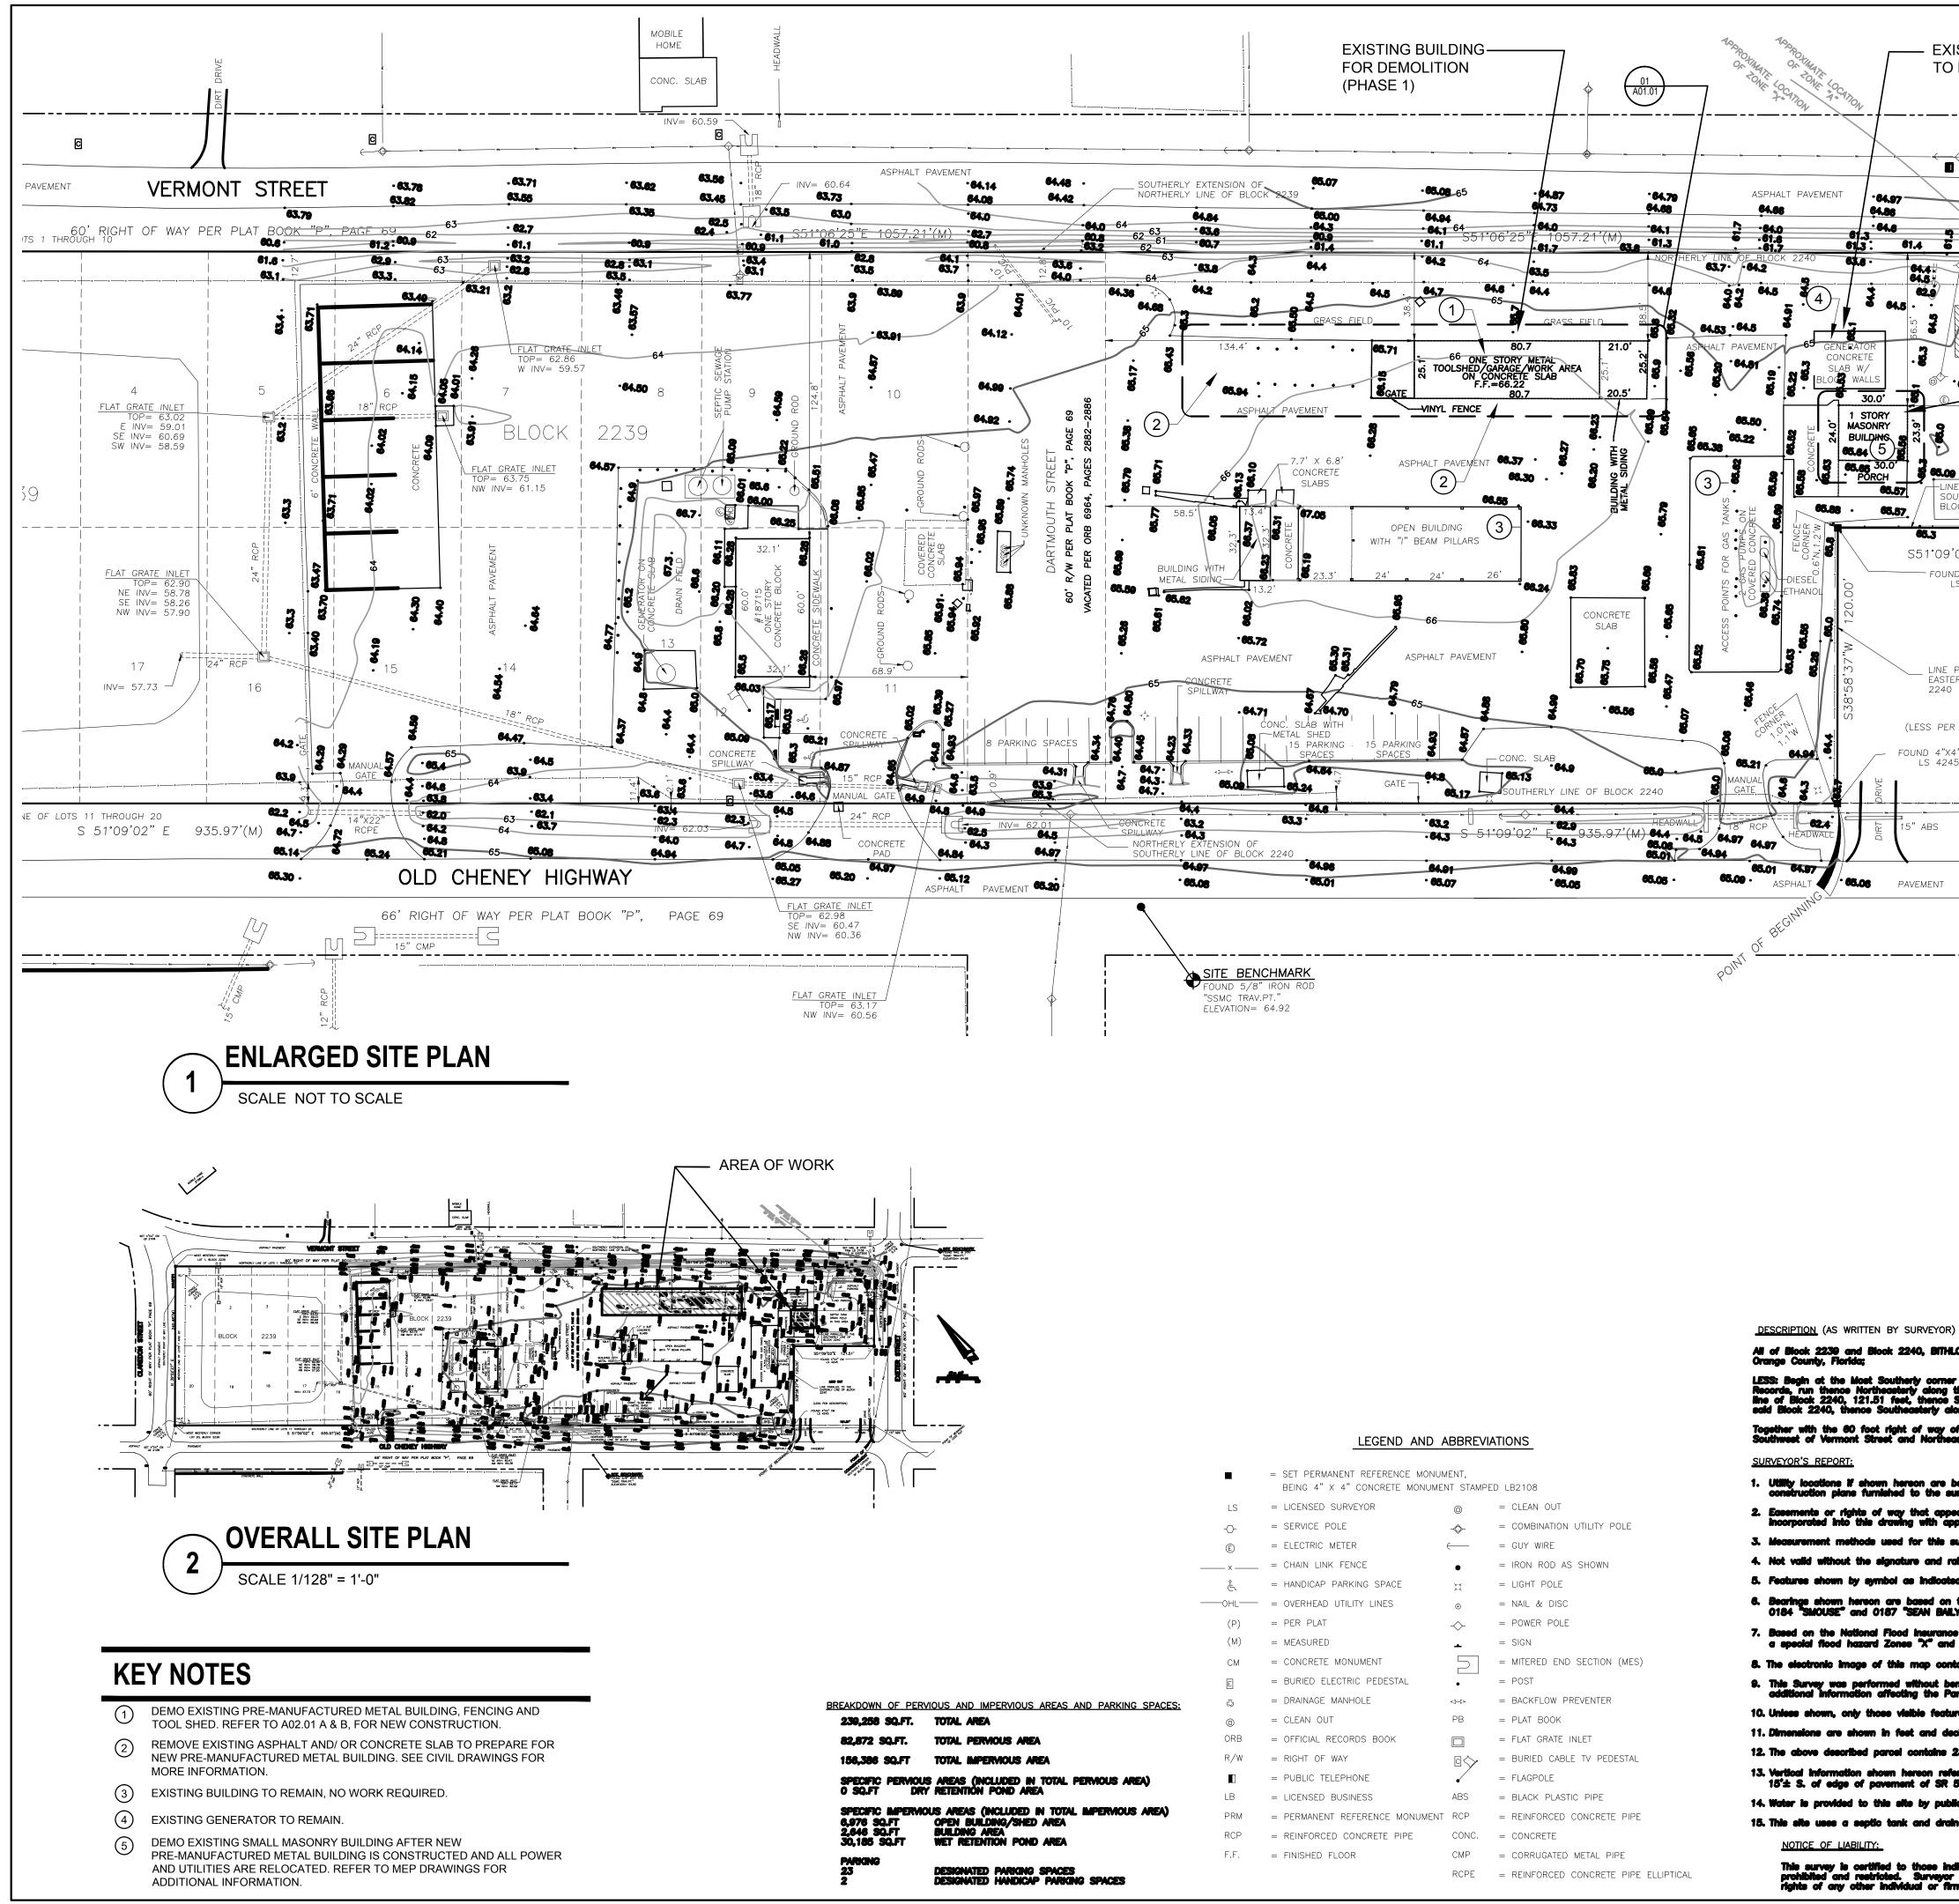
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Seal/Signature

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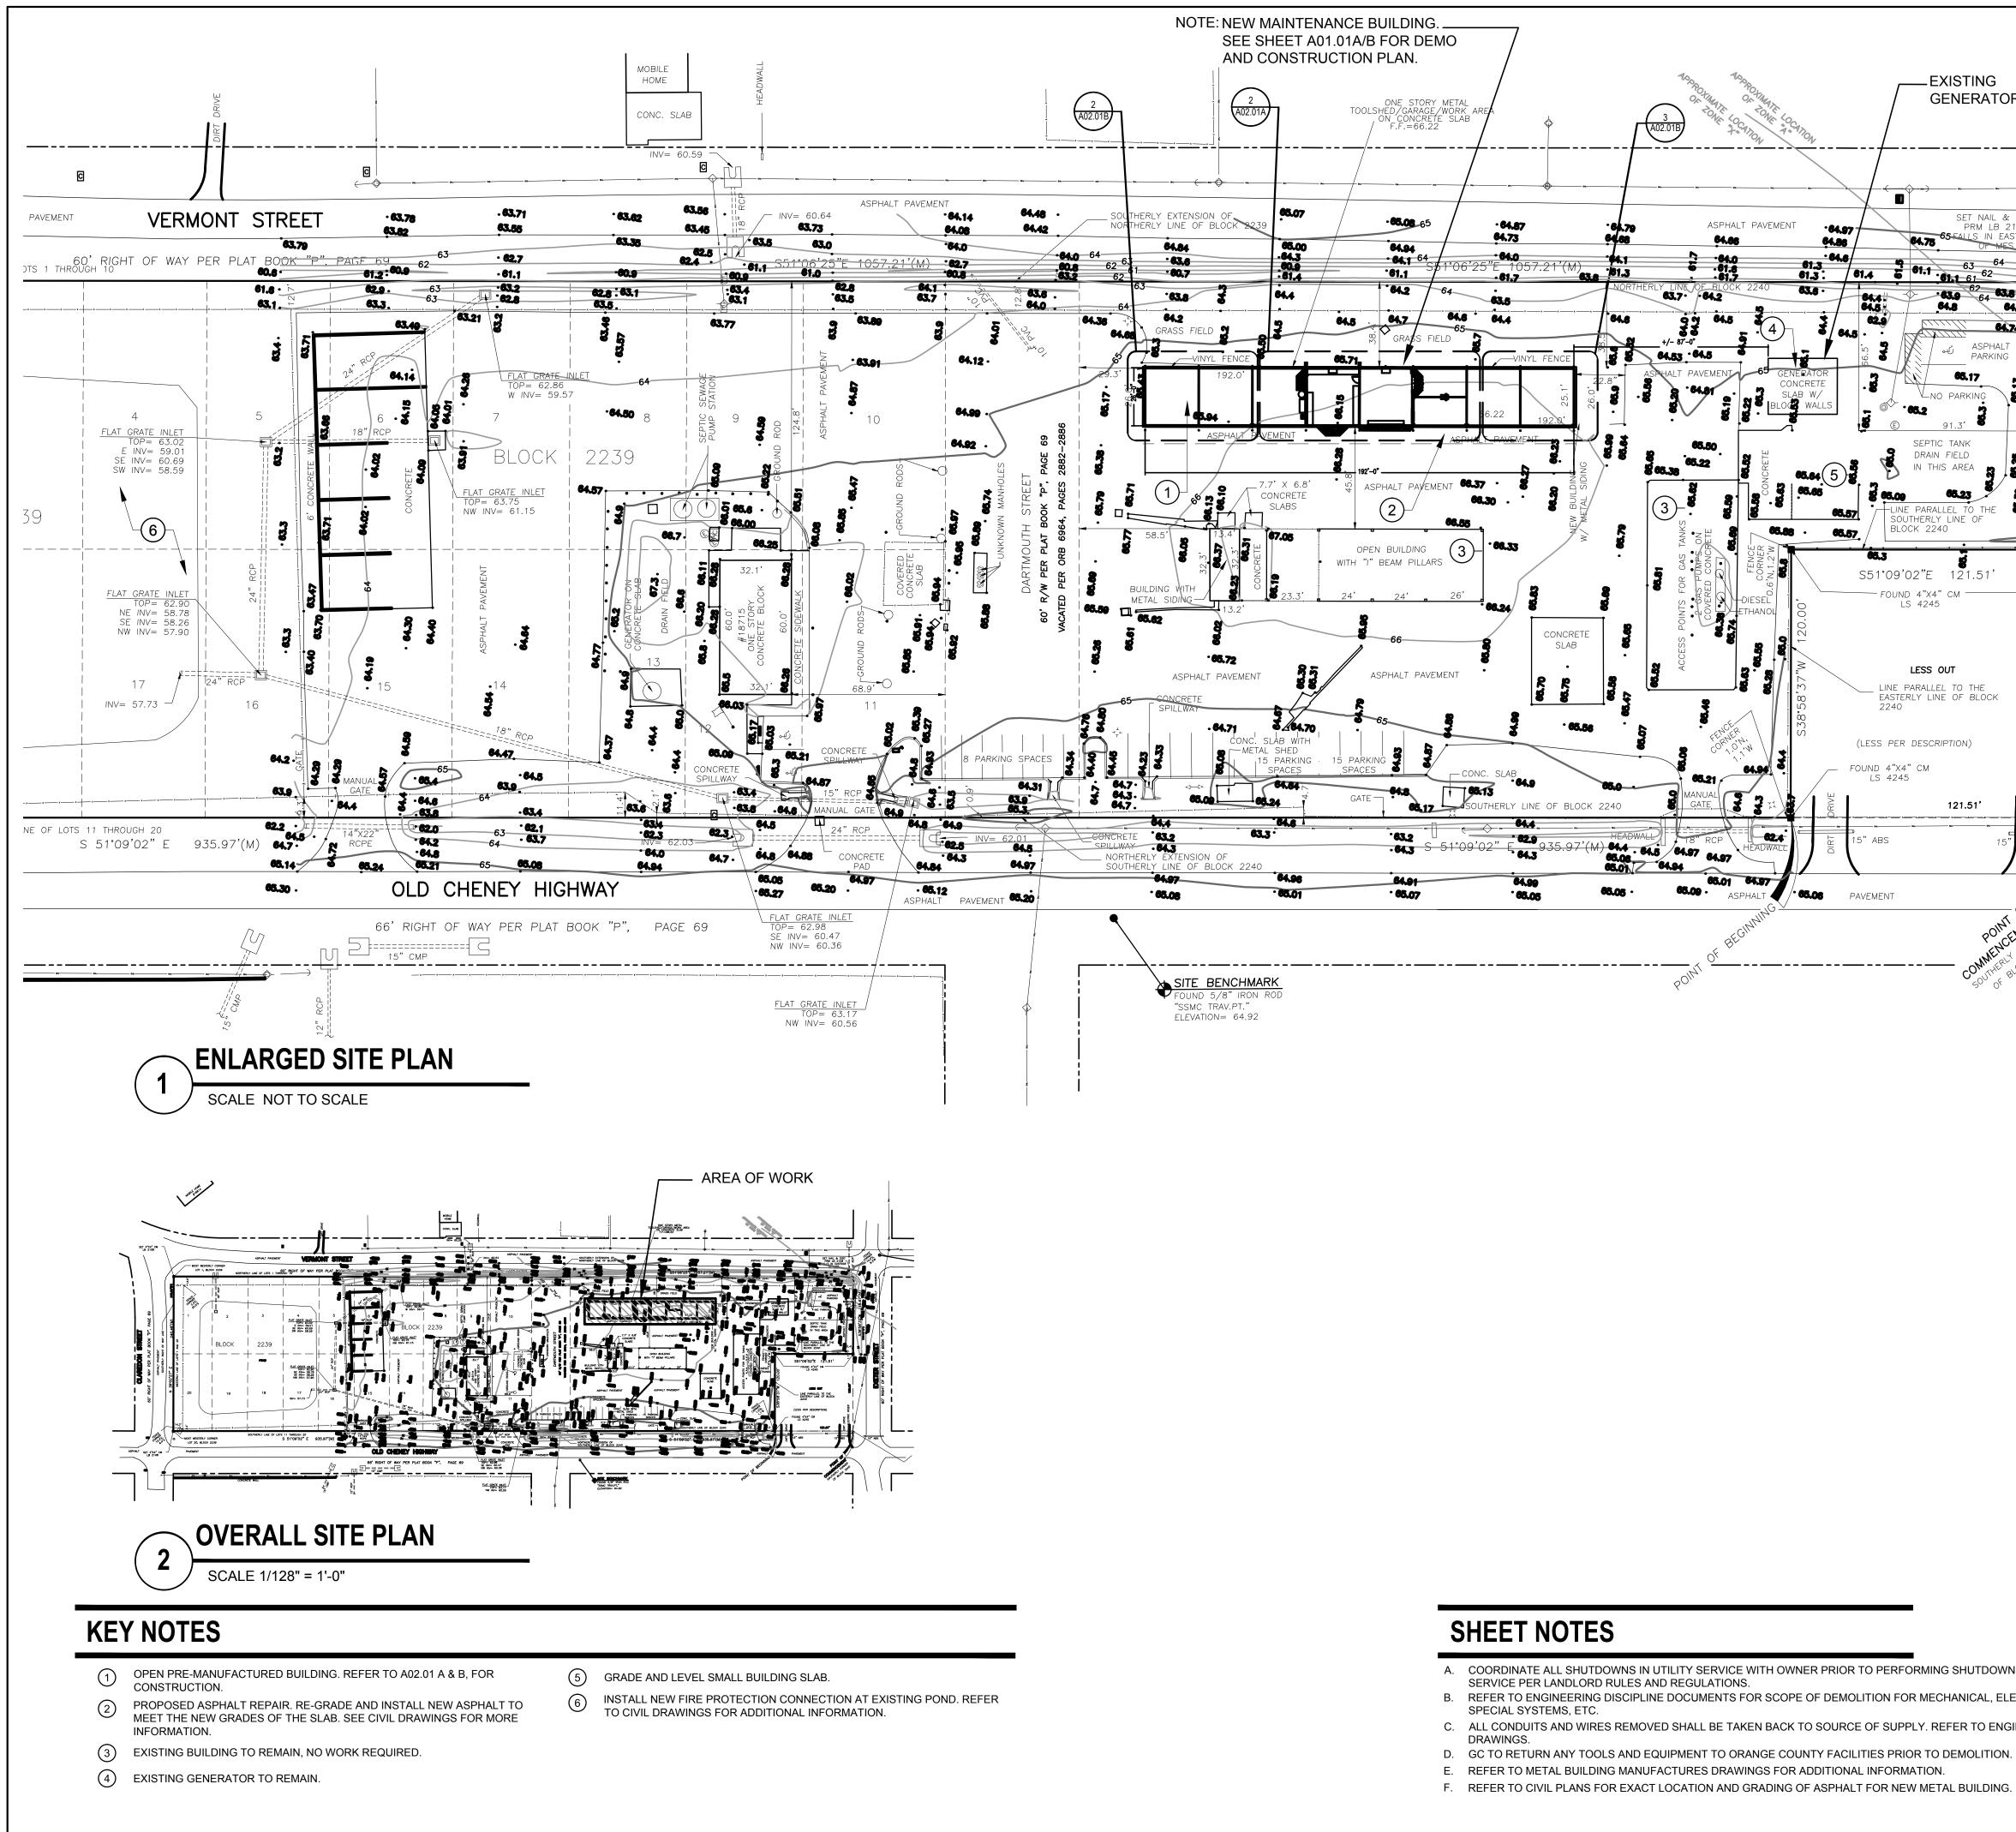
GENERAL DETAILS





- flood hazard Zones "X" and

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0, according to the plat thereof as recorded in Plat Book P, Page 69 of the Public Records of	Consultant • Seal/Signature	٦
of said Block 2240, BITHLO as per plat thereof as recorded in Plat Bock P, Page 69 said Public the Easterly line of said Block 2240, 120 feet, thence run Northwesterly parallel to the Southerly Southwesterly parallel to the Easterly line of said Block 2240, 120 feet to the Southerly line of ong said Southerly line of said Block 2240, 121.50 feet to the POINT OF BEGINNING. If Dartmouth Street lying Southeasterly of Block 2239 and Northwesterly of Block 2240 and let of Old Cheney Highway.		
named on field location of markings by Utility Company representatives, surface features and inveyor. Additional sub—surface utilities may exist that have not been field located. Far on recorded plane or that have been furnished to the surveyor or by others have been propriate notation. Other easements may be discovered by a search of the Public Records. urvey meet MINIMUM TECHNICAL STANDARDS FOR LAND SURVEYING CH. 61G17—6 requirements. Hered seal of a Florida licensed Surveyor and Mapper.		
d in the legend are not to ecole. the North right of way line of Old Cheney Highway, being \$51°09'02"E, and based on GIS Points Y. Program FIRM Map No. 12095C 0315E, dated 12/06/2000, the above described property is within "A". tains horizontal positions for all features shown relative to State Plane Coordinates '83/'90. nefit of an abstract, title search, title opinion or title insurance. A title search may reveal root as shown. ree in the immediate violnity of the above described parcel boundary have been located. cimals thereof. 239,258 square feet or 5.403 acres more or less.	Sheet Title: ARCHITECTURAL SITE PLAN EXISTING	
are to Orange County Datum, Benchmark No. S—417—045, "X" out top W. end concrete headwall, 50, 800'± E. of Exeter Street (at creek). Elevation = 64.972 (NGVD29). ic utilities. n field.	A00.50A	
lividuals shown on the face thereof. Any other use, benefit or reliance by any other party is strictly is responsible only to those certified and hereby disclaims any other liability and hereby restricts the m to use this survey, without express written consent of the surveyor.		




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D. GC TO RETURN ANY TOOLS AND EQUIPMENT TO ORANGE COUNTY FACILITIES PRIOR TO DEMOLITION.
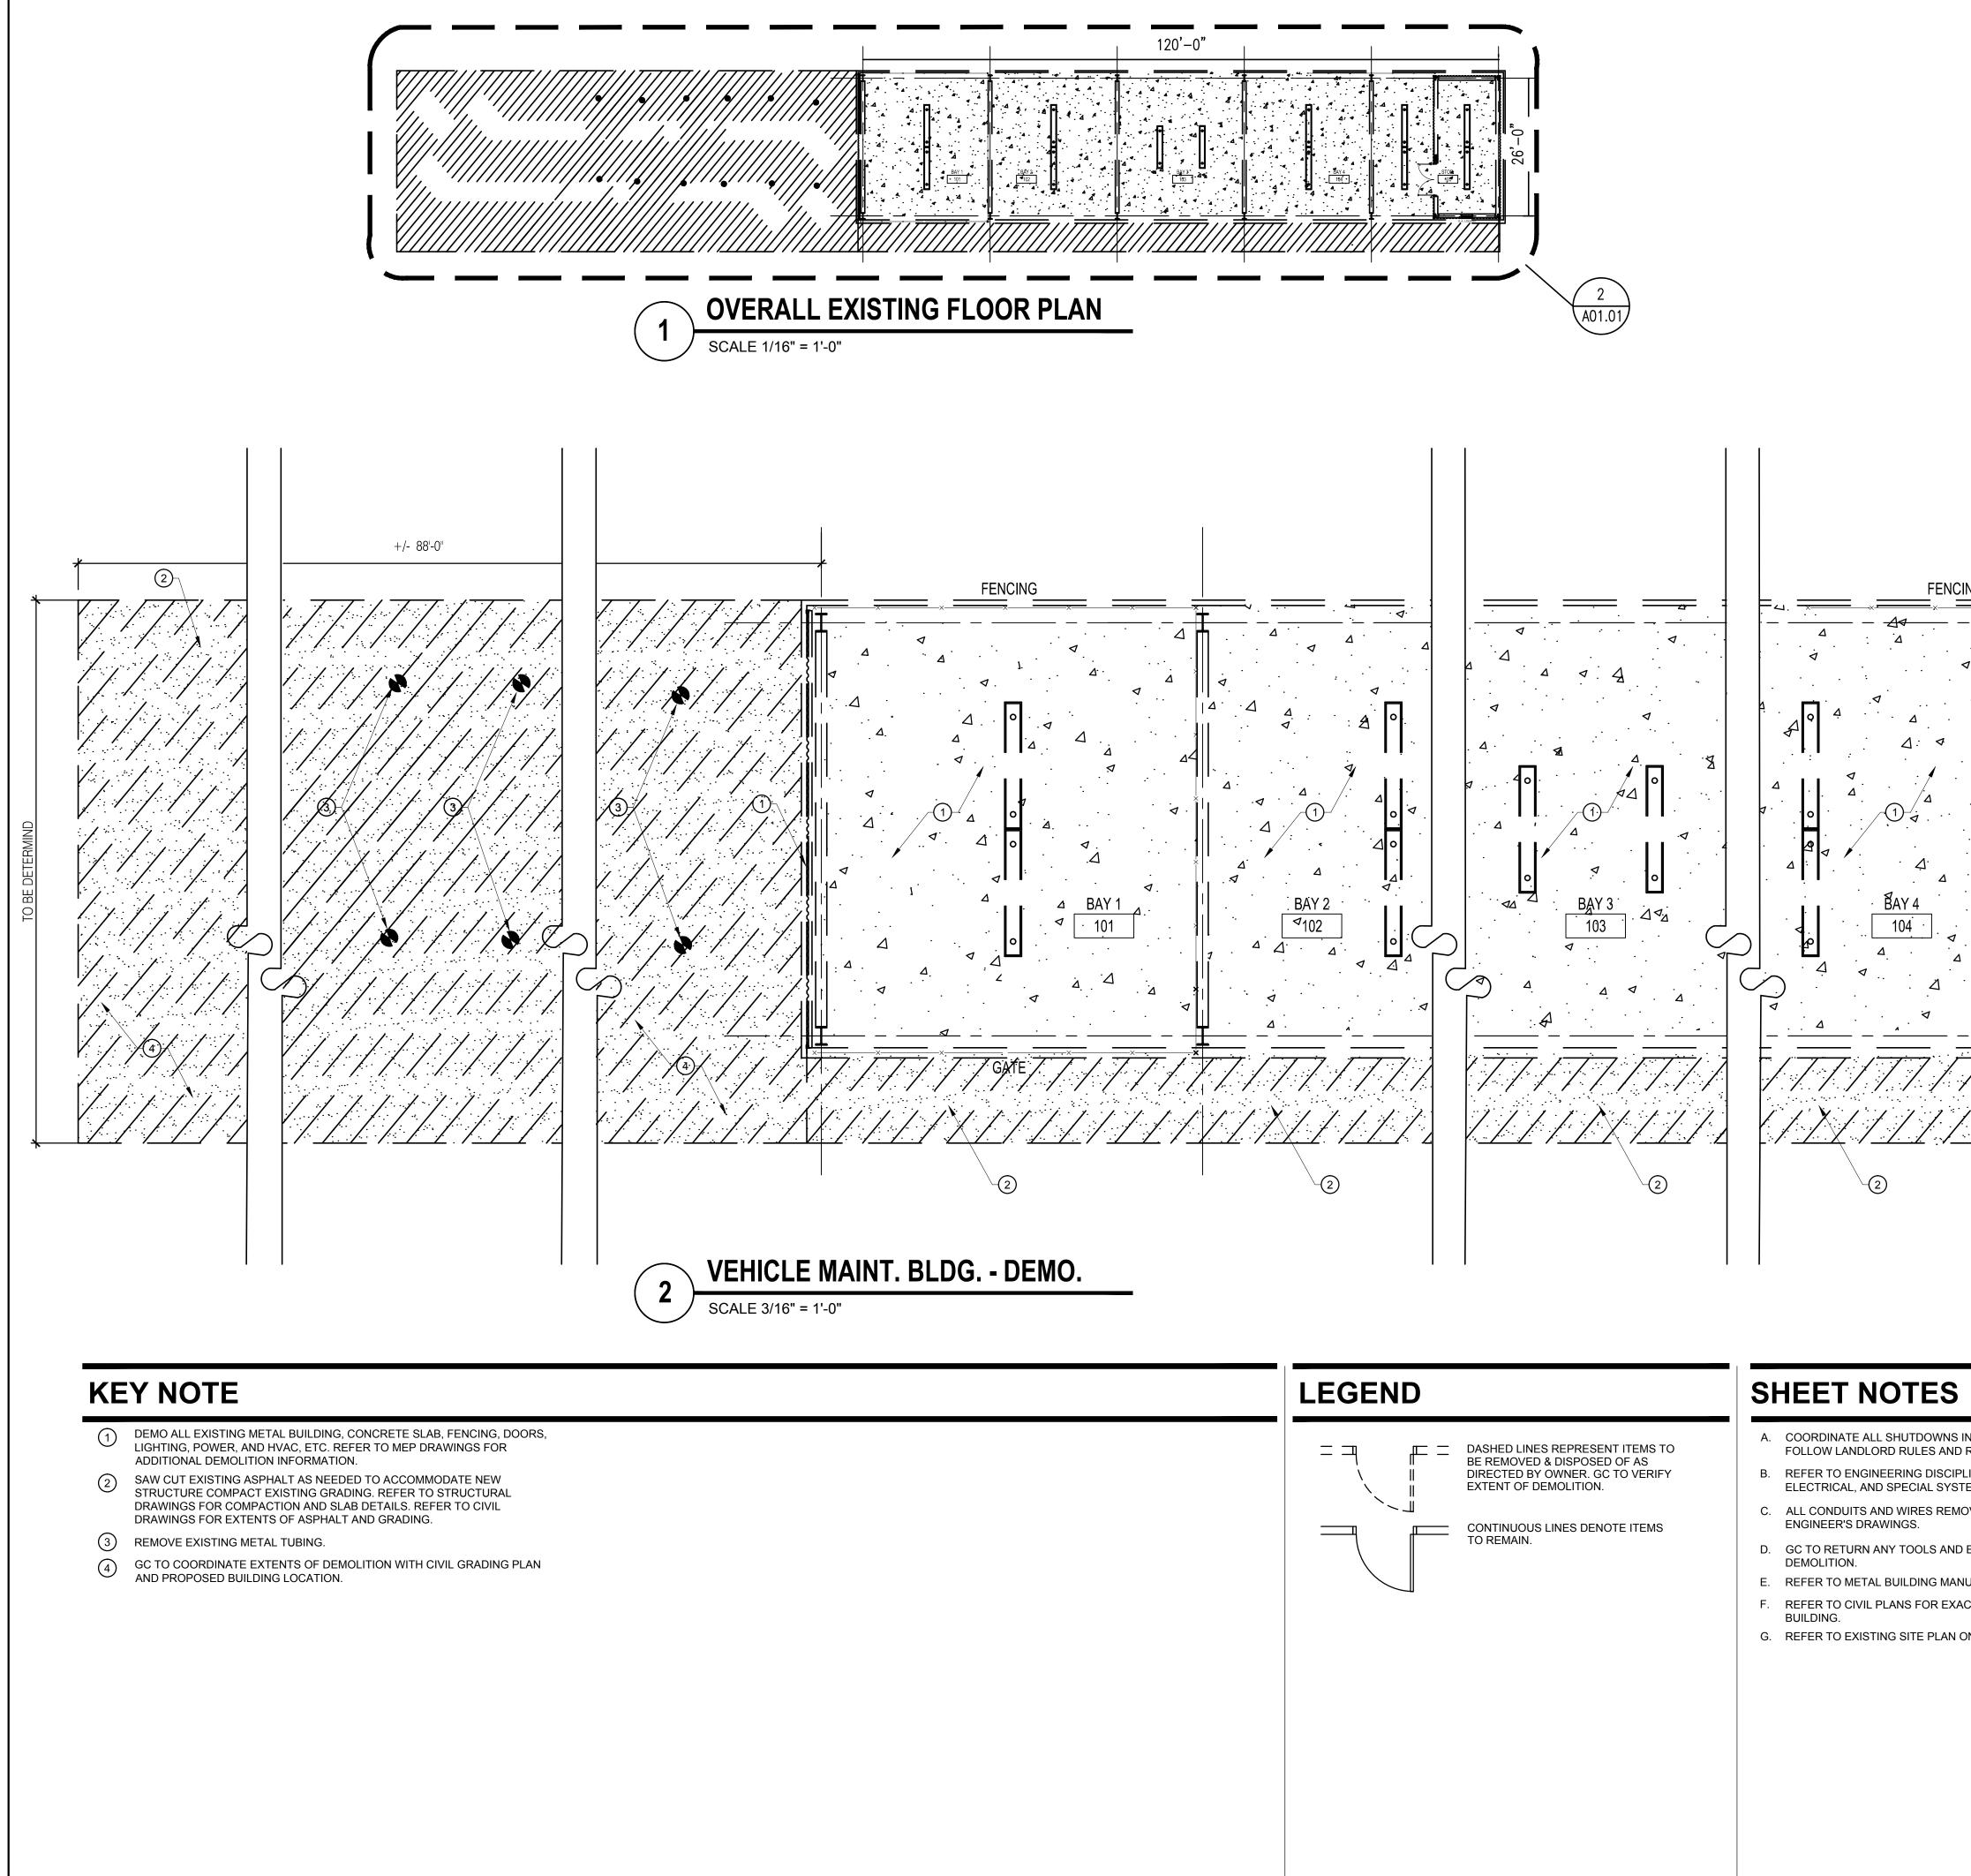
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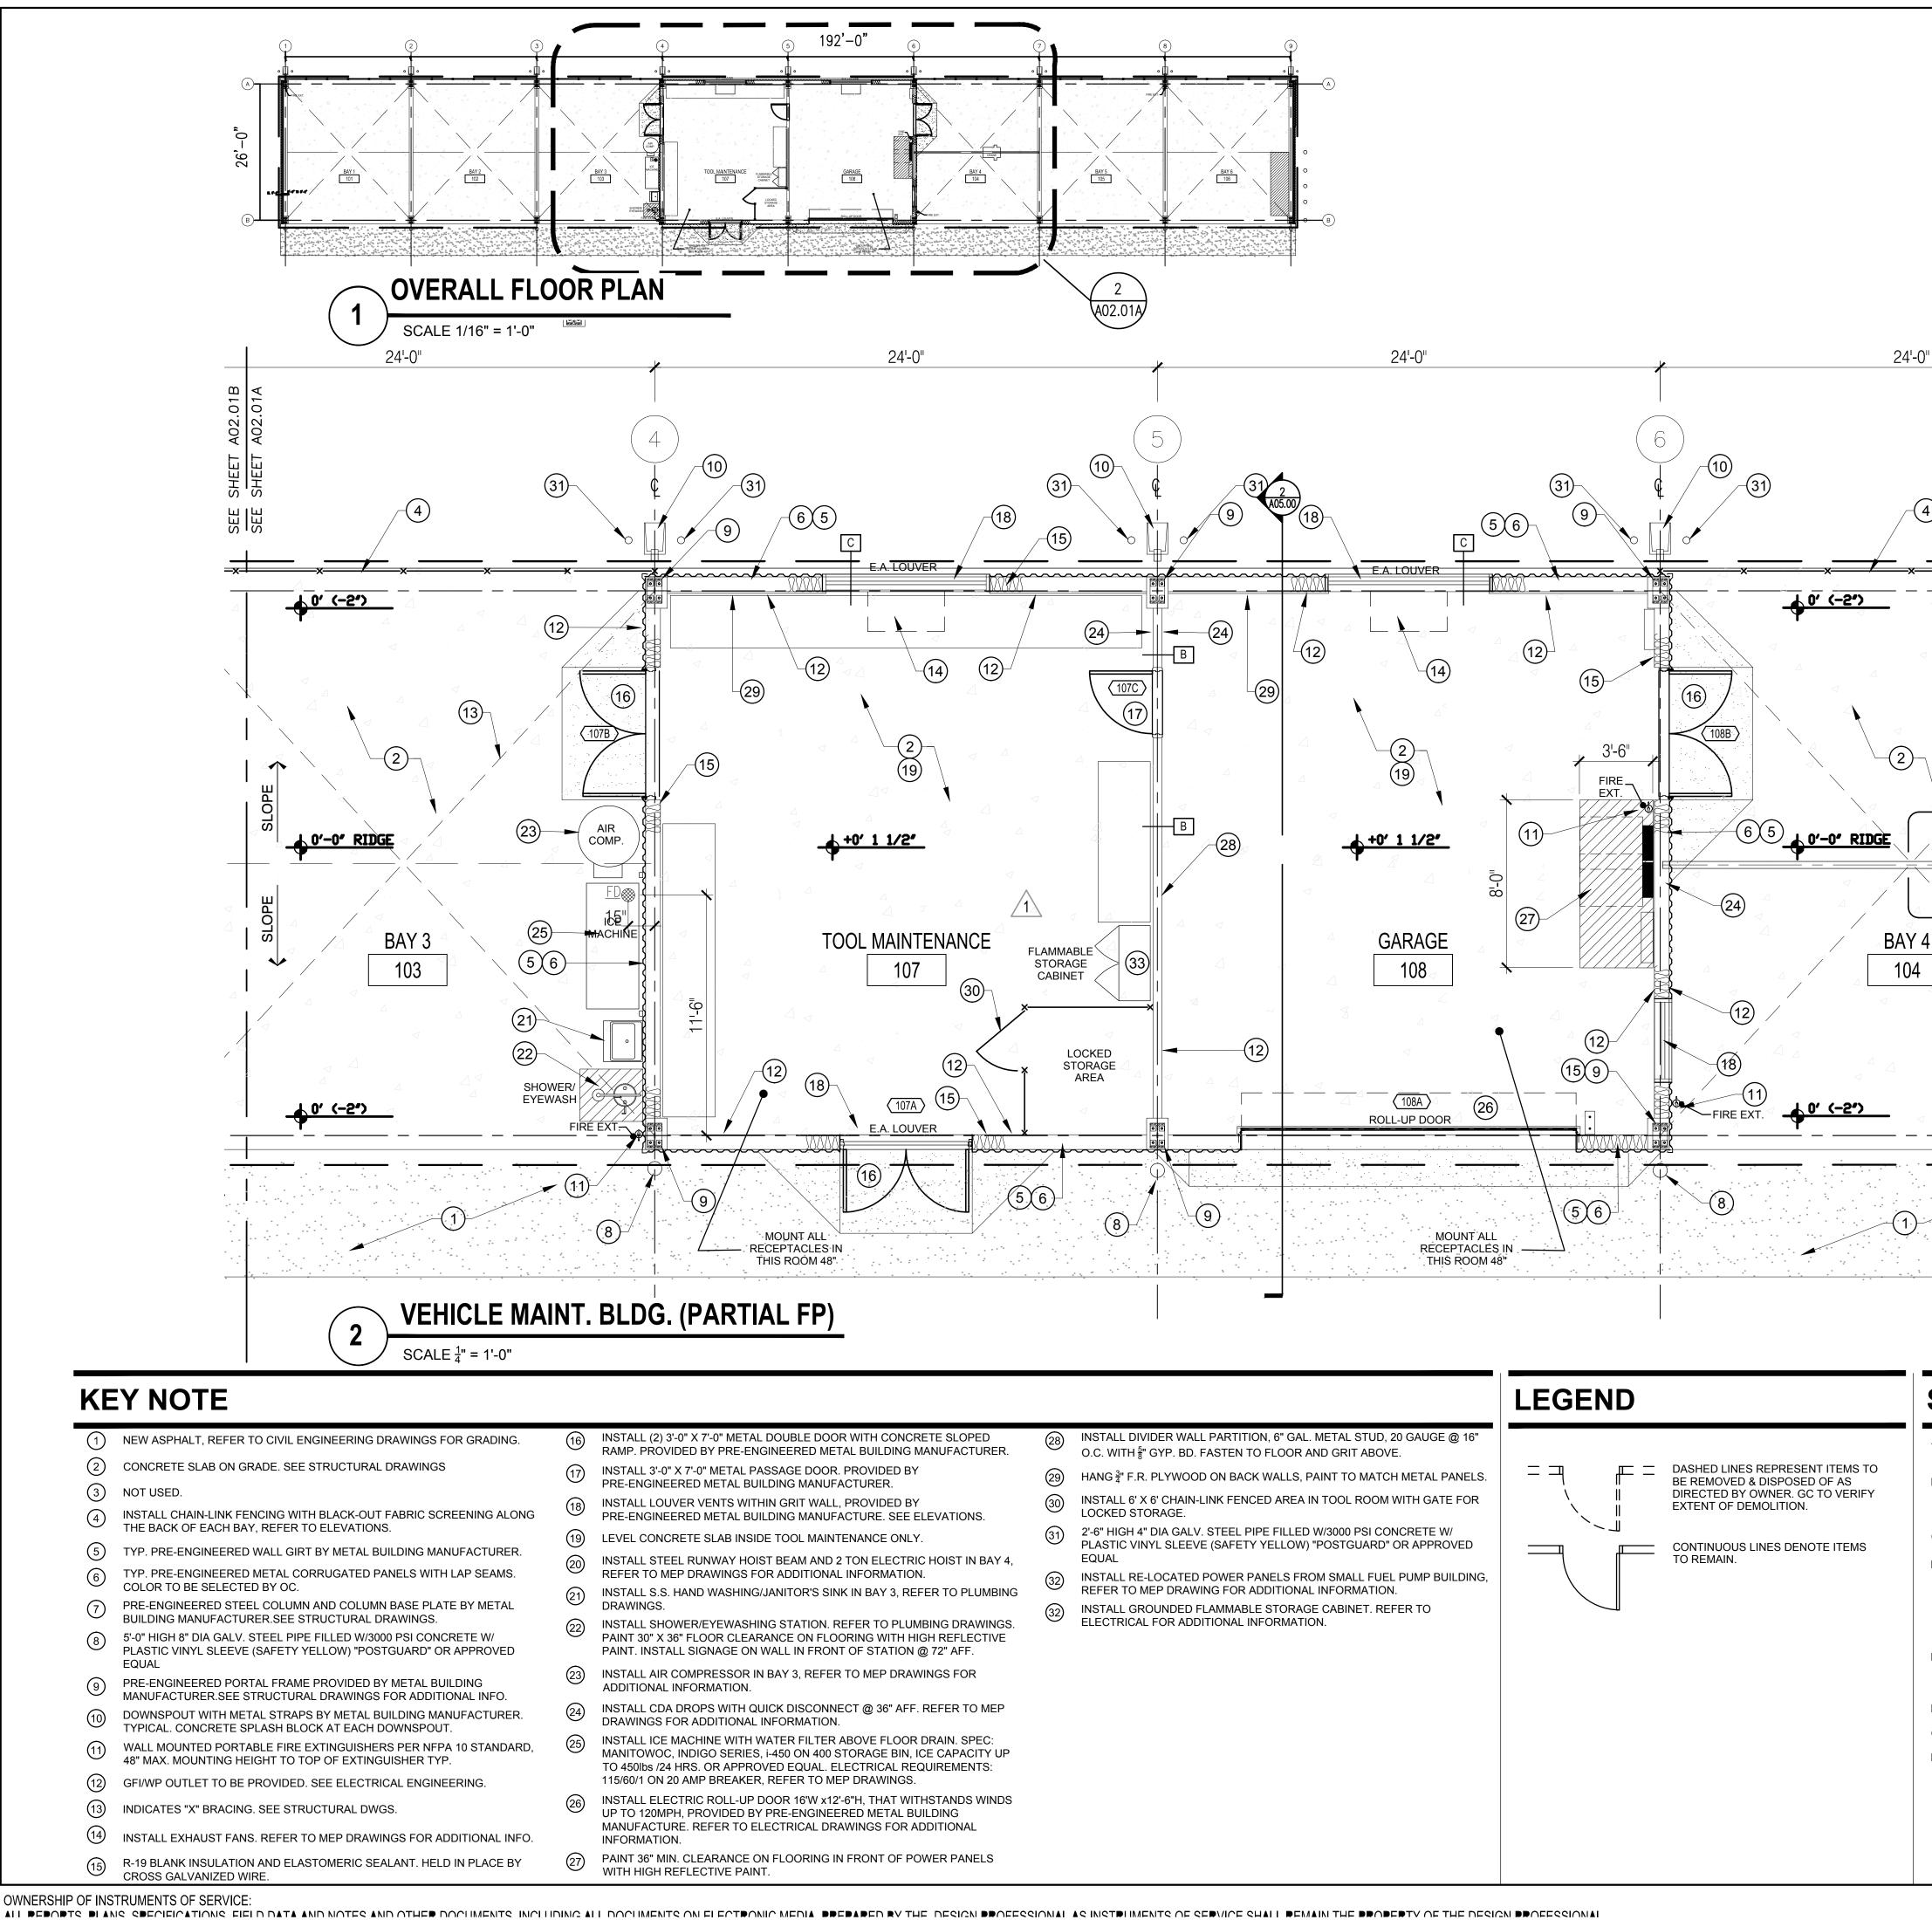


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SHEET NOTES		
A. NEW PRE-ENGINEERED METAL BUILDING WITH (6) @ 24'-0" X 26'-0" BAYS, TOOL MAINTENANCE AND GARAGE. BUILDING BY METAL BUILDING MANUFACTURER.		
B. CONCRETE SLAB FOR PRE-ENGINEERED BUILDING: 6" THICK REINFORCED CONCRETE SLAB WITH CONTROL JOINTS AND BEARING PADS AS REQUIRED. SEE STRUCTURAL ENGINEERING DRAWINGS.		
C. INSTALL CONCRETE FILLED BOLLARDS TO PROTECT COLUMNS		


- D. FOR THE PURPOSES OF THIS DRAWING IT IS ASSUMED THAT THE OUTSIDE EDGE OF THE BOTTOM TRACK OF THE EXTERIOR METAL SIDING ASSEMBLY AND THE CONCRETE SLAB EDGE ARE IN THE SAME PLANE. A FINAL DETERMINATION OF THE DIMENSIONS AND/OR LOCATION OF THE CONCRETE SLAB EDGE AND DETAILS FOR CONNECTION OF THE EXTERIOR ASSEMBLY HAS TO BE COORDINATED WITH THE FINAL DRAWINGS FROM THE METAL BUILDING MANUFACTURER.
- E. PRE-ENGINEERED BUILDING TO MEET FLORIDA PRODUCT APPROVALS. METAL BUILDING MANUFACTURER SHALL PROVIDE SIGNED AND SEALED DRAWINGS BY A REGISTERED ENGINEER IN THE STATE OF FLORIDA.
- F. REFER TO DOOR SCHEDULE FOR ADDITIONAL INFORMATION.
- G. REFER TO STRUCTURAL FOR SLAB DETAILS.
- H. PROVIDE "Z" FLASHING AT ALL WINDOW, DOOR AND LOUVER OPENINGS.



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CONSTRUCTION PLAN



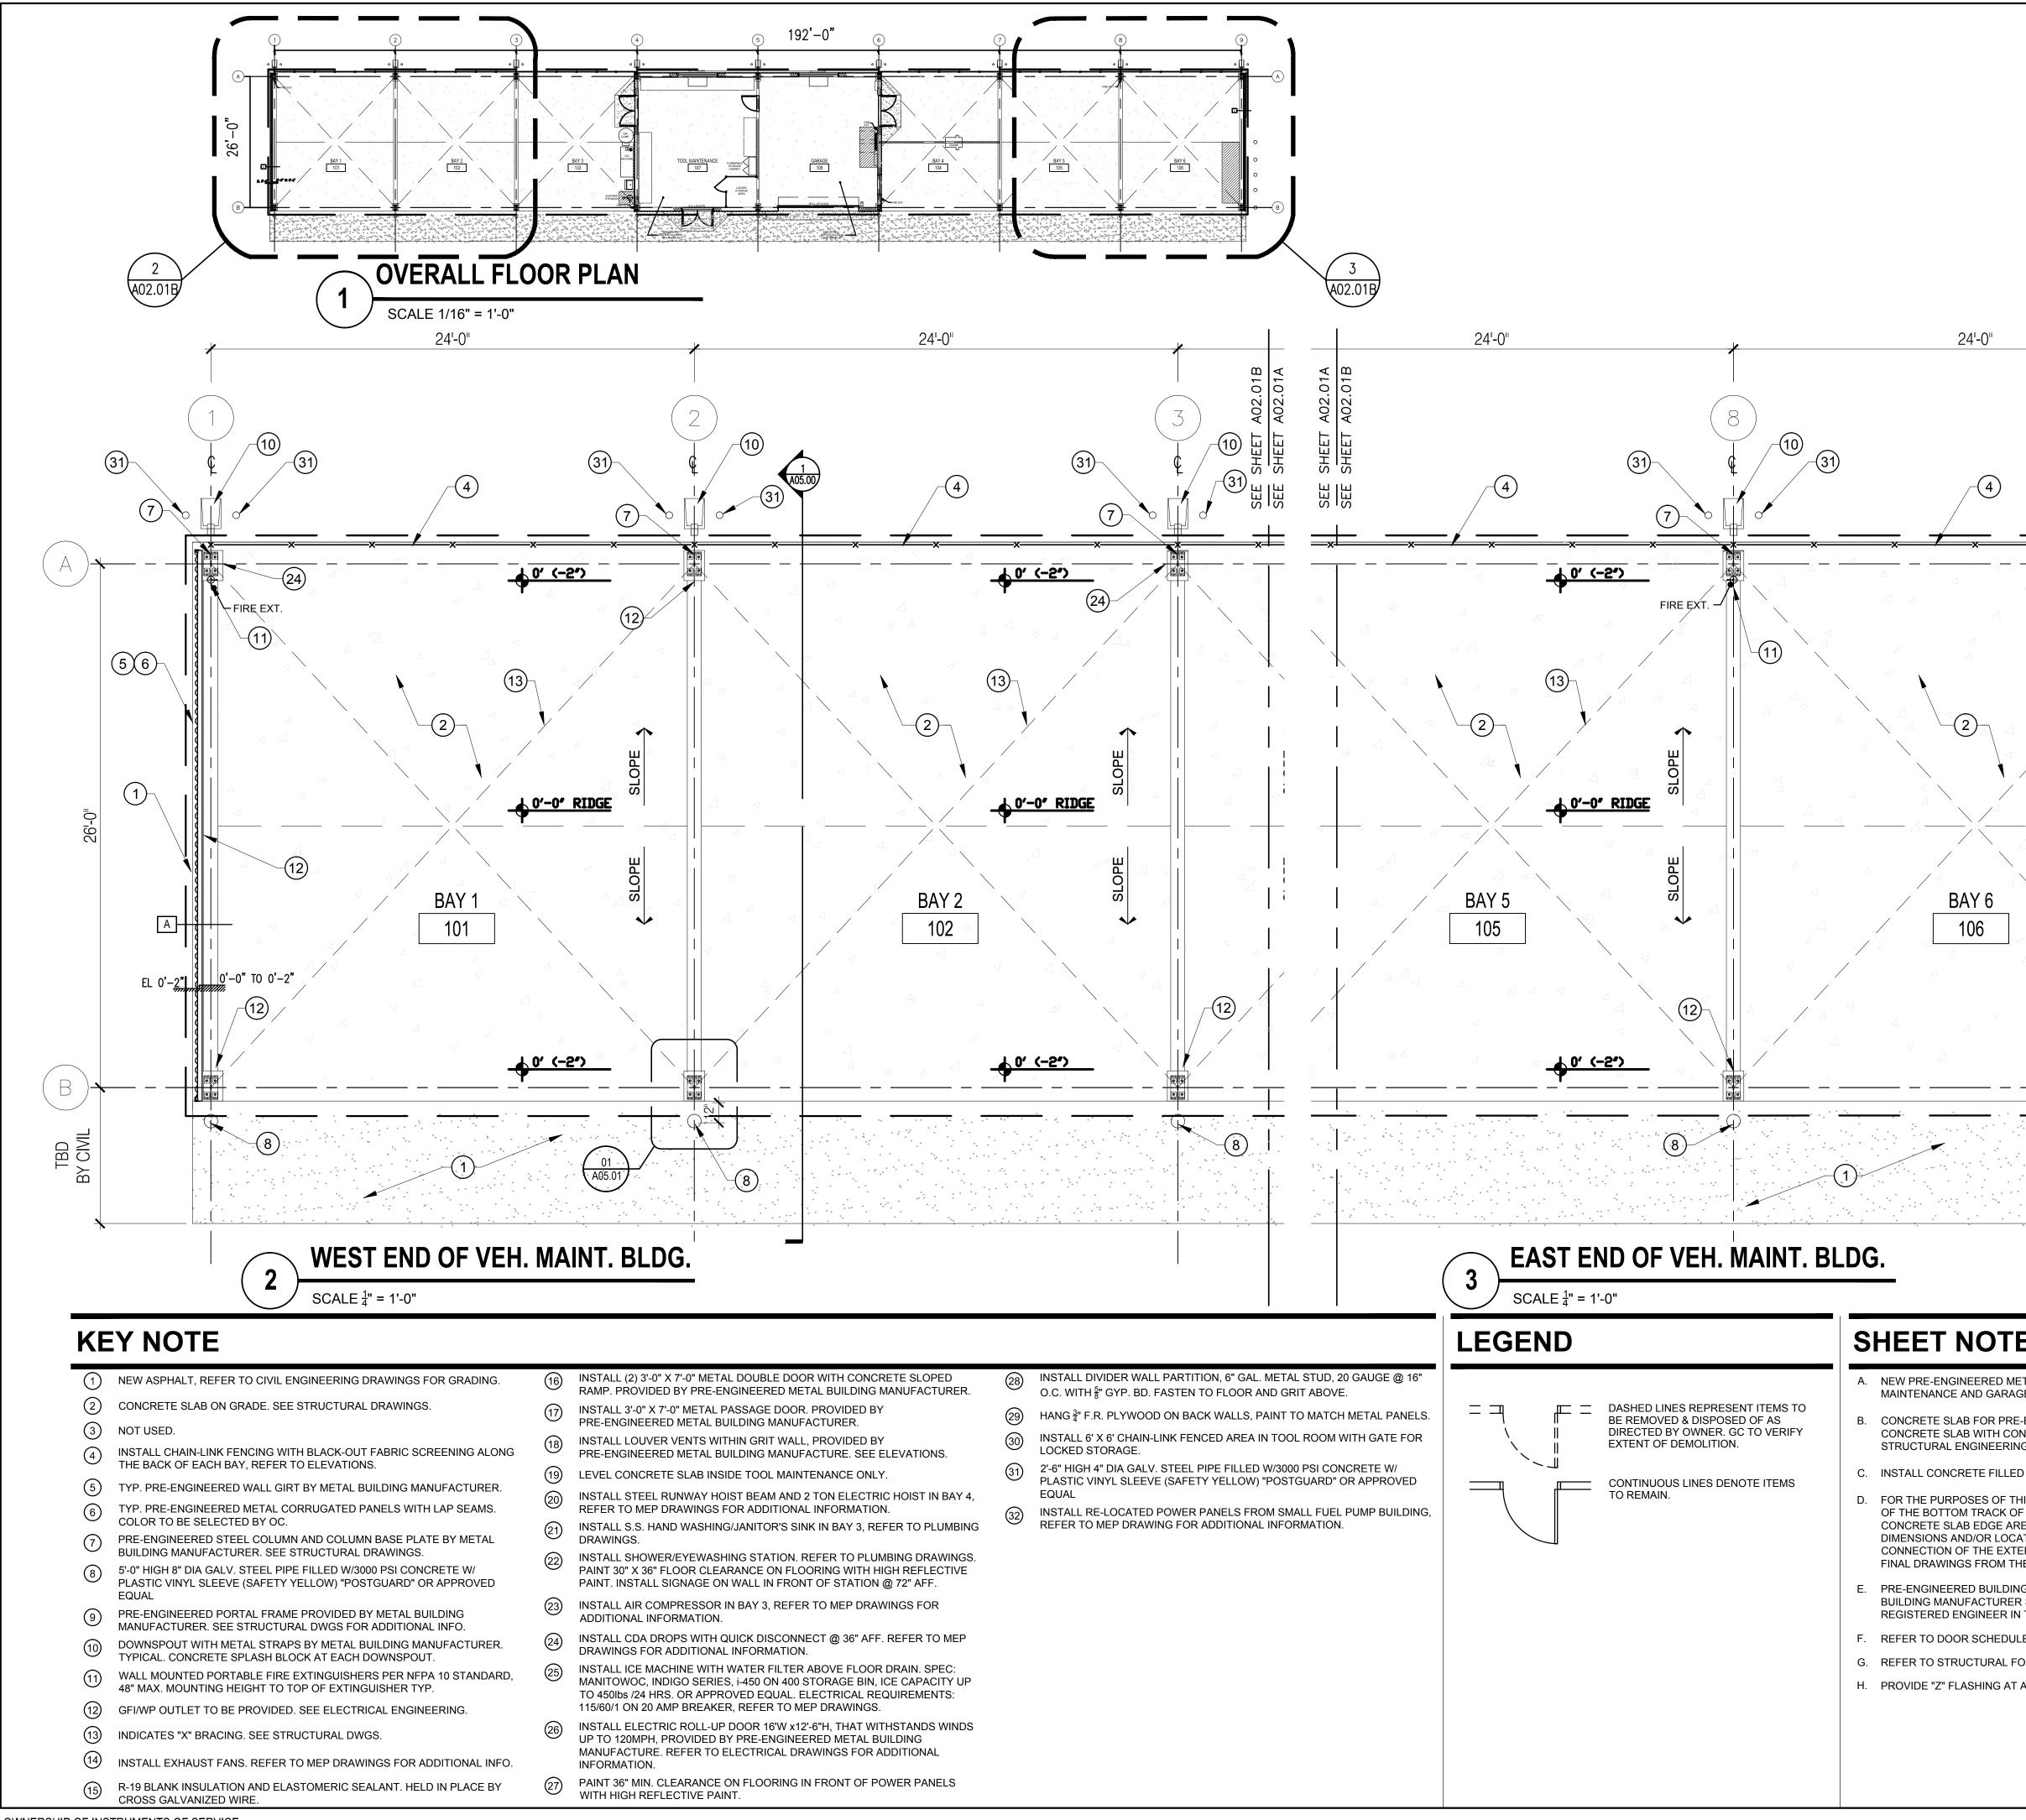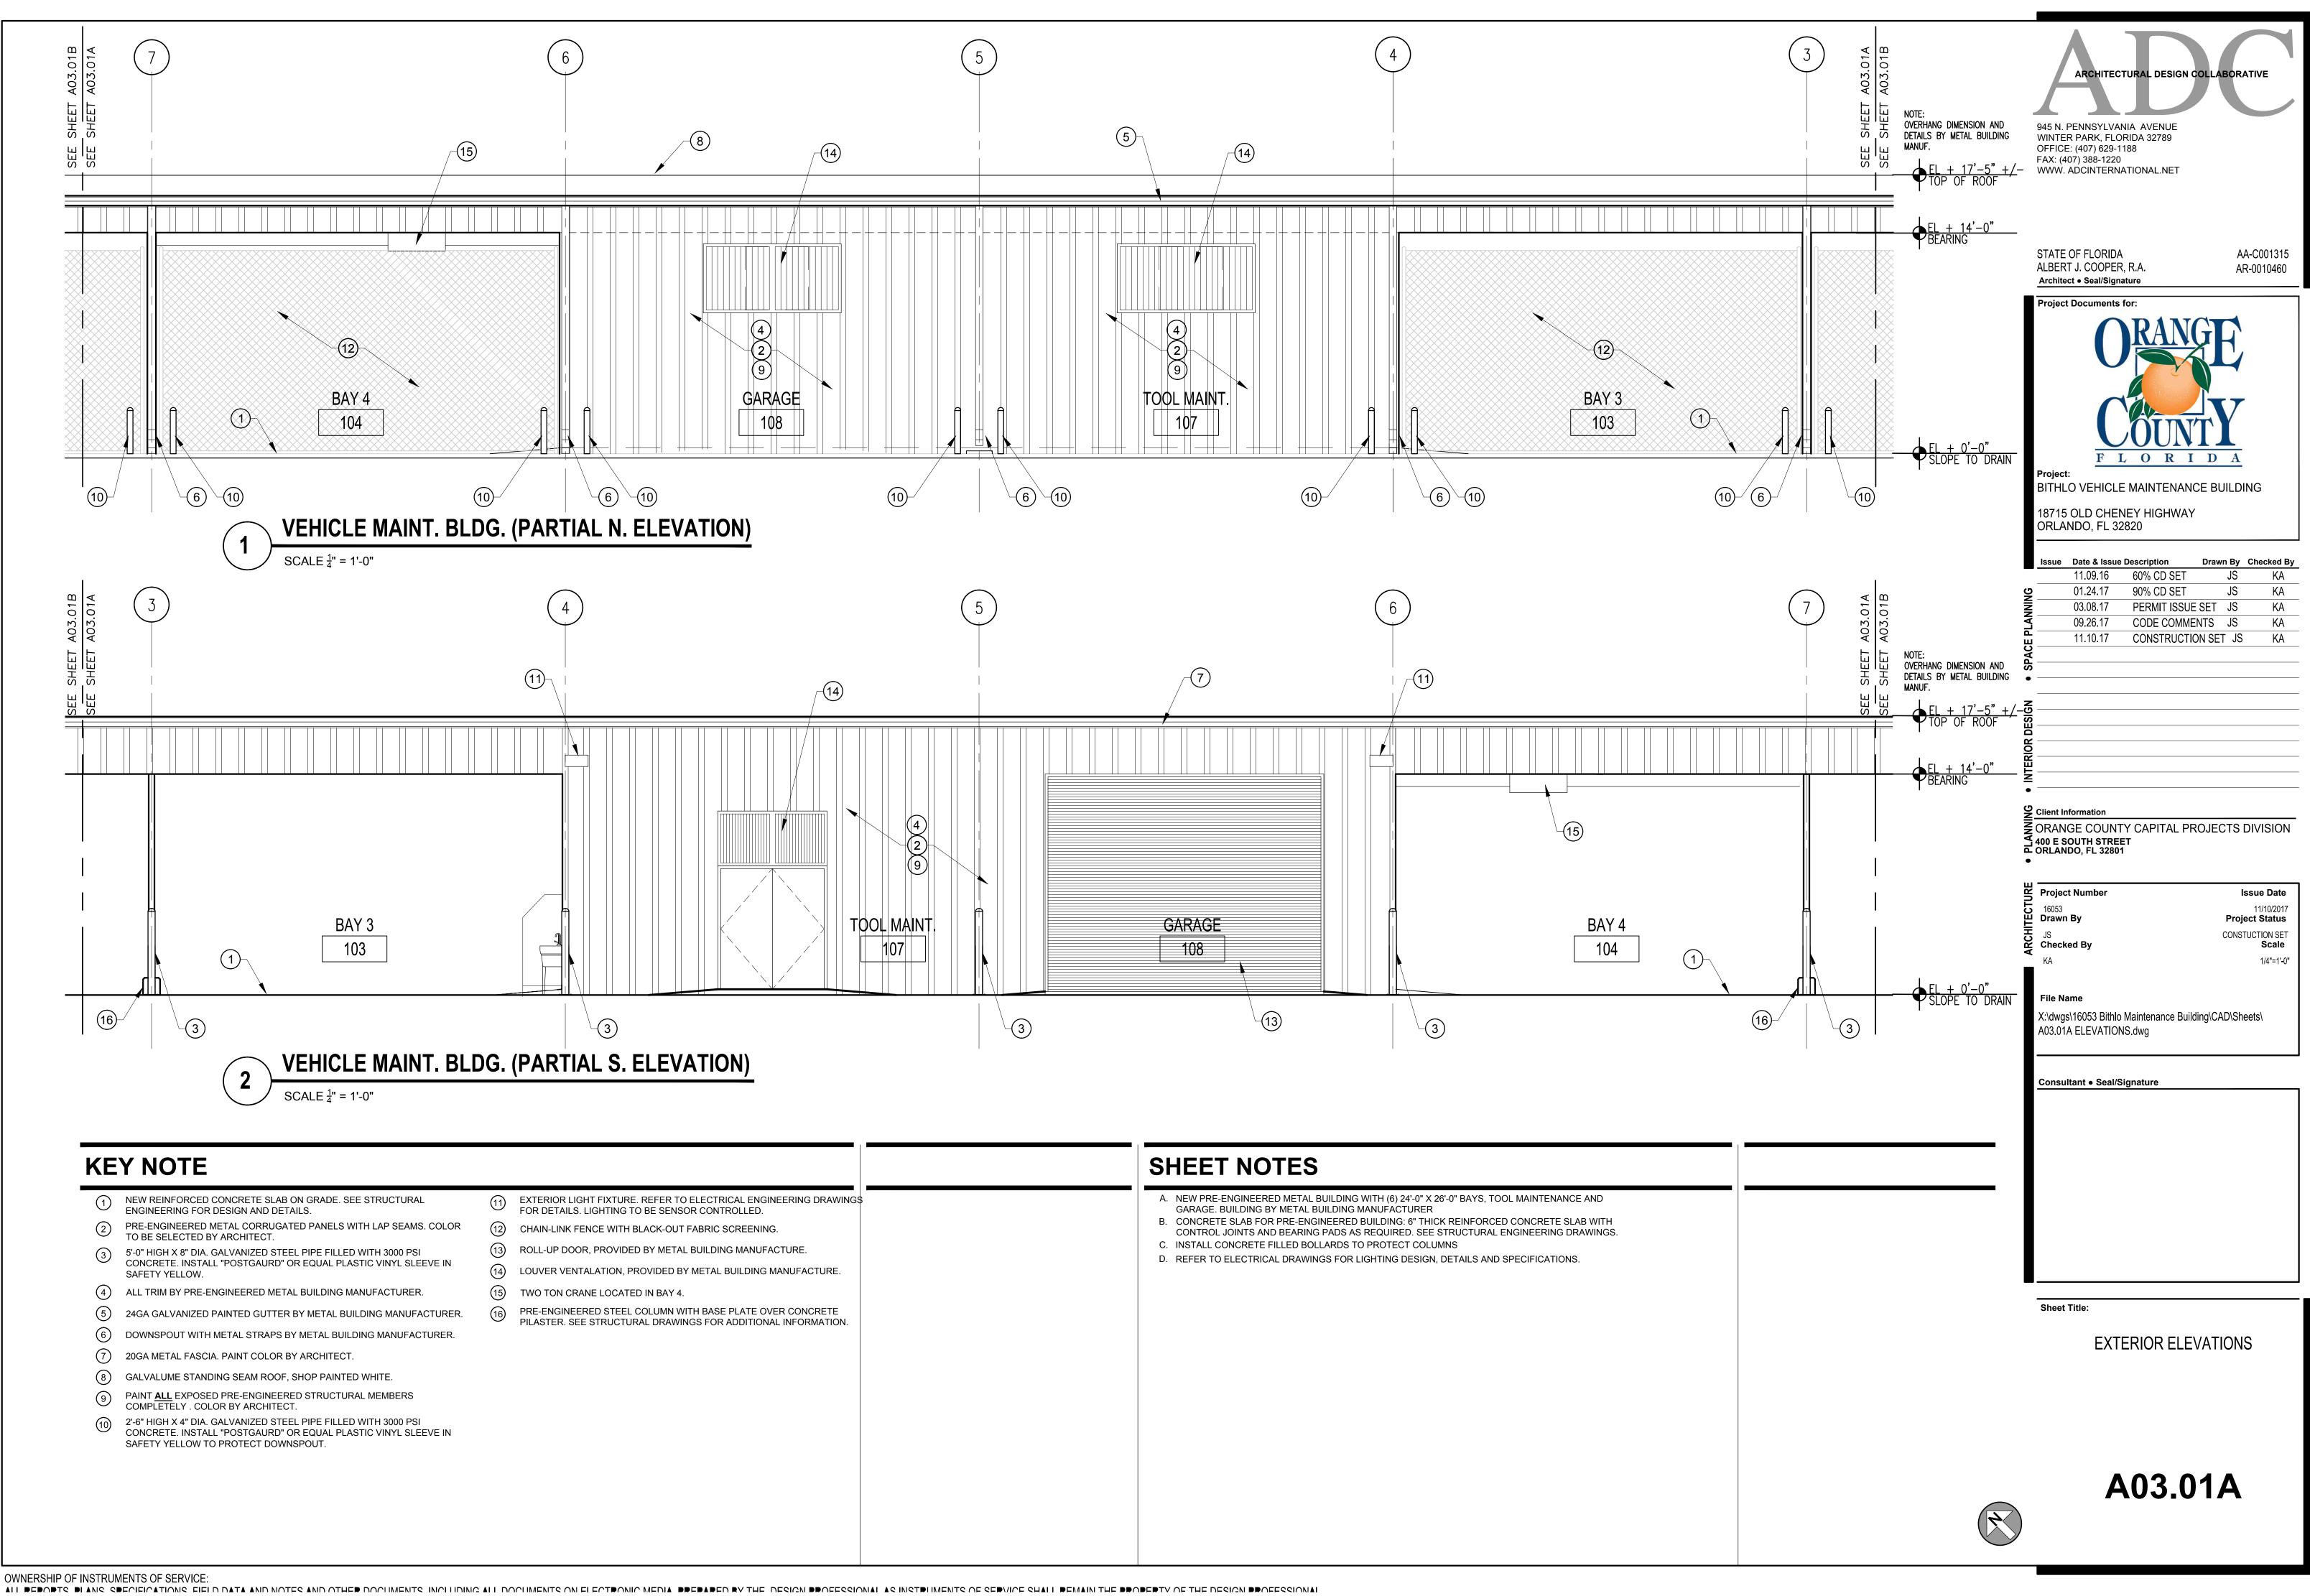
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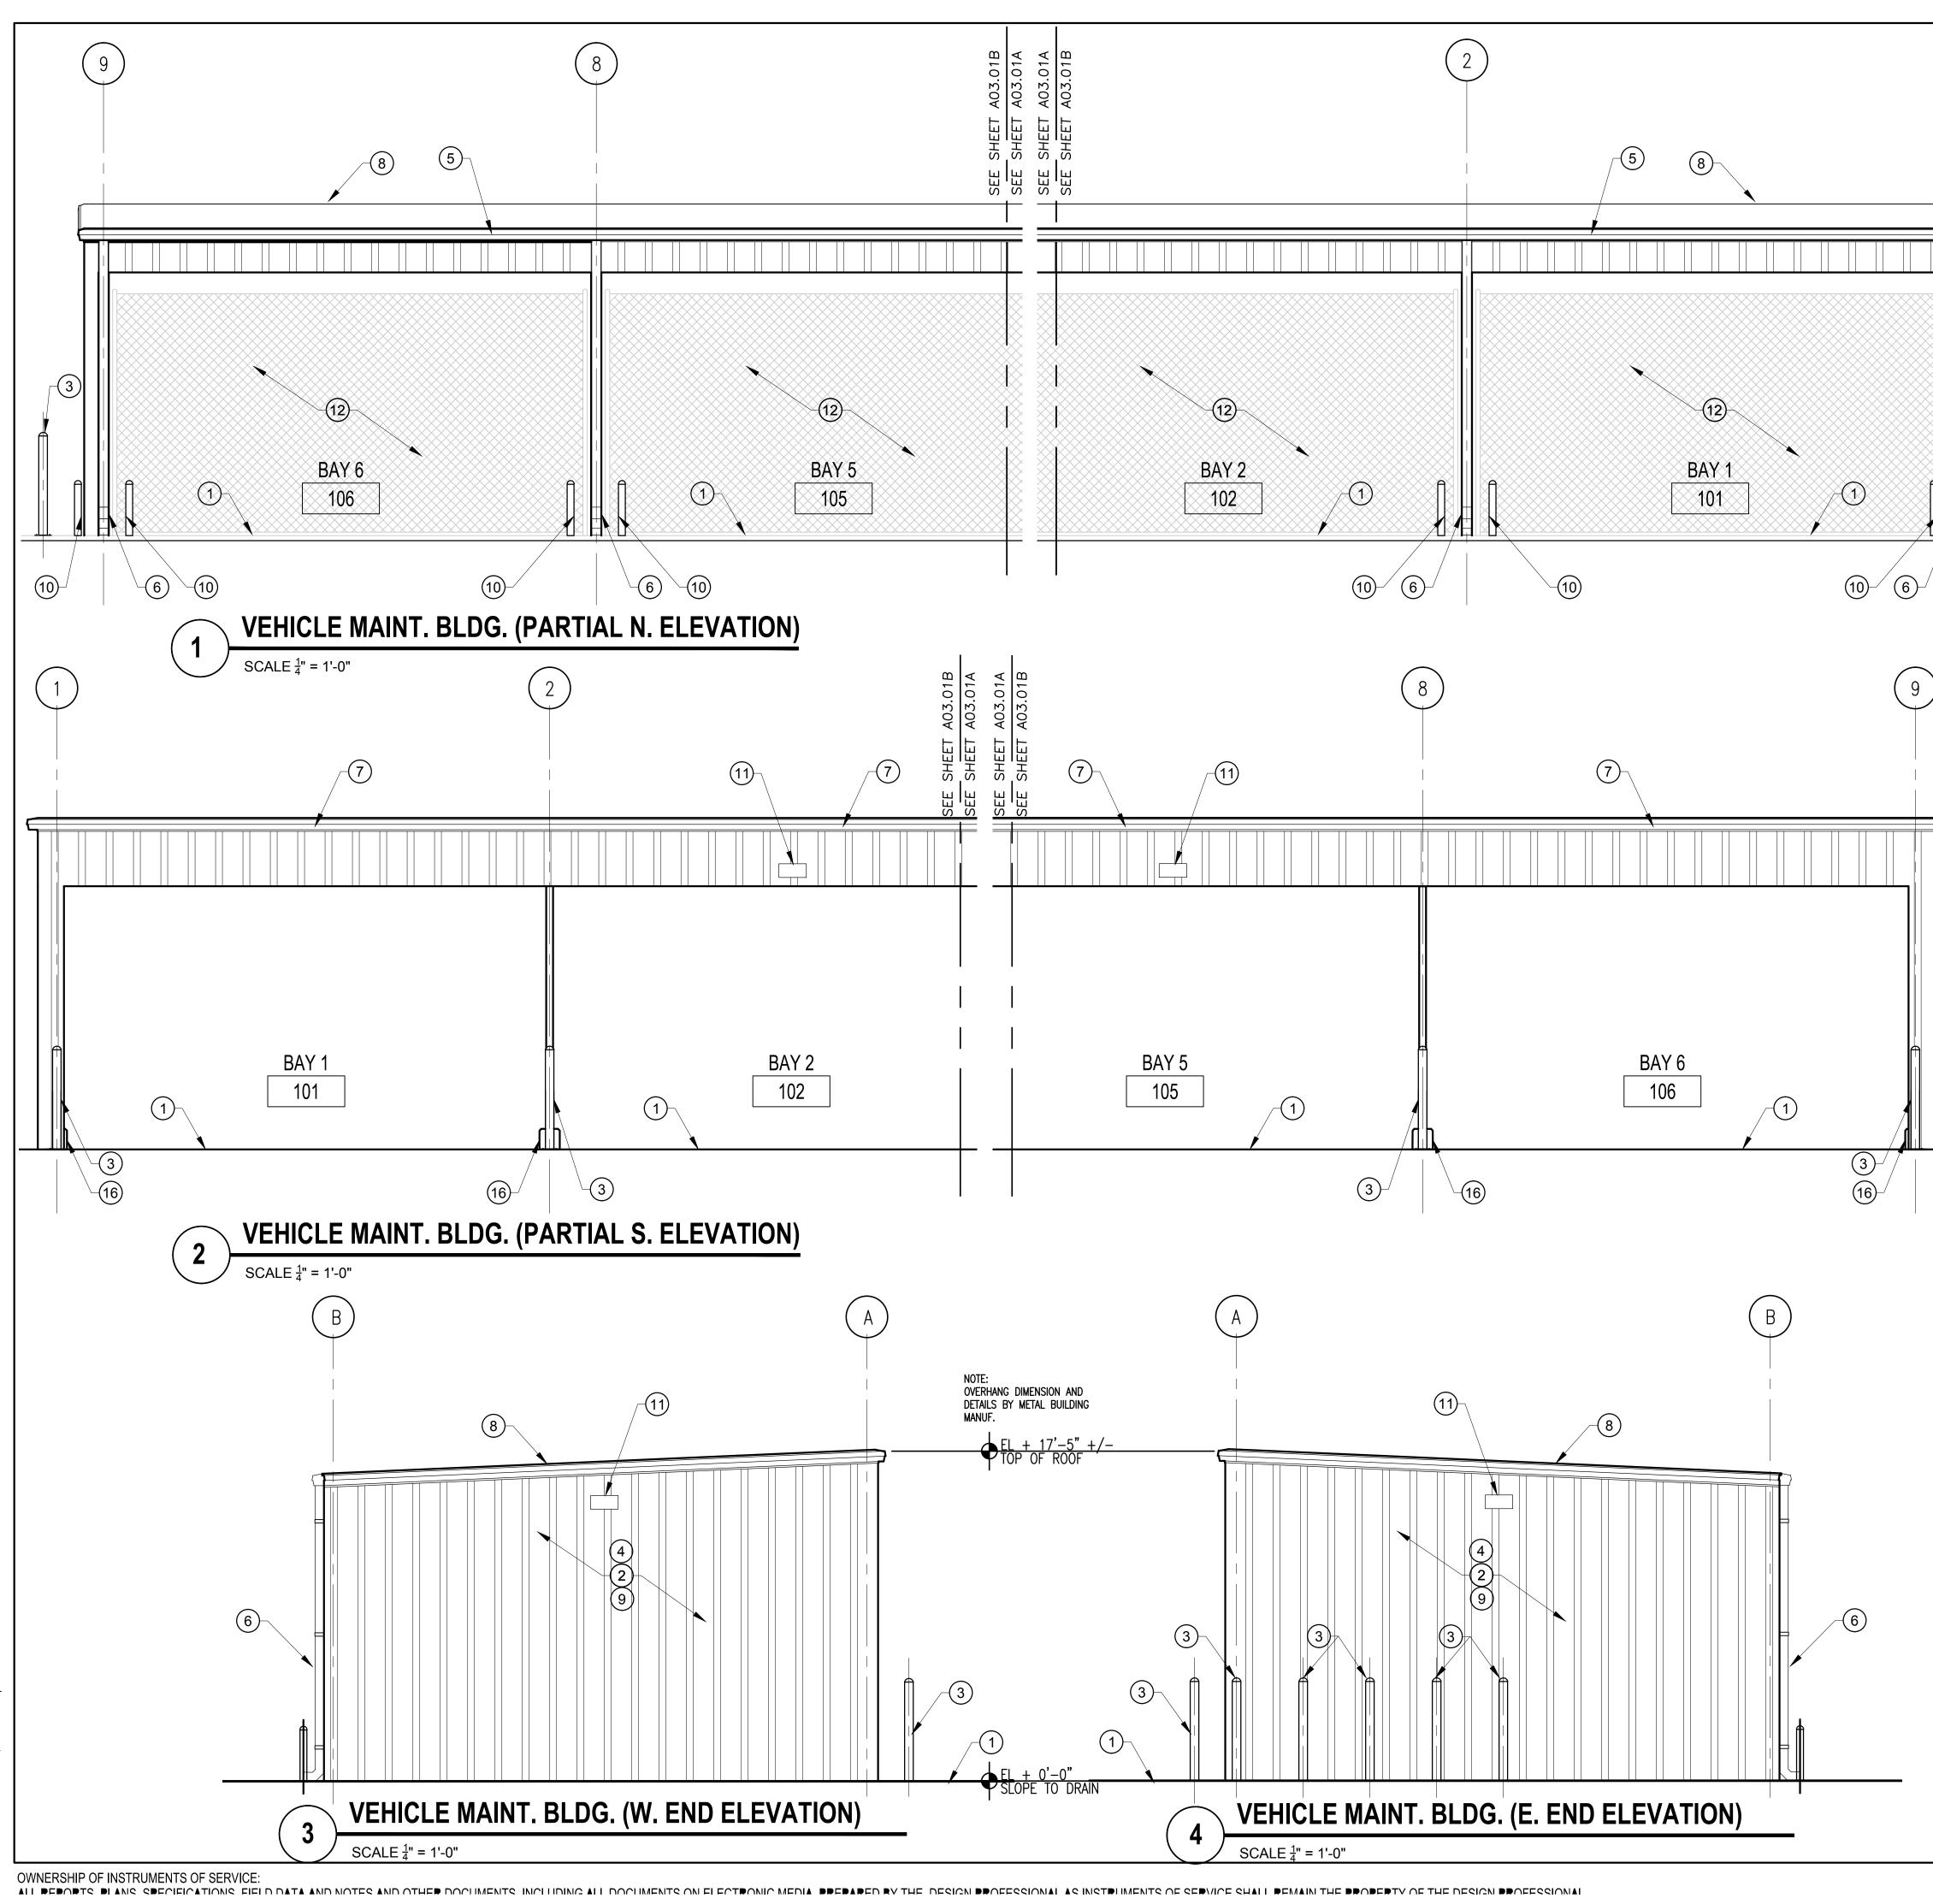
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STRUCTURAL ENGINEERING		
D. FOR THE PURPOSES OF THIS OF THE BOTTOM TRACK OF T CONCRETE SLAB EDGE ARE I DIMENSIONS AND/OR LOCATI CONNECTION OF THE EXTER	DRAWING IT IS ASSUMED THAT THE OUTSIDE EDGE THE EXTERIOR METAL SIDING ASSEMBLY AND THE N THE SAME PLANE. A FINAL DETERMINATION OF THE ON OF THE CONCRETE SLAB EDGE AND DETAILS FOR IOR ASSEMBLY HAS TO BE COORDINATED WITH THE METAL BUILDING MANUFACTURER.	Sheet Title: CONSTRUCTION PLAN
	TO MEET FLORIDA PRODUCT APPROVALS. METAL HALL PROVIDE SIGNED AND SEALED DRAWINGS BY A HE STATE OF FLORIDA.	
F. REFER TO DOOR SCHEDULEG. REFER TO STRUCTURAL FOR		

H. PROVIDE "Z" FLASHING AT ALL WINDOW, DOOR AND LOUVER OPENINGS.

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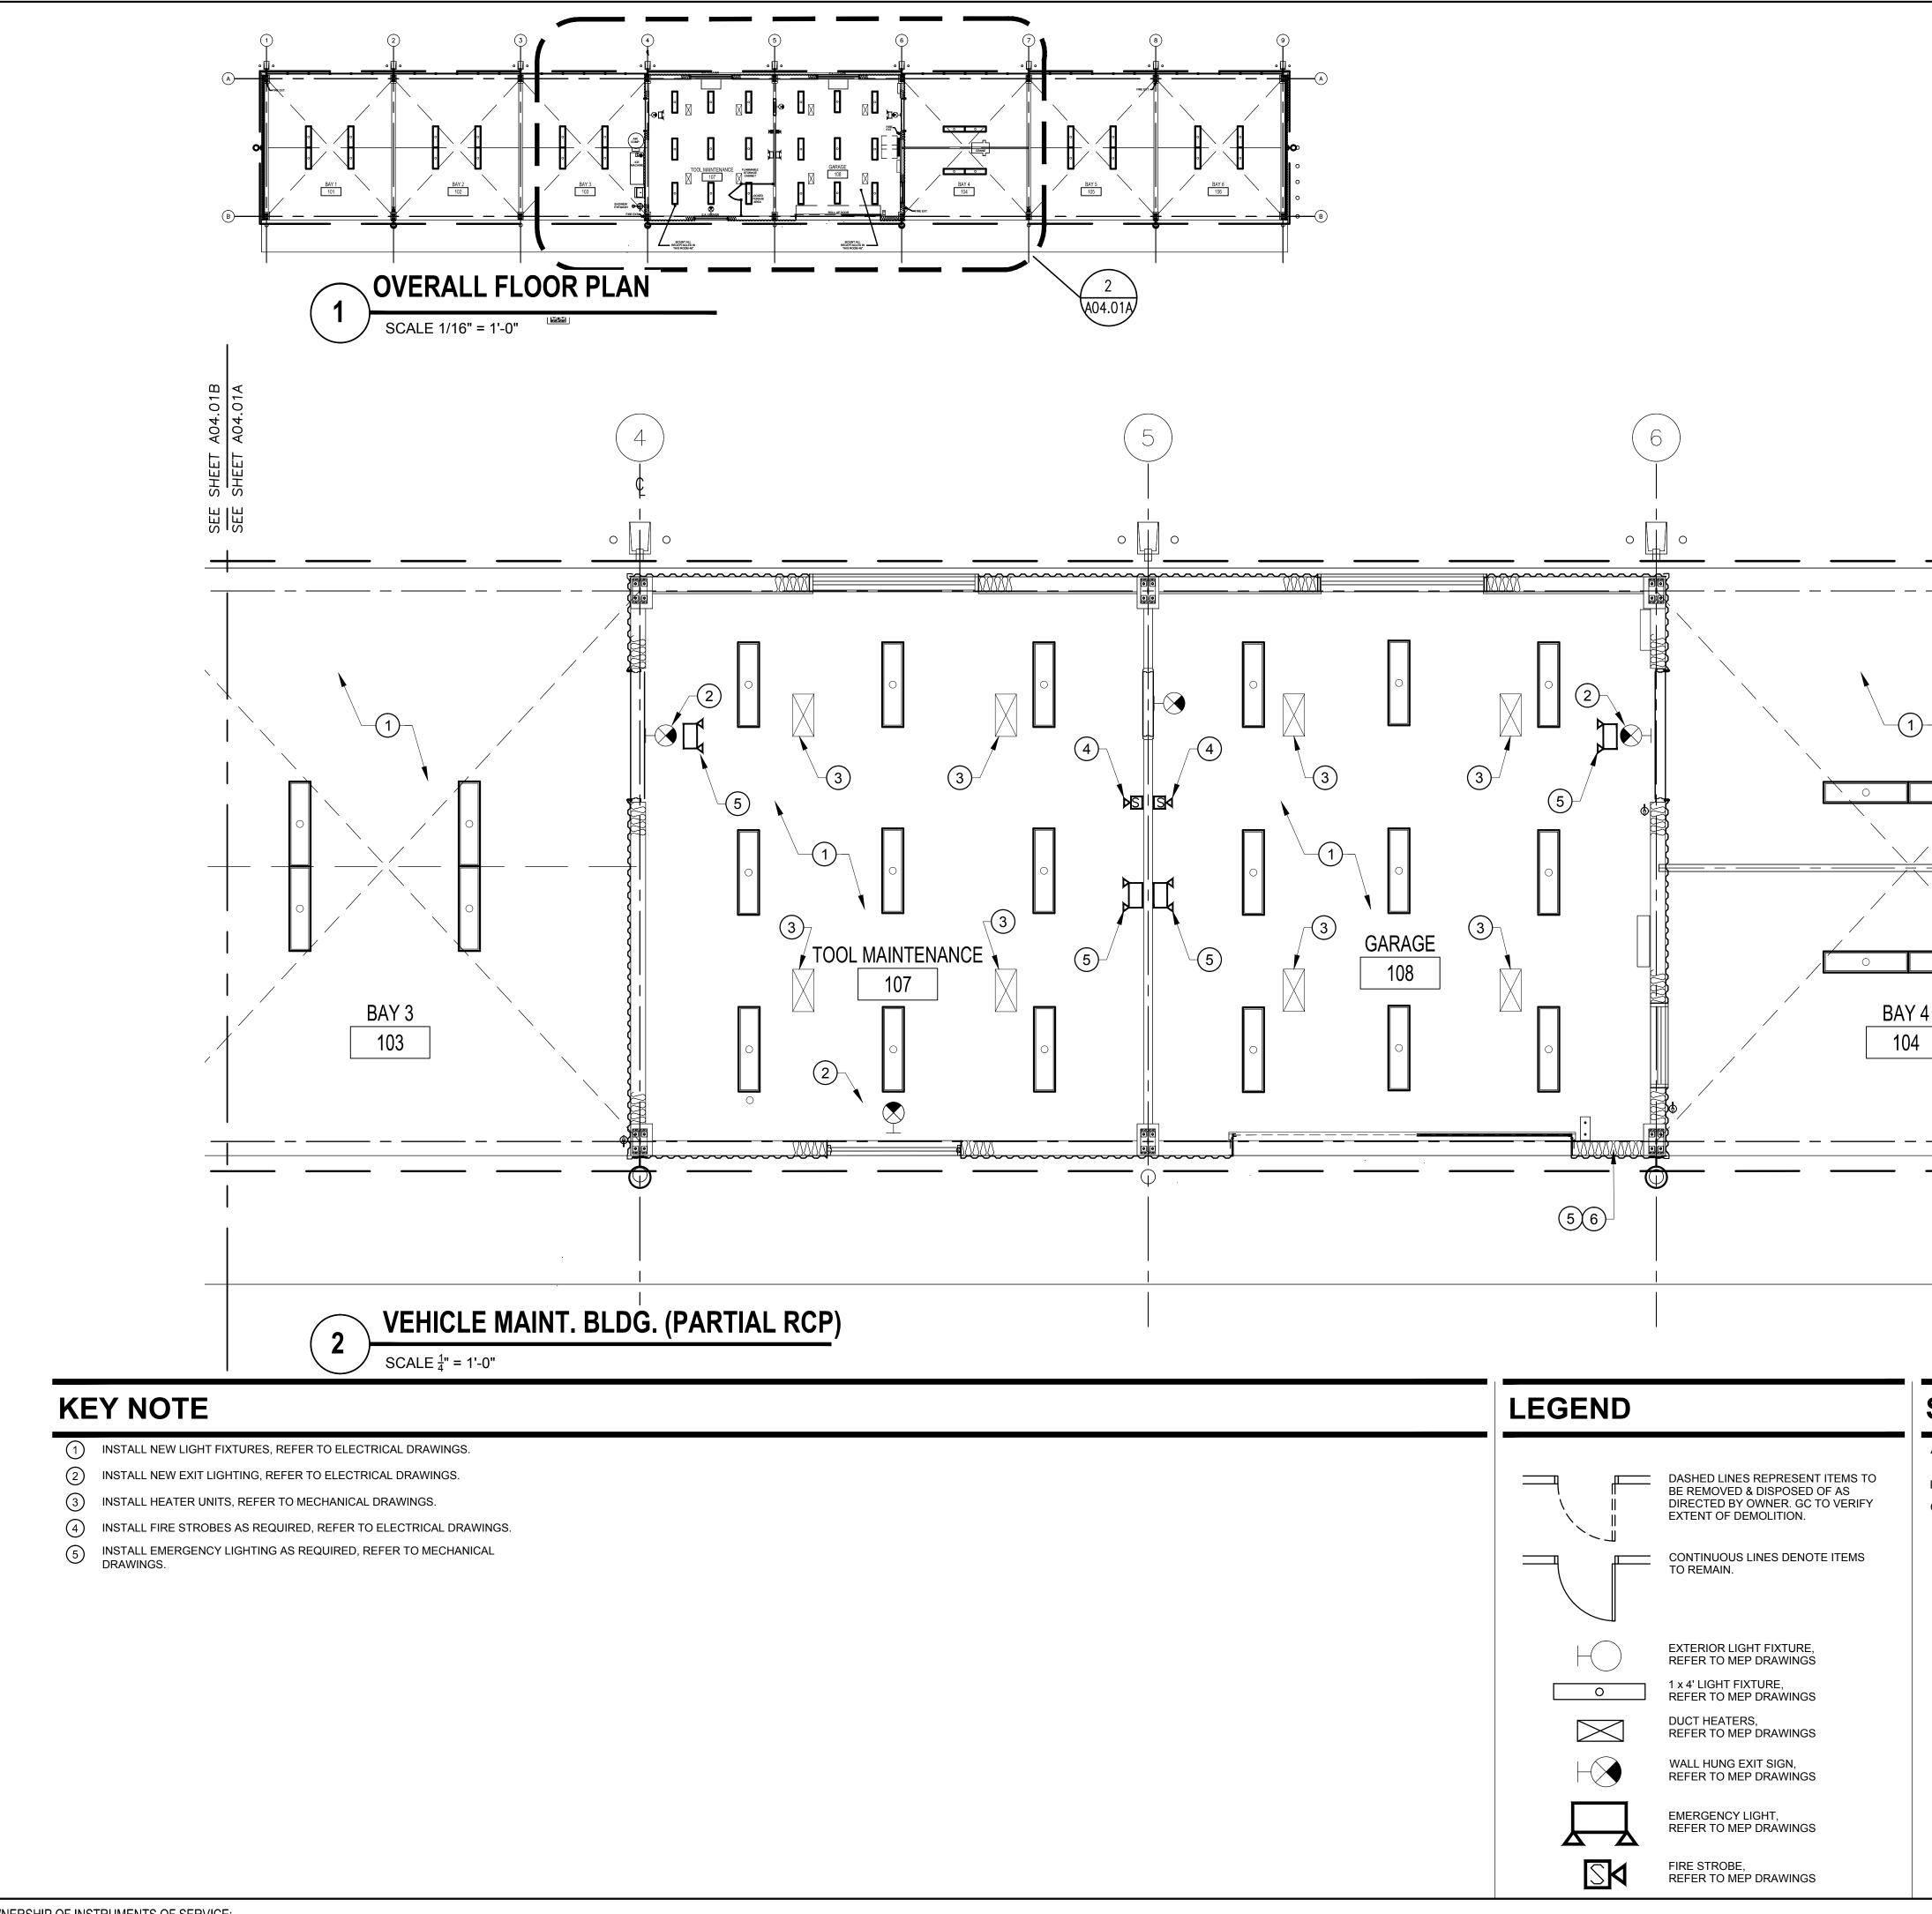


	SHEET NOTES
CAL ENGINEERING DRAWING\$ ROLLED. CREENING. 3 MANUFACTURE. BUILDING MANUFACTURE.	 A. NEW PRE-ENGINEERED METAL BUILDING WITH (6) 24'-0" X 26'-0" BAYS, TOOL MAINTENANCE A GARAGE. BUILDING BY METAL BUILDING MANUFACTURER B. CONCRETE SLAB FOR PRE-ENGINEERED BUILDING: 6" THICK REINFORCED CONCRETE SLAB CONTROL JOINTS AND BEARING PADS AS REQUIRED. SEE STRUCTURAL ENGINEERING DRAVING. C. INSTALL CONCRETE FILLED BOLLARDS TO PROTECT COLUMNS D. REFER TO ELECTRICAL DRAWINGS FOR LIGHTING DESIGN, DETAILS AND SPECIFICATIONS.
PLATE OVER CONCRETE ADDITIONAL INFORMATION.	



	KEY NOTES	
	 NEW REINFORCED CONCRETE SLAB ON GRADE. SEE STRUCTURAL ENGINEERING FOR DESIGN AND DETAILS. PRE-ENGINEERED METAL CORRUGATED PANELS WITH LAP SEAMS. COLOR TO BE SELECTED BY ARCHITECT. 5'-0" HIGH X 8" DIA. GALVANIZED STEEL PIPE FILLED WITH 3000 PSI CONCRETE. INSTALL "POSTGAURD" OR EQUAL PLASTIC VINYL SLEEVE IN SAFETY YELLOW. ALL TRIM BY PRE-ENGINEERED METAL BUILDING MANUFACTURER. 24GA GALVANIZED PAINTED GUTTER BY METAL BUILDING MANUFACTURER. DOWNSPOUT WITH METAL STRAPS BY METAL BUILDING 	ARCHITECTURAL DESIGN COLLABORATIVE 945 N. PENNSYLVANIA AVENUE WINTER PARK, FLORIDA 32789 OFFICE: (407) 629-1188 FAX: (407) 388-1220 WWW. ADCINTERNATIONAL.NET
	 MANUFACTURER. 20GA METAL FASCIA. PAINT COLOR BY ARCHITECT. GALVALUME STANDING SEAM ROOF, SHOP PAINTED WHITE. PAINT ALL EXPOSED PRE-ENGINEERED STRUCTURAL MEMBERS COMPLETELY . COLOR BY ARCHITECT. 2'-6" HIGH X 4" DIA. GALVANIZED STEEL PIPE FILLED WITH 3000 PSI CONCRETE. INSTALL "POSTGAURD" OR EQUAL PLASTIC VINYL SLEEVE IN SAFETY YELLOW TO PROTECT DOWNSPOUT. EXTERIOR LIGHT FIXTURE. REFER TO ELECTRICAL ENGINEERING DRAWINGS FOR DETAILS. LIGHTING TO BE SENSOR CONTROLLED. CHAIN-LINK FENCE WITH BLACK-OUT FABRIC SCREENING. ROLL-UP DOOR, PROVIDED BY METAL BUILDING MANUFACTURE. LOUVER VENTALATION, PROVIDED BY METAL BUILDING MANUFACTURE. TWO TON CRANE LOCATED IN BAY 4. PRE-ENGINEERED STEEL COLUMN WITH BASE PLATE OVER CONCRETE PILASTER. SEE STRUCTURAL DRAWINGS FOR ADDITIONAL INFORMATION. 	STATE OF FLORIDA ALBERT J. COOPER, R.A. Architect \bullet Seal/SignatureAA-C001315 AR-0010460Project Documents for:Image: Constant of the seal of the
)		Issue Date & Issue Description Drawn By Checked By 11.09.16 60% CD SET JS KA 01.24.17 90% CD SET JS KA 03.08.17 PERMIT ISSUE SET JS KA 09.26.17 CODE COMMENTS JS KA 11.10.17 CONSTRUCTION SET JS KA
3	 GENERAL NOTES A. NEW PRE-ENGINEERED METAL BUILDING WITH (6) 24'-0" X 26'-0" BAYS, TOOL MAINTENANCE AND GARAGE. BUILDING BY METAL BUILDING MANUFACTURER B. CONCRETE SLAB FOR PRE-ENGINEERED BUILDING: 6" THICK REINFORCED CONCRETE SLAB WITH CONTROL JOINTS AND BEARING PADS AS REQUIRED. SEE STRUCTURAL ENGINEERING DRAWINGS. C. INSTALL CONCRETE FILLED BOLLARDS TO PROTECT COLUMNS D. REFER TO ELECTRICAL DRAWINGS FOR LIGHTING DESIGN, DETAILS AND SPECIFICATIONS. 	NOISED AND AND AND AND AND AND AND AND AND AN
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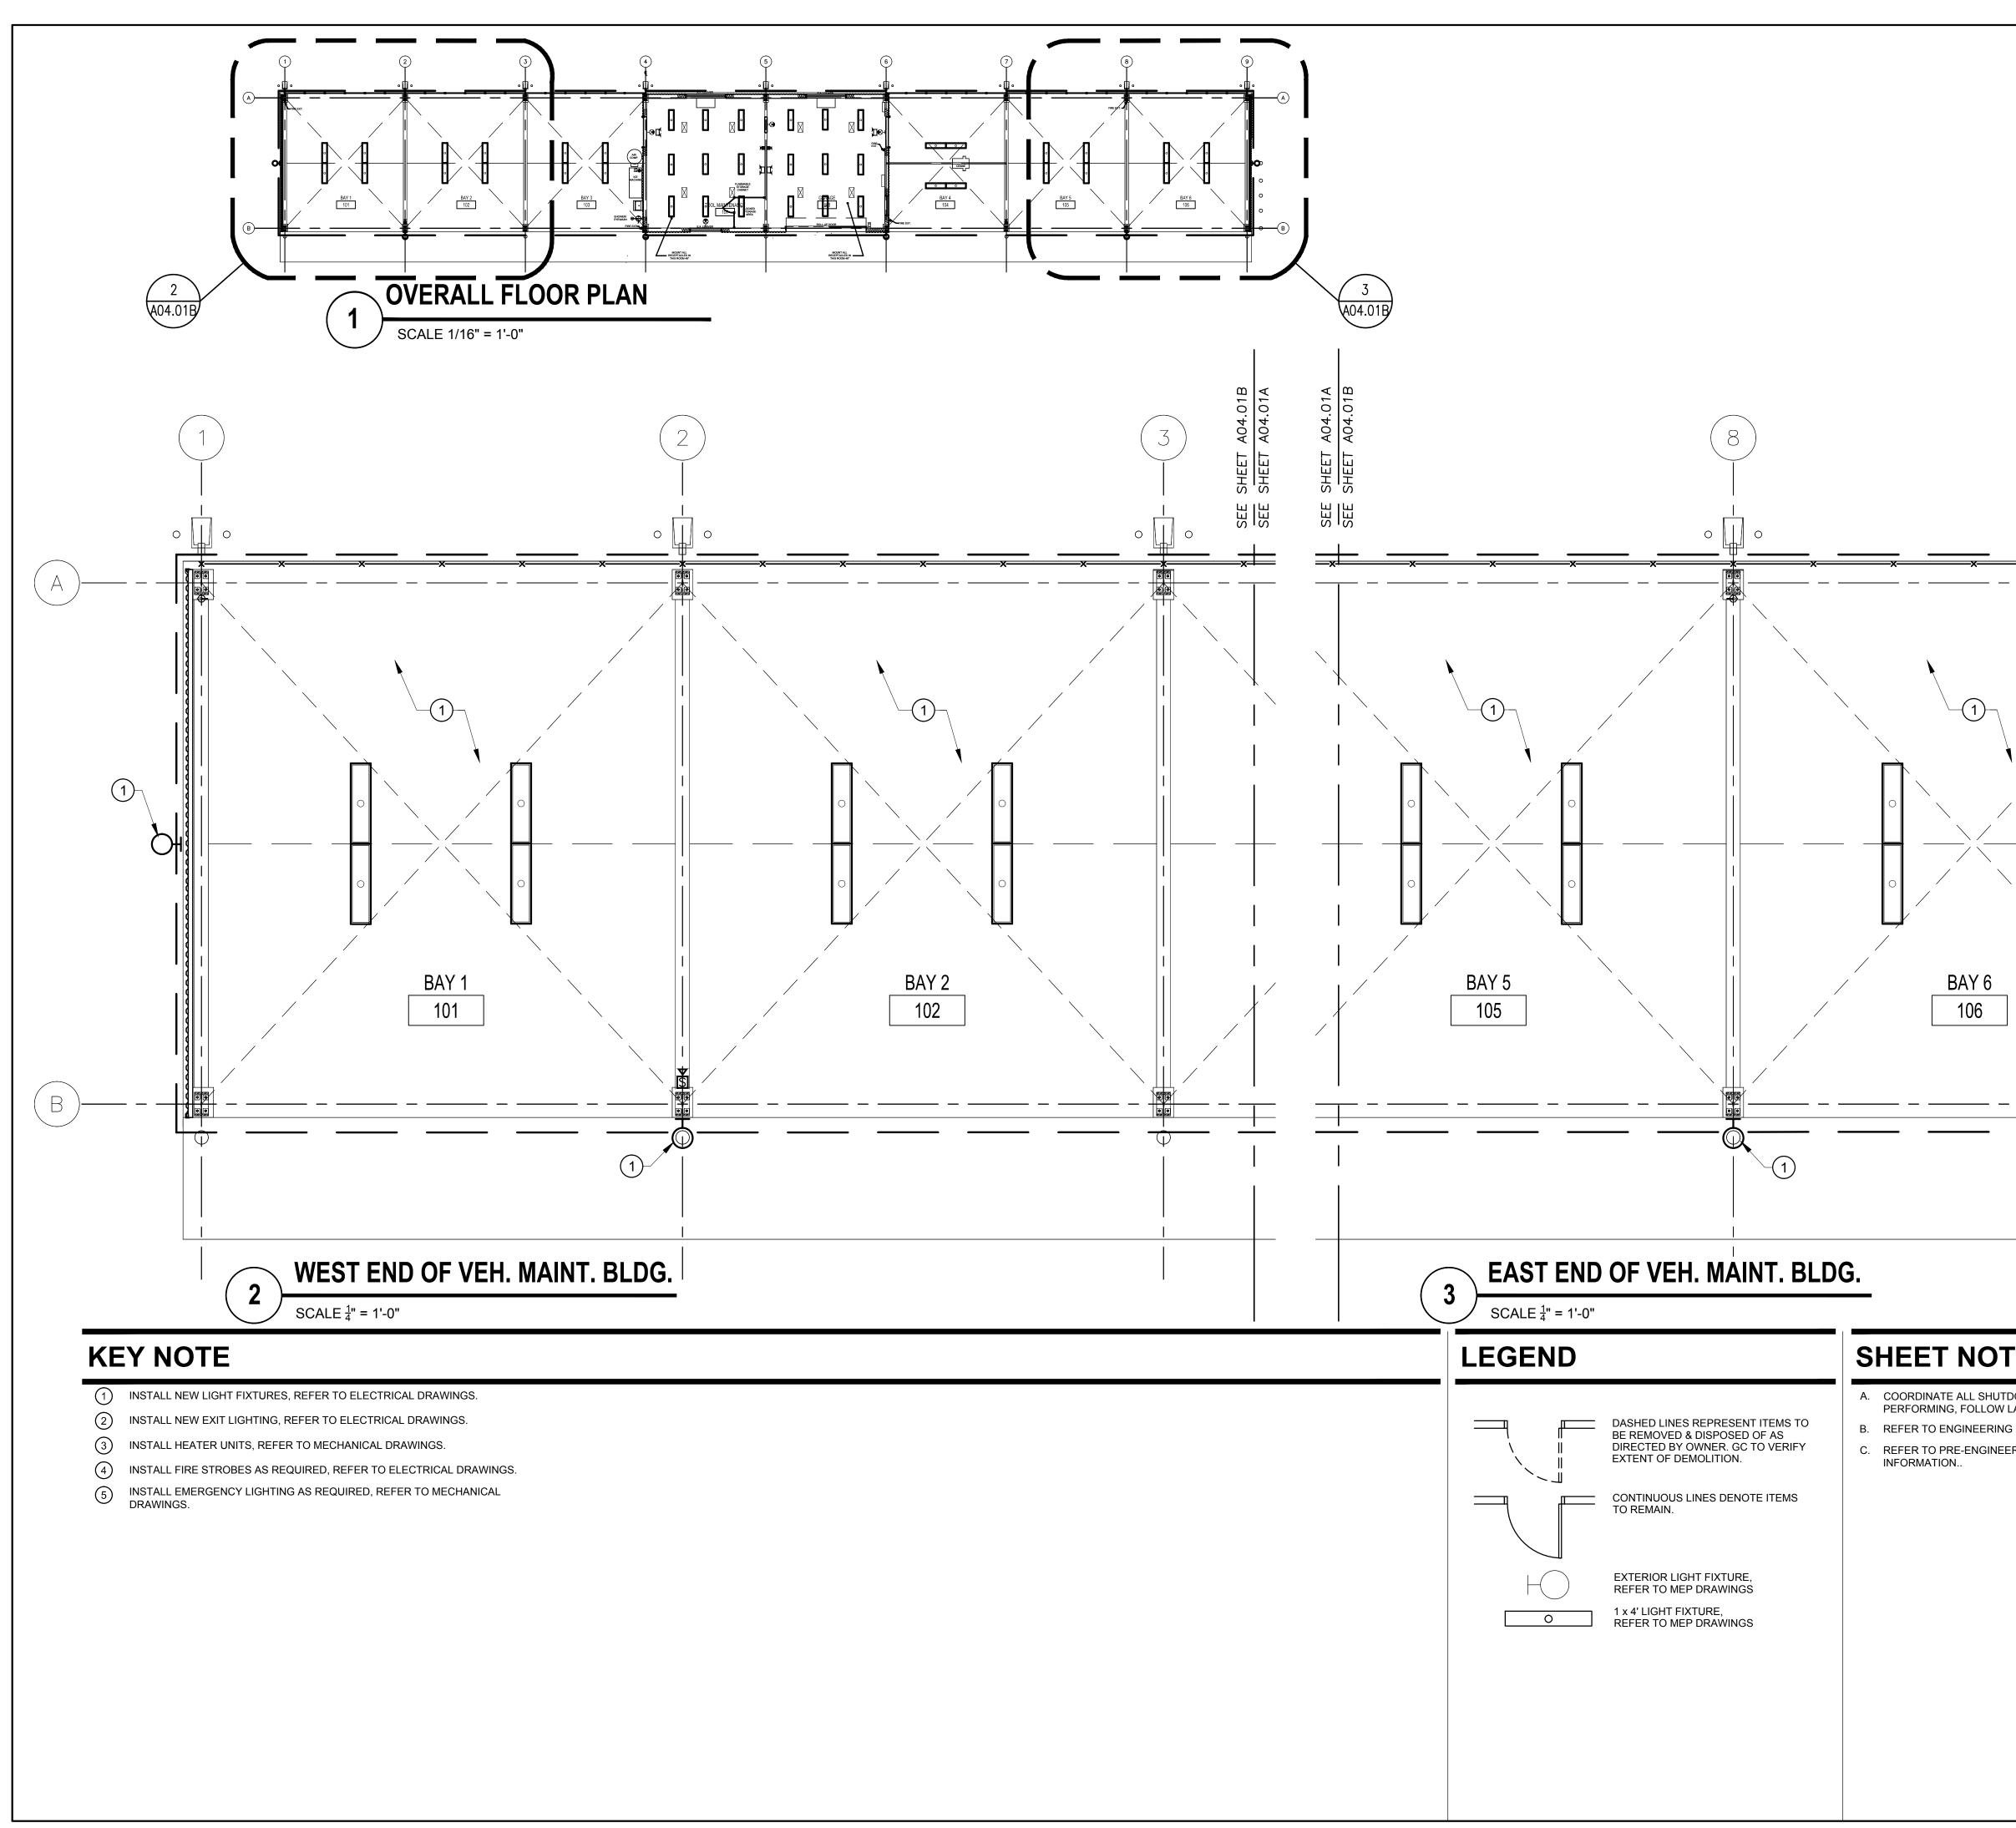
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A. COORDINATE ALL SHUTDOWNS IN UTILITY SERVICES WITH OWNER PRIOR TO		
 PERFORMING, FOLLOW LANDLORD RULES AND REGULATIONS. B. REFER TO ENGINEERING DISCIPLINE DOCUMENTS FOR ADDITIONAL INFORMATION. C. REFER TO PRE-ENGINEERED METAL BUILDING DRAWINGS FOR ADDITIONAL INFORMATION 		

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REFLECTED CEILING PLAN

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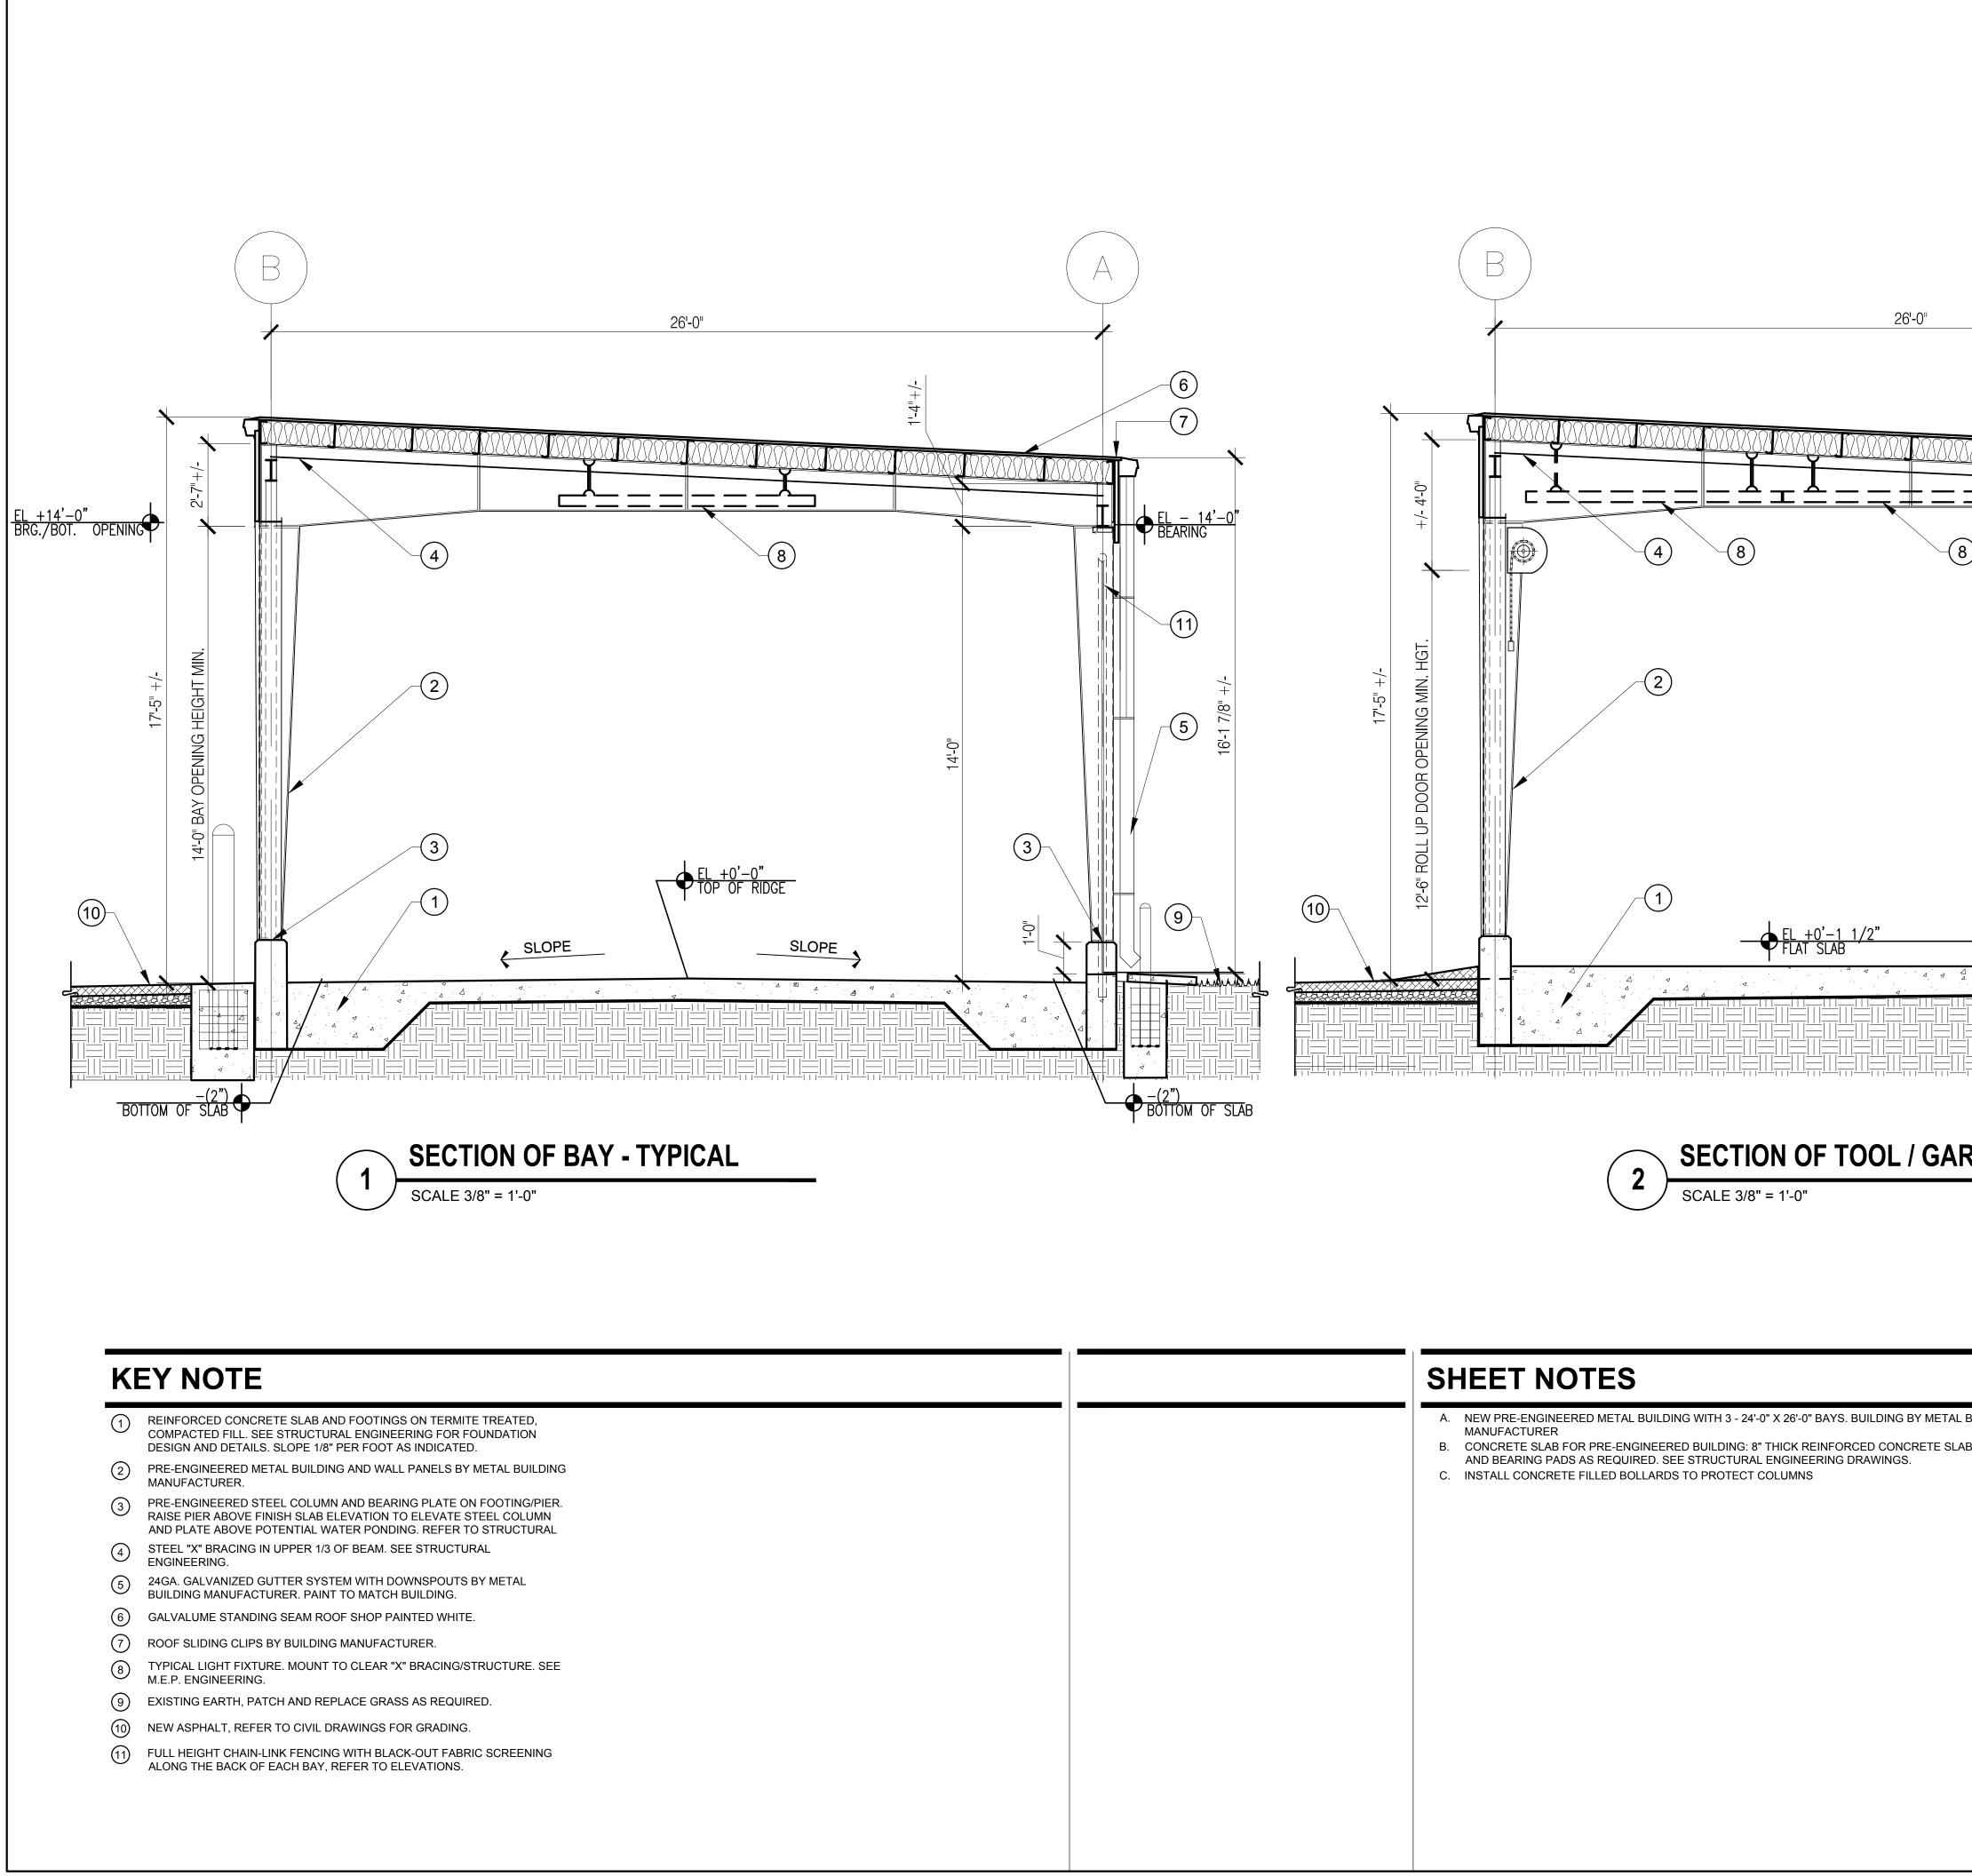
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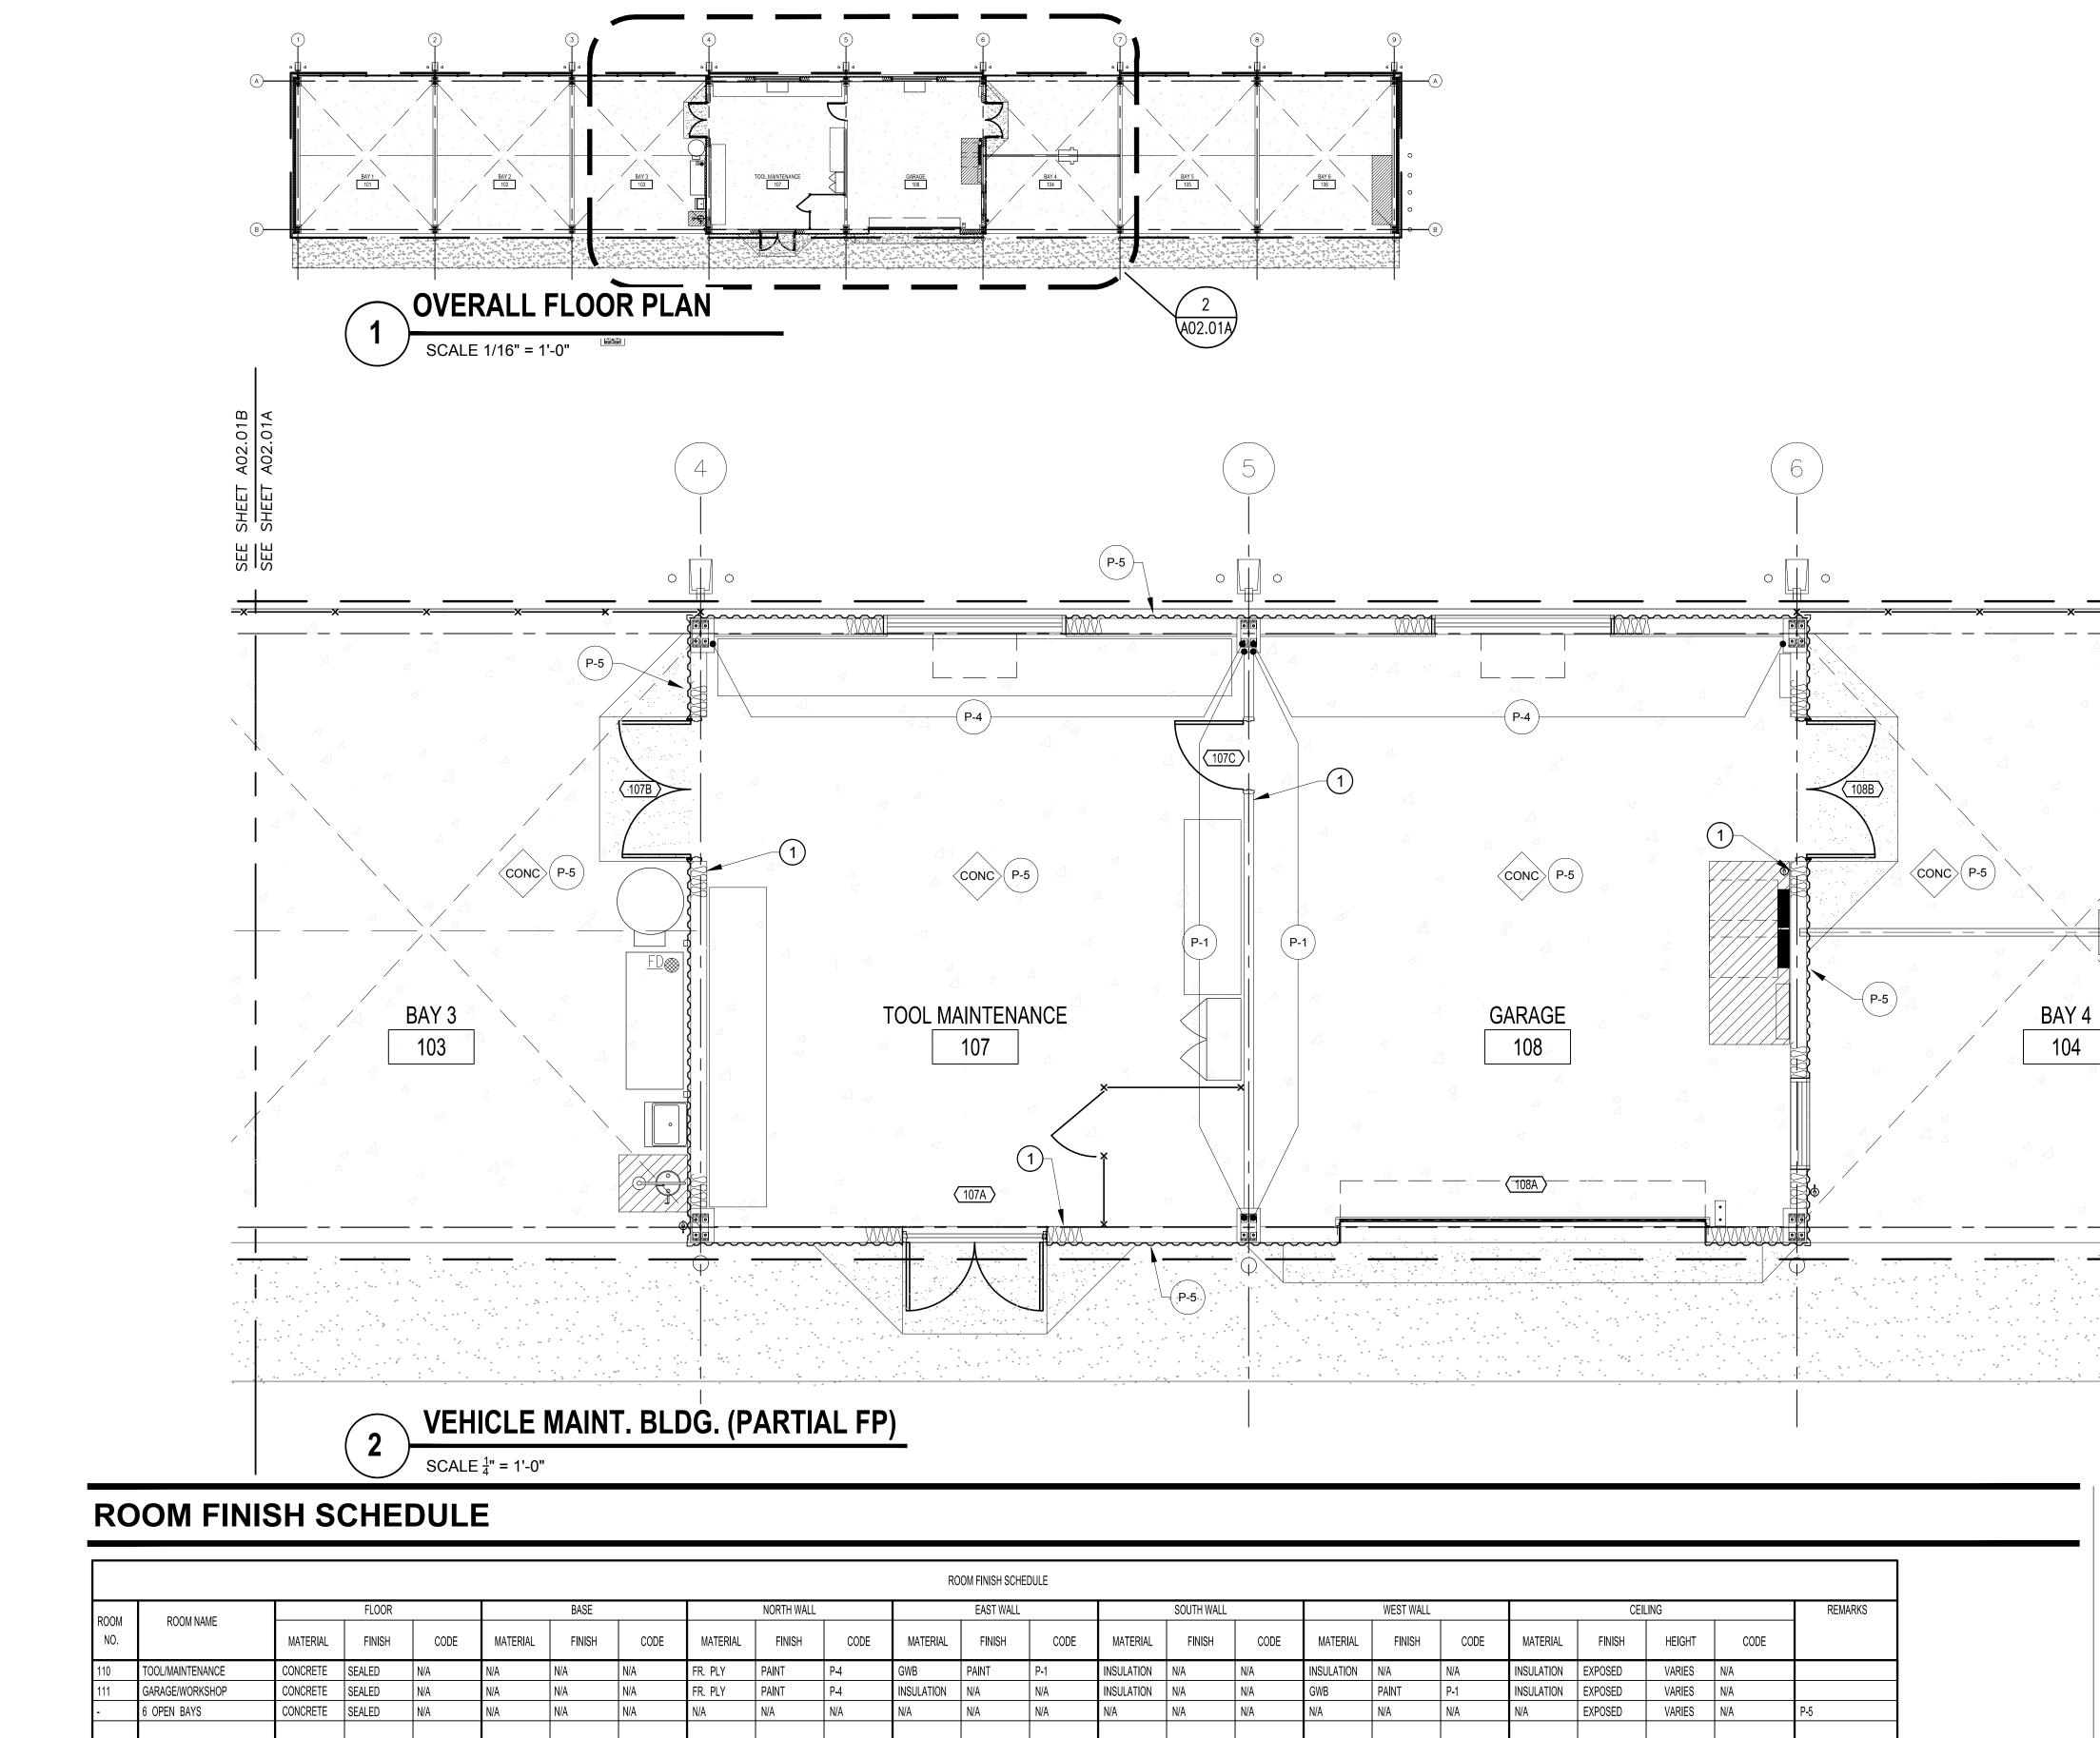
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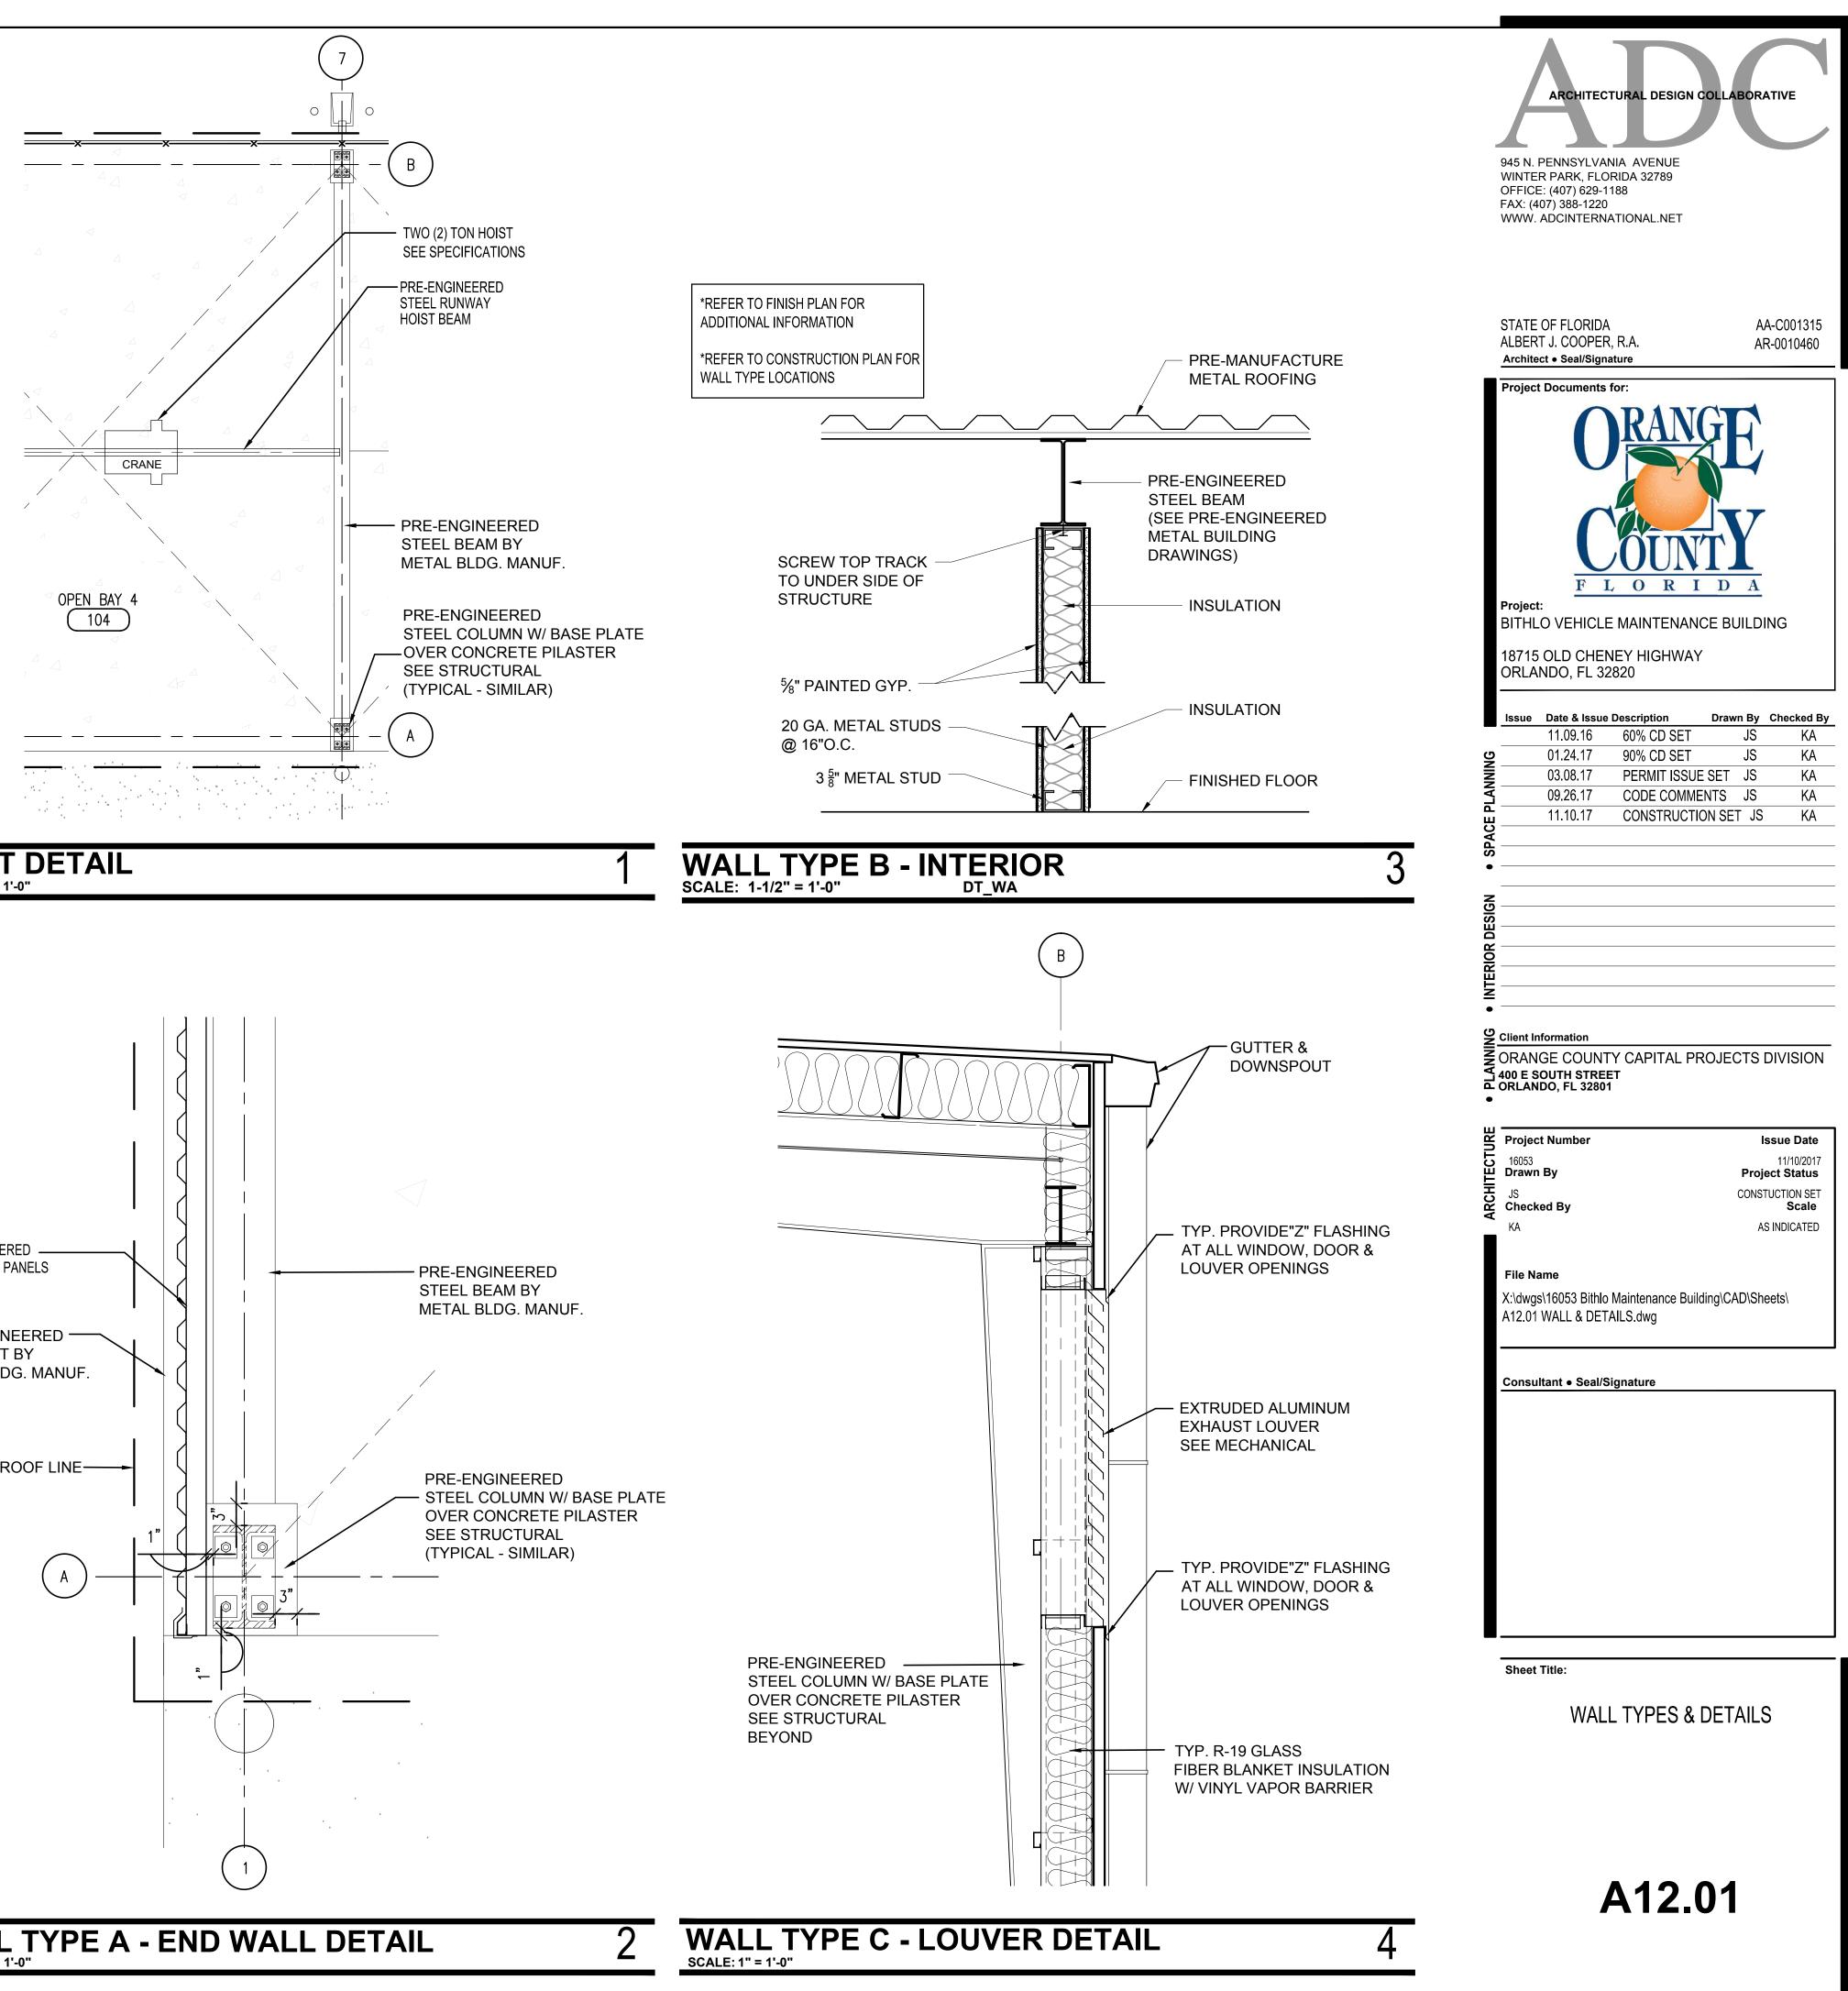
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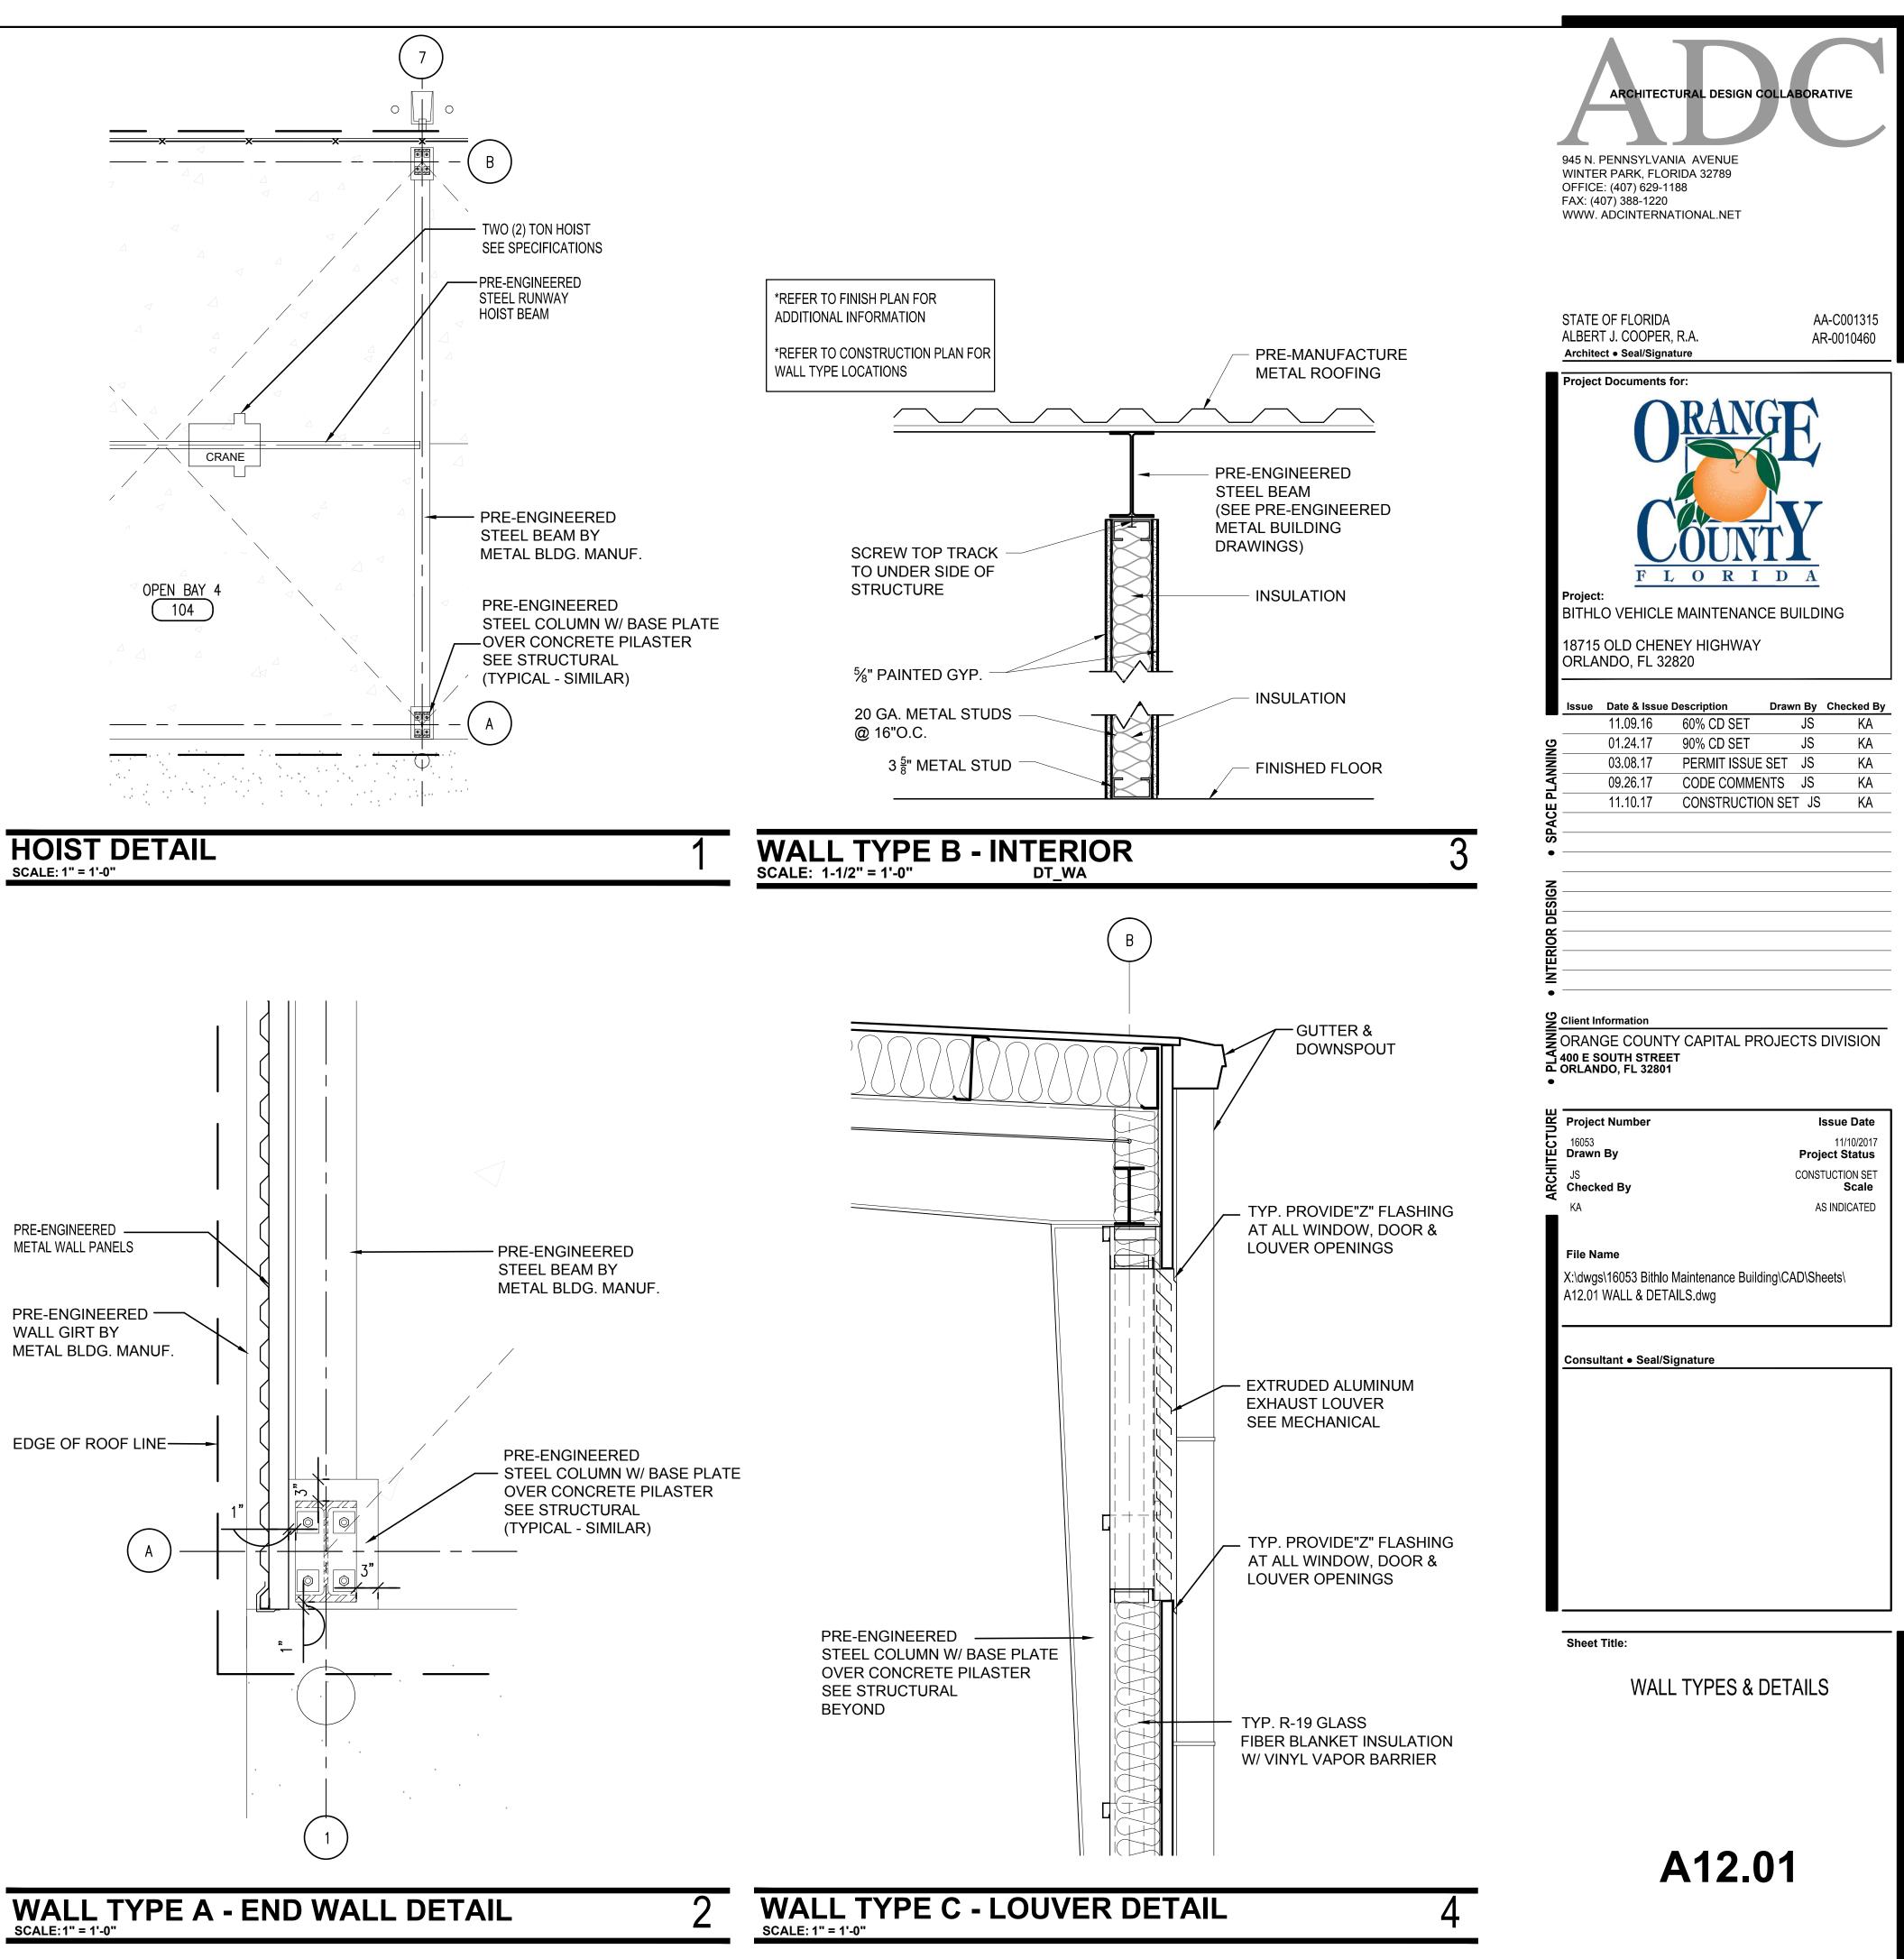
1 INSTALL 6" X 9" TACTILE "EXIT" SIGNAGE WITH BRAILLE CHARACTERS AT ALL EXIT DOORS. REFER TO SHEET A00.40 FOR MOUNTING HEIGHTS.

RO	OM FINISH SCHE	DULE													
EAST WALL			SOUTH WALL			WEST WALL				CEILING					
RIAL	FINISH	CODE	MATERIAL	FINISH	CODE	MATERIAL	FINISH	CODE	MATERIAL	FINISH	HEIGHT	CODE			
	PAINT	P-1	INSULATION	N/A	N/A	INSULATION	N/A	N/A	INSULATION	EXPOSED	VARIES	N/A			
ON	N/A	N/A	INSULATION	N/A	N/A	GWB	PAINT	P-1	INSULATION	EXPOSED	VARIES	N/A			
	N/A	N/A	N/A	N/A	N/A	N/A	N/A	N/A	N/A	EXPOSED	VARIES	N/A	P-5		

		ARCHITECTURAL DESIGN CO	
		945 N. PENNSYLVANIA AVENUE WINTER PARK, FLORIDA 32789 OFFICE: (407) 629-1188	
		FAX: (407) 388-1220 WWW. ADCINTERNATIONAL.NET	
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CODE	DESCRIPTION (PROVIDED MATERIAL NOTED OR APPROVED EQUAL		
P-1	SEE SPECIFICATIONS SECTION 09900, INTERIOR PAINT MANUFACTURE, GLIDDEN COLOR: 'TOASTY GREY' 30YY51/098		
P-4	PAINT TO MATCH COLOR OF EXTERIOR MTL. PANELS	Sheet Title:	
P-5	PAINT ALL EXPOSED METAL BUILDING STRUCTURE COLOR TO BE SELECTED BY		
		FINISH PLAI	N
FF	FACTORY FINISH		
		A06.0	1

ALL REPORTS, PLANS, SPECIFICATIONS, FIELD DATA AND NOTES AND OTHER DOCUMENTS, INCLUDING ALL DOCUMENTS ON ELECTRONIC MEDIA, PREPARED BY THE DESIGN PROFESSIONAL AS INSTRUMENTS OF SERVICE SHALL REMAIN THE PROPERTY OF THE DESIGN PROFESSIONAL.





		FLOOR D	RAIN SC	CHEDULE										
MARK	<u>BODY</u>	<u>GRATE OR</u>	STRAINER	MANUFACTURER	PLUMBING FIXTURE SCHEDULE									
<u>FD-1</u>	CAST IRON	6"NICKEL ROU	BRONZE, ND	J.R. SMITH #2005–A06–NB WATTS #FD–100–A6 ZURN #ZN–415–6B	MARK	FIXTURE	SOIL	WASTE	VENT	HW	<u>.cw</u>	MANUFACTURER		
FLOOR DRAIL				L DE APPROVED PROTECTION DEVICES.	AC	AIR COMPRESSOR				—		PROVIDE COMPRESSED AIR CONNECTIONS AS SHOWN.		
2. FURNISH 3. PROVIDE WHEN D	H ALL FLOOR DRAINS WITH E ALL DRAINS WITH WIDE AU RAINS ARE LOCATED IN NO	TRAP SAME SIZE AS I NCHOR FLANGE AND C DN-MEMBRANE FLOORS	CAD	COMPRESSED AIR DROP						PROVIDE 1/2" AIR DROP DOWN TO SINGLE QUICK DISCONNECT FITTING 36" - A.F.F. AIR DROP SHALL TAKE OFF FROM TOP OF AIR MAIN WITH DRAIN VALVE AT BOTTOM OF PIPE DROP. SEE DETAIL.				
	IMARY TRA			ION DEVICE SCHEDULE	<u>ES/EW</u>	COMBINATION EMERGENCY SHOWER AND EYEWASH UNIT		1 1/4"	2"		1/2"	PROVIDE COMBINATION EMERGENCY SHOWER AND EYE WASH UNIT.		
<u>PIPE</u> <u>SIZE</u>	<u>PIPE</u> <u>MATERIAL</u>	INSTALLATION TYPE		MANUFACTURER	НВ	WALL MOUNTED HOSE BIBB					3/4"	COLUMN MOUNTED, ANTI-SIPHON VACUUM BREAKER, 3/4" MALE HOSE THREAD, HARDENED STAINLESS STEEL OPERATING STEM, CHROME PLATED STEEL HANDLE.		
2"	PVC OR C.I.	F.D. OUTLET	J.R. SMITH #26	698; ZURN #1021; SIOUX CHIEF #200-092								WATER FILTER FOR ICE MACHINE – BUILT-IN SCALE INHIBITOR,		
3" 4"	PVC OR C.I. PVC OR C.I.	F.D. OUTLET	"	698; ZURN #1021; SIOUX CHIEF #200-092 698; ZURN #1021; SIOUX CHIEF #200-092	IM ICE MACHINE WITH WATER FILTRATION			2"		_	— 1/2 "	GRADED DENSITY CARBON BLOCK FILTER AND FILTRATION AND SCALE REDUCTION MATERIAL MEETING NSF AND /OF FDA COMPLIANT. FILTER HOUSING SHALL BE QUICK CHANGE TYPE.		
1. INSTALL	PROTECTION DEVICE NOTES: IN ALL NEW FLOOR DRAIN ID INSTALL PER MANUFACTU	S.	ONS.									PRE-FILTER: ARTIC PURE: AR-PRE FILTER: ARTIC PURE: AR-10000		
SECO	ONDARY TR	AP SEAL	PROTEC	TION DEVICE SCHEDULE	<u>ıs</u>	JANITOR'S SINK		3"	2"	3/4"	3/4"	ENAMELED CAST IRON SINK WITH BACK SPLASH AND 8" CENTER FAUCET HOLES, U-TYPE RIM GUARD, 3" CAST IRON P-TRAP, STRAINER AND FAUCET WITH VACUUM BREAKER.		
<u>PIPE</u> <u>SIZE</u>	<u>PIPE</u> MATERIAL	INSTALLATION TYPE		MANUFACTURER	OWS	ABOVEGROUND OIL/WATER		2"	2"			OIL/WATER SEPARATOR CAPABLE OF 20 GPM DISCHARGE RATE. ABOVE GROUND ACID RESISTANT COATED STEEL, 3" INLET/OUTLET.		
2"	PVC OR C.I.	F.D. OUTLET	J.R. SMITH #20	692.02; PROSET #TG22G; SURESEAL #SS2009		OWS SEPERATOR						BASIS OF DESIGN: ZURN MODEL Z1186, SIZE 500.		
3"	PVC OR C.I.	F.D. OUTLET	J.R. SMITH #26	692.02; PROSET #TG33G; SURESEAL #SS3000	PLUMBING	FIXTURE NOTES:		<u> </u>		I				
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		FLOOR	DRAIN S	CHEDULE								
MARK	BODY	<u>GRATE</u>	R STRAINER	MANUFACTURER		PL	UME	BING	i FIX	TUR	E S	CHEDULE
<u>FD-1</u>	CAST IRON	6" NICK R	EL BRONZE, DUND	E, J.R. SMITH #2005-A06-NB WATTS #FD-100-A6 ZURN #ZN-415-6B		<u>FIXTURE</u>	SOIL	WASTE	VENT	HW	<u>_CW</u>	MANUFACTURER
FLOOR DRAII					<u>AC</u>	AIR COMPRESSOR	—			—		PROVIDE COMPRESSED AIR CONNECTIONS AS SHOWN.
2. FURNISH 3. PROVIDE WHEN D	H ALL FLOOR DRAINS E ALL DRAINS WITH W DRAINS ARE LOCATED	WITH TRAP SAME SIZE A DE ANCHOR FLANGE AND IN NON-MEMBRANE FLOO	S BRANCH LINE. RE CLAMPING DEVICE. RS, THEY SHALL BI	CODE APPROVED PROTECTION DEVICES. FER TO PLANS FOR CONNECTION SIZES. ATTACH DRAINS TO MEMBRANE IN FLOOR. E FLASHED IN COMPLIANCE WITH THE SPECIFICATIONS.	CAD	COMPRESSED AIR DROP						PROVIDE 1/2" AIR DROP DOWN TO SINGLE QUICK DISCONNECT FITTING 36" - A.F.F. AIR DROP SHALL TAKE OFF FROM TOP OF AIR MAIN WITH DRAIN VALVE AT BOTTOM OF PIPE DROP. SEE DETAIL.
		RAP SEAL I		TION DEVICE SCHEDULE	<u>ES/EW</u>	COMBINATION EMERGENCY SHOWER AND EYEWASH UNIT		1 1/4"	2"		1/2"	PROVIDE COMBINATION EMERGENCY SHOWER AND EYE WASH UNIT.
<u>PIPE</u> <u>SIZE</u>	<u>Pipe</u> <u>Materi</u>	L INSTALLATION TYPE		MANUFACTURER	HB	WALL MOUNTED HOSE BIBB					3/4"	COLUMN MOUNTED, ANTI-SIPHON VACUUM BREAKER, 3/4" MALE HOSE THREAD, HARDENED STAINLESS STEEL OPERATING STEM, CHROME PLATED STEEL HANDLE.
2"	PVC OR	C.I. F.D. OUTLET	j.r. smith 🛔	2698; ZURN #1021; SIOUX CHIEF #200-092								· · · · · · · · · · · · · · · · · · ·
3"	PVC OR	C.I. F.D. OUTLET	j.r. smith 🛔	2698; ZURN #1021; SIOUX CHIEF #200-092		ICE MACHINE						WATER FILTER FOR ICE MACHINE – BUILT-IN SCALE INHIBITOR, GRADED DENSITY CARBON BLOCK FILTER AND FILTRATION AND
4"	PVC OR	C.I. F.D. OUTLET	j.r. smith 🛔	2698; ZURN #1021; SIOUX CHIEF #200-092	<u>IM</u>	WITH WATER FILTRATION		2"			1/2"	SCALE REDUCTION MATERIAL MEETING NSF AND /OF FDA COMPLIANT. FILTER HOUSING SHALL BE QUICK CHANGE TYPE.
1. INSTALL	PROTECTION DEVICE N IN ALL NEW FLOOR ID INSTALL PER MANU		ATIONS.									PRE-FILTER: ARTIC PURE: AR-PRE FILTER: ARTIC PURE: AR-10000
SECO	ONDARY '	TRAP SEAI	. PROTE	CTION DEVICE SCHEDULE	<u>JS</u>	JANITOR'S SINK		3"	2"	3/4"	3/4"	ENAMELED CAST IRON SINK WITH BACK SPLASH AND 8" CENTER FAUCET HOLES, U-TYPE RIM GUARD, 3" CAST IRON P-TRAP, STRAINER AND FAUCET WITH VACUUM BREAKER.
<u>PIPE</u> <u>SIZE</u>	<u>Pipe</u> Materi/	INSTALLATION		MANUFACTURER	OWS	ABOVEGROUND OIL/WATER		2"	2"			OIL/WATER SEPARATOR CAPABLE OF 20 GPM DISCHARGE RATE. ABOVE GROUND ACID RESISTANT COATED STEEL, 3" INLET/OUTLET.
2"	PVC OR	C.I. F.D. OUTLET	J.R. SMITH #	2692.02; PROSET #TG22G; SURESEAL #SS2009		SEPERATOR			2 2	<u>′</u>		BASIS OF DESIGN: ZURN MODEL Z1186, SIZE 500.
3"	PVC OR	C.I. F.D. OUTLET	j.r. smith #	2692.02; PROSET #TG33G; SURESEAL #SS3000								
				PLUMBING	FIXTURE NOTES:							

		FLOOR D	RAIN SC	HEDULE								
MARK	BODY	<u>GRATE OR</u>	STRAINER	MANUFACTURER		PL	.UMI	BING	i FIX	TUR	E S	CHEDULE
<u>FD-1</u>	FD-1 CAST IRON 6" NICKEL BRONZ			J.R. SMITH #2005-A06-NB	MARK	<u>FIXTURE</u>	SOIL	WASTE	VENT	HW	<u>CW</u>	MANUFACTURER
	ZURN #ZN-415-6B					AIR COMPRESSOR						PROVIDE COMPRESSED AIR CONNECTIONS AS SHOWN.
FLOOR DRAIN		WITH TRAP PRIMER V	ALVE OR OTHER COI	DE APPROVED PROTECTION DEVICES.	<u>AC</u>							
3. PROVIDE WHEN D	 FURNISH ALE NEW FEDORE DIVINES WITH TRAP SAME SIZE AS BRANCH LINE. REFER TO PLANS FOR CONNECTION SIZES. PROVIDE ALL DRAINS WITH WIDE ANCHOR FLANGE AND CLAMPING DEVICE. ATTACH DRAINS TO MEMBRANE IN FLOOR. WHEN DRAINS ARE LOCATED IN NON-MEMBRANE FLOORS, THEY SHALL BE FLASHED IN COMPLIANCE WITH THE SPECIFICATIONS. ALL FLOOR DRAINS SHALL BE INSTALLED WITH THE GRATE FLUSH TO FINISHED FLOOR. 					COMPRESSED AIR DROP						PROVIDE 1/2" AIR DROP DOWN TO SINGLE QUICK DISCONNECT FITTING 36" A.F.F. AIR DROP SHALL TAKE OFF FROM TOP OF AIR MAIN WITH DRAIN VALVE AT BOTTOM OF PIPE DROP. SEE DETAIL.
					<u>es/ew</u>	COMBINATION EMERGENCY SHOWER AND EYEWASH UNIT		1 1/4"	2"		1/2"	PROVIDE COMBINATION EMERGENCY SHOWER AND EYE WASH UNIT.
PIPE SIZE	PIPE SIZE PIPE MATERIAL INSTALLATION TYPE MANUFACTURER		Ш	WALL MOUNTED HOSE BIBB					3/4"	COLUMN MOUNTED, ANTI-SIPHON VACUUM BREAKER, 3/4" MALE HOSE THREAD, HARDENED STAINLESS STEEL OPERATING STEM, CHROME PLATED STEEL HANDLE.		
2"	PVC OR C.I.	F.D. OUTLET	J.R. SMITH #20	698; ZURN #1021; SIOUX CHIEF #200-092								
3"	PVC OR C.I.	F.D. OUTLET	J.R. SMITH #20	698; ZURN #1021; SIOUX CHIEF #200-092	м			2"			1/2"	WATER FILTER FOR ICE MACHINE – BUILT–IN SCALE INHIBITOR, GRADED DENSITY CARBON BLOCK FILTER AND FILTRATION AND SCALE REDUCTION MATERIAL MEETING NSF AND /OF FDA
4"	PVC OR C.I.	F.D. OUTLET	J.R. SMITH #20	698; ZURN #1021; SIOUX CHIEF #200-092	_	WITH WATER FILTRATION		2			1/2	COMPLIANT. FILTER HOUSING SHALL BE QUICK CHANGE TYPE.
1. INSTALL	PROTECTION DEVICE NOTES	S.										PRE-FILTER: ARTIC PURE: AR-PRE FILTER: ARTIC PURE: AR-10000
2. SIZE AN	D INSTALL PER MANUFACT	JRER'S RECOMMENDAT	10NS.									ENAMELED CAST IRON SINK WITH BACK SPLASH AND 8" CENTER
SECO	ONDARY TR	AP SEAL	PROTEC	TION DEVICE SCHEDULE		JANITOR'S SINK		3"	2"	3/4"	3/4"	FAUCET HOLES, U-TYPE RIM GUARD, 3" CAST IRON P-TRAP, STRAINER AND FAUCET WITH VACUUM BREAKER.
<u>PIPE</u> <u>SIZE</u>	<u>PIPE</u> MATERIAL	INSTALLATION TYPE		MANUFACTURER		ABOVEGROUND OIL/WATER		2"	2"			OIL/WATER SEPARATOR CAPABLE OF 20 GPM DISCHARGE RATE. ABOVE GROUND ACID RESISTANT COATED STEEL, 3" INLET/OUTLET.
2"	2" PVC OR C.I. F.D. OUTLET J.R. SMITH #2692.02; PROSET #TG22G; SURESEAL #SS2009			SEPERATOR						BASIS OF DESIGN: ZURN MODEL Z1186, SIZE 500.		
3"	PVC OR C.I.	F.D. OUTLET	J.R. SMITH #20	592.02; PROSET #TG33G; SURESEAL #SS3000		G FIXTURE NOTES:						· ·
4"	PVC OR C.I.	F.D. OUTLET	J.R. SMITH #20	592.02; PROSET #TG34G; SURESEAL #SS4009		FER TO ARCHITECTURAL DRAW	INGS FOR	MOUNTING	HEIGHTS	OF ALL F	IXTURES.	
	I		•		1 2. PR(OVIDE LISTED MANUFACTURER	OR APPR	OVED EQU	AL.			

TRAP SEAL PROTECTION DEVICE NOTES:

. INSTALL IN ALL NEW FLOOR DRAINS AS SECONDARY PROTECTION. INSTALL IN ALL EXISTING FLOOR DRAINS AS SECONDARY PROTECTION. 2. SIZE AND INSTALL PER MANUFACTURER'S RECOMMENDATIONS.

	AIR COMPRESSOR SCHEDULE											
MARK #	located on drawing #	M.F.G. OR APPROVED EQUAL	MODEL NO.	cfm in Continuous Duty	DISCHARGE PSI	STORAGE (GAL.)	VOLTAGE	MOTOR H.P.	REMARKS			
AC-1	P3.3	INGERSOL RAND	TYPE 30, 2475N5-V	18.5	125	80	208V-1-60	5	PROVIDE FILTER, REGULATOR AND VIBRATION ISOLATION BETWEEN FEET AND SLAB.			

ADDITIONAL ACCEPTABLE MANUFACTURERS - EQUIPMENT BY OTHER MANUFACTURERS WILL BE CONSIDERED PROVIDED ALL REQUIREMENTS OF DESCRIPTION AND INTENT OF THE SPECIFICATIONS ARE MET. IT IS THE CONTRACTOR RESPONSIBILITY TO PROVIDE ALL DOCUMENTATION INDICATING EQUALITY TO BASIS OF DESIGN EQUIPMENT AND FIXTURES SCHEDULED ABOVE. FINAL DETERMINATION OF EQUALITY SHALL BE BY ENGINEER OR OWNER.

CLEANOUT SCHEDULE

		r
MARK	APPLICATION	MANUFACTURER
	FINISHED FLOORS	J.R. SMITH #4033L; WATTS #CO-200-R; ZURN #ZN-1400
	FINISHED FLOORS, HEAVY DUTY	J.R. SMITH #4113L; WATTS #CO-200-RX; ZURN #ZN-1400-HD
FCO	TILE AREAS	J.R. SMITH #4153L; WATTS #CO-200-T; ZURN #ZN-1400-X
	TERRAZZO AREAS	J.R. SMITH #4193L; WATTS #CO-200-U; ZURN #ZN-1400-Z
	CARPETED AREAS	J.R. SMITH #4033L-Y; WATTS #CO-200-RC; ZURN #Z-1400-HD
	UNFINISHED AREAS	J.R. SMITH #4113L; WATTS #CO-200-RX; ZURN #Z-1400-HD
C0/	LINE CLEANOUTS	J.R. SMITH #4472T; WATTS #CO—590—RD; ZURN #Z—1468
WCO	STACK CLEANOUTS	J.R. SMITH #4532S; WATTS #CO-460-RD; ZURN #Z-1446
ECO	OUTSIDE AREAS	J.R. SMITH #4113L; WATTS #CO-200-RX; ZURN #Z-1400-HD

NOTES:

. INSTALL ECO IN 24"x24"x4" THICK CONCRETE PAD. TOP OF PAD ELEVATION TO BE 2" ABOVE FINISHED GRADE.

. PROVIDE ALL CLEANOUTS WITH WIDE ANCHOR FLANGE & CLAMPING DEVICE. ATTACH CLEANOUTS TO MEMBRANE IN FLOOR. WHEN CLEANOUTS ARE LOCATED IN NON-MEMBRANE FLOORS, THEY SHALL BE FLASHED IN COMPLIANCE WITH THE SPECIFICATIONS.

			W	ATER	НАММ	/IER /	ARRESTO	R SCHE	DULE	
3.	PROVIDE	LINE	& STACK	IYPE WALL	CLEANOUIS W	TH ACCESS	COVERS.			

	WAIEN		Annesion Schedule
<u>PIPE</u> <u>SIZE</u>	PDI SIZE	<u>FIXTURE_UNIT</u> <u>RANGE</u>	MANUFACTURER
1/2"	A	1–11	SIOUX CHIEF HYDRA-RESTER #652-A OR APPROVED EQUAL
3/4"	В	12-32	SIOUX CHIEF HYDRA-RESTER #653-B OR APPROVED EQUAL
1"	С	33–60	SIOUX CHIEF HYDRA-RESTER #654-C OR APPROVED EQUAL
1-1/4"	D	61–113	SIOUX CHIEF HYDRA-RESTER #655-D OR APPROVED EQUAL
1-1/2"	E	114–154	SIOUX CHIEF HYDRA-RESTER #656-E OR APPROVED EQUAL
2"	F	155–330	SIOUX CHIEF HYDRA-RESTER #657-F OR APPROVED EQUAL
WATER HAMMER ARF	RESTOR NOTES:		

1. AIR CHAMBERS ARE NOT AN ACCEPTABLE EQUAL TO WATER HAMMER ARRESTORS AND SHALL NOT BE INSTALLED. 2. SIZE AND INSTALL PER MANUFACTURER'S RECOMMENDATIONS.

2. PROVIDE LISTED MANUFACTURER OR APPROVED EQUAL.

ABBREVIATIONS LEGEND SOIL OR WASTE LINE (BELOW GRADE) COLD WATER CW HOT WATER HW SOIL OR WASTE LINE (ABOVE GRADE) HOT WATER RETURN HWR FORCE MAIN LINE (BELOW GRADE) DWV DRAIN, WASTE, AND VENT FORCE MAIN LINE (ABOVE GRADE) WASTE CONDENSATE DRAIN PIPING GREASE WASTE GW GREASE WASTE PIPING (BELOW GRADE) FORCE MAIN _____GW_____ ____ FM COND. CONDENSATE VENT PIPING VENT STORM DRAIN LINE (BELOW GRADE) _____ VENT THRU ROOF VTR STORM DRAIN LINE (ABOVE GRADE) CLEANOUT CO OVERFLOW STORM DRAIN (ABOVE GRADE) WCO WALL CLEANOUT FC0 FLOOR CLEANOUT DOMESTIC COLD WATER PIPING ____ _____ _ _ ____ ECO EXTERIOR CLEANOUT (GRADE) HOT WATER PIPING ____ B.V. BALANCING VALVE HOT WATER RETURN PIPING AB. ABOVE TRAP DN. DOWN EXTERIOR CLEANOUT (ECO) _____ CLG. CEILING CLEANOUT (CO/WCO) 0/H OVERHEAD MIN. MINIMUM FLOOR CLEANOUT (FCO) C.P. CHROME PLATED TWO PIECE, FULL PORT BALL VALVE S.S. STAINLESS STEEL SWING CHECK VALVE SLOPE SL. VERTICAL SHUT-OFF VALVE (GATE) GA. GAUGE CALIBRATED BALANCING VALVE BLDG. BUILDING CONN. CONNECTION CIRCULATOR PUMP (VERTICAL) Dè-A.H.A.P. AS HIGH AS POSSIBLE A.F.F. ABOVE FINISHED FLOOR (# PXXX) B.F.F. BELOW FINISHED FLOOR INDICATES RISER/DETAIL NUMBER, SHEET PXXX FOUND, AND RISER VIEW, (IF APPLICABLE) F.F.E. FINISHED FLOOR ELEVATION I.E. INVERT ELEVATION FD FLOOR DRAIN AD AREA DRAIN FLOOR SINK FS ROOF DRAIN RD CD CONDENSATE DRAIN CR CONDENSATE RECEPTOR HOSE BIBB HR

- SPECIFICALLY NOTED.
- ARCHITECTURAL DRAWINGS.
- SYSTEM SERVED.
- APPLIANCES.
- GRADE.

- MOVEMENT.

- MANUFACTURER'S SPECIFICATIONS AND MAKE FINAL CONNECTIONS.

- ENGINEER.
- TIME ALLOTTED.

GENERAL PLUMBING NOTES

1. REFERENCE THE SPECIFICATIONS FOR MATERIALS AND EQUIPMENT STANDARDS.

2. THE INSTALLATION OF THE PLUMBING SYSTEMS AND EQUIPMENT SHALL COMPLY WITH ALL APPLICABLE CODES INCLUDING BUT NOT LIMITED TO THE 2014 FLORIDA BUILDING CODE AND 2014 FLORIDA PLUMBING CODE.

3. THE CONTRACTOR SHALL COORDINATE THE INTERRUPTION OF ALL UTILITY SERVICES WITH OWNER'S REPRESENTATIVE. PROVIDE A MINIMUM OF FIVE WORKING DAYS ADVANCED NOTICE (OR PER PLUMBING SPECIFICATIONS) OF SCHEDULED UTILITY DISCONNECTION.

4. PLANS ARE NOT COMPLETELY TO SCALE. PIPE ROUTING SHOWN IS SCHEMATIC AND IS NOT INTENDED TO INDICATE EXACT LOCATION OF PIPING AND VALVES. CONTRACTOR SHALL PROVIDE ANY ADDITIONAL FITTINGS REQUIRED FOR PROPER INSTALLATION AND TO MAINTAIN PROPER CLEARANCES. COORDINATE WITH ALL TRADES AND OTHER POTENTIAL OBSTRUCTIONS AND ROUTE PIPING TO AVOID INTERFERENCES.

5. CONCEAL PIPING ABOVE CEILINGS, WITHIN WALLS OR CHASES EXCEPT IN MECHANICAL ROOMS OR AS

6. PERFORM FIRESTOPPING UNDER DIVISION 07 SECTION 'FIRESTOPPING', AND AS DETAILED ON THE

PROVIDE ACCESS PANELS TO ALL VALVES LOCATED WITHIN CHASES OR NON-ACCESSIBLE CEILINGS. REFER TO ARCHITECTURAL DRAWINGS FOR CEILING TYPES. ALL VALVES SHALL BE ACCESSIBLE AND LABELED FOR

8. REFER TO ARCHITECTURAL DRAWINGS FOR FIXTURE LOCATIONS AND MOUNTING HEIGHTS.

9. INSTALL CODE REQUIRED FIXED AIR GAPS ON ALL INDIRECT WASTE CONNECTIONS SERVING EQUIPMENT, AND

10. PROVIDE CLEANOUTS ON ALL SANITARY DRAIN & WASTE, STORM DRAIN, AND CONDENSATE DRAIN PIPING AS INDICATED ON THE DRAWINGS, AND AS REQUIRED BY LOCAL AND STATE CODES. INSTALL CLEANOUTS IN ACCESSIBLE LOCATIONS. COORDINATE TOP OF FLOOR/GRADE CLEANOUT ELEVATION WITH TOP OF FINISHED

11. INSTALL HOSE BIBBS AND WALL HYDRANTS AT 18" ABOVE FINISHED FLOOR OR FINISHED GRADE.

12. ALL FLOOR DRAINS SHALL BE INSTALLED WITH TRAP SEAL PROTECTION DEVICES. ALL FLOOR DRAINS SHALL BE INSTALLED WITH GRATES FLUSH TO THE FINISHED FLOOR.

13. UNLESS NOTED OTHERWISE, SLOPE ALL SANITARY DWV, STORM DRAIN, AND CONDENSATE DRAIN PIPING 3" PIPE SIZE & LARGER A MINIMUM OF 1/8" PER FT. OF RUN, AND 2-1/2" PIPE SIZE AND SMALLER A MINIMUM 1/4" PER FT. OF RUN. SLOPE VENT PIPING DOWN & BACK TO FIXTURES.

14. EACH PLUMBING VENT SHALL TERMINATE NOT LESS THAN 10 FT. FROM, OR AT LEAST 3 FT. ABOVE ANY WINDOW, DOOR, OPENING, AIR INTAKE, OR VENT SHAFT.

15. PROVIDE WATER HAMMER ARRESTORS AT ALL PLUMBING FIXTURES OR BATTERY OF FIXTURES WITH QUICK-CLOSING VALVES. WATER HAMMER ARRESTORS SHALL BE SIZED PER PDI STANDARDS. AIR CHAMBERS SHALL NOT BE CONSIDERED AN EQUAL TO WATER HAMMER ARRESTORS AND SHALL NOT BE INSTALLED.

16. WATER SERVICE PIPE AND THE BUILDING SEWER SHALL BE SEPARATED BY 5 FEET OF UNDISTURBED OR COMPACTED EARTH. THE REQUIRED SEPARATION DISTANCE SHALL NOT APPLY WHERE THE BOTTOM OF THE WATER SERVICE PIPE WITHIN 5 FEET OF THE SEWER IS A MINIMUM OF 12 INCHES ABOVE THE TOP OF THE HIGHEST POINT OF THE SEWER AND THE PIPE MATERIALS CONFORM TO APPLICABLE PLUMBING CODES.

17. UNLESS NOTED OTHERWISE, RUN CW & HW PIPING FULL SIZE THRU LENGTH OF CHASE, AND MAKE CONNECTIONS TO FIXTURES AS INDICATED IN THE PLUMBING FIXTURE SCHEDULE. PROVIDE RIGID SUPPORT AND BLOCKING IN CHASE FOR HEADER AND BRANCH PIPING, AND FOR FLUSH VALVES TO PREVENT ANY

18. WATER PIPING SHALL NOT BE ROUTED OVER ANY ELECTRICAL OR COMMUNICATIONS ROOMS.

19. PROVIDE CALIBRATED BALANCING VALVES WITH THREADED CONNECTIONS IN HOT WATER RETURN PIPING, AND BALANCE SYSTEM FOR PROPER OPERATION. REFER TO CIRCULATOR PUMP SCHEDULE.

20. COORDINATE THE EXACT LOCATION OF FLOOR DRAINS WITH ARCHITECT PRIOR TO CONSTRUCTION.

21. PROVIDE ALL NECESSARY VALVES, TRAPS, FLOW CONTROLS, FILTERS, BACKFLOW ASSEMBLIES, FAUCETS, STOPS, TAILPIECES, VACUUM BREAKERS, IF NOT FURNISHED WITH EQUIPMENT.

22. CONTRACTOR SHALL ROUGH-IN ALL WASTES AND SUPPLIES TO ALL EQUIPMENT ACCORDING TO

23. PROVIDE SUPPLY STOPS ON HOT AND COLD WATER PIPE SUPPLYING ALL FIXTURES AND EQUIPMENT.

24. PROVIDE APPROVED CHROME PLATED TYPE VACUUM BREAKERS WHERE REQUIRED BY LOCAL CODES, AND AS INDICATED ON PLANS FOR NEW WORK.

25. SUBMIT CORE-DRILL PLAN TO STRUCTURAL ENGINEER AND ARCHITECT FOR REVIEW PRIOR TO STARTING ANY

26. PROVIDE DIELECTRIC UNIONS WHERE CONNECTIONS ARE MADE BETWEEN DISSIMILAR PIPE MATERIALS.

27. SEE RISER DIAGRAMS FOR PIPE SIZES AND ROUTING NOT SHOWN ON PLANS.

28. METERING AND SITE UTILITY CONNECTIONS SHALL BE PROVIDED ON SITE UTILITY DRAWINGS. ALL SERVICES SHOWN ON THIS SET OF PLANS TERMINATE 5'-0" FROM BUILDING, UNLESS SHOWN OTHERWISE ON DRAWINGS. PLUMBING CONTRACTOR SHALL MAKE FINAL CONNECTIONS TO SITE UTILITES (INC. CLEANOUTS, INCREASES, BACKWATER VALVES, ETC.).

29. PRESSURE REDUCING VALVES SHALL BE PROVIDED WHERE THE WATER PRESSURE EXCEEDS 80 PSI AT ANY PLUMBING FIXTURE. WATER VELOCITY SHALL NOT EXCEED 5 FEET PER SECOND.

30. COORDINATE EXACT LOCATION OF FLOOR DRAINS AND CONDENSATE RECEPTORS FOR HVAC EQUIPMENT WITH MECHANICAL CONTRACTOR. CONDENSATE PIPING SHALL DISCHARGE INTO STORM SYSTEM.

31. DO NOT PENETRATE WALL FOOTINGS WITH PIPING, COORDINATE WITH GENERAL CONTRACTOR TO DROP FOOTINGS AS REQUIRED TO CLEAR PLUMBING SERVICES WHERE ABSOLUTELY NECESSARY. ALL PIPING PENETRATING A BEARING WALL OR FOOTING MUST BE SLEEVED AND LOCATION APPROVED BY STRUCTURAL

32. IF THE INTENT OF THE INFORMATION SHOWN ON THESE DOCUMENTS IS NOT CLEAR, OR IS CAPABLE OF MORE THAN ONE INTERPRETATION, SUCH MATTERS SHALL BE BROUGHT TO THE ATTENTION OF THE ARCHITECT/ENGINEER IN WRITING BEFORE THE SUBMISSION OF BIDS, AND THE ARCHITECT/ENGINEER SHALL MAKE CORRECTION OR EXPLANATION IN WRITING.

33. WHERE THE CONTRACTOR PROPOSES ALTERNATE SOLUTIONS, DIFFERENT ROUTINGS OF PIPING, DIFFERENT LOCATIONS OF EQUIPMENT, FIXTURES, ETC., THE CONTRACTOR SHALL BE RESPONSIBLE FOR ALL OF THE RAMIFICATIONS OF THE PROPOSED CHANGE THAT ARE NOT INCLUDED IN HIS PROPOSAL, BUT BECOME APPARENT AT A LATER DATE, AND SHALL BEAR THE CONSEQUENCES OF CORRECTING ANY AND ALL CONFLICTS, DEFICIENCIES OR OTHER PROBLEMS AT NO INCREASE IN COST OR INCREASE IN CONSTRUCTION ARCHITECTURAL DESIGN COLLABORATIVE

945 N. PENNSYLVANIA AVENUE WINTER PARK, FLORIDA 32789 OFFICE: (407) 629-1188 FAX: (407) 388-1220 WWW. ADCINTERNATIONAL.NET

STATE OF FLORIDA ALBERT J. COOPER, R.A. Architect • Seal/Signature

AA-C001315 AR-0010460

Project Documents for:



BITHLO VEHICLE MAINTENANCE BUILDING

18715 OLD CHENEY HIGHWAY ORLANDO, FL 32820

Project⁻

Issue Date & Issue Description Drawn By Checked By 11.09.16 60% CD SET MB JJB 01.24.17 90% CD SET MB JJB 03.08.17 PERMIT ISSUE SET MB JJB 09.26.17 CODE COMMENTS MB JJB 11.10.17 CONSTRUCTION SETMB JJB

Client Information CRANGE COUNTY CAPITAL PROJECTS DIVISION

Issue Date

Project Status

CONSTUCTION SET

11/10/2017

Scale

400 E SOUTH STREET CORLANDO, FL 32801

Project Number 16053 Drawn By Checked By


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PLUMBING SYMBOLS LEGEND AND GENERAL NOTES

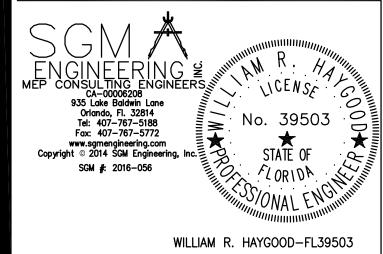P-001