


OCSO SECTOR IV PARKING LOT DESIGN


2400 W. 33RD ST ORLANDO, FL 32839

PROJECT SCOPE

THE PROJECT SCOPE INVOLVES THE REPAVING OF THE EXISTING PARKING LOT, INCLUDING SELECTED REMOVAL AND REPLACEMENT OF ASPHALT PAVEMENT AND CONCRETE CURBING, NEW HANDICAP ACCESSIBLE RAMPS, VALLEY GUTTER ADJACENT TO EXISTING ALUMINUM BUILDING, AND PARKING LOT STRIPING. THE REPAVING WILL CONSIST OF A 1" ASPHALT OVERLAY.

VICINITY MAP

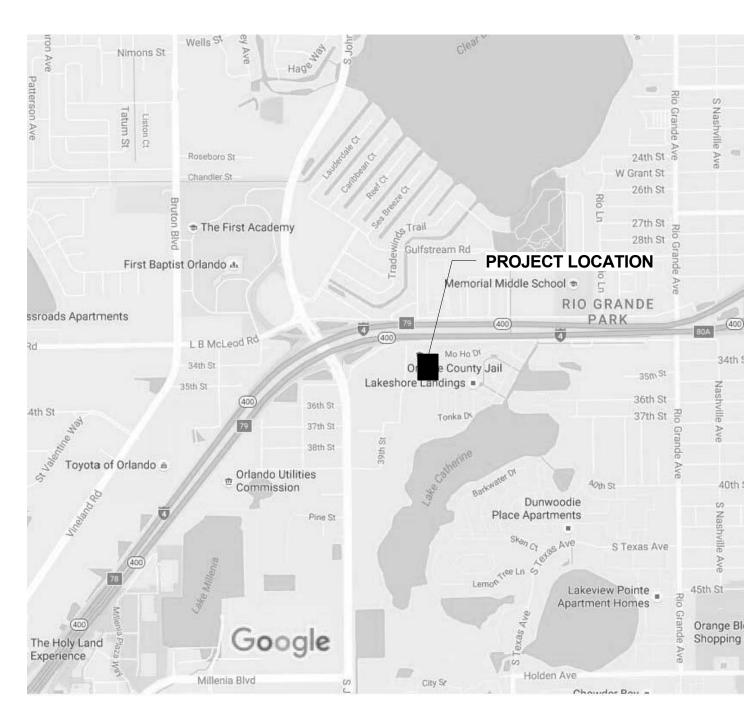

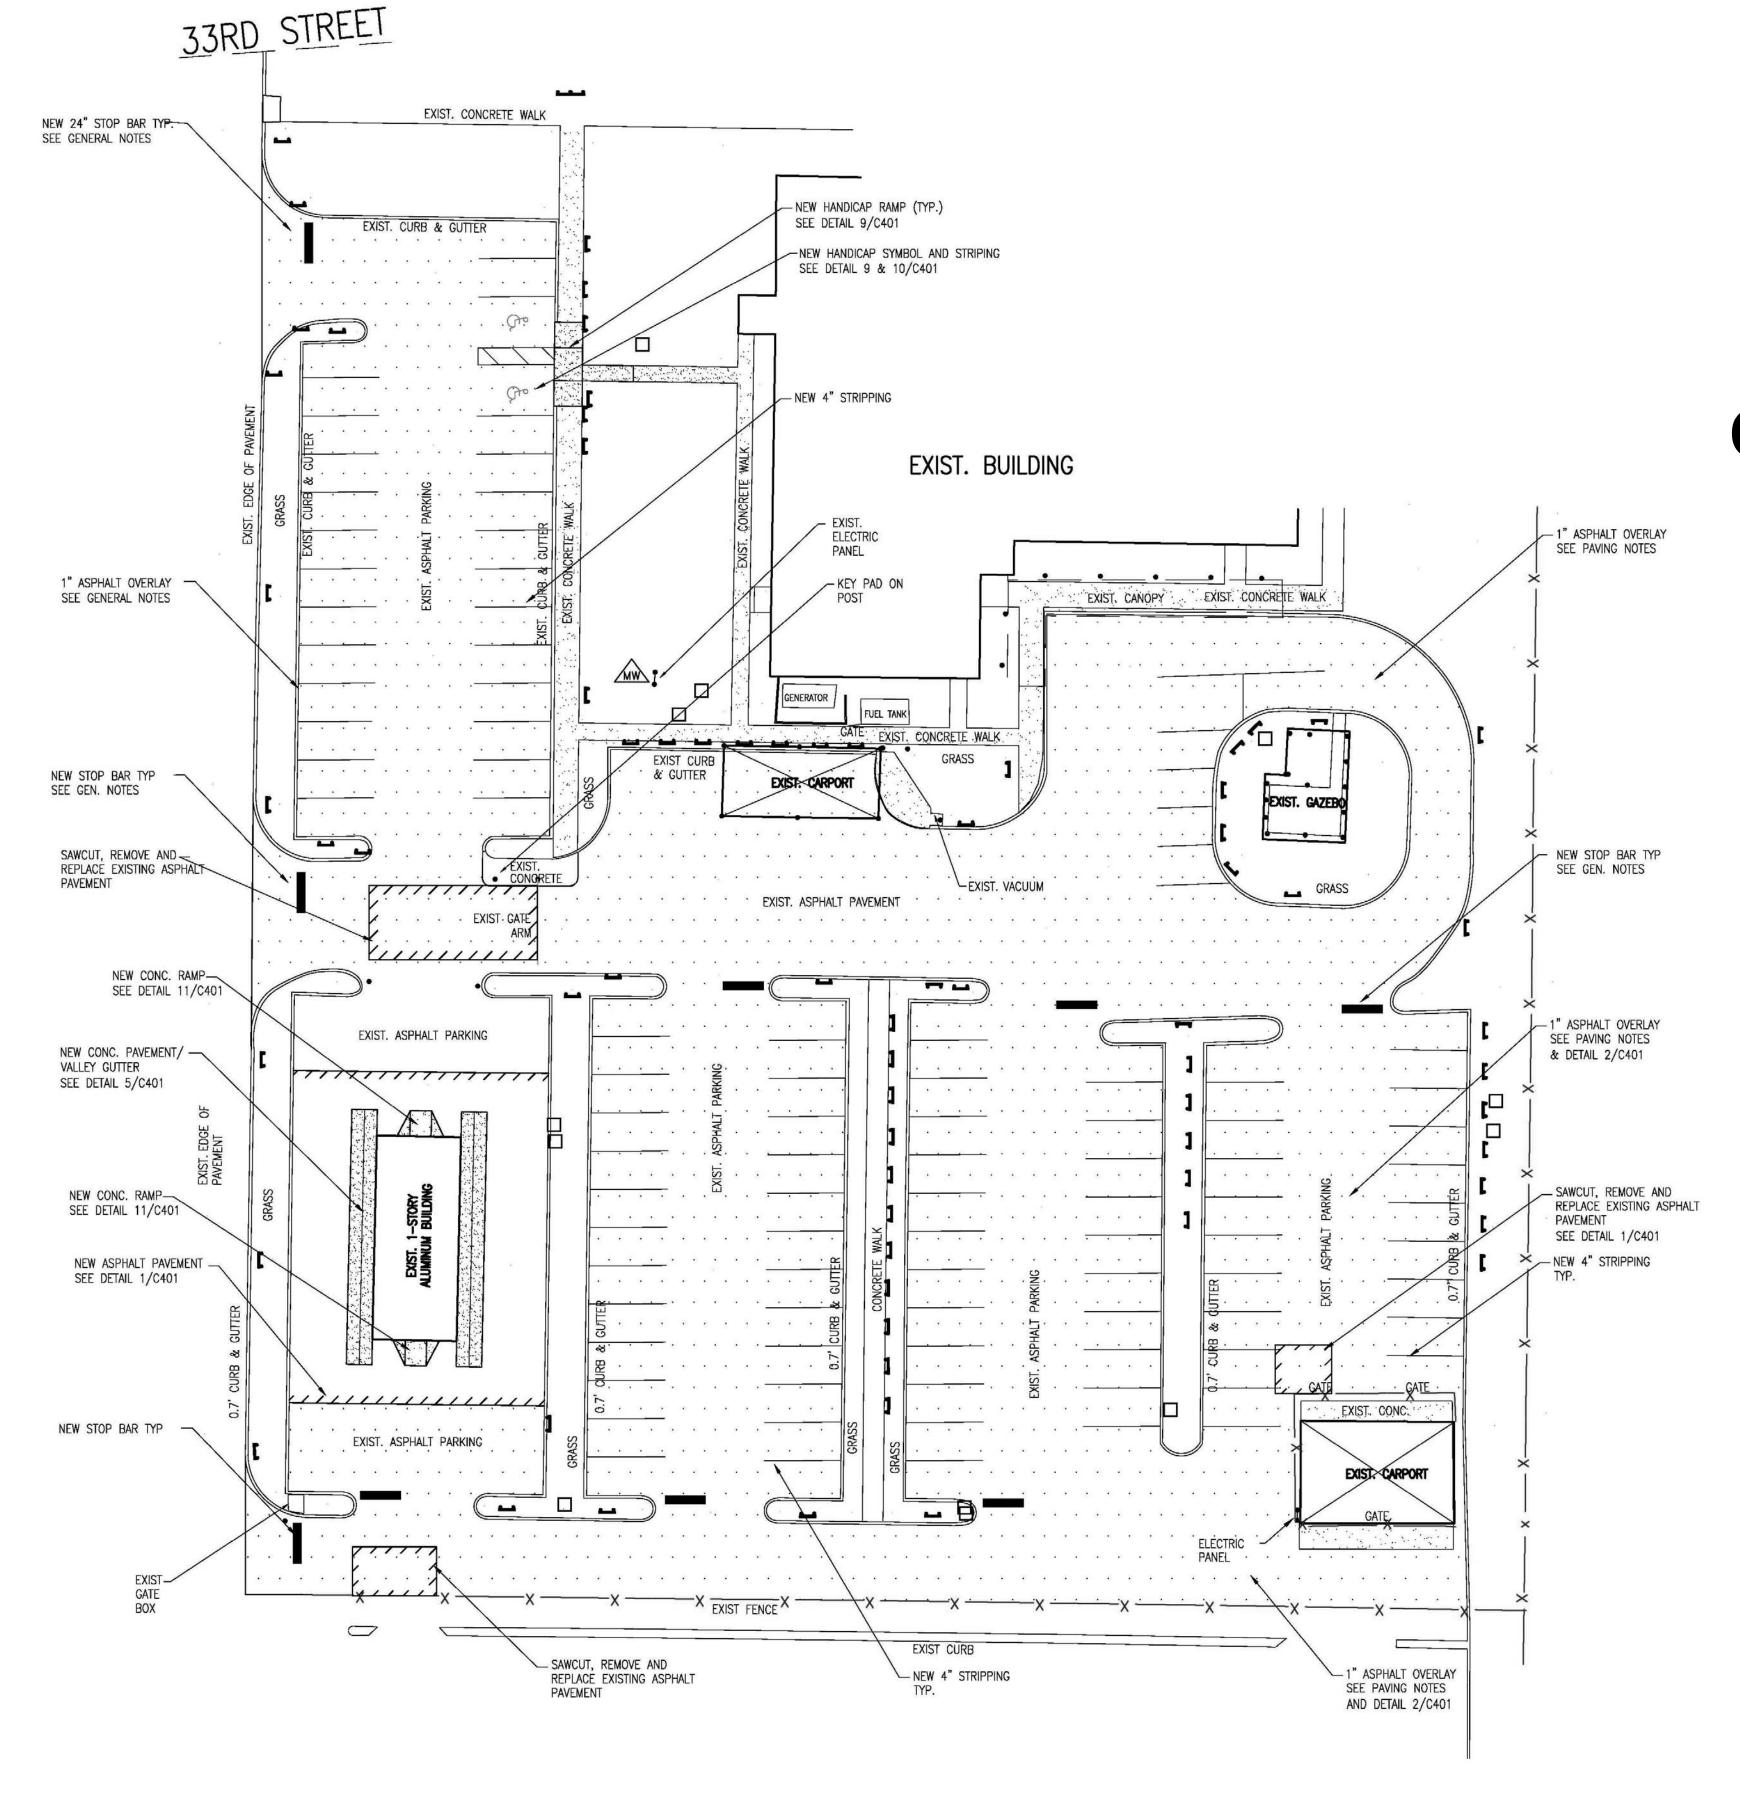

PERMIT DOCUMENTS

JANUARY 6, 2017

ORANGE COUNTY GOVERNMENT

400 EAST SOUTH STREET, SUITE 500 ORLANDO, FL 32801

BOARD OF COUNTY COMMISSIONERS

MAYOR - TERESA JACOBS

DISTRICT 1 COMMISSIONER - BETSY VANDERLAY

DISTRICT 2 COMMISSIONER - BRYAN NELSON

DISTRICT 3 COMMISSIONER - PETE CLARKE

DISTRICT 4 COMMISSIONER - JENNIFER THOMPSON

DISTRICT 5 COMMISSIONER - EMILY BONILLA

DISTRICT 6 COMMISSIONER -VICTORIA P. SIPLIN




PROJECT DESIGN TEAM

ARCHITECTURAL
RHODES+BRITO ARCHITECTS, INC
605 E. ROBINSON STREET, SUITE 750
ORLANDO, FL 32801
PH. (407) 648-7288

CONTACT: ADEL SHALABY, AIA

SK CONSORTIUM, INC.
PLANNING, ENGINEERING, URBAN DESIGN
1053 N. ORLANDO AVE., SUITE 3
MAITLAND, FL 32751
PH. (407) 629.4288
FAX (407) 629.1656
CONTACT: MAJID KALAGHCHI

	DATE	SUBMISSION / REVISION	NO.
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APPLICABLE CODES

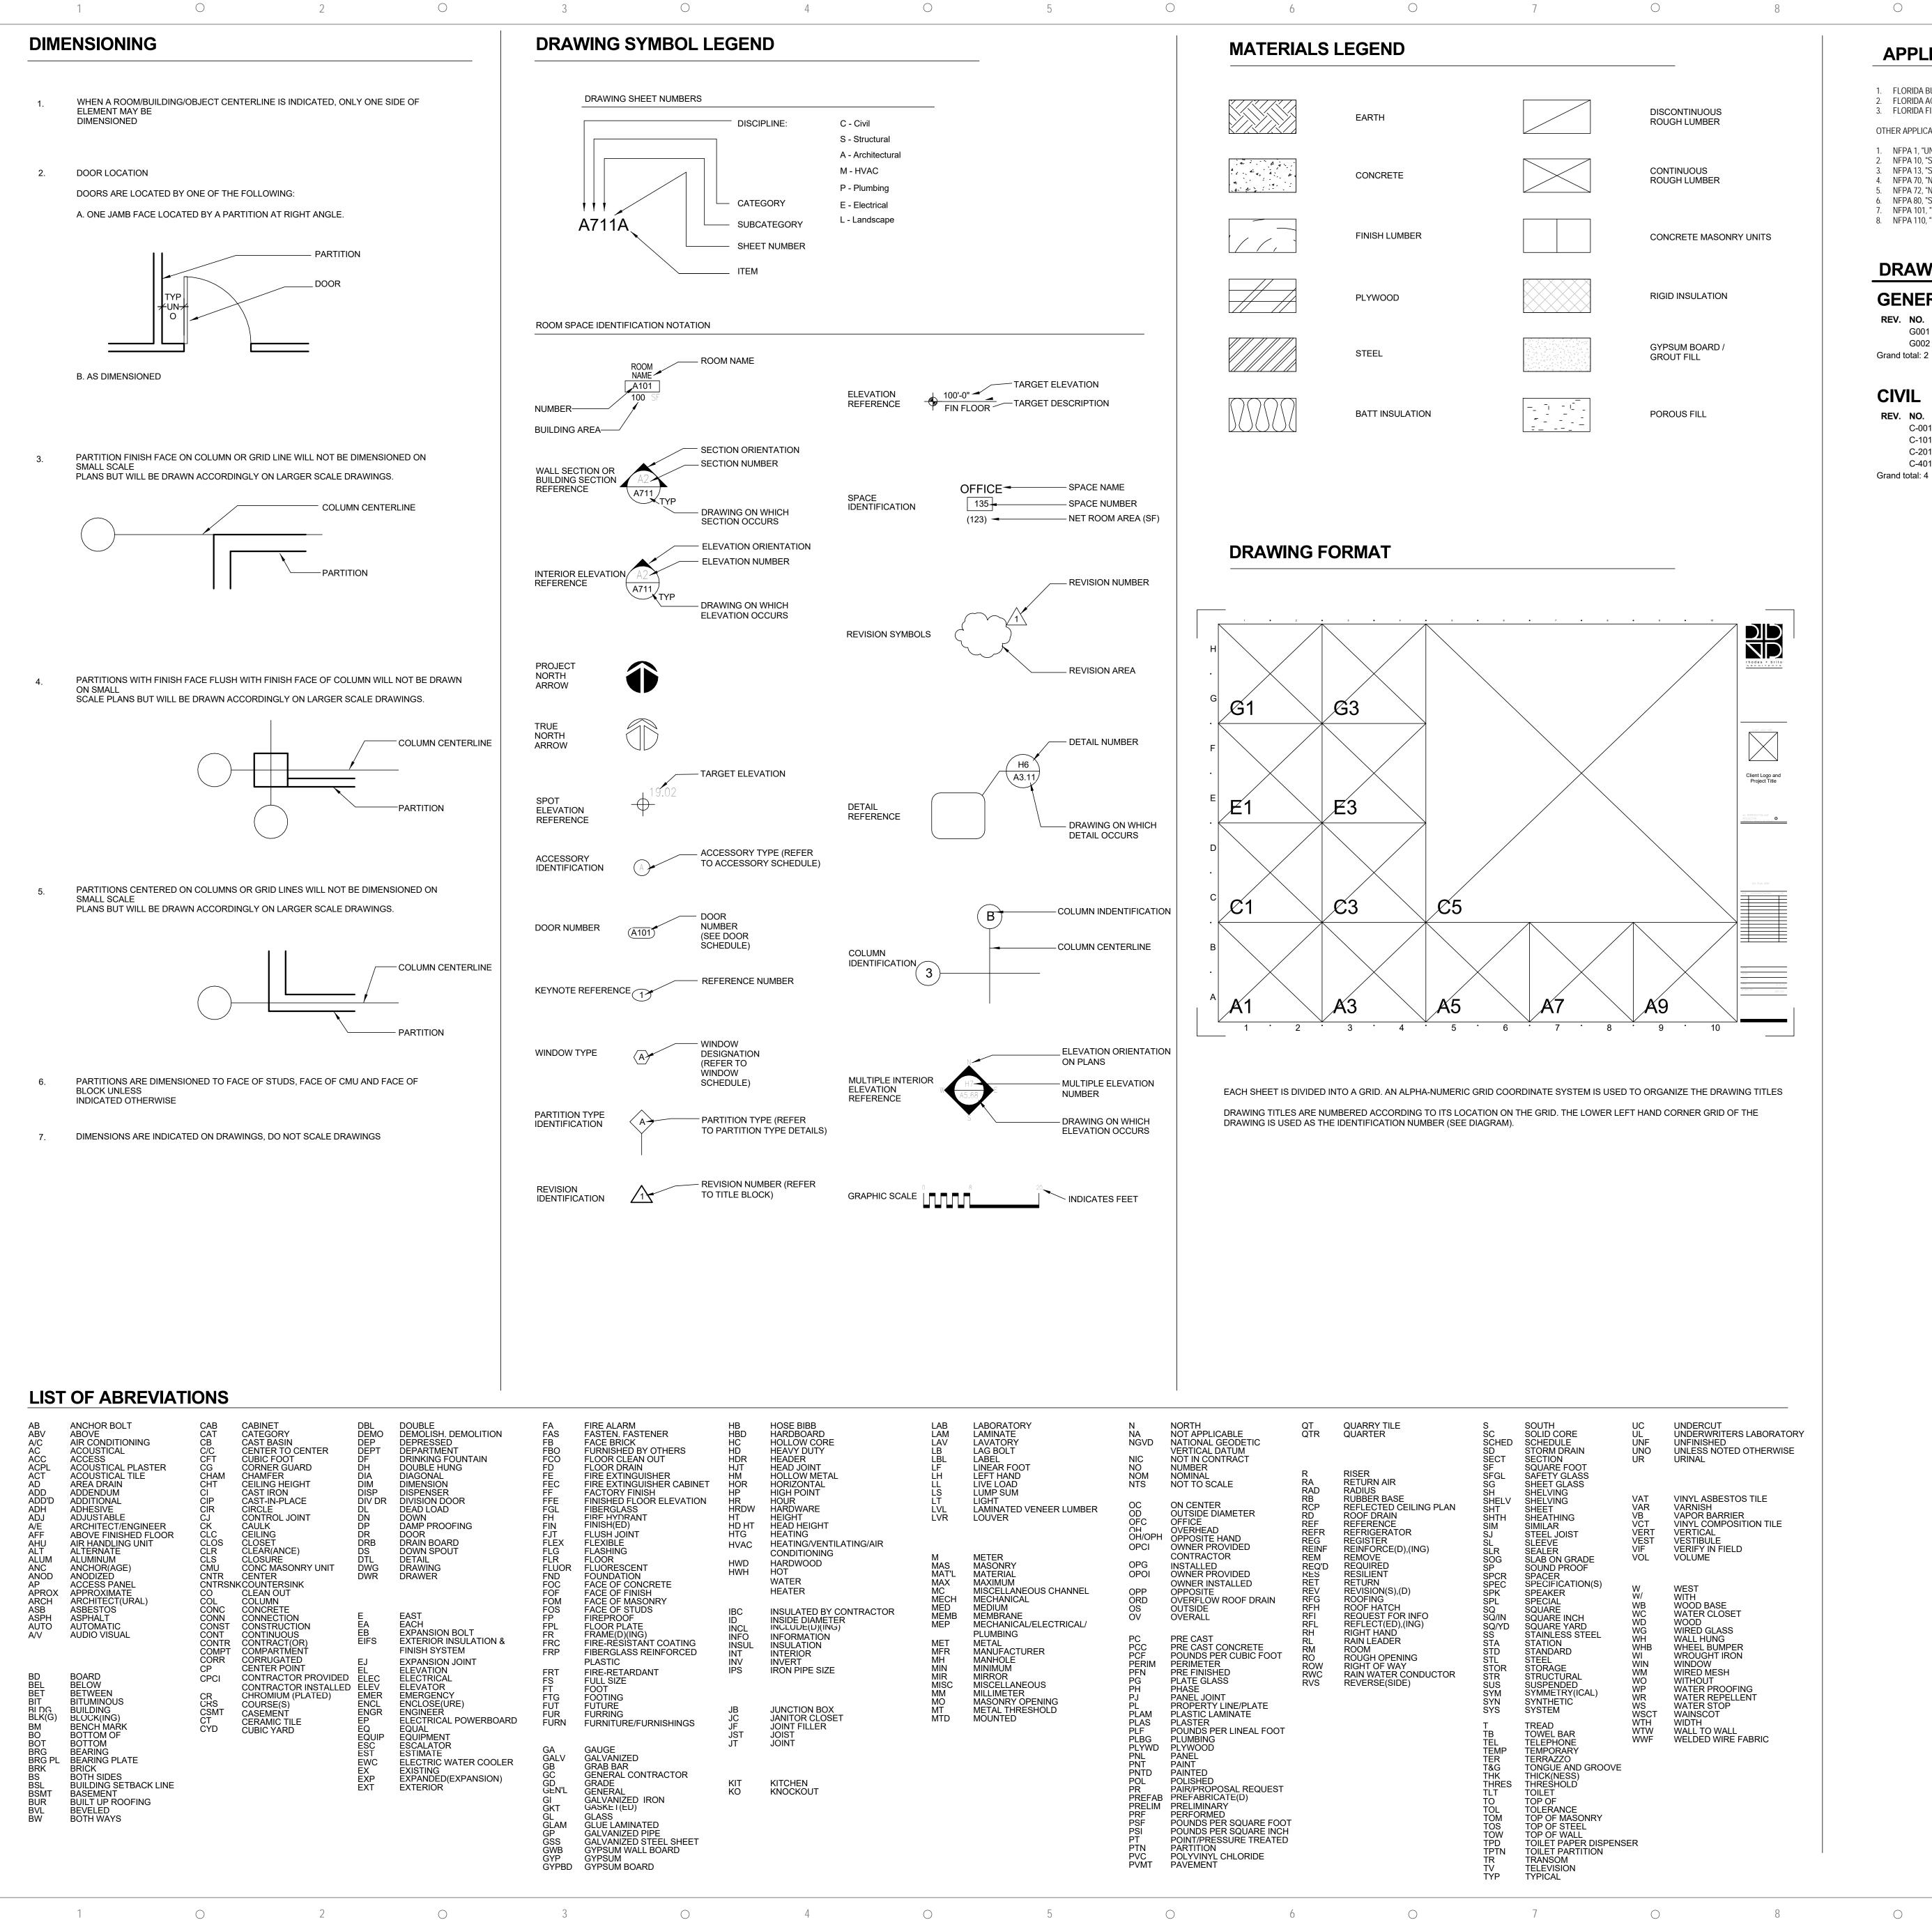- 1. FLORIDA BUILDING CODE (FBC) 2014 EDITION AND AMENDMENTS
- 2. FLORIDA ACCESSIBILITY CODE 2014 EDITION
- 3. FLORIDA FIRE PREVENTION CODE (FFPC) 2014, 5TH EDITION OTHER APPLICABLE CODE CRITERIA, BUT NOT LIMITED TO THE FOLLOWING:
- 1. NFPA 1, "UNIFORM FIRE CODE," 2012 ED. AS MODIFIED BY FFPC
- NFPA 10, "STANDARD FOR PORTABLE FIRE EXTINGUISHERS," 2013 EDITION
- NFPA 13, "STANDARD FOR THE INSTALLATION OF SPRINKLER SYSTEMS," 2013 EDITION NFPA 70, "NATIONAL ELECTRICAL CODE," 2008 EDITION
- 5. NFPA 72, "NATIONAL FIRE ALARM CODE," 2013 EDITION 6. NFPA 80, "STANDARD FOR FIRE DOORS AND FIRE WINDOWS," 2013 EDITION
- NFPA 101, " LIFE SAFETY CODE," (LSC) 2012 ED., AS MODIFIED BY THE FFPC 8. NFPA 110, "STANDARD ON EMERGENCY AND STANDBY POWER SYSTEMS, 2013 EDITION.

DRAWING INDEX

GENERAL

SHEET NAME COVER SHEET

GENERAL INFORMATION AND DRAWING INDEX G002

- SHEET NAME DEMOLITION AND EROSION CONTROL PLAN SITE DEVELOPMENT PLAN
- GRADING AND DRAINAGE PLAN C-201 C-401 SITE DETAILS

rhodes + brito

ARCHITECTS

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OCSO SECTOR IV PARKING LOT DESIGN

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1/5/2017 12:33:00 PM

MOHAMED SHALABY

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DATE	SUBMISSION / REVISION	NO.

GENERAL INFORMATION AND DRAWING INDEX

SCALE:	12" = 1'-0"
DRAWN BY:	CK
CHECK BY:	AS
DATE:	JANUARY 6, 2017
PROJECT NUMBER:	15012-0013

DEMOLITION AND EROSION CONTROL PLAN SCALE: 1" = 20'



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1. UTILITY LOCATIONS SHOWN HEREON ARE BASED ON FIELD LOCATIONS OF MARKINGS BY SOUTHEASTERN SURVEYING & MAPPING CORP. FIELD MARKINGS ARE BASED ON SIGNALS RECEIVED FROM GROUND PENETRATING RADAR (GPR) AND ELECTRONIC EQUIPMENT. LOCATIONS ARE APPROXIMATE AND TEST HOLES SHOULD BE PERFORMED FOR VERIFICATION. 2. VERTICAL INFORMATION SHOWN HEREON REFERS TO ORANGE COUNTY BENCHMARK D-235-005, BEING A 3" BRASS DISK SET IN CONCRETE WITH AN ELEVATION OF 100.732

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STAMPED ON DISK BEING IN THE NATIONAL GEODETIC VERTICAL DATUM OF 1929 (NGVD 29). 3. HORIZONTAL FEATURES SHOWN ON THE MAP REFER TO A NATIONAL GEODETIC SURVEY POINT WITH DESIGNATION "GIS 0131 KAREN MCKEE", PID NUMBER AK7129 AND IS RELATIVE TO NORTH AMERICAN DATUM OF 1983 (NAD83), 2011 ADJUSTMENT, STATE PLANE COORDINATE SYSTEM, FLORIDA EAST ZONE. DISTANCES SHOWN ARE GRID DISTANCES.

SOIL EROSION AND SEDIMENTATION

CONTROL NOTES

- 1. ALL EROSION AND SEDIMENT CONTROL WORK SHALL CONFORM TO ORANGE COUNTY AND ST JOHNS RIVER WATER MANAGEMENT DISTRICT (SJRWMD).
- 2. EROSION AND SEDIMENT CONTROL MEASURES ARE TO BE PLACED PRIOR TO, OR AS THE
- FIRST STEP IN, CONSTRUCTION. 3. SOIL MATERIALS, SHALL BE CONTAINED, AND NOT ALLOWED TO COLLECT ON ANY
- OFF-PERIMETER AREAS OR IN WATERWAYS. THESE INCLUDE BOTH NATURAL AND MAN-MADE OPEN DITCHES, STREAMS, STORM DRAINS, LAKES AND POND. 4. DAILY INSPECTIONS SHALL BE MADE BY THE CONTRACTOR TO DETERMINE THE EFFECTIVENESS OF THESE EFFORTS. ANY NECESSARY REMEDIES SHALL BE PERFORMED
- WITHOUT DELAY. 5. ALL MUD, DIRT OR OTHER MATERIALS TRACKED OR SPILLED ONTO EXISTING STATE-COUNTY-CITY OR PRIVATE ROADS AND FACILITIES FROM THIS SITE, DUE TO
- CONSTRUCTION SHALL BE PROMPTLY REMOVED BY THE CONTRACTOR/BUILDER. 6. PERMANENT SOIL EROSION CONTROL MEASURES FOR ALL SLOPES, CHANNELS, DITCHES OR ANY DISTURBED LAND AREAS SHALL BE COMPLETED WITHIN (15) FIFTEEN CALENDAR DAYS AFTER FINAL GRADING. WHEN IT IS NOT POSSIBLE TO PERMANENTLY PROTECT A DISTURBED AREA IMMEDIATELY AFTER GRADING OPERATIONS, TEMPORARY EROSION CONTROL MEASURES SHALL BE INSTALLED. ALL TEMPORARY PROTECTION SHALL BE MAINTAINED UNTIL PERMANENT MEASURES ARE IN PLACE AND ESTABLISHED. A CERTIFICATE OF COMPLIANCE WILL NOT BE ISSUED UNTIL THE ABOVE REQUIREMENTS
- EXISTING DRAINAGE SYSTEM AND INLETS SHALL BE PROTECTED BY USING FILTER FABRIC PLACED AROUND INLETS AND BENEATH GRATES.

SITE DEMOLITION NOTES

HAVE BEEN MET.

- 1. ALL DEMOLITION AND CONSTRUCTION ACTIVITY WILL BE ACCOMPLISHED IN APPROPRIATE
- PHASES IN ORDER TO KEEP EXISTING FACILITY OPERATIONAL. 2. DISPOSAL OF ALL MATERIAL LEAVING THE SITE WILL BE ON HAUL ROUTES, AND BY METHODS
- AS APPROVED BY OWNER.
- COORDINATE LOCATION OF CONTRACTOR STAGING AREA WITH OWNER CONSTRUCTION REPRESENTATIVE. 4. ALL PROPERTY AFFECTED BY THIS WORK SHALL BE RESTORED TO A CONDITION EQUAL TO OR BETTER THAN EXISTED UNLESS SPECIFICALLY EXEMPTED BY THE PLANS. THE
- COST FOR SUCH RESTORATION SHALL BE INCIDENTAL TO OTHER CONSTRUCTION AND NO EXTRA COMPENSATION WILL BE ALLOWED.
- 5. ALL SURVEY DATA USED AND CONDITIONS ASSUMED TO BE PRESENT IN PREPARATION OF THESE PLANS WAS PROVIDED BY SOUTHEASTERN SURVEYING & MAPPING, INC.
- 6. CONTRACTOR SHALL CLEAN THE CONSTRUCTION AREA OF ALL DEBRIS, AGGREGATES, ETC. ALL WASTE MATERIAL SHALL BE REMOVED FROM SITE AND DISPOSED OF IN A LEGAL MANNER.
- 7. CONTRACTOR SHALL PROTECT THE EDGE OF ALL REMAINING PAVEMENT AND HARDSCAPE. DO NOT HAUL OVER UNPROTECTED PAVEMENT OR SAWCUT EDGES.
- 8. CONTRACTOR SHALL VERIFY LOCATION OF ALL UNDERGROUND UTILITIES AND IMPROVEMENTS PRIOR TO START OF CONSTRUCTION.
- 9. CONTRACTOR WILL BE RESPONSIBLE FOR REMOVAL AND REPLACEMENT OF EXISTING SITE IMPROVEMENTS
- AS REQUIRED FOR MILLING OPERATION. THIS MAY INCLUDE FENCING, PAVEMENT MARKERS, WHEEL STOPS, ETC. 10. NOISE LEVELS AND HOURS OF DEMOLITION OPERATIONS SHALL BE AS DIRECTED BY
- 11. CONTRACTOR SHALL RECORD CONFIGURATION OF EXISTING STRIPING ON SITE AND BE
- RESPONSIBLE FOR LAYOUT AND RESTRIPING UPON COMPLETION OF PROJECT.
- 12. REMOVE AND REPLACE ANY DAMAGED CONCRETE CURB AS NOTED WITHIN PROJECT
- 13. EXISTING SITE MAY CONTAIN ABOVE AND BELOW GROUND IMPROVEMENTS NOT DEPICTED ON THIS PLAN. CONTRACTOR SHALL VERIFY SITE CONDITIONS WITH OWNER'S REPRE-SENTATIVE AND BE RESPONSIBLE FOR REMOVAL OR RELOCATION OF EXISTING IMPROVE-MENTS INTERFERING WITH NEW DEVELOPMENT.

PAVING NOTES:

- 1. CONTRACTOR SHALL MILL EXISTING PAVEMENT AS REQUIRED FOR PLACEMENT OF NEW WEARING COARSE. MILLING AND PAVING OPERATION SHALL BE CONDUCTED IN APPROPRIATE PHASES IN ORDER TO UTILIZE THE EXISTING PARKING AREA BY THE USER.
- 2. PROTECT EXISTING IMPROVEMENTS DURING MILLING OPERATION. MINIMUM MILL DEPTH IS 1.5", HOWEVER THE DEPTH SHALL BE INCREASED WHERE REQUIRED FOR REPAIR TO EXISTING BASE, PAVING, AND ELIMINATION OF DRAINAGE BIRD BATHS.
- 3. IF EXISTING BASE IS EXPOSED DURING MILLING OPERATION, CONTRACTOR SHALL PROTECT EXISTING BASE BY APPLICATION OF PRIME COAT TO EXPOSED BASE, WITHIN THE SAME DAY AS THE EXPOSURE.
- 4. ALL MILLING AND RESURFACING OPERATION SHALL COMPLY WITH LATEST FDOT STANDARD SPECIFICATIONS FOR ROADWAY LEGEND AND BRIDGE CONSTRUCTION.

NECESSARY WORK TO MATCH EXISTING GRADES AT SITE IMPROVEMENTS SHALL BE THE RESPONSIBILITY OF CONTRACTOR. ASPHALT PAVEMENT

	AND BRIDGE CONSTRUCTION.	<u> </u>
5	CONTRACTOR HAS THE OPTION OF REMOVING EXISTING ASPHALT PAVEMENT BY MECHANICAL MEANS IN ITS ENTIRETY.	
٥.	CONTRACTOR THAT THE OF HOR OF REMOVING EXISTING ASTRIALT FAVEWENT BY MECHANICAL WEARS IN 113 ENTIRETY,	
	HOWEVER ANY COSTS ASSOCIATED WITH REMOVAL OF ENTIRE SURFACE COARSE, REPAIR OF DAMAGED BASE, AND	
	TIOMEVER AIN COSTS ASSOCIATED WITH REMIDIAL OF ENTINE SORTAGE COARSE, REFAIR OF DAMAGED DASE, AND	

PHASING NOTES				
CONTRACTOR IS RESPONSIBLE FOR MAIN CONSTRUCTION. CONTRACTOR SHALL MA BY USE OF BARRICADES, TEMPORARY W	INTAIN VEHICULAR AND PEDE		-SITE DURING	
CONTRACTOR SHALL COORDINATE CONST	RUCTION PHASING WITH OWN	JER'S REPRESENTATIVE	CONSTRUCTION I	PHASING

- SHALL BE CONDUCTED IN A MANNER AS ACCEPTABLE TO OCCP. 3. CONTRACTOR SHALL MAINTAIN UTILITY SERVICE TO EXISTING BUILDING DURING ENTIRE CONSTRUCTION PERIOD. CONTRACTOR SHALL PROVIDE ALL TEMPORARY MEASURES AS
- 4. ACCESS TO EXIST. FACILITY SHALL BE MAINTAINED DURING ENTIRE CONSTRUCTION


PROJECT SCOPE

PROJECT SCOPE CONSISTS OF MILLING AND RESURFACING OF EXIST.

ASPHALT PAVEMENT (MILLING	AREA)	
CONCRETE CURB		====
CONCRETE WALK		
FENCE		
POWER POLE	J PP	
LIGHT POLE	X	
FIRE HYDRANT	FH	
TREE	\odot	Ø
FINISH GRADE	38°.	
STORM DRAIN LINE	———— SD ————	
STORM DRAIN INLET		
STORM M.H.		
SAN. SEWER LINE	SS	
SAN. SEWER MH	(5)	



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Consultants

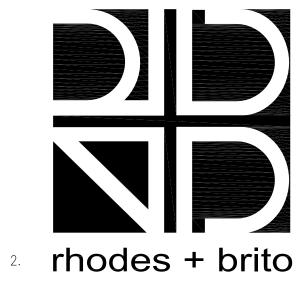OCSO SECTOR IV PARKING LOT DESIGN

> 2400 W. 33RD ST ORLANDO, FL 32839


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TO BE REMOVED

MAJID KALAGHCHI

PE41046

PERMIT DOCUMENTS

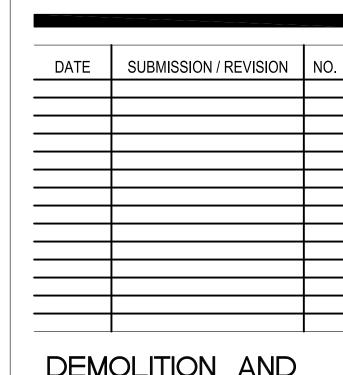

DEMOLITION AND **EROSION CONTROL**

SCALE:	1"=20
DRAWN BY:	JF
CHECK BY:	MK
DATE:	JANUARY 6, 2017
PROJECT NUMBER:	15012-0013

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- 1. ALL SURVEY DATA USED AND CONDITIONS ASSUMED TO BE PRESENT IN PREPARATION OF THESE PLANS WAS PROVIDED BY SOUTHEASTERN SURVEYING & MAPPING.
- 2. THE CONTRACTOR SHALL VERIFY AND LOCATE ALL VERTICAL AND HORIZONTAL CONTROL POINTS PRIOR TO CONSTRUCTION. IF ANY DISCREPANCIES SHOULD BE FOUND, THE CONTRACTOR SHALL NOTIFY THE ENGINEER AND SURVEYOR OF THE CONDITION IN WRITING PRIOR TO COMMENCING HIS CONSTRUCTION ACTIVITIES.

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- 3. ALL PAVEMENT OFFSETS, RADII AND DIMENSIONS SHOWN ARE TO PROPOSED EDGE OF PAVEMENT, UNLESS OTHERWISE NOTED.
- 4. THE CONTRACTOR SHALL STAKE ALL IMPROVEMENTS USING THE GEOMETRIC DATA PROVIDED. IT IS THE CONTRACTORS SOLE RESPONSIBILITY TO COMPLETELY STAKE AND CHECK ALL IMPROVEMENTS TO ENSURE ADEQUATE POSITIONING, BOTH HORIZONTAL AND VERTICAL, PRIOR TO THE INSTALLATION OF ANY IMPROVEMENTS.

GENERAL NOTES

- 1. TRAFFIC MARKINGS NOTES:
- A. ALL DRIVEWAYS EXITING ONTO ANY PUBLIC OR PRIVATE STREET MUST HAVE A TRAFFIC CONTROL DEVICE (30" STOP SIGN MOUNTED 7' ABOVE THE PEDESTRIAN VEHICLE TRAVEL WAY (MEASURED FROM BOTTOM OF SIGN) AND THROUGHOUT
- THE SITE AS NECESSARY FOR SAFETY.

 B. ALL SIGN INSTALLATIONS SHALL COMPLY WITH SIZE, LOCATION AND HEIGHT (7')

 AS OUTLINED IN THE "MITTER"
- AS OUTLINED IN THE "MUTCD."

 C. PAVEMENT MARKINGS GENERAL PRINCIPLES (SECTION 3A-5):

 1. PARKING LOT PAVEMENT MARKINGS SHALL BE WHITE PAINTED (DIRECTIONAL ARROWS, STOP BARS, LINES DESIGNATING PARKING
- SPACES AND HANDICAPPED PARKING SYMBOLS).

 D. ALL HANDICAPPED PARKING SPACES MUST BE LEGALLY SIGNED WITH ONE REGULATION HANDICAP SIGN AND ONE WHITE PAVEMENT MARKING SYMBOL PER
- E. A 24" STOP BAR SHALL BE PROVIDED AT ALL POINTS OF EGRESS IN CONFORMANCE WITH FDOT #17346, DRAWING #3 OF 8.
- 2. HANDICAP RAMPS SHALL COMPLY WITH FLORIDA DEPARTMENT OF TRANSPORTATION ROADWAY AND TRAFFIC DESIGN STANDARDS INDEX NO. 0304. AND ORANGE COUNTY REQUIREMENTS WITH TRUNKATED DOME MATS.
- 3. ALL CONSTRUCTION SHALL COMPLY WITH FDOT SPECIFICATIONS FOR ROADWAY AND BRIDGE CONSTRUCTION LATEST EDITION AND STANDARDS OF ORANGE COUNTY.

PAVING NOTES

- 1. CONTRACTOR IS RESPONSIBLE FOR SUBMISSION OF PRODUCT DATA, DESIGN MIX, METHOD OF APPLICATION, ETC. TO OWNER'S
- REPRESENTATIVE FOR REVIEW AND APPROVAL PRIOR TO START OF CONSTRUCTION.

 2. COORDINATE LOCATION OF CONTRACTOR STAGING AREA WITH OWNER'S REPRESENTATIVE.
- 3. ALL PAVEMENT MARKINGS SHALL CONFORM TO MANUAL ON UNIFORM TRAFFIC CONTROL DEVICES AND FDOT SPECIFICATIONS. ALL NEW PAVEMENT MARKINGS ARE TO BE INSTALLED IN ACCORDANCE WITH FDOT INDEX NO. 710.
- 4. CONTRACTOR SHALL APPLY TACK COAT IN ACCORDANCE WITH FDOT SECTION 300 PRIOR TO PLACEMENT OF OVERLAY.
 5. MILLING OPERATION SHALL COMPLY WITH FDOT STANDARD SPECIFICATIONS FOR ROADWAY CONSTRUCTION, SECTION 327.
- 6. EXISTING ASPHALT PAVEMENT SHALL BE A MINIMUM OF 1.5" TYPE S3 (SP9.5) ASPHALT SURFACE COURSE IN ACCORDANCE WITH
- 7. CLEAN EXISTING ASPHALT PAVEMENT OF ALL LOOSE MATERIAL, GRAVEL, AND FOREIGN MATTER BY BROOMING AND VACUUMING PRIOR TO APPLICATION OF TACK COAT OR ASPHALT OVERLAY.
- 8. CONTRACTOR SHALL CLEAN THE CONSTRUCTION AREA OF ALL DEBRIS, AGGREGATES, ETC. ALL WASTE MATERIAL SHALL BE REMOVED FROM SITE AND DISPOSED OF IN A LEGAL MANNER.
- 9. FINAL STRIPING TO BE TWO COATS OF LATEX BASE TRAFFIC PAINT.

 10. CONTRACTOR SHALL RECORD CONFIGURATION OF EXISTING STRIPING WITHIN AREAS TO RECEIVE OVERLAY, AND BE RESPONSIBLE FOR
- 11. REPLACE ANY DAMAGED WHEEL STOPS AND CURBING WITHIN AREAS OF WORK.
 12. CONTRACTOR SHALL ENSURE POSITIVE DRAINAGE WHERE PROPOSED ASPHALT OVERLAY ABUTS EXISTING ASPHALT BY MILLING
- AND/OR FEATHERING TO MINIMIZE BIRD BATHS.
- 13. ENSURE POSITIVE DRAINAGE BY MATCHING EXISTING DRAINAGE PATTERN WHERE NECESSARY DUE TO EXISTING BIRD BATHS/DAMAGED PAVEMENT. CONTRACTOR SHALL REPAIR THESE AREAS PRIOR TO OVERLAY TO CORRECT ANY DRAINAGE ISSUES.
- 14. CONTRACTOR HAS THE OPTION OF REMOVING EXISTING ASPHALT PAVEMENT BY MECHANICAL MEANS IN ITS ENTIRETY, HOWEVER
 ANY COSTS ASSOCIATED WITH REMOVAL OF ENTIRE SURFACE COARSE, REPAIR OF DAMAGED BASE, AND NECESSARY WORK TO MATCH
- EXISTING GRADES AT SITE IMPROVEMENTS SHALL BE THE RESPONSIBILITY OF CONTRACTOR.

 15. ANY EXPOSED BASE COARSE DURING MILLING AND/OR ASPHALT REMOVAL OPERATION SHALL BE PRIME COATED WITHIN THE SAME DAY. AVOID EXPOSRE OF BASE COARSE TO THE ELEMENTS.

ADDITIONAL NOTES/SEPCS

FDOT STANDARD SPECIFICATIONS SECTION 331.


- 1. PERMITS: THE CONTRACTOR SHALL OBTAIN THE NECESSARY PERMITS (ORANGE COUNTY, "RIGHT-OF-WAY UTILIZATION PERMIT", AND OTHER APPLICABLE AUTHORIZATION), PRIOR TO ANY ROADWAY WORK. ADDITIONALLY, THE CONTRACTOR SHALL PROVIDE ADVANCE NOTICE TO THE APPROPRIATE AUTHORITY, AS REQUIRED, PRIOR TO CONSTRUCTION OPERATIONS.
- 2. PROTECTION OF EXISTING IMPROVEMENTS: THE CONTRACTOR SHALL BE RESPONSIBLE FOR THE PROTECTION OF ALL PAVEMENTS, AND OTHER IMPROVEMENTS WITHIN THE WORK AREA. ALL DAMAGE TO SUCH IMPROVEMENTS, AS A RESULT OF THE CONTRACTOR'S OPERATIONS, BEYOND THE LIMITS OF THE WORK OF PAVEMENT REPLACEMENT AS DESCRIBED HEREIN, SHALL BE REPAIRED BY THE CONTRACTOR AT HIS EXPENSE
- 3. STREET OR ROADWAY PAVEMENT CUT AND REMOVED IN CONNECTION WITH TRENCH EXCAVATION SHALL BE REPLACED OR RESTORED IN EQUAL OR BETTER CONDITION THAN THE ORIGINAL AND AS SHOWN ON THE DRAWINGS. THE DRAWINGS INDICATE MINIMUM REQUIREMENTS.
- 4. MATERIALS, INCLUDING SOIL CEMENT, BITUMINOUS PRIME AND TACK COAT, AND ASPHALTIC CONCRETE FOR THE ABOVE WORK SHALL MEET THE REQUIREMENTS ESTABLISHED THEREFORE BY THE FDOT SPECIFICATIONS.
 BITUMINOUS PRIME COAT MATERIAL SHALL BE CUTBACK ASPHALT GRADE RC-70.
 BITUMINOUS TACK COAT MATERIAL SHALL BE EMULSIFIED ASPHALT GRADE RS-2.
- ASPHALTIC CONCRETE SHALL BY TYPE SP9.5.
- 5. PAVEMENT REMOVAL:

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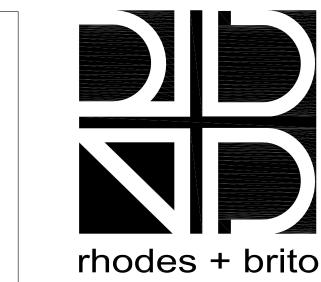
- a. WHERE EXISTING PAVEMENT IS TO BE REMOVED, THE SURFACING SHALL BE MECHANICAL SAW CUT PRIOR TO REMOVAL, MILLING AND TRENCH EXCAVATION, LEAVING A UNIFORM AND STRAIGHT EDGE, WITH MINIMUM DISTURBANCE TO THE REMAINING ADJACENT SURFACING. IMMEDIATELY FOLLOWING THE SPECIFIED BACKFILLING AND COMPACTION, A TEMPORARY SAND SEAL COAT SURFACE SHALL BE APPLIED TO THE CUT AREAS. THIS TEMPORARY SURFACING SHALL PROVIDE A SMOOTH TRAFFIC SURFACE WITH THE EXISTING ROADWAY AND SHALL BE MAINTAINED UNTIL FINAL RESTORATION. FOLLOWING THE ABOVE OPERATION, THE CONTRACTOR SHALL PROCEED IMMEDIATELY WITH FINAL PAVEMENT RESTORATION IN ACCORDANCE WITH THE REQUIREMENTS SET FORTH IN THE SEMINOLE COUNTY, "RIGHT—OF—WAY UTILIZATION REGULATIONS", AND THESE STANDARDS.
- 6. PAVEMENT RESTORATION ASPHALT:
- a. SOIL CEMENT BASE COURSE SHALL BE COMPACTED FOR ITS FULL THICKNESS TO NOT LESS THAN 95 PERCENT OF MAXIMUM DENSITY AS DETERMINED BY AASHTO DESIGNATION T-180. FIELD DENSITY OF SOIL CEMENT BASE IN PLACE SHALL BE DETERMINED BY AASHTO DESIGNATION T-191 OR ASTM DESIGNATION D2922.
- b. CONSTRUCTION METHODS AND EQUIPMENT SHALL GENERALLY MEET THE REQUIREMENTS THEREFORE AS ESTABLISHED IN THE FDOT SPECIFICATIONS, BUT SHALL BE MODIFIED TO MEET THE RELATIVELY NARROW STRIP CONSTRUCTION CONDITIONS. ANY SUCH MODIFICATIONS SHALL BE APPROVED BY THE ENGINEER PRIOR TO THEIR USE.
 c. AFTER THE APPLICATION OF THE PRIME COAT ON THE BASE, THE PRIME COAT SHALL BE ALLOWED TO CURE WITHOUT SANDING FOR A PERIOD OF 24—HOURS. THE CONTRACTOR SHALL TAKE ALL NECESSARY PRECAUTIONS TO PROTECT THE PRIMED SURFACE AGAINST DAMAGE DURING THIS INTERVAL. IF, AT THE END OF 24—HOURS, IT IS NOT PROPOSED TO
- APPLICATION OF CLEAN SAND AND OPENED TO TRAFFIC.

 d. JOINTS WITH EXISTING SURFACE AND BASE SHALL BE STRAIGHT AND NEAT. IF NECESSARY TO OBTAIN A STRAIGHT NET JOINT, THE CONTRACTOR SHALL CUT OUT SUFFICIENT EXISTING MATERIAL AND REPLACE IT WITH NEW MATERIAL.

PROCEED AT ONCE WITH THE APPLICATION OF THE SURFACE COURSE, PRIMED SURFACE SHALL BE GIVEN A LIGHT

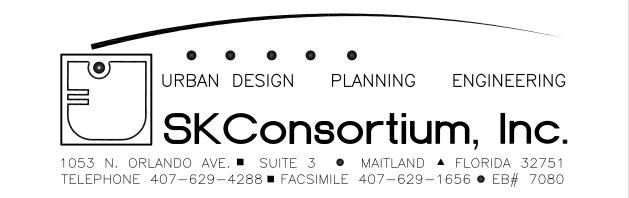

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OCSO SECTOR IV
PARKING LOT
DESIGN

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	<u> </u>		
DATE	SUBMISSION / REVISION	NO.	
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OIT			
5116	SITE DEVELOPMENT		

SCALE: 1"=20"

DRAWN BY: JF

CHECK BY: MK

DATE: JANUARY 6, 2017


PLAN

PROJECT NUMBER:

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15012-0013


SCALE: 1" = 20'

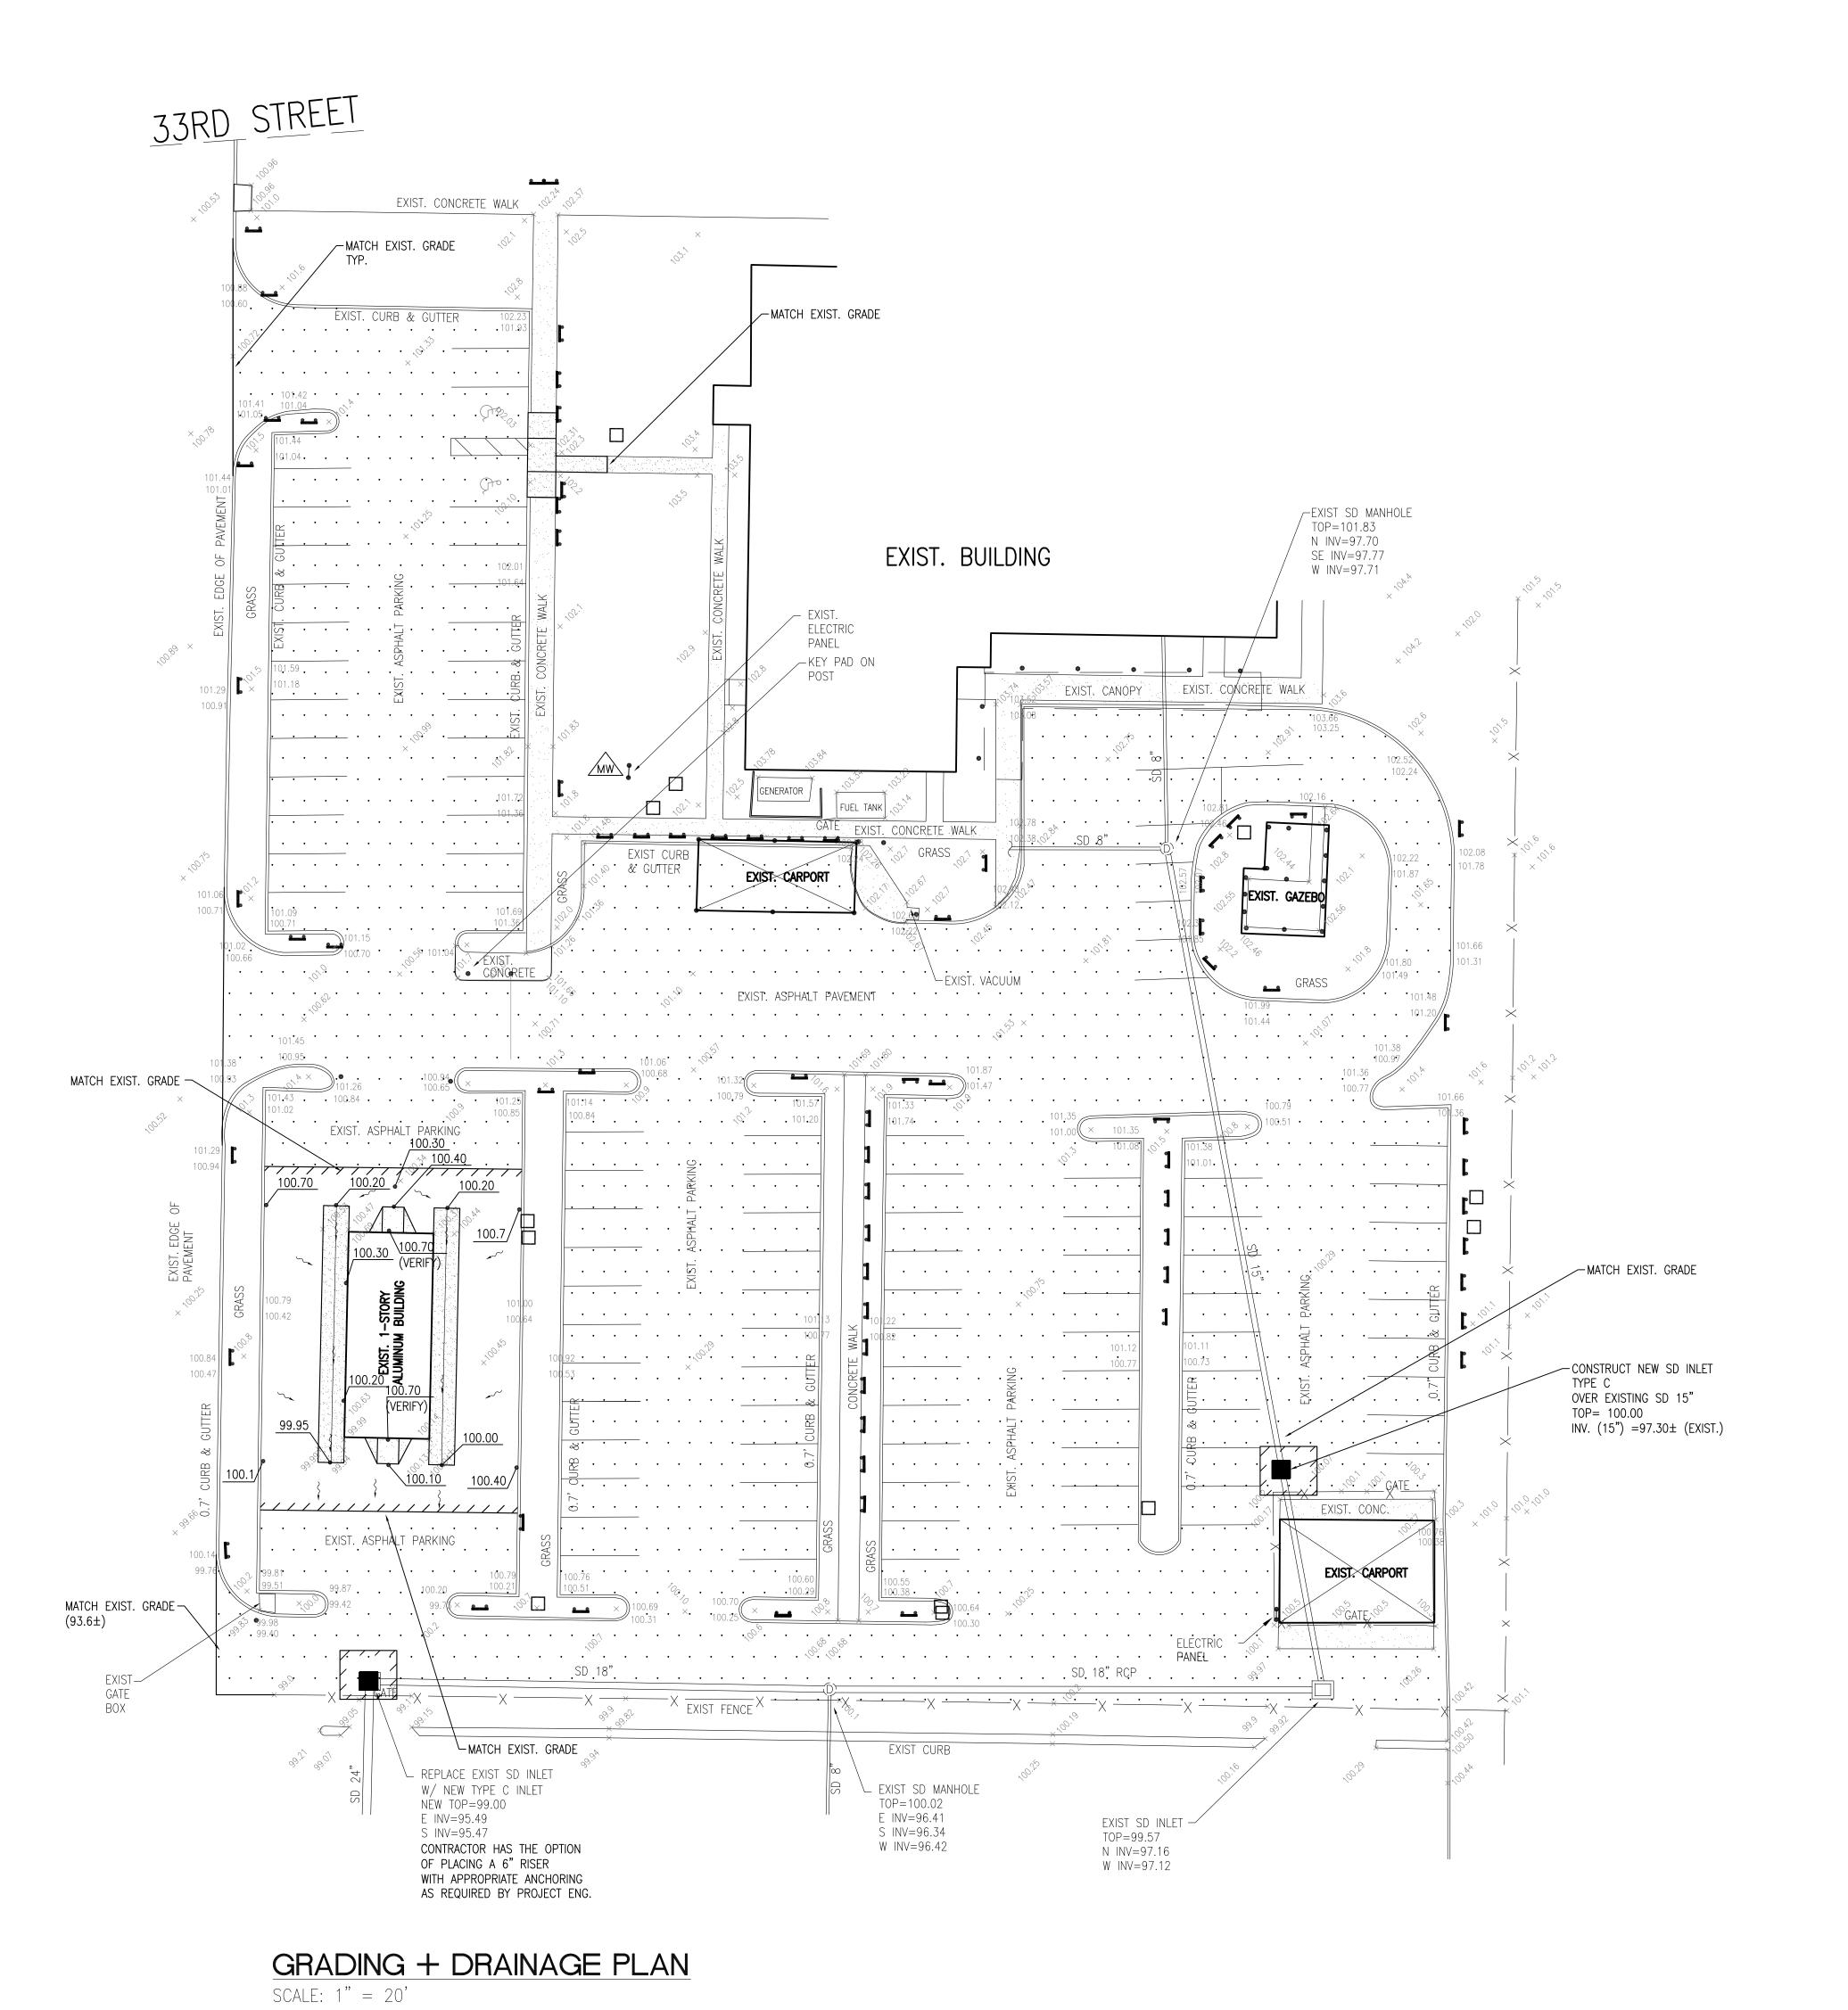

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GENERAL NOTES:

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- 1. PRIOR TO CONSTRUCTION THE CONTRACTOR SHALL VERIFY LOCATION AND INVERTS OF EXISTING UTILITIES AT PROPOSED CROSSING AND POINTS OF CONNECTION. THE
- CONTRACTOR SHALL NOTIFY THE ENGINEER IMMEDIATELY OF ANY UTILITY CONFLICTS.

 2. COMPLY WITH FLORIDA DEPT. OF TRANSPORTATION ROADWAY & TRAFFIC DESIGN
- STANDARDS ON THE FOLLOWING:

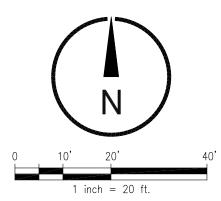 2.A. STORM DRAIN INLET TYPE "C" & "E": INDEX No. 232 (PROVIDE STEEL ANGLE FOR GRATE SEAT FOR INLETS IN TRAFFIC AREAS)
- 2.B. TYPE "V" GUTTER INLET INDEX No. 221 2.C. TYPE "P AND J" MANHOLE INDEX NO. 200
- 2.D. TYPE "F" INLET INDEX NO. 233
 3. REFER TO SHEET COO1 FOR EROSION & SEDIMENTATION CONTROL DURING
- CONSTRUCTION.
 4. ALL DISTURBED AREAS SHALL BE SODDED. SEE LANDSCAPE PLANS FOR MINIMUM
- EXTENT OF SODDING ON—SITE

 5. ALL STORM DRAIN INLETS LOCATED IN VEHICULAR TRAFFIC AREAS SHALL RECEIVE
 A STEEL ANGLE GRATE SEAT. ALL GRATES SHALL BE TRAFFIC RATED. SITE IS NOT
 LOCATED WITHIN THE 100YR. FLOOD PRONE AREA.

OCSO SECTOR IV PARKING LOT DESIGN

rhodes + brito

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DATE SUBMISSION / REVISION NO.

GRADING + DRAINAGE PLAN


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JANUARY 6, 2017
15012-0013

C201


EXIST.

FINISH GRADE
FLOW PATTERN
CONTOUR
STORM DRAIN INIET
STORM DRAIN LINE
STORM MANHOLE

URBAN DESIGN PLANNING ENGINEERING
SKConsortium, Inc.
1953 N. ORLANDO AVE. SUITE 3 MAITLAND A FLORIDA 32751
TELEPHONE 407-629-4288 FACSIMILE 407-629-1656 EB# 7080

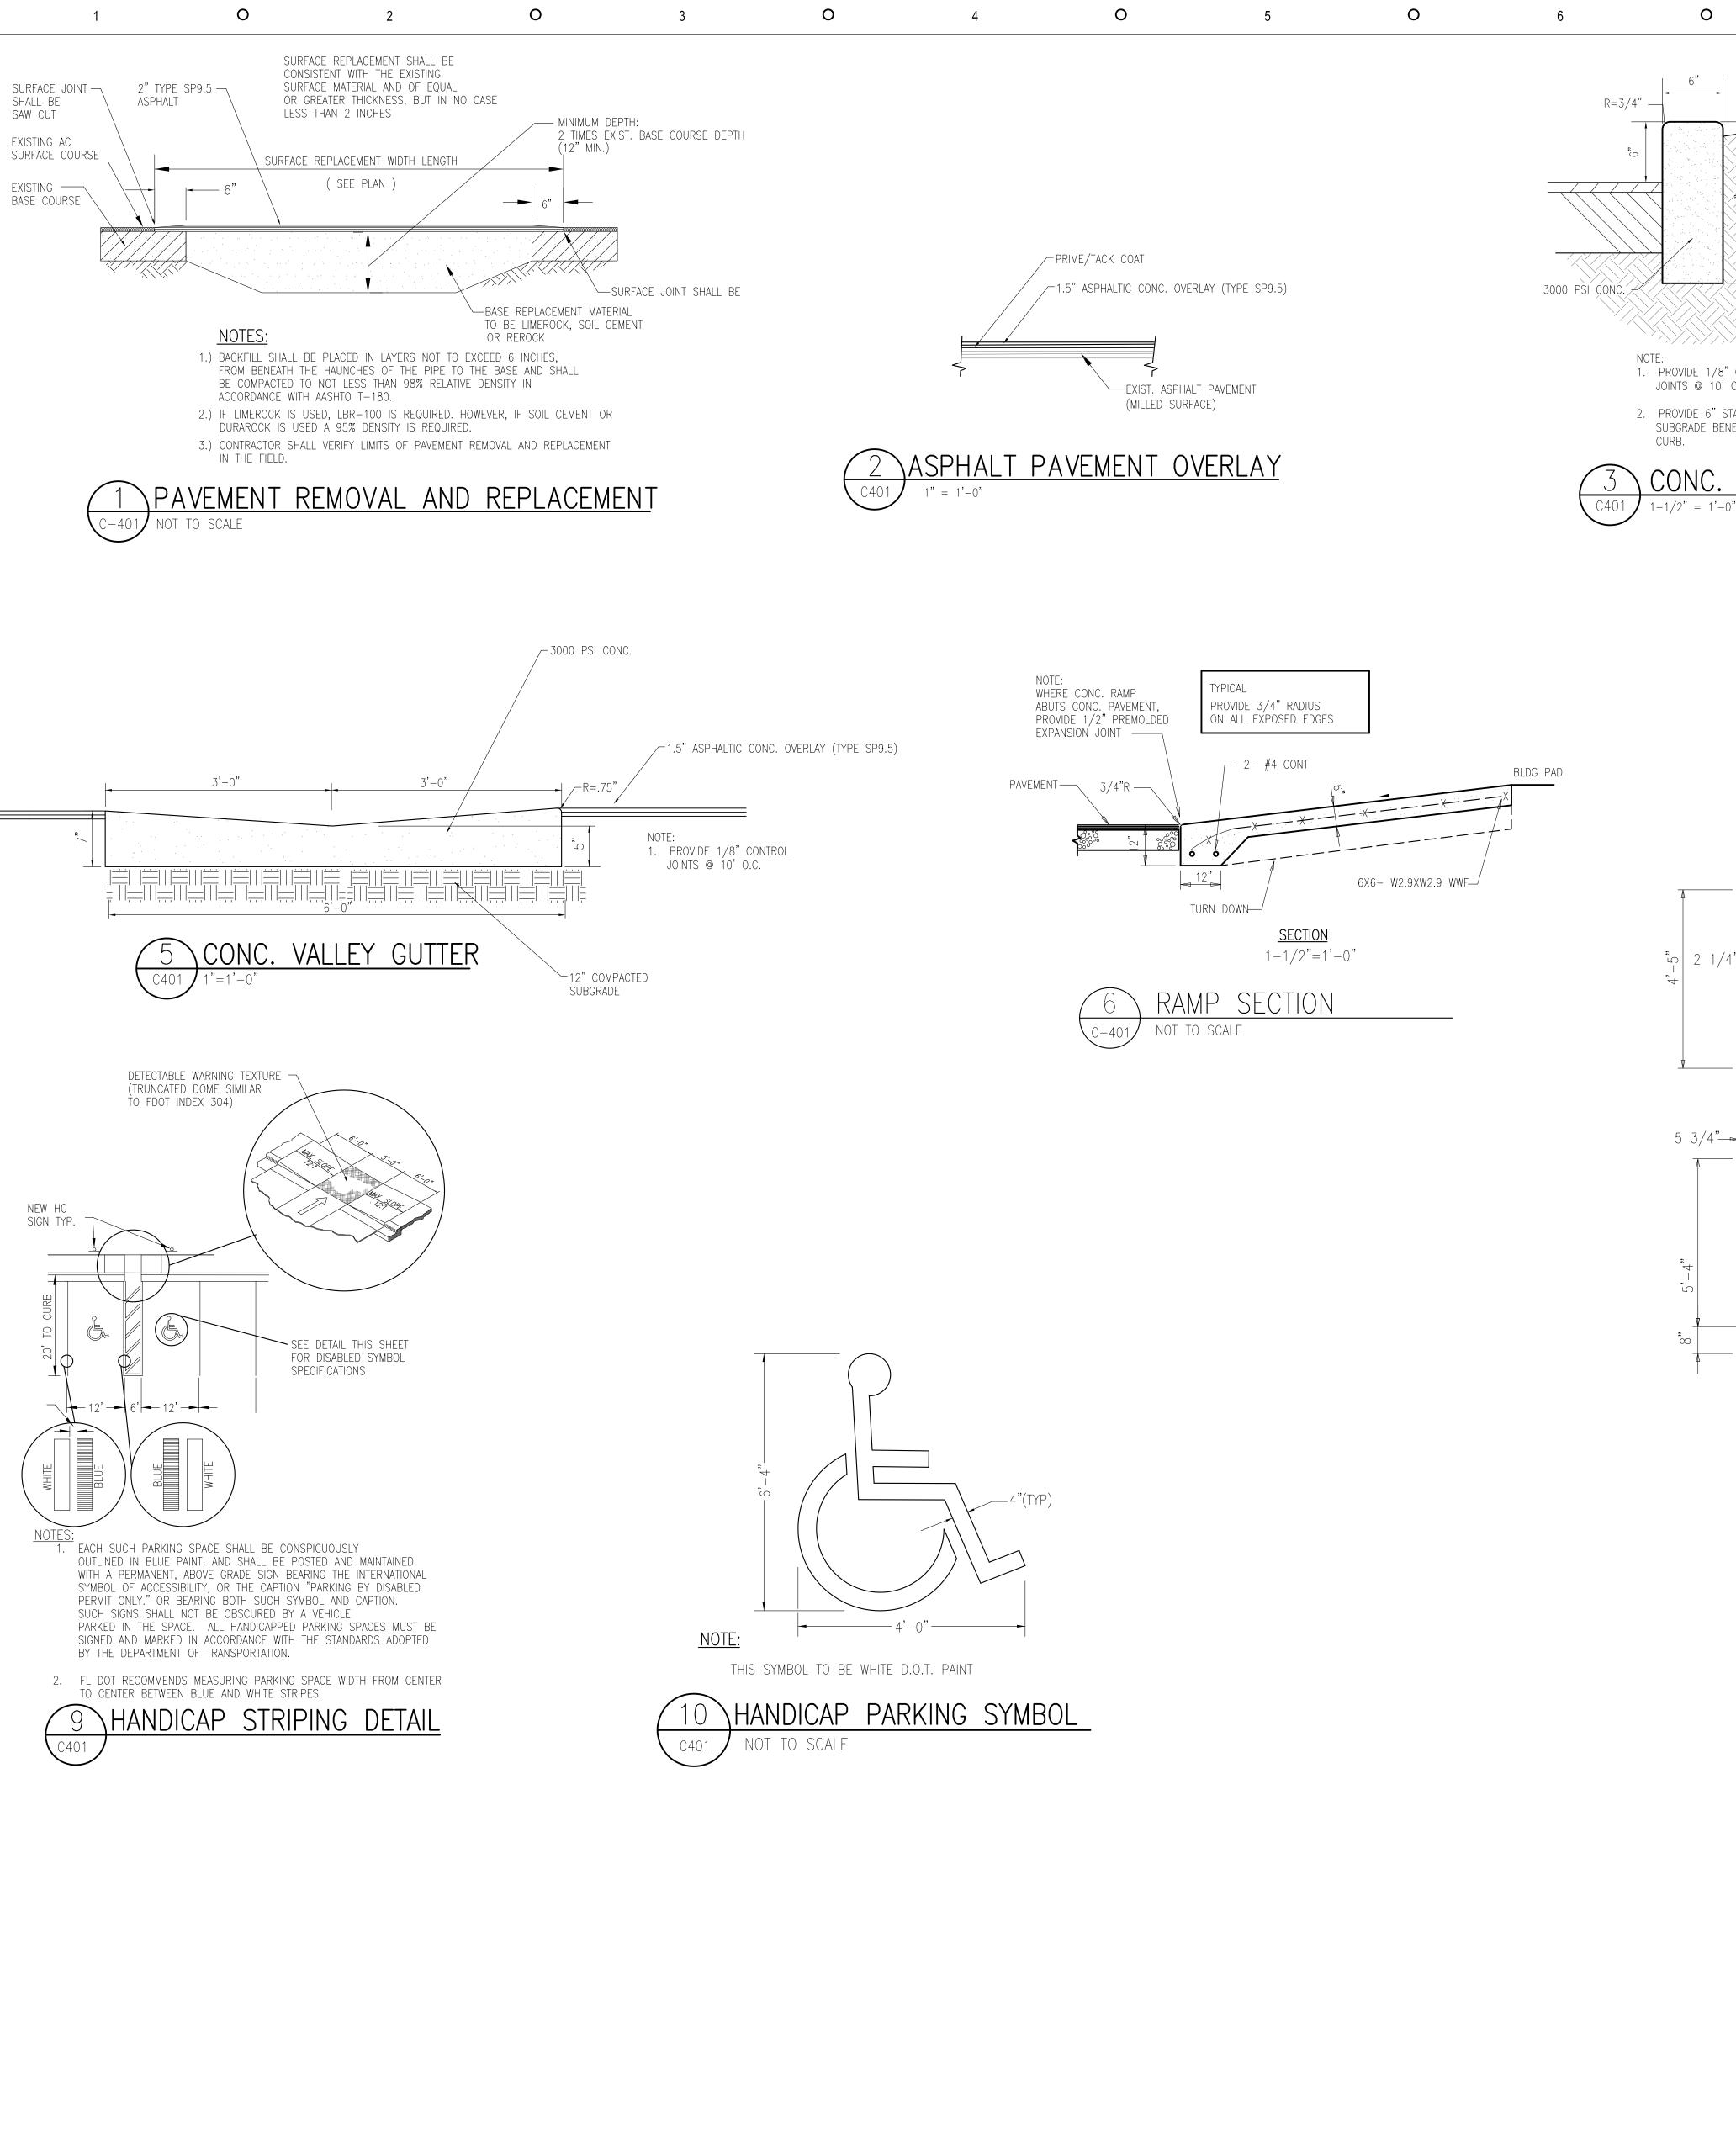

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APPROX. WEIGHT 235 LBS.
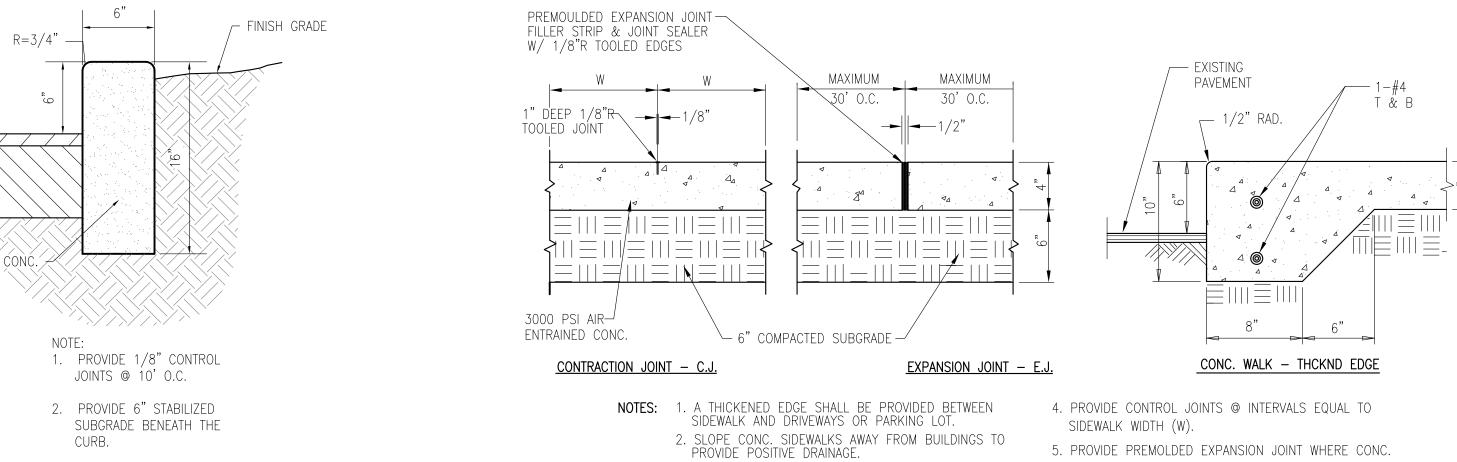
<u>→</u> 2 1/2"

____ NO. 4 BARS


PROVIDE STEEL ANGLE GRATE

SEAT AT ALL INLETS

@ 12" CTRS.

3. PROVIDE 2% CROSS SLOPE ON CONC. WALKS TYP.




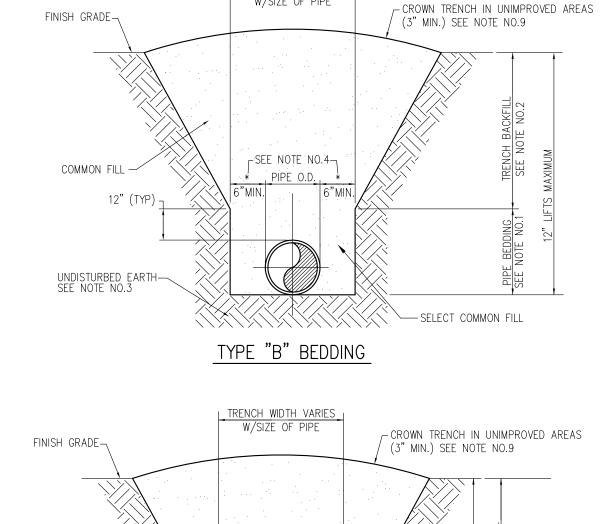

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WALK ABUTS BLDG., POLES, AND OTHER CONC. WALKS.

10

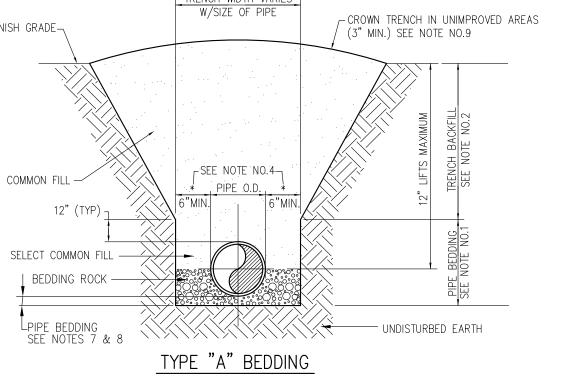


1. PIPE BEDDING: SELECT COMMON FILL COMPACTED TO 95% OF THE MAXIMUM DENSITY AS PER AASHTO T-180. 2. TRENCH BACKFILL: COMMON FILL COMPACTED TO 95% OF THE MAXIMUM DENSITY AS PER AASHTO T-180. 3. PIPE BEDDING UTILIZING SELECT COMMON FILL OR BEDDING ROCK IN ACCORDANCE WITH TYPE A BEDDING TO TO BE DETERMINED IN THE FIELD AS DIRECTED BY THE COUNTY.

4. (*): 15" MAX. FOR PIPE DIAMETER LESS THAN 24" AND 24" MAX. FOR PIPE DIAMETER 24" AND LARGER. 5. WATER SHALL NOT BE PERMITTED IN THE TRENCH DURING CONSTRUCTION. 6. ALL PIPE TO BE INSTALLED WITH BELL FACING UPSTREAM TO THE DIRECTION OF THE FLOW. 7. GRAVITY SEWERS SHALL UTILIZE TYPE A BEDDING, IF REQUIRED BY THE COUNTY. BEDDING DEPTH SHALL BE 4" MINIMUM FOR PIPE DIAMETER LESS THAN 15" AND 6" MINIMUM FOR PIPE DIAMETER 16" AND LARGER. 8. DEPTH FOR REMOVAL OF UNSUITABLE MATERIAL SHALL GOVERN DEPTH OF BEDDING ROCK BELOW THE PIPE. COUNTY SHALL DETERMINE IN THE FIELD REQUIRED REMOVAL OF UNSUITABLE MATERIAL TO REACH SUITABLE FOUNDATION. 9. FINAL RESTORATION IN IMPROVED AREAS SHALL BE IN COMPLIANCE WITH ALL APPLICABLE REGULATIONS OF GOVERNING AGENCIES. SURFACE RESTORATION WITHIN THE RIGHT-OF-WAY SHALL COMPLY WITH REQUIREMENTS OF RIGHT-OF-WAY UTILIZATION REGULATIONS AND ROAD CONSTRUCTION SPECIFICATIONS.

URBAN DESIGN PLANNING ENGINEERING

TELEPHONE 407-629-4288 ■ FACSIMILE 407-629-1656 ● EB# 7080

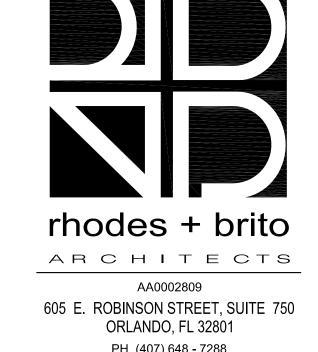

PH (407) 648 - 7288 www. rbarchitects.com Consultants

OCSO SECTOR IV PARKING LOT DESIGN

2400 W. 33RD ST ORLANDO, FL 32839

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Seal

MAJID KALAGHCHI PE41046

PERMIT DOCUMENTS

	·	
DATE	SUBMISSION / REVISION	NO.

SITE DETAILS

SCALE:	1"=20'
DRAWN BY:	JF
CHECK BY:	MK
DATE:	JANUARY 6, 2017
PROJECT NUMBER:	15012-0013