ORANGE COUNTY CAPITAL PROJECT DIVISION **INTERNAL OPERATIONS CENTER II** 400 E. SOUTH STREET, 5th FLOOR ORLANDO, FL 32801

ORANGE COUNTY MAYOR HONORABLE TERESA JACOBS


COMMISSIONER DISTRICT 1 **BETSY VANDERLEY**

COMMISSIONER DISTRICT 2 **BRYAN NELSON**



ARCHITECTURAL DESIGN COLLABORATIVE

ARCHITECT 945 N. PENNSYLVANIA AVENUE WINTER PARK, FLORIDA 32789 (407) 629-1188 CONTACT: KAREN ANDERSON

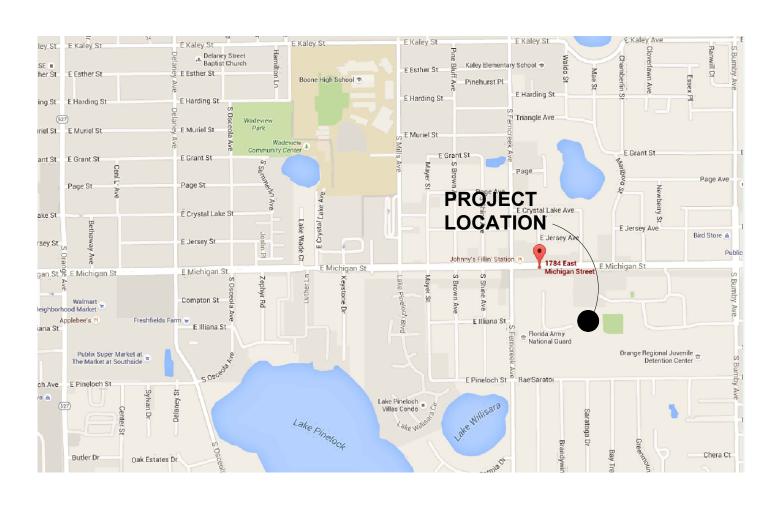



VICINITY MAP N.T.S.



COMMISSIONER DISTRICT 6 VICTORIA P. SIPLIN

GREAT OAKS VILLAGE WITTENSTEIN COTTAGE **1784 E. MICHIGAN STREET** ORLANDO, FL 32806 ORANGE COUNTY PROJECT MANAGER: RANDY NIXON



SGM ENGINEERING

MEP ENGINEER 935 LAKE BALDWIN LANE ORLANDO, FL 32814 (407)767-5188 CONTACT: JOHN J BONOTTO





N LOCATION MAP

COMMISSIONER DISTRICT 3 PETE CLARKE **COMMISSIONER DISTRICT 4** JENNIFER THOMPSON **COMMISSIONER DISTRICT 5** EMILY BONILLA



BASE CONSULTANTS

STRUCTURAL ENGINEER 1214 EAST CONCORD STREET ORLANDO, FL 32803 (407)337-7227 CONTACT: LAURA BARBERO-BUFFA



PERMIT ISSUE SET

ARCHITECTURAL ABBREVIATIONS

PLYWD PLYWOOD

PRTECN PROTECTION

Α	
ANOD APPL ARCH	ACCESSORY ACOUSTIC(AL) ABOVE FINISHED FLOOR AUTHORITY HAVING JURISDICTIO ALUMINUM ALTERNATE ANNUNCIATOR ANODIZED APPLIANCE ARCHITECT(URAL) AUTOMATIC AVERAGE AND
В	
BLKG BRDLM BU	BUILDING BOLLARD BOARD BLOCKING BROADLOOM BUILT UP
С	
CLG COATG COILG CONC CONSTR CONT CONTR COVTR	CABINET CARPET CEMENT(ITIOUS) CERAMIC CEILING COATING CONCRETE CONSTRUCTION CONTINUOUS(ATION) CONTRACT(OR) COVER CONCRETE MASONRY UNIT
D	
DEPT DES DET DF DIA DIFF DIM DISP DIV DN \$ DR DSCON	DOUBLE DEPARTMENT DESIGN(ED) DETAIL DRINKING FOUNTAIN DIAMETER DIFFUSER DIFFUSER DIVISION DOUSION DOULAR (US CURRENCY) DOOR DISCONNECT DRAWER
E	
ELEC EMBED ENGR ENTR EQ EQUIP EXIST EXP JT EXPS	ELASTOMERIC ELECTRICAL EMBEDD(ED)(ING) ENGINEER(ED) ENTRANCE EQUAL EQUIPMENT EXISTING EXPANSION JOINT EXPOSE(D) EXTERIOR
F	
FD FE FE&C FHC FIN FLDG FPLC FR FRMG FXD FXTR FLR	FIREPLACE FIRE RAT(ING)(ED) FRAMING FIXED

G	
GA GFRC	GAUGE GLASS FIBER REINFORCED
GFRG	CONCRETE GLASS FIBER REINFORCED
GFRP	GYPSUM GLASS FIBER REINFORCED
GL GR GYP	PLASTER GLASS GRAD(E)(ING) GYPSUM
н	
HD HDWD HDWE HM HORIZ HVAC	HEAD HARDWOOD HARDWARE HOLLOW METAL HORIZONTAL HEATING, VENTILATING, AND AIR CONDITIONING
INFO INSTRUM INSUL INTLK INT INFILTR	INSTRUMENT(ATION)
J	
JAN	JANITOR
K	
KIT	KITCHEN
LAV LB £ LT LVLG LVR	LAVATORY POUND BRITISH POUND (CURRENCY) LIGHT LEVELING LOUVER
М	
MAX MFD MFR MECH MET MEMB MEZZ MIN MISC MLWK MOIST MOT MTD	MAXIMUM MANUFACTURED MANUFACTURER MECHANICAL METAL MEMBRANE MEZZANINE MINIMUM MISCELLANEOUS MILLWORK MOISTURE MOTOR(IZED) MOUNTED
Ν	
NIC NO NTS	NOT IN CONTRACT NUMBER NOT TO SCALE
0	
ORNA OVFL OVHD OPNG OPR	ORNAMENTAL OVERFLOW OVERHEAD OPENING(S) OPERABLE
Ρ	
PORT PREFIN	PEDESTRIAN PARTICLE BOARD PROJECT MANAGER

READER rdr RECES RECESSED RECPT RECEPTACLE REF REFER(ENCE) REFL REFLECTED REFR REFRIGERATOR reqd required RESIS RESIST(ANT)(IVE) REINFORCE(D)(ING)(MENT) REINF RESIL RESILIENT RFG roofing ROOM SCR SCRIBE SECUR SECURITY SQUARE FEET SINGLE SGL SHORING SHORG SIM SIMILAR SST STAINLESS STEEL STD STANDARD STL STEEL STRFR STOREFRONT STRUCT STRUCTURAL SURF SURFACE SUSP SUSPENDED SYS SYSTEM(S) THK THICK TLT TOILET TRAFFIC TRAF TRANS TRANSPARENT TRTD TREATED T&G TONGUE AND GROOVE TYP TYPICAL UNDRLAY UNDERLAYMENT UTIL UTILITY UNLESS NOTED OTHERWISE UNO VEH VEHICLE VERT VERTICAL VIF VERIFY IN FIELD WITH WATER CLOSET WOOD WD WDW WINDOW W/O WITHOUT WEIGHT WΤ

WTRPRF WATERPROOFING

R

RM

SF

SCOPE

PROJECT NARRATIVE/SCOPE OF WORK

THIS PROJECT IS AN ALTERATION TO AN EXISTING RESIDENCE TO BUILD OUT THREE BEDROOMS IN EACH WING OF THE BUILDING TO ACCOMMODATE A BOYS AND GIRLS AREA. THE EXISTING RESTROOM IN EACH OF THE TWO WINGS WILL BE ALTERED TO PROVIDE AN ACCESSIBLE FIXTURE SET. THE SHOWER IN THE RESTROOM OFF THE COMMON GATHERING AREA WILL BE ALTERED FOR GREATER ACCESSIBILITY.

THE EXISTING CERAMIC TILE FLOOR WILL BE REPLACED WITH NEW FLOORING THROUGHOUT AND GENERAL MAINTENANCE MAY BE PERFORMED AS RELATED TO ALTERATION CONSTRUCTION.

THE KITCHEN WILL BE ALTERED TO PROVIDE FOR AN ACCESSIBLE PATH AROUND THE KITCHEN, AN ACCESSIBLE SINK, AND AN ACCESSIBLE MICROWAVE.

A NEW FIRE SPRINKLER SYSTEM WILL BE INSTALLED AS DIRECTED BY THE FIRE MARSHAL

THE EXISTING STAIRS AT THE REAR OF THE BUILDING WILL BE REPAIRED OR REPLACED AND COMPLIANT HANDRAILS WILL BE INSTALLED. NO EXPANSION OF THE EXISTING FOOTPRINT IS PLANNED.

SCOPE OF WORK NOTES:

1. WORK THAT IS NOT STATED HEREIN NOR SHOWN IN THESE PLANS IS NOT PART OF THE SCOPE OF WORK FOR THIS PROJECT.

2. ADDITIONAL WORK REQUIRED THAT WOULD ALTER THE PRESENTED SCOPE OF WORK SHALL BE SUBJECT TO A REVISION OF THESE DOCUMENTS AND MAY BE REQUIRED TO BE REVIEWED BY THE BUILDING DEPARTMENT HAVING JURISDICTION.

GENERAL DEMOLITION NOTES:

REMOVE EXISTING RECEPTACLES, TELEPHONES, SWITCHES, AND ANY ELECTRICAL DEVICES IN WALLS TO BE DEMOLISHED. RELOCATE THESE DEVICES AS INDICATED OR REQUIRED BY THE DRAWINGS, ARCHITECT, OR OWNER REPRESENTATIVE. PROVIDE ARCHITECT WITH AS-BUILT DRAWINGS OF FINAL INSTALLATION FOR RECORD PURPOSES. CONTRACTOR IS NOTIFIED THAT NOT ALL EXISTING DEVICES MAY HAVE BEEN INDICATED ON THE DRAWINGS AND THAT SOME EXISTING ELECTRICAL DEVICES MAY NOT HAVE BEEN SHOWN IN THEIR ACTUAL LOCATION. CONTRACTOR IS REQUIRED TO VISIT SITE AND BECOME FAMILIAR WITH THE EXISTING CONDITIONS PRIOR TO DETERMINING THE WORK THAT NEEDS TO BE ACCOMPLISHED AS PART OF HIS/HER BID.

- THE WORK SHALL INCLUDE THE FURNISHING OF ALL MATERIALS. CUTTING. EXTENDING. CONNECTING, REPAIRING, ADAPTING, AND OTHER COINCIDENTAL WORK TOGETHER WITH SUCH TEMPORARY INSTALLATIONS AS MAY BE NECESSARY TO SATISFY THE DEMOLITION PROGRAM. APPROVAL SHALL BE SECURED FROM THE OWNER/PROJECT MANAGER PRIOR TO CUTTING/DRILLING ANY STRUCTURAL SUPPORT.
- 3 ALL BUILDING CONSTRUCTION AFFECTED BY THE REMOVAL, RELOCATION, INSTALLATION OF ANY PIECE OF EQUIPMENT SHALL BE REPAIRED AND FINISHED AS REQUIRED TO MATCH EXISTING CONDITION OR AS DIRECTED BY THE ARCHITECTURAL DRAWINGS, SPECIFICATIONS, OR PROJECT MANAGER.
- WHEN ELECTRICAL DEVICES ARE PRESENT IN PARTITIONS OR CEILINGS TO BE REMOVED. THE ELECTRICAL CONTRACTOR SHALL DISCONNECT THEM UP TO THE NEXT OUTLET TO REMAIN OR BACK TO PANEL THE BOARD. IF EXISTING TO REMAIN OUTLETS ARE FED THROUGH DEMOLISHED PARTITIONS OR CEILINGS, THE CIRCUIT SHALL BE REARRANGED TO MAINTAIN CIRCUIT CONTINUITY. WIRE SHALL BE REMOVED BACK TO SOURCE FROM INACCESSIBLE RACEWAYS NOT REUSED. INSTALL BLANK PLATES ON FLUSH OUTLETS NOT REUSED. PLATE COLOR SHALL MATCH ADJACENT SURFACE AS NEAR AS POSSIBLE IN FINISHED AREAS.
- REFER TO ELECTRICAL ENGINEERING FOR WORK TO BE REMOVED FROM STRUCTURE. OTHER ELECTRICAL ITEMS ASSOCIATED WITH THIS WORK SHALL BE REMOVED IF NOT REQUIRED FOR NEW EQUIPMENT TO CONTINUE IN SERVICE.
- CONTRACTOR SHALL DEMOLISH ANY INTERIOR FINISHES TO COMPLETE THE NECESSARY AND PROPOSED WORK AS DIRECTED BY THE ARCHITECTURAL DRAWINGS, INTERIOR DESIGN DRAWINGS, SPECIFICATIONS, OR BY PROJECT MANAGER. EXISTING FIXTURES, EQUIPMENT, AND ALL DEBRIS WHICH ARE REQUIRED TO BE REMOVED SHALL
- BE REMOVED BY THE CONTRACTOR. CONTRACTOR TO COORDINATE WITH PROJECT MANAGER PRIOR TO REMOVAL OF SUCH. ALL ELECTRICAL AND PLUMBING LINES WHICH REQUIRE REMOVAL OR ALTERATION ARE TO BE
- DONE SO BY THE CONTRACTOR. LINES TO BE CAPPED AND PREPARED FOR REMOVAL OR RE-ROUTING AS SPECIFIED.
- REMOVE ALL UTILITIES IN DEMOLITION AREAS AND CONSTRUCTION AREAS IN A MANNER, AND IN THE TIME, SATISFACTORY TO THE UTILITY COMPANY. IF UTILITY COMPANY DESIRES TO EFFECT THE REMOVAL OF THE MATERIALS, THEY SHALL BE PERMITTED TO DO SO.
- 10 COVER ITEMS AS SPECIFIED BY OWNER/PROJECT MANAGER TO PROTECT FROM DUST AND DEBRIS. 11 SALVAGED MATERIALS SHALL BE REMOVED, CLEANED, AND PREPARED FOR RE-INSTALLATION. OWNER MAINTAINS OWNERSHIP OF ALL MATERIALS UNLESS OTHERWISE SPECIFIED.
- 2 WHERE EXISTING WALLS, CEILINGS, AND FIXTURES HAVE BEEN REMOVED, AREAS SHALL BE PATCHED TO MATCH EXISTING FINISHES, OR FINISHES TO BE ADDED AS PER PLANS, INTERIOR DESIGNER, OR AS PER OWNER.
- 13 WHERE EXISTING WORK IS DAMAGED IN THE EXECUTION OF THIS CONTRACT, OR WHERE OPENINGS ARE LEFT DUE TO THE REMOVAL OF PIPES, EQUIPMENT OR APPARATUS, THE SAME SHALL BE REPAIRED OR CLOSED TO CORRESPOND IN MATERIAL, QUALITY, SHAPE AND FINISH WITH THAT OF SIMILAR AND ADJOINING WORK, UNLESS OTHERWISE CALLED FOR. WHERE DAMAGE IS IRREPARABLE, NEW ITEMS OR EQUIPMENT SHALL BE PROVIDED. CONTRACTOR SHALL PROVIDE ALL NECESSARY WATERPROOFING, FIRE STOPPING AND SEALING OF PENETRATIONS LEFT FROM REMOVED EQUIPMENT OR PRODUCED BY THIS WORK.
- 14 INTERRUPTION OF EXISTING SERVICES AND/OR OPERATION OF FACILITIES SHALL BE KEPT TO A MINIMUM. CONTRACTOR SHALL FURNISH ALL MATERIALS REQUIRED WHENEVER TEMPORARY CONNECTIONS ARE NECESSARY TO MAINTAIN CONTINUITY OF SERVICE. INTERRUPTION OF EXISTING SERVICES, THE INSTALLATION OF TEMPORARY FACILITIES, AND THE WORK OF MAKING FINAL CONNECTIONS TO THE NEW WORK SHALL BE DONE ONLY AT SUCH TIMES PERMITTED AND SCHEDULED IN ADVANCE BY THE ARCHITECT/OWNER WITHOUT ADDITIONAL COST. CARE MUST BE USED IN REMOVING SERVICES TO AREAS BEING DEMOLISHED SO THAT SERVICES TO OTHER AREAS WHICH MIGHT BE SERVED THROUGH THESE AREAS WILL NOT BE INTERRUPTED.
- 5 WHERE DEMOLITION WORK REQUIRES TEMPORARY INTERRUPTION OF ELECTRICAL, TELEPHONE, TV ALARM OR COMMUNICATION SERVICES, RESPECTIVE UTILITIES AND/OR COMPANY REPRESENTATIVES SHALL BE NOTIFIED AS NECESSARY, AND ALL WORK DONE SHALL BE UNDER SUPERVISION AND THEIR ESTABLISHED STANDARDS.
- 16 ALL LIGHTING FIXTURES, RECEPTACLES, SWITCHES, WIRING DEVICES, SPECIAL OUTLETS, TELEPHONE CABLES, TV CABLES, MISCELLANEOUS SYSTEM WIRING, POWER CONDUCTORS, CONDUITS, ELECTRICAL BOXES, RACEWAYS AND ANY OTHER ELECTRICAL SYSTEM COMPONENTS LOCATED IN THE AREAS SHOWN AS BEING DEMOLISHED OR NOT USED AFTER WORK IS COMPLETED SHALL BE REMOVED UNLESS OTHERWISE NOTED AS EXISTING TO REMAIN OR BE RELOCATED. CONDUITS RUNNING IN SLAB AT FINISHED AREAS SHALL BE CUT FLUSH, PLUGGED AND ABANDONED AFTER CONDUCTORS ARE REMOVED. NO WIRING SHALL BE LEFT ABANDONED AFTER WORK IS COMPLETED.
- 17 ALL DEMOLITION, RENOVATION, AND CONSTRUCTION TO COMPLY WITH CURRENT NFPA REQUIREMENTS.
- 18 DEBRIS SHALL BE REMOVED FROM THE SITE DAILY. 19 THE GC SHALL THOROUGHLY INVESTIGATE EXISTING CONDITIONS INCLUDING GENERAL PLAN LAYOUT/CONFIGURATION AND EXISTING STRUCTURAL COMPONENTS VISIBLE OR CONCEALED (IN WALL AND/OR ABOVE CEILING), THAT COULD IMPACT THE WORK. THE GC SHALL FIELD VERIFY EXISTING DIMENSIONS, MATERIALS AND METHODS OF CONSTRUCTION, AND STRUCTURE, AND COORDINATE EACH WITH THE CONTRACT DOCUMENTS. THE GC SHALL NOTIFY THE ARCHITECT OF DISCREPANCIES BETWEEN EXISTING CONDITIONS AND THE CONTRACT DOCUMENTS PRIOR TO

AS BUILT DRAWINGS:

COMMENCING WORK.

- GC TO PROVIDE ARCHITECT WITH FULL SIZED RED-LINED AND CLOUDED MARKED-UP/AS BUILT DRAWINGS AT EVERY SITE VISIT. DRAWINGS SHOULD SHOW ANY FIELD MODIFICATIONS THAT DIFFER FROM CONSTRUCTION DOCUMENTS.
- THE ABOVE REFERENCED RUNNING SET OF AS-BUILTS WILL BE USED AT COMPLETION OF PROJECT TO PROVIDE THE CLIENT WITH AN ACCURATE SET OF RECORD DRAWINGS.

PROJECT INFORMATION

APPLICABLE CODES

FLORIDA BUILDING CODE - (5th EDITION 2014) FLORIDA BUILDING CODE ACCESSIBILITY (5th EDITION 2014) FLORIDA BUILDING CODE - EXISTING BUILDING- (5th EDITION 2014) FLORIDA FIRE PREVENTION CODE - (5th EDITION) NFPA 101 - LIFE SAFETY CODE 2012 WITH FLORIDA AMENDMENTS NFPA 1- UNIFORM FIRE CODE 2012 WITH FLORIDA AMENDMENTS NFPA 70 - NATIONAL ELECTRICAL CODE - 2011 FLORIDA MECHANICAL CODE - 2014

CITY OF ORLANDO JURISDICTION

OCCUPANCY

GROUP CLASSIFICATION: MAX. PROJECTED RESIDENTS:

RESIDENTIAL:

RESIDENTIAL R4 - GROUP HOME 12 OCC. TOTAL IN BEDROOMS PLUS (4) MAX SUPPORT STAFF TOTAL OF (16) OCCUPANTS OR LESS OFFICES PROVIDED FOR 24 HOUR STAFF WHICH ARE AN ACCESSORY USE TO THE R-4 OCCUPANCY

EXITS

SEE LIFE SAFETY SUMMARY AND I	DIAGRAM ON A00.53
MAX. TRAVEL DISTANCE:	250 FT. (SPRINKLERED)
PROVIDED:	99 FT.
MAX. COMMON PATH OF TRAVEL:	75 FT (SPRINKLERED)
PROVIDED:	35 FT.
MAX. DEAD END CORRIDOR:	50FT. (SPRINKLERED)
PROVIDED:	0 FT.
EGRESS CAPACITY:	137 x .2 = 27.4"
PROVIDED:	170" (3 doors @ 34" ONE AT 68")
	· · · · · · · · · · · · · · · · · · ·

CONSTRUCTION

TYPE:	EXISTING
SPRINKLERED or NONSPRINKLERED:	SPRINKLERED BUILDING
HEIGHT:	EXISTING
CLASSIFICATION OF WORK:	ALTERATION / RENOVATION

PLUMBING REQUIREMENTS: 16 TOTAL / 2 = 8 EACH SEX (PER TABLE 403.1)

MINIMUM REQUIRED PLUMBING FIXTURES

	FEMALE	MALE	UNISEX
WATER CLOSETS	(1) REQUIRED	(1) REQUIRED	(1) REQUIRED
1 PER (10 PEOPLE)	(2) PROVIDED	(2) PROVIDED	(1) PROVIDED
LAVATORIES	(1) REQUIRED	(1) REQUIRED	(1) REQUIRED
1 PER (10 PEOPLE)	(2) PROVIDED	(2) PROVIDED	(1) PROVIDED
DRINKING FOUNTAINS	-	-	(1) REQUIRED
1 PER (100)	-	-	(2) PROVIDED
UTILITY SINK	-	-	(1) REQUIRED
1 PER (100)	-	-	(2) PROVIDED

DRAWING INDEX

ARCHITECTURAL

	COVER SHEET
A00.00	INDEX
A00.01	GRAPHIC SYMBOLS
A00.30	DOOR, FRAME AND HARDWARE SCHEDULE
A00.31	TYPICAL STANDARDS
A00.40	ACCESSIBILITY INFORMATION
A00.50	SITE PLAN
A00.51	LIFE SAFETY PLAN
A01.01	DEMOLITION PLAN
A02.01	CONSTRUCTION PLAN
A04.01A	DEMO REFLECTED CEILING PLAN
A04.01B	REFLECTED CEILING PLAN
A05.01	FLOOR FINISH PLAN
A06.01	FURNITURE AND EQUIPMENT LAYOUT
A08.01	ENLARGED RESTROOMS
A08.02	ENLARGED RESTROOMS
A08.03	ENLARGED KITCHEN
A08.04	STAIR DETAILS AND ELEVATIONS
A12.01	MILLWORK DETAILS
A12.02	PARTITION TYPES AND DETAILS

FIRE PROTECTION

F0.01	FIRE PROTECTION SYMBOLS, LEGEND AND GENERAL NOTES
F100	FIRE PROTECTION SITE PLAN
F1.01	FIRE PROTECTION PLAN
F5.01	FIRE PROTECTION DETAILS

PLUMBING

PLUMBING SYMBOLS, LEGEND AND GENERAL NOTES
PLUMBING PLAN
PLUMBING SCHEDULES
PLUMBING DETAILS

MECHANICAL

M0.01	MECHANICAL SYMBOLS, LEGEND AND
	GENERAL NOTES
MD1.01	MECHANICAL DEMOLITION PLAN
M1.01	MECHANICAL PLAN
M5.01	MECHANICAL DETAILS

ELECTRICAL

E0.01	ELECTRICAL SYMBOLS, LEGEND GENERAL NOTES
E0.02	ELECTRICAL SPECIFICATIONS
ED1.01	LIGHTING DEMO PLAN
ED1.02	POWER DEMO PLAN
E1.01	LIGHTING RENOVATION PLAN
E1.02	POWER RENOVATION PLAN
E4.01	ELECTRICAL PANEL SCHEDULES

STRUCTURAL

S0.01	GENERAL NOTES
S0.02	SYMBOLS AND ABBREVIATIONS
S02.03	FOUNDATION AND SLAB PLAN
S05.01	SECTIONS AND DETAILS

F FLORIDA ERREIRA • Seal/Signa			\-C0013 R-95752
ocuments	for:		
	RAN OUN L O R		
GRADES MICHIGA	S AND RENO		
		Drawn By	
			K
12.02.16			K
rmation			
	ET 5th FLOOR	YKUJECTS [אוע ISI(
J, FL 3280'	•		
Number		ls	ssue Da
у		Proje	12/02/2 ect Stat
l By		-	MIT / BID S Sca
-			N
1e 5253 OC W	/ittenstein House		ETS
IDEX.dwg		יאטאטאטוזנ	\
nt ● Seal/S	Signature		
nt ● Seal/S	Signature		
nt ● Seal/S	Signature		
int ● Seal/S	Signature		
nt ● Seal/S	Signature		
nt ● Seal/S	Signature		
nt ∙ Seal/S	Signature		
nt ∙ Seal/S	Signature		
nnt ● Seal/S	Signature		
int • Seal/S	Signature		
	• Seal/Sign ocuments Ocuments C C C C C C C C C C C C C C C C C C C	• Seal/Signature ocuments for:	Seal/Signature ocuments for: OCUMENTS for: OCUMENTS for: OCUMENTS for: OCUMENTS for: OCUMPACE AND RENOVATIONS MICHIGAN STREET DO, FL 32806 Mate & Issue Description Drawn By 7.27.16 60% CD SET JS 2.02.16 PERMIT/BID SET JS 2.02.16 PERMIT/BID SET JS 2.02.16 PERMIT/BID SET JS 2.02.16 PERMIT/BID SET JS 2.02.17 PERMITION Transion COUNTY CAPITAL PROJECTS I Transion COUNTY CAPITAL PROJECTS I Transion COUNTY CAPITAL PROJECTS I Aumber Is Y Proje PERMITION PERMITION PERMITION PERMITION PERMITION PERMITION PERMITION PERMITION PERMITION


INDEX



GRAPHIC SYMBOLS (CONT.)

STONE

ELEVATION INDICATIONS

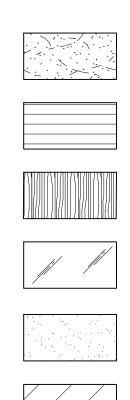

BRICK/CONCRETE BLOCK

FINISHED WOOD

GLASS

QUARTZ

RESIN


SECTION INDICATIONS

an a	SAND OR GROUT
	EARTH OR NATURAL GROUND
	POROUS FILL (GRAVEL)
	STONE
	CONCRETE
	BRICK
	CONCRETE MASONRY UNIT
	METAL
	NON-FERROUS ALUMINUM
	PLYWOOD
	WOOD (FINISH)
	WOOD (CONTINUOUS)
	WOOD (BLOCKING) INTERRUPTED MEMBER
	INSULATION (LOOSE OR BATT)
	INSULATION (RIGID)
	GLASS (LARGE SCALE)
~~~~~	GYPSUM BOARD
	PLASTER WITH LATH
	ACOUSTICAL TILE
	CARPET
	FABRIC WRAPPED PANEL

(X'-X") XXXXX


 $\square$  $\boxtimes$ 



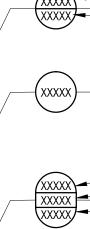

	STONE
	CONCRETE
	BRICK
	CONCRETE MASONRY UNIT
	METAL
	NON-FERROUS ALUMINUM
	PLYWOOD
	WOOD (FINISH)
	WOOD (CONTINUOUS)
	WOOD (BLOCKING) INTERRUPTED MEMBER
	INSULATION (LOOSE OR BATT)
	INSULATION (RIGID)
	GLASS (LARGE SCALE)
	GYPSUM BOARD
	PLASTER WITH LATH
	ACOUSTICAL TILE
	CARPET
	FABRIC WRAPPED PANEL

**FINISH** 

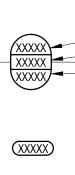

XXXXXX>

## **GRAPHIC SYMBOLS (CONT.)**

### **REFLECTED CEILING**

--

**⊷** 

X'-X"

X'-X"

 $\otimes$ 

 $\langle SD \rangle$ 

HST

 $\leq$ 

 $\Box$ 

ACOUSTICAL CEILING AND GRID
 MAIN RUNNER
GYPSUM BOARD SOFFIT
EXISTING TO BE REMOVED
SURFACE MOUNTED FLUORESCENT LIGHT FIXTURE
FLUORESCENT STRIP FIXTURE
FLUORESCENT PENDANT FIXTURE
CEILING HEIGHT CHANGE
DIMENSION OF CEILING ABOVE FINISH FLOOR
CEILING FINISH
CEILING MOUNTED EXIT SIGN, SHOWS QUANTITY OF FACE(S) AND DIRECTION OF ARROW(S)
SMOKE DETECTOR
STROBE
FIRE SPRINKLER
SPEAKER
ACCESS DOOR
SECURITY CAMERA
THERMOSTAT
LIGHT SWITCH
DIMMER SWITCH
RETURN AIR
SUPPLY AIR
LINEAR DIFFUSER
DENOTES EXISTING TO REMAIN

DENOTES EXISTING, RELOCATED FIXTURE

WALL FINISH - BASE FINISH - EXTENT OF FINISH

WALL FINISH - EXTENT OF FINISH

WALL FINISH WAINSCOT FINISH BASE FINISH EXTENT OF FINISH

SPECIAL FINISH

FLOOR FINISH

CHANGE IN FLOOR FINISH

## **GRAPHIC SYMBOLS (CONT.)**

Ð

з**Д**.

Δ

AV

TV

3

 $\bigcirc$ 

 $\odot$ 

 $\bigcirc$ 

(AV)

TV

 $\square$ 

Ð

0

 $\mathbf{\Theta}$ 

 $\bigcirc$ 

Ð

J

DR

PB

Μ

Η

EL

BG

GF

0

## **POWER & COMMUNICATION** WALL MOUNTED DUPLEX WALL MOUNTED FOURPLEX QUADRAPLEX ISOLATED WALL MOUNTED SEPARATE DUPLEX WALL MOUNTED DEDICATED DUPLEX WALL MOUNTED DEDICATED FOURPLEX WALL MOUNTED HALF DEDICATED FOURPLEX WALL MOUNTED SPECIAL OUTLET WALL MOUNTED TELEPHONE RECEPTACLE WALL MOUNTED TELE/DATA RECEPTACLE WALL MOUNTED 1 TELE/2 DATA RECEPTACLE - QUAD FACEPLATE TERMINAL IN SINGLE-GANG, DUPLEX J-BOX. WALL MOUNTED DATA RECEPTACLE WALL MOUNTED A/V RECEPTACLE WALL MOUNTED TV/CAMERA RECEPTACLE - 3" SQUARE. FLUSH FLOOR MOUNTED TELEPHONE RECEPTACLE FLUSH FLOOR MOUNTED TELE/DATA RECEPTACLE FLUSH FLOOR MOUNTED 1 TELE/2 DATA RECEPTACLE FLUSH FLOOR MOUNTED DATA RECEPTACLE FLUSH FLOOR MOUNTED DUPLEX FLUSHFLOOR MOUNTED FOURPLEX FLUSH FLOOR MOUNTED DEDICATED DUPLEX FLUSH FLOOR MOUNTED DEDICATED FOURPLEX FLUSH FLOOR MOUNTED SEPARATE DUPLEX FLUSH FLOOR MOUNTED SEPARATE FOURPLEX FLUSH FLOOR MOUNTED DUPLEX WITH TELE/DATA RECEPTACLE FLUSH FLOOR MOUNTED DEDICATED DUPLEX WITH TELE/DATA RECEPTACLE FLUSH FLOOR MOUNTED SEPARATE DUPLEX WITH TELE/DATA RECEPTACLE FLUSH FLOOR MOUNTED A/V RECEPTACLE FLUSH FLOOR MOUNTED TV RECEPTACLE POKE-THRU TEL. MONUMENT POKE-THRU TELE/DATA MONUMENT POKE-THRU DATA POWER MONUMENT

POKE-THRU DUPLEX POWER MONUMENT POKE-THRU FOURPLEX POWER MONUMENT POKE-THRU DEDICATED DUPLEX POWER MONUMENT POKE-THRU DEDICATED FOURPLEX POWER MONUMENT POKE-THRU SEPARATE DUPLEX POWER MONUMENT

POKE-THRU SEPARATE FOURPLEX POWER MONUMENT

AV POKE-THRU A/V MONUMENT

 $\mathbb{T}$ POKE-THRU TV MONUMENT

FLUSH WALL MOUNTED POWER JUNCTION BOX  $\bigcirc$ 

WITH HARDWIRE CONNECTION FLOOR POKE-THRU JUNCTION BOX

WITH HARDWIRE CONNECTION

#### COMBINATION FLOOR POKE-THRU JUNCTION BOX $\boxed{1}$ WITH HARDWIRE CONNECTION CR CARD READER ID INTERCOM DEVICE


DOOR RELEASE BUTTON DOOR BELL PUSH BUTTON TO READ "PUSH TO EXIT"

- PER NFPA 7.2.1.6.2 (4) MONITOR
- PD PHONE DIRECTORY
- ELECTROMAGNETIC DOOR HOLD OPEN
- ELECTRIC LOCKSET (SEE HARDWARE SCHEDULE) MAGNETIC LOCK (SEE HARDWARE SCHEDULE)
- ML SECURITY SYSTEM DOOR MONITOR CONTACT
- MC (SEE HARDWARE SCHEDULE) IA INTRUSION ALARM (SEE SECURITY DRAWINGS)
- KEY SWITCH (SEE SECURITY DRAWINGS)
- KS CONTROL PANEL CP
  - 491 EMERGENCY BREAK GLASS STATION; SECURITY DOOR CONTROLS WALL MOUNTED SIMON BOARD, POWER & DATA
- SB TO BE COORDINATED WITH VENDOR
- $\langle \! \rangle \rangle$ **EQUIPMENT ITEM - SEE SCHEDULE**
- FS FIRE WARDEN STATION
- FP FIRE ALARM PULL BOX
- SM SECURITY MONITOR
- AV A/V FOR PROJECTION SYSTEM CAMERA REFER TO REFLECTED CEILING PLAN FOR LOCATION

  - RECESSED POWER. DATA & COAX OUTLET, SEE PLAN FOR HT
  - GROUND FAULT INTERCEPTOR

___

## **GRAPHIC SYMBOLS**

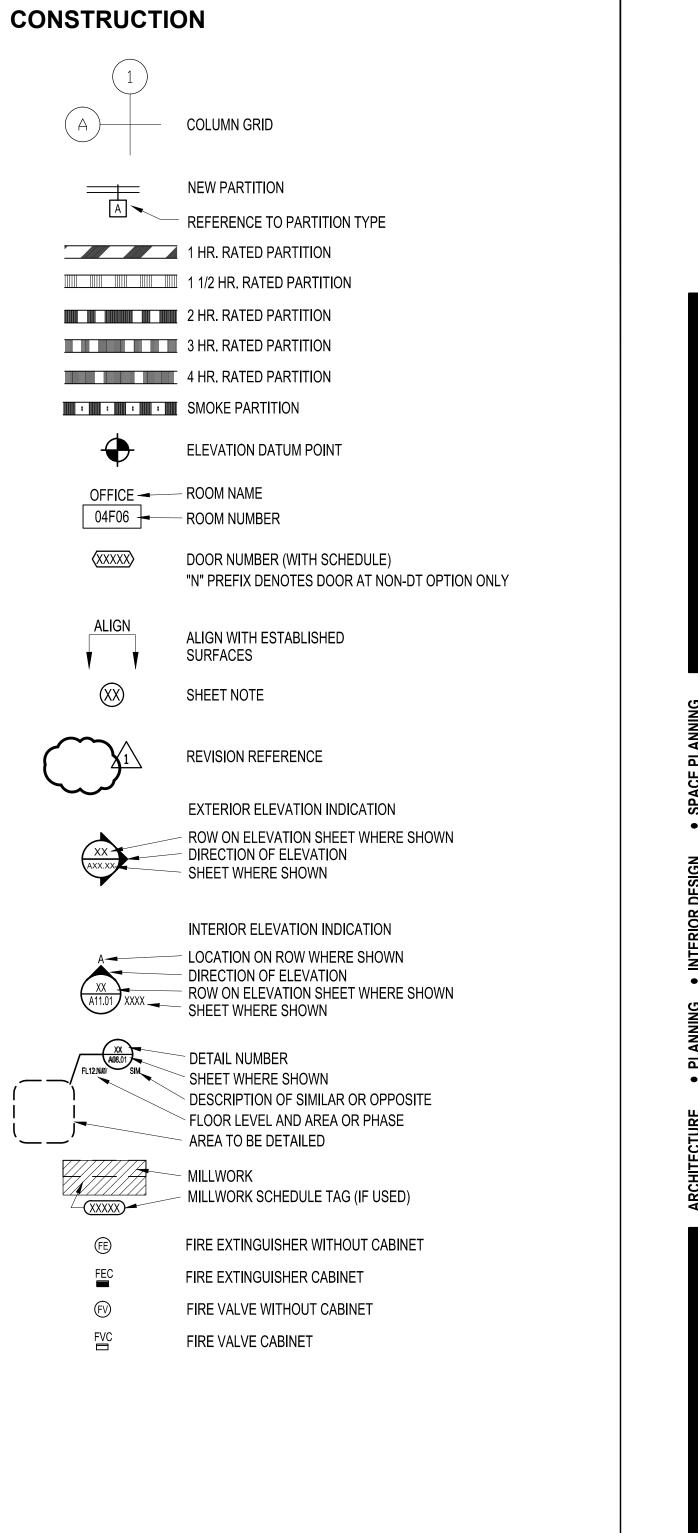


	945 N. PENNSYLVANIA WINTER PARK, FLORII OFFICE: (407) 629-1188 FAX: (407) 388-1220 WWW. ADCINTERNAT	A AVENUE DA 32789 3	OLLABORATIV	
	STATE OF FLORIDA MARIA FERREIRA Architect • Seal/Signatu	re	AA-C0 AR-957	
	Project Documents for O F L Project: GREAT OAKS VILL ADA UPGRADES A 1784 E. MICHIGAN ORLANDO, FL 3280	RAN PARENT OUN O R I AGE WITTEN ND RENOVA STREET		AGE
	Issue Date & Issue De	-	Drawn By Che	
۵ ۲		60% CD SET 90% CD SET	JS JS	KA KA
PLANNING	12.02.16	PERMIT/BID SE	T JS	KA
CE PL				
SPACE				
•				
DESIGN				
NTERIOR				
•				
	Client Information ORANGE COUNTY 400 E SOUTH STREET ORLANDO, FL 32801		OJECTS DIVI	SION
rure	Project Number		Issue	
ARCHITECTUR	15253 <b>Drawn By</b>		Project S	
ARCH	JS Checked By		PERMIT / E	Scale
	KA			NTS
	File Name			
	X:\dwgs\15253 OC Witte A00.01 GRAPHIC SYME		DA\CAD\SHEETS	3\
	Consultant   Seal/Sign	nature		
	Sheet Title:			
		HIC SYME	BOLS	



## DOOR, FRAME AND HARDWARE GROUP SCHEDULE

DOOR ASSEMBLY					FRAME ASSE	MBLY		FIRE	HARDWARE	HARDWARE					
NO. LOCATION	TYPE	WIDTH	HEIGHT	THICKNESS	MATERIAL	FINISH	MATERIAL	FINISH	HEAD DETAIL	JAMB DETAIL	SILL DETAIL	RATING	GROUP	FUNCTION	REMARKS
100 ENTRY DOOR	-					PAINT		PAINT	-	-	-	-	-		2, 3, 6
101 LOBBY	-					PAINT		PAINT	-	-	-	-	-		2, 3
102 OFFICE	-					PAINT		PAINT	-	-	-	-	-		2, 3
02A STORAGE CLOSET	-					PAINT		PAINT	-	-	-	-	-		2, 3
04A CORRIDOR	-					PAINT		PAINT	-	-	-	-	-		2, 3
04B LIVING ROOM / DINING ROOM	-					PAINT		PAINT	-	-	-	-	-		2, 3
06A UNISEX RESTROOM	-					PAINT		PAINT	-	-	-	-	-		2, 3
06B JANITOR CLOSET	-					PAINT		PAINT	-	-	-	-	-		2, 3
06C HALLWAY #1	-					PAINT		PAINT	-	-	-	-	-		2, 3
106D HALLWAY #2	-					PAINT		PAINT	-	-	-	-	-		2, 3
107 MECHANICAL ROOM	-					PAINT		PAINT	-	-	-	-	-		2, 3
108 OFFICE	-					PAINT		PAINT	-	-	-	-	-		2, 3
09A LAUNDRY ROOM	A	3'-0"	6'-8"	1 3/4"	S.C. WOOD	PAINT	HOLLOW MTL	PAINT	03/A00.30	04/A00.30	-	-	2		2, 3
09B LAUNDRY ROOM	-					PAINT		PAINT	-	-	-	-	-		2, 3
10A STUDY AREA	В	3'-0"	6'-8"	1 3/4"	WOOD/GLASS	PAINT	WOOD	PAINT	05/A00.30	06/A00.30	-	-	2		2, 5, 7
10B BACK ENTRY	-					PAINT		PAINT	-	-	-	-	-		2, 3, 6
11A STORAGE CLOSET	A	2'-8"	6'-8"	1 3/4"	S.C. WOOD	STAIN	HOLLOW MTL	PAINT	03/A00.30	04/A00.30	-	-	1		2, 4
111B BACK DOOR	C	3'-0"	6'-8"	1 3/4"	METAL/GLASS	PAINT	HOLLOW MTL	PAINT	01/A00.30	02/A00.30	-	-	3		2, 6
12A BOY'S RESTROOM	D	3'-0"	6'-8"	1 3/4"	METAL	STAIN	HOLLOW MTL	PAINT	01/A00.30	02/A00.30	-	-	4		2, 5
13A FIRE RISER ROOM	A	2'-8"	6'-8"	1 3/4"	S.C. WOOD	STAIN	HOLLOW MTL	PAINT	03/A00.30	04/A00.30	-	-	1		2, 4
13B BACK DOOR	C	3'-0"	6'-8"	1 3/4"	METAL/GLASS	PAINT	HOLLOW MTL	PAINT	01/A00.30	02/A00.30	-	-	3		2, 6
14A GIRL'S RESTROOM	D	3'-0"	6'-8"	1 3/4"	METAL	STAIN	HOLLOW MTL	PAINT	01/A00.30	02/A00.30	-	-	4		2, 5
16A GIRL'S SLEEPING QUARTERS #1	A	3'-0"	6'-8"	1 3/4"	S.C. WOOD	STAIN	HOLLOW MTL	PAINT	03/A00.30	04/A00.30	-	-	2		2, 4
16B CLOSET	F	2'-8"	6'-8"	1 3/4"	S.C. WOOD	STAIN	WOOD	PAINT	05/A00.30	06/A00.30	-	-	5		1, 4, 7
17A GIRL'S SLEEPING QUARTERS #2	A	3'-0"	6'-8"	1 3/4"	S.C. WOOD	STAIN	HOLLOW MTL	PAINT	03/A00.30	04/A00.30	-	-	2		2, 4
17B CLOSET	E	5'-0"	6'-8"	1 3/4"	S.C. WOOD	STAIN	WOOD	PAINT	05/A00.30	06/A00.30	-	-	5		1, 4
18A GIRL'S SLEEPING QUARTERS #3	A	3'-0"	6'-8"	1 3/4"	S.C. WOOD	STAIN	HOLLOW MTL	PAINT	03/A00.30	04/A00.30	-	-	2		2, 4
18B CLOSET	E	5'-0"	6'-8"	1 3/4"	S.C. WOOD	STAIN	WOOD	PAINT	05/A00.30	06/A00.30	-	-	5		1, 4, 7
19A BOY'S SLEEPING QUARTERS #1	A	3'-0"	6'-8"	1 3/4"	S.C. WOOD	STAIN	HOLLOW MTL	PAINT	03/A00.30	04/A00.30	-	-	2		2, 4
19B CLOSET	F	2'-8"	6'-8"	1 3/4"	S.C. WOOD	STAIN	WOOD	PAINT	05/A00.30	06/A00.30	-	-	5		1, 4, 7
20A BOY'S SLEEPING QUARTERS #2	A	3'-0"	6'-8"	1 3/4"	S.C. WOOD	STAIN	HOLLOW MTL	PAINT	03/A00.30	04/A00.30	-	-	2		2, 4
20B CLOSET	E	5'-0"	6'-8"	1 3/4"	S.C. WOOD	STAIN	WOOD	PAINT	05/A00.30	06/A00.30	-	-	5		1, 4, 7
21A BOY'S SLEEPING QUARTERS #3	A	3'-0"	6'-8"	1 3/4"	S.C. WOOD	STAIN	HOLLOW MTL	PAINT	03/A00.30	04/A00.30	-	-	2		2, 4
21B CLOSET	E	5'-0"	6'-8"	1 3/4"	S.C. WOOD	STAIN	WOOD	PAINT	05/A00.30	06/A00.30	-	-	5		1, 4, 7

## **DOOR TYPES**

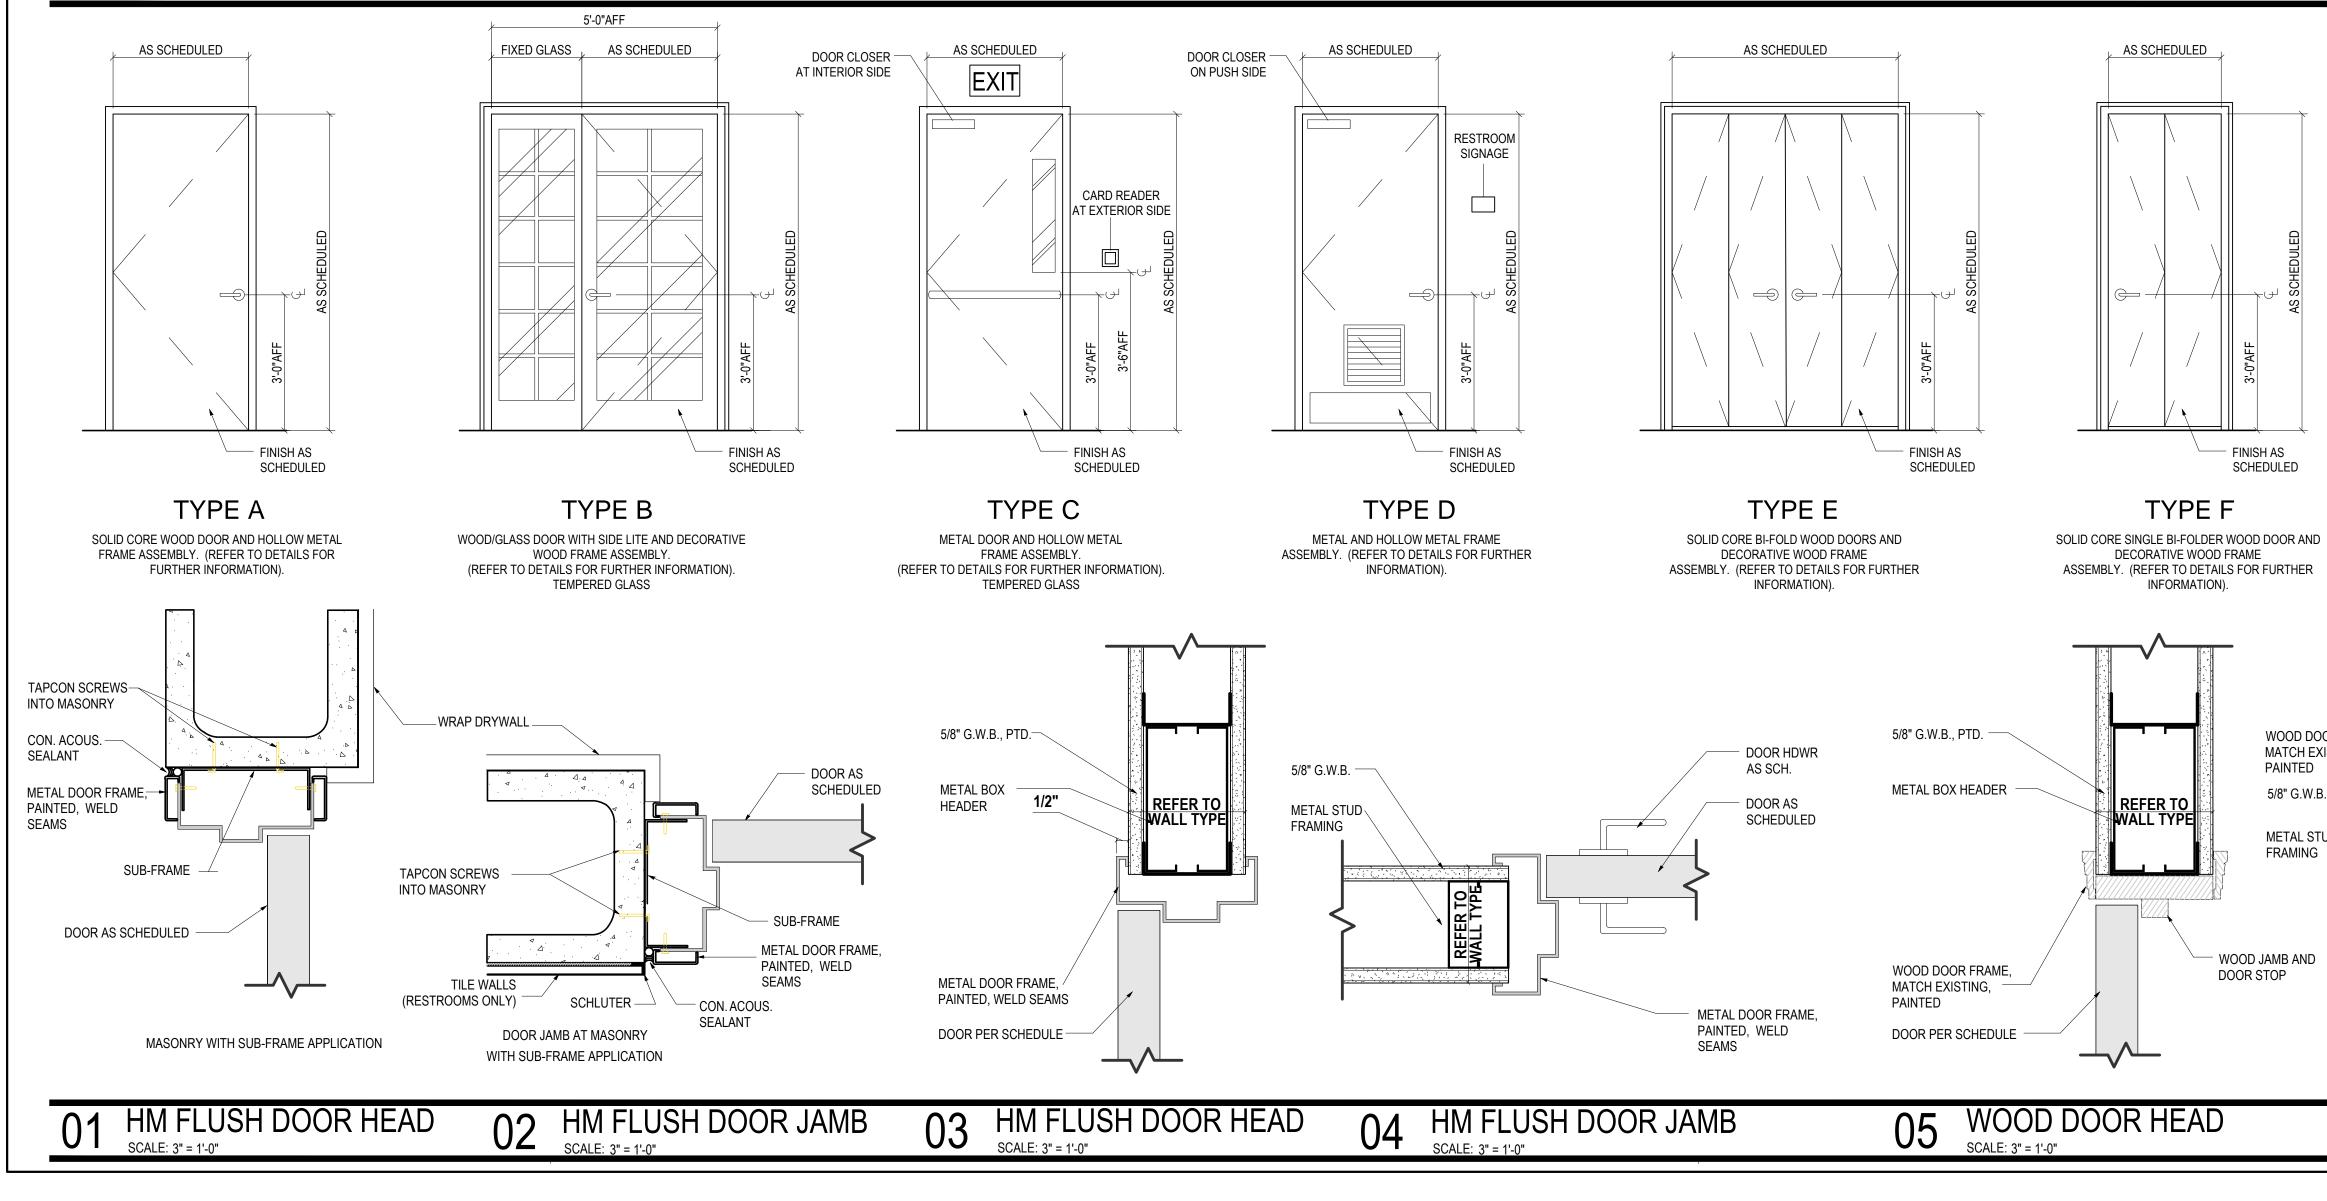

## HARDWARE GROUPS

### **SET 01**

- LOCKSET PRIVACY- SCHLAGE L9496P, 06 LEVER, 626 FINISH
- FULL MORTISE BUTT STAINLESS HINGES, STANLEY CB1900 4 1/2"X4 1/2" (3) - DOOR STOP- FLOOR MOUNTED-DOME; ROCKWOOD 440, 626 FINISH

#### **SET 02**

- LOCKSET PASSAGE- SCHLAGE L9080P, 06 LEVER, 626 FINISH
- FULL MORTISE BUTT STAINLESS HINGES, STANLEY CB1900 4 1/2"X4 1/2" (3) - DOOR STOP- FLOOR MOUNTED-DOME; ROCKWOOD 440, 626 FINISH

**SET 03** 

- CARD READER @ EXTERIOR ONLY
- EXIT DEVICE PANIC HARDWARE SHALL BE PUSH-PAD TYPE TO EGRESS DIRECTION
- AND NOT REQUIRED MORE THAN ONE OPERATION
- TO UNLATCH
- WEATHER STRIPPING - SURFACE CLOSER- LCN 4040XP, 689 FINISH @ PUSH SIDE
- DOOR SWEEP, ZERO 539AA, W1 - DOOR STOP, ZERO 475AA, Y1
- DOOR STOP- FLOOR MOUNTED-DOME; ROCKWOOD 440, 626 FINISH @ EXTERIOR
- THRESHOLD, ZERO 566A SERIES METAL, TYPE 1
- (1) 12" KICKPLATE IVES 8400, US26D FINISH @ PUSH SIDE - KEYED CYLINDER @ INTERIOR AND EXTERIOR

#### SET 04

- LOCKSET PASSAGE- SCHLAGE L9080P, 06 LEVER, 626 FINISH
- FULL MORTISE BUTT STAINLESS HINGES, STANLEY CB1900 4 1/2"X4 1/2" (3) - DOOR STOP- FLOOR MOUNTED-DOME; ROCKWOOD 440, 626 FINISH
- SURFACE CLOSER- LCN 4040XP, 689 FINISH @ PUSH SIDE - DOOR LOUVER, ZERO 20X20" CECO
- (2) 12" KICKPLATE STAINLESS IVES 8400, US32D FINISH - SILENCERS - ROCKWOOD 608 GRAY (METAL DOORS ONLY)

#### **SET 05**

- LOCKSET SINGLE DUMMY HANDLE- SCHLAGE L9000 SERIES, 06 LEVER,
- 626 FINISH @ PULL SIDE ONLY - STAINLESS HINGES, STANLEY FOR BI-FOLD DOORS (3) EACH DOOR
- HEAVY DUTY TOP TRACK KIT FOR BI-FOLD DOORS, CUT TO FIT

## SHEET NOTES


- 1. DOOR TO HAVE 1" UNDERCUT. 2. PAINT ALL DOOR FRAMES EXISTING AND NEW COLOR P-3,
- REFER TO FINISH SCHEDULE ON SHEET A05.01.
- 3. PAINT EXISTING DOORS COLOR P-3, REFER TO FINISH SCHEDULE ON SHEET A05.01.
- 4. NEW DOORS COLOR SHALL BE STAINED, COLOR: SHERWIN WILLIAMS - RANCH OAK, SW3125-O.
- 5. NEW DOOR SHALL BE PAINTED COLOR P-3. REFER TO FINISH SCHEDULE ON SHEET A05.01. 6. SPLIT FINISH - DOOR SHALL BE PAINTED TO MATCH
- EXISTING ON EXTERIOR SIDE. THE INTERIOR SIDE OF DOOR SHALL BE PAINTED COLOR P-3. REFER TO FINISH SCHEDULE ON SHEET A05.01.
- 7. WOOD CASING TO MATCH EXISTING.

**ARCHITECTURAL DESIGN COLL** 945 N. PENNSYLVANIA AVENUE

WINTER PARK, FLORIDA 32789 OFFICE: (407) 629-1188 FAX: (407) 388-1220 WWW. ADCINTERNATIONAL.NET

STATE OF FLORIDA
MARIA FERREIRA
Architect

AA-C001315 AR-95752

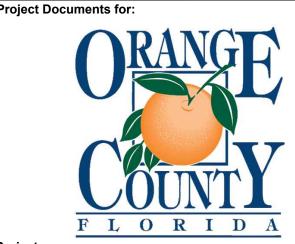

Project: GREAT OAKS VILLAGE WITTENSTEIN COTTAGE ADA UPGRADES AND RENOVATIONS 1784 E. MICHIGAN STREET ORLANDO, FL 32806


		Issue Date	& Issue	Description	Drawn B	y Checked By
DSERS		07.2		60% CD SET	JS	
e floor I.N.O.	Ċ	09.1		90% CD SET	JS	
HERE	Ň					
IATELY	NN	12.0	2.16	PERMIT/BID SE	T JS	S KA
ERING.	Ľ					
	SPACE PLANNING					
	AC					
G	SF					
	٠					
EYING	_					
RIOR	<b>TERIOR DESIGN</b>					
	ES					
	2					
HE GLASS	0					
	ШЦ					
ESS	Z					
Ē	•					
BE	G		41.0			
		Client Information				
				Y CAPITAL PRO	OJECT	<b>5 DIVISION</b>
DTH IN	LAN	400 E SOUTH ORLANDO, F		T 5th FLOOR		
	•	URLANDU, F	L 32001			
	Ж	Drein of Nor				Jacus Data
	Γ.	Project Num	iber			Issue Date
	ARCHITECTI	15253 <b>Drawn By</b>			п-	12/02/2016 oject Status
	Ë	-				•
RIES	CH	JS Observed Dec			Р	ERMIT / BID SET
	AR	Checked By				Scale
ON.		KA				NA
E HALF						
Y WITH		File Name				
		X:\dwgs\1525	3 OC Wi	ittenstein House AD	DA\CAD\S	SHEETS\
		A00.30 DOOF	R, FRAM	E & HARDWARE S	SCHEDU	LES dwg
						-
		Consultant •	Seal/Si	ignature		
		Sheet Title:				
		D	JUK,	FRAME & H	AKDV	VAKE
>						
				SCHEDUL	-ES	
				400.3	5U	

## **GENERAL NOTES**

- A COORDINATE ALL HARDWARE WITH DOOR SWING. CLC TO BE ON INTERIOR OF ROOMS. DOOR STOP SHALL BE MOUNTED AND INSTALLED ON INTERIOR OF ROOMS, U B ALL HARDWARE FINISH TO MATCH EXISTING, U.N.O. WI
- MULTIPLE FINISHES EXIST, NOTIFY ARCHITECT IMMEDI AND CONFIRM FINAL FINISH SELECTION BEFORE ORDE C ALL EXISTING DOORS AND FRAMES TO BE PAINTED,
- REFER TO FINISH SCHEDULE FOR COLOR. D ALL DOOR HARDWARE SHALL BE LEVER TYPE MEETING
- REQUIREMENTS OF ADA. CONTRACTOR SHALL COORDINATE ALL HARDWARE KE WITH THE OWNER AND OBTAIN OWNER'S APPROVAL P TO PLACING HARDWARE ORDER.
- REFER TO SPECIFICATIONS FOR HARDWARE FINISH. G AT DOORS AND SIDELIGHTS WHERE GLASS IS USED TH SHALL BE SAFETY GLAZED (TEMPERED) AND TESTED I WITH ANSI-Z-97.
- H PANIC HARDWARE SHALL BE PUSH-PAD TYPE TO EGRE DIRECTION AND SHALL NOT REQUIRE MORE THAN ONE OPERATION TO UNLATCH. ALL EGRESS DOORS SHALL OPERABLE WITHOUT THE USE OF A KEY OR SPECIAL KNOWLEDGE.
- ALL DOORS TO HAVE MINIMUM 32" CLEAR OPENING WI ACCORDANCE W/ SECTION 1008.1.1 OF THE IBC. J PROVIDE EACH ASSEMBLY WITH ALL SUPPORTS,
- EQUIPMENT, AND MECHANISMS NECESSARY FOR A COMPLETE OPERABLE INSTALLATION. INSTALL WEATHERSTRIPPING AFTER DOOR IS INSTALLED AND ADJUSTED.
- K PROVIDE ALL OTHER MATERIALS SUCH AS BRACKETS FASTENERS, BACK-UP PLATES AND OTHER ACCESSOF NOT SPECIFICALLY DESCRIBED BUT REQUIRED FOR A COMPLETE OPERABLE FINISH HARDWARE INSTALLATION
- L EXTERIOR DOOR THRESHOLD SHALL NOT EXCEED ON INCHES (1/2") IN HEIGHT AND SHALL HAVE A 1:2 BEVEL. M ALL DOOR HARDWARE, AS APPLICABLE, SHALL COMPL
- THE REQUIREMENTS OF NFPA 101, SECTION 7.2.1.5.4.


SCHEDULED

- FINISH AS

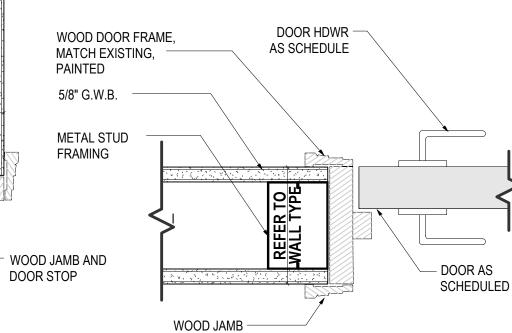


AND DOOR STOP

WOOD DOOR JAMB 06 SCALE: 3" = 1'-0"

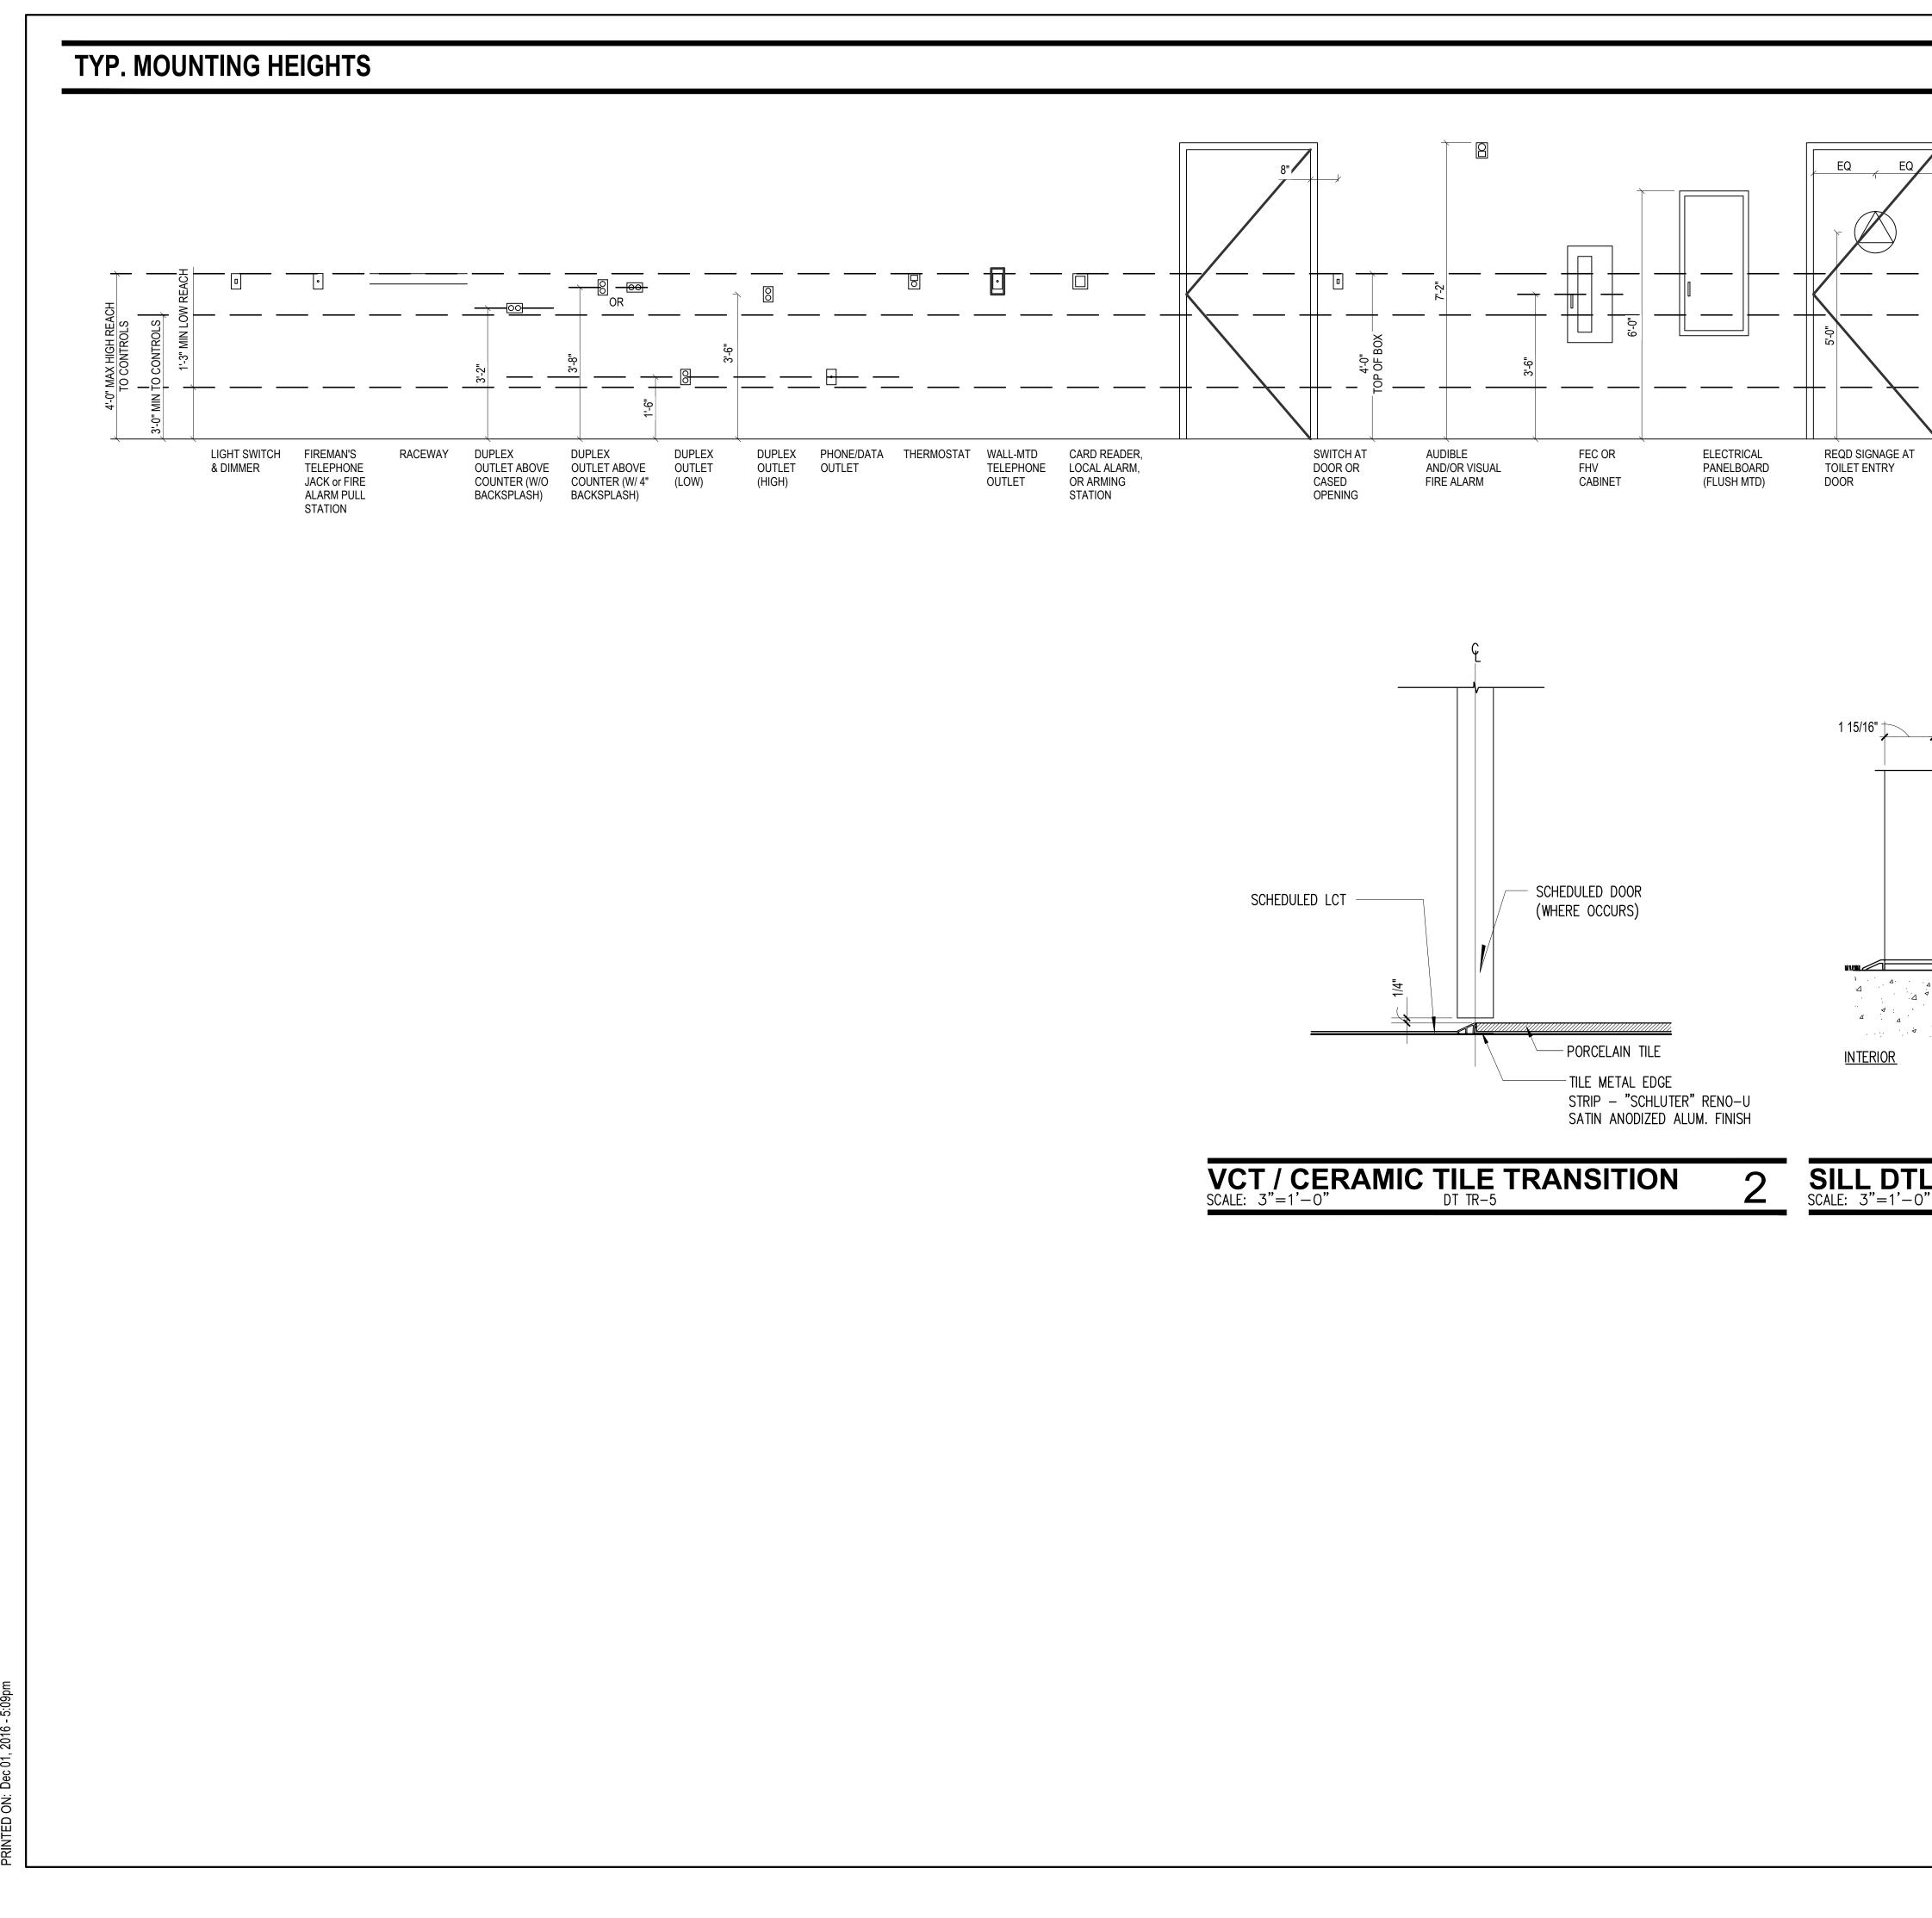

OF ADJACENT FRAME CEITING TINE CEITING TIN	945 N. PENNSYLVANIA AVENUE WINTER PARK, FLORIDA 32789 OFFICE: (407) 629-1188 FAX: (407) 388-1220 WWW. ADCINTERNATIONAL.NET	COLLABORATIVE
AUDINOU 4" REFER TO TO NOTE "G"	STATE OF FLORIDA MARIA FERREIRA Architect • Seal/Signature Project Documents for:	AA-C001315 AR-95752
LOW LEVEL EXIT SIGN (WHERE OCCURS) AT EXIT DOOR EXIT DOOR EXIT DOOR	Project: GREAT OAKS VILLAGE WITT ADA UPGRADES AND RENOV 1784 E. MICHIGAN STREET ORLANDO, FL 32806	
VARIES 1 15/16" HOLLOW METAL FRAME BEYOND INSULATED HOLLOW METAL DOOR	Issue         Date & Issue Description           07.27.16         60% CD SET           09.15.16         90% CD SET           12.02.16         PERMIT/BID	JS KA
PER SCHEDULE SWEEP AS SPECIFIED THRESHOLD CONT. MTL. SILL PAN FLASHING	Subscript{Client Information  Client Information  ORANGE COUNTY CAPITAL F  400 E SOUTH STREET 5th FLOOR  ORLANDO, FL 32801	PROJECTS DIVISION
EXTERIOR	Project Number 15253 Drawn By JS Checked By KA	Issue Date 12/02/2016 Project Status PERMIT / BID SET Scale VARIES
L. @ EXT. HM. FRAME 1	<b>File Name</b> X:\dwgs\15253 OC Wittenstein House A00.31 Typical Standards.dwg	ADA\CAD\SHEETS\
	Consultant • Seal/Signature	
SHEET NOTES		
1. REFER TO SHEET A00.40 FOR ACCESSIBILITY DETAILS.		
	Sheet Title: TYPICAL STA	NDARDS

A00.31

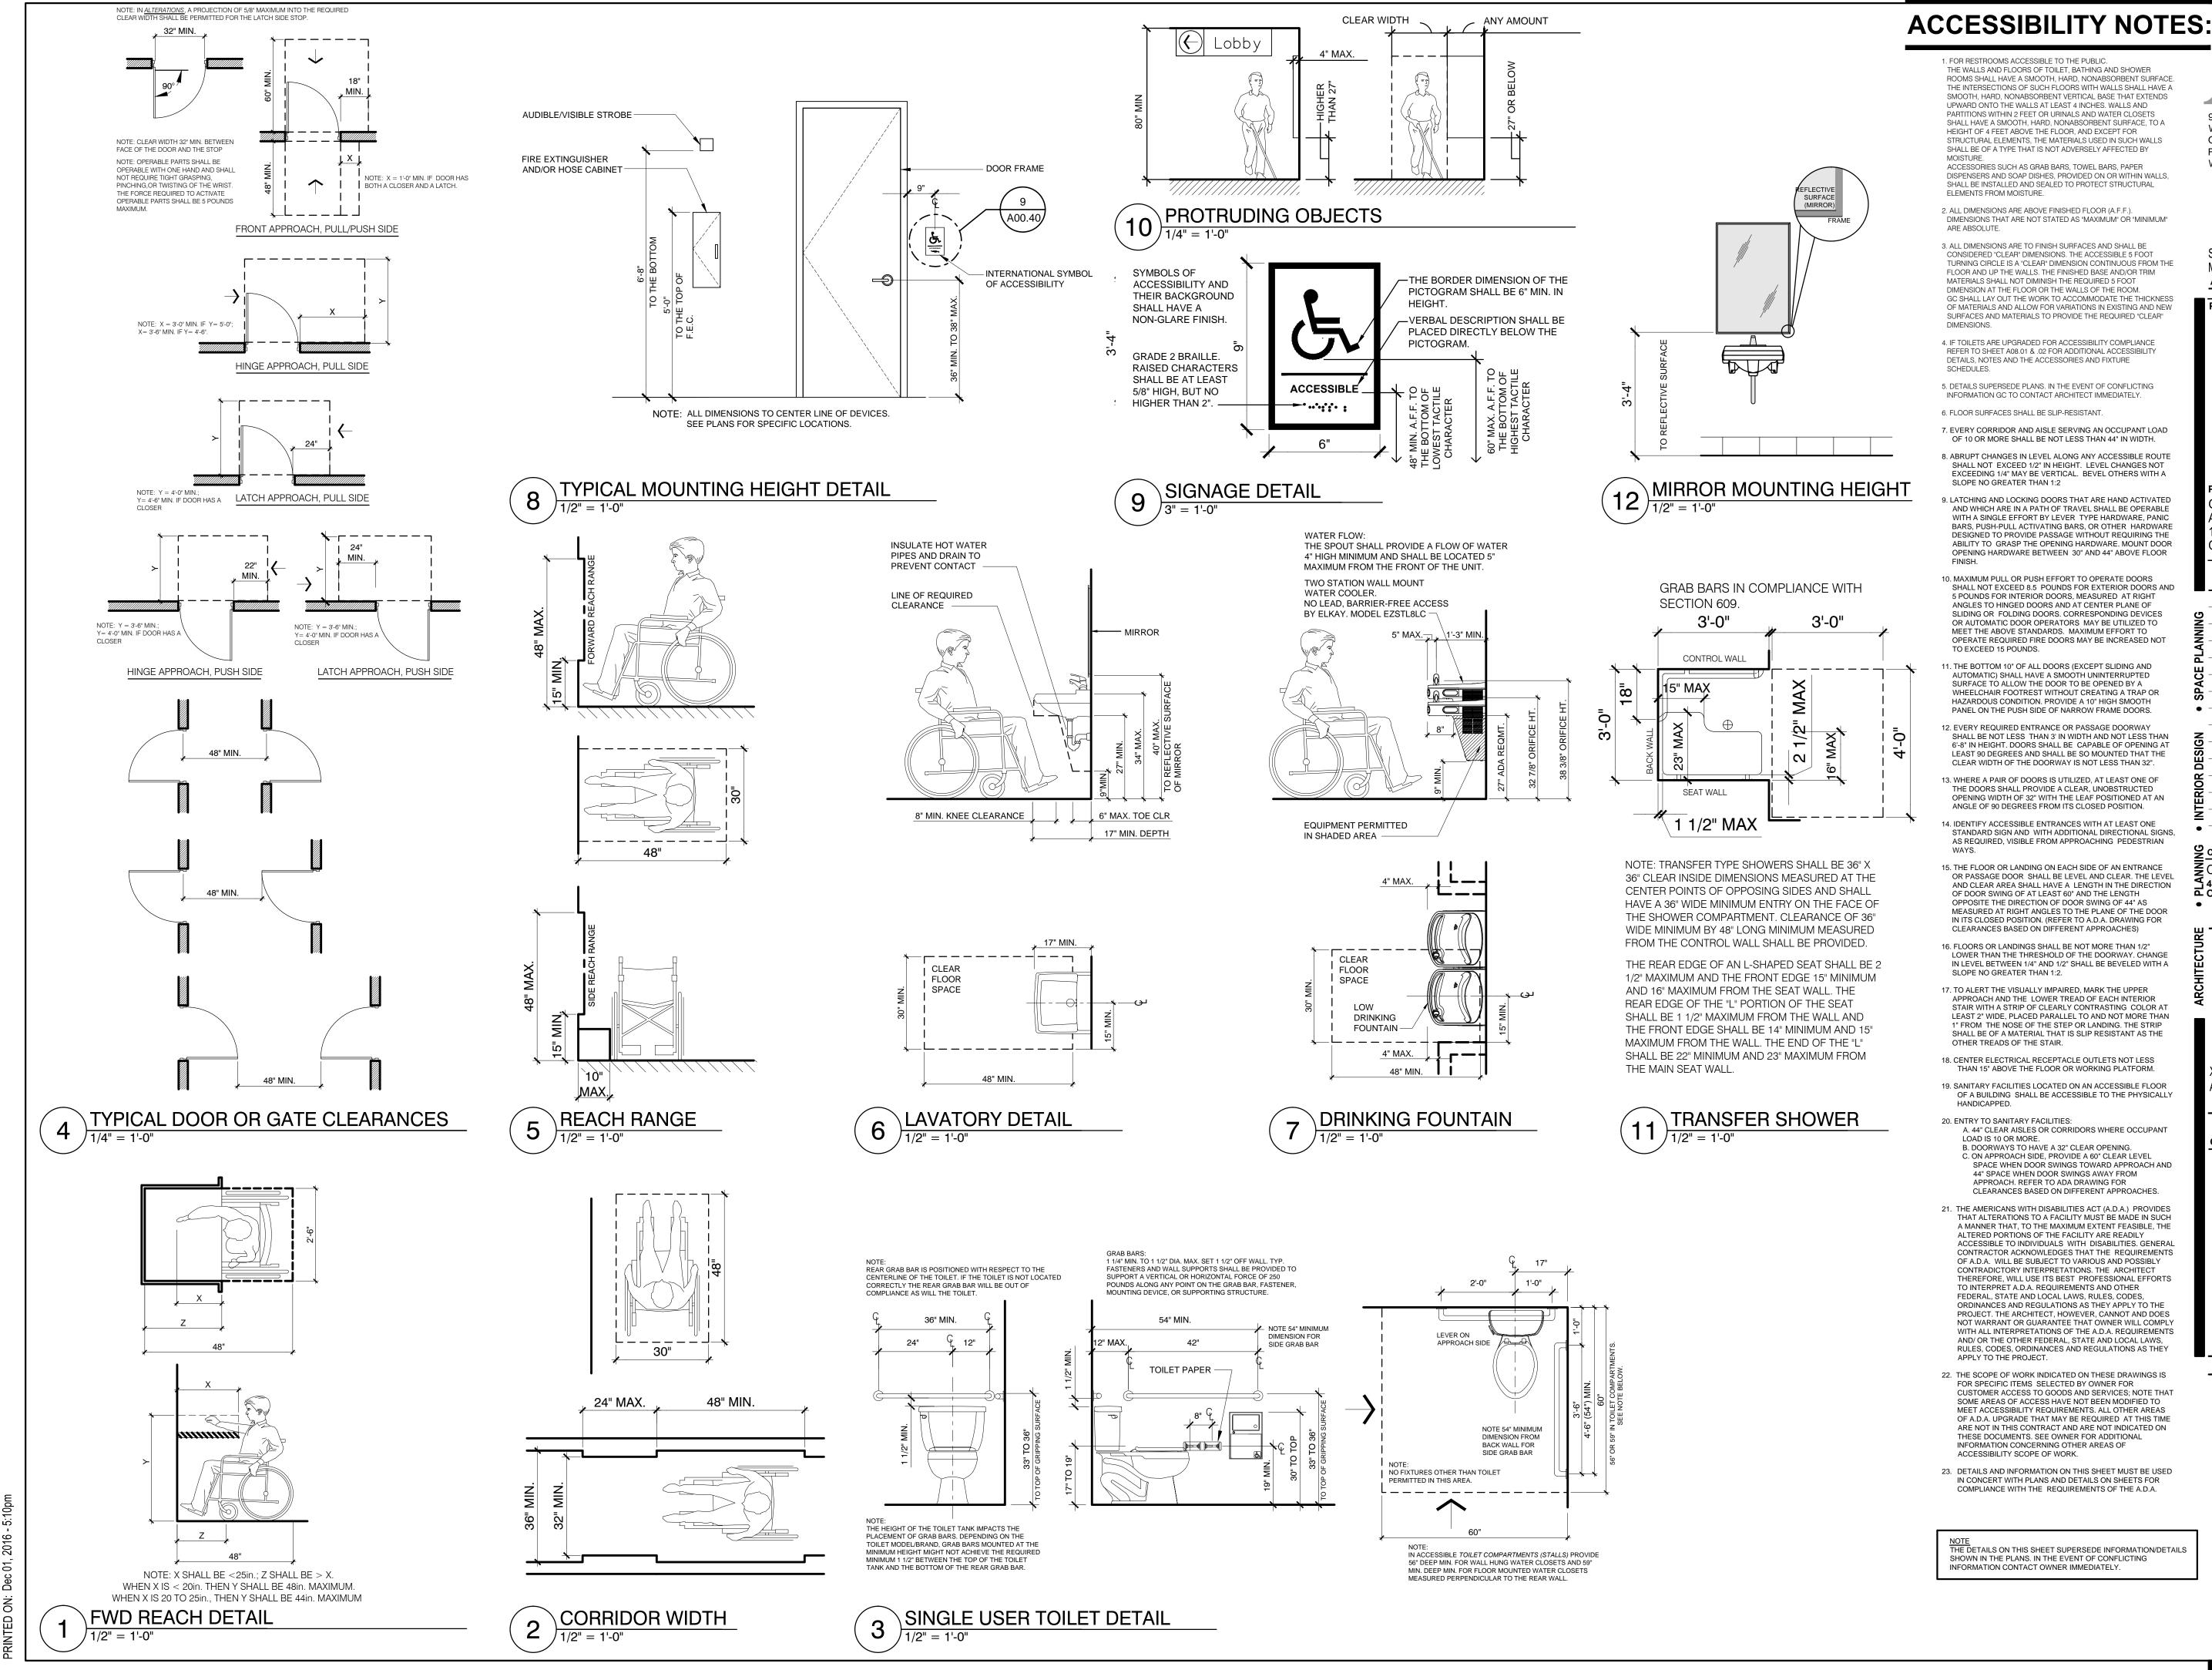

1. FOR RESTROOMS ACCESSIBLE TO THE PUBLIC. THE WALLS AND FLOORS OF TOILET, BATHING AND SHOWER ROOMS SHALL HAVE A SMOOTH, HARD, NONABSORBENT SURFACE. THE INTERSECTIONS OF SUCH FLOORS WITH WALLS SHALL HAVE A SMOOTH, HARD, NONABSORBENT VERTICAL BASE THAT EXTENDS UPWARD ONTO THE WALLS AT LEAST 4 INCHES. WALLS AND PARTITIONS WITHIN 2 FEET OR URINALS AND WATER CLOSETS SHALL HAVE A SMOOTH, HARD, NONABSORBENT SURFACE, TO A HEIGHT OF 4 FEET ABOVE THE FLOOR. AND EXCEPT FOR STRUCTURAL ELEMENTS. THE MATERIALS USED IN SUCH WALLS SHALL BE OF A TYPE THAT IS NOT ADVERSELY AFFECTED BY MOISTURE. ACCESSORIES SUCH AS GRAB BARS, TOWEL BARS, PAPER DISPENSERS AND SOAP DISHES, PROVIDED ON OR WITHIN WALLS, SHALL BE INSTALLED AND SEALED TO PROTECT STRUCTURAL ELEMENTS FROM MOISTURE.

- 2. ALL DIMENSIONS ARE ABOVE FINISHED FLOOR (A.F.F.). DIMENSIONS THAT ARE NOT STATED AS "MAXIMUM" OR "MINIMUM" ARE ABSOLUTE.
- 3. ALL DIMENSIONS ARE TO FINISH SURFACES AND SHALL BE CONSIDERED "CLEAR" DIMENSIONS. THE ACCESSIBLE 5 FOOT TURNING CIRCLE IS A "CLEAR" DIMENSION CONTINUOUS FROM THE FLOOR AND UP THE WALLS. THE FINISHED BASE AND/OR TRIM MATERIALS SHALL NOT DIMINISH THE REQUIRED 5 FOOT DIMENSION AT THE FLOOR OR THE WALLS OF THE ROOM. GC SHALL LAY OUT THE WORK TO ACCOMMODATE THE THICKNESS OF MATERIALS AND ALLOW FOR VARIATIONS IN EXISTING AND NEW SURFACES AND MATERIALS TO PROVIDE THE REQUIRED "CLEAR" DIMENSIONS.
- 4. IF TOILETS ARE UPGRADED FOR ACCESSIBILITY COMPLIANCE REFER TO SHEET A08.01 & .02 FOR ADDITIONAL ACCESSIBILITY DETAILS, NOTES AND THE ACCESSORIES AND FIXTURE SCHEDULES
- 5. DETAILS SUPERSEDE PLANS. IN THE EVENT OF CONFLICTING INFORMATION GC TO CONTACT ARCHITECT IMMEDIATELY.
- 6. FLOOR SURFACES SHALL BE SLIP-RESISTANT.
- 7. EVERY CORRIDOR AND AISLE SERVING AN OCCUPANT LOAD OF 10 OR MORE SHALL BE NOT LESS THAN 44" IN WIDTH.
- 8. ABRUPT CHANGES IN LEVEL ALONG ANY ACCESSIBLE ROUTE SHALL NOT EXCEED 1/2" IN HEIGHT. LEVEL CHANGES NOT EXCEEDING 1/4" MAY BE VERTICAL. BEVEL OTHERS WITH A SLOPE NO GREATER THAN 1:2
- 9. LATCHING AND LOCKING DOORS THAT ARE HAND ACTIVATED AND WHICH ARE IN A PATH OF TRAVEL SHALL BE OPERABLE WITH A SINGLE EFFORT BY LEVER TYPE HARDWARE, PANIC BARS, PUSH-PULL ACTIVATING BARS, OR OTHER HARDWARE DESIGNED TO PROVIDE PASSAGE WITHOUT REQUIRING THE ABILITY TO GRASP THE OPENING HARDWARE. MOUNT DOOR OPENING HARDWARE BETWEEN 30" AND 44" ABOVE FLOOR
- 10. MAXIMUM PULL OR PUSH EFFORT TO OPERATE DOORS SHALL NOT EXCEED 8.5 POUNDS FOR EXTERIOR DOORS AND 5 POUNDS FOR INTERIOR DOORS, MEASURED AT RIGHT ANGLES TO HINGED DOORS AND AT CENTER PLANE OF SLIDING OR FOLDING DOORS. CORRESPONDING DEVICES OR AUTOMATIC DOOR OPERATORS MAY BE UTILIZED TO MEET THE ABOVE STANDARDS. MAXIMUM EFFORT TO OPERATE REQUIRED FIRE DOORS MAY BE INCREASED NOT TO EXCEED 15 POUNDS.
- 11. THE BOTTOM 10" OF ALL DOORS (EXCEPT SLIDING AND AUTOMATIC) SHALL HAVE A SMOOTH UNINTERRUPTED SURFACE TO ALLOW THE DOOR TO BE OPENED BY A WHEELCHAIR FOOTREST WITHOUT CREATING A TRAP OR HAZARDOUS CONDITION. PROVIDE A 10" HIGH SMOOTH PANEL ON THE PUSH SIDE OF NARROW FRAME DOORS
- 12. EVERY REQUIRED ENTRANCE OR PASSAGE DOORWAY SHALL BE NOT LESS THAN 3' IN WIDTH AND NOT LESS THAN 6'-8" IN HEIGHT, DOORS SHALL BE CAPABLE OF OPENING AT LEAST 90 DEGREES AND SHALL BE SO MOUNTED THAT THE CLEAR WIDTH OF THE DOORWAY IS NOT LESS THAN 32".
- 13. WHERE A PAIR OF DOORS IS UTILIZED, AT LEAST ONE OF THE DOORS SHALL PROVIDE A CLEAR, UNOBSTRUCTED OPENING WIDTH OF 32" WITH THE LEAF POSITIONED AT AN ANGLE OF 90 DEGREES FROM ITS CLOSED POSITION
- 4. IDENTIFY ACCESSIBLE ENTRANCES WITH AT LEAST ONE STANDARD SIGN AND WITH ADDITIONAL DIRECTIONAL SIGNS, AS REQUIRED, VISIBLE FROM APPROACHING PEDESTRIAN WAYS.
- 15 THE FLOOR OR LANDING ON EACH SIDE OF AN ENTRANCE OR PASSAGE DOOR SHALL BE LEVEL AND CLEAR. THE LEVEL AND CLEAR AREA SHALL HAVE A LENGTH IN THE DIRECTION OF DOOR SWING OF AT LEAST 60" AND THE LENGTH OPPOSITE THE DIRECTION OF DOOR SWING OF 44" AS MEASURED AT RIGHT ANGLES TO THE PLANE OF THE DOOR IN ITS CLOSED POSITION. (REFER TO A.D.A. DRAWING FOR CLEARANCES BASED ON DIFFERENT APPROACHES)
- 16. FLOORS OR LANDINGS SHALL BE NOT MORE THAN 1/2" LOWER THAN THE THRESHOLD OF THE DOORWAY. CHANGE IN LEVEL BETWEEN 1/4" AND 1/2" SHALL BE BEVELED WITH A SLOPE NO GREATER THAN 1:2
- 17. TO ALERT THE VISUALLY IMPAIRED, MARK THE UPPER APPROACH AND THE LOWER TREAD OF EACH INTERIOR STAIR WITH A STRIP OF CLEARLY CONTRASTING COLOR AT LEAST 2" WIDE PLACED PARALLEL TO AND NOT MORE THAN 1" FROM THE NOSE OF THE STEP OR LANDING. THE STRIP SHALL BE OF A MATERIAL THAT IS SLIP RESISTANT AS THE OTHER TREADS OF THE STAIR.
- 18. CENTER ELECTRICAL RECEPTACLE OUTLETS NOT LESS THAN 15" ABOVE THE FLOOR OR WORKING PLATFORM.
- 19. SANITARY FACILITIES LOCATED ON AN ACCESSIBLE FLOOR OF A BUILDING SHALL BE ACCESSIBLE TO THE PHYSICALLY HANDICAPPED.
- 20. ENTRY TO SANITARY FACILITIES: A. 44" CLEAR AISLES OR CORRIDORS WHERE OCCUPANT LOAD IS 10 OR MORE. B. DOORWAYS TO HAVE A 32" CLEAR OPENING. C. ON APPROACH SIDE, PROVIDE A 60" CLEAR LEVEL SPACE WHEN DOOR SWINGS TOWARD APPROACH AND 44" SPACE WHEN DOOR SWINGS AWAY FROM APPROACH, REFER TO ADA DRAWING FOR CLEARANCES BASED ON DIFFERENT APPROACHES.
- 21. THE AMERICANS WITH DISABILITIES ACT (A.D.A.) PROVIDES THAT ALTERATIONS TO A FACILITY MUST BE MADE IN SUCH A MANNER THAT, TO THE MAXIMUM EXTENT FEASIBLE, THE ALTERED PORTIONS OF THE FACILITY ARE READILY ACCESSIBLE TO INDIVIDUALS WITH DISABILITIES. GENERAL CONTRACTOR ACKNOWLEDGES THAT THE REQUIREMENTS OF A.D.A. WILL BE SUBJECT TO VARIOUS AND POSSIBLY CONTRADICTORY INTERPRETATIONS. THE ARCHITECT THEREFORE, WILL USE ITS BEST PROFESSIONAL EFFORTS TO INTERPRET A.D.A. REQUIREMENTS AND OTHER FEDERAL, STATE AND LOCAL LAWS, RULES, CODES, ORDINANCES AND REGULATIONS AS THEY APPLY TO THE PROJECT. THE ARCHITECT, HOWEVER, CANNOT AND DOES NOT WARRANT OR GUARANTEE THAT OWNER WILL COMPLY WITH ALL INTERPRETATIONS OF THE A.D.A. REQUIREMENTS AND/ OR THE OTHER FEDERAL, STATE AND LOCAL LAWS, RULES, CODES, ORDINANCES AND REGULATIONS AS THEY APPLY TO THE PROJECT.
- 22. THE SCOPE OF WORK INDICATED ON THESE DRAWINGS IS FOR SPECIFIC ITEMS SELECTED BY OWNER FOR CUSTOMER ACCESS TO GOODS AND SERVICES; NOTE THAT SOME AREAS OF ACCESS HAVE NOT BEEN MODIFIED TO MEET ACCESSIBILITY REQUIREMENTS. ALL OTHER AREAS OF A.D.A. UPGRADE THAT MAY BE REQUIRED AT THIS TIME ARE NOT IN THIS CONTRACT AND ARE NOT INDICATED ON THESE DOCUMENTS. SEE OWNER FOR ADDITIONAL INFORMATION CONCERNING OTHER AREAS OF ACCESSIBILITY SCOPE OF WORK.
- 23. DETAILS AND INFORMATION ON THIS SHEET MUST BE USED IN CONCERT WITH PLANS AND DETAILS ON SHEETS FOR COMPLIANCE WITH THE REQUIREMENTS OF THE A.D.A.

NOTE THE DETAILS ON THIS SHEET SUPERSEDE INFORMATION/DETAILS SHOWN IN THE PLANS. IN THE EVENT OF CONFLICTING INFORMATION CONTACT OWNER IMMEDIATELY.

**ARCHITECTURAL DESIGN COLL** 

945 N. PENNSYLVANIA AVENUE WINTER PARK, FLORIDA 32789 OFFICE: (407) 629-1188 FAX: (407) 388-1220 WWW. ADCINTERNATIONAL.NET

STATE OF FLORIDA MARIA FERREIRA
Architect       Seal/Signature
Proiect Documents for:

'roject

AA-C001315 AR-95752



GREAT OAKS VILLAGE WITTENSTEIN COTTAGE ADA UPGRADES AND RENOVATIONS 1784 E. MICHIGAN STREET ORLANDO, FL 32806

	Issue	Date & Issu	e Description	Drawn By	Checked By
		07.27.16	60% CD SET	JS	KA
g		09.15.16	90% CD SET	JS	KA
Z		12.02.16	PERMIT/BID SE	t js	KA
SPACE PLANNING					
с. Ш					
AC					
S					
•					
z					
SIG					
В					
<u> N</u>					
INTERIOR DESIGN					
Ζ					
•					
Ы И	Client In	formation			
_			TY CAPITAL PRO	OJECTS	DIVISION
٩,	400 E S	OUTH STRE	EET 5th FLOOR		
•	ORLAN	DO, FL 3280	U1		
JRE	Proiec	t Number		I	ssue Date
				-	

- 15253 <b>Drawn By</b>	
JS Checked By	

12/02/2016 Project Status PERMIT / BID SET Scale VARIES

File Name


K:\dwgs\15253 OC Wittenstein House ADA\CAD\SHEETS\ A00.40 ACCESSIBILITY INFO AL.dwg


onsultant • Seal/Signature

Sheet Title:

ACCESSIBILITY INFO.



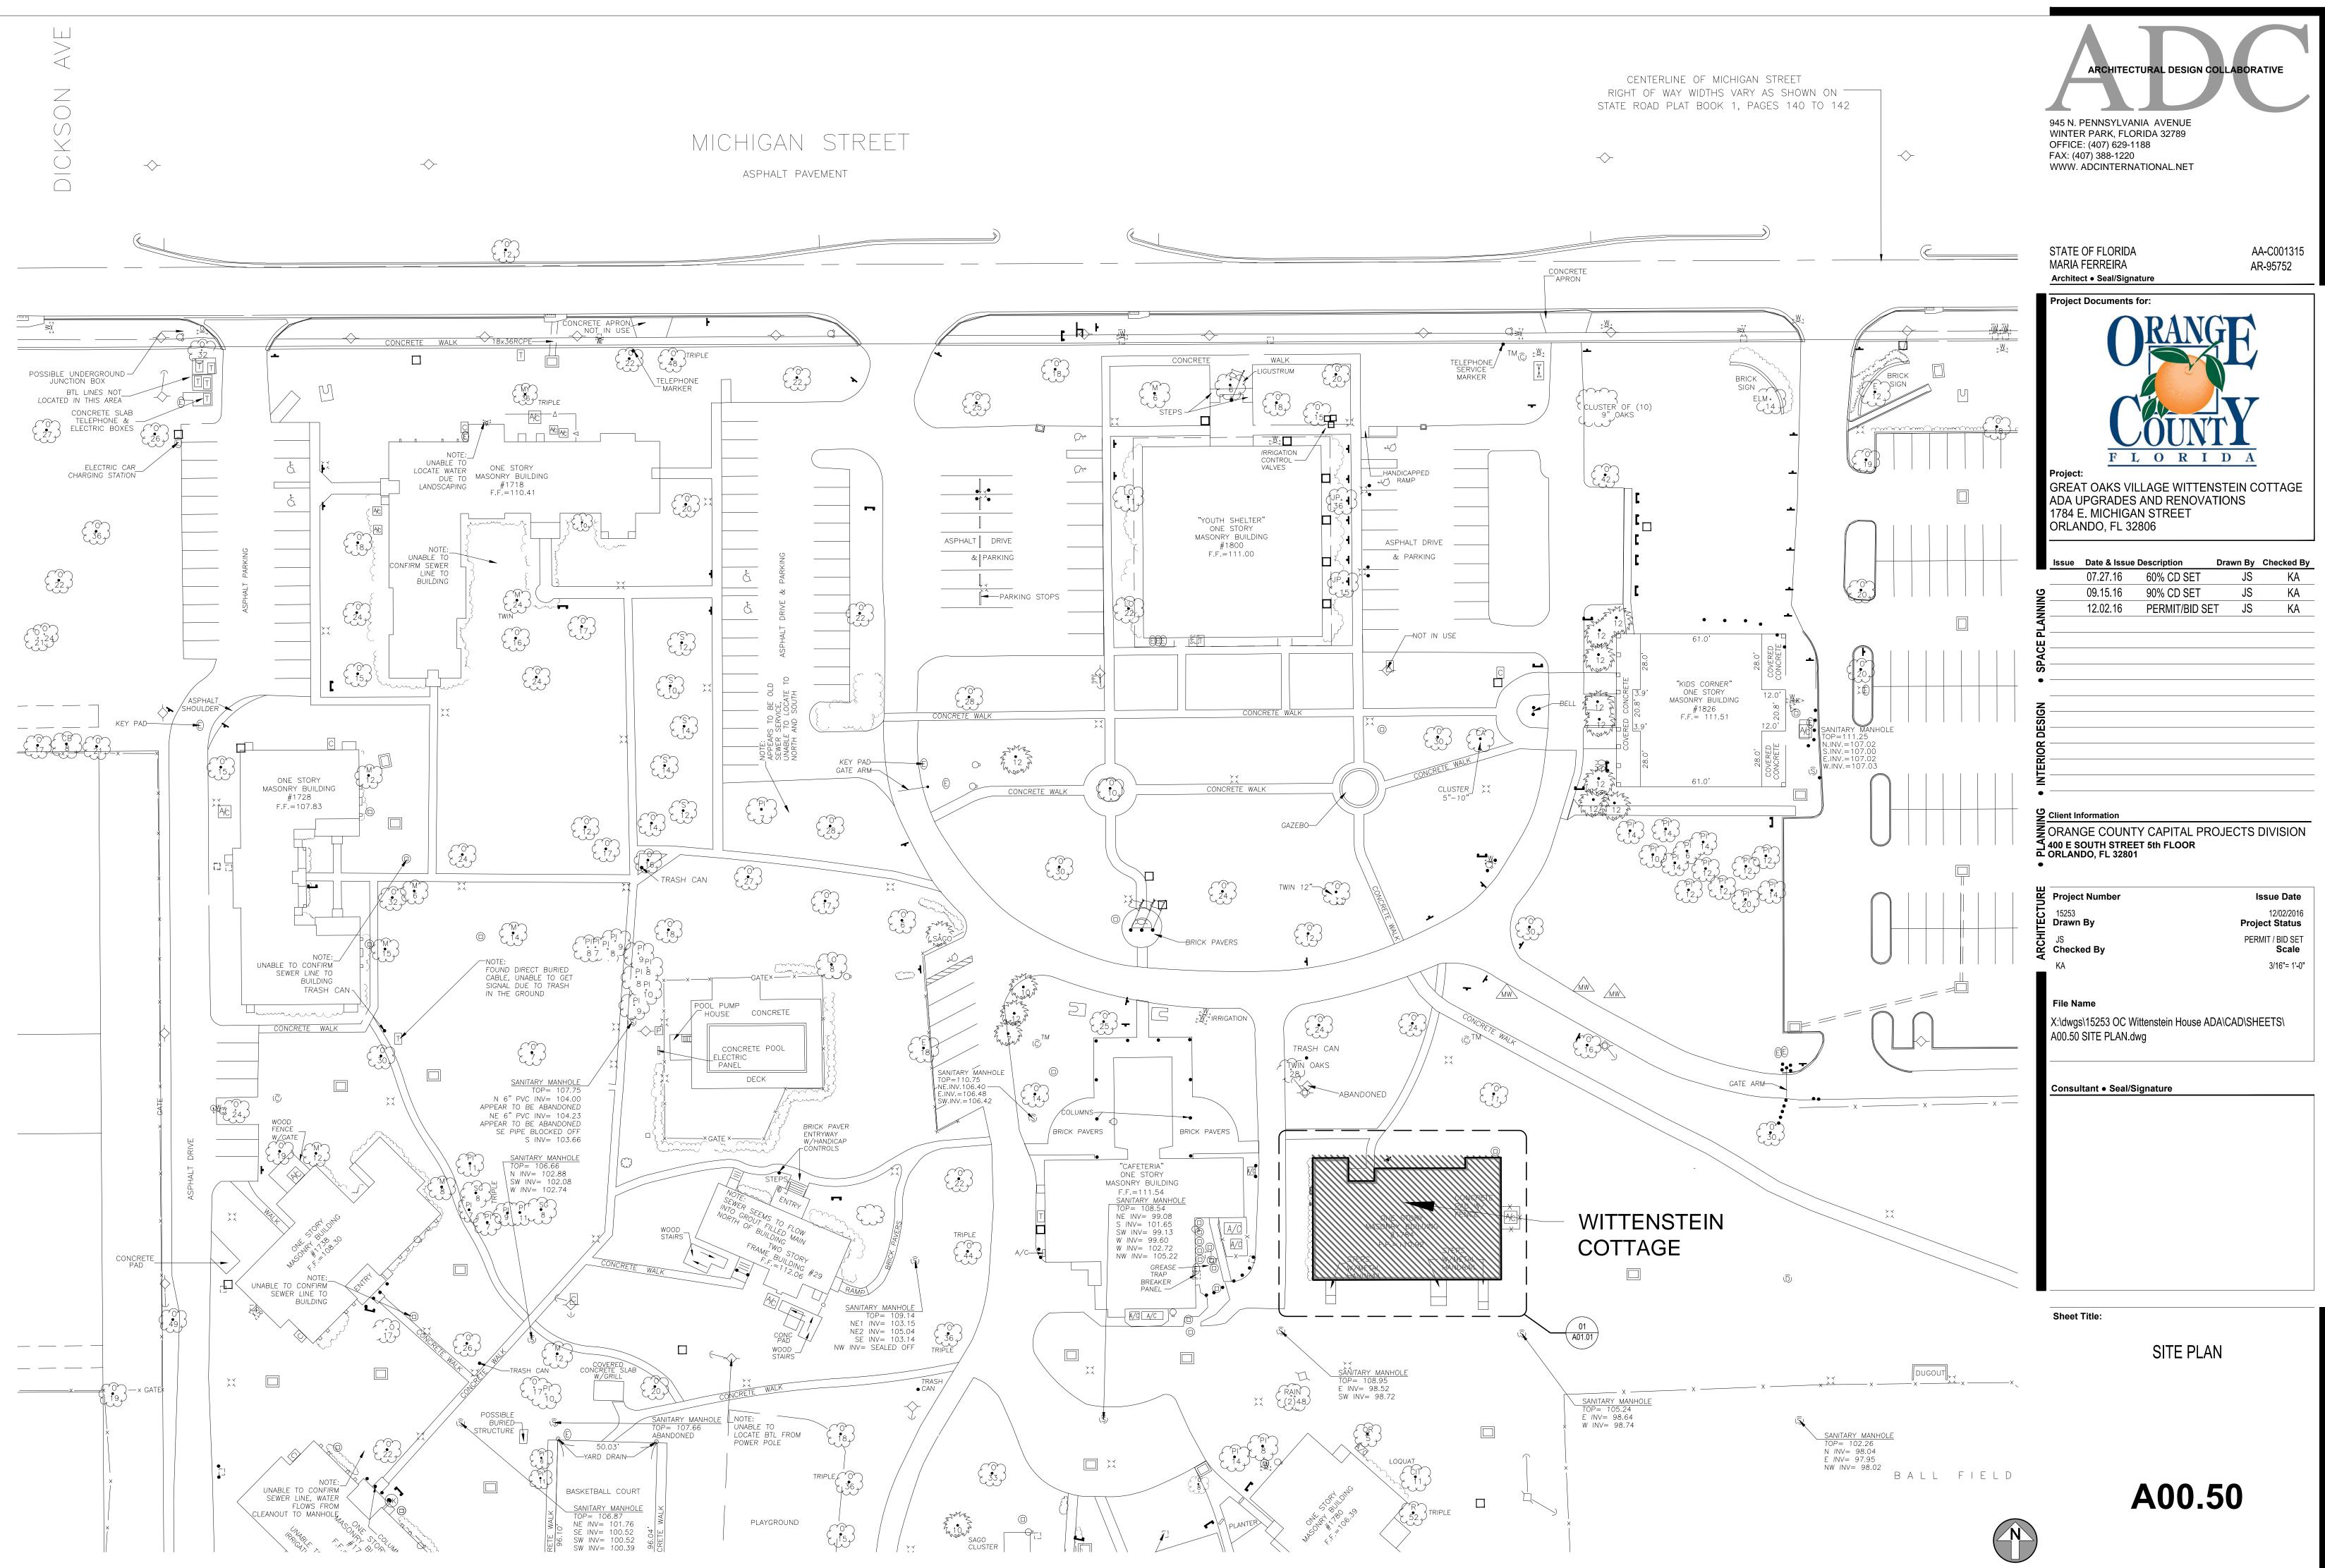

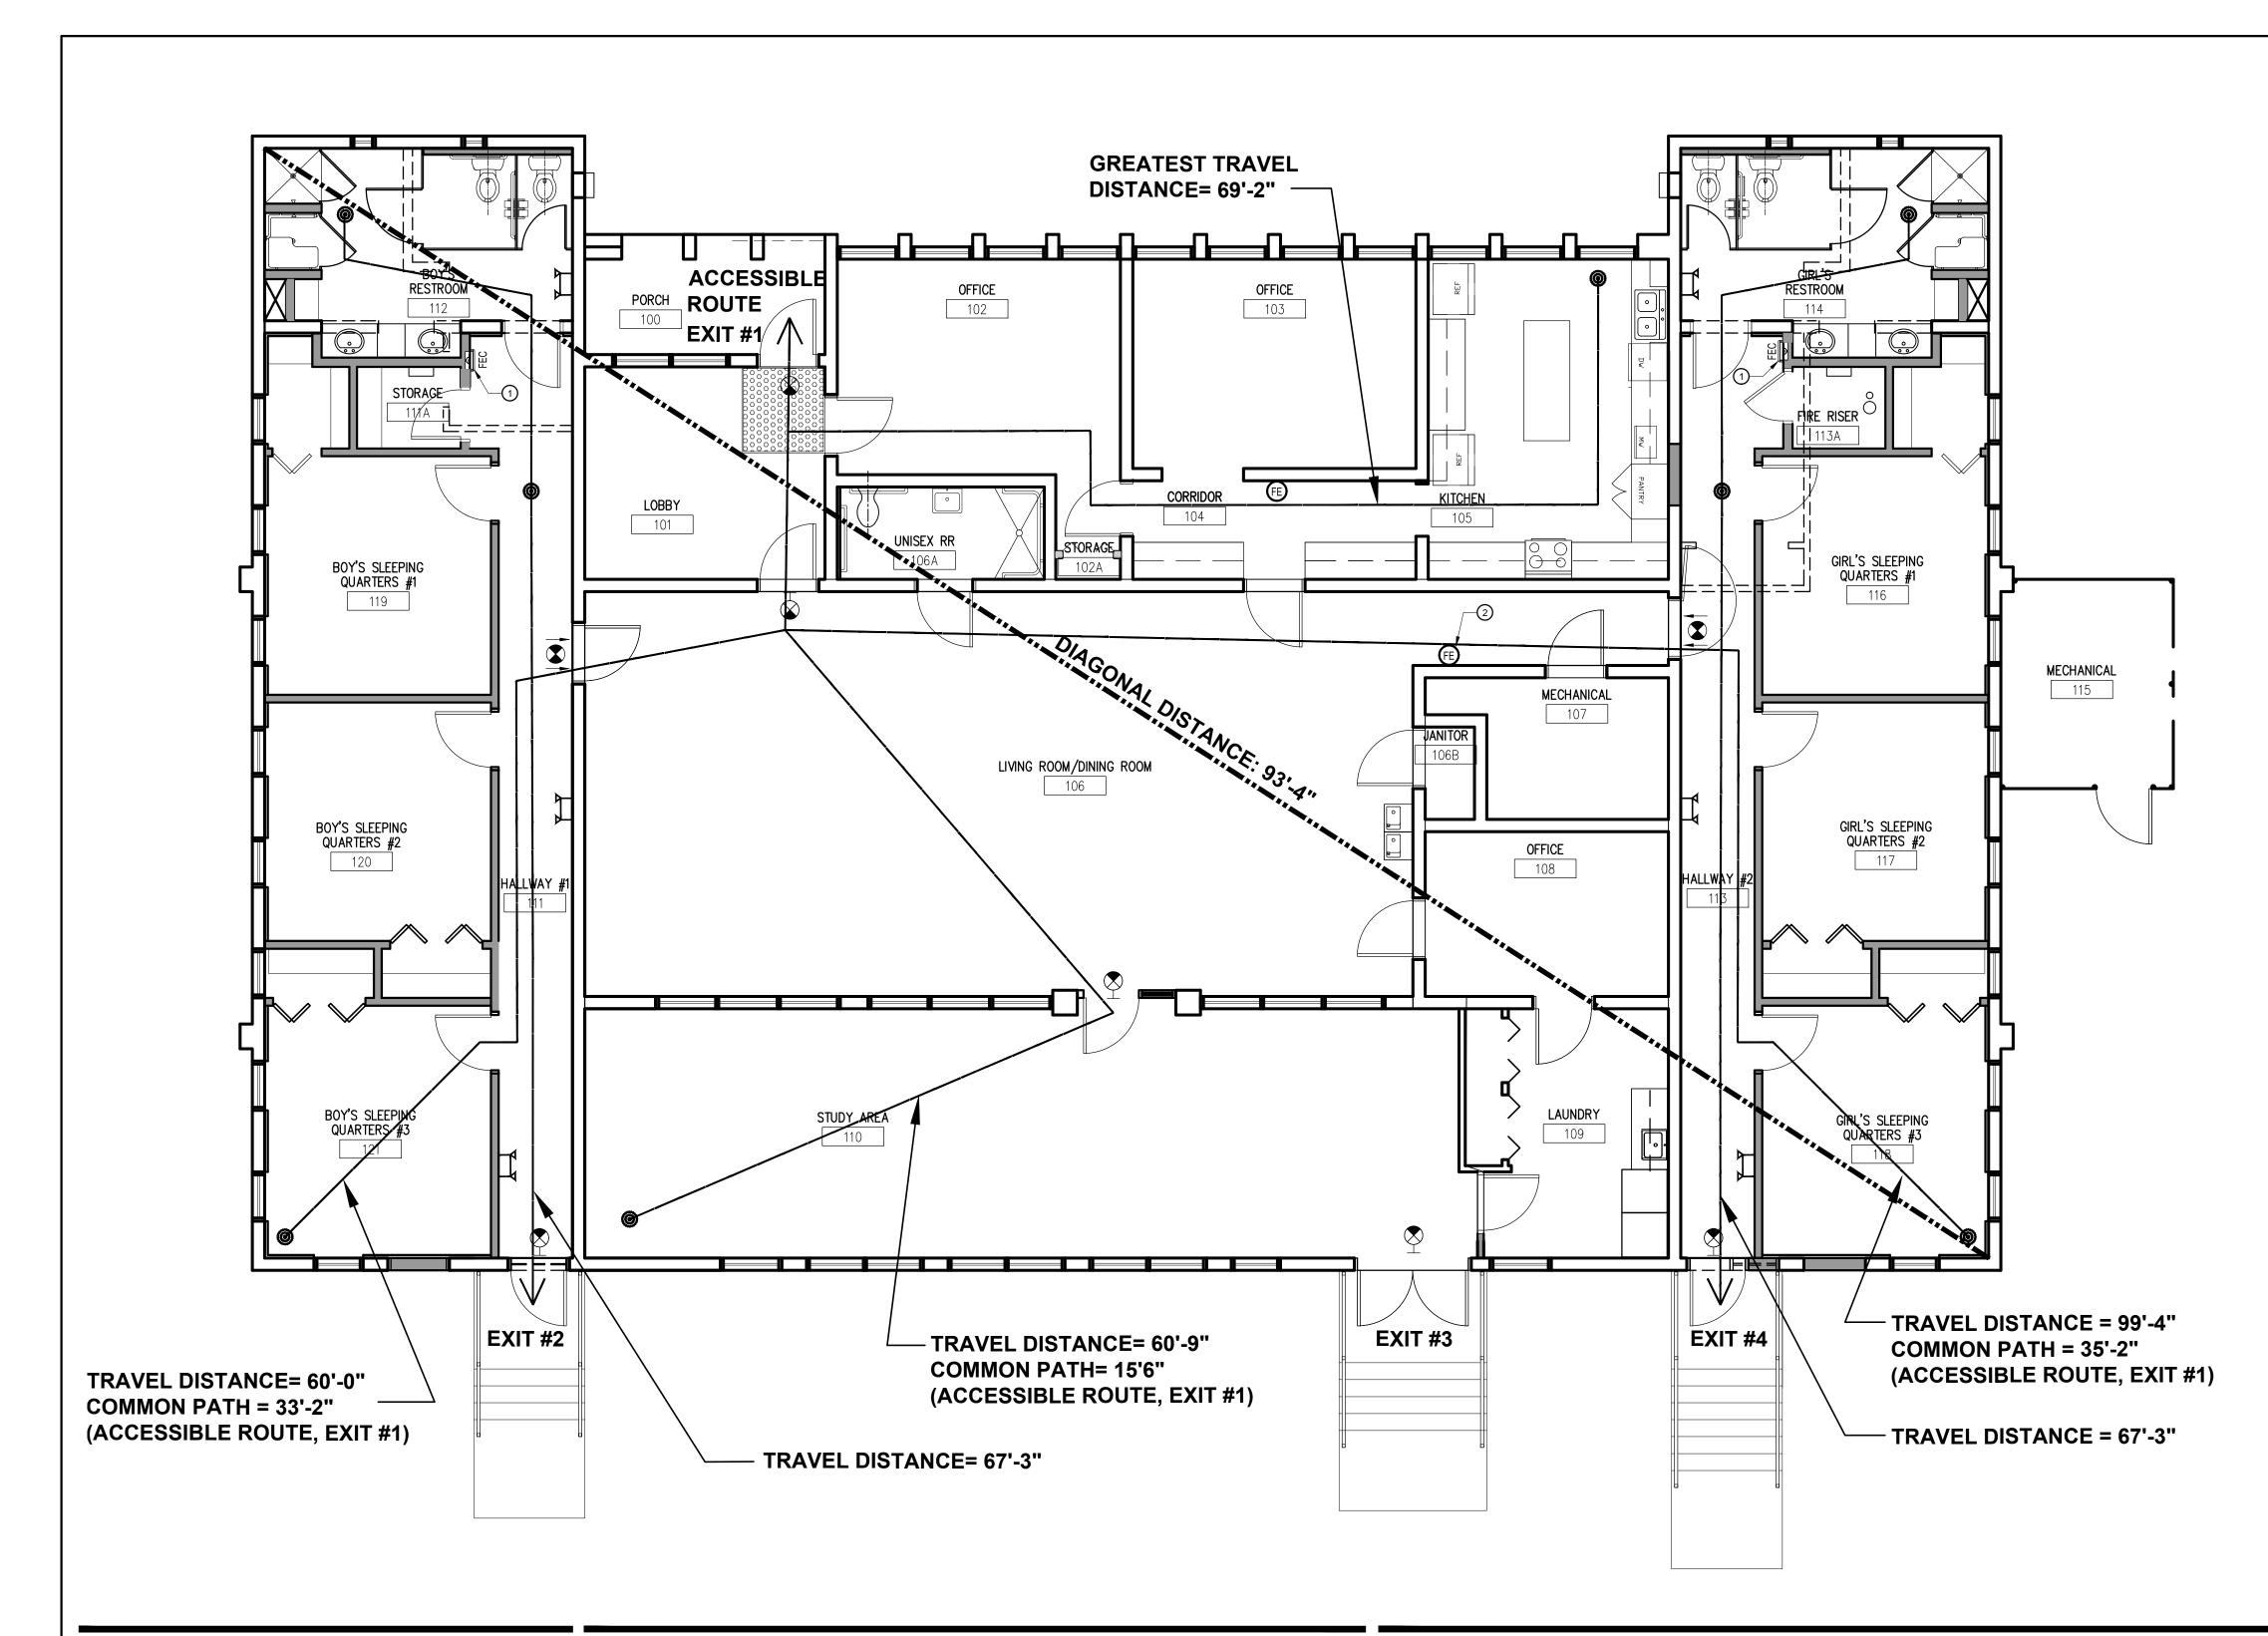

## **KEY NOTES**

- (1) WALL RECESSED FIRE EXTINGUISHER CABINET
- ② INSTALL WALL HUNG FIRE EXTINGUISHER

LEGEND			
SYMBOL	REMARKS		
(COMMON PATH OF TRAVEL) TRAVEL DISTANCE	TRAVEL DISTANCE		
	EXIT SIGNAGE - SEE MEP DRAWINGS FOR SPECIFICATIONS		
	EXISTING WALL		
	NEW NON RATED WALL TO UNDERSIDE OF EXISITNG CEILING TILE		
FEC	FIRE EXTINGUISHER CABINET		
	EMERGENCY LIGHTS		

## **PROJECT INFORMATION / CODE SUMMARY**

#### APPLICABLE CODES FLORIDA BUILDING CODE - (5th EDITION 2014) FLORIDA BUILDING CODE ACCESSIBILITY (5th EDITION 2014) FLORIDA BUILDING CODE - EXISTING BUILDING- (5th EDITION 2014) FLORIDA FIRE PREVENTION CODE - (5th EDITION) NFPA 101 - LIFE SAFETY CODE 2012 WITH FLORIDA AMENDMENTS NFPA 1- UNIFORM FIRE CODE 2012 WITH FLORIDA AMENDMENTS NFPA 70 - NATIONAL ELECTRICAL CODE - 2011 FLORIDA MECHANICAL CODE - 2014

CITY OF ORLANDO JURISDICTION

### 

GROUP CLASSIFICATION: MAX. PROJECTED RESIDENTS:

RESIDENTIAL:

RESIDENTIAL R4 - GROUP HOME 12 OCC. TOTAL IN BEDROOMS PLUS (4) MAX SUPPORT STAFF TOTAL OF (16) OCCUPANTS OR LESS. OFFICES PROVIDED FOR 24 HOUR STAFF WHICH ARE AN ACCESSORY USE TO THE R-4 OCCUPANCY.

#### **EXITS**

SEE LIFE SAFETY SUMMARY AND	DIAGRAM ON A00.51
MAX. TRAVEL DISTANCE:	250 FT. (SPRINKLERED)
PROVIDED:	99 FT.
MAX. COMMON PATH OF TRAVEL	: 75 FT (SPRINKLERED)
PROVIDED:	35 FT.
MAX. DEAD END CORRIDOR:	50FT. (SPRINKLERED)
PROVIDED:	0 FT.
EGRESS CAPACITY:	137 x .2 = 27.4"
PROVIDED:	170" (3 doors @ 34" ONE AT 6


### 

	TYPE: SPRINKLERED or NONSPRINKLERED: HEIGHT: CLASSIFICATION OF WORK:	EXISTING SPRINKLERED BUILDIN EXISTING ALTERATION / RENOVA
--	-------------------------------------------------------------------------------	--------------------------------------------------------------------

#### PLUMBING REQUIREMENTS:

NOTE: WATER CLOSETS, LAVATORIES, & DRINKING FOUNTAINS PROVIDED IN THE BUILDING COMMON AREA. EXISTING RESTRO & DRINKING FOUNTAINS TO REMAIN AND ARE TO BE REPLACE SAME AMOUNT OF NEW PLUMBING FIXTURES.

	ARCHITECTU 945 N. PENNSYLVANIA WINTER PARK, FLORI OFFICE: (407) 629-1184 FAX: (407) 388-1220 WWW. ADCINTERNAT	DA 32789 8
	STATE OF FLORIDA MARIA FERREIRA Architect • Seal/Signatu	AA-C001315 AR-95752 re
		RANGE O R I D A AGE WITTENSTEIN COTTAGE ND RENOVATIONS STREET
	09.15.16	Drawn ByChecked By60% CD SETJSKA90% CD SETJSKAPERMIT/BID SETJSKA
	S Client Information	
	ORANGE COUNTY 400 E SOUTH STREET ORLANDO, FL 32801	CAPITAL PROJECTS DIVISION 5th FLOOR
	Project Number 15253 Drawn By JS Checked By KA	Issue Date 12/02/2016 Project Status PERMIT / BID SET Scale 3/16"= 1'-0"
	File Name X:\dwgs\15253 OC Witte A00.51 LIFE SAFETY P	enstein House ADA\CAD\SHEETS\ LAN.dwg
	Consultant ● Seal/Sig	nature
KEY PLAN		
68") ING ATION	Sheet Title:	E SAFETY PLAN
NEW FLOOR PLAN S ARE COMS ED WITH	Ą	00.51

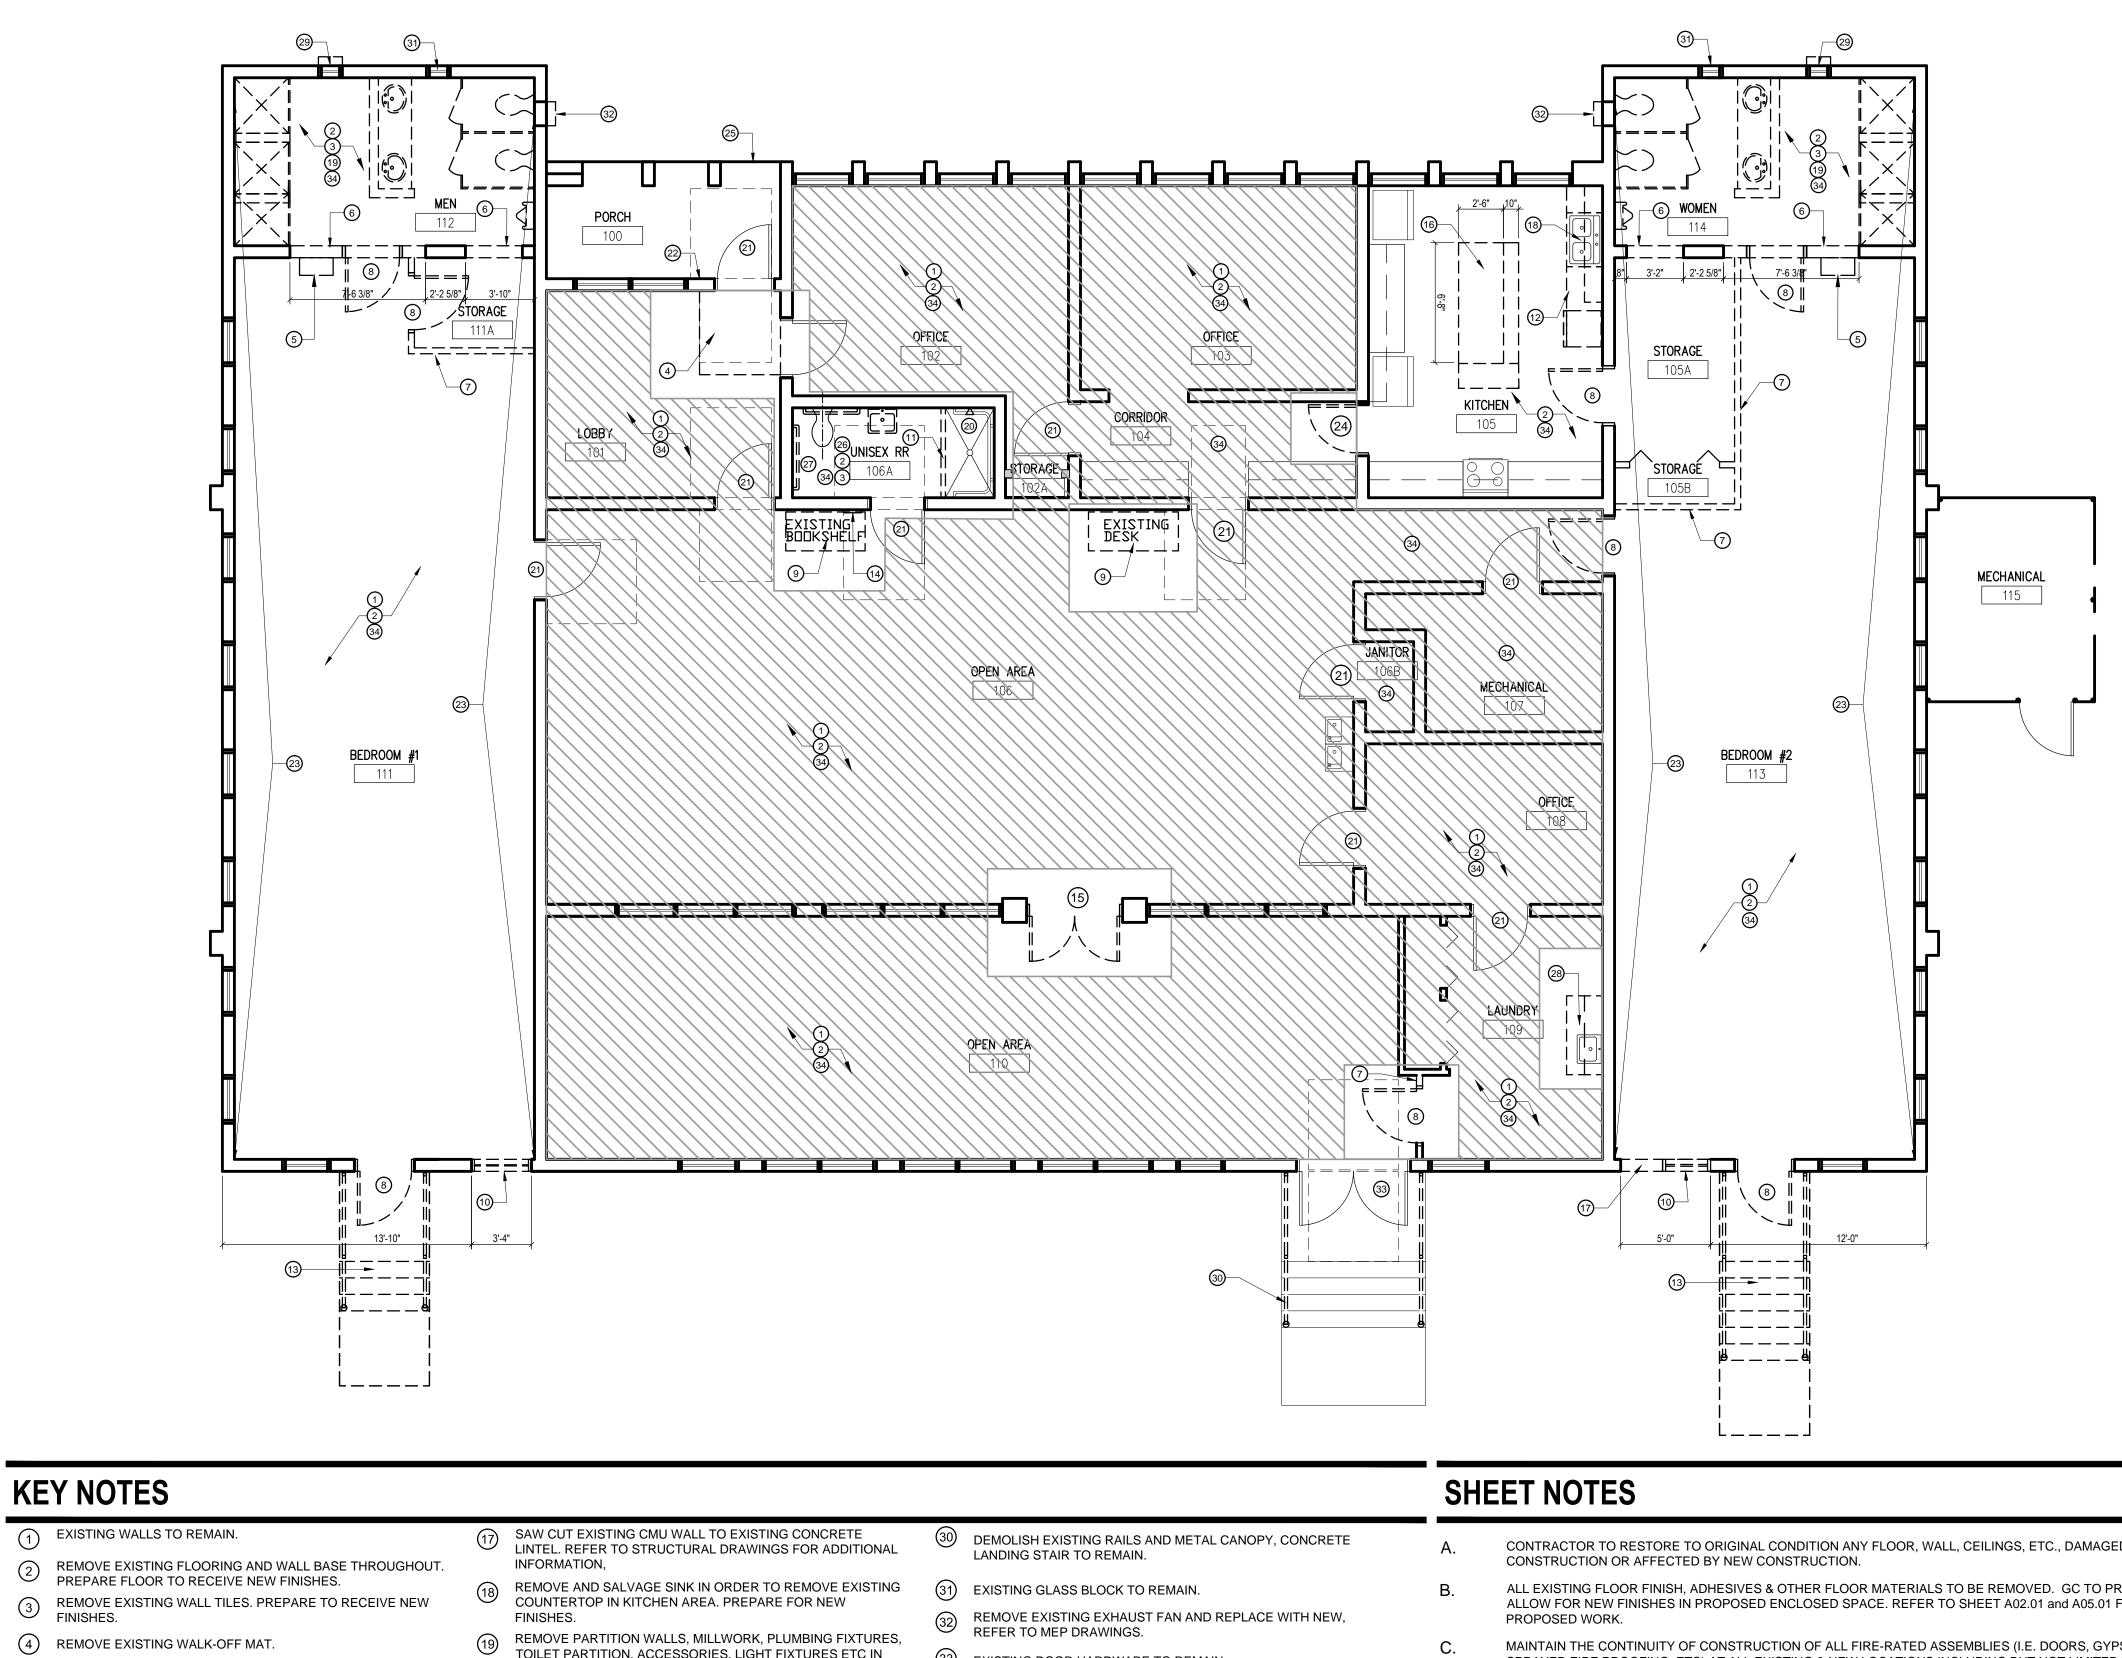

- 5 REMOVE AND RELOCATE TEMPERATURE DALANGING THE FOR SHOWERS. REFER TO MEP DRAWINGS FOR ADDITIONAL REMOVE AND RELOCATE TEMPERATURE BALANCING VALVES INFORMATION.
- 6 SAW CUT EXISTING CMU UP TO EXISTING TIE BEAM. REFER TO STRUCTURAL DRAWINGS, SHEET S05.01.
- (7) REMOVE PORTION OF EXISTING PARTITION WALL.
- 8 REMOVE DOOR AND FRAME. PATCH AND REPAIR WALL AS NEEDED.
- (9) RELOCATE FURNITURE TO PROVIDE CLEAR FLOOR SPACE. 10 REMOVE EXISTING WINDOW AND FRAME. GC TO SALVAGE AND RETURN TO ORANGE COUNTY FACILITIES TO KEEP IN
- STORAGE. (1) REMOVE/GRIND SHOWER THRESHOLD. PREPARE FLOOR FOR LEVEL TRANSITION INTO SHOWER.
- (12) REMOVE COUNTER TOP AND BASE CADINE IS IN OF KITCHEN. PREPARE TO RECEIVE NEW FINISHES. REMOVE COUNTER TOP AND BASE CABINETS IN THIS SECTION Image: 13DEMOLISH EXISTING CONCRETE LANDING STAIR, RAILS AND<br/>METAL CANOPY.
- (14) REMOVE RESTROOM SIGNAGE. PATCH AND REPAIR WALL, MATCH EXISTING.
- (15) REMOVE DOUBLE DOORS, RETURN TO ORANGE COUNTY FACILITIES TO KEEP IN STORAGE.
- (16) GC TO CUT EXISTING MILLWORK TO PROVIDE REQUIRED CLEARANCES. REMOVE EXISTING TABLE LEGS AND REUSE, REMOVE EXISTING BASE CABINET.

- TOILET PARTITION, ACCESSORIES, LIGHT FIXTURES ETC IN EXISTING RESTROOMS. CAP ALL PLUMBING. REFER TO MEP DRAWINGS FOR ADDITIONAL INFORMATION.
- (20) REMOVE SHOWER HEAD ASSEMBLY AND PREPARE WALL TO RECEIVE NEW PLUMPING EVALUES RECEIVE NEW PLUMBING FIXTURE. REMOVE INTERIOR DOOR HARDWARE THROUGHOUT THAT IS 21
- NOT LEVER. ADJUST DOOR CLOSER THROUGHOUT TO MAXIMUM OPENING FORCE OF 5 LBS MAXIMUM.
- (2) RE-MOUNT DOOR BELL TO MAX HEIGHT 48" AFF. PATCH AND REPAIR AS REQUIRED TO MATCH EXISTING PAINT AND FINISHES.
- REMOVE EXISTING WALL PANELING. PREPARE WALL TO 23 RECEIVE NEW FINISHES. PROTECT WINDOWS PATCH AND REPAIR AS NEEDED.
- (24) REMOVE DOOR AND DOOR FRAME. GC TO PREPARE FOR CASED OPENING AT KITCHEN FRAME. CASED OPENING AT KITCHEN ENTRY.
- (25) GC TO PREPARE CONCRETE TO PROVIDE LEVEL TRANSITION AT PORCH. REPAIR SIDEWALK WHERE CONCRETE IS DAMAGED.
- 26 REMOVE EXISTING TOILET TO ALLOW FOR NEW, 18" O.C FROM WALL.
- (27) REMOVE GRAB BARS TO ALLOW FOR NEW, ADA COMPLIANT.
- GC TO REMOVE EXISTING SINK, FAUCET AND SINK CABINET 28 BASE. SALVAGE SINK TO BE REINSTALLED AND COUNTERTOP.
- (29) REMOVE EXISTING EXHAUST FAN SAW CUT CMU TO HEIGHT OF ADJACENT GLASS BLOCK.

#### CONTRACTOR TO RESTORE TO ORIGINAL CONDITION ANY FLOOR, WALL, CEILINGS, ETC., DAMAGED DURING ALL EXISTING FLOOR FINISH, ADHESIVES & OTHER FLOOR MATERIALS TO BE REMOVED. GC TO PREP FLOOR TO ALLOW FOR NEW FINISHES IN PROPOSED ENCLOSED SPACE. REFER TO SHEET A02.01 and A05.01 FOR EXTENT OF MAINTAIN THE CONTINUITY OF CONSTRUCTION OF ALL FIRE-RATED ASSEMBLIES (I.E. DOORS, GYPSUM ENCLOSURES, 33 EXISTING DOOR HARDWARE TO REMAIN. SPRAYED FIRE PROOFING, ETC) AT ALL EXISTING & NEW LOCATIONS INCLUDING BUT NOT LIMITED TO STRUCTURAL COLUMNS, BEAMS, AND FLOOR SLAB. (34) REMOVE ALL EXISTING DRYWALL CEILING THROUGHOUT D. COORDINATE ALL SHUTDOWNS IN UTILITY SERVICE WITH OWNER PRIOR TO PERFORMING SHUTDOWNS IN UTILITY ENTIRE BUILDING, PREPARE TO INSTALL NEW FIRE SERVICE PER LANDLORD RULES AND REGULATIONS. SPRINKLER SYSTEM. REFER TO MEP DRAWINGS FOR ADDITIONAL INFORMATION. REFER TO ENGINEERING DISCIPLINE DOCUMENTS FOR SCOPE OF DEMOLITION FOR MECHANICAL, ELECTRICAL, FIRE PROTECTION, SPECIAL SYSTEMS, ETC. PROTECT ALL EXTERIOR WINDOWS (FRAME AND GLAZING) FROM DAMAGE DURING DEMOLITION, CONSTRUCTION, AND INSTALLATION PHASES. LEGEND GC TO COORDINATE REMOVAL OF EXISTING FREESTANDING AND BUILT IN FURNITURE WITH CLIENT. G. ALL EXISTING COLUMNS TO REMAIN. PATCH, REPAIR AND PREPARE FOR NEW FINISH AS REQUIRED. DASHED LINES REPRESENT ITEMS TO _ _ ╨ _ _ ALL CONDUITS AND WIRES REMOVED SHALL BE TAKEN BACK TO SOURCE OF SUPPLY. REFER TO ENGINEER'S BE REMOVED & DISPOSED OF AS DRAWINGS. DIRECTED BY OWNER. GC TO VERIFY EXTENT OF DEMOLITION. CONTRACTOR TO PROTECT EXISTING MECHANICAL UNITS AND DUCTWORK TO REMAIN DURING EXTENT OF CONSTRUCTION. CONTINUOUS LINES DENOTE ITEMS GC TO REMOVE ALL EXISTING BLINDS IN THE AREAS OF DEMOLITION. PATCH AND REPAIR DRYWALL AS NEEDED. K. ____ TO REMAIN.


NOT IN SCOPE OF WORK.

______

	ARCHITECT 945 N. PENNSYLVAN WINTER PARK, FLOF OFFICE: (407) 629-11 FAX: (407) 388-1220 WWW. ADCINTERNA	RIDA 32789 88	LABORATIV	E
	STATE OF FLORIDA MARIA FERREIRA Architect • Seal/Signa	ture	AA-CC AR-95	01315 752
	Project Documents f	RANG OUNT O R I I LAGE WITTENST AND RENOVATION STREET	EIN COTT	ĀGE
N • SPACE PLANNING	ORLANDO, FL 320 Issue Date & Issue I 07.27.16 09.15.16 12.02.16		awn By Che JS JS JS	KA KA KA KA
	Client Information ORANGE COUNT 400 E SOUTH STREE ORLANDO, FL 32801		ECTS DIV	ISION
ARCHITECTURE	Project Number 15253 Drawn By JS Checked By KA File Name X:\dwgs\15253 OC Wi A01.01 DEMOLITION		12 Project \$ PERMIT / 3/1	BID SET <b>Scale</b> 5"= 1'-0"
	Consultant ● Seal/Si	gnature		
	Sheet Title:			


## **KEY PLAN**



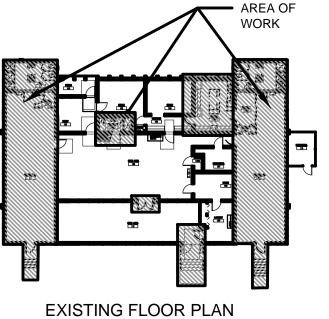

DEMOLITION PLAN



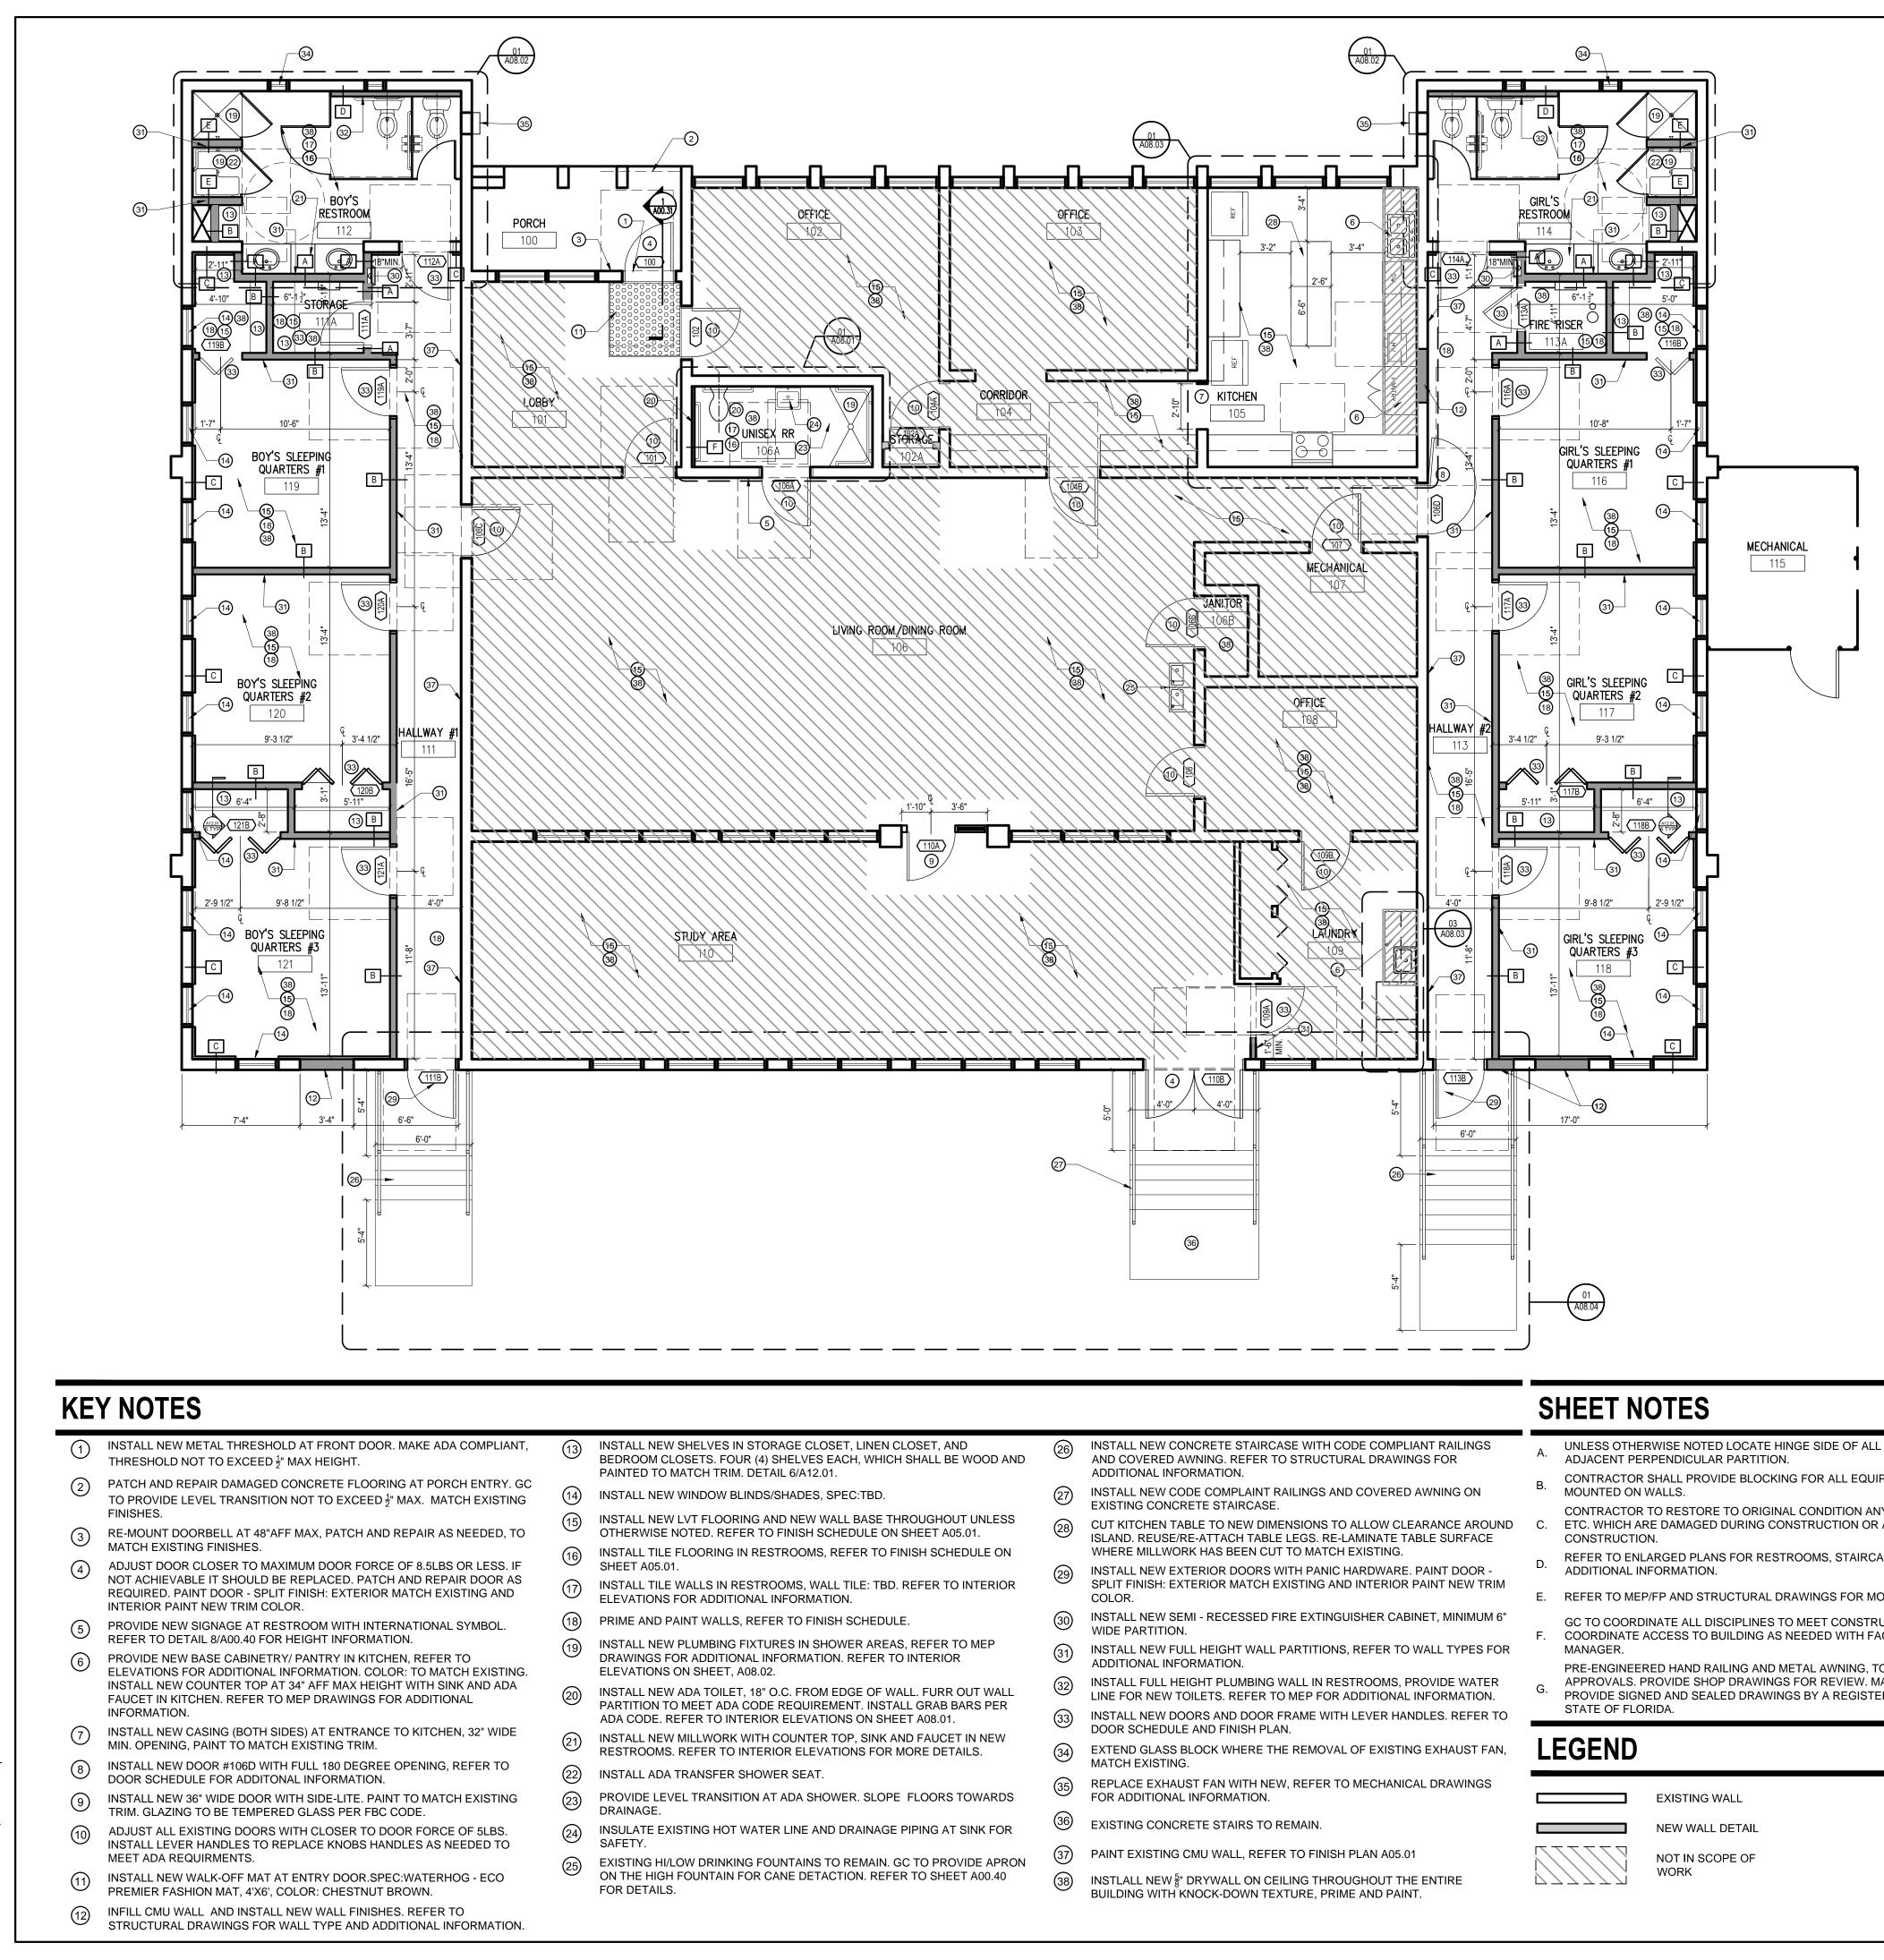

AND 3E WOOD AND	26	INSTALL NEW CONCRETE STAIRCASE WITH CODE COMPLIANT RAILINGS AND COVERED AWNING. REFER TO STRUCTURAL DRAWINGS FOR ADDITIONAL INFORMATION.
	27)	INSTALL NEW CODE COMPLAINT RAILINGS AND COVERED AWNING ON EXISTING CONCRETE STAIRCASE.
DUT UNLESS 05.01. HEDULE ON	28	CUT KITCHEN TABLE TO NEW DIMENSIONS TO ALLOW CLEARANCE AROUND ISLAND. REUSE/RE-ATTACH TABLE LEGS. RE-LAMINATE TABLE SURFACE WHERE MILLWORK HAS BEEN CUT TO MATCH EXISTING.
O INTERIOR	29	INSTALL NEW EXTERIOR DOORS WITH PANIC HARDWARE. PAINT DOOR - SPLIT FINISH: EXTERIOR MATCH EXISTING AND INTERIOR PAINT NEW TRIM COLOR.
	30	INSTALL NEW SEMI - RECESSED FIRE EXTINGUISHER CABINET, MINIMUM 6" WIDE PARTITION.
TO MEP DR	31	INSTALL NEW FULL HEIGHT WALL PARTITIONS, REFER TO WALL TYPES FOR ADDITIONAL INFORMATION.
R OUT WALL BARS PER	32	INSTALL FULL HEIGHT PLUMBING WALL IN RESTROOMS, PROVIDE WATER LINE FOR NEW TOILETS. REFER TO MEP FOR ADDITIONAL INFORMATION.
EARS PER 1. ET IN NEW	33	INSTALL NEW DOORS AND DOOR FRAME WITH LEVER HANDLES. REFER TO DOOR SCHEDULE AND FINISH PLAN.
TAILS.	34	EXTEND GLASS BLOCK WHERE THE REMOVAL OF EXISTING EXHAUST FAN, MATCH EXISTING.
S TOWARDS	35	REPLACE EXHAUST FAN WITH NEW, REFER TO MECHANICAL DRAWINGS FOR ADDITIONAL INFORMATION.
T SINK FOR	36	EXISTING CONCRETE STAIRS TO REMAIN.
OVIDE APRON	37	PAINT EXISTING CMU WALL, REFER TO FINISH PLAN A05.01
EET A00.40	(38)	INSTLALL NEW [§] " DRYWALL ON CEILING THROUGHOUT THE ENTIRE

- UNLESS OTHERWISE NOTED LOCATE HINGE SIDE OF ALL DOORS 6" FROM
- CONTRACTOR SHALL PROVIDE BLOCKING FOR ALL EQUIPMENT AND ACCESSORIES
- CONTRACTOR TO RESTORE TO ORIGINAL CONDITION ANY FLOOR, WALLS, CEILINGS, C. ETC. WHICH ARE DAMAGED DURING CONSTRUCTION OR AFFECTED BY NEW
- REFER TO ENLARGED PLANS FOR RESTROOMS, STAIRCASES AND KITCHEN FOR
- E. REFER TO MEP/FP AND STRUCTURAL DRAWINGS FOR MORE INFORMATION.
- GC TO COORDINATE ALL DISCIPLINES TO MEET CONSTRUCTION DEADLINES. F. COORDINATE ACCESS TO BUILDING AS NEEDED WITH FACILITIES AND BUILDING
- PRE-ENGINEERED HAND RAILING AND METAL AWNING, TO MEET FLORIDA PRODUCT APPROVALS. PROVIDE SHOP DRAWINGS FOR REVIEW. MANUFACTURER SHALL PROVIDE SIGNED AND SEALED DRAWINGS BY A REGISTERED ENGINEER IN THE

## **ADDITIVE BID ITEMS**

- CONTRACTOR TO PRICE OUT REPLACING ALL LIGHTING TO LED FIXTURES THROUGHOUT AS ADDITIVE BID ITEM.
- 2. CONTRACTOR TO PRICE PAINTING THROUGHOUT AS AN ADDITIVE BID ITEM.
- CONTRACTOR TO PRICE OUT REPLACING EXISTING COUNTER TOPS IN KITCHEN WITH SOLID SURFACE AS ADDITIVE BID ITEM. REFER TO SHEET A05.01 FOR FINISH SCHEDULE.




945 N. PENNSYLVANIA AVENUE WINTER PARK, FLORIDA 32789 OFFICE: (407) 629-1188 FAX: (407) 388-1220 WWW. ADCINTERNATIONAL.NET


Solution     Solution	MARI	E OF FLORIDA A FERREIRA tect • Seal/Sign			AA-C AR-9	
Project: GREAT OAKS VILLAGE WITTENSTEIN COTTAG ADA UPGRADES AND RENOVATIONS 1784 E. MICHIGAN STREET ORLANDO, FL 32806         Issue       Date & Issue Description       Drawn By       Checked         07.27.16       60% CD SET       JS       K         09.15.16       90% CD SET       JS       K         12.02.16       PERMIT/BID SET       JS       K         09.15.16       90% CD SET       JS       K         12.02.16       PERMIT/BID SET       JS       K         0010000000000000000000000000000000000	Proje	ct Documents	for:			
GREAT OAKS VILLAGE WITTENSTEIN COTTAG         ADA UPGRADES AND RENOVATIONS         1784 E. MICHIGAN STREET         ORLANDO, FL 32806         Issue Date & Issue Description       Drawn By         Checked         07.27.16       60% CD SET         09.15.16       90% CD SET         12.02.16       PERMIT/BID SET         J       12.02.16         PERMIT/BID SET       JS         K       12.02.16         PERMIT/BID SET       JS         K       SUBJUCTION         Client Information       SUBJUCTION         ORANGE COUNTY CAPITAL PROJECTS DIVISION         ORANGE COUNTY CAPITAL PROJECTS DIVISION         ORANGE COUNTY CAPITAL PROJECTS DIVISION         ORLANDO, FL 32801         Project Number       Issue Date         15253       12/02/20         JS       Project Statu         JS       Project Statu         JS       Project Statu         JKA       3/16*=1         File Name       X:\dwgs\15253 OC Wittenstein House ADA\CAD\SHEETS\AD2.01 CONSTRUCTION PLAN.dwg			RAN PAR OUN			
ADA UPGRADES AND RENOVATIONS 1784 E. MICHIGAN STREET ORLANDO, FL 32806 Issue Date & Issue Description Drawn By Checked 07.27.16 60% CD SET JS K 09.15.16 90% CD SET JS K 12.02.16 PERMIT/BID SET JS K 12.02.16 PERMIT/BID SET JS K Client Information ORANGE COUNTY CAPITAL PROJECTS DIVISION 400 E SOUTH STREET 5th FLOOR ORLANDO, FL 32801 Project Number Issue Date 15253 Project Statu JS Checked By Scall KA 3/16"= 1 File Name X:\dwgs\15253 OC Wittenstein House ADA\CAD\SHEETS\ A02.01 CONSTRUCTION PLAN.dwg	-		ILLAGE WITTE	INSTEI	N COT	TAG
07.27.16       60% CD SET       JS       K         09.15.16       90% CD SET       JS       K         12.02.16       PERMIT/BID SET       JS       K         12.02.16       PERMIT/BID SET       JS       K         0	ADA 1784	UPGRADES E. MICHIGA	S AND RENOV AN STREET			
09.15.16       90% CD SET       JS       K         12.02.16       PERMIT/BID SET       JS       K         10       Client Information       Image: Second	Issue			Drawn	-	
12.02.16     PERMIT/BID SET     JS     K       Image: Second state	,					
Client Information         ORANGE COUNTY CAPITAL PROJECTS DIVISIO         400 E SOUTH STREET 5th FLOOR         ORLANDO, FL 32801         Project Number       Issue Dat         15253       12/02/20         Drawn By       Project Statu         JS       Checked By         KA       3/16"= 1         File Name       X:\dwgs\15253 OC Wittenstein House ADA\CAD\SHEETS\         A02.01 CONSTRUCTION PLAN.dwg				SET		- K
Client Information         ORANGE COUNTY CAPITAL PROJECTS DIVISIO         400 E SOUTH STREET 5th FLOOR         ORLANDO, FL 32801         Project Number       Issue Dat         15253       12/02/20         Drawn By       Project Statu         JS       Checked By         KA       3/16"= 1         File Name       X:\dwgs\15253 OC Wittenstein House ADA\CAD\SHEETS\         A02.01 CONSTRUCTION PLAN.dwg	{ 					
Client Information         Client Information         ORANGE COUNTY CAPITAL PROJECTS DIVISIO         400 E SOUTH STREET 5th FLOOR         ORLANDO, FL 32801         Project Number         Issue Dat         15253         Drawn By         Project Statu         JS         Checked By         KA         3/16"= 1         File Name         X:\dwgs\15253 OC Wittenstein House ADA\CAD\SHEETS\         A02.01 CONSTRUCTION PLAN.dwg	L L 」 					
Client Information         Client Information         ORANGE COUNTY CAPITAL PROJECTS DIVISION         400 E SOUTH STREET 5th FLOOR         ORLANDO, FL 32801         Project Number         15253         Drawn By         JS         Checked By         KA         3/16"= 1         File Name         X:\dwgs\15253 OC Wittenstein House ADA\CAD\SHEETS\ A02.01 CONSTRUCTION PLAN.dwg						
Client Information         ORANGE COUNTY CAPITAL PROJECTS DIVISIO         400 E SOUTH STREET 5th FLOOR         ORLANDO, FL 32801         Project Number       Issue Dat         15253       12/02/20         Drawn By       Project Statu         JS       Checked By         KA       3/16"= 1         File Name       X:\dwgs\15253 OC Wittenstein House ADA\CAD\SHEETS\         A02.01 CONSTRUCTION PLAN.dwg	,					
Client Information         ORANGE COUNTY CAPITAL PROJECTS DIVISIO         400 E SOUTH STREET 5th FLOOR         ORLANDO, FL 32801         Project Number       Issue Dat         15253       12/02/20         Drawn By       Project Statu         JS       Checked By         KA       3/16"= 1         File Name       X:\dwgs\15253 OC Wittenstein House ADA\CAD\SHEETS\         A02.01 CONSTRUCTION PLAN.dwg	5					
Client Information         ORANGE COUNTY CAPITAL PROJECTS DIVISIO         400 E SOUTH STREET 5th FLOOR         ORLANDO, FL 32801         Project Number       Issue Dat         15253       12/02/20         Drawn By       Project Statu         JS       Checked By         KA       3/16"= 1         File Name       X:\dwgs\15253 OC Wittenstein House ADA\CAD\SHEETS\         A02.01 CONSTRUCTION PLAN.dwg						
Client Information         ORANGE COUNTY CAPITAL PROJECTS DIVISIO         400 E SOUTH STREET 5th FLOOR         ORLANDO, FL 32801         Project Number       Issue Dat         15253       12/02/20         Drawn By       Project Statu         JS       Checked By         KA       3/16"= 1         File Name       X:\dwgs\15253 OC Wittenstein House ADA\CAD\SHEETS\         A02.01 CONSTRUCTION PLAN.dwg						
Client Information         ORANGE COUNTY CAPITAL PROJECTS DIVISIO         400 E SOUTH STREET 5th FLOOR         ORLANDO, FL 32801         Project Number       Issue Dat         15253       12/02/20         Drawn By       Project Statu         JS       Checked By         KA       3/16"= 1         File Name       X:\dwgs\15253 OC Wittenstein House ADA\CAD\SHEETS\         A02.01 CONSTRUCTION PLAN.dwg						
ORANGE COUNTY CAPITAL PROJECTS DIVISION 400 E SOUTH STREET 5th FLOOR ORLANDO, FL 32801         Project Number       Issue Date 15253         15253       12/02/20         Drawn By       Project Statu         JS       Checked By         KA       3/16"= 1         File Name       X:\dwgs\15253 OC Wittenstein House ADA\CAD\SHEETS\         A02.01 CONSTRUCTION PLAN.dwg						
KA 3/16"= 1 <b>File Name</b> X:\dwgs\15253 OC Wittenstein House ADA\CAD\SHEETS\ A02.01 CONSTRUCTION PLAN.dwg	Client ORAN 400 E	NGE COUN ⁻ south stre	ET 5th FLOOR	ROJEC	TS DI\	/ISIC
KA 3/16"= 1 <b>File Name</b> X:\dwgs\15253 OC Wittenstein House ADA\CAD\SHEETS\ A02.01 CONSTRUCTION PLAN.dwg	ORLA ORLA Proje	NGE COUN ⁻ SOUTH STRE NDO, FL 3280 ect Number	ET 5th FLOOR		lssu 1	e Dat
X:\dwgs\15253 OC Wittenstein House ADA\CAD\SHEETS\ A02.01 CONSTRUCTION PLAN.dwg	D Client ORAI 400 E ORLA Proje	NGE COUN SOUTH STRE NDO, FL 3280 ect Number	ET 5th FLOOR		Issu 1 Project	ie Dat 2/02/20 Statu / BID S
X:\dwgs\15253 OC Wittenstein House ADA\CAD\SHEETS\ A02.01 CONSTRUCTION PLAN.dwg	Client ORAI 400 E ORLA Proje 15253 Draw JS Chec	NGE COUN SOUTH STRE NDO, FL 3280 ect Number	ET 5th FLOOR		Issu 1. Project PERMIT	le Dai 2/02/20 Statu / BID S Scal
	Client ORAI 400 E ORLA Proje 15253 Draw JS Chec	NGE COUN SOUTH STRE NDO, FL 3280 ect Number	ET 5th FLOOR		Issu 1. Project PERMIT	le Da 2/02/20 Statu / BID S Scal
Consultant • Seal/Signature	Client ORAI ORAI ORAI ORAI ORLA ORLA ORLA ORLA ORLA ORLA ORLA ORLA	NGE COUN SOUTH STRE NDO, FL 3280 ect Number n By ked By ked By	ET 5th FLOOR 1		Issu 1 Project PERMIT 3	e Dat 2/02/20 Statu / BID S Scal /16"= 1
	Client ORAI 400 E ORLA Proje 15253 Draw JS Chec KA File N X:\dwg	NGE COUN SOUTH STRE NDO, FL 3280 ect Number n By ked By ked By	ET 5th FLOOR 1		Issu 1 Project PERMIT 3	e Dat 2/02/20 Statu / BID S Scal /16"= 1
	Client     ORAI     ORAI     ORLA     ORLA	NGE COUN SOUTH STRE NDO, FL 3280 ect Number m By ked By ked By Name gs\15253 OC V 1 CONSTRUC	ET 5th FLOOR 1 Vittenstein House TION PLAN.dwg		Issu 1 Project PERMIT 3	e Dat 2/02/20 Statu / BID S Scal /16"= 1
	Client     ORAI     ORAI     ORLA     ORLA	NGE COUN SOUTH STRE NDO, FL 3280 ect Number m By ked By ked By Name gs\15253 OC V 1 CONSTRUC	ET 5th FLOOR 1 Vittenstein House TION PLAN.dwg		Issu 1 Project PERMIT 3	e Dat 2/02/20 Statu / BID S Scal /16"= 1
	Client     ORAI     ORAI     ORLA     ORLA	NGE COUN SOUTH STRE NDO, FL 3280 ect Number m By ked By ked By Name gs\15253 OC V 1 CONSTRUC	ET 5th FLOOR 1 Vittenstein House TION PLAN.dwg		Issu 1 Project PERMIT 3	e Da 2/02/20 Statu / BID S Scal /16"= 1
	Client     ORAI     ORAI     ORLA     ORLA	NGE COUN SOUTH STRE NDO, FL 3280 ect Number m By ked By ked By Name gs\15253 OC V 1 CONSTRUC	ET 5th FLOOR 1 Vittenstein House TION PLAN.dwg		Issu 1 Project PERMIT 3	e Da 2/02/20 Statu / BID S Scal /16"= 1
	Client     ORAI     ORAI     ORLA     ORLA	NGE COUN SOUTH STRE NDO, FL 3280 ect Number m By ked By ked By Name gs\15253 OC V 1 CONSTRUC	ET 5th FLOOR 1 Vittenstein House TION PLAN.dwg		Issu 1 Project PERMIT 3	e Dat 2/02/20 Statu / BID S Scal /16"= 1
	Client     ORAI     ORAI     ORLA     ORLA	NGE COUN SOUTH STRE NDO, FL 3280 ect Number m By ked By ked By Name gs\15253 OC V 1 CONSTRUC	ET 5th FLOOR 1 Vittenstein House TION PLAN.dwg		Issu 1 Project PERMIT 3	e Da 2/02/20 Statu / BID S Scal /16"= 1
	Client     ORAI     ORAI     ORLA     ORLA	NGE COUN SOUTH STRE NDO, FL 3280 ect Number m By ked By ked By Name gs\15253 OC V 1 CONSTRUC	ET 5th FLOOR 1 Vittenstein House TION PLAN.dwg		Issu 1 Project PERMIT 3	e Da 2/02/20 Statu / BID S Scal /16"= 1
	Client     ORAI     ORAI     ORAI     ORA     ORLA     ORLA	NGE COUN SOUTH STRE NDO, FL 3280 ect Number m By ked By ked By Name gs\15253 OC V 1 CONSTRUC	ET 5th FLOOR 1 Vittenstein House TION PLAN.dwg		Issu 1 Project PERMIT 3	e Dat 2/02/20 Statu / BID S Scal /16"= 1
	Client     ORAI     ORAI     ORLA     ORLA	NGE COUN SOUTH STRE NDO, FL 3280 ect Number m By ked By ked By Name gs\15253 OC V 1 CONSTRUC	ET 5th FLOOR 1 Vittenstein House TION PLAN.dwg		Issu 1 Project PERMIT 3	e Dat 2/02/20 Statu / BID S Scal /16"= 1
	Client ORAI 400 E ORLA Proje 15253 Draw JS Chec KA File N X:\dwg A02.0	NGE COUN SOUTH STRE NDO, FL 3280 ect Number m By ked By ked By Name gs\15253 OC V 1 CONSTRUC	ET 5th FLOOR 1 Vittenstein House TION PLAN.dwg		Issu 1 Project PERMIT 3	e Dat 2/02/20 Statu / BID S Scal /16"= 1
Shoot Title:	Client ORAN 400 E ORLA Proje 15253 Draw SCheck KA File N X:\dwn A02.0	NGE COUN SOUTH STRE NDO, FL 3280 ect Number n By ked By Name gs\15253 OC V 1 CONSTRUC ultant • Seal/S	ET 5th FLOOR 1 Vittenstein House TION PLAN.dwg		Issu 1 Project PERMIT 3	e Dat 2/02/20 Statu / BID S Scal /16"= 1
Sheet Title:	Client ORAN 400 E ORLA Proje 15253 Draw SCheck KA File N X:\dwn A02.0	NGE COUN SOUTH STRE NDO, FL 3280 ect Number n By ked By Name gs\15253 OC V 1 CONSTRUC ultant • Seal/S	ET 5th FLOOR 1 Vittenstein House TION PLAN.dwg		Issu 1 Project PERMIT 3	e Dat 2/02/20 Statu / BID S Scal /16"= 1
Sheet Title:	Client ORAI 400 E ORLA Proje 15253 Draw JS Chec KA File N X:\dwn A02.0	NGE COUN SOUTH STRE NDO, FL 3280 ect Number in By ked By Name gs\15253 OC V 1 CONSTRUC ultant • Seal/S	ET 5th FLOOR 1 Vittenstein House TION PLAN.dwg Signature	ADA\CAE	Issu Project PERMIT 3	e Dat 2/02/20 Statu / BID S Scal /16"= 1

A02.01

## **KEY PLAN**

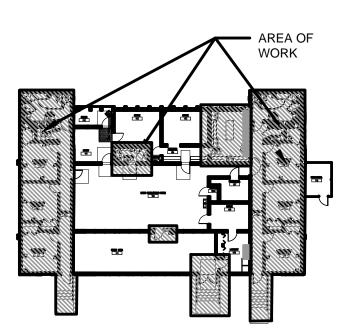

NEW FLOOR PLAN

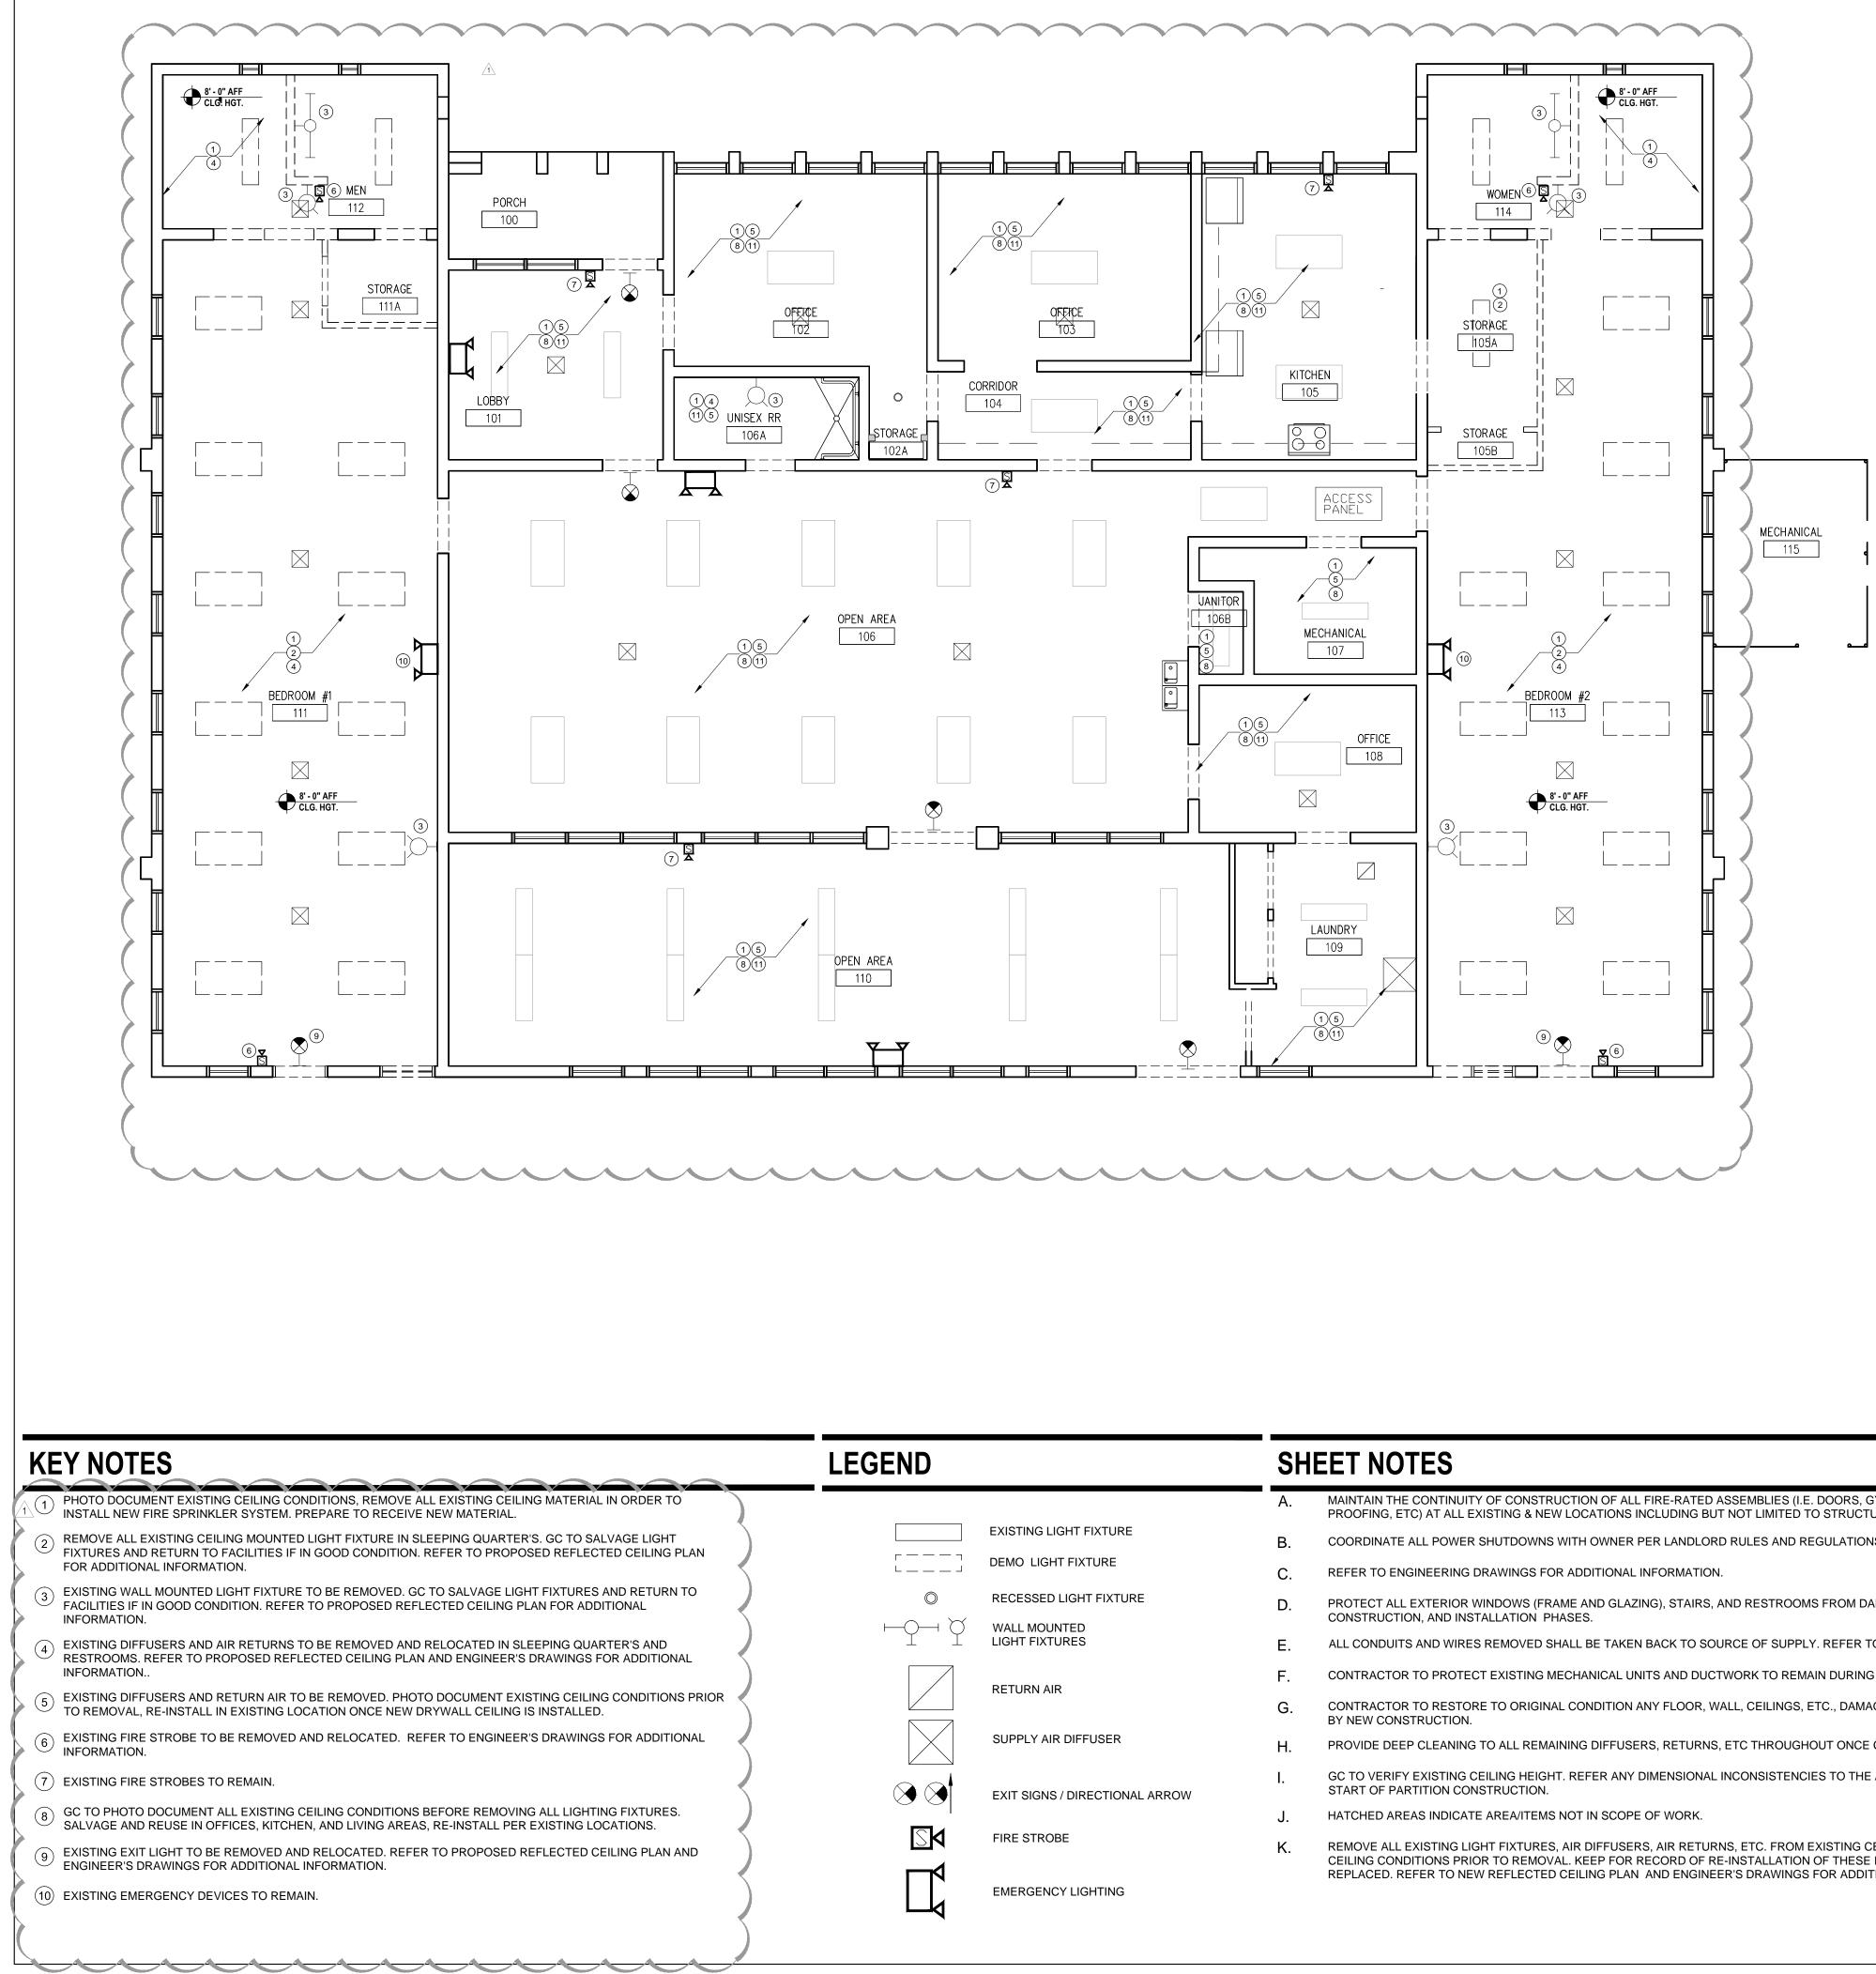


)		SHEET NOTES			
		Α.	MAINTAIN THE CONTINUITY OF CONSTRUCTION OF ALL FIRE-RATED ASSEMBLIES (I.E. DOORS, GYPSUM ENCLOSURES, SPRAYED F PROOFING, ETC) AT ALL EXISTING & NEW LOCATIONS INCLUDING BUT NOT LIMITED TO STRUCTURAL COLUMNS, BEAMS, AND FLO		
	EXISTING LIGHT FIXTURE	В.	COORDINATE ALL POWER SHUTDOWNS WITH OWNER PER LANDLORD RULES AND REGULATIONS.		
J	DEMO LIGHT FIXTURE	C.	REFER TO ENGINEERING DRAWINGS FOR ADDITIONAL INFORMATION.		
$\bigcirc$	RECESSED LIGHT FIXTURE	D.	PROTECT ALL EXTERIOR WINDOWS (FRAME AND GLAZING), STAIRS, AND RESTROOMS FROM DAMAGE DURING DEMOLITION, CONSTRUCTION, AND INSTALLATION PHASES.		
ΗŸ	WALL MOUNTED LIGHT FIXTURES	E.	ALL CONDUITS AND WIRES REMOVED SHALL BE TAKEN BACK TO SOURCE OF SUPPLY. REFER TO ENGINEER'S DRAWINGS.		
	RETURN AIR	F.	CONTRACTOR TO PROTECT EXISTING MECHANICAL UNITS AND DUCTWORK TO REMAIN DURING EXTENT OF CONSTRUCTION.		
		G.	CONTRACTOR TO RESTORE TO ORIGINAL CONDITION ANY FLOOR, WALL, CEILINGS, ETC., DAMAGED DURING CONSTRUCTION OR BY NEW CONSTRUCTION.		
$\times$	SUPPLY AIR DIFFUSER	Н.	PROVIDE DEEP CLEANING TO ALL REMAINING DIFFUSERS, RETURNS, ETC THROUGHOUT ONCE CONSTRUCTION IS COMPLETED.		
	EXIT SIGNS / DIRECTIONAL ARROW	Ι.	GC TO VERIFY EXISTING CEILING HEIGHT. REFER ANY DIMENSIONAL INCONSISTENCIES TO THE ARCHITECT FOR RESOLUTION PR START OF PARTITION CONSTRUCTION.		
		J.	HATCHED AREAS INDICATE AREA/ITEMS NOT IN SCOPE OF WORK.		
	FIRE STROBE	K.	REMOVE ALL EXISTING LIGHT FIXTURES, AIR DIFFUSERS, AIR RETURNS, ETC. FROM EXISTING CEILING. GC TO PHOTO DOCUMENT CEILING CONDITIONS PRIOR TO REMOVAL. KEEP FOR RECORD OF RE-INSTALLATION OF THESE ITEMS ONCE NEW DRYWALL CEILI		
	EMERGENCY LIGHTING		REPLACED. REFER TO NEW REFLECTED CEILING PLAN AND ENGINEER'S DRAWINGS FOR ADDITIONAL INFORMATION.		

## ADDITIVE BID ITEMS


CONTRACTOR TO PRICE OUT REPLACING ALL LIGHTING T THROUGHOUT AS ADDITIVE BID ITEM.

TO LED FIXTURES	ARCHITECTURAL DESIGN	
	945 N. PENNSYLVANIA AVENUE WINTER PARK, FLORIDA 32789	
	OFFICE: (407) 629-1188 FAX: (407) 388-1220 WWW. ADCINTERNATIONAL.NET	
	STATE OF FLORIDA	AA-C001315
	MARIA FERREIRA Architect • Seal/Signature	AR-95752
	Project Documents for:	
	ORLANDO, FL 32806	
	Issue         Date & Issue Description           07.27.16         60% CD SET           09.15.16         90% CD SET	
	O9.15.16         90% CD SET           12.02.16         PERMIT/BID           1         12/23/2016         GC / Client Coor.	SET JS KA
	INTERIOR DESIGN	
	Sclient Information NORANGE COUNTY CAPITAL F A00 E SOUTH STREET 5th FLOOR ORLANDO, FL 32801	PROJECTS DIVISION
	Project Number	<b>Issue Date</b> 12/02/2016
	LD 15253 Drawn By JS Checked By	Project Status PERMIT / BID SET Scale
	KA	3/16"= 1'-0"
	File Name X:\dwgs\15253 OC Wittenstein House A04.01A DEMO REFLECTED CEILIN	
	Consultant ● Seal/Signature	
- AREA OF WORK		
	Sheet Title:	
	DEMO REFLECTED	CEILING PLAN
Ň	A04.0	<b>1A</b>

## **KEY PLAN**

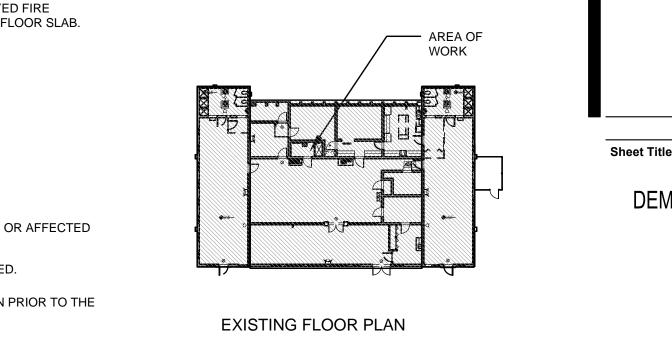

ENT EXISTING CEILING IS

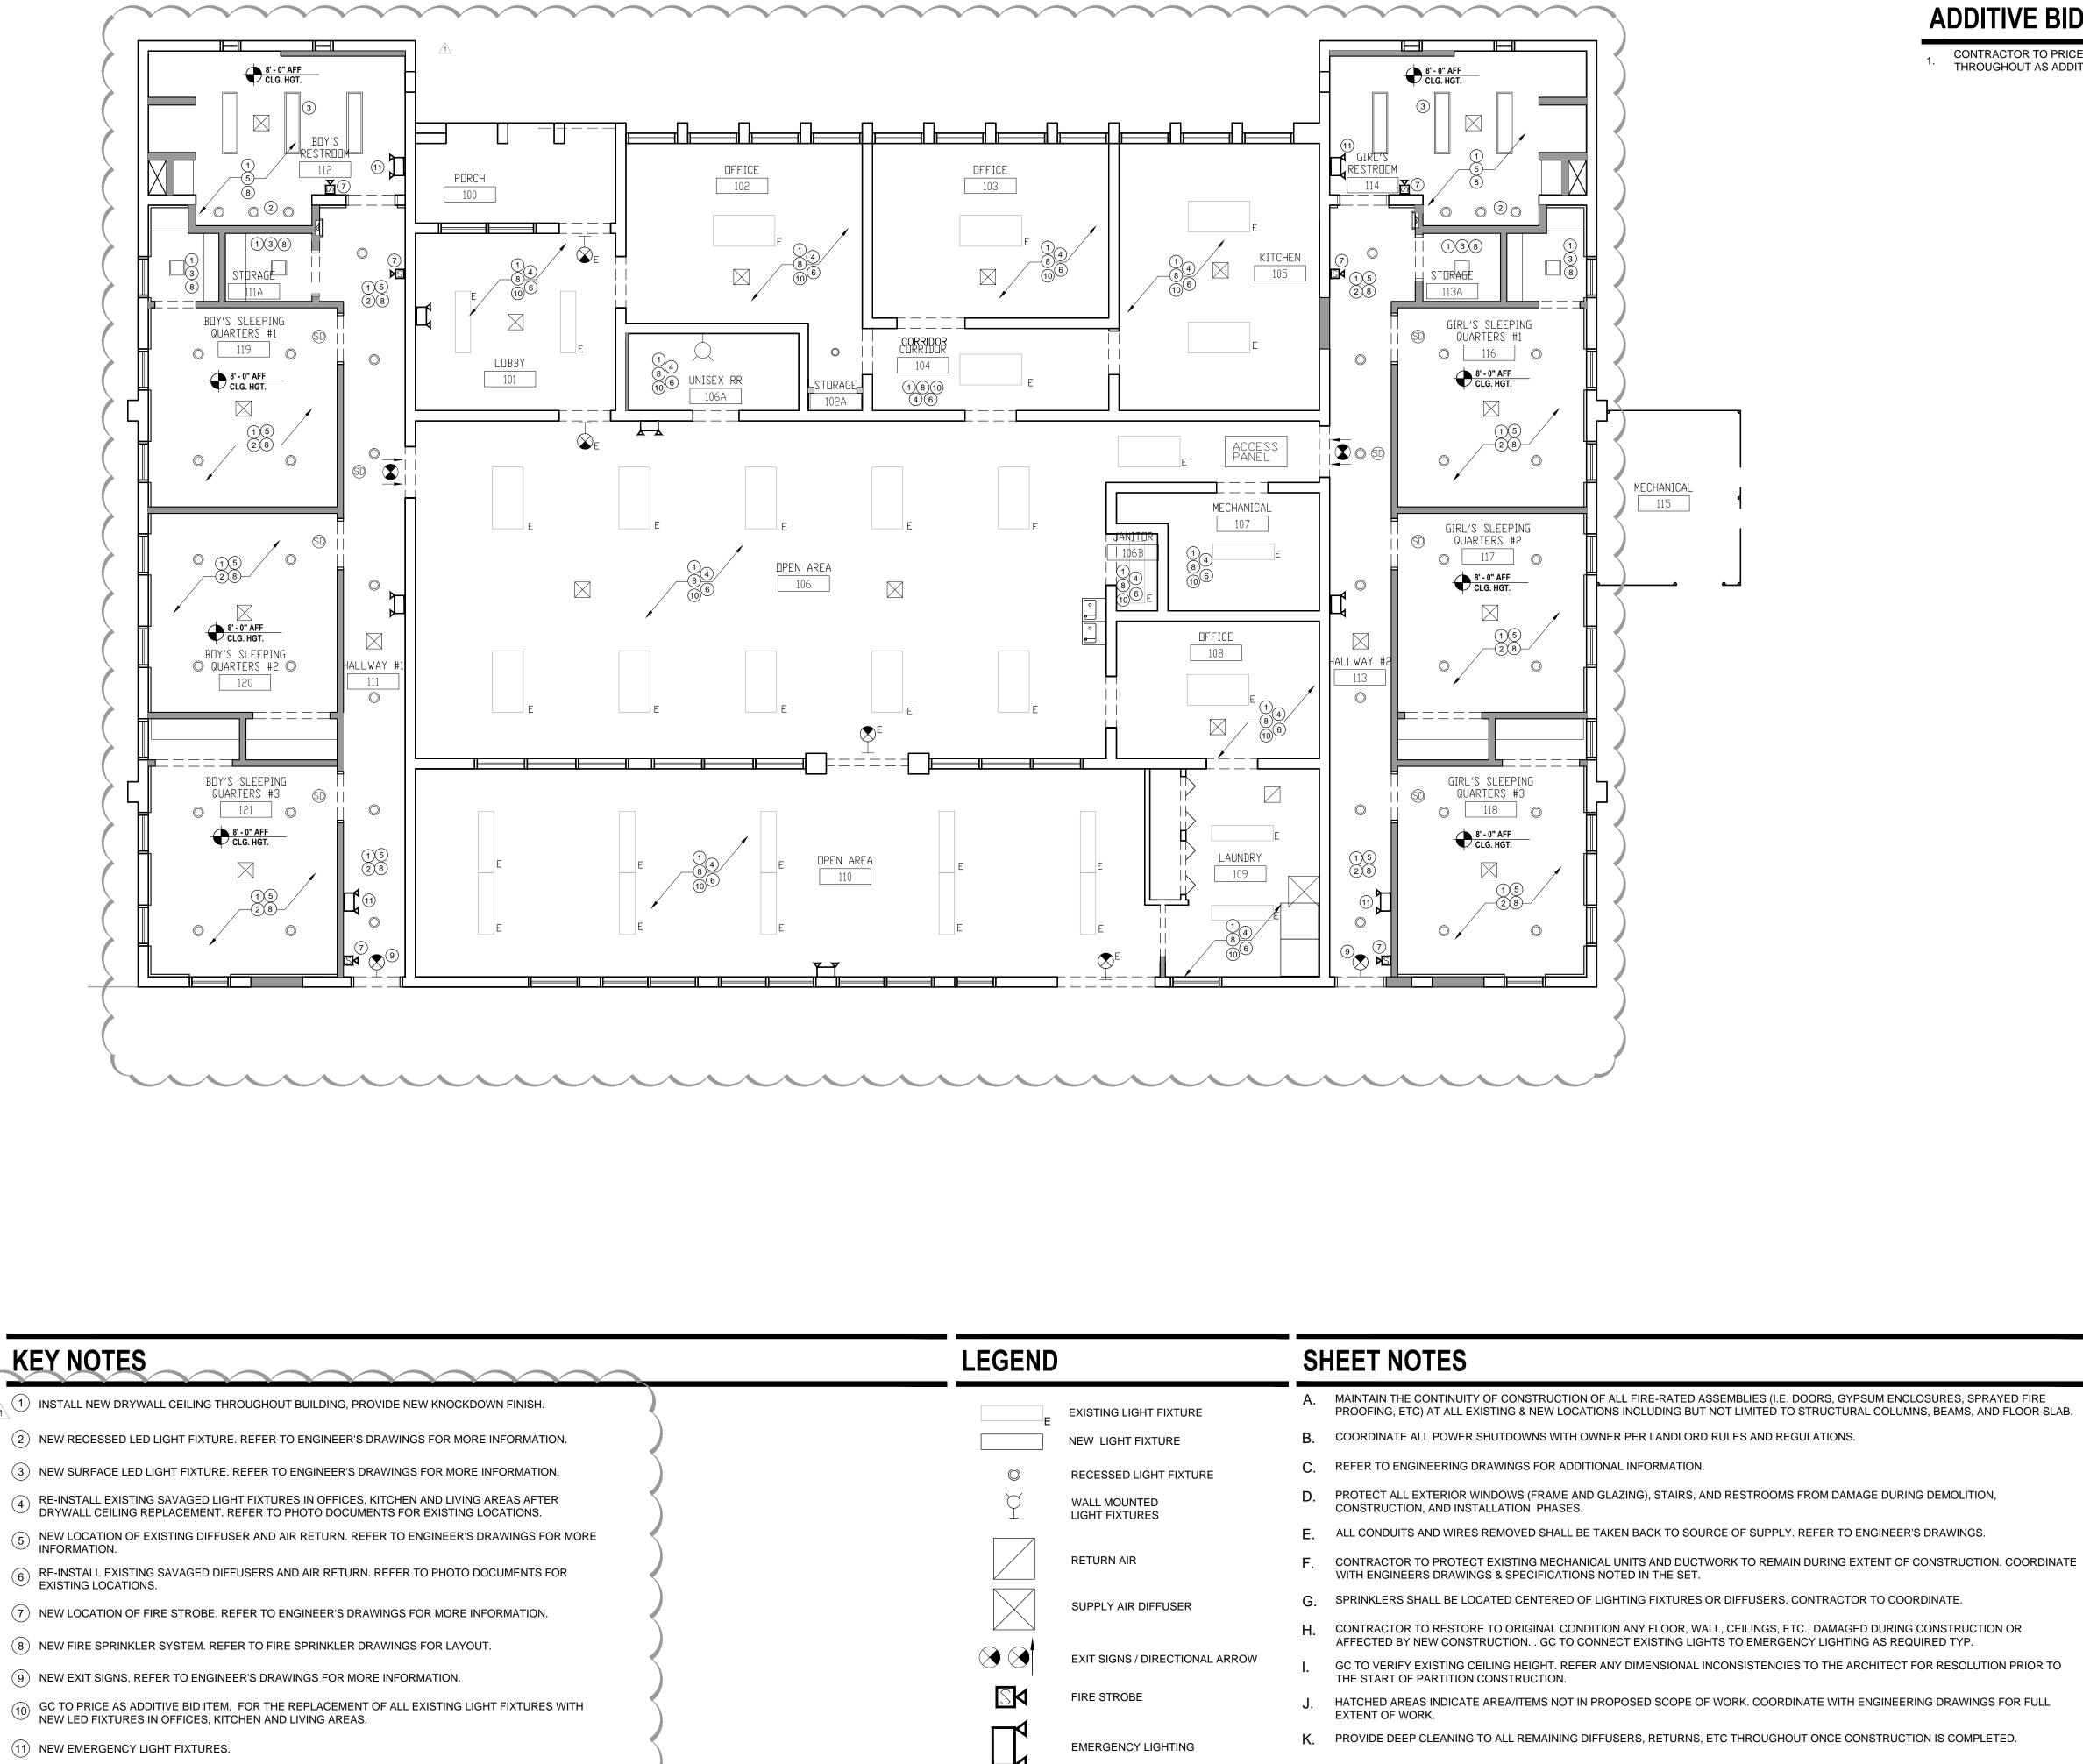

 $\overline{}$ 

E	EXISTING LIGHT F
	NEW LIGHT FIXTU
$\bigcirc$	RECESSED LIGHT
Å	WALL MOUNTED LIGHT FIXTURES
	RETURN AIR
	SUPPLY AIR DIFF
$\mathbf{\mathfrak{S}}$	EXIT SIGNS / DIRE
	FIRE STROBE
	EMERGENCY LIGH
SD	SMOKE DETECTO

SMOKE DETECTOR


- PROOFING, ETC) AT ALL EXISTING & NEW LOCATIONS INCLUDING BUT NOT LIMITED TO STRUCTURAL COLUMNS, BEAMS, AND FLOOR SLAB.
- D. PROTECT ALL EXTERIOR WINDOWS (FRAME AND GLAZING), STAIRS, AND RESTROOMS FROM DAMAGE DURING DEMOLITION,
- E. ALL CONDUITS AND WIRES REMOVED SHALL BE TAKEN BACK TO SOURCE OF SUPPLY. REFER TO ENGINEER'S DRAWINGS.
- H. CONTRACTOR TO RESTORE TO ORIGINAL CONDITION ANY FLOOR, WALL, CEILINGS, ETC., DAMAGED DURING CONSTRUCTION OR AFFECTED BY NEW CONSTRUCTION. . GC TO CONNECT EXISTING LIGHTS TO EMERGENCY LIGHTING AS REQUIRED TYP.
- J. HATCHED AREAS INDICATE AREA/ITEMS NOT IN PROPOSED SCOPE OF WORK. COORDINATE WITH ENGINEERING DRAWINGS FOR FULL

## **ADDITIVE BID ITEMS**

CONTRACTOR TO PRICE OUT REPLACING ALL LIGHTING TO LED FIXTURES THROUGHOUT AS ADDITIVE BID ITEMS.

ARCHITECTURAL DESIGN C	OLLABORATIVE
945 N. PENNSYLVANIA AVENUE WINTER PARK, FLORIDA 32789 OFFICE: (407) 629-1188 FAX: (407) 388-1220 WWW. ADCINTERNATIONAL.NET	
STATE OF FLORIDA MARIA FERREIRA Architect • Seal/Signature	AA-C001315 AR-95752
Project Documents for:	E
COUN	Y
F L O R I Project: GREAT OAKS VILLAGE WITTEN ADA UPGRADES AND RENOVA	
1784 E. MICHIGAN STREET ORLANDO, FL 32806 Issue Date & Issue Description	Drawn By Checked By
OT.27.16         60% CD SET           09.15.16         90% CD SET           12.02.16         PERMIT/BID SE           12/23/2016         GC / CLIENT COORI	JS KA JS KA T JS KA
SPACE	
•	
•	
INTERIOR DESIGN	
•	OJECTS DIVISION
NOISED NOIS	<b>Issue Date</b> 12/02/2016
NOISED NOIS	Issue Date
<ul> <li>NOISED NOISED NOI</li></ul>	Issue Date 12/02/2016 Project Status PERMIT / BID SET Scale 3/16"= 1'-0"
<ul> <li>NOT Client Information</li> <li>Client Information</li> <li>ORANGE COUNTY CAPITAL PRO 400 E SOUTH STREET 5th FLOOR ORLANDO, FL 32801</li> <li>Project Number 15253 Drawn By JS Checked By KA</li> <li>File Name</li> </ul>	Issue Date 12/02/2016 Project Status PERMIT / BID SET Scale 3/16"= 1'-0"
<ul> <li>District of the second state of t</li></ul>	Issue Date 12/02/2016 Project Status PERMIT / BID SET Scale 3/16"= 1'-0"
<ul> <li>District of the second state of t</li></ul>	Issue Date 12/02/2016 Project Status PERMIT / BID SET Scale 3/16"= 1'-0"
<ul> <li>District of the second state of t</li></ul>	Issue Date 12/02/2016 Project Status PERMIT / BID SET Scale 3/16"= 1'-0"
<ul> <li>District of the second state of t</li></ul>	Issue Date 12/02/2016 Project Status PERMIT / BID SET Scale 3/16"= 1'-0"
<ul> <li>District of the second state of t</li></ul>	Issue Date 12/02/2016 Project Status PERMIT / BID SET Scale 3/16"= 1'-0"

## **KEY PLAN**

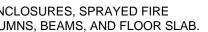




AREA OF WORK

PROPOSED FLOOR PLAN



## A04.01B

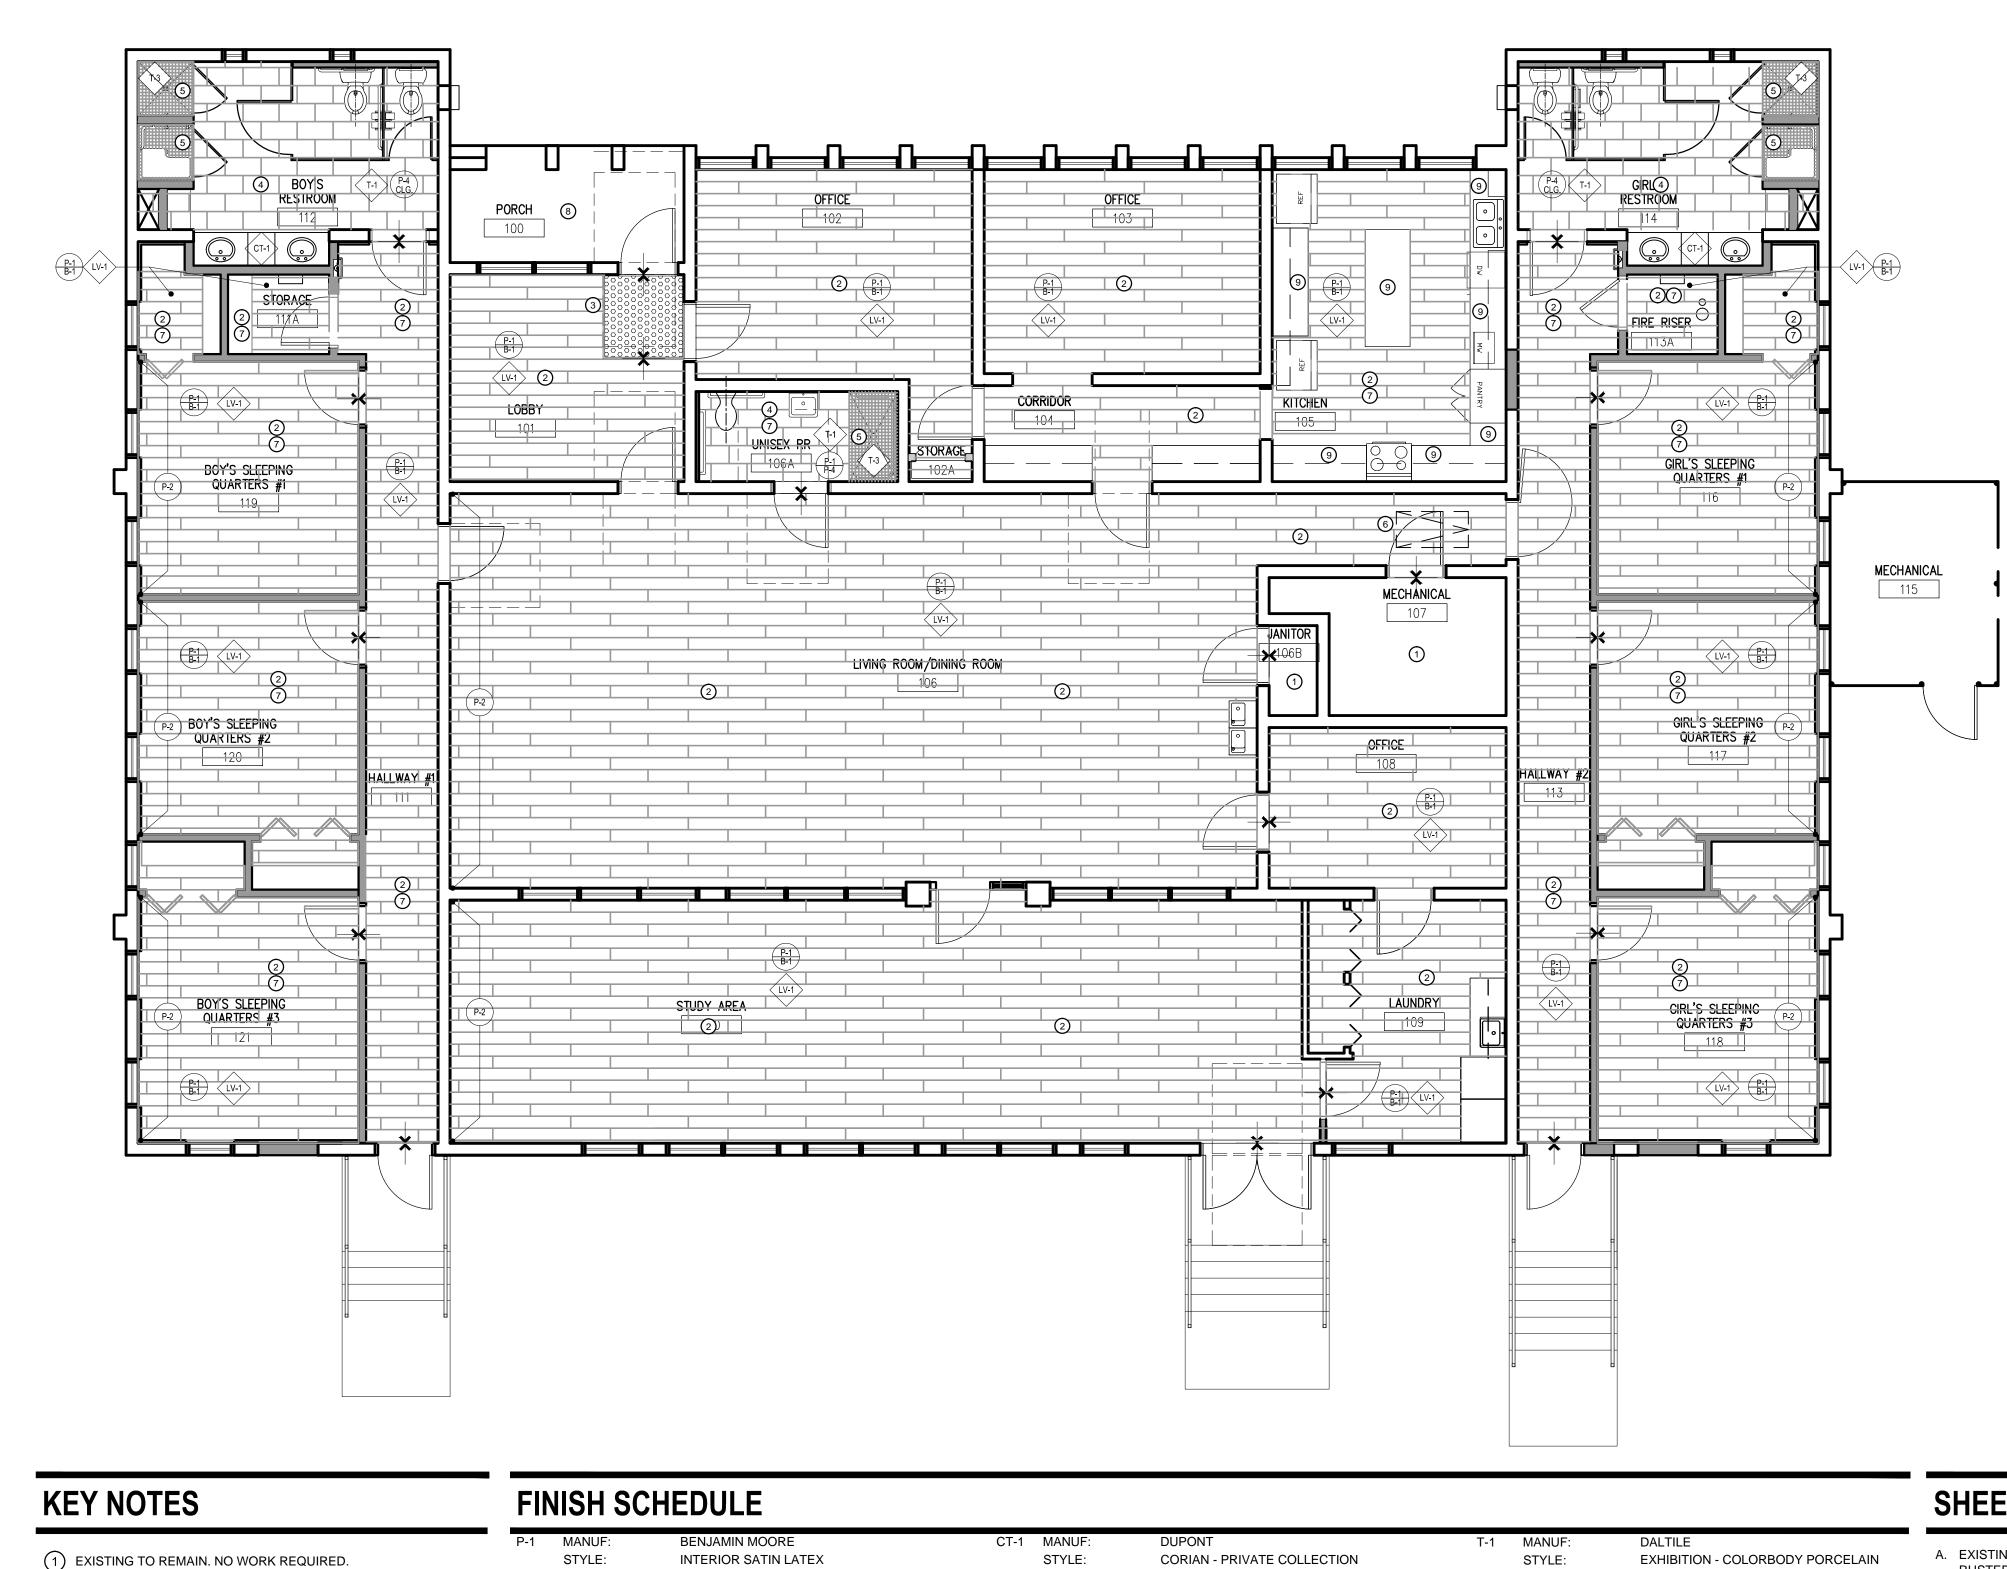

- 2 INSTALL NEW LVT FLOORING THROUGHOUT UNLESS OTHERWISE INDICATED. INSTALL NEW WALL BASE THROUGHOUT SPACE.
- (3) INSTALL WALK-OFF MAT AT ENTRY.
- (4) INSTALL NEW TILE FLOORING, REFER TO INTERIOR ELEVATIONS P-2 FOR WALL TILE INFORMATION.
- 5 INSTALL SHOWER FLOORING, SLOPE TOWARDS DRAIN. REFER TO INTERIOR ELEVATIONS FOR WALL TILE DESIGN.
- 6 PAINT EXISTING ATTIC ACCESS DOOR AND FRAME TO MATCH CEILING COLOR. PRIME AND PAINT WALLS AS INDICATED. GC TO PRICE OUT ALTERNATE COST TO PAINT ENTIRE INTERIOR SPACES
- THROUGHOUT BUILDING.
- 8 PAINT EXTERIOR CONCRETE FLOORING AT FRONT ENTRY, MATCH EXISTING.
- (9) GC TO PRICE AS ADDITIVE BID ITEM FOR THE REPLACEMENT OF LAMINATE COUNTER TOPS TO SOLID SURFACE AND UNDERMOUNT SINK. REFER TO SPEC: CT-2.

P-1	MANUF:	BENJAMIN MOORE
F-1	STYLE:	INTERIOR SATIN LATEX
	COLOR:	WHEELING NEUTRAL, HC-92
	AREA:	GENERAL WALL PAINT
	FINISH:	SATIN FINISH
	NOTES:	GC MAY PROVIDE APPROVED EQUAL
	NOTES.	UNDER SUBSTITUTION REQUEST.
	FLAME SPREAD R	ATING CLASS A
P-2	MANUF:	BENJAMIN MOORE
	STYLE:	INTERIOR SATIN LATEX
	COLOR:	VAN COURTLAND BLUE, HC-145
	AREA:	ACCENT WALL PAINT
	FINISH:	SATIN FINISH
	NOTES:	GC MAY PROVIDE APPROVED EQUAL
	FLAME SPREAD R	UNDER SUBSTITUTION REQUEST. ATING CLASS A
P-3	MANUF:	BENJAMIN MOORE
	STYLE:	INTERIOR SATIN LATEX
	COLOR:	KINGSPORT GRAY, HC-86
	AREA:	BASEBOARD, TRIM PAINT, AND EXISTING
	FINISH:	DOORS. SEMI-GLOSS FINISH
	NOTES:	GC MAY PROVIDE APPROVED EQUAL
		UNDER SUBSTITUTION REQUEST.
	FLAME SPREAD R	ATING CLASS A
P-4	MANUF:	BENJAMIN MOORE
	STYLE:	INTERIOR SATIN LATEX
	COLOR:	SIMPLY WHITE, HC-117
	AREA:	GENERAL CEILING PAINT, WINDOW TRIM
	FINISH:	AND WOODEN SHELVES EGGSHELL FINISH

CT-1	MANUF:	DUPONT	T-1	MANUF:	DALTILE		
	STYLE:	CORIAN - PRIVATE COLLECTION		STYLE:	EXHIBITION - COLORBODY PORCELAIN 12X24"	А.	EXISTING DOORS TO RUSTED OR DAMAGE
	COLOR:	WITCH HAZEL		COLOR:	ECRU - EX12, TEXTURED		HANDLES WITH LEVE
	AREA:	RESTROOM COUNTER TOPS		AREA:	RESTROOM TILE FLOORING		BUILDING.
	INSTALLATION:	INTEGRATED SINK BOWL, GLACIER ICE		INSTALLATION:	BRICK PATTERN, ¹ / ₈ GROUT	В.	PROTECT ALL WINDO
	NOTES:	GC MAY PROVIDE APPROVED EQUAL		NOTES:	GC MAY PROVIDE APPROVED EQUAL		PATCH AND REPAIR I
		UNDER SUBSTITUTION REQUEST.		110120	UNDER SUBSTITUTION REQUEST.	C.	GC TO CLEAN, REPA
CT-2	MANUF:	DUPONT	T-2	MANUF:	DALTILE		NEEDED. REPLACE A EXISTING.
	STYLE:	CORIAN	1-2	STYLE:	FORMULA - COLORBODY PORCELAIN		
	COLOR:	LINEN		STILE.	12X24"	D.	PATCH AND REPAIR A
	AREA:	KITCHEN COUNTER & 4" BACKSPLASH		COLOR:	THEOREM IVORY - FM93, POLISHED		TO NEW PAINT ON TH
	NOTES:	ITEM TO BE PRICED AS AN ALTERNATE.		AREA:	RESTROOM WALL TILE	F	REPAIR AND/OR REP
				INSTALLATION:	STRAIGHT, 1/16" GROUT	L.	AS NECESSARY TO N
PL-1	MANUF: STYLE:	NEVAMAR PREMIUM LAMINATE		NOTES:	GC MAY PROVIDE APPROVED EQUAL UNDER SUBSTITUTION REQUEST.	F.	PATCH AND REPAIR
	COLOR:		T-3				CONSTRUCTION AS F
		TENDU, WZ2007 -PV		MANUF: DALTILE	DALTILE		REFER TO NEW PAIN
	AREA:			STYLE:	KEYSTONE BLEND -1X1"	G.	PLACE ANY NEW MA
	NOTES:	GC MAY PROVIDE APPROVED EQUAL UNDER SUBSTITUTION REQUEST.		COLOR:	DK04 BEACH BLEND		INSTALLATION TO AL ENVIRONMENT.
				AREA:	RESTROOM SHOWER FLOORING		
B-1	MANUF:			INSTALLATION:	STRAIGHT	Н.	REFER TO INTERIOR
	STYLE:	INFLECTION, MW-XX-G		INSTALLATION.	STRAIGHT	I	REFER TO DOOR SCI
	COLOR:	80 FAWN	SP-1	MANUF:	ASI GLOBAL PARTITIONS		COLORS.
	AREA:	5.25" GENERAL WALL BASE		STYLE:	SOLID PLASTIC (HDPE)		
LV-1	MANUF:	PATCRAFT		COLOR:	IVORY ESSENCE SPECKLE - 9500		
	STYLE:	1600V - 7X48" PLANKS		AREA:	RESTROOM SHOWER DOORS AND		
	COLOR:	00796 RUM		TOILET PARTITIONS			
	AREA:	MAIN FLOORING THOUGHOUT		INSTALLATION:	REFER TO ELEVATIONS		
	NOTES:	GC MAY PROVIDE APPROVED EQUAL		NOTES:	GC MAY PROVIDE APPROVED EQUAL UNDER SUBSTITUTION REQUEST.		
		UNDER SUBSTITUTION REQUEST.					


## SHEET NOTES

- AIR EXISTING FRAMES AS NEEDED.
- AIR ANY EXISTING DAMAGED DRYWALL ILDING. PAINT TO MATCH EXISTING OR REFER THE FINISH SCHEDULE.
- EPLACE ANY DAMAGED FLOORING/CARPETING O MATCH EXISTING.
- AIR ANY CEILING DAMAGE DURING AS REQUIRED. PAINT TO MATCH EXISTING OR AINT ON THE FINISH SCHEDULE.
- MATERIALS IN SPACE AT LEAST 3 DAYS BEFORE ALLOW THE NEW MATERIAL TO ACCLIMATE TO
- OR ELEVATIONS FOR ADDITIONAL INFORMATION.

Λ		
ARCHIT	FECTURAL DESIGN CO	LLABORATIVE
	VANIA AVENUE	
OFFICE: (407) 62		
FAX: (407) 388-1 WWW. ADCINTE	220 ERNATIONAL.NET	
STATE OF FLOR		AA-C0013
MARIA FERREIR Architect • Seal/S		AR-95752
Project Docume	nts for:	
(	RANC	E
F		
	DES AND RENOVAT IGAN STREET 32806	IONS
Issue         Date & Is           07.27.16		Drawn By Checked JS K
09.15.16	6 90% CD SET	JS K
12.02.16	6 PERMIT/BID SET	JS K
Client Information	ΙΝΤΥ ΓΔΡΙΤΔΙ ΦΟΟ	
400 E SOUTH ST	JNTY CAPITAL PRC REET 5th FLOOR 2801	JECTS DIVISIO
Client Information ORANGE COU 400 E SOUTH ST ORLANDO, FL 32	REET 5th FLOOR	JECTS DIVISIO
400 E SOUTH ST DRLANDO, FL 32 Project Number	REET 5th FLOOR 2801	Issue Da
400 E SOUTH ST ORLANDO, FL 32	REET 5th FLOOR 2801	<b>Issue Da</b> 12/02/20
400 E SOUTH ST DRLANDO, FL 32 Project Number 15253 Drawn By JS	REET 5th FLOOR 2801	Issue Da 12/02/20 <b>Project Statu</b> PERMIT / BID S
400 E SOUTH ST DRLANDO, FL 32 Project Number 15253 Drawn By	REET 5th FLOOR 2801	Issue Da 12/02/20 <b>Project Statu</b> PERMIT / BID S <b>Sca</b>
400 E SOUTH ST DRLANDO, FL 32 Project Number 15253 Drawn By JS Checked By	REET 5th FLOOR 2801	Issue Da 12/02/20 <b>Project Statu</b> PERMIT / BID S <b>Sca</b> l
400 E SOUTH ST DRLANDO, FL 32 Project Number 15253 Drawn By JS Checked By KA File Name X:\dwgs\15253 O	C Wittenstein House AD	Issue Da 12/02/20 <b>Project Statu</b> PERMIT / BID S <b>Sca</b> 3/16"= 1
100 E SOUTH ST DRLANDO, FL 32 Project Number 15253 Drawn By JS Checked By KA File Name X:\dwgs\15253 O	REET 5th FLOOR 2801	Issue Da 12/02/20 <b>Project Statu</b> PERMIT / BID S <b>Sca</b> 3/16"= 1
400 E SOUTH ST DRLANDO, FL 32 Project Number 15253 Drawn By JS Checked By KA File Name X:\dwgs\15253 O A05.01 FINISH F	REET 5th FLOOR 2801	Issue Dat 12/02/20 <b>Project Statu</b> PERMIT / BID S <b>Sca</b> l 3/16"= 1
400 E SOUTH ST DRLANDO, FL 32 Project Number 15253 Drawn By JS Checked By KA File Name X:\dwgs\15253 O	REET 5th FLOOR 2801	Issue D: 12/02/; Project Stat PERMIT / BID Sca 3/16"=
400 E SOUTH ST DRLANDO, FL 32 Project Number 15253 Drawn By JS Checked By KA File Name X:\dwgs\15253 O A05.01 FINISH F	REET 5th FLOOR 2801	Issue Da 12/02/2 Project State PERMIT / BID 3 Sca 3/16"=
400 E SOUTH ST DRLANDO, FL 32 Project Number 15253 Drawn By JS Checked By KA File Name X:\dwgs\15253 O A05.01 FINISH F	REET 5th FLOOR 2801	Issue Da 12/02/20 Project Statu PERMIT / BID S Sca 3/16"= 1
400 E SOUTH ST DRLANDO, FL 32 Project Number 15253 Drawn By JS Checked By KA File Name X:\dwgs\15253 O A05.01 FINISH F	REET 5th FLOOR 2801	Issue Da 12/02/20 Project Statu PERMIT / BID S Sca 3/16"= 1
400 E SOUTH ST DRLANDO, FL 32 Project Number 15253 Drawn By JS Checked By KA File Name X:\dwgs\15253 O A05.01 FINISH F	REET 5th FLOOR 2801	Issue Da 12/02/20 Project Statu PERMIT / BID S Sca 3/16"= 1
400 E SOUTH ST DRLANDO, FL 32 Project Number 15253 Drawn By JS Checked By KA File Name X:\dwgs\15253 O A05.01 FINISH F	REET 5th FLOOR 2801	Issue Da 12/02/20 Project Statu PERMIT / BID S Sca 3/16"= 1
400 E SOUTH ST DRLANDO, FL 32 Project Number 15253 Drawn By JS Checked By KA File Name X:\dwgs\15253 O A05.01 FINISH F	REET 5th FLOOR 2801	Issue Da 12/02/20 <b>Project Statu</b> PERMIT / BID S <b>Sca</b> 3/16"= 4
ioo E SOUTH ST DRLANDO, FL 32 Project Number 15253 Drawn By JS Checked By КА File Name X:\dwgs\15253 O A05.01 FINISH F	REET 5th FLOOR 2801	Issue Da 12/02/20 Project Statu PERMIT / BID S Sca 3/16"= 1
IOO E SOUTH ST DRLANDO, FL 32 Project Number 15253 Drawn By JS Checked By KA File Name X:\dwgs\15253 O A05.01 FINISH F	REET 5th FLOOR 2801	Issue Da 12/02/20 <b>Project Statu</b> PERMIT / BID S <b>Sca</b> 3/16"= 1
400 E SOUTH ST DRLANDO, FL 32 Project Number 15253 Drawn By JS Checked By KA File Name X:\dwgs\15253 O A05.01 FINISH F Consultant • Se	REET 5th FLOOR 2801	Issue Da 12/02/2 Project Statu PERMIT / BID S Sca 3/16"= ~ A\CAD\SHEETS\

- S TO REMAIN, REPAIR AND/OR REPLACE ANY AGED HINGES AS NEEDED. REPLACE ALL KNOB EVEL HANDLES ON ALL DOORS THROUGHOUT
- NDOWS AND FRAMES DURING CONSTRUCTION.
- PAIR AND PAINT EXISTING WINDOW FRAMES AS E ANY DAMAGED WINDOW SILLS, MATCH

SCHEDULE FOR DOOR AND FRAME FINISH

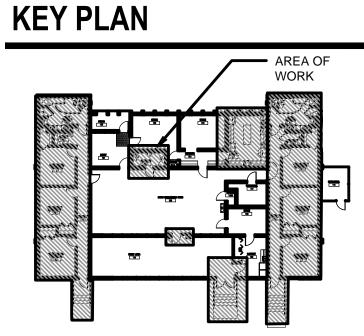


NEW FLOOR PLAN

## **KEY PLAN**

- WALL FINISH - EXTENT OF FINISH XXXX WALL FINISH XXXX SPECIAL FINISH XXXXX
- FLOOR FINISH  $\rightarrow$ 
  - CHANGE IN FLOOR FINISH


# A05.01

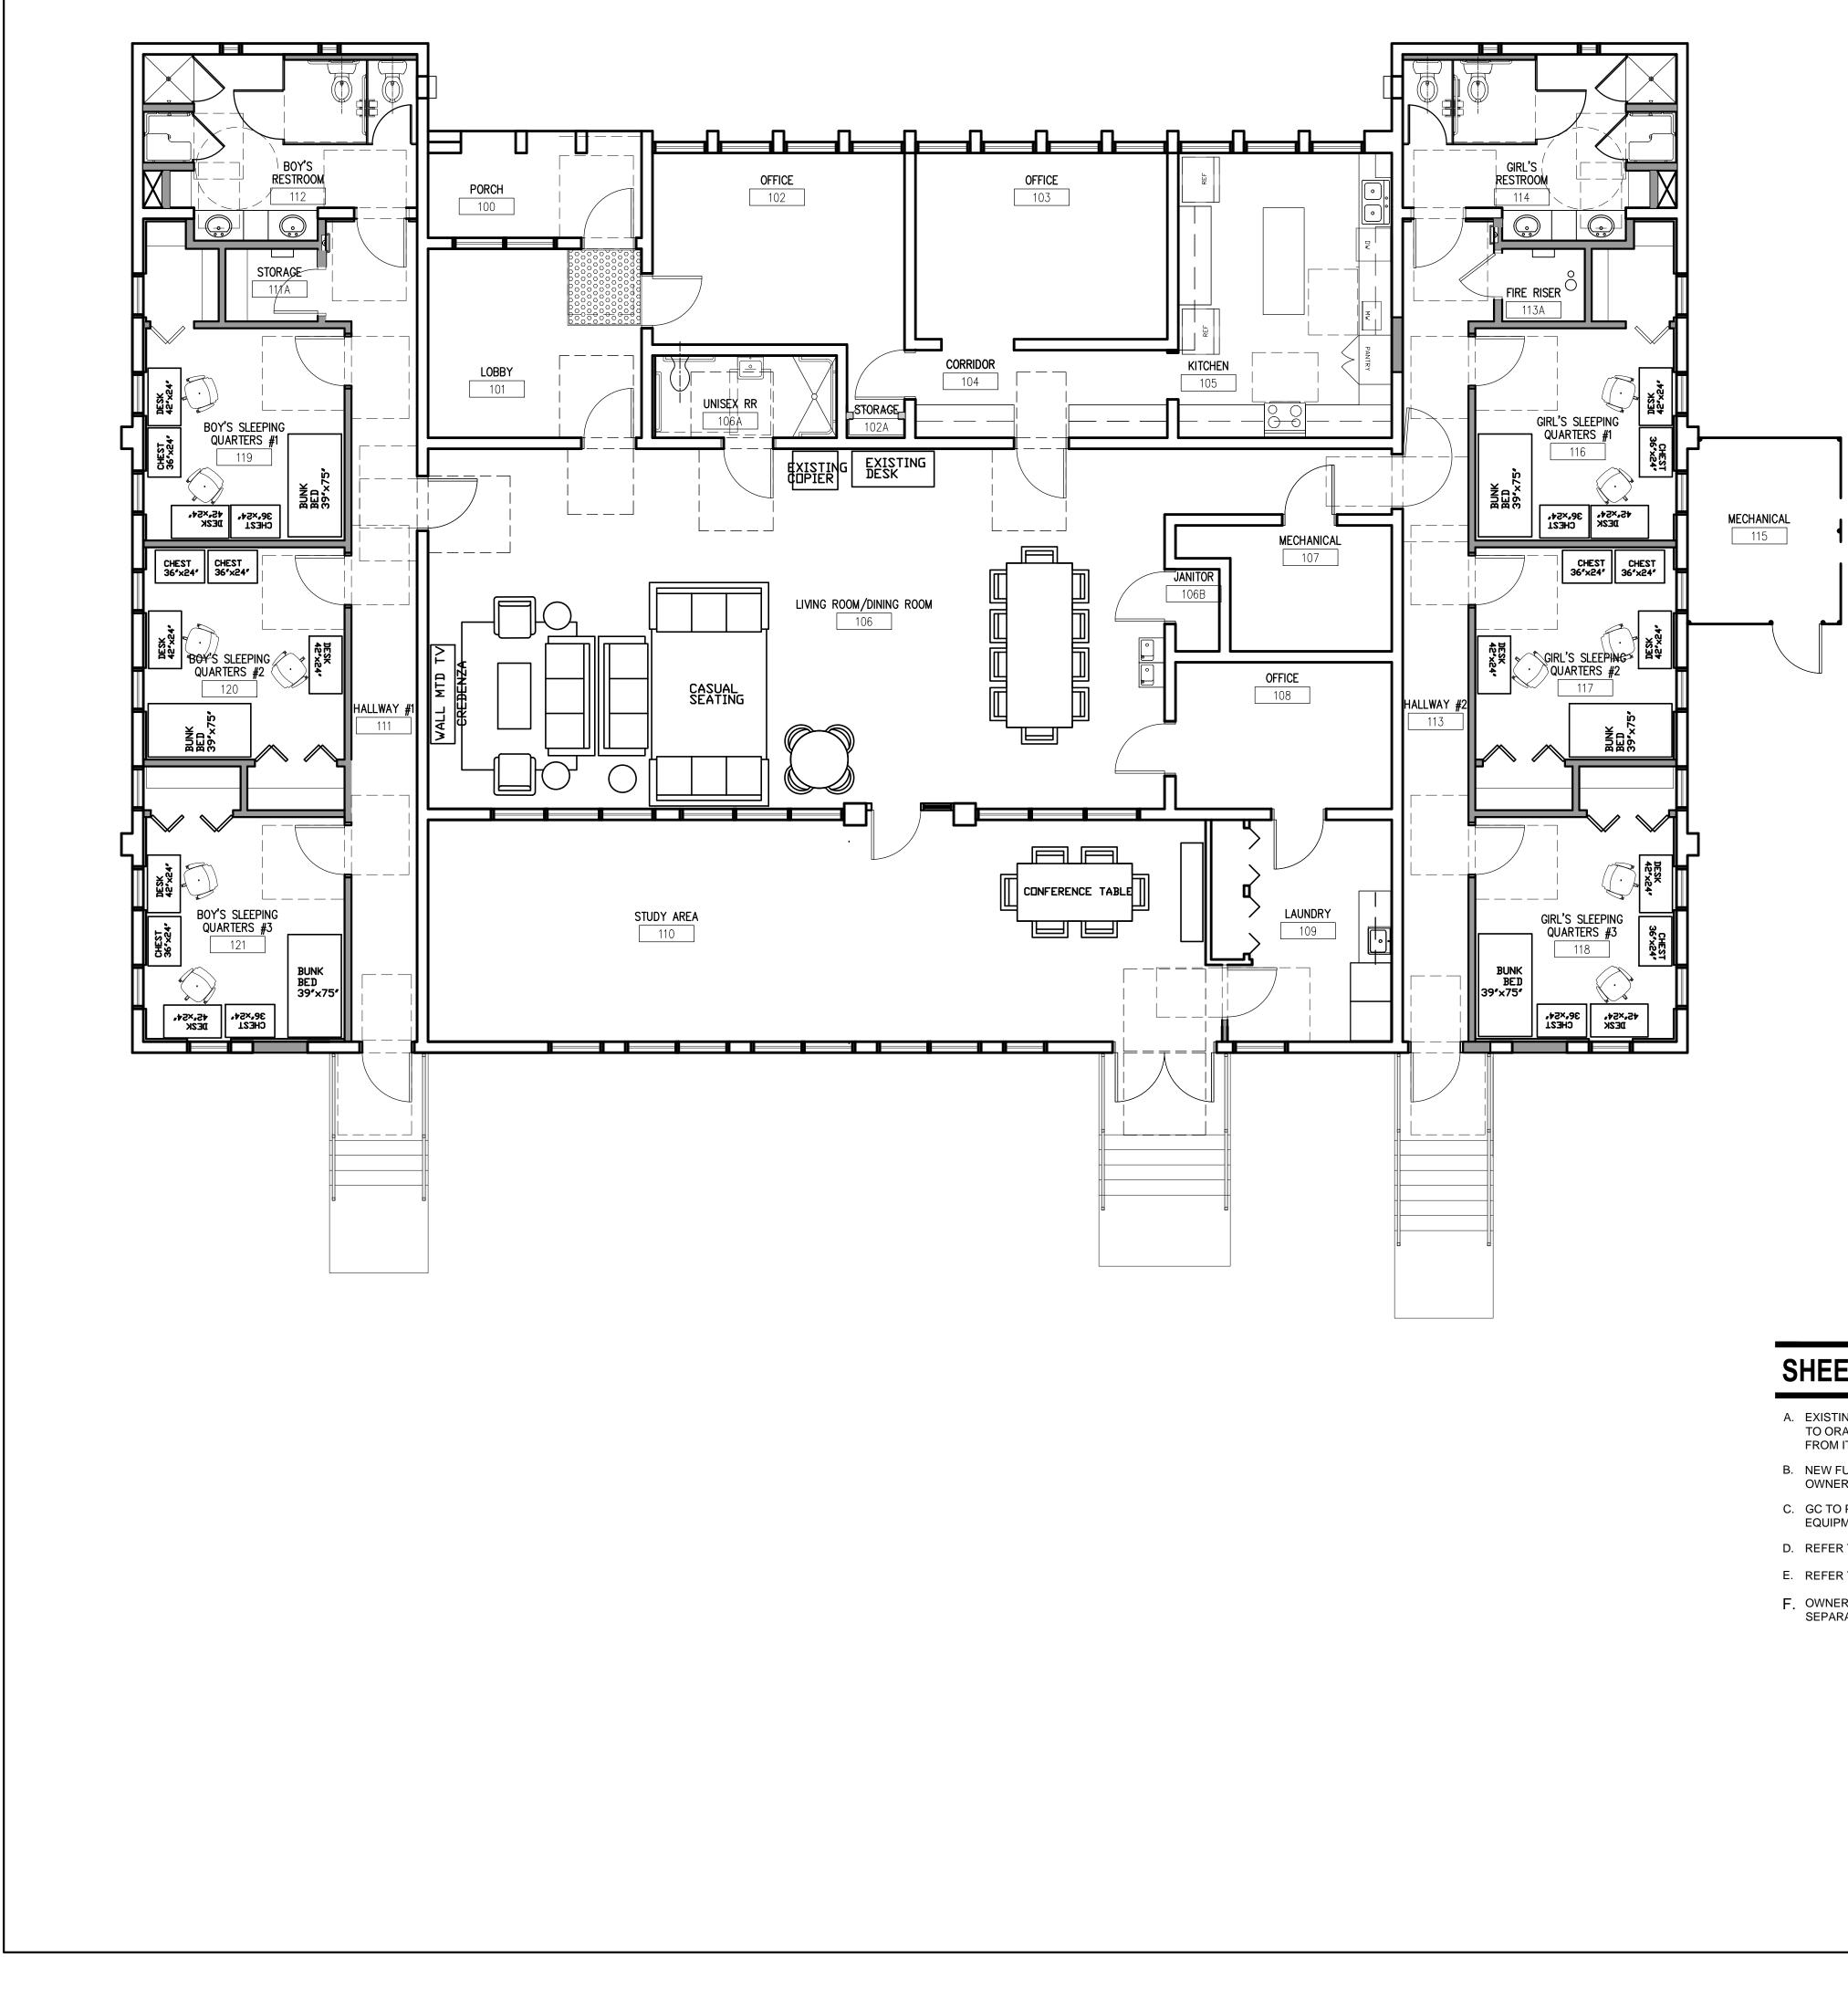

## SHEET NOTES

- A. EXISTING OFFICE FURNITURE AND EQUIPMENT TO BE RETURNED TO ORANGE COUNTY FACILITIES. COORDINATE WITH MANAGER FROM ITEMS TO BE REMOVED / REPLACED.
- B. NEW FURNITURE AND EQUIPMENT SHALL BE PURCHASED BY OWNER. GC TO COORDINATE DELIVERY AND INSTALLATION.
- C. GC TO PROVIDE DEEP CLEANING OF REMAINING FURNITURE AND EQUIPMENT.
- D. REFER TO THIS SHEET FOR FURNITURE LAYOUT.
- E. REFER TO SPECIFICATION BOOK FOR ADDITIONAL INFORMATION.
- F. OWNER TO PURCHASE AND PROCURE FURNITURE UNDER SEPARATE CONTRACT.

ARCHITECTURA	L DESIGN CO	DLLABORATIV
	VENUE	
945 N. PENNSYLVANIA A WINTER PARK, FLORIDA	-	
OFFICE: (407) 629-1188 FAX: (407) 388-1220		
WWW. ADCINTERNATION	IAL.NE I	
STATE OF FLORIDA MARIA FERREIRA		AA-CO
Architect   Seal/Signature		AR-95
Project Documents for:		
OF	AN(	E
	TIN	Ň
	$\mathbf{O}$ R I	
Project:		
GREAT OAKS VILLAG ADA UPGRADES AND	RENOVA	
1784 E. MICHIGAN ST ORLANDO, FL 32806	REET	
Issue Date & Issue Descr	iption	Drawn By Che
	6 CD SET	JS
	% CD SET RMIT/BID SE ⁻	JS T JS
Client Information		
ORANGE COUNTY CA		DJECTS DIV
400 E SOUTH STREET 5th	FLOOR	
ORLANDO, FL 32801		
ORLANDO, FL 32801 Project Number		Issue
Project Number		12
Project Number 15253 Drawn By		12. Project S
Project Number		12
Project Number 15253 Drawn By JS		12 Project S PERMIT /
Project Number 15253 Drawn By JS Checked By KA		12. Project S PERMIT /
Project Number 15253 Drawn By JS Checked By KA File Name	oin Harra AD	12. Project S PERMIT / 3/1
Project Number 15253 Drawn By JS Checked By KA File Name X:\dwgs\15253 OC Wittenst		12 Project S PERMIT / 3/1
Project Number 15253 Drawn By JS Checked By KA File Name		12 Project S PERMIT / 3/1
Project Number 15253 Drawn By JS Checked By KA File Name X:\dwgs\15253 OC Wittenst A06.01 FURNITURE AND E	EQUIPMENT I	12 Project S PERMIT / 3/1
Project Number 15253 Drawn By JS Checked By KA File Name X:\dwgs\15253 OC Wittenst	EQUIPMENT I	12 Project S PERMIT / 3/1
Project Number 15253 Drawn By JS Checked By KA File Name X:\dwgs\15253 OC Wittenst A06.01 FURNITURE AND E	EQUIPMENT I	12 Project S PERMIT / 3/1
Project Number 15253 Drawn By JS Checked By KA File Name X:\dwgs\15253 OC Wittenst A06.01 FURNITURE AND E	EQUIPMENT I	12 Project S PERMIT / 3/1
Project Number 15253 Drawn By JS Checked By KA File Name X:\dwgs\15253 OC Wittenst A06.01 FURNITURE AND E	EQUIPMENT I	12 Project S PERMIT / 3/1
Project Number 15253 Drawn By JS Checked By KA File Name X:\dwgs\15253 OC Wittenst A06.01 FURNITURE AND E	EQUIPMENT I	12 Project S PERMIT / 3/1
Project Number 15253 Drawn By JS Checked By KA File Name X:\dwgs\15253 OC Wittenst A06.01 FURNITURE AND E	EQUIPMENT I	12 Project S PERMIT / 3/1
Project Number 15253 Drawn By JS Checked By KA File Name X:\dwgs\15253 OC Wittenst A06.01 FURNITURE AND E	EQUIPMENT I	12 Project S PERMIT / 3/1
Project Number 15253 Drawn By JS Checked By KA File Name X:\dwgs\15253 OC Wittenst A06.01 FURNITURE AND E	EQUIPMENT I	12 Project S PERMIT / 3/1

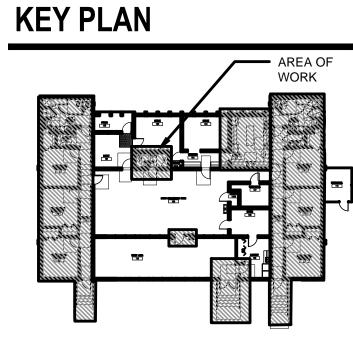


NEW FLOOR PLAN

## FURNITURE & EQUIPMENT LAYOUT


Sheet Title:

A06.01

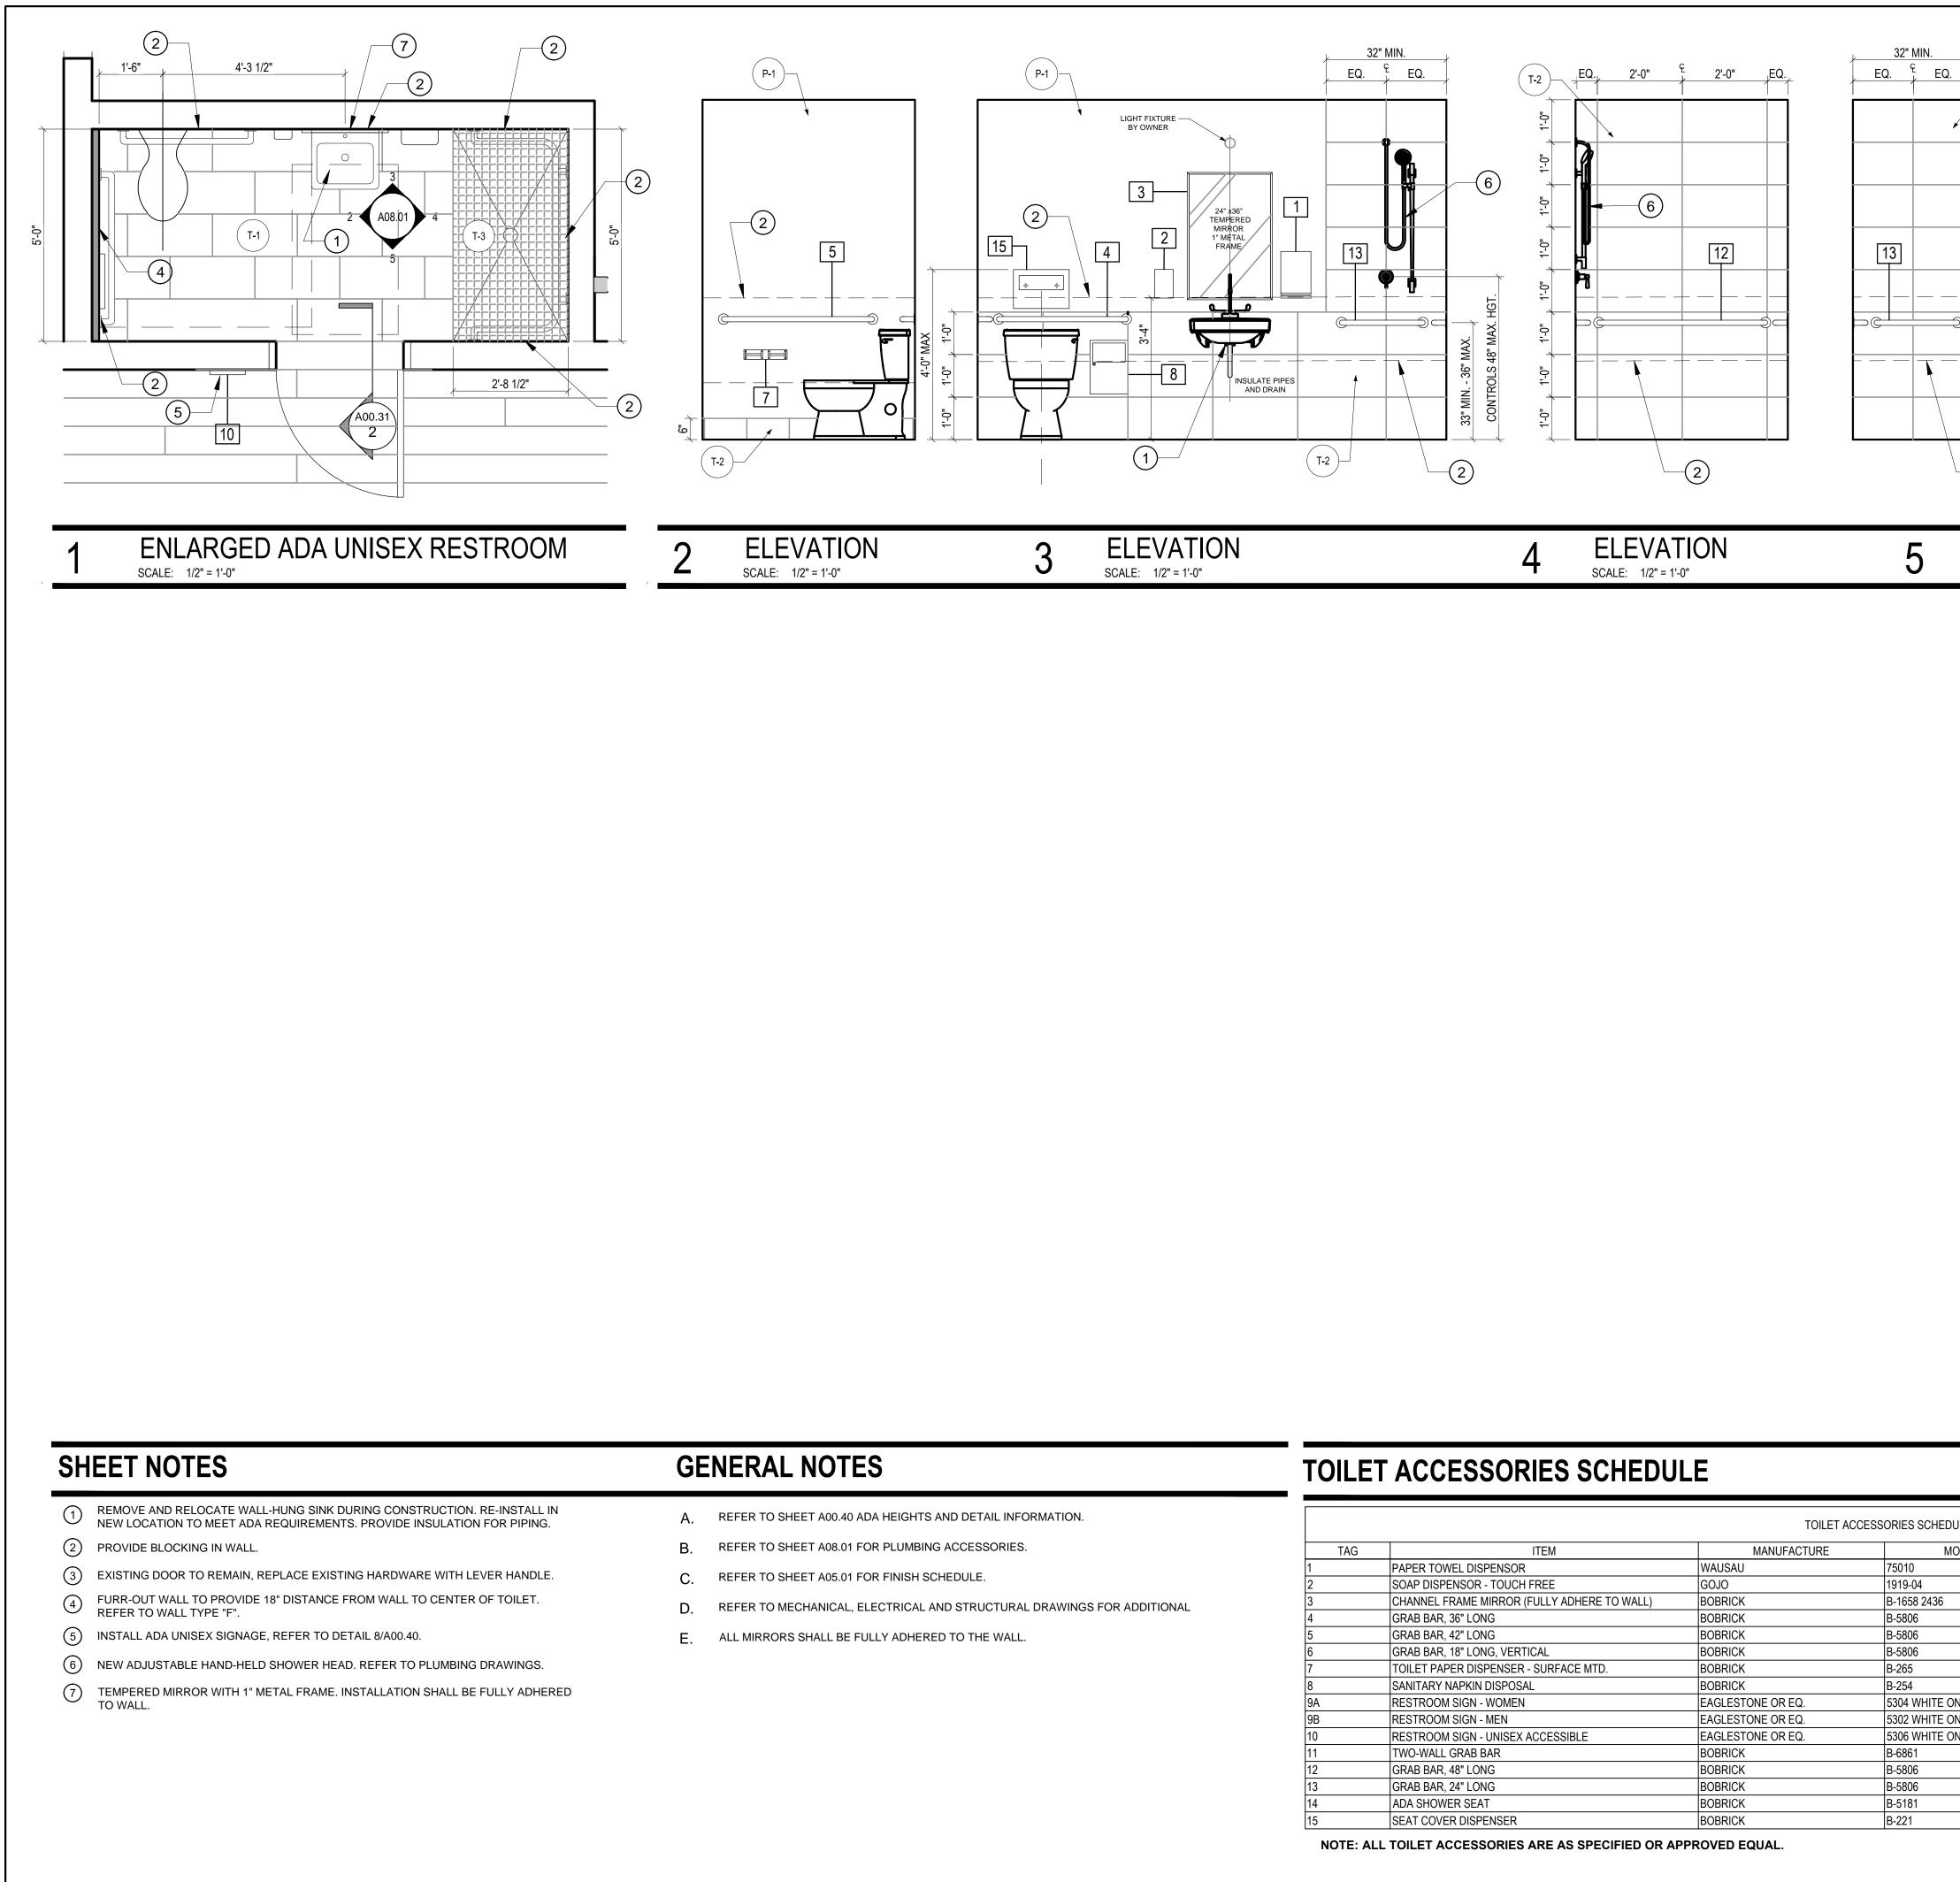

	TOILET ACCESSORIES SCHE					
TAG	ITEM	MANUFACTURE	MC			
1	PAPER TOWEL DISPENSOR	WAUSAU	75010			
2	SOAP DISPENSOR - TOUCH FREE	GOJO	1919-04			
3	CHANNEL FRAME MIRROR (FULLY ADHERE TO WALL)	BOBRICK	B-1658 2436			
4	GRAB BAR, 36" LONG	BOBRICK	B-5806			
5	GRAB BAR, 42" LONG	BOBRICK	B-5806			
6	GRAB BAR, 18" LONG, VERTICAL	BOBRICK	B-5806			
7	TOILET PAPER DISPENSER - SURFACE MTD.	BOBRICK	B-265			
8	SANITARY NAPKIN DISPOSAL	BOBRICK	B-254			
9A	RESTROOM SIGN - WOMEN	EAGLESTONE OR EQ.	5304 WHITE ON			
9B	RESTROOM SIGN - MEN	EAGLESTONE OR EQ.	5302 WHITE ON			
10	RESTROOM SIGN - UNISEX ACCESSIBLE	EAGLESTONE OR EQ.	5306 WHITE ON			
11	TWO-WALL GRAB BAR	BOBRICK	B-6861			
12	GRAB BAR, 48" LONG	BOBRICK	B-5806			
13	GRAB BAR, 24" LONG	BOBRICK	B-5806			
14	ADA SHOWER SEAT	BOBRICK	B-5181			
15	SEAT COVER DISPENSER	BOBRICK	B-221			

WINTERS ( FAX. (607) WW. ADA STATE OF WW. ADA	FLORIDA RREIRA Seal/Signature cuments for: COUNCINE FLORIDA RREIRA Seal/Signature	TEIN COTTAGE ONS Drawn By Checked By JS KA JS KA
STATE OF MARIA FIE Project To ELEVATION SCALE: 1/2"=10" TO TO TO TO TO TO TO TO TO TO	RREIRA         Seal/Signature         cuments for:         ORANGE         COUNT         F       O       R         OAKS VILLAGE WITTENS         SRADES AND RENOVATI         AICHIGAN STREET       O         O, FL 32806         Ite & Issue Description       D         Z.27.16       60% CD SET         O.15.16       90% CD SET	AR-95752
Image: Solate:       12***140*         Image: Solate:       12****140*         Image: Solate:       12****140*         Image: Solate:       12************************************	DAKS VILLAGE WITTENS GRADES AND RENOVATI /ICHIGAN STREET O, FL 32806 te & Issue Description D 7.27.16 60% CD SET 0.15.16 90% CD SET	TEIN COTTAGE ONS Drawn By Checked By JS KA JS KA
SCALE: 1/2" = 1'-0" Project: P	GRADES AND RENOVATI /ICHIGAN STREET O, FL 32806 te & Issue Description D 7.27.16 60% CD SET 0.15.16 90% CD SET	Drawn By Checked By JS KA JS KA
Image: Second state sta	7.27.16         60% CD SET           9.15.16         90% CD SET	JS KA JS KA
Client Inform     CRANGE     CORANGE     Drawn By     JS     Checked I     KA     File Name     X:ldwgs\15     A08.01 INT		
• Since the second seco		
KA File Name X:\dwgs\15 A08.01 INT	nation COUNTY CAPITAL PRO TH STREET 5th FLOOR , FL 32801	JECTS DIVISION
	<b>By</b> 253 OC Wittenstein House ADA	Issue Date 12/02/2016 Project Status PERMIT / BID SET Scale 1/2" = 1'-0"
Consultan	ERIOR ELEVATIONS.dwg	
DULE		
MODEL NO. REMARKS		
BLACK TRANSLUCENT         BLACK AND SILVER         BRIGHT-POLISHED STAINLESS STEEL FINISH - TEMPERED         SATIN STAINLESS STEEL         SATIN STAINLESS STEEL		
SATIN STAINLESS STEEL         SATIN STAINLESS STEEL         BRIGHT POLISHED CHROME PLATED STEEL FINISH         WOMEN'S RR ONLY; SATIN FINISH STAINLESS STEEL         ON BLACK         ON BLACK	ENLARGED FLOOI & ELEVATIC	
ON BLACK       SATIN STAINLESS STEEL         SATIN STAINLESS STEEL         SATIN STAINLESS STEEL         REVERSIBLE SOLID PHENOLIC FOLDING SHOWER SEAT         STAINLESS STEEL SURFACE MOUNTED		1

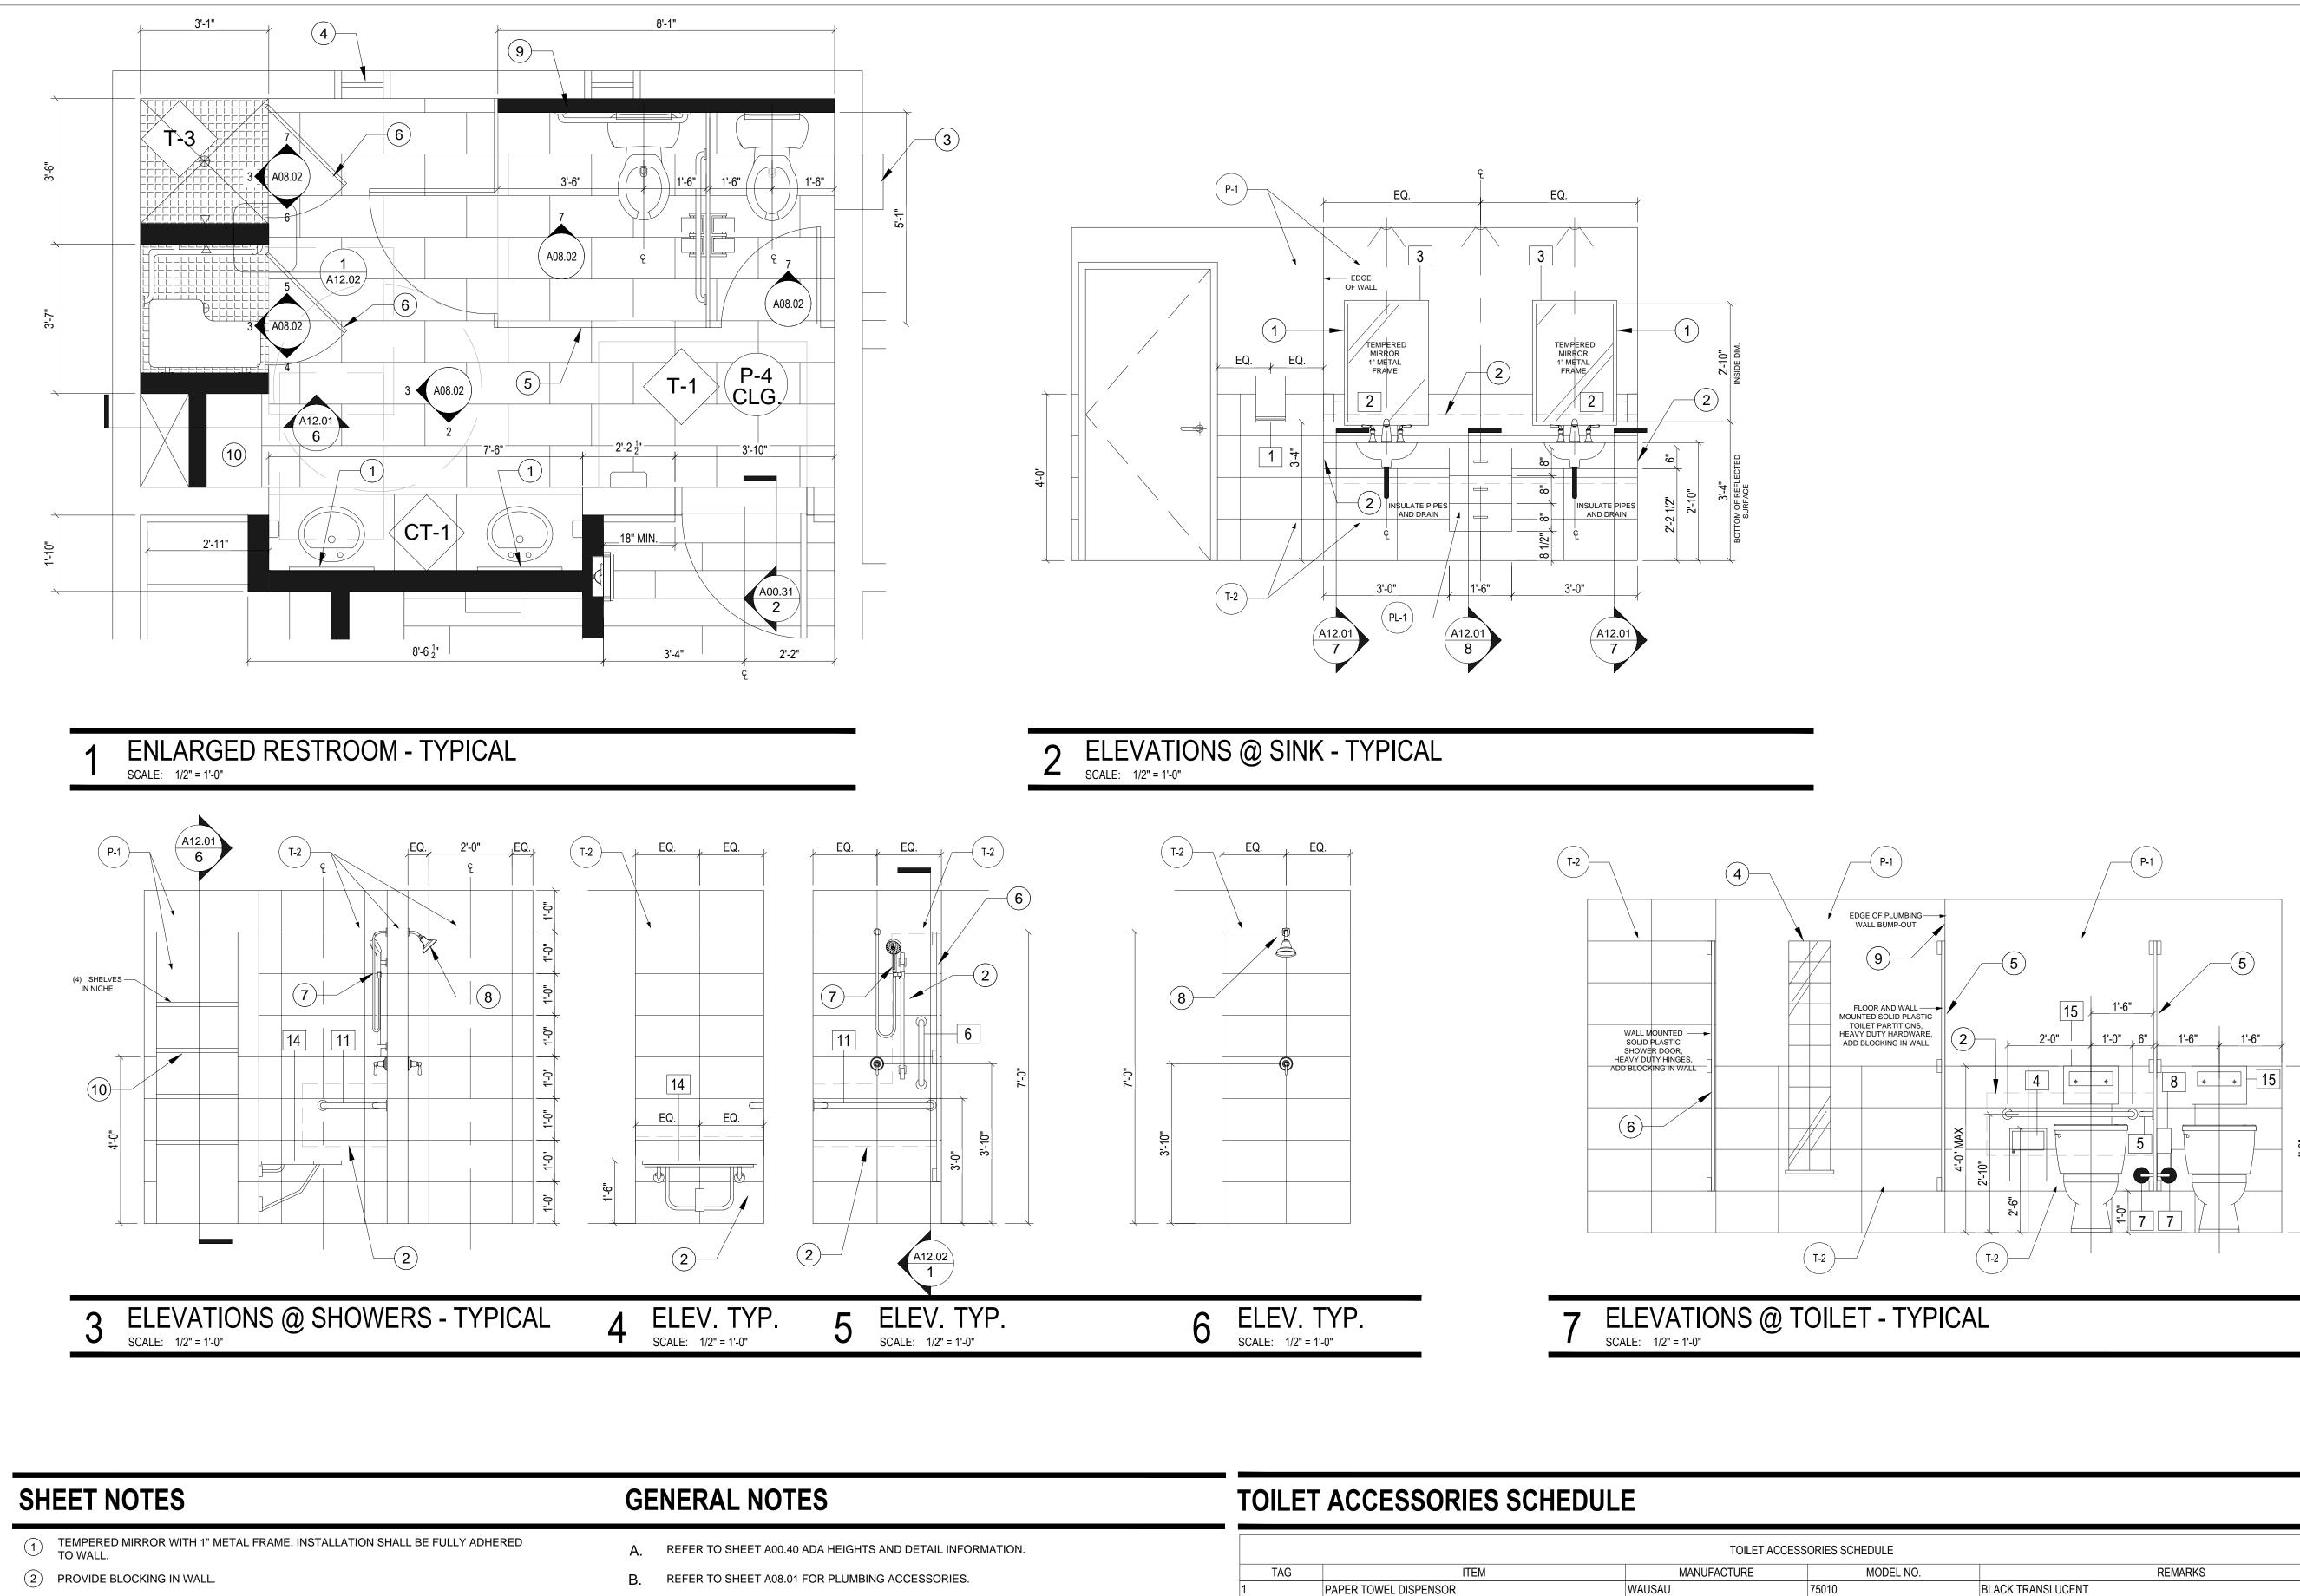

- 3 PROPOSED EXHAUST FAN, REFER TO MECHANICAL DRAWINGS.
- (4) EXTEND GLASS BLOCK, MATCH EXISTING.
- 5 INSTALL SOLID PLASTIC TOILET PARTITIONS WITH HEAVY DUTY HINGES, MANUFACTURE: ONE POINT PARTITIONS, COLOR: IVORY ESSENCE SPECKLE #9500.
- 6 INSTALL SOLID PLASTIC DOOR ON THE SHOWERS WITH HEAVY DUTY HINGES, MANUF. ONE POINT PARTITIONS, COLOR: IVORY ESSENCE SPECKLE #9500. REFER TO DETAIL
- 1/A12.02. 7 NEW ADJUSTABLE HAND-HELD SHOWER HEAD WITH CONTROL VALUE. REFER TO PLUMBING DRAWINGS.
- 8 NEW FIXED SHOWER HEAD WITH CONTROL VALUE, REFER TO PLUMBING DRAWINGS.
- 9 FURR-OUT WALL TO PROVIDE PLUMBING WALL . REFER TO WALL TYPE "D".
- (10) INSTALL FOUR (4) WOODEN PAINTED SHELVES, REFER TO DETAIL 6/A12.01


- REFER TO SHEET A05.01 FOR FINISH SCHEDULE. C.
- D. INFORMATION.

REFER TO MECHANICAL, ELECTRICAL AND STRUCTURAL DRAWINGS FOR ADDITIONAL


TOILET ACCESSORIES SCHEDULE					
TAG	ITEM	MANUFACTURE	MODEL NO.	REMARKS	
	PAPER TOWEL DISPENSOR	WAUSAU	75010	BLACK TRANSLUCENT	
	SOAP DISPENSOR - TOUCH FREE	GOJO	1919-04	BLACK AND SILVER	
	CHANNEL FRAME MIRROR (FULLY ADHERE TO WALL)	BOBRICK	B-1658 2436	BRIGHT-POLISHED STAINLESS STEEL FINISH - TEMPERED	
	GRAB BAR, 36" LONG	BOBRICK	B-5806	SATIN STAINLESS STEEL	
	GRAB BAR, 42" LONG	BOBRICK	B-5806	SATIN STAINLESS STEEL	
	GRAB BAR, 18" LONG, VERTICAL	BOBRICK	B-5806	SATIN STAINLESS STEEL	
	TOILET PAPER DISPENSER - SURFACE MTD.	BOBRICK	B-265	BRIGHT POLISHED CHROME PLATED STEEL FINISH	
	SANITARY NAPKIN DISPOSAL -WOMEN'S RR ONLY	BOBRICK	B-254	WOMEN'S RR ONLY; SATIN FINISH STAINLESS STEEL	
A	RESTROOM SIGN - WOMEN	EAGLESTONE OR EQ.	5304 WHITE ON BLACK		
В	RESTROOM SIGN - MEN	EAGLESTONE OR EQ.	5302 WHITE ON BLACK		
0	RESTROOM SIGN - UNISEX ACCESSIBLE	EAGLESTONE OR EQ.	5306 WHITE ON BLACK		
1	TWO-WALL GRAB BAR	BOBRICK	B-6861	SATIN STAINLESS STEEL	
2	GRAB BAR, 48" LONG	BOBRICK	B-5806	SATIN STAINLESS STEEL	
3	GRAB BAR, 24" LONG	BOBRICK	B-5806	SATIN STAINLESS STEEL	
4	ADA SHOWER SEAT	BOBRICK	B-5181	REVERSIBLE SOLID PHENOLIC FOLDING SHOWER SEAT	
5	SEAT COVER DISPENSER	BOBRICK	B-221	STAINLESS STEEL SURFACE MOUNTED	

NOTE: ALL TOILET ACCESSORIES ARE AS SPECIFIED OR APPROVED EQUAL.


	945 N. PENNSYLVANIA AVENUE WINTER PARK, FLORIDA 32789 OFFICE: (407) 629-1188 FAX: (407) 388-1220 WWW. ADCINTERNATIONAL.NET	COLLABORATIVE
	STATE OF FLORIDA MARIA FERREIRA Architect • Seal/Signature	AA-C001315 AR-95752
	Project Documents for:         Image: Constant of the second sec	NSTEIN COTTAGE
	Issue         Date & Issue Description           07.27.16         60% CD SET           09.15.16         90% CD SET           12.02.16         PERMIT/BID S	Drawn By Checked By JS KA JS KA SET JS KA
5	<ul> <li>Signature</li> <li>Signature</li></ul>	ROJECTS DIVISION
	<ul> <li>400 E SOUTH STREET 5th FLOOR ORLANDO, FL 32801</li> <li>Project Number 15253 Drawn By JS Checked By KA</li> <li>File Name X:\dwgs\15253 OC Wittenstein House A A08.02 INTERIOR ELEVATIONS.dwg</li> </ul>	Issue Date 12/02/2016 Project Status PERMIT / BID SET Scale 1/2" = 1'-0"
	Consultant • Seal/Signature	
IARKS	Sheet Title:	
NISH - TEMPERED	ENLARGED RESTF & ELEVATI	
EEL FINISH LESS STEEL	A08.	02
SHOWER SEAT		

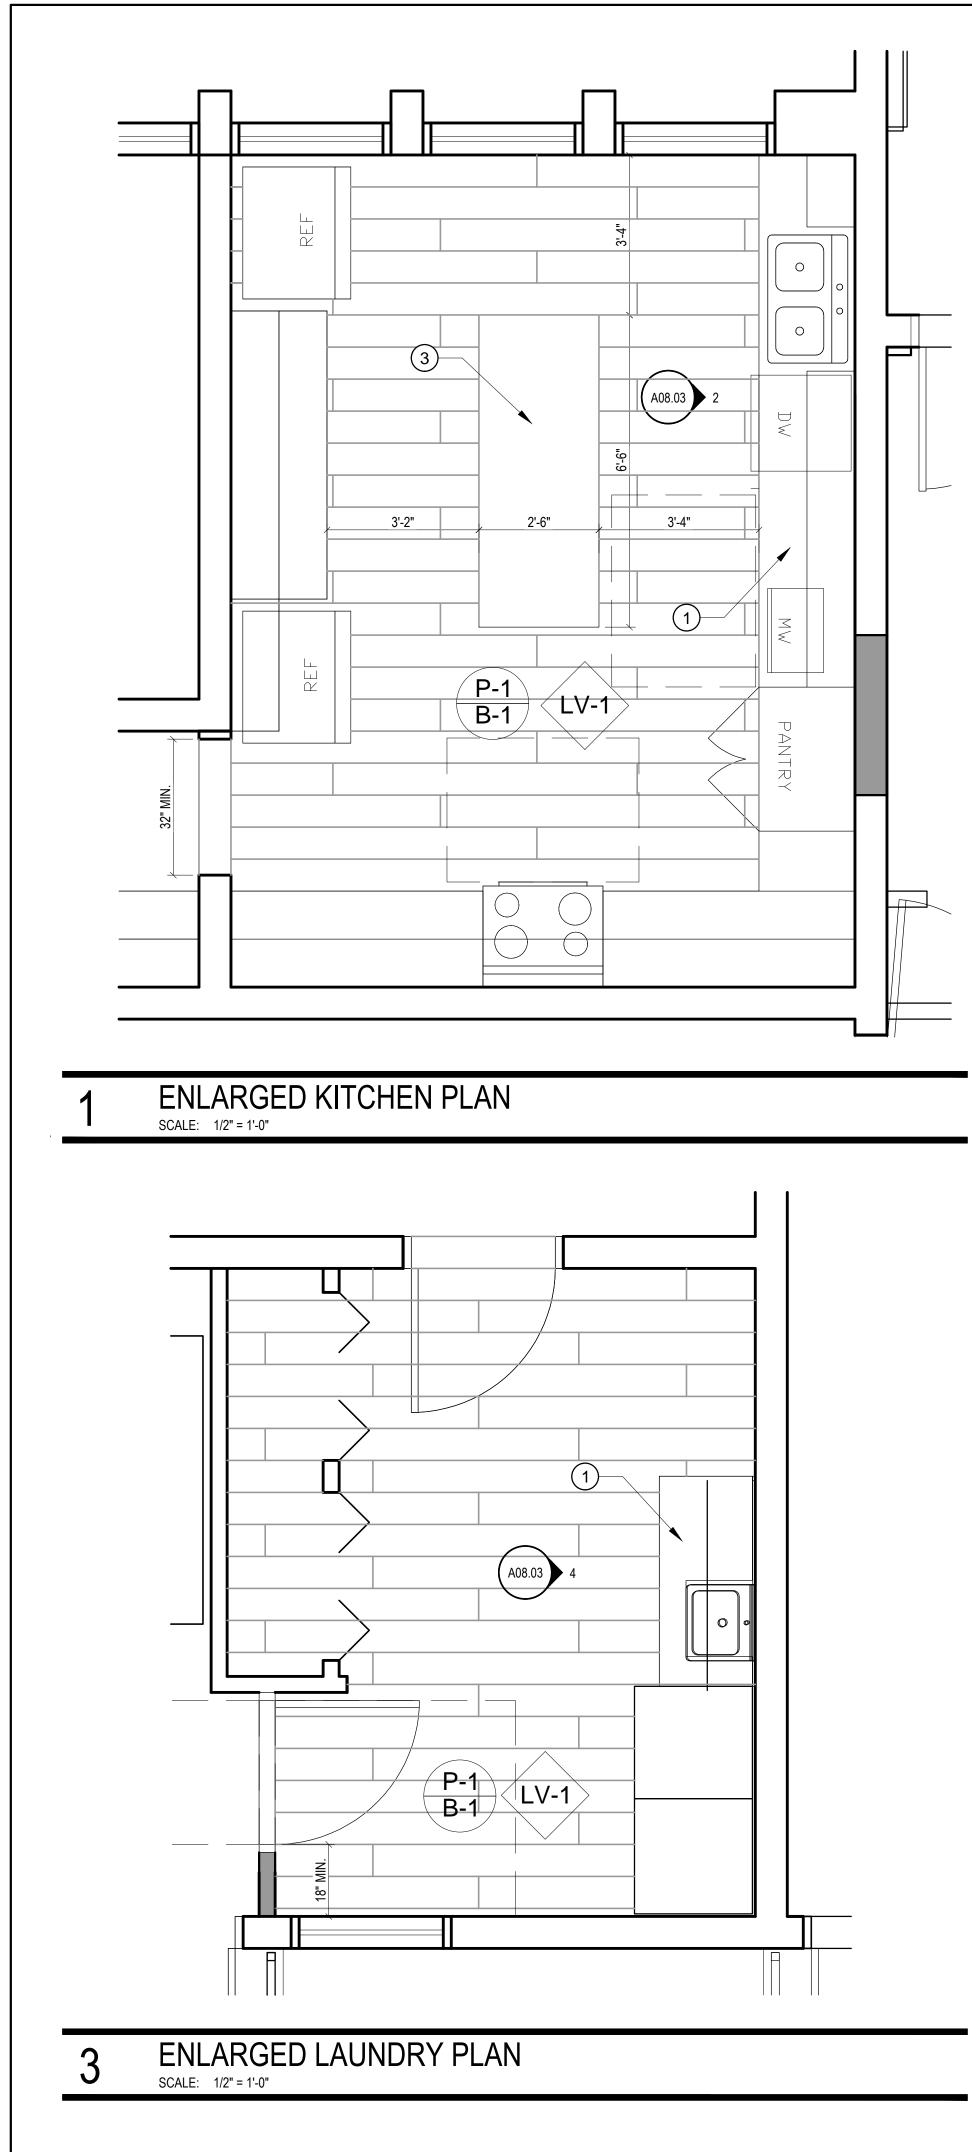

Õ

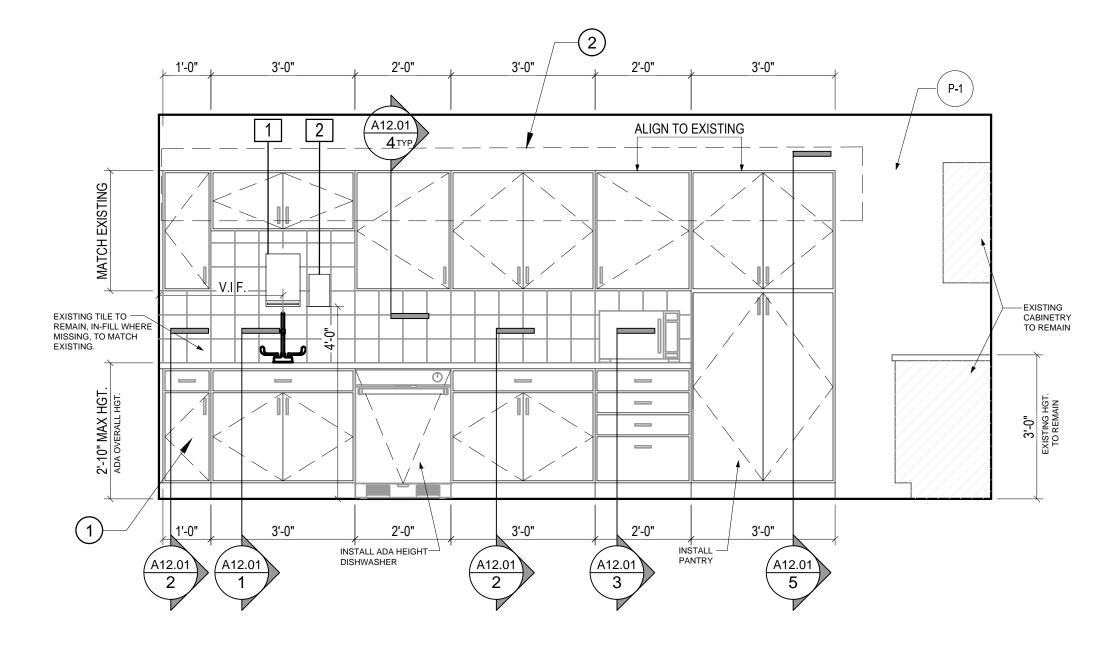

**ELEVATION - KITCHEN** 2 SCALE: 1/2" = 1'-0"

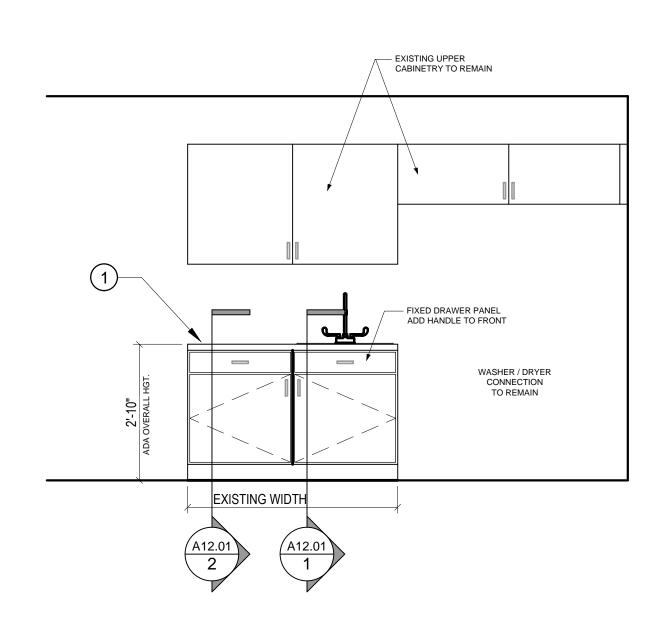

### **ELEVATION - LAUNDRY** SCALE: 1/2" = 1'-0"


## SHEET NOTES

SHEET NOTES

A. REFER TO SHEET A00.40 ADA HEIGHTS AND DETAIL INFORMATION.

C. REFER TO SHEET A05.01 FOR FINISH SCHEDULE.

- 1 INSTALL NEW CABINETRY WITH NEW COUNTER TOP, TOTAL OF 34" AFF, FINISH TO MATCH EXISTING.
- 2 PROVIDE BLOCKING IN WALL FOR UPPER CABINETS.
- ③ CUT EXISTING ISLAND COUNTER TO NEW SIZE.

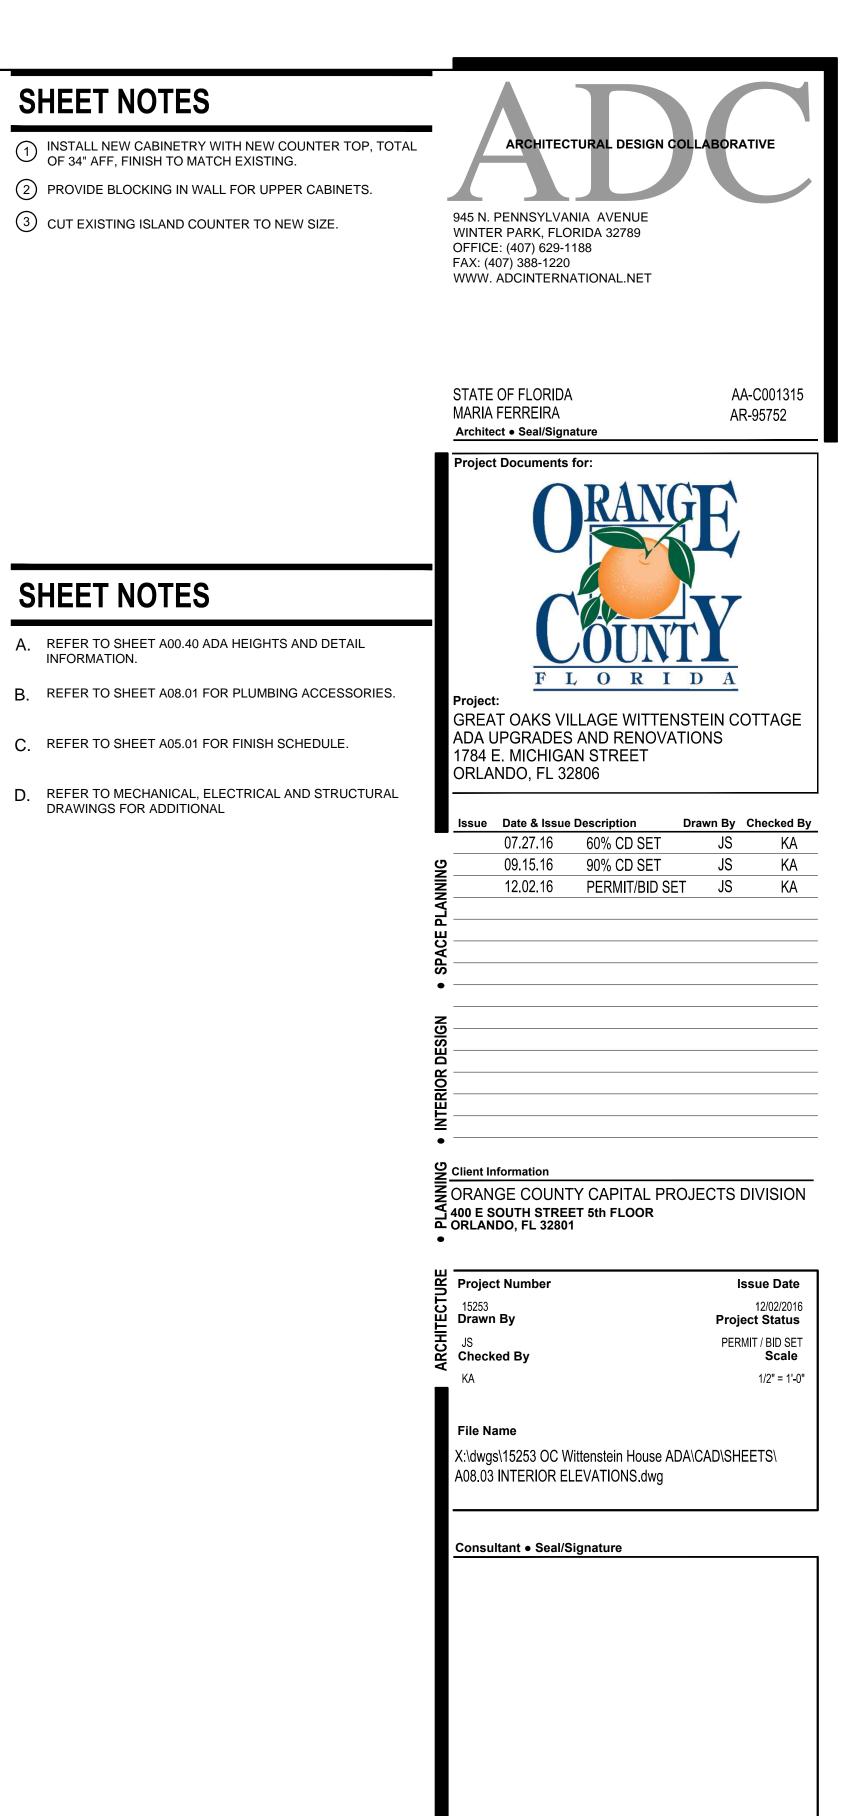



Sheet Title:


ENLARGED KITCHEN PLAN & ELEVATIONS






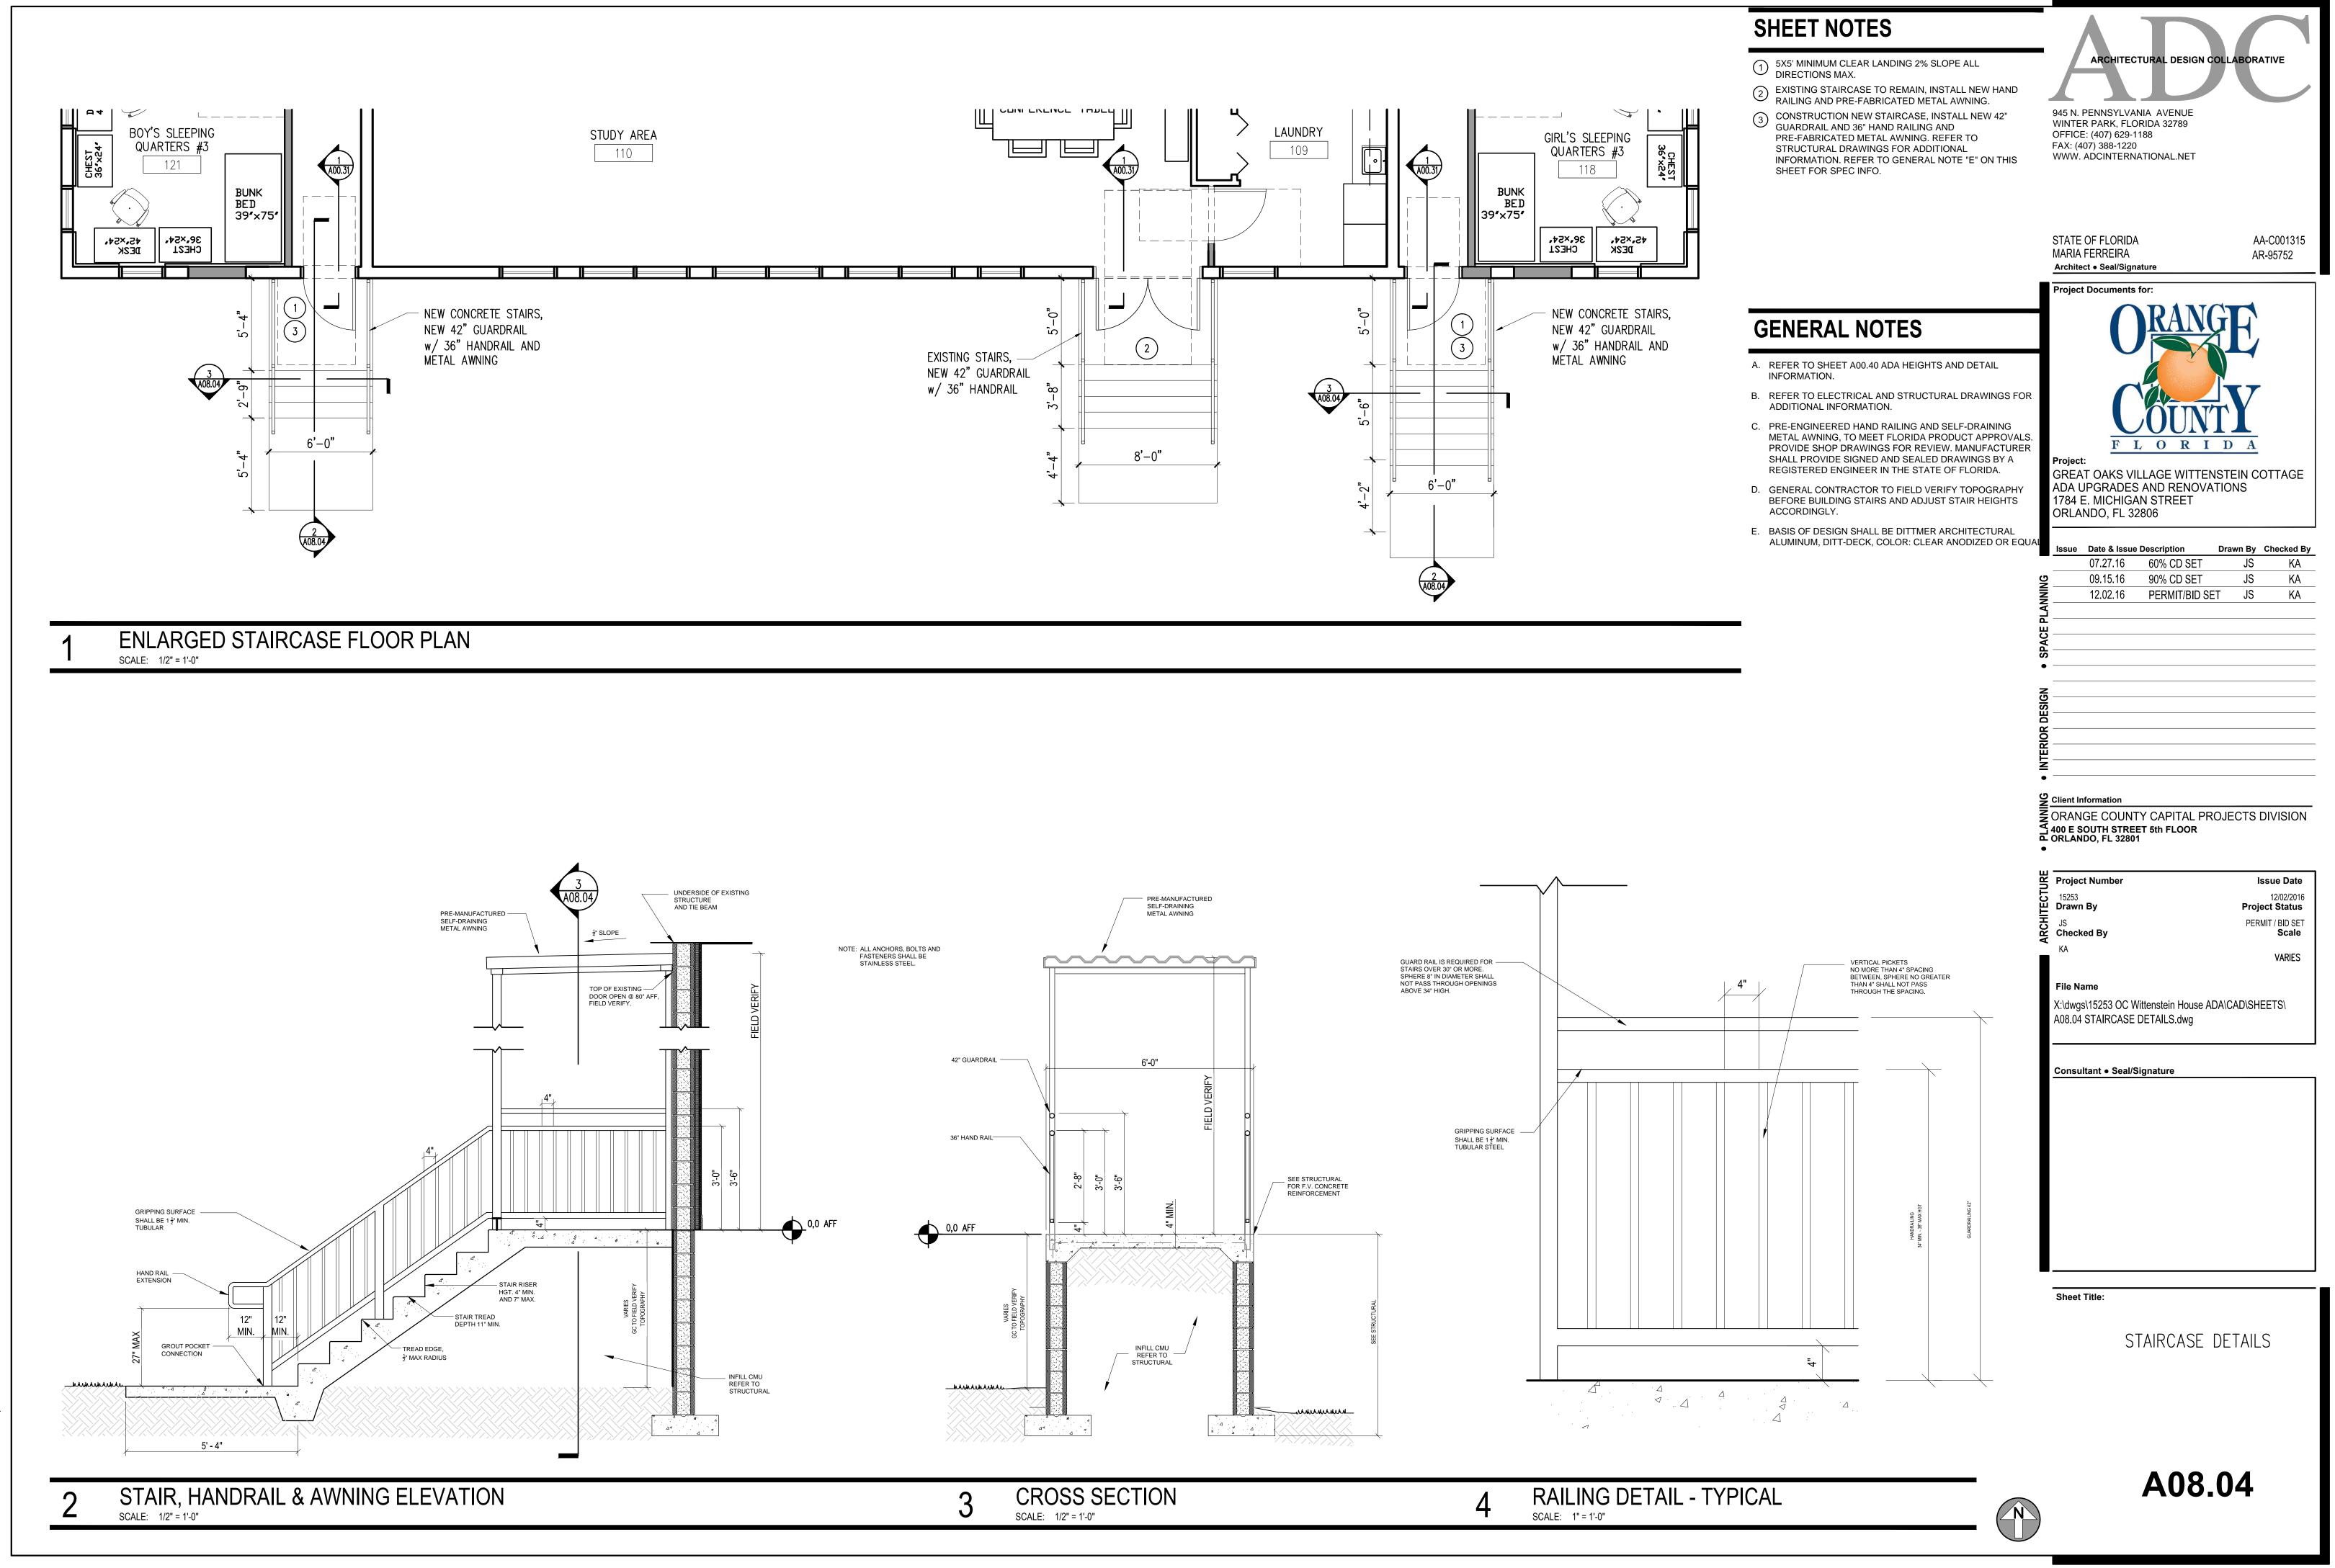

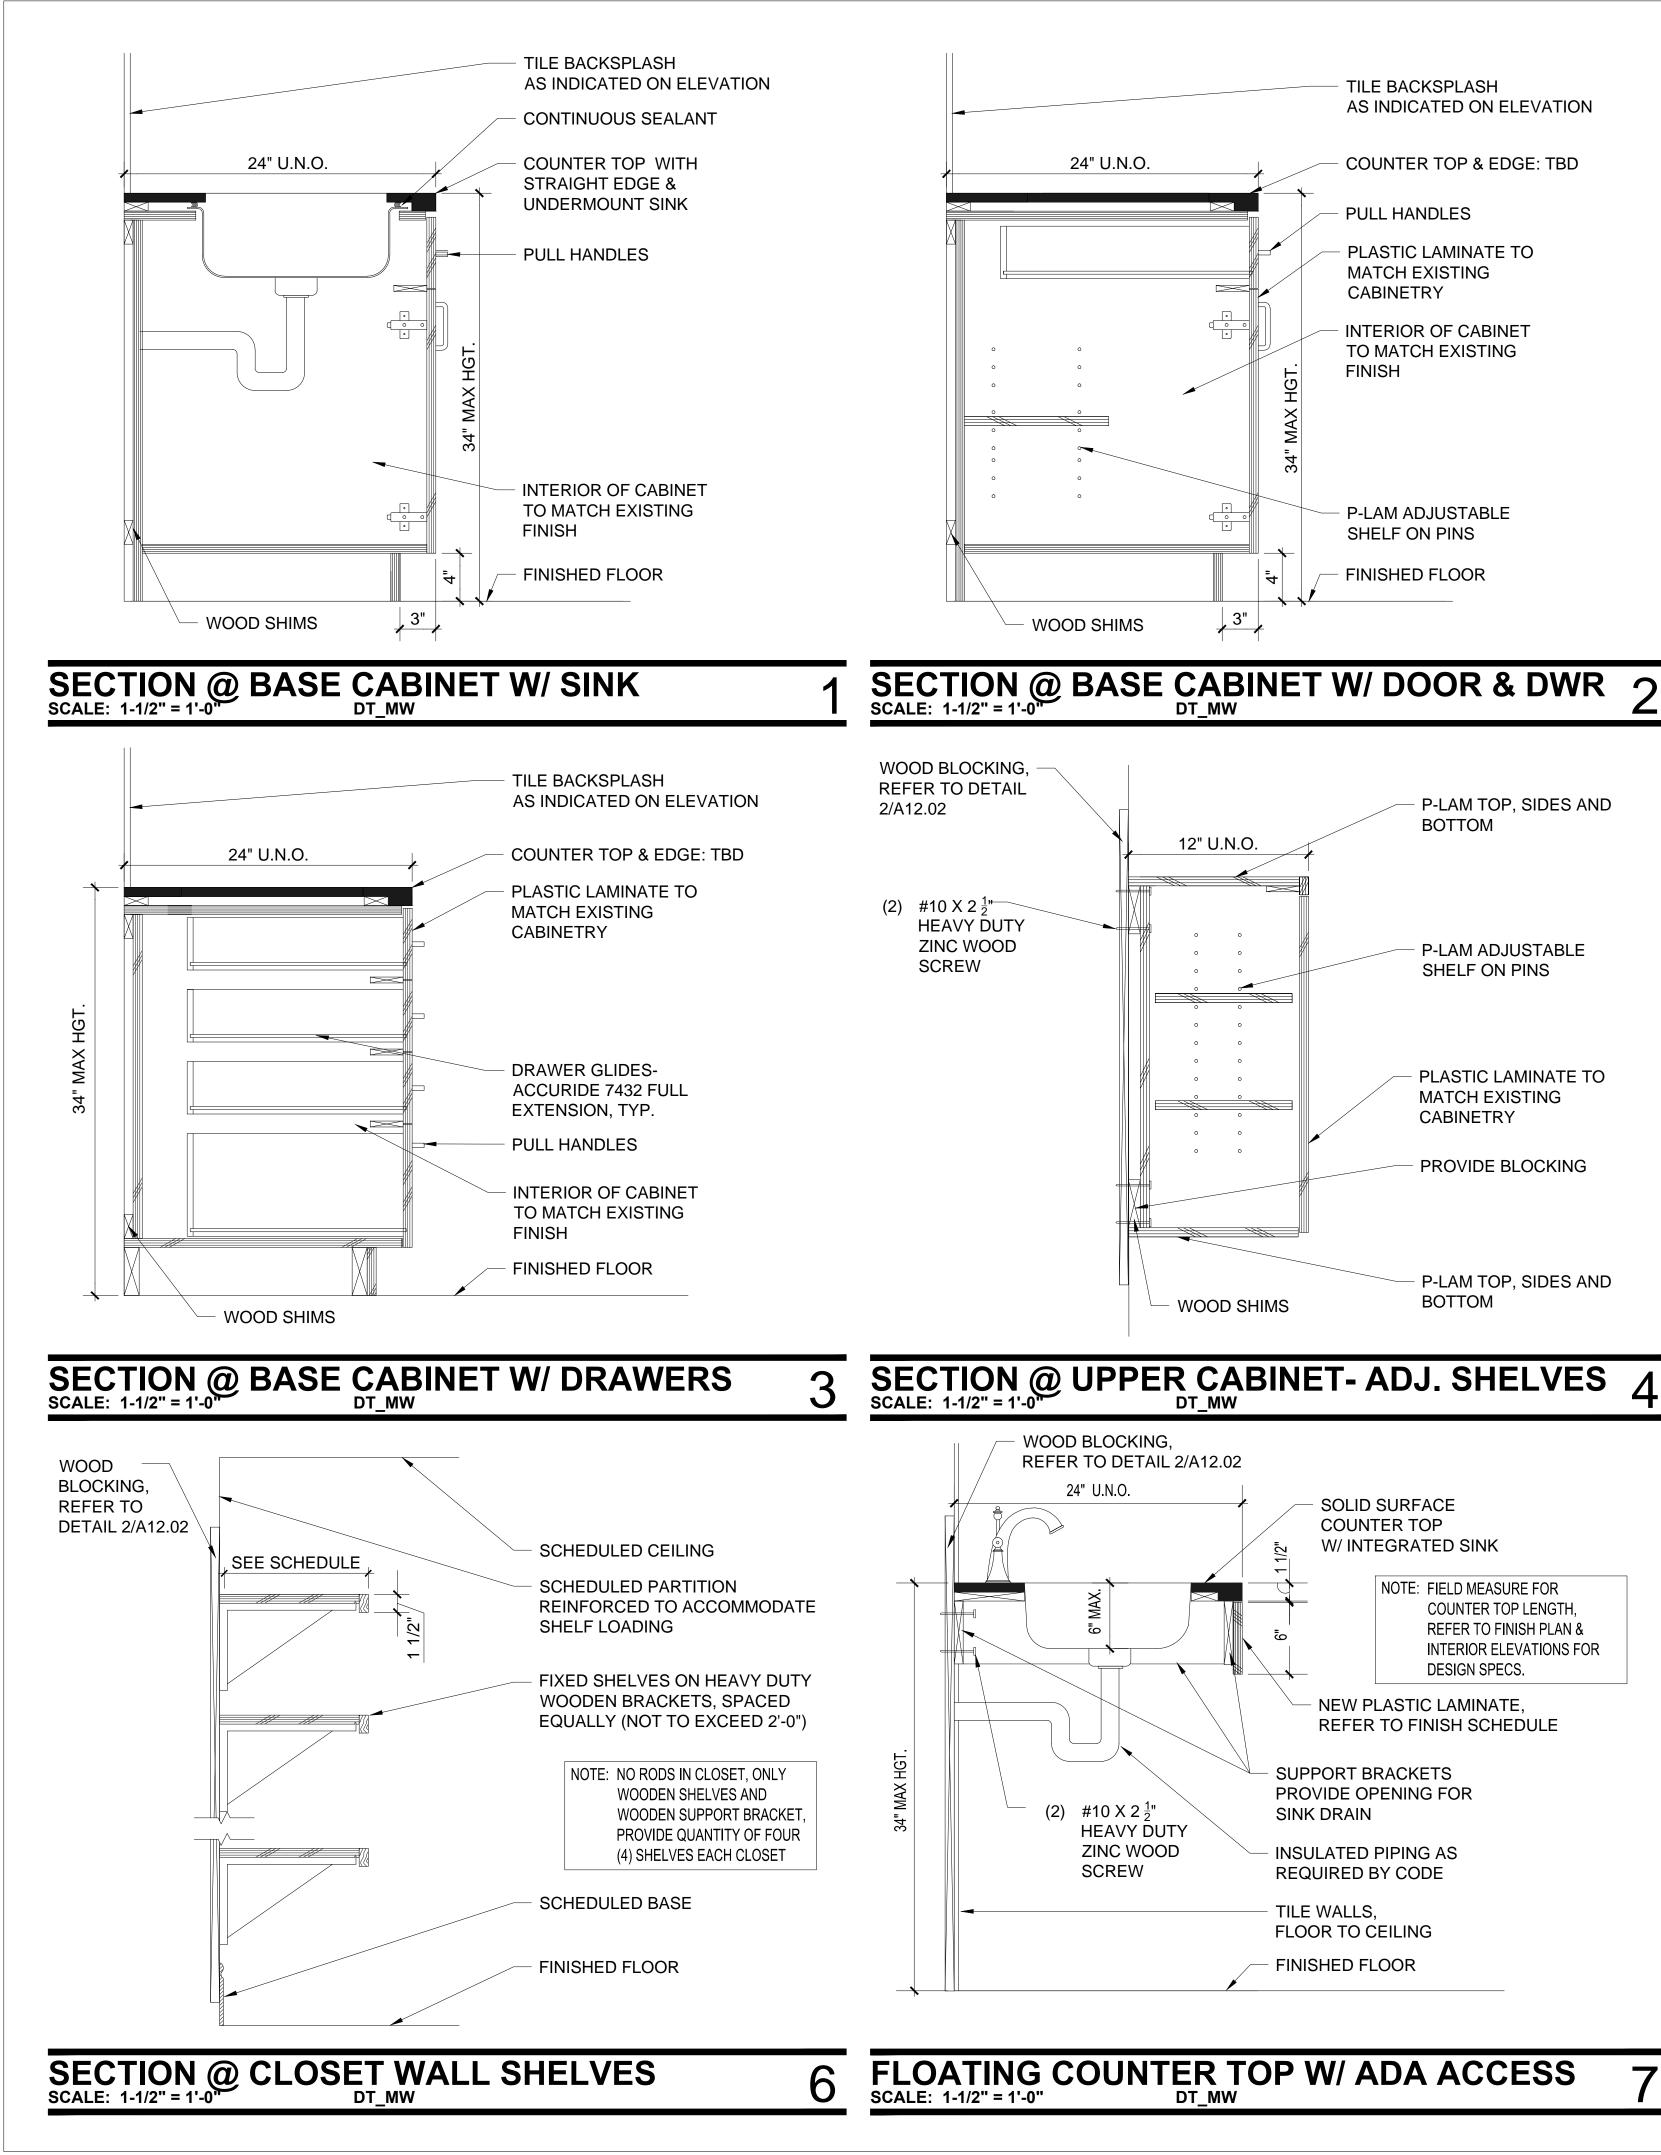

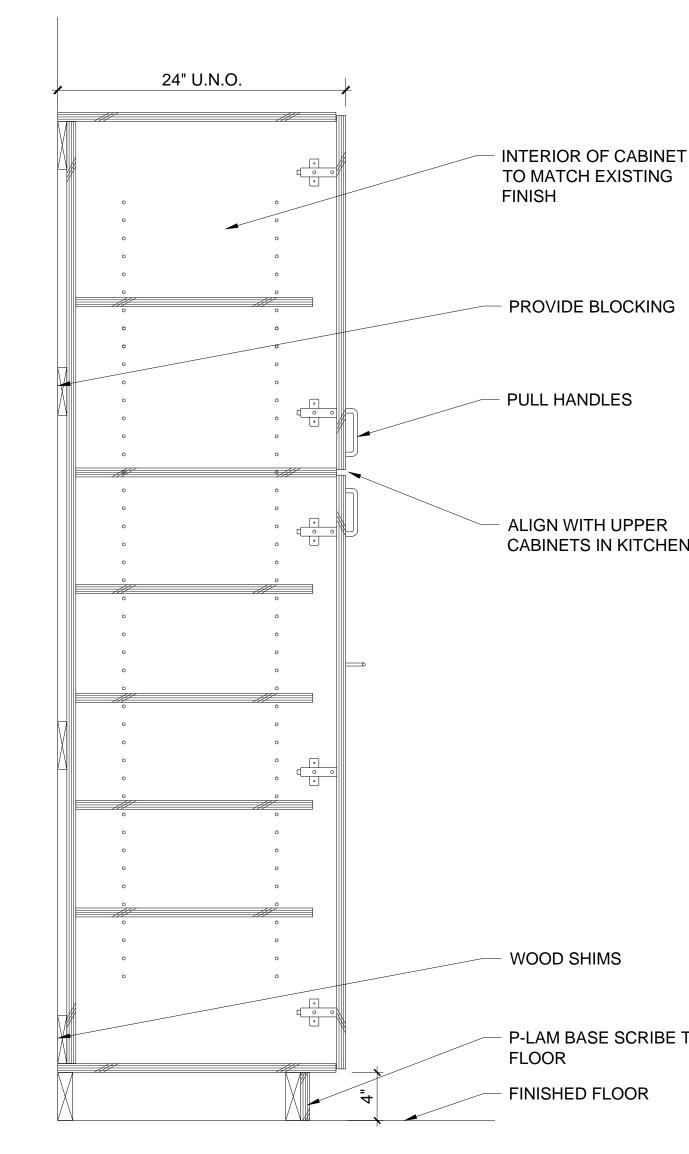

# SECTION @ PANTRY CABINET- AD

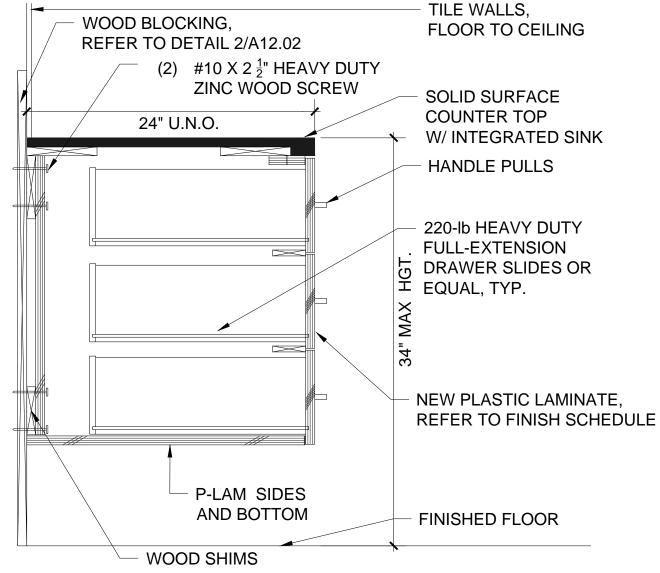

SECTION OF FLOATING CABINET W/ DWRS

5	SHEET NOTES	
1	ALL MILLWORK DOOR HINGES TO BE 120 DEGREE, HEAVY DUTY EUROPEAN STYLE. GC TO SIZE HARDWARE LENGTHS SO THERE IS NOT INTERFERENCE WITH WALLS OR OTHER OBSTRUCTIONS.	ARCHITECTURAL DESIGN CO 945 N. PENNSYLVANIA AVENUE WINTER PARK, FLORIDA 32789 OFFICE: (407) 629-1188 FAX: (407) 388-1220 WWW. ADCINTERNATIONAL.NET

STATE OF FLORIDA

AA-C001315


TO MATCH EXISTING	MARIA FERREIRA Architect • Seal/Signature	AR-95752
FINISH	Project Documents for:	
PROVIDE BLOCKING	ORAN	GE
PULL HANDLES		
ALIGN WITH UPPER CABINETS IN KITCHEN	Project: GREAT OAKS VILLAGE WITT ADA UPGRADES AND RENOV 1784 E. MICHIGAN STREET ORLANDO, FL 32806	
	Issue Date & Issue Description	Drawn By Checked By
	07.27.16 60% CD SET	JS KA
	90% CD SET 12.02.16 PERMIT/BID	SET JS KA
	• SPACE	
	DESIGN	
	• Client Information	
WOOD SHIMS	ORANGE COUNTY CAPITAL F 400 E SOUTH STREET 5th FLOOR ORLANDO, FL 32801	PROJECTS DIVISION
P-LAM BASE SCRIBE TO FLOOR	Project Number	Issue Date
	Drawn By	12/02/2016 Project Status
FINISHED FLOOR	Project Number 15253 Drawn By JS Checked By KA	PERMIT / BID SET <b>Scale</b> 1-1/2" = 1'-0"
DJ. SHELVES5	File Name X:\dwgs\15253 OC Wittenstein House A12.01 MILLWORK DETAILS.dwg	e ADA\CAD\SHEETS\
ALLS, TO CEILING		
	Consultant • Seal/Signature	
SURFACE ER TOP		
GRATED SINK E PULLS		
EAVY DUTY		
(TENSION R SLIDES OR TYP.		
	Sheet Title:	
	Sneet fille.	





MILLWORK DETAILS

A12.01

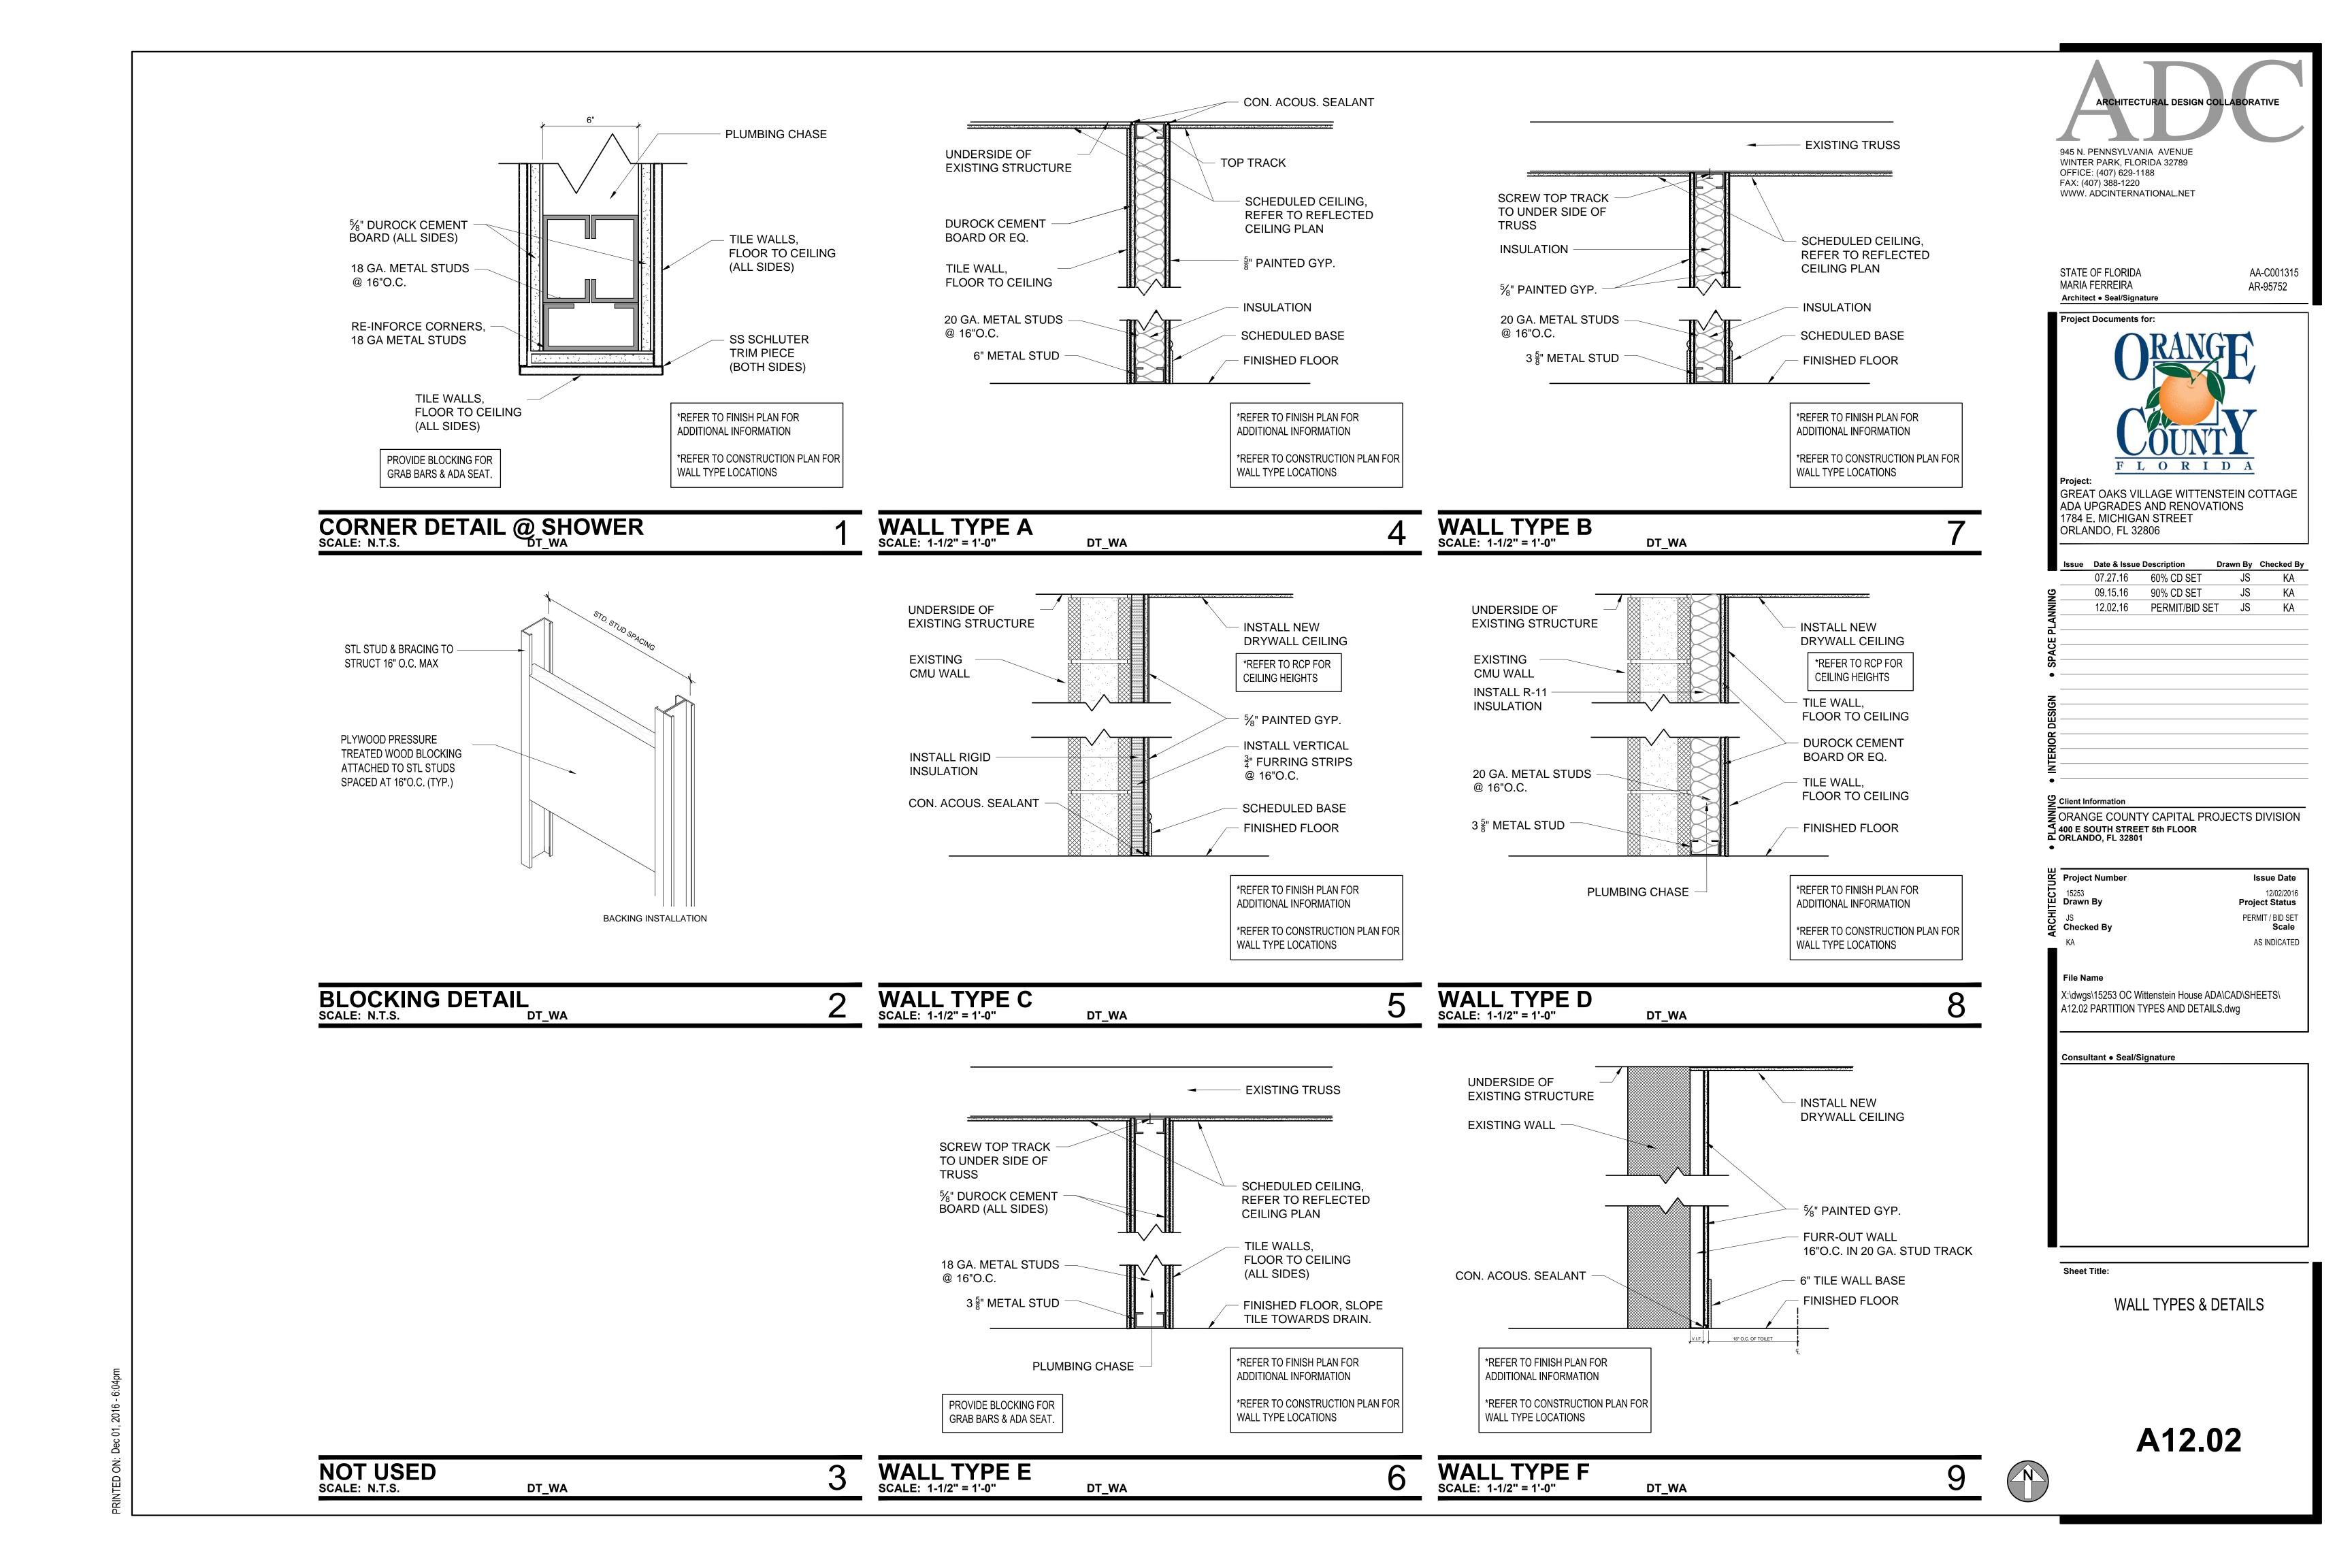

THE FIRE SUPPRESSION ENGINEERING DOCUMENTS AND BOOK SPECIFICATIONS ARE PREPARED EXCLUSIVELY FOR THIS PROJECT AND ARE IN COMPLIANCE WITH THE FOLLOWING STANDARD. THE INSTALLING CONTRACTOR IS RESPONSIBLE FOR PREPARING WORKING PLANS AND HYDRAULIC CALCULATIONS AS DEFINED BY 2010 ED. NFPA 13. THE WORKING PLANS AND HYDRAULIC CALCULATIONS SHALL BE SUBMITTED TO THE ENGINEER OF RECORD FOR REVIEW AND APPROVAL. THE APPROVED SHOP DRAWINGS AND HYDRAULIC CALCULATIONS SHALL BE SUBMITTED TO THE LOCAL AUTHORITY HAVING JURISDICTION FOR FINAL APPROVAL AND BUILDING PERMIT.

61G15-32.003 COMMON REQUIREMENTS TO ALL FIRE PROTECTION ENGINEERING DOCUMENTS. (1) THE FIRE PROTECTION SYSTEM ENGINEERING DOCUMENTS SHALL PROVIDE THE ÈNGINEERING REQUIREMENTS TO BE USED IN THE PREPARATION OF THE FIRE PROTECTION SYSTEM LAYOUT DOCUMENTS AND TO INDICATE THE NATURE AND SCOPE OF THE WORK, AND TO DESCRIBE, DETAIL, DIMENSION, LABEL AND DEFINE THE FIRE PROTECTION COMPONENTS, SYSTEM(S), MATERIALS, ASSEMBLIES, EQUIPMENT AND ITS STRUCTURAL AND UTILITY SUPPORT SYSTEM(S), INSOFAR AS THEY INVOLVE THE SAFEGUARDING OF LIFE, HEALTH OR PROPERTY. (2) THE FIRE PROTECTION SYSTEM ENGINEERING DOCUMENTS SHALL SPECIFY THE APPLICABLE REQUIREMENTS FOR THE ACCEPTANCE TESTING OF THE FIRE PROTECTION SYSTEM AND COMPONENTS, WHICH SHALL BE BASED UPON APPLICABLE CODES AND STANDARDS, WHERE AVAILABLE.

(3) THE OCCUPANCY OF THE AREA OR DESCRIPTION OF A SPECIFIC HAZARD BEING PROTECTED BY THE FIRE PROTECTION SYSTEM(S) SHALL BE SHOWN ON THE FIRE PROTECTION SYSTEM ENGINEERING DOCUMENTS.

(4) THE APPLICABLE CODE AND STANDARD TO BE USED IN THE PREPARATION OF THE FIRE PROTECTION SYSTEM LAYOUT DOCUMENTS SHALL BE SHOWN ON THE FIRE PROTECTION SYSTEM ENGINEERING DOCUMENTS. WHEN CODES AND STANDARDS ARE NOT AVAILABLE OR APPLICABLE, AND SAID LAYOUT DOCUMENTS ARE TO BE BASED ON ENGINEERING JUDGMENT, ANY REASONS AND ASSUMPTIONS MADE TO DEVELOP THE FIRE PROTECTION CONCEPT SHALL BE IDENTIFIED ON THE FIRE PROTECTION SYSTEM ENGINEERING DOCUMENTS. (5) STRUCTURAL SUPPORT AND STRUCTURAL OPENINGS REQUIRED BY THE FIRE PROTECTION SYSTEM SHALL BE SHOWN ON THE FIRE PROTECTION SYSTEM ENGINEERING DOCUMENTS AND SHALL BE REFERENCED ON STRUCTURAL ENGINEERING DOCUMENTS.

(6) WHEN LAYOUT DOCUMENTS CONTAIN MATERIAL DEVIATION FROM THE ENGINEER OF RECORD'S FIRE PROTECTION SYSTEM ENGINEERING DOCUMENT, SUCH LAYOUT DOCUMENTS ARE NOT COMPLIANT UNLESS THEY ARE ACCOMPANIED BY REVISED ENGINEERING DOCUMENTS MADE AND SEALED BY THE ENGINEER OF RECORD FOR THE FIRE PROTECTION SYSTEM.

(7) REQUIREMENTS FOR ACTIVATION CONTROL SYSTEMS, SEQUENCE, OPERATING PARAMETERS, INTERLOCKS, SAFETY RELATED DEVICES, INDICATORS AND ALARMS, SHALL BE SHOWN ON THE FIRE PROTECTION SYSTEM ENGINEERING DOCUMENTS, UNLESS SHOWN ON OTHER RELATED DOCUMENTS.

(8) ANY INFORMATION DEEMED APPROPRIATE BY THE ENGINEER OF RECORD TO ASSIST THE AUTHORITY HAVING JURISDICTION IN UNDERSTANDING THE OWNER'S INTENDED USE AND PROPOSED PROTECTION OF THE BUILDING OR FACILITY AND TO PROVIDE SUFFICIENT DIRECTION TO THE INSTALLATION CONTRACTOR OR OTHER INTERESTED PARTIES REGARDING THE LAYOUT OF THE SYSTEM(S), SHALL BE INCLUDED IN THE FIRE PROTECTION SYSTEM ENGINEERING DOCUMENTS.

SPECIFIC AUTHORITY 471.008, 471.033(2), FS LAW IMPLEMENTED 471.005(7), 471.033(2), FS

HISTORY--NEW 5-19-93, FORMERLY 21H-32.003, AMENDED 4-2-2000, 6-26-01 61G15-32.004 DESIGN OF WATER BASED FIRE PROTECTION SYSTEMS. (1) WATER BASED FIRE PROTECTION SYSTEMS INCLUDE, BUT ARE NOT LIMITED TO, AUTOMATIC SPRINKLER SYSTEMS OF WET, DRY, FINE WATER SPRAY (MIST), MANUAL, AND DELUGE VALVE CONTROLLED TYPES, PUMPING SYSTEMS, STANDPIPES, FIRE WATER MAINS AND DEDICATED FIRE PROTECTION WATER SOURCES.

(2) TO ENSURE MINIMUM DESIGN QUALITY IN FIRE PROTECTION SYSTEM ENGINEERING DOCUMENTS, SAID DOCUMENTS SHALL INCLUDE AS A MINIMUM THE FOLLOWING INFORMATION WHEN APPLICABLE:

(A) THE POINT OF SERVICE FOR THE FIRE PROTECTION WATER SUPPLY AS DEFINED BY 633.021(18) F.S.

(B) APPLICABLE NFPA STANDARD TO BE APPLIED, OR IN THE CASE WHERE NO SUCH STANDARD EXISTS, THE ENGINEERING STUDY, JUDGMENTS, AND/OR PERFORMANCE BASED ANALYSIS AND CONCLUSIONS.

(C) CLASSIFICATION OF HAZARD OCCUPANCY FOR EACH ROOM OR AREA. (D) DESIGN APPROACH, WHICH INCLUDES SYSTEM TYPE, DENSITIES, DEVICE TEMPERATURE RATING, AND SPACING FOR EACH SEPARATE HAZARD OCCUPANCY.

(E) CHARACTERISTICS OF WATER SUPPLY TO BE USED, SUCH AS MAIN SIZE AND LOCATION, WHETHER IT IS DEAD-END OR CIRCULATING; AND IF DEAD-END, THE DISTANCE TO THE NEAREST CIRCULATING MAIN, AS WELL AS ITS MINIMUM DURATION AND RELIABILITY FOR THE MOST HYDRAULICALLY DEMANDING DESIGN AREA.

(F) WHEN PRIVATE OR PUBLIC WATER SUPPLIES ARE USED, THE FLOW TEST DATA, INCLUDING DATE AND TIME OF TEST, WHO CONDUCTED TEST OR SUPPLIED INFORMATION, TEST ELEVATION, STATIC GAUGE PRESSURE AT NO FLOW, FLOW RATE WITH RESIDUAL GAUGE PRESSURE, HYDRANT FLOW COEFFICIENT, AND LOCATION OF TEST IN RELATION TO THE HYDRAULIC POINT OF SERVICE.

(G) VALVING AND ALARM REQUIREMENTS TO MINIMIZE POTENTIAL FOR IMPAIRMENTS AND UNRECOGNIZED FLOW OF WATER.

(H) MICROBIAL INDUCED CORROSION (MIC). THE ENGINEER OF RECORD SHALL MAKE REASONABLE EFFORTS TO IDENTIFY WATER SUPPLIES THAT COULD LEAD TO MICROBIAL INDUCED CORROSION (MIC). SUCH EFFORTS MAY CONSIST OF DISCUSSIONS WITH THE LOCAL WATER PURVEYOR AND/OR FIRE OFFICIAL, FAMILIARITY WITH CONDITIONS IN THE LOCAL AREA, OR LABORATORY TESTING OF WATER SUPPLIES. WHEN CONDITIONS ARE FOUND THAT MAY RESULT IN MIC CONTAMINATION OF THE FIRE PROTECTION PIPING, THE ENGINEER SHALL DESIGN CORRECTIVE MEASURES.

(I) BACKFLOW PREVENTION AND METERING SPECIFICATIONS AND DETAILS TO MEET LOCAL WATER PURVEYOR REQUIREMENTS INCLUDING MAXIMUM ALLOWABLE PRESSURE DROP. (J) QUALITY AND PERFORMANCE SPECIFICATIONS OF ALL YARD AND INTERIOR FIRE PROTECTION COMPONENTS.

(3) CONTRACTOR SUBMITTALS WHICH DEVIATE FROM THE ABOVE MINIMUM DESIGN PARAMETERS SHALL BE CONSIDERED MATERIAL DEVIATIONS AND REQUIRE SUPPLEMENTAL ENGINEERING APPROVAL AND DOCUMENTATION.

(4) IN THE EVENT THE ENGINEER OF RECORD PROVIDES MORE INFORMATION AND DIRECTION THAN IS ESTABLISHED ABOVE, HE OR SHE SHALL BE HELD RESPONSIBLE FOR THE TECHNICAL ACCURACY OF THE WORK IN ACCORDANCE WITH APPLICABLE CODES, STANDARDS, AND SOUND ENGINEERING PRINCIPLES. SPECIFIC AUTHORITY 471.008, 471.033(2), FS

LAW IMPLEMENTED 471.005(7), 471.033(2), FS HISTORY--NEW 5-19-93, FORMERLY 21H-32.004, AMENDED 4-2-2000, 6-26-01, 7–12–05

## FIRE PROTECTION LEGEND

#### **DESCRIPTION**

<u>SYMBOL</u>

____

×××××××

NEW 160° \" SPRINKLER (MATCH EXISTING) RELOCATED 160° \" SPRINKLER EXISTING 160° \" SPRINKLER NEW SPRINKLER PIPING EXISTING SPRINKLER PIPING EXISTING SPRINKLER PIPING TO BE REMOVED CONNECT TO EXISTING

### FIRE PROTECTION ABREVIATIONS

ABOVE FINISHED FLOOR	AFF
BELOW FINISHED GRADE	BFG
BELOW FINISHED FLOOR	BFF
CONTINUATION	CONT
CONNECTION	CONN
DIAMETER	DIA
DOWN	DN
DRAWING	DWG
NOT IN CONTRACT	NIC
NOT TO SCALE	NTS
REDUCED PRESSURE BACKFLOW PREVENTER	RPBP
SQUARE FEET	SF
UNLESS NOTED OTHERWISE	U.N.O.

### FIRE SPRINKLER HEAD LEGEND

SYMBOL	ORF	TEMP	RESPONSE	K-FAC	FINISH	MODEL	STYLE	PLATE	MFG.
•	*	155 <b>°</b>	*	*	BRASS	*	RECESSED	WHITE	*

* = ALL NEW AND/OR REPLACED EXISTING SPRINKLERS SHALL MATCH THE CHARACTERISTICS OF THE EXISTING SPRINKLERS.

#### FIRE PROTECTION LEGEND

•	NEW 160° PENDENT SPRINKLER
0	NEW 160° UPRIGHT SPRINKLER
۲	EXISTING SPRINKLER TO REMAIN
	NEW SPRINKLER PIPING
	EXISTING SPRINKLER PIPING
<del>×××××××</del>	EXISTING SPRINKLER PIPING TO BE REMOVED

NEW SPRINKLER SYSTEM WILL BE HYDRAULICALLY DESIGNED FOR LIGHT HAZARD OCCUPANCY.

OCCUPANCY CLASSIFICATION: SYSTEM TYPE: DESIGN DENSITY: HYDRAULIC REMOTE AREA: SPRINKLER ORIFICE SIZE: DURATION OF SUPPLY: HOSE STREAM ALLOWANCE:

OCCUPANCY CLASSIFICATION: SYSTEM TYPE: DESIGN DENSITY: HYDRAULIC REMOTE AREA: SPRINKLER ORIFICE SIZE: DURATION OF SUPPLY: MAXIMUM COVERAGE/SPRINKLER HEAD: HOSE STREAM ALLOWANCE:

FLOW TEST INFORMATION: FLOW TEST DATE: 7/22/2016 HYDRANT: P14684 STATIC PRESSURE: 64 PSI

FLOW: 1140 GPM

**DESIGN CRITERIA:** 

WATER SUPPLY NOTES:

GENERAL NOTES:

MFG.

GUARDS

### FIRE PROTECTION DATA

OCCUPANCY CLASSIFICATIONS AS NOTED ON PLANS

MAXIMUM COVERAGE/SPRINKLER HEAD:

**RESIDUAL PRESSURE: 46 PSI** 

- THE FOLLOWING PUBLICATIONS SHALL BE USED AS A REFERENCE FOR DESIGN OF THE FIRE SUPPRESSION SYSTEM ON THIS PROJECT.
- 1. NFPA 13 (2010 ED.), STANDARD FOR THE INSTALLATION OF SPRINKLER SYSTEMS.
- 2. NFPA 24 (2010 ED.), STANDARD FOR THE INSTALLATION OF PRIVATE FIRE SERVICE MAINS AND THEIR APPURTENANCES.

1. THE EXISTING WATER SUPPLY HAS NO REPORTED CASES OF M.I.C. - THE WATER SYSTEM IS TREATED WITH A CURROSION INHIBITOR.

- 1. THE FIRE PROTECTION SYSTEMS SHALL COMPLY WITH THE ABOVE REFERENCED NFPA STANDARDS AND ALL STATE AND LOCAL CODES AND REQUIREMENTS.
- 2. FINAL SYSTEM ACCEPTANCE AND APPROVAL SHALL BE CONDUCTED BY THE LOCAL AHJ AND THE ARCHITECT/ENGINEER.
- 3. CONTRACTOR'S SPRINKLER SYSTEM LAYOUT (SHOP DRAWINGS), HYDRAULIC CALCULATIONS AND MATERIAL DATA SHALL BE SUBMITTED TO THE ARCHITECT/ENGINEER AND STATE FIRE MARSHALL FOR APPROVAL PRIOR TO SYSTEM INSTALLATIÓN.
- 4. THE FIRE PROTECTION SYSTEMS SHOWN REPRESENT THE DESIGN INTENT OF THE ENGINEER OF RECORD, IN ACCORDANCE WITH STATE REGULATION 61G15-32. IT IS THE RESPONSIBILITY OF THE CONTRACTOR TO COORDINATE INSTALLATION WITH ALL OTHER TRADES. THE CONTRACTOR SHALL PROVIDE COMPLETE SPRINKLER SYSTEM LAYOUT DRAWINGS WITH ANY ADDITIONAL OFFSETS, SPRINKLERS OR SYSTEM COMPONENTS AS REQUIRED FOR A COMPLETE AND OPERABLE SYSTEM AND TO AVOID CONFLICTS WITH OTHER TRADES.
- 5. SEE ARCHITECTURAL REFLECTED CEILING PLANS FOR CEILING TYPES. HEIGHTS AND ALL ASSOCIATED DATA.
- 6. PROVIDE FIRE STOP ASSEMBLIES FOR ALL PENETRATIONS OF SMOKE/FIRE WALLS, CEILINGS AND FLOORS. FIRE STOP ASSEMBLIES SHALL MEET ASTM E-814. SEE FIRE RATED PIPE PENETRATION DETAILS.
- 7. ALL DRAIN AND DRY PIPE SYSTEM PIPING AND FITTINGS SHALL BE GALVANIZED BOTH INSIDE AND OUTSIDE.
- 8. INSTALL ADDITIONAL SPRINKLERS UNDER ALL EXPOSED DUCTWORK OR OBSTRUCTIONS OR COMBINATIONS OF OBSTRUCTIONS EXCEEDING 48" IN WIDTH. PROVIDE ADDITIONAL SPRINKLERS AS REQUIRED FOR PROPER COVERAGE OF OBSTRUCTIONS IN ACCORDANCE WITH NFPA 13.
- 9. ALL SPRINKLER HEADS INSTALLED WITHIN MECHANICAL ROOMS, STORAGE ROOMS, JANITORS CLOSETS OR AREAS SUBJECT TO MECHANICAL INJURY SHALL BE PROTECTED WITH LISTED
- 10. COORDINATE PIPE ROUTING WITH DUCT ROUTING, EQUIPMENT LOCATIONS, ELECTRICAL INSTALLATIONS AND BUILDING STRUCTURAL MEMBERS. DO NOT ROUTE PIPING OVER ELECTRICAL PANELS. PIPING ROUTED OVER ELECTRICAL PANELS SHALL BE REROUTED AT NO ADDITIONAL COST.
- 11. PROVIDE TAMPER SWITCHES ON ALL CONTROL VALVES.
- 12. SLOPE ALL PIPING TO THE SYSTEM MAIN DRAIN AS REQUIRED TO INSURE PROPER DRAINAGE. IT IS THE CONTRACTOR'S RESPONSIBILITY TO INSURE THAT ALL PIPING IS DRAINABLE. ADDITIONAL DRAINS AND PLUGS SHALL BE INSTALLED WHERE REQUIRED TO COMPLY WITH THE ABOVE REFERENCED CODES.
- 13. ALL ROLL GROOVED AND CUT GROOVED COUPLINGS AND FITTINGS SHALL BE PROVIDED BY A SINGLE MANUFACTURER.
- 14. SPRINKLERS SHALL BE CENTERED IN CEILING TILES IN AREAS WITH LAY-IN TILES AND VISUALLY ALIGNED IN AREAS WITH SMOOTH CEILINGS.
- 15. THIS PROJECT INVOLVES THE ADDITION AND/OR ALTERATION OF 49 OR LESS SPRINKLERS. AS PERMITTED BY STATE STATUE 553.79 AND 633.021, A STATE LICENSED SPRINKLER CONTRACTOR SHALL DESIGN THE REQUIRED SPRINKLER DRAWINGS AND HYDRAULIC CALCULATIONS. DRAWINGS AND CALCULATIONS SHALL BE SUBMITTED FOR REVIEW AND APPROVAL BY THE AHJ PRIOR TO INSTALLATION.

LIGHT HAZARD WET PIPE .10 GPM/SQ. FT. 1,500 SQ. FT. 1/2" 30 MIN. 225 SQ. FT. 100 GPM

ORDINARY HAZARD GROUP I ≪H> WET PIPE .15 GPM/SQ. FT. 1,500 SQ. FT. 1/2" 60 - 90 MIN. 130 SQ. FT. 250 GPM

ARC	HITECTURAL	. DESIGN CO	LLABORATIVE	
945 N. PENNS WINTER PAR OFFICE: (407) FAX: (407) 388 WWW. ADCIN	K, FLORIDA 3 ) 629-1188 3-1220	32789		
Project Docu	ments for:	ANG N UN' R I		

> **GREAT OAKS VILLAGE WITTENSTEIN COTTAGE** ADA UPGRADES AND RENOVATIONS 1784 E. MICHIGAN STREET ORLANDO, FL 32806


	Issue	Date & Issue	e Description	Drawn By	Checked By		
		07.27.16	60% CD SET	JS	KA		
ŋ		09.15.16	90% CD SET	JS	KA		
SPACE PLANNING		12.02.16	PERMIT/BID SE	t JS	KA		
P							
Ч							
AC							
S							
•							
ž							
INTERIOR DESIGN							
ŠDE							
<b>PIO</b>							
TER							
Z							
•							
۶U S	Sclient Information ORANGE COUNTY CAPITAL PROJECTS DIVISION						
Ņ	ORAN	GE COUN ⁻	TY CAPITAL PRO	OJECTS	DIVISION		

400 E SOUTH STREET 5th FLOOR GORLANDO, FL 32801

URE	Project Numbe
TECT	15253 <b>Drawn By</b>
CHI	WRH
ARCI	<b>Checked By</b> JEB
_	

Issue Date 12/02/2016 Project Status PERMIT / BID CD SET Scale AS NOTED


**File Name** 

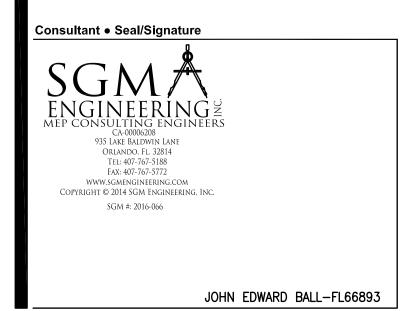

Sheet Title:

### Fire Protection Symbols Legend and General Notes

## F0.01

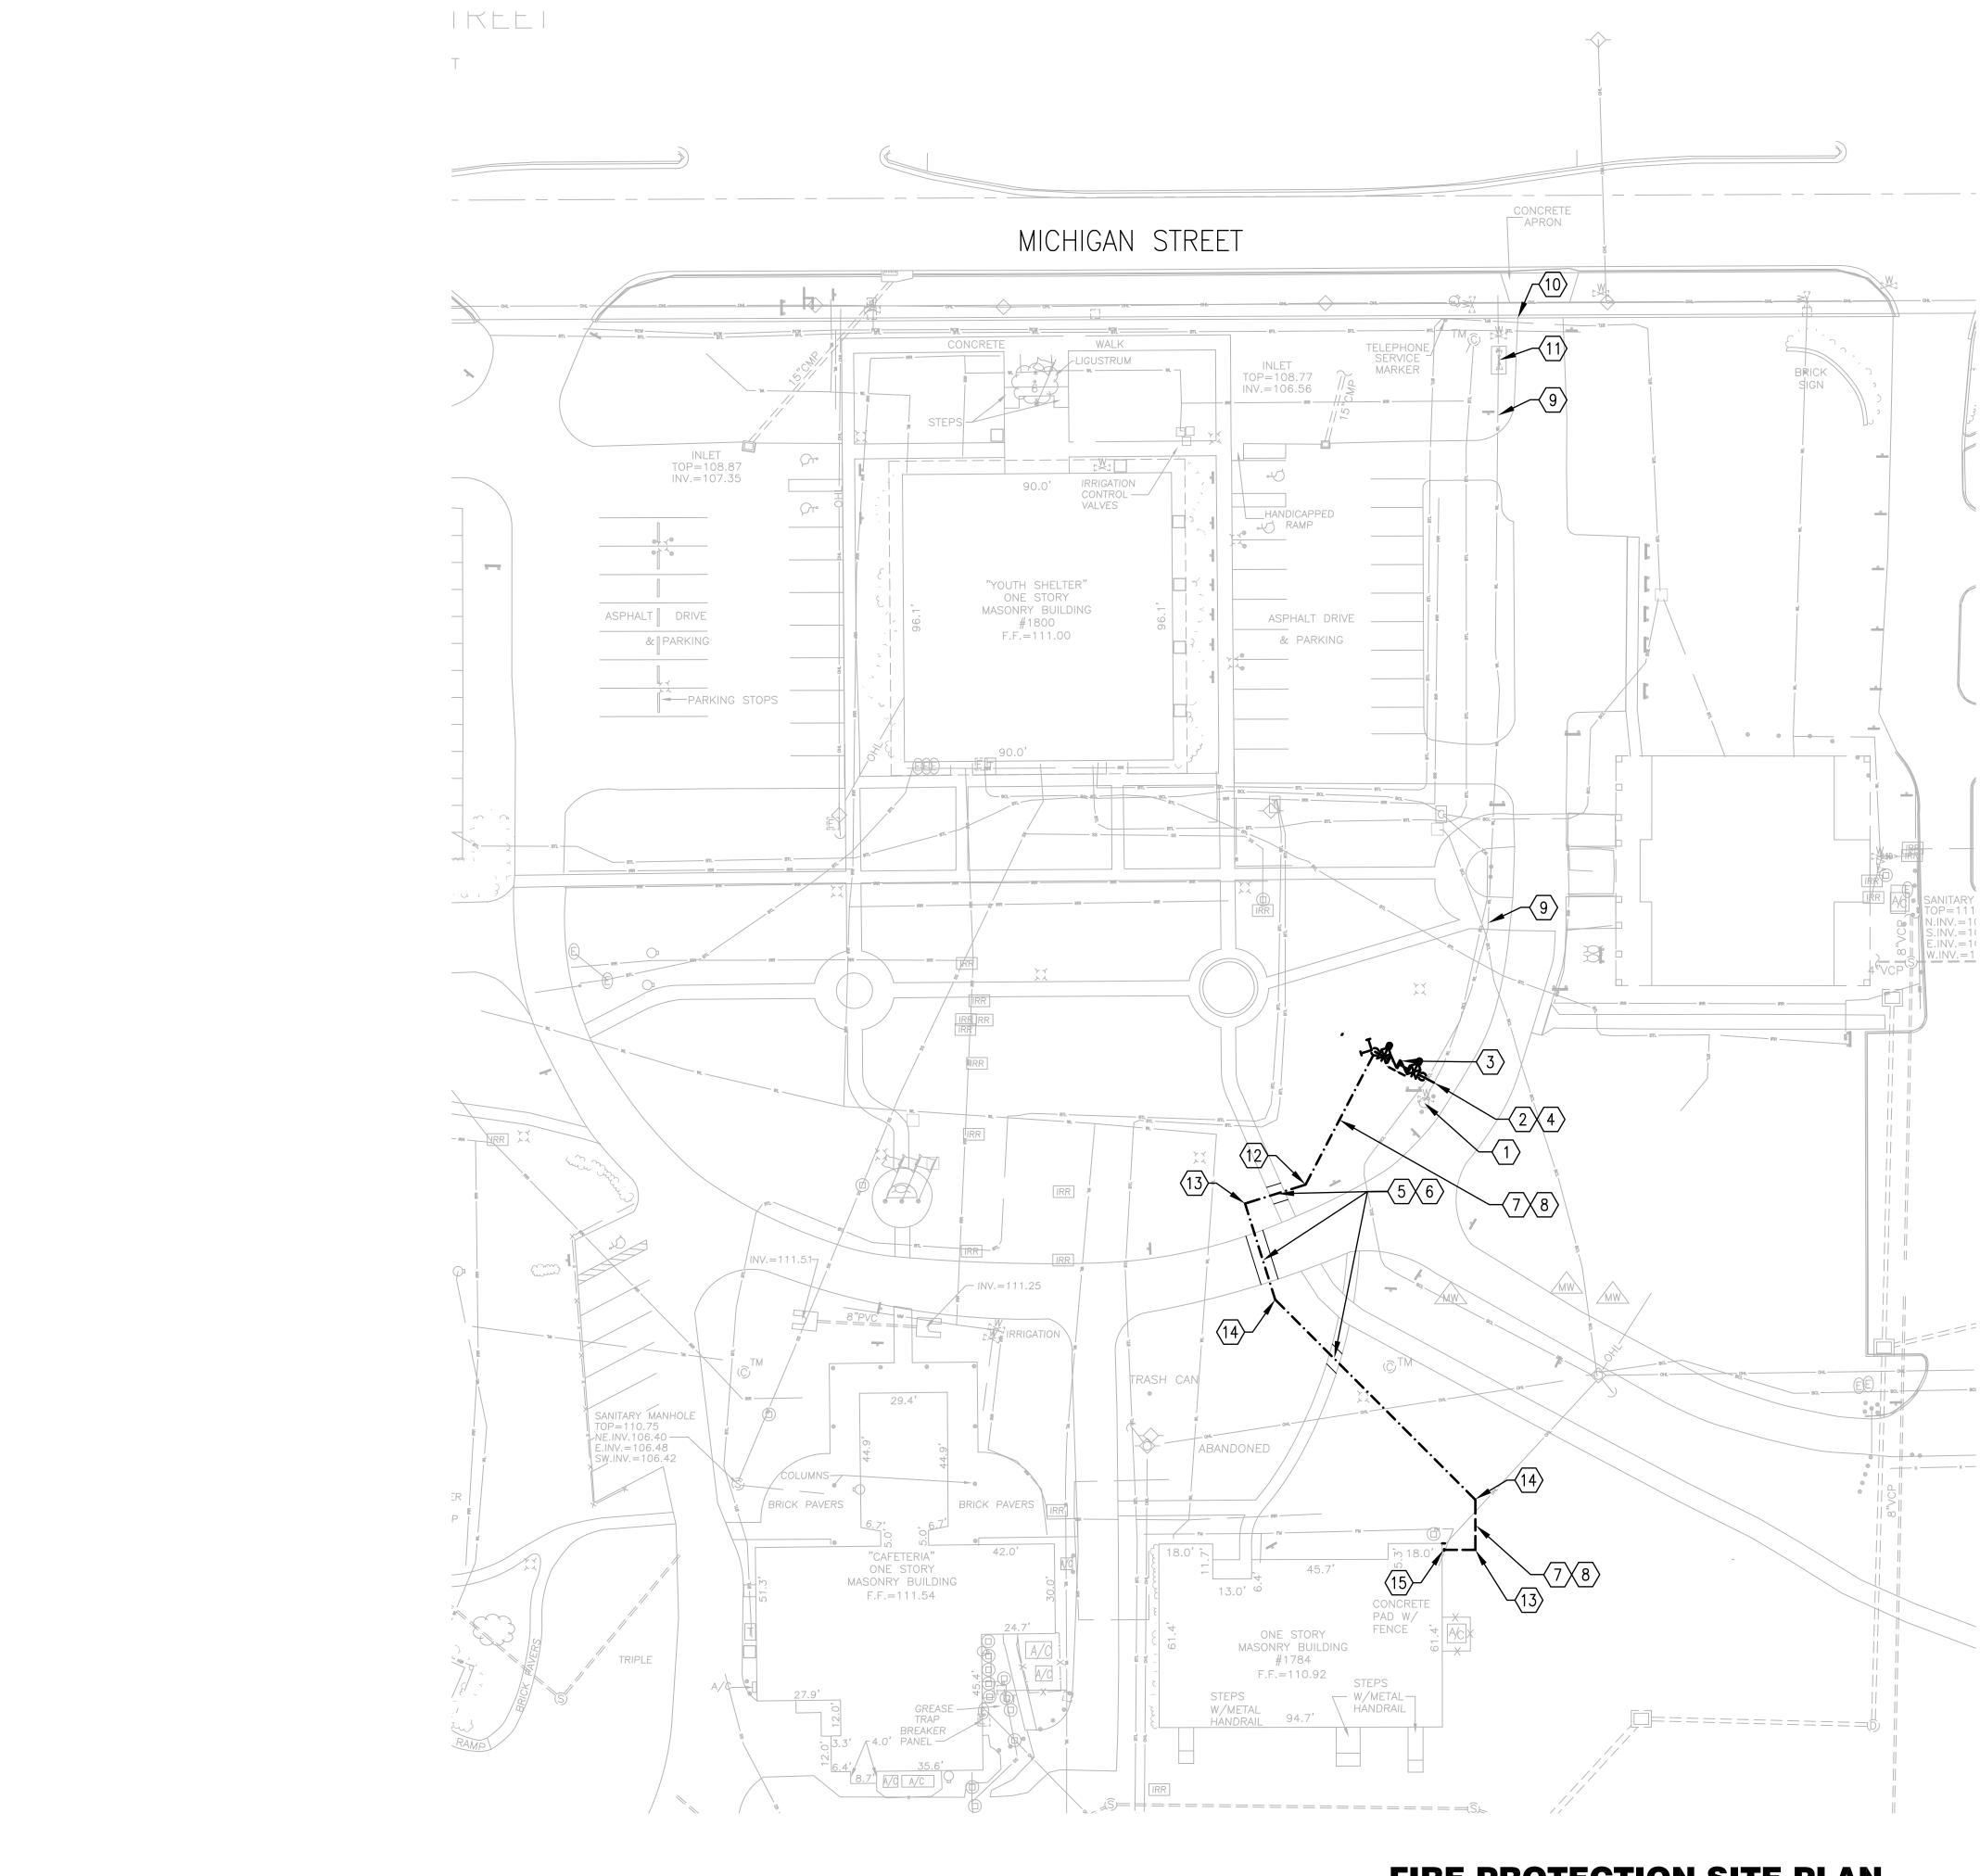

**FIRE PROTECTION SITE PLAN** SCALE: 1"=30' 0 15' 30' 60

### **GENERAL NOTES:**

- a. ALL FIRE PROTECTION PIPING AND EQUIPMENT SHALL BE INSTALLED IN ACCORDANCE WITH THE FLORIDA BUILDING CODE 5TH EDITION (2014) AND NFPA 24-2010 REQUIREMENTS.
- b. THE SUBSURFACE INFORMATION FOR THIS PROJECT MAY NOT BE AN ADEQUATE REPRESENTATION OF ACTUAL CONDITIONS FOR PROJECT CONSTRUCTION. THE CONTRACTOR SHALL FIELD VERIFY ALL EXISTING UTILITIES WITHIN CONSTRUCTION AREA. ANY CONFLICTS WITH EXISTING UTILITIES SHALL BE BROUGHT TO THE IMMEDIATE ATTENTION OF THE ENGINEER. SURVEY INFORMATION TO VERIFY EXISTING UTILITIES, LOCATION, DEPTH, HAS NOT BEEN PROVIDED. SURVEY IN PROGRESS.
- c. AN APPROVED WATER SUPPLY CAPABLE OF SUPPLYING THE REQUIRED FIRE FLOW FOR FIRE PROTECTION SHALL BE PROVIDED TO ALL PREMISES UPON WHICH FACILITIES, BUILDINGS, OR PORTIONS OF BUILDINGS ARE HEREAFTER CONSTRUCTED OR MOVED INTO THE JURISDICTION.
- d. ALL PIPE CROSSINGS SHALL MEET FDEP REQUIREMENTS. SEE GENERAL NOTES SHEET FOR SEPARATION REQUIREMENTS.
- e. PAINTING EXPOSED WATER PIPING, VALVES AND FITTINGS:
- e.1. PAINT ALL EXTERIOR ABOVEGROUND SURFACES OF THE DOMESTIC WATER PIPE RISERS, ELBOWS OR BENDS, AND ADJUSTABLE PIPE SUPPORTS WITH OSHA BLUE
- e.2. PAINT ALL EXTERIOR ABOVEGROUND SURFACES OF THE FIRE WATER PIPE RISERS, ELBOWS OR BENDS, AND ADJUSTABLE PIPE SUPPORTS WITH OSHA RED.
- e.3. PAINT ALL EXTERIOR ABOVEGROUND SURFACES OF THE IRRIGATION WATER PIPE RISERS, ELBOWS OR BENDS, AND ADJUSTABLE PIPE SUPPORTS WITH PANTONE PURPLE 522C.
- e.4. DO NOT PAINT ANY GLASS PARTS, MECHANICAL STEMS, PVC, INFORMATION TAGS AND BRASS PARTS AND FITTINGS.

1. EXISTING FIRE HYDRANT.

- 2. CONNECT TO EXISTING YARD PIPING WITH 6"x4" TAPPING SLEEVE AND VALVE PER CITY OF ORLANDO ENGINEERING SPECIFICATIONS. CONTRACTOR SHALL VERIFY SIZE, TYPE, LOCATION, AND DEPTH OF EXISTING YARD PIPING.
- 3. CONTRACTOR SHALL PROVIDE AN OUC APPROVED REDUCED PRESSURE DETECTOR ASSEMBLY (RPDA) WITH A FIRE DEPARTMENT CONNECTION (2-WAY).
- 4. CONTRACTOR SHALL VERIFY EXISTING FIRE HYDRANT SHUTOFF VALVE IS DOWNSTREAM OF THE POINT OF CONNECTION.
- 5. CONTRACTOR SHALL COORDINATE WITH THE OWNER FOR ANY DISRUPTIONS TO ROADWAYS, SIDEWALKS, AND PATHS, AT LEAST 72 HOURS IN ADVANCE.
- 6. OPEN CUT EXISTING PAVEMENT, SIDEWALKS, AND PATHS AS NECESSARY FOR INSTALLATION OF THE FIRE PROTECTION MAIN AS SHOWN. CONTRACTOR SHALL RESTORE CONDITIONS TO BETTER OR EQUAL TO EXISTING CONDITIONS.
- 7. OPEN CUT EXISTING GROUND AS NECESSARY FOR INSTALLATION OF THE FIRE PROTECTION MAIN AS SHOWN. CONTRACTOR SHALL RESTORE CONDITIONS TO BETTER OR EQUAL TO EXISTING CONDITIONS.
- 8. 4" UNDERGROUND FIRE PROTECTION MAIN.
- 9. EXISTING FIRE MAIN.
- 10. EXISTING FIRE MAIN POINT OF CONNECTION.
- 11. EXISTING FIRE MAIN CONTROL VALVES.
- 12. 4" 45° ELBOW.
- 13. 4"90°ELBOW.
- 14. 4"22-1/2°ELBOW.
- 15. SEE DRAWING F1.01 FOR CONTINUATION.

Project	t Documents	for:		
Project GREA ADA L		RAN OUN COUN L O R I	NSTEIN CO	OTTAGE
	E. MICHIGA NDO, FL 32	AN STREET 2806		
Issue	Date & Issue 07.27.16	Description	Drawn By JS	
2	07.27.16	60% CD SET 90% CD SET	JS	KA KA
	12.02.16	PERMIT/BID S	ET JS	KA
5				
2				
5				
<u> </u>				
E ORAN	CHE COUNT			
400 E S ORLAN Project 15253 Drawn WRH Check	OUTH STRE IDO, FL 3280	TY CAPITAL PF ET 5th FLOOR 1	ls Proje	ssue Date 12/02/2016 ect Status / BID CD SET Scale
400 E S - ORLAN	SOUTH STRE IDO, FL 3280 St Number n By Ked By	ET 5th FLOOR	ls Proje	ssue Date 12/02/2016 ect Status / BID CD SET
400 E S ORLAN Projec 15253 Drawn WRH Check JEB	SOUTH STRE IDO, FL 3280 St Number n By Ked By	ET 5th FLOOR	ls Proje	ssue Date 12/02/2016 ect Status / BID CD SET Scale
400 E S ORLAN Project 15253 Drawn WRH Check JEB File Na Consu	SOUTH STRE IDO, FL 3280 at Number By	Signature	ls Proje	ssue Date 12/02/2016 ect Status / BID CD SET Scale
400 E S ORLAN Project 15253 Drawn WRH Check JEB File Na Consu	Consulting South Stree IDO, FL 3280 The By ame ame State By State By State By State By State By State By State By State By State State State State State State State State State State State State	Signature	ls Proje	ssue Date 12/02/2016 ect Status / BID CD SET Scale
400 E S ORLAN Project 15253 Drawn WRH Check JEB File Na Consu	Consulting South Stree IDO, FL 3280 The By ame ame State By State By State By State By State By State By State By State By State State State State State State State State State State State State	Signature Signature Signat	ls Proje	ssue Date 12/02/2016 ect Status / BID CD SET Scale AS NOTED
400 E S ORLAN Project 15253 Drawn WRH Check JEB File Na Consu	Consulting South Stree IDO, FL 3280 Ct Number By Red By ame State By Consulting Consulting Consulting Consulting State Balow ORLANDO, FL Seal/S Consulting South State South State State States States State	Signature Signature Signat	le Proje PERMIT	ssue Date 12/02/2016 ect Status / BID CD SET Scale AS NOTED


F1.00

ARCHITECTURAL DESIGN COLLABORATIVE

945 N. PENNSYLVANIA AVENUE WINTER PARK, FLORIDA 32789

OFFICE: (407) 629-1188




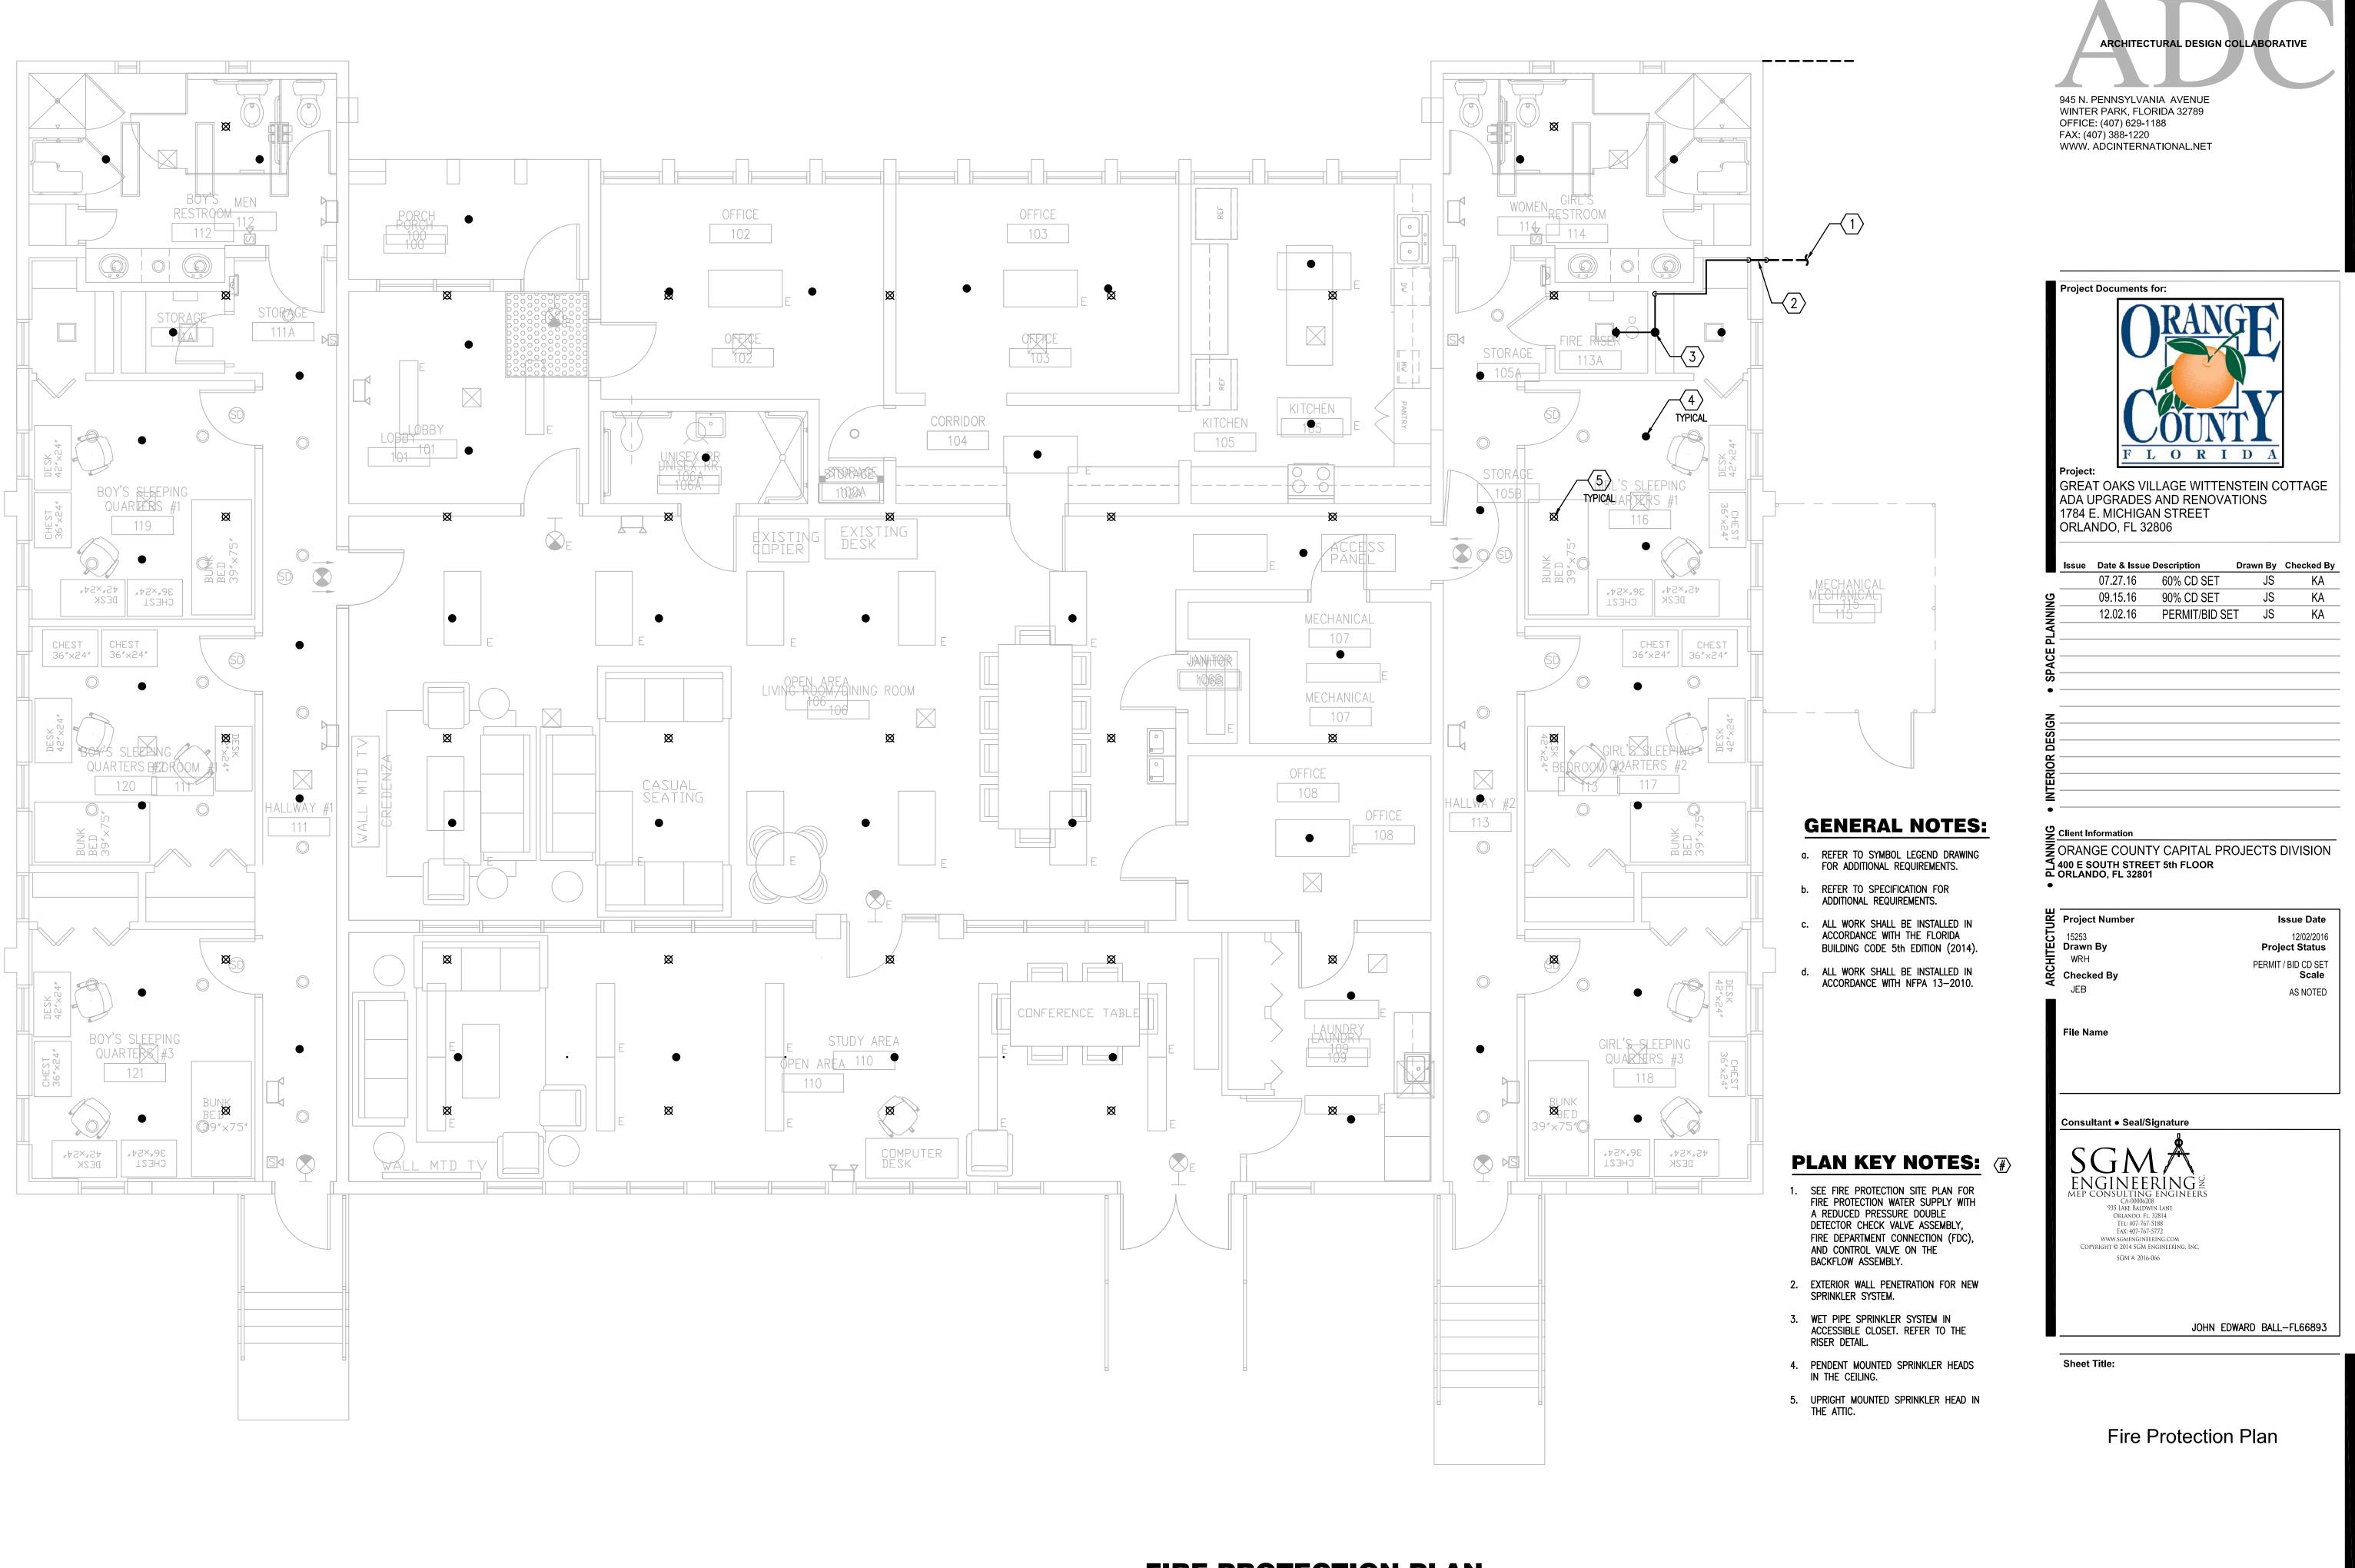


FIRE PROTECTION PLAN SCALE: 1/4"=1'-0" 0 2' 4'


7


## F1.01

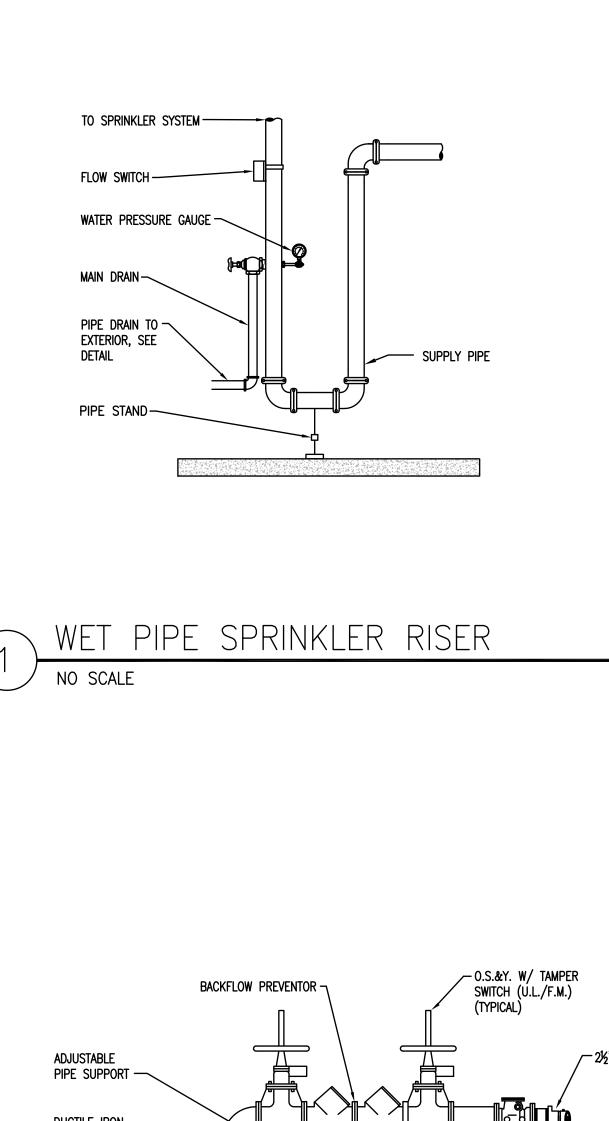

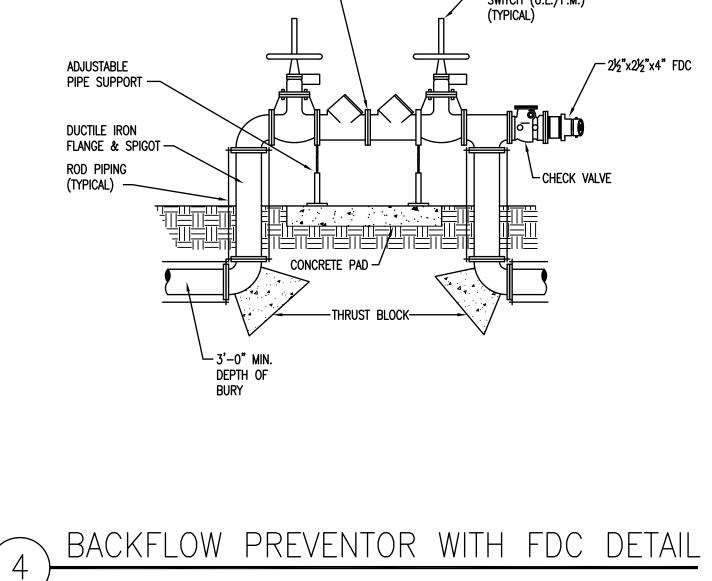


NO SCALE

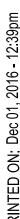

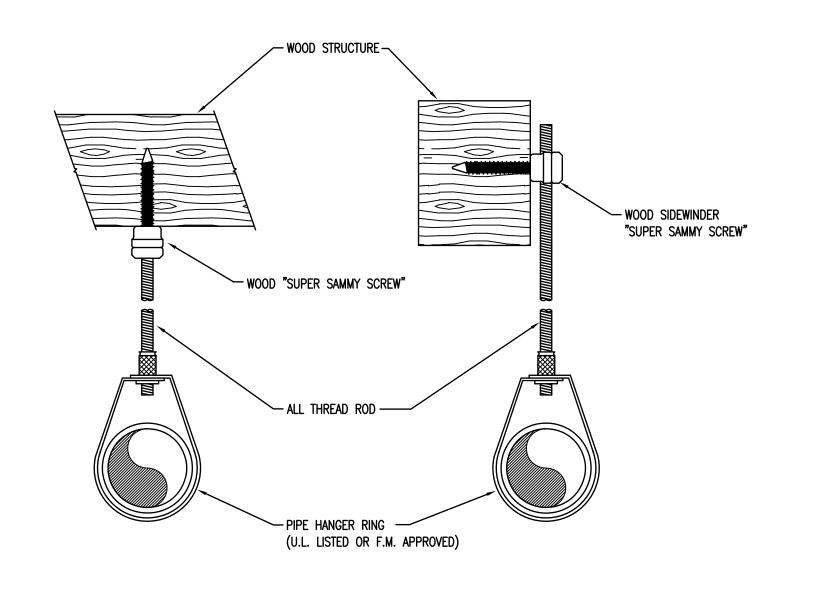





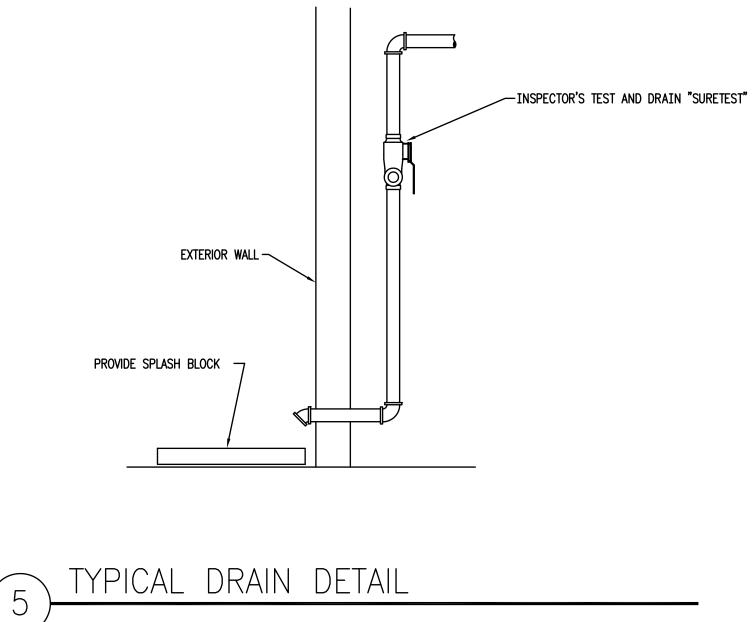

NO SCALE

	ARCHITECTURAL DESIGN COLLABORATIVE 945 N. PENNSYLVANIA AVENUE WINTER PARK, FLORIDA 32789 OFFICE: (407) 629-1188 FAX: (407) 388-1220 WWW. ADCINTERNATIONAL.NET
1" 90' ELL I" 90' ELL BRANCH LINE REDUCER CEILING SPRINKLER HEAD	<image/> <section-header><section-header><section-header><section-header><section-header></section-header></section-header></section-header></section-header></section-header>
MOUNTING DETAIL	Issue         Date & Issue Description         Drawn By         Checked By           07.27.16         60% CD SET         JS         KA           09.15.16         90% CD SET         JS         KA           12.02.16         PERMIT/BID SET         JS         KA
	O9.15.16         90% CD SET         JS         KA           12.02.16         PERMIT/BID SET         JS         KA
	• ORANGE COUNTY CAPITAL PROJECTS DIVISION 400 E SOUTH STREET 5th FLOOR ORLANDO, FL 32801 •
	Project Number Issue Date 15253 12/02/2016 Drawn By Project Status WRH PERMIT / BID CD SET Checked By Scale JLM AS NOTED File Name
	<section-header><section-header><section-header><section-header><section-header><section-header><section-header><section-header><text></text></section-header></section-header></section-header></section-header></section-header></section-header></section-header></section-header>
	JOHN EDWARD BALL-FL66893
	Sheet Title: Fire Protection Details
	F5.01

### **ABBREVIATIONS**

CW

HWR

DWV

A.W.

COND.

VTR

CO

WCO

FCO

**ECO** 

B.V.

AB.

DN.

CLG

MIN. C.P.

S.S.

SL.

GA.

BLDG.

CONN.

EXIST.

A.H.A.P.

A.F.F.

F.F.E.

I.E.

FD H.D.

RD

ST

STO

HB

NFWH

COLD WATER HOT WATER
HOT WATER RETURN LIQUID PROPANE
DRAIN, WASTE, AND VENT
WASTE
ACID WASTE
CONDENSATE
VENT
VENT THRU ROOF CLEANOUT
WALL CLEANOUT
FLOOR CLEANOUT
EXTERIOR CLEANOUT (GRADE)
BALANCING VALVE
ABOVE
DOWN
CEILING
MINIMUM CHROME PLATED
STAINLESS STEEL
SLOPE
GAUGE
BUILDING
CONNECTION
EXISTING AS HIGH AS POSSIBLE
ABOVE FINISHED FLOOR
FINISHED FLOOR ELEVATION
INVERT ELEVATION
FLOOR DRAIN
HUB DRAIN
ROOF DRAIN
STORM DRAIN STORM DRAIN OVERFLOW
HOSE BIBB
NON-FREEZE WALL HYDRANT

— — — — GW— — — — — — — AW— — — — ____AW______ _____ _____ _____ _____ — — — — ST — — — — _____ST_____ _____STO______ _____ _____ _____ _____ _____ — I P——— 0<del>.</del>____ ı**|_____** Ø_____ _____ -------• (FXXX) PXXX

### LEGEND

SOIL OR WASTE LINE (BELOW GRADE) SOIL OR WASTE LINE (ABOVE GRADE) GREASE WASTE PIPING (BELOW GRADE) ACID WASTE PIPING (BELOW GRADE) ACID WASTE PIPING (ABOVE GRADE) CONDENSATE DRAIN PIPING VENT PIPING EXISTING WASTE PIPING (BELOW GRADE) EXISTING WASTE PIPING (ABOVE GRADE) EXISTING VENT PIPING STORM DRAIN PIPING (BELOW GRADE) STORM DRAIN PIPING (ABOVE GRADE) STORM DRAIN OVERFLOW (ABOVE GRADE) DOMESTIC COLD WATER PIPING HOT WATER PIPING HOT WATER RETURN PIPING EXISTING COLD WATER PIPING EXISTING HOT WATER PIPING EXISTING HOT WATER RETURN PIPING LIQUID PROPANE PIPING TRAP 2-WAY CLEANOUT (ECO) CLEANOUT (CO/WCO) FLOOR CLEANOUT (FCO) TWO PIECE, FULL PORT BALL VALVE SWING CHECK VALVE GATE VALVE VERTICAL SHUT-OFF VALVE (GATE) CIRCUIT SETTER TYPE BALANCING VALVE CIRCULATOR PUMP (VERTICAL) INDICATES NEW CONNECTION TO EXISTING UTILITIES INDICATES RISER/DETAIL NUMBER, SHEET FOUND, AND RISER VIEW, (IF APPLICABLE)

## **GENERAL PLUMBING DEMOLITION NOTES**

- CONTRACTOR SHALL FIELD VERIFY EXACT LOCATIONS AND SIZES OF EXISTING 1. SERVICES SHOWN ON DRAWINGS PRIOR TO PRICING, FABRICATION, OR CONSTRUCTION. CONTRACTOR SHALL FIELD LOCATE ALL OTHER EXISTING EQUIPMENT, FIXTURES, AND SERVICES IN THE AREA OF THIS PROJECT.
- CONTRACTOR SHALL VERIFY INVERT ELEVATIONS OF SEWERS TO WHICH NEW SEWER LINES ARE TO BE CONNECTED BEFORE INSTALLATION OF NEW SEWER LINE.
- 3. CONTRACTOR TO REPAIR SLAB TO PRECONSTRUCTION CONDITIONS AFTER TRENCH CUTTING THE SLAB AS REQUIRED FOR SANITARY SEWER INSTALLATION.

### **GENERAL PLUMBING NOTES**

- 1. REFERENCE THE SPECIFICATIONS FOR MATERIALS AND EQUIPMENT STANDARDS.
- THE INSTALLATION OF THE PLUMBING SYSTEMS AND EQUIPMENT SHALL COMPLY WITH ALL 2. APPLICABLE CODES INCLUDING BUT NOT LIMITED TO THE 2014 FLORIDA BUILDING CODE AND 2014 FLORIDA PLUMBING CODE.
- 3. THE CONTRACTOR SHALL COORDINATE THE INTERRUPTION OF ALL UTILITY SERVICES WITH OWNER'S REPRESENTATIVE. PROVIDE A MINIMUM OF FIVE WORKING DAYS ADVANCED NOTICE, OR PER PLUMBING SPECIFICATIONS, OF SCHEDULED UTILITY DISCONNECTION.
- PLANS ARE NOT COMPLETELY TO SCALE. PIPE ROUTING SHOWN IS SCHEMATIC AND IS NOT INTENDED TO INDICATE EXACT LOCATION OF PIPING AND VALVES. CONTRACTOR SHALL PROVIDE ANY ADDITIONAL FITTINGS REQUIRED FOR PROPER INSTALLATION AND TO MAINTAIN PROPER CLEARANCES. COORDINATE WITH ALL TRADES AND OTHER POTENTIAL OBSTRUCTIONS AND ROUTE PIPING TO AVOID INTERFERENCES.
- 5. CONCEAL PIPING ABOVE CEILINGS, WITHIN WALLS OR CHASES EXCEPT IN MECHANICAL ROOMS OR AS SPECIFICALLY NOTED.
- 6. FIRESTOP ALL PENETRATIONS THROUGH RATED WALLS, CEILINGS, AND FLOORS WITH LISTED ASSEMBLIES AND SLEEVE WHERE REQUIRED. FIRESTOP ASSEMBLIES SHALL BE EQUAL OR EXCEED THE RATING OF THE WALL OR FLOOR. ALL FIRESTOP ASSEMBLIES SHALL MEET ASTM E-814 REQUIREMENTS. SEE ARCHITECTURAL DRAWINGS FOR FINAL FINISHES AND ADDITIONAL PIPE PENETRATION REQUIREMENTS.
- PROVIDE ACCESS PANELS TO ALL VALVES LOCATED WITHIN CHASES OR NON-ACCESSIBLE CEILINGS. REFER TO ARCHITECTURAL DRAWINGS FOR CEILING TYPES. ALL VALVES SHALL BE ACCESSIBLE AND LABELED FOR SYSTEM SERVED.
- 8. REFER TO ARCHITECTURAL DRAWINGS FOR FIXTURE LOCATIONS AND MOUNTING HEIGHTS.
- INSTALL CODE REQUIRED FIXED AIR GAPS ON ALL INDIRECT WASTE CONNECTIONS SERVING EQUIPMENT, AND APPLIANCES.
- 10. PROVIDE CLEANOUTS ON ALL SANITARY DRAIN & WASTE, STORM DRAIN, AND CONDENSATE DRAIN PIPING AS INDICATED ON THE DRAWINGS, AND AS REQUIRED BY LOCAL AND STATE CODES. INSTALL CLEANOUTS IN ACCESSIBLE LOCATIONS. COORDINATE TOP OF FLOOR/GRADE CLEANOUT ELEVATION WITH TOP OF FINISHED GRADE.
- 11. INSTALL HOSE BIBBS AND EXTERIOR WALL HYDRANTS AT 18" ABOVE FINISHED FLOOR AND FINISHED GRADE.
- 12. ALL FLOOR DRAINS SHALL BE INSTALLED WITH A TRAP GUARD INSERT. ALL FLOOR DRAINS SHALL BE INSTALLED WITH GRATES FLUSH TO THE FINISHED FLOOR.
- 13. ALL FLOOR, WALL AND CEILING OPENINGS CREATED BY THE REMOVAL OF EXISTING PLUMBING RELATED ITEMS SHALL BE REPAIRED TO MATCH EXISTING ADJACENT FINISHES AND WALL CONSTRUCTION.
- 14. UNLESS NOTED OTHERWISE, SLOPE ALL SANITARY DWV, STORM DRAIN, AND CONDENSATE DRAIN PIPING 3" PIPE SIZE & LARGER A MINIMUM OF 1/8" PER FT. OF RUN, AND 2-1/2" PIPE SIZE AND SMALLER A MINIMUM 1/4" PER FT. OF RUN. SLOPE VENT PIPING DOWN & BACK TO FIXTURES.
- 15. EACH PLUMBING VENT SHALL TERMINATE NOT LESS THAN 10 FT. FROM, OR AT LEAST 3 FT. ABOVE ANY WINDOW, DOOR, OPENING, AIR INTAKE, OR VENT SHAFT.
- 16. PROVIDE WATER HAMMER ARRESTORS AT ALL PLUMBING FIXTURES OR BATTERY OF FIXTURES WITH QUICK-CLOSING VALVES. WATER HAMMER ARRESTORS SHALL BE SIZED PER PDI STANDARDS. AIR CHAMBERS SHALL NOT BE CONSIDERED AN EQUAL TO WATER HAMMER ARRESTORS AND SHALL NOT BE INSTALLED.
- 17. WATER SERVICE PIPE AND THE BUILDING SEWER SHALL BE SEPARATED BY 5 FEET OF UNDISTURBED OR COMPACTED EARTH. THE REQUIRED SEPARATION DISTANCE SHALL NOT APPLY WHERE THE BOTTOM OF THE WATER SERVICE PIPE WITHIN 5 FEET OF THE SEWER IS A MINIMUM OF 12 INCHES ABOVE THE TOP OF THE HIGHEST POINT OF THE SEWER AND THE PIPE MATERIALS CONFORM TO APPLICABLE PLUMBING CODES.
- 18. UNLESS NOTED OTHERWISE, RUN CW & HW PIPING FULL SIZE THRU LENGTH OF CHASE, AND MAKE CONNECTIONS TO FIXTURES AS INDICATED IN THE PLUMBING FIXTURE SCHEDULE. PROVIDE RIGID SUPPORT AND BLOCKING IN CHASE FOR HEADER AND BRANCH PIPING, AND FOR FLUSH VALVES TO PREVENT ANY MOVEMENT.
- 19. PROVIDE BALANCING VALVES WITH THREADED CONNECTIONS IN HOT WATER RETURN PIPING, AND BALANCE SYSTEM FOR PROPER OPERATION. REFER TO PLUMBING FIXTURE SCHEDULE.
- 20. COORDINATE THE EXACT LOCATION OF FLOOR AND ROOF DRAINS WITH ARCHITECT PRIOR TO CONSTRUCTION.
- 21. PROVIDE ALL NECESSARY VALVES, TRAPS, FLOW CONTROLS, FILTERS, BACKFLOW ASSEMBLIES, FAUCETS, STOPS, TAILPIECES, VACUUM BREAKERS, IF NOT FURNISHED WITH EQUIPMENT.
- 22. CONTRACTOR SHALL ROUGH-IN ALL WASTES AND SUPPLIES TO ALL EQUIPMENT ACCORDING TO MANUFACTURER'S SPECIFICATIONS AND MAKE FINAL CONNECTIONS.
- 23. PROVIDE SUPPLY STOPS ON HOT AND COLD WATER PIPE SUPPLYING ALL FIXTURES AND EQUIPMENT.
- 24. PROVIDE APPROVED CHROME PLATED TYPE VACUUM BREAKERS WHERE REQUIRED BY LOCAL CODES, AND AS INDICATED ON PLANS FOR NEW WORK.
- 25. SUBMIT CORE-DRILL PLAN TO STRUCTURAL ENGINEER AND ARCHITECT FOR REVIEW PRIOR TO STARTING ANY WORK.
- 26. PROVIDE DIELECTRIC UNIONS WHERE CONNECTIONS ARE MADE BETWEEN DISSIMILAR PIPE MATERIALS.
- 27. SEE RISER DIAGRAMS FOR PIPE SIZES AND ROUTING NOT SHOWN ON PLANS.
- 28. METERING AND SITE UTILITY CONNECTIONS SHALL BE PROVIDED ON SITE UTILITY DRAWINGS. ALL SERVICES SHOWN ON THIS SET OF PLANS TERMINATE 5'-0" FROM BUILDING, UNLESS SHOWN OTHERWISE ON DRAWINGS. PLUMBING CONTRACTOR SHALL MAKE FINAL CONNECTIONS TO SITE UTILITES. (INC. CLEANOUTS, INCREASES, BACKWATER VALVES, ETC.)
- 29. PRESSURE REDUCING VALVES SHALL BE PROVIDED WHERE THE WATER PRESSURE EXCEEDS 80 PSI AT ANY PLUMBING FIXTURE. WATER VELOCITY SHALL NOT EXCEED 8 FEET PER SECOND.
- 30. COORDINATE EXACT LOCATION OF FLOOR DRAINS AND HUB DRAINS FOR HVAC EQUIPMENT WITH MECHANICAL CONTRACTOR. CONDENSATE PIPING SHALL NOT DISCHARGE INTO SANITARY SYSTEM.
- 31. DO NOT PENETRATE WALL FOOTINGS WITH PIPING, COORDINATE WITH GENERAL CONTRACTOR TO DROP FOOTINGS AS REQUIRED TO CLEAR PLUMBING SERVICES WHERE ABSOLUTELY NECESSARY. ALL PIPING PENETRATING A BEARING WALL OR FOOTING MUST BE SLEEVED AND LOCATION APPROVED BY STRUCTURAL ENGINEER.
- 32. IF THE INTENT OF THE INFORMATION SHOWN ON THESE DOCUMENTS IS NOT CLEAR, OR IS CAPABLE OF MORE THAN ONE INTERPRETATION, SUCH MATTERS WILL BE BROUGHT TO THE ATTENTION OF THE ARCHITECT/ENGINEER IN WRITING BEFORE THE SUBMISSION OF BIDS, AND THE ARCHITECT/ENGINEER SHALL MAKE CORRECTION OR EXPLANATION IN WRITING.
- 33. WHERE THE CONTRACTOR PROPOSES ALTERNATE SOLUTIONS, DIFFERENT ROUTINGS OF PIPING, DIFFERENT LOCATIONS OF EQUIPMENT, FIXTURES, ETC., THE CONTRACTOR SHALL BE RESPONSIBLE FOR ALL OF THE RAMIFICATIONS OF THE PROPOSED CHANGE THAT ARE NOT INCLUDED IN HIS PROPOSAL, BUT BECOME APPARENT AT A LATER DATE, AND SHALL BEAR THE CONSEQUENCES OF CORRECTING ANY AND ALL CONFLICTS, DEFICIENCIES OR OTHER PROBLEMS AT NO INCREASE IN COST OR INCREASE IN CONSTRUCTION TIME ALLOTTED.

PLUMBING EQUIPMENT SCHEDULE							
MARK	FIXTURE	SOIL/ WASTE	VENT	COLD WATER	HOT WATER	DESCRIPTION	
FCO	FLOOR CLEAN-OUT	-	-	-	-	<u>WATTS #CO-200-RX</u> , EPOXY COATED CAST IRON FLOOR CLEANOUT WITH 5 IN. (127MM) ROUND ADJUSTABLE GASKETED HEAVY DUTY NICKEL BRONZE TOP, REMOVABLE GAS TIGHT GASKETED BRASS CLEANOUT PLUG AND NO HUB (STANDARD) OUTLET.	
FD-1	FLOOR DRAIN	3"	-	-	-	<u>WATTS #FD-100-A</u> , ADJUSTABLE ROUND NICKEL BRONZE STRAINER, EPOXY COATED CAST IRON FLOOR DRAIN WITH ANCHOR FLANGE, REVERSIBLE CLAMPING COLLAR WITH PRIMARY AND SECONDARY WEEPHOLES, AND NO HUB (STANDARD) OUTLET.	
HB-1	HOSE BIBB	-	-	3/4"	-	WOODFORD #24, ANTI-SIPHON, VACUM BREAKER, DESIGNED FOR MILD CLIMATE AREAS. ASSE STANDARD 1011 APPROVED, FURNISHED WITH POLYCARBONATE WHEEL HANDLE AND LOSE TEE KEY ALUMINUM, BRASS OR CHROME BOX.	
wco	WALL CLEAN-OUT	-	-	-	-	WATTS #CO-440-RD, WALL CLEANOUT WITH TWO-PIECE EXPANDABLE CLEANOUT PLUG, STAINLESS STEEL ACCESS COVER, AND VANDAL PROOF STAINLESS STEEL SCREW.	
NOTE O							

PLUMBING FIXTURE SCHEDULE							
MARK	FIXTURE	SOIL/ WASTE	VENT	COLD WATER	HOT WATER	DESCRIPTION	
L-1	LAVATORY	1-1/2"	2"	1/2"	1/2"	<u>CHINA:</u> AMERICAN STANDARD #0355.027 'LUCERNE' WALL HUNG LAVATORY, 4" SPREAD FAUCET HOLES, FRONT OVERFLOW, WHITE. <u>FAUCET:</u> T&S #B-0871 FAUCET, 4" CENTERSET DECK MOUNTED. SUPPLY WITH BRADLEY #S59-4000A THERMOSTATIC MIXING VALVE. BRASS CRAFT, 1/4 ROUGH BRASS STOPS, SCREEN DRAIN, PLASTIC ESCUTCHEONS, SUPPLIES, TRAPS, & DISPOSAL WASTE.	
WC-1	WATER CLOSET	3"	2"	1/2"	-	AMERICAN STANDARD #2898.012, ELONGATED TANK TYPE, VITREOUS CHINA, LOW- CONSUMPTION (1.6 GPF/6.0 LPF), 12" ROUGHING-IN. SEAT: CHURCH #9500C, ENLOGATED SEAT OPEN FRONT LESS COVER, SOLID PLASTIC, CONCEALED CHECK STAINLESS STEEL HINGES.	
WC-2	WATER CLOSET-ADA	3"	2"	1/2"	-	AMERICAN STANDARD #2998.012, ELONGATED TANK TYPE, VITREOUS CHINA, LOW- CONSUMPTION (1.6 GPF/6.0 LPF), 12" ROUGHING-IN, 16-1/2" RIM HEIGHT. SEAT: CHURCH #9500C, ENLOGATED SEAT OPEN FRONT LESS COVER, SOLID PLASTIC, CONCEALED CHECK STAINLESS STEEL HINGES.	
SH-1	SHOWER	1-1/2"	1-1/2"	1/2"	1/2"	<u>SHOWER:</u> 36"x36" SHOWER RECEPTOR, TILE WALLS & DOORS BY OTHERS. <u>FAUCET:</u> MOEN #T552EP 'BRANTFORD', CHROME FINISH SHOWER TRIM, 2.0 GPM MAX. <u>SHOWER DRAIN</u> : OATEY 130 SERIES, PVC PLASTIC.	
SH-2	SHOWER-ADA	1-1/2"	1-1/2"	1/2"	1/2"	<u>SHOWER:</u> 36"X36" ROLL IN SHOWER RECEPTOR (SEAT, GRAB BARS & TILE WALLS BY OTHERS) <u>FAUCET:</u> MOEN #T552EP 'BRANTFORD', CHROME FINISH SHOWER TRIM, 2.0 GPM MAX. <u>SHOWER DRAIN</u> : OATEY 130 SERIES, PVC PLASTIC.	
SH-3	SHOWER-ADA	1-1/2"	1-1/2"	1/2"	1/2"	SHOWER: STERLING: #72131100, 60"x32-1/2" SHOWER RECEPTOR, VIKRELL MATERIAL. CERAMIC TILE WALL SURROUNDS. <u>FAUCET:</u> MOEN #T552EP 'BRANTFORD', CHROME FINISH SHOWER TRIM, 2.0 GPM MAX. <u>SHOWER DRAIN</u> : SHOWER DRAIN: ZURN #FD2254, ADJUSTABLE SHOWER DRAIN, CHROME PLATED.	
NOTE: I. ALL FIXTURES SHALL COMPLY WITH TABLE 604.4 OF THE FLORIDA PLUMBING CODE FOR WATER CONSERVATION.							


2. CONTRACTOR MAY SUBMIT AN APPROVED EQUIVALENT MANUFACTURER FOR ALL FIXTURES.

### DI LINADINIC COLUDNAENIT COLICOLU C

NOTE: CONTRACTOR MAY SUBMIT AN APPROVED EQUIVALENT MANUFACTURER FOR ALL EQUIPMENT.


	AL DESIGN COLLABORATIVE
945 N. PENNSYLVANIA A WINTER PARK, FLORIDA	
OFFICE: (407) 629-1188 FAX: (407) 388-1220 WWW. ADCINTERNATIOI	NAL.NET
Project Documents for:	
	ANGE
UČ	<b>ÚNT</b> I
FL (	D R I D A
GREAT OAKS VILLAO ADA UPGRADES ANI 1784 E. MICHIGAN S ORLANDO, FL 32806	
Issue Date & Issue Desc	ription Drawn By Checked B
	% CD SET JS KA % CD SET JS KA
	RMIT/BID SET JS KA
Client Information	APITAL PROJECTS DIVISION
ORANGE COUNTY C/ 400 E SOUTH STREET 5tl ORLANDO, FL 32801	n FLOOR
ORANGE COUNTY C/ 400 E SOUTH STREET 5tl ORLANDO, FL 32801 Project Number 15253	n FLOOR Issue Date 12/02/2016
ORANGE COUNTY C/ 400 E SOUTH STREET 5tl ORLANDO, FL 32801 Project Number 15253 Drawn By JH	n FLOOR Issue Date 12/02/2016 Project Status PERMIT / BID CD SET
ORANGE COUNTY C/ 400 E SOUTH STREET 5tl ORLANDO, FL 32801 Project Number 15253 Drawn By	n FLOOR Issue Date 12/02/2016 Project Status
ORANGE COUNTY C/ 400 E SOUTH STREET 5tl ORLANDO, FL 32801 Project Number 15253 Drawn By JH Checked By JEB	n FLOOR Issue Date 12/02/2016 Project Status PERMIT / BID CD SET Scale
ORANGE COUNTY C/ 400 E SOUTH STREET 5tl ORLANDO, FL 32801 Project Number 15253 Drawn By JH Checked By	n FLOOR Issue Date 12/02/2016 Project Status PERMIT / BID CD SET Scale
ORANGE COUNTY C/ 400 E SOUTH STREET 5tl ORLANDO, FL 32801 Project Number 15253 Drawn By JH Checked By JEB	n FLOOR Issue Date 12/02/2016 Project Status PERMIT / BID CD SET Scale
ORANGE COUNTY C/ 400 E SOUTH STREET 5tl ORLANDO, FL 32801 Project Number 15253 Drawn By JH Checked By JEB	n FLOOR Issue Date 12/02/2016 Project Status PERMIT / BID CD SET Scale
ORANGE COUNTY C/ 400 E SOUTH STREET 5tl ORLANDO, FL 32801 Project Number 15253 Drawn By JH Checked By JEB	n FLOOR Issue Date 12/02/2016 Project Status PERMIT / BID CD SET Scale AS NOTED
ORANGE COUNTY C/ 400 E SOUTH STREET 5tl ORLANDO, FL 32801 Project Number 15253 Drawn By JH Checked By JEB File Name Consultant • Seal/Signat SGM/	Issue Date 12/02/2016 Project Status PERMIT / BID CD SET Scale AS NOTED
ORANGE COUNTY C/ 400 E SOUTH STREET 5ti ORLANDO, FL 32801 Project Number 15253 Drawn By JH Checked By JEB File Name Consultant • Seal/Signat SGM/ ENGINEERIN MEP CONSULTING ENG CA-00006208 935 LAKE BALDWIN LAWE ORLANDO, FL 32814	Issue Date 12/02/2016 Project Status PERMIT / BID CD SET Scale AS NOTED
ORANGE COUNTY C/ 400 E SOUTH STREET 5tt ORLANDO, FL 32801 Project Number 15253 Drawn By JH Checked By JEB File Name Consultant • Seal/Signat SGM/ ENGINEERING CA-00006208 935 LARE BALDWIN LANE ORLANDO, FL 32814 TEL: 407-767-5188 FAX: 407-767-5172 WWW.SGMENGINEERING.CO	Issue Date 12/02/2016 Project Status PERMIT / BID CD SET Scale AS NOTED
ORANGE COUNTY C/ 400 E SOUTH STREET 5tt ORLANDO, FL 32801 Project Number 15253 Drawn By JH Checked By JEB File Name Consultant • Seal/Signat SGM/ ENGINEERIN MEP CONSULTING ENG CA-0006208 935 LARE BALDWIN LANE ORLANDO, FL 32814 TEL: 407-767-5188 FAX: 407-767-5188 FAX: 407-767-5188	Issue Date 12/02/2016 Project Status PERMIT / BID CD SET Scale AS NOTED
ORANGE COUNTY C/ 400 E SOUTH STREET 5ti ORLANDO, FL 32801 Project Number 15253 Drawn By JH Checked By JEB File Name Consultant • Seal/Signat SGM/ ENGINEERING CA-00006208 935 LARE BALDWIN LANE ORLANDO, FL 32814 TE: 407-767-5188 FAX: 407-767-5172 WWW.SGMENGINEERING.CC COPYRIGHT © 2014 SGM ENGINEER	Issue Date 12/02/2016 Project Status PERMIT / BID CD SET Scale AS NOTED
ORANGE COUNTY C/ 400 E SOUTH STREET 5tt ORLANDO, FL 32801 Project Number 15253 Drawn By JH Checked By JEB File Name Consultant • Seal/Signat SGC/ ENGINEERING CA-00006208 935 LARE BALDWIN LANE ORLANDO, FL 32814 TE: 407-767-5188 FAX: 407-767-5772 WWW.SGMENGINEERING.CC COPYRIGHT © 2014 SGM ENGINEER	Issue Date 12/02/2016 Project Status PERMIT / BID CD SET Scale AS NOTED
ORANGE COUNTY C/ 400 E SOUTH STREET 5tt ORLANDO, FL 32801 Project Number 15253 Drawn By JH Checked By JEB File Name Consultant • Seal/Signat SGC/ ENGINEERING CA-00006208 935 LARE BALDWIN LANE ORLANDO, FL 32814 TE: 407-767-5188 FAX: 407-767-5772 WWW.SGMENGINEERING.CC COPYRIGHT © 2014 SGM ENGINEER	Issue Date 12/02/2016 Project Status PERMIT / BID CD SET Scale AS NOTED
ORANGE COUNTY C/ 400 E SOUTH STREET 5tt ORLANDO, FL 32801	Issue Date 12/02/2016 Project Status PERMIT / BID CD SET Scale AS NOTED AS NOTED
ORANGE COUNTY C/ 400 E SOUTH STREET 5tt ORLANDO, FL 32801 Project Number 15253 Drawn By JH Checked By JEB File Name Consultant • Seal/Signat SGM # 2016-066 Sheet Title: Plumbi	Issue Date 12/02/2016 Project Status PERMIT / BID CD SET Scale AS NOTED


Notes

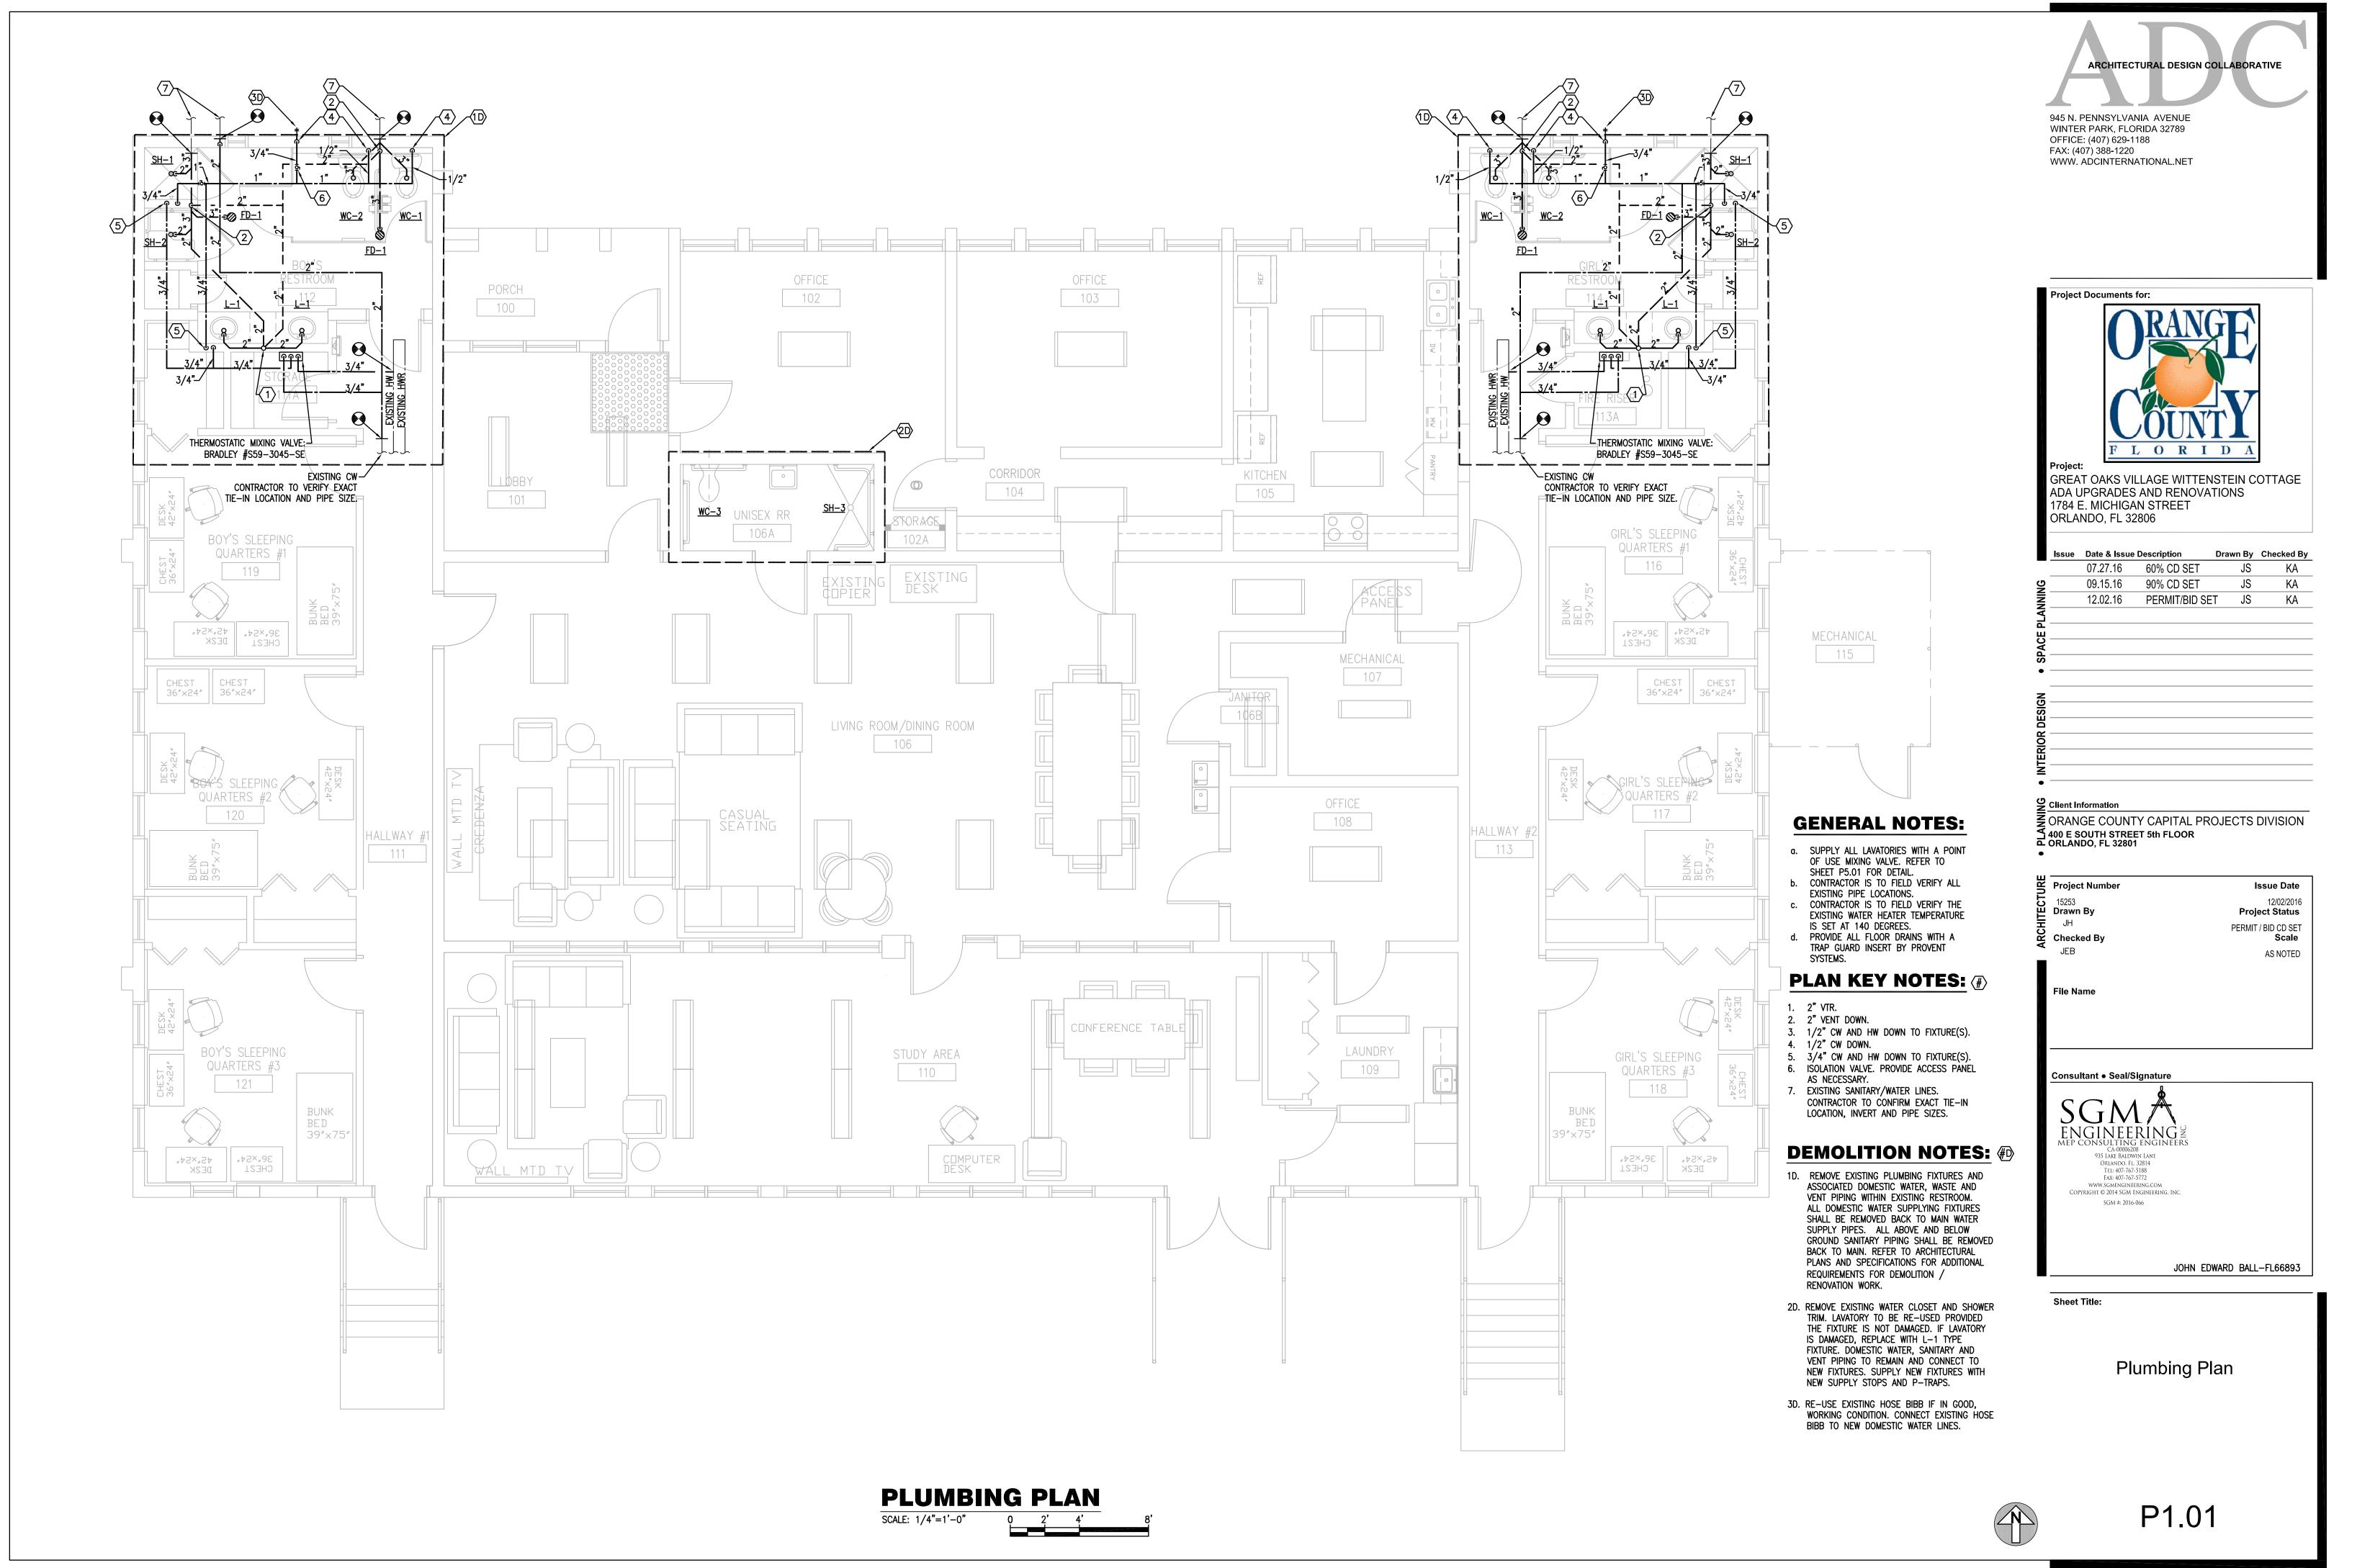


RINTED ON: Dec 01, 2016 - 12:39pm


12 20 З, Õ ō  $\Box$ 

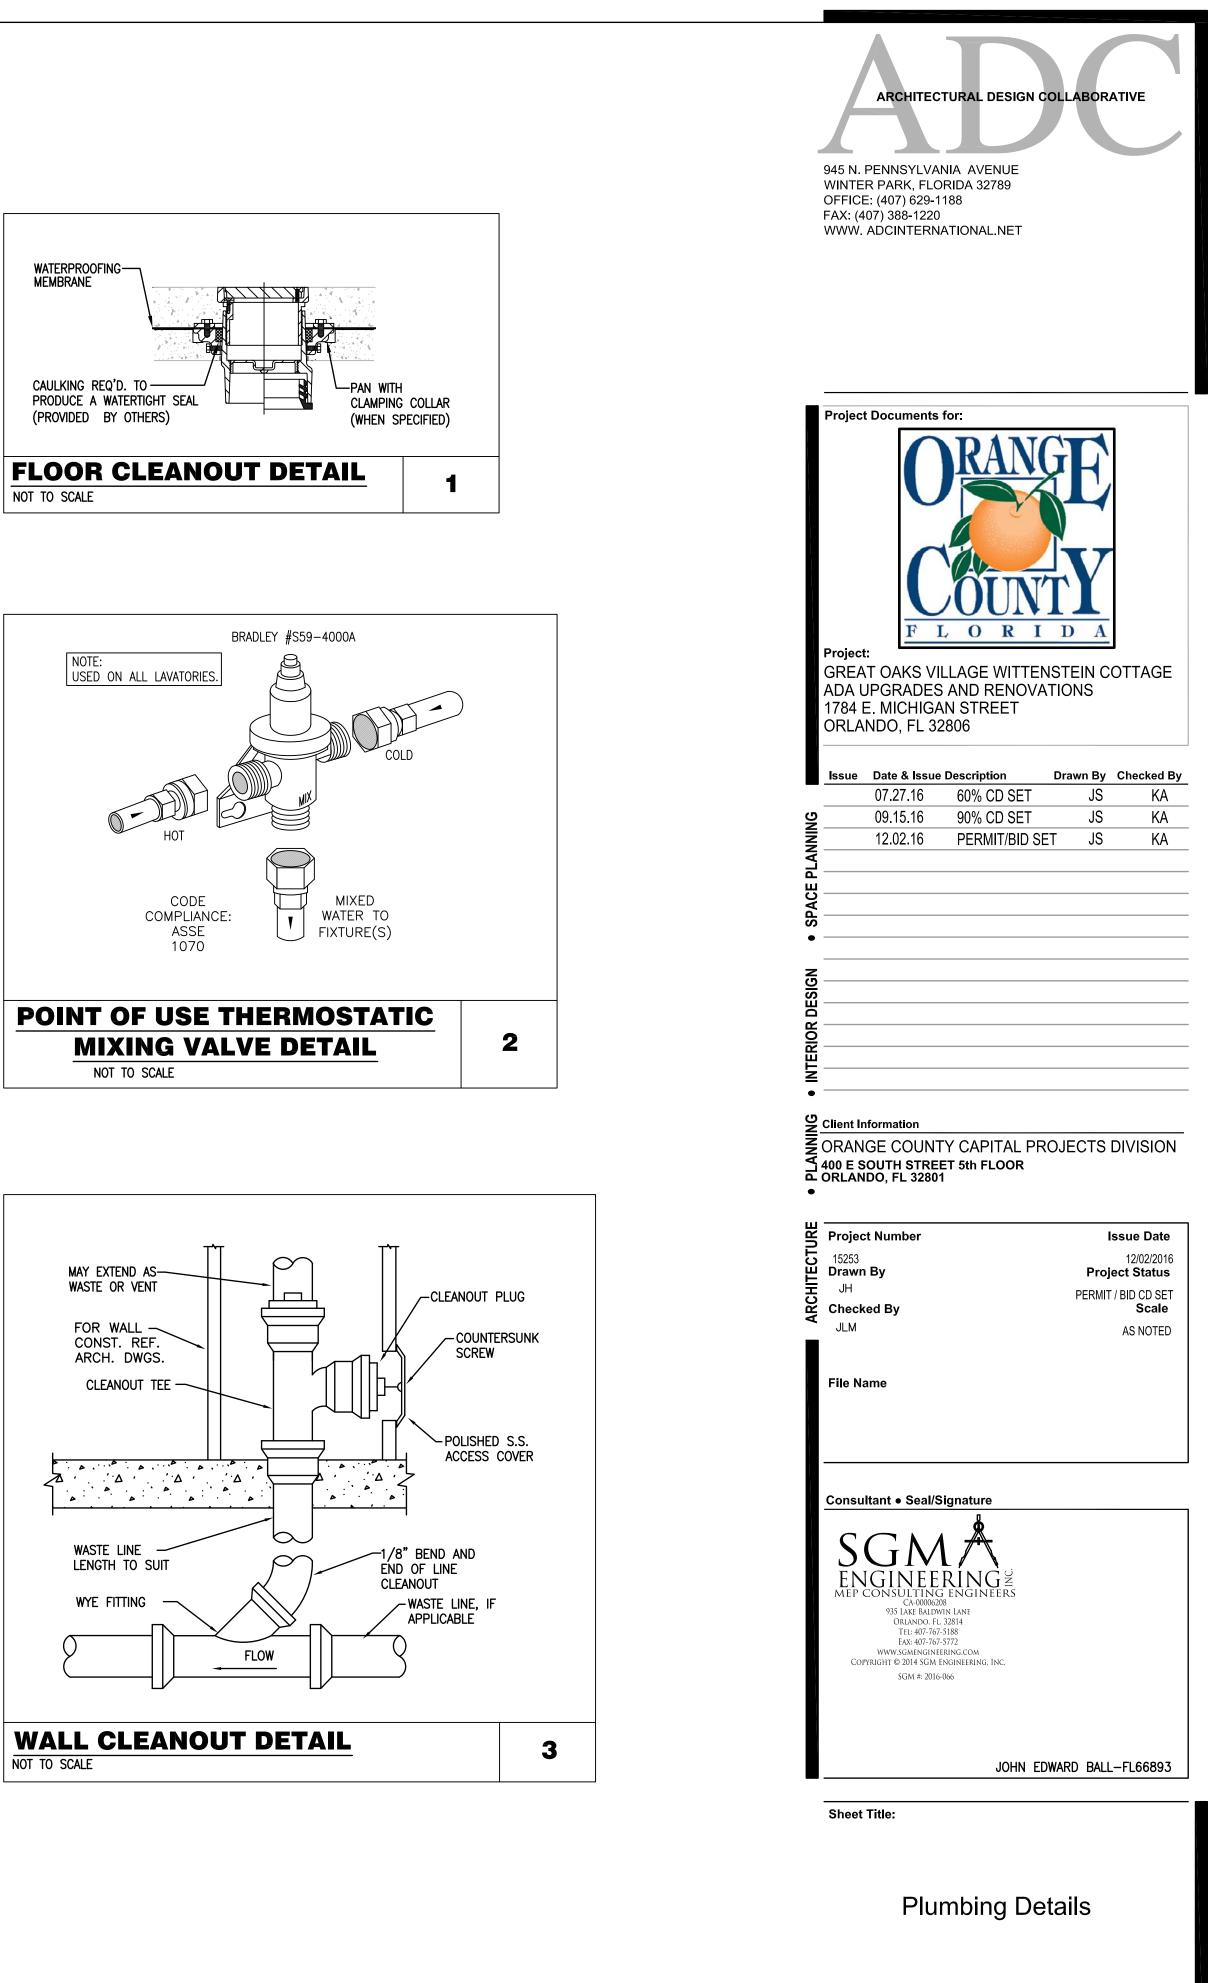


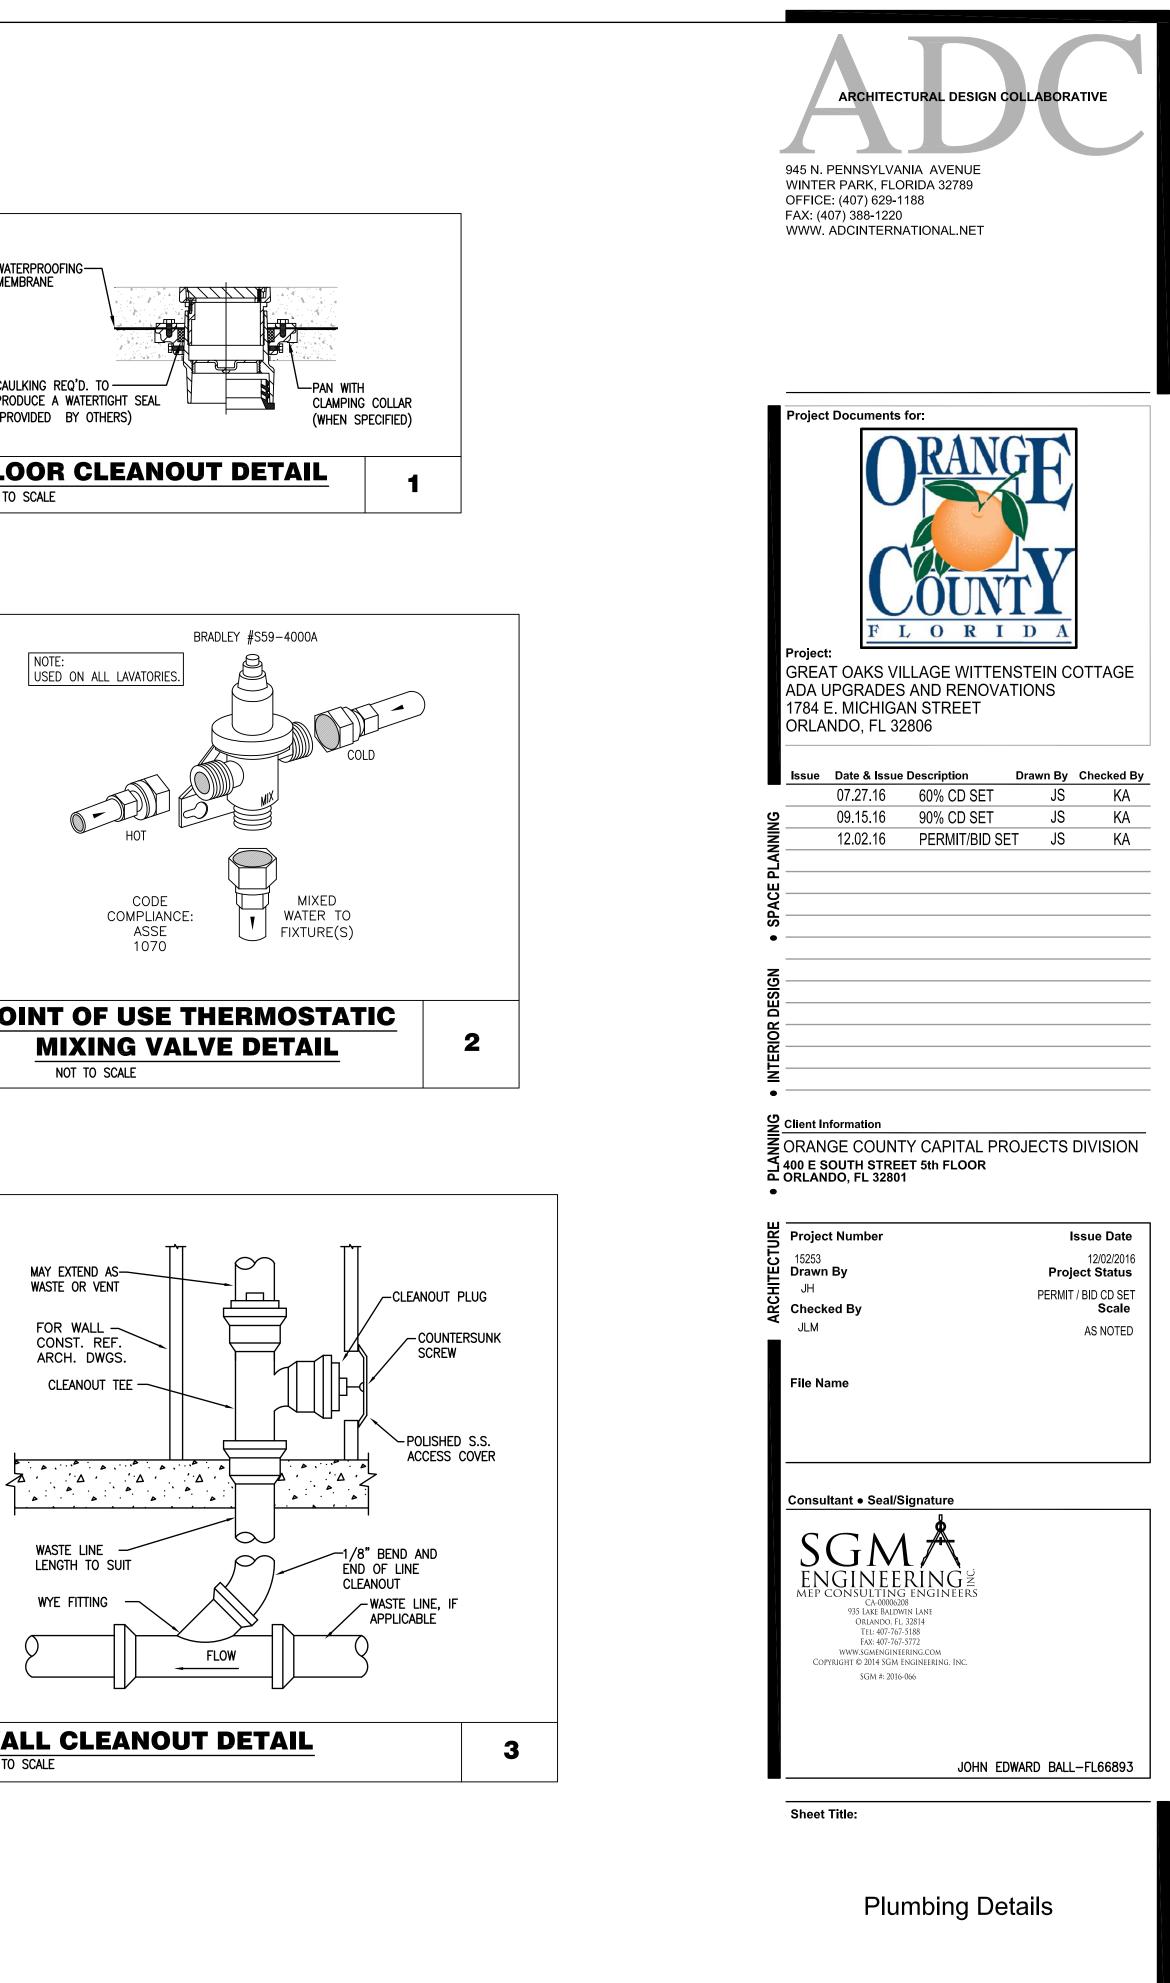


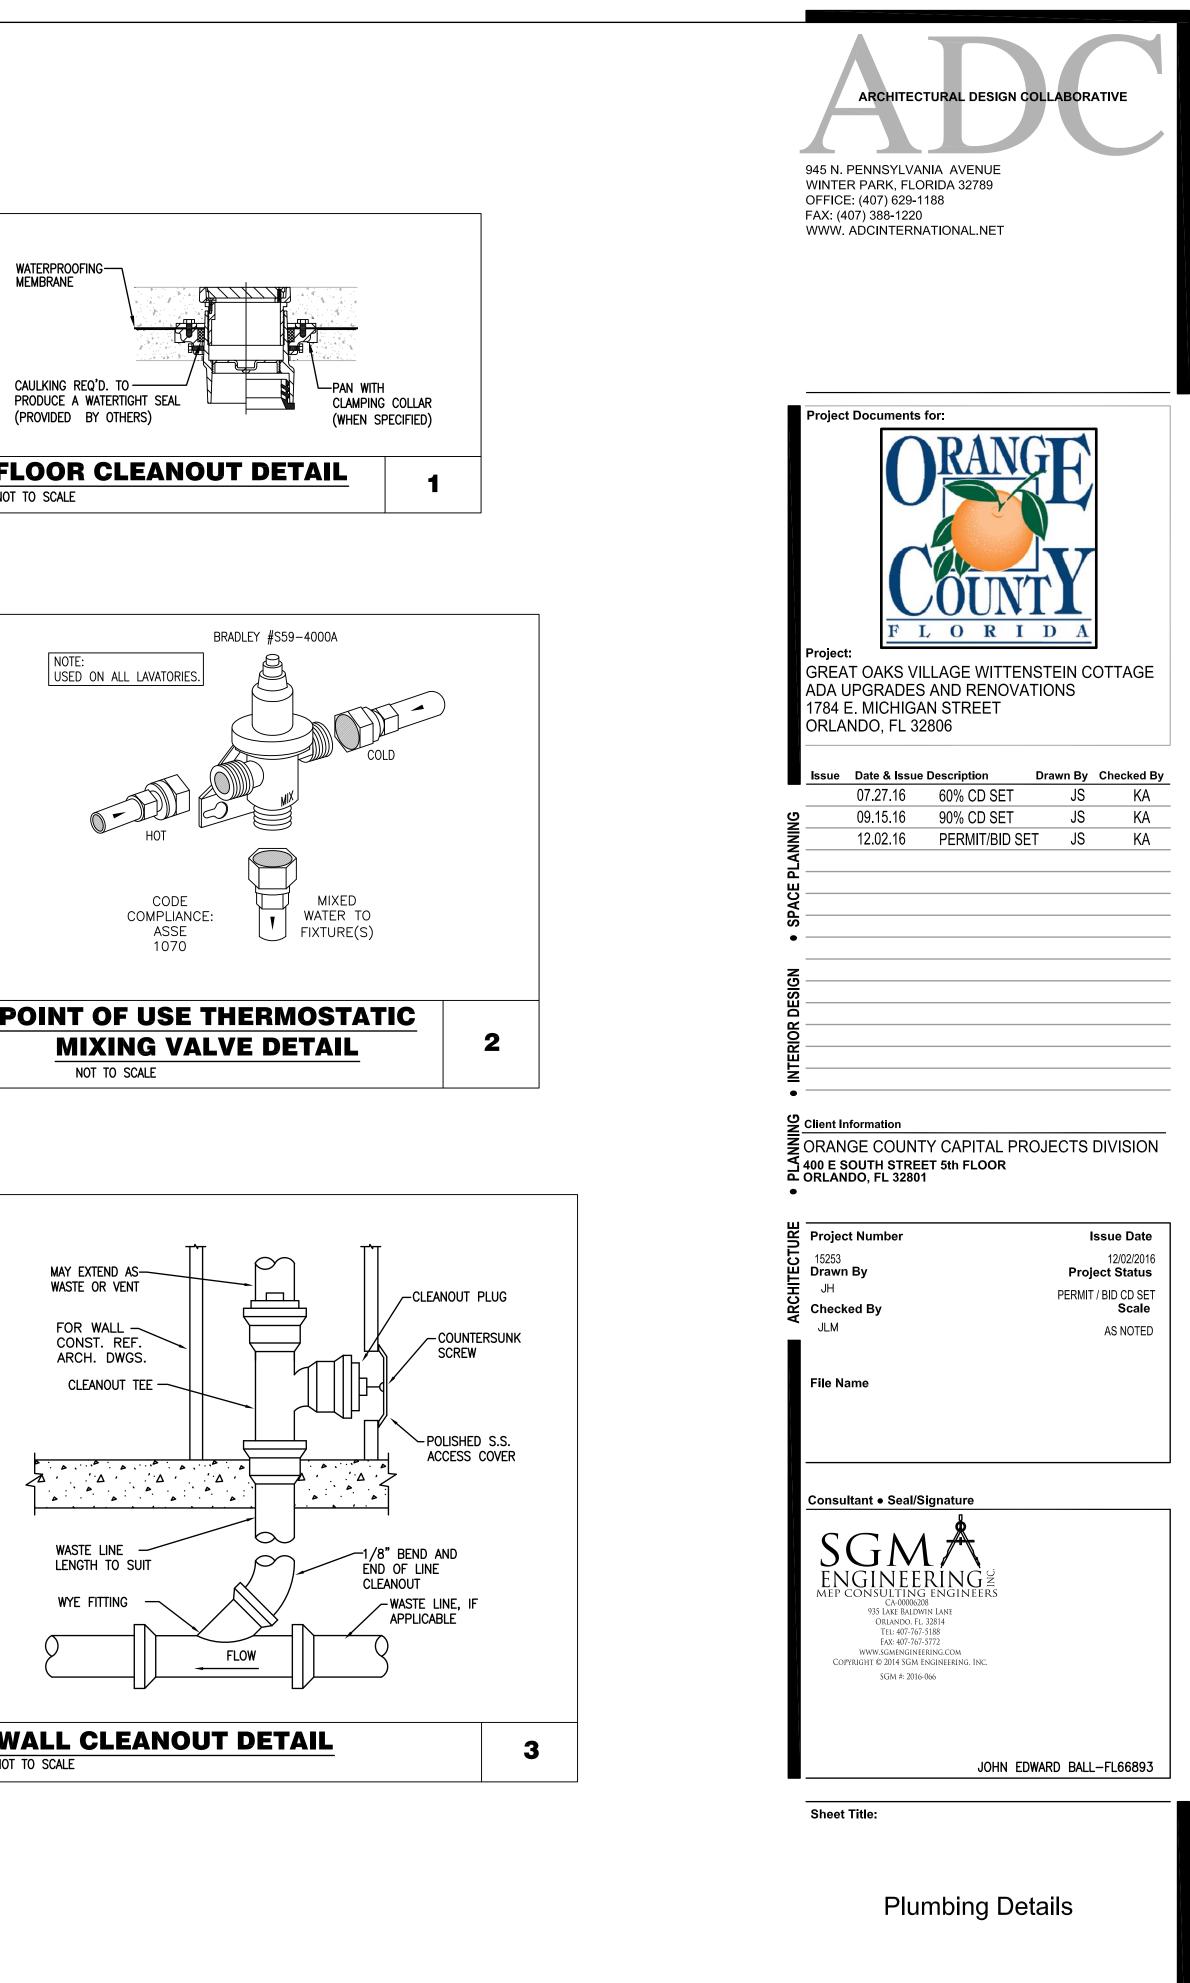

P5.01

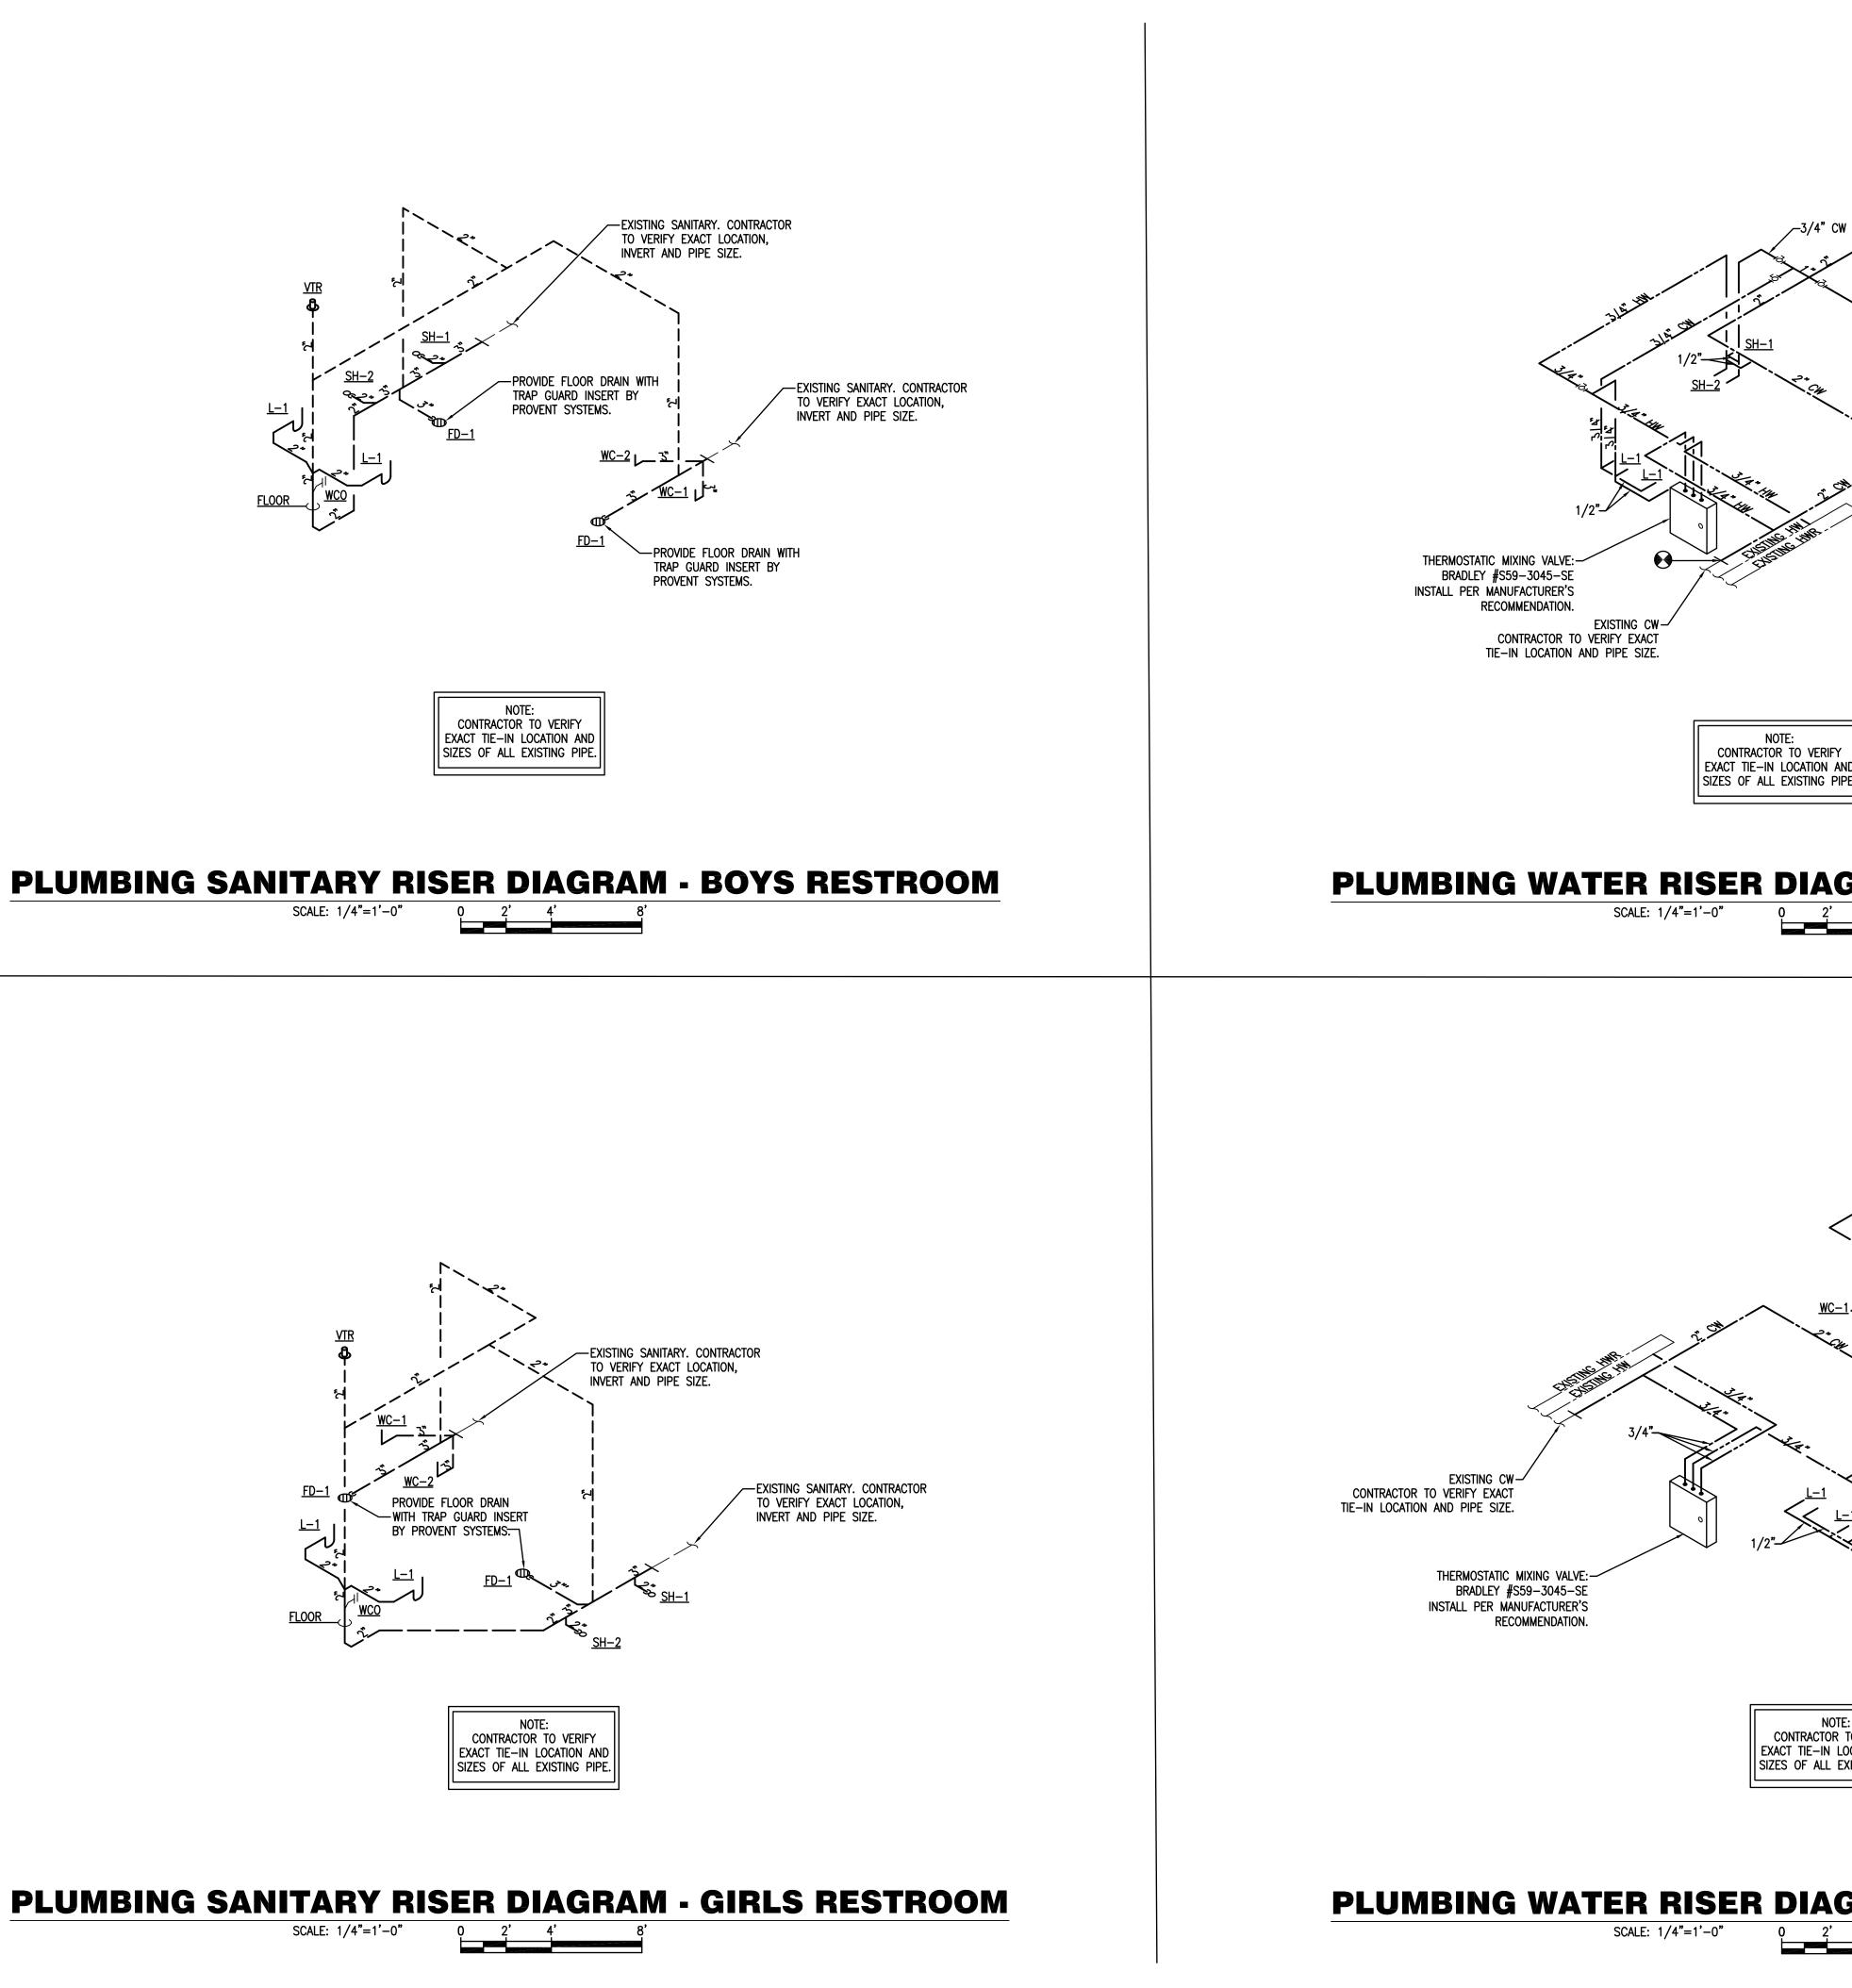

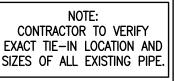

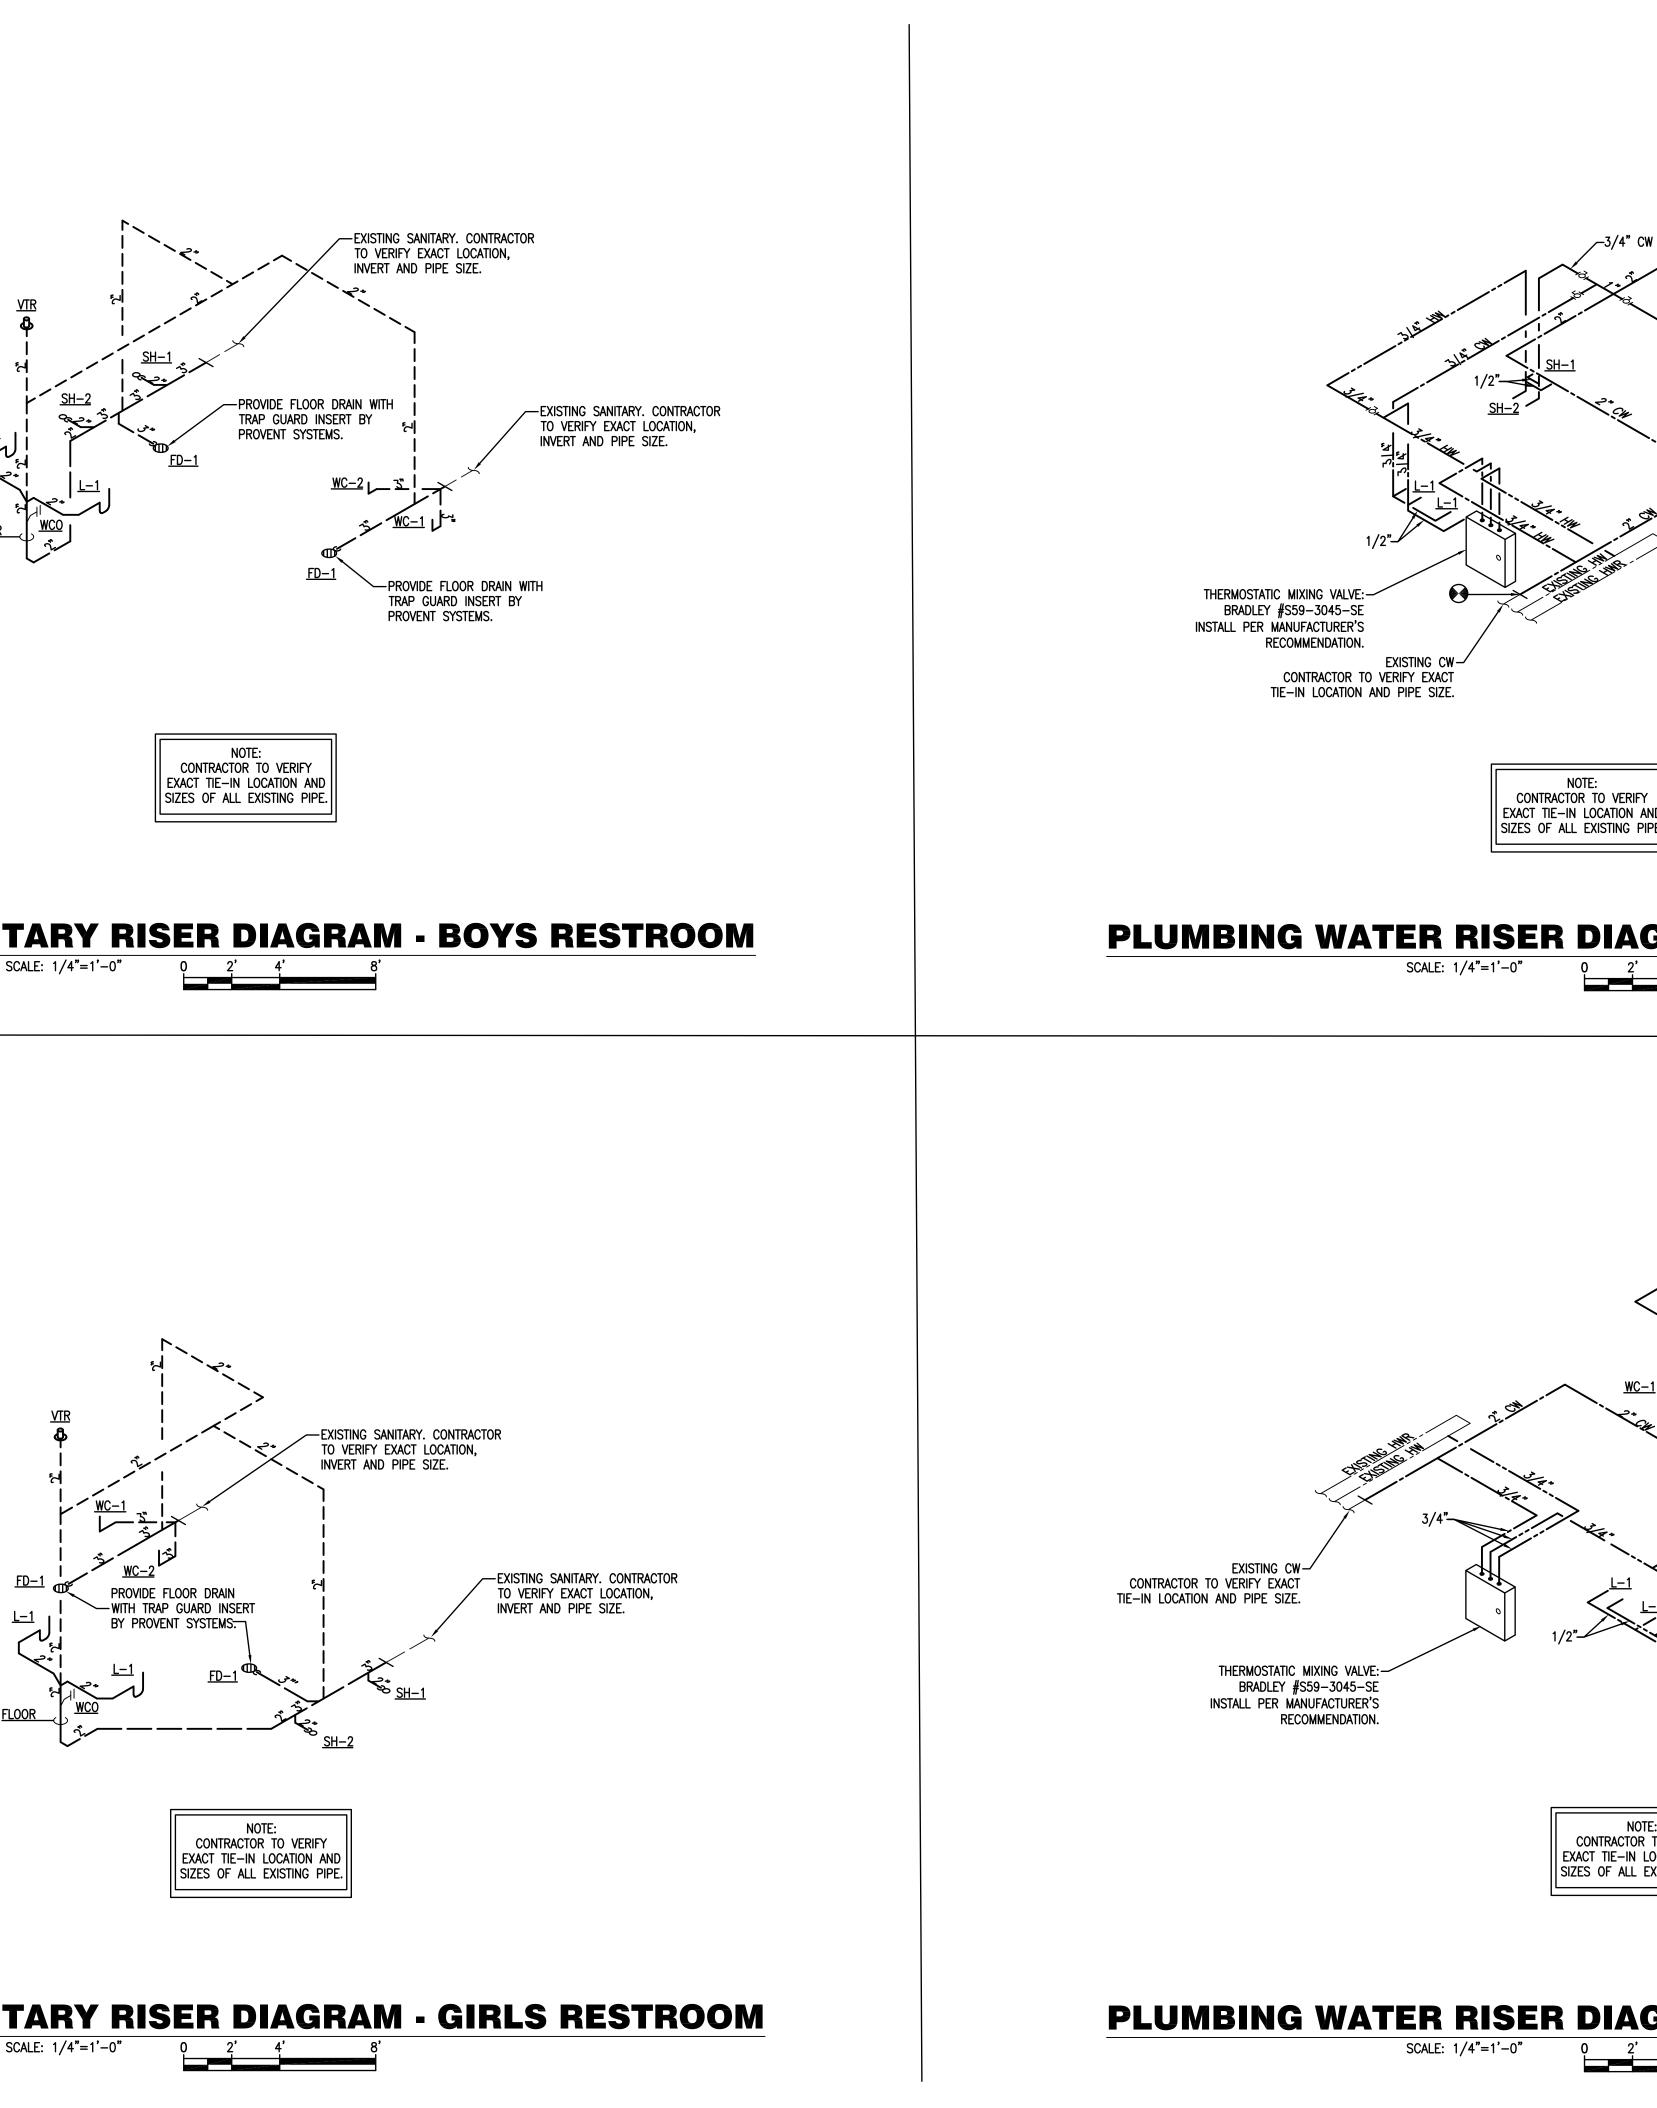



1	ARCHITECTURAL DESIGN COLLABORATIVE 945 N. PENNSYLVANIA AVENUE WINTER PARK, FLORIDA 32789 OFFICE: (407) 629-1188 FAX: (407) 388-1220 WWW. ADCINTERNATIONAL.NET
EXISTING HB-1 WC-2 WC-1	Project Documents for:         Image: Constrained of the second state
GRAM - BOYS RESTROOM	Internitional of the line internition of the state of the st
	<ul> <li>ORANGE COUNTY CAPITAL PROJECTS DIVISION ORANGE COUNTY CAPITAL PROJECTS DIVISION 400 E SOUTH STREET 5th FLOOR ORLANDO, FL 32801</li> <li>Project Number Issue Date 15253 12/02/2016 Drawn By Project Status JH PERMIT / BID CD SET Checked By Scale JEB AS NOTED</li> </ul>
HC-2 HC-2 Consultant • Seal/Signature SGC ADDREERING 2 MEP CONSULTING ENGINEERS CA.0000208 935 LAKE BALDWIN LANE ORLANDO, FL 32814 TE: 407-767-5187 EX: 407-767
E: TO VERIFY DCATION AND XISTING PIPE.	JOHN EDWARD BALL-FL66893 Sheet Title: Plumbing Riser Diagrams
GRAM - GIRLS RESTROOM	P4.01

### **MECHANICAL GENERAL NOTES**

- . IF THE INTENT OF ARCHITECT/ ENGINEER WITH REGARD TO ANY DETAIL IS NOT CLEAR, OR IS CAPABLE OF MORE THAN ONE INTERPRET WILL BE BROUGHT TO THE ATTENTION OF THE ARCHITECT/ENGINEER IN WRITING BEFORE THE SUBMISSION OF BIDS, AND THE ARCHITE MAKE CORRECTION OR EXPLANATION IN WRITING. OTHERWISE, NO EXTRA CHARGE WILL BE ALLOWED FOR THE WORK OR MA ARCHITECT/ENGINEER WILL REQUIRE, PROVIDED THAT IT COMES WITHIN A REASONABLE INTERPRETATION OF THE DRAWINGS AND SPECIFICA
- 2. THE PLANS AND SPECIFICATIONS ARE INTENDED AS A GENERAL DESCRIPTION OF THE WORK TO BE PERFORMED. ALL ITEMS NOT SPECIF SHOWN, BUT NECESSARY FOR THE COMPLETION OF THE INSTALLATION, SHALL BE FURNISHED AND INSTALLED BY THIS CONTRACTOR. TH THOROUGHLY ACQUAINT THEMSELVES WITH THE MECHANICAL, ARCHITECTURAL, STRUCTURAL AND ELECTRICAL PLANS BEFORE SUBMITTING ADDITIONAL COMPENSATION WILL BE ALLOWED DUE TO THE CONTRACTOR'S FAILURE TO FAMILIARIZE THEMSELVES WITH THE PLANS.
- 3. ALL WORK SHALL BE IN ACCORDANCE WITH THE FLORIDA BUILDING CODE 2014.
- 4. THE SIZE AND LOCATION OF EQUIPMENT INSTALLED UNDER DIVISION 23 MECHANICAL SHALL BE COORDINATED WITH OTHER TRAD EQUIPMENT SHALL BE VERIFIED WITH MANUFACTURER'S CERTIFIED DRAWINGS. TRANSITIONS TO ALL EQUIPMENT SHALL BE VERIFIED EQUIPMENT FURNISHED.
- 5. DUCTWORK AND PIPING TO MECHANICAL EQUIPMENT SHALL BE INSTALLED IN A MANNER THAT DOES NOT OBSTRUCT EQUIPMENT SERVICE O
- 6. COORDINATE WORK WITH ALL TRADES INCLUDING, BUT NOT LIMITED TO, ARCHITECTURAL, STRUCTURAL, CIVIL, LIGHTING, POWER SYST FIRE PROTECTION EXISTING AND NEW WORK.
- 7. INTERRUPTION OF EXISTING SERVICES SHALL BE MINIMAL AND SHALL BE FULLY COORDINATED WITH THE OWNER AND ALL TRADES IN ADV ALL INTERRUPTIONS DURING NON-CRITICAL TIMES.
- B. DISCONNECT SWITCHES REQUIRED FOR THE MECHANICAL EQUIPMENT SHALL BE PROVIDED BY DIVISION 26 ELECTRICAL EXCEPT SCHEDULE.
   9. ALL EQUIPMENT, DUCTWORK, ETC., SHALL BE SUPPORTED AS DETAILED AND/OR SPECIFIED. PROVIDE ADDITIONAL SUPPORTS AS REQUI
- 9. ALL EQUIPMENT, DUCTWORK, ETC., SHALL BE SUPPORTED AS DETAILED AND/OR SPECIFIED. PROVIDE ADDITIONAL SUPPORTS AS REC VIBRATION-FREE, RIGID INSTALLATION. SUPPORT ALL OBJECTS FROM STRUCTURE WITHOUT PENETRATING THE CEILING.
- 10. ALL HVAC EQUIPMENT LOCATION & WEIGHT SHALL BE COORDINATED AND APPROVED BY THE ARCHITECT, STRUCTURAL ENGINEER, CON PRIOR TO PURCHASE AND INSTALLATION.
- 11. REFER TO TYPICAL DETAILS FOR DUCTWORK AND INSTALLATION OF EQUIPMENT.
- 12. ALL DUCTWORK SHALL BE CONSTRUCTED AND INSTALLED IN ACCORDANCE WITH NFPA 90A AND 90B.
- 13. DUCT SIZES SHOWN ARE MINIMUM INSIDE DIMENSIONS.
- 14. SEE SPECS. FOR GAUGES, THICKNESS, BRACING, REQUIREMENTS, ETC., OF DUCTWORK.
- 15. BEFORE FABRICATION, VERIFY AND COORDINATE ALL DIMENSIONS IN FIELD. DUCT SIZES AND ALL OPENINGS THRU BUILDING CONST EQUIPMENT FURNISHED.
- 16. ALL WORK SHALL BE COORDINATED WITH ALL TRADES INVOLVED. OFFSETS IN DUCTS AND PIPING (INCLUDING DIVIDING DUCTS) AND OBSTRUCTIONS SHALL BE PROVIDED AT NO ADDITIONAL COST.
- 17. ALL DUCTWORK AND PIPING IS SHOWN SCHEMATICALLY. PROVIDE ALL TRANSITIONS, ELBOWS, FITTINGS, ETC., TO ALLOW SMOOTH FLO FITTINGS SHALL TRANSITION TO FULL SIZE OF THE SUM OF BOTH BRANCHES, UPSTREAM OF SPLIT.
- 18. ACCESS PANELS IN DUCTWORK AND CEILINGS SHALL BE PROVIDED WHERE REQUIRED FOR OPERATION, BALANCING, MAINTENANCE AND ALL MECHANICAL EQUIPMENT INCLUDING CONTROL DAMPERS, TEMPERATURE CONTROL DEVICES, SMOKE DETECTORS, FIRE DAMPERS AND STATIONS.
- 19. MAINTAIN CLEARANCE OF A MINIMUM OF 6" BETWEEN DUCTWORK, PIPING, EQUIPMENT, ETC., AND ALL FIRE RATED AND FIRE/SMOKE ALLOW FOR INSPECTIONS OF RATED WALLS.
- 20. PROVIDE TRANSITIONS AT DIFFUSER NECKS AS REQUIRED TO MATCH SIZES OF FLEX DUCTS TO BE CONNECTED.
- 21. PROVIDE VOLUME DAMPERS IN ALL BRANCH DUCTS FROM MAIN TRUNK LINES OF LOW PRESSURE SYSTEMS.
- 22. COORDINATE DIFFUSER, GRILLE AND REGISTER LOCATIONS WITH ARCHITECTURAL REFLECTED CEILING PLANS AND EQUIPMENT OF ALL TRADES
- 23. COORDINATE WITH ARCHITECT BEFORE PURCHASING GRILLES, REGISTERS, DIFFUSERS, LOUVERS AND OTHER AIR DISTRIBUTION DEVICES TO
- 24. SIDEWALL REGISTERS AND LINEAR TYPE DIFFUSERS SHALL BE INSTALLED LEVEL ALONG A COMMON ELEVATION IN THE SPACE SERVED.
- 25. DAMPERS AND INSIDES OF DUCTS VISIBLE THROUGH GRILLES, REGISTERS AND DIFFUSERS SHALL BE PAINTED FLAT BLACK.
- 26. ALL OPERABLE THERMOSTAT PARTS SHALL BE MOUNTED 48" ABOVE FINISHED FLOOR. ROOM THERMOSTATS DO NOT REQUIRE COVERS. VO VOLT UNLESS OTHERWISE INDICATED.
- 27. COORDINATE COMBINATION THERMOSTAT/HUMDISTAT LOCATIONS WITH FURNITURE/EQUIPMENT LAYOUTS, WINDOWS AND DOOR SWING AREAS.
- 28. ALL CONTROL WIRING AND HARDWARE TO COMPLETE THE HVAC CONTROL SYSTEM SHALL BE FURNISHED AND INSTALLED UNDER DIVISION 23 MECHANICAL OF THESE CONTRACT DOCUMENTS UNLESS OTHERWISE SPECIFIED OR INDICATED ON DRAWINGS.


	EXHAUST FAN SCHEDULE														
			E.S.P. IN	FAN	м	DTOR DATA		TYPE OF				CONTE	REMARKS		
MARK	SPACE SERVED	CFM	INCHES H ₂ O	RPM	RPM	VOLTS/PH	APMS	FAN	MAKE	MODEL	DRIVE	SONES	REMARKS		
EF-1	RESTROOM	360	0.10	843	1500	120/1	1.7	SIDE WALL	BROAN OR APPROVED EQUAL	MODEL 12C	DIRECT	8.0	1-2		
EF-2	RESTROOM	360	0.10	843	1500	120/1	1.7	SIDE WALL	BROAN OR APPROVED EQUAL	MODEL 12C	DIRECT	8.0	1–2		
NOTEC															

•

NOTES:


PROVIDE FANS WITH BACKDRAFT DAMPERS.
 PROVIDE A WEATHERHOOD WITH INSECT SCREEN.


		MECHANICAL	ABBRE	EVIATIONS	MEC	HANICAL SYMB
RETATION, SUCH MATTERS					PIPING	
HITECT/ ENGINEER SHALL	A	AIR	HR	HOUR		
MATERIAL WHICH THE	AAV	AUTOMATIC AIR VENT	HVAC	HEATING VENTILATING		
ICATIONS.	AC	AIR CONDITIONING		AND AIR CONDITIONING	<b>—</b>	POINT OF CONNECTION
	ACU	AIR CONDITIONING UNIT	HZ	HERTZ (CYCLES PER SECOND)	U U	
CIFICALLY MENTIONED OR	AD	ACCESS DOOR, AIR DRYER				
THIS CONTRACTOR SHALL	AFF	ABOVE FINISHED FLOOR	ID	INSIDE DIAMETER		POINT OF DISCONNECTION
NG THEIR FINAL BID. NO	AFG AHU	ABOVE FINISHED GRADE AIR HANDLING UNIT	IN	INCH		
	ALUM	ALUMINUM			T	
	AP	ACCESS PANEL	KEF	KITCHEN EXHAUST FAN		COMBINATION THERMOSTAT/HUMI
	APD	AIR PRESSURE DROP	KW	KILOWATT	S	TEMPERATURE SENSOR
RADES. CONNECTION TO	ATC	AUTOMATIC TEMPERATURE CONTROL	LDB	LEAVING DRY BULB	-	
IED AND PROVIDED FOR	AV	AIR VENT	LWB	LEAVING WET BULB	(CO)	CARBON DIOXIDE SENSOR
	BDD	BACK DRAFT DAMPER	LOR	LIMIT OF REMOVAL		
CLEARANCES.	BOT	BOTTOM	MAX	MAXIMUM	(SD) SD	SMOKE DETECTOR
	BFP	BACKFLOW PREVENTER	MBC	MASTER BUILDING CONTROLLER		
YSTEMS, PLUMBING, AND	BTU	BRITISH THERMAL UNIT	MBH	THOUSAND BTU PER HOUR		
			MD	MANUAL DAMPER		FIRE STAT
	C	CELSIUS, DEGREE CELSIUS	MIN	MINIMUM		
ADVANCE TO SCHEDULE	CENT	CENTRIFUGAL	Ν	NORTH	X	EXISTING FIRE DAMPER
	CFM	CUBIC FEET PER MINUTE	NA	NOT APPLICABLE		
PT WHEN INDICATED ON	CHWS&R	CHILLED WATER SUPPLY & RETURN	NO OR #	NUMBER, NORMALLY OPEN		
I WHEN INDICATED ON	CLG		NTS	NOT TO SCALE		FIRE DAMPER
	CF CO	CEILING FAN CLEAN OUT				
QUIRED TO PROVIDE A	COND	CONDENSATE	OA	OUTSIDE AIR		
		CONDENSALE	OBD	OPPOSED BLADE DAMPER		SMOKE DAMPER
	DB	DRY BULB, DOWN BLOW	OD	OUTSIDE DIAMETER		
CONTRACTOR AND OWNER	DCW	DOMESTIC COLD WATER	OPER	OPERATING		MANUAL VOLUME DAMPER
	DEG	DEGREE				
	DELIV	DELIVERY	PSI	POUNDS PER SQUARE INCH		
	DHW	DOMESTIC HOT WATER	PSIG	POUNDS PER SQUARE INCH GAUGE	(C)	CARBON MONOXIDE SENSOR
	DISC	DISCONNECT				
	DN	DOWN	RA	RETURN AIR		TAP WITH 45° ENTRY
			REG	REGISTER		
	EA	EXHAUST AIR, EACH	RF	RETURN FAN		
	EAT	ENTERING AIR TEMPERATURE	RG	RETURN GRILLE	EUH	ELECTRIC UNIT HEATER
NSTRUCTION SHALL SUIT	EDB	ENTERING DRY BULB	RH	RELATIVE HUMIDITY		
STRUCTUR SHALL SUI	EF	EXHAUST FAN	RHC	REHEAT COIL	EMS	ENERGY MANAGEMENT SYSTEM
	EFF	EFFICIENCY	RM	ROOM		
ND TRANSITIONS AROUND	ELEV EMS	ELEVATION ENERGY MANAGEMENT SYSTEM			<u>M</u>	MOTOR OPERATED DAMPER
	ENT	ENTERING	SA	SUPPLY AIR		
	ERG	EXISTING RETURN GRILLE	SEF	SMOKE EXHAUST FAN		
FLOWS. ALL SPLIT DUCT	EWB	ENTERING WET BULB	SF	SUPPLY FAN	DIAN DET	<b>AIL IDENTIFICATI</b>
			S/FD	SMOKE/FIRE DAMPER	PLAN-DEIA	AL IDENTIFICATI
O VISUAL INSPECTION OF	F	FAHRENHEIT	т	THERMOSTAT	DETAIL NUMBER	
AND AIRFLOW MEASURING	FD	FIRE DAMPER, FLOOR DRAIN	TEC	TERMINAL EQUIPMENT CONTROLLER		$\frac{1}{1}$
	FPM FPS	Feet per minute Feet per second	TEMP	TEMPERATURE		
	F/SD	FIRE/SMOKE DAMPER	T/D	TRANSFER DUCT		SHEET WHERE
E RATED PARTITIONS, TO	FT	FEET	ΤΎΡ	TYPICAL		DETAIL IS SHOWN
	GPH	GALLONS PER HOUR	V	VENT, VOLT		
	GPM	GALLONS PER MINUTE	VD	VOLUME DAMPER	SECTION I	DENTIFICATION
	GLY		VERT	VERTICAL		
	GRV GWS	GRAVITY RELIEF VENTILATOR GLYCOL WATER SUPPLY	WB	WET BULB	SECTION NUMBER	
DES.	GWR	GLYCOL WATER RETURN	WPD	WATER PRESSURE DROP		
to verify finish.		GETCOL WATER RETORN				SHEET WHERE
IU VERIFT FINISH.	HHWS&R	HEATING HOT WATER SUPPLY & RETURN	1WB 2WB	ONE WAY BLOW TWO WAY BLOW		DETAIL IS SHOWN
	HOA	HAND-OFF-AUTOMATIC	3WB	THREE WAY BLOW		
	HP	HORSEPOWER, HEAT PUMP	5110			
VOLTAGE SHALL BE 24						
).						

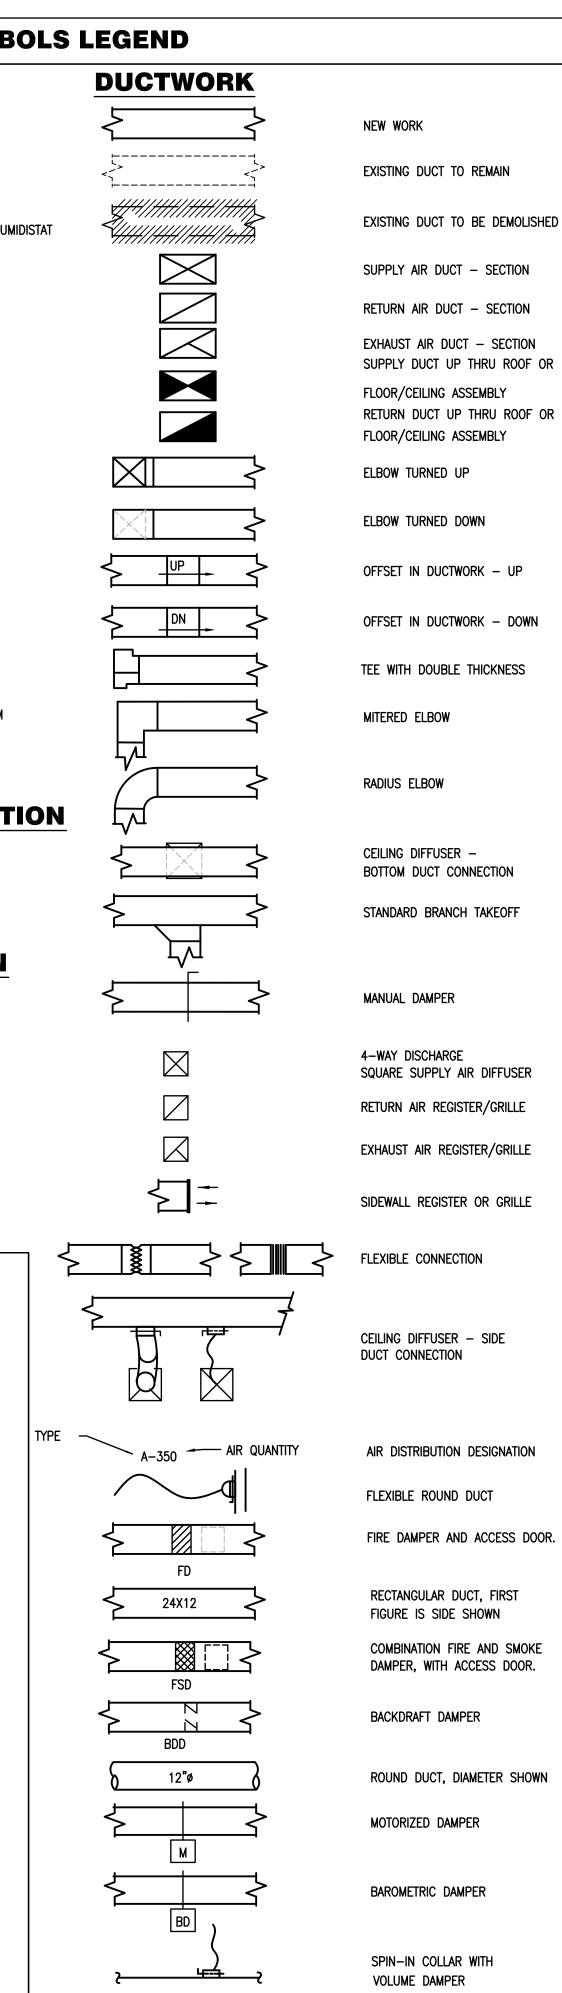


945 N	. PENNSYLVA	NIA AVENUE		
WINTI OFFIC FAX: (	ER PARK, FLC CE: (407) 629-1 (407) 388-1220	0RIDA 32789 188		
Proje	ct Documents	for:		
	C	KANG	E	
	<u>C</u>	OUN'I	Y	
	ct: AT OAKS VI	LORI LLAGE WITTENS AND RENOVAT		TAGE
1784	E. MICHIGA ANDO, FL 32	AN STREET		
lssue	Date & Issue 07.27.16 09.15.16	60% CD SET	JS	hecked I KA
	12.02.16	90% CD SET PERMIT/BID SET	JS JS	KA KA
•				
ב רי				
EKIUK UENK				
Client Client ORAN 400 E		TY CAPITAL PRO ET 5th FLOOR 1	JECTS DI	VISIO
DEClient ORAN 400 E ORLA	NGE COUNT SOUTH STRE NDO, FL 3280 ect Number	ET 5th FLOOR	Issu	ue Date
DEClient ORAN 400 E ORLA	NGE COUNT SOUTH STREI NDO, FL 3280 ect Number	ET 5th FLOOR	Issi , Project	ue Date 12/02/201/ t Status
Client ORAN ORAN 400 E ORLA Proje 15253 Draw MAC	NGE COUNT SOUTH STREI NDO, FL 3280 ect Number	ET 5th FLOOR	Issu Project PERMIT / BI	ue Date 12/02/2011 t Status ID CD SE Scale
Client ORAN ORAN ORAN ORAN Proje 15253 Draw MAC Chec	NGE COUNT SOUTH STRE NDO, FL 3280 ect Number n By C ked By	ET 5th FLOOR	Issu Project PERMIT / BI	ue Date 12/02/2010 Status
Client ORAN ORAN 400 E ORLAN Proje 15253 Draw MAC Chec JEB	NGE COUNT SOUTH STRE NDO, FL 3280 ect Number n By C ked By	ET 5th FLOOR	Issu Project PERMIT / BI	ue Date 12/02/2010 t Status ID CD SE ⁻ Scale
Client ORAN ORAN 400 E Proje 15253 Draw Chec JEB File N	VGE COUNT SOUTH STREE NDO, FL 3280 ect Number in By c ked By viewed By viewed By viewed By viewed By viewed By viewed By viewed By viewed By	Signature	Issu Project PERMIT / BI	ue Date 12/02/2011 t Status ID CD SE Scale
Client ORAN ORAN 400 E Proje 15253 Draw MAC Chec JEB File N	NGE COUNT SOUTH STREINDO, FL 3280 Act Number Sin By Consultant • Seal/S	Signature	Issu Project PERMIT / BI	ue Date 12/02/201 t Status ID CD SE Scale
Client ORAN ORAN 400 E Proje 15253 Draw MAC Chec JEB File N	VGE COUNT SOUTH STREENDO, FL 3280 ect Number in By C iked By Name ultant • Seal/S Name CONSULTINC CANONGER CONSULTINC CANONGER CONSULTINC CANONGER CONSULTINC CANONGER SI LAKE BALDW ORLANDO, FL TEL: 407-767 FA: 407-767 CONSULTINC CANONGER SI LAKE BALDW ORLANDO, FL 305 LAKE BALDW	Signature	Issu Project PERMIT / BI	ue Date 12/02/201 t Status ID CD SE Scale
Cons Client ORAN 400 E 15253 Draw MAC JEB File N Cons Cons Cons	AGE COUNT SOUTH STREINDO, FL 3280 ect Number in By c kked By Name ultant • Seal/S SAME Source Consultinc CA-00062 935 LARE BALDOW ORLANDO, FL TEL: 407-767 FAX: 407-767 FAX: 407-767 VWW.SGMEKGINE OPT/RIGHT © 2014 SGM 1 SGM #: 2016	Signature	Issu Project PERMIT / BI	ue Date 12/02/201 Status D CD SE Scale S NOTEL
Cons Client ORAN 400 E 15253 Draw MAC JEB File N Cons Cons Cons	AGE COUNT SOUTH STREINDO, FL 3280 ect Number in By c sked By Name ultant • Seal/S C SGINEE CA-000620 935 LAKE BALDON ORLANDO, FL TEL: 407-767 WWW.SGMENGEE CA-000620 935 LAKE BALDON ORLANDO, FL TEL: 407-767 SGM #: 2016	Signature	Issu Project PERMIT / BI A	ue Date 12/02/201 Status D CD SE Scale S NOTE
Cons Client ORAN 400 E 15253 Draw MAC JEB File N Cons Cons Cons	AGE COUNT SOUTH STREENDO, FL 3280 ect Number in By C iked By Name ultant • Seal/S GONSULTINC CA-000620 935 LAKE BALDON ORLANDO, FL TEL: 407-767 FAX: 407-767 STREE 2016 ORLANDO, FL 3200 STREENDON SCA-0000620 935 LAKE BALDON ORLANDO, FL 3200 STREENDON SCA-0000620 935 LAKE BALDON ORLANDO, FL 3200 STREENDON SCA-0000620 935 LAKE BALDON ORLANDO, FL 3200 STREENDON SCA-0000620 935 LAKE BALDON ORLANDO, FL 3200 STREENDON SCA-0000620 935 LAKE BALDON SCA-0000620 935 LAKE BALDON SCA-000620 935 LAKE BALDON SCA-000600 935 LAKE BALDON SCA-000620 935 LAKE BALDON SCA-000	Signature	Issu Project PERMIT / BI A ARD BALL-F	ue Date 12/02/201 Status D CD SE Scale S NOTE
Cons Client ORAN 400 E 15253 Draw MAC JEB File N Cons Cons Cons	Adme Adme Addme Addme A	Signature	Issu Project PERMIT / BI A ARD BALL-F	ue Date 12/02/201 Status D CD SE Scale S NOTEL

## M0.01

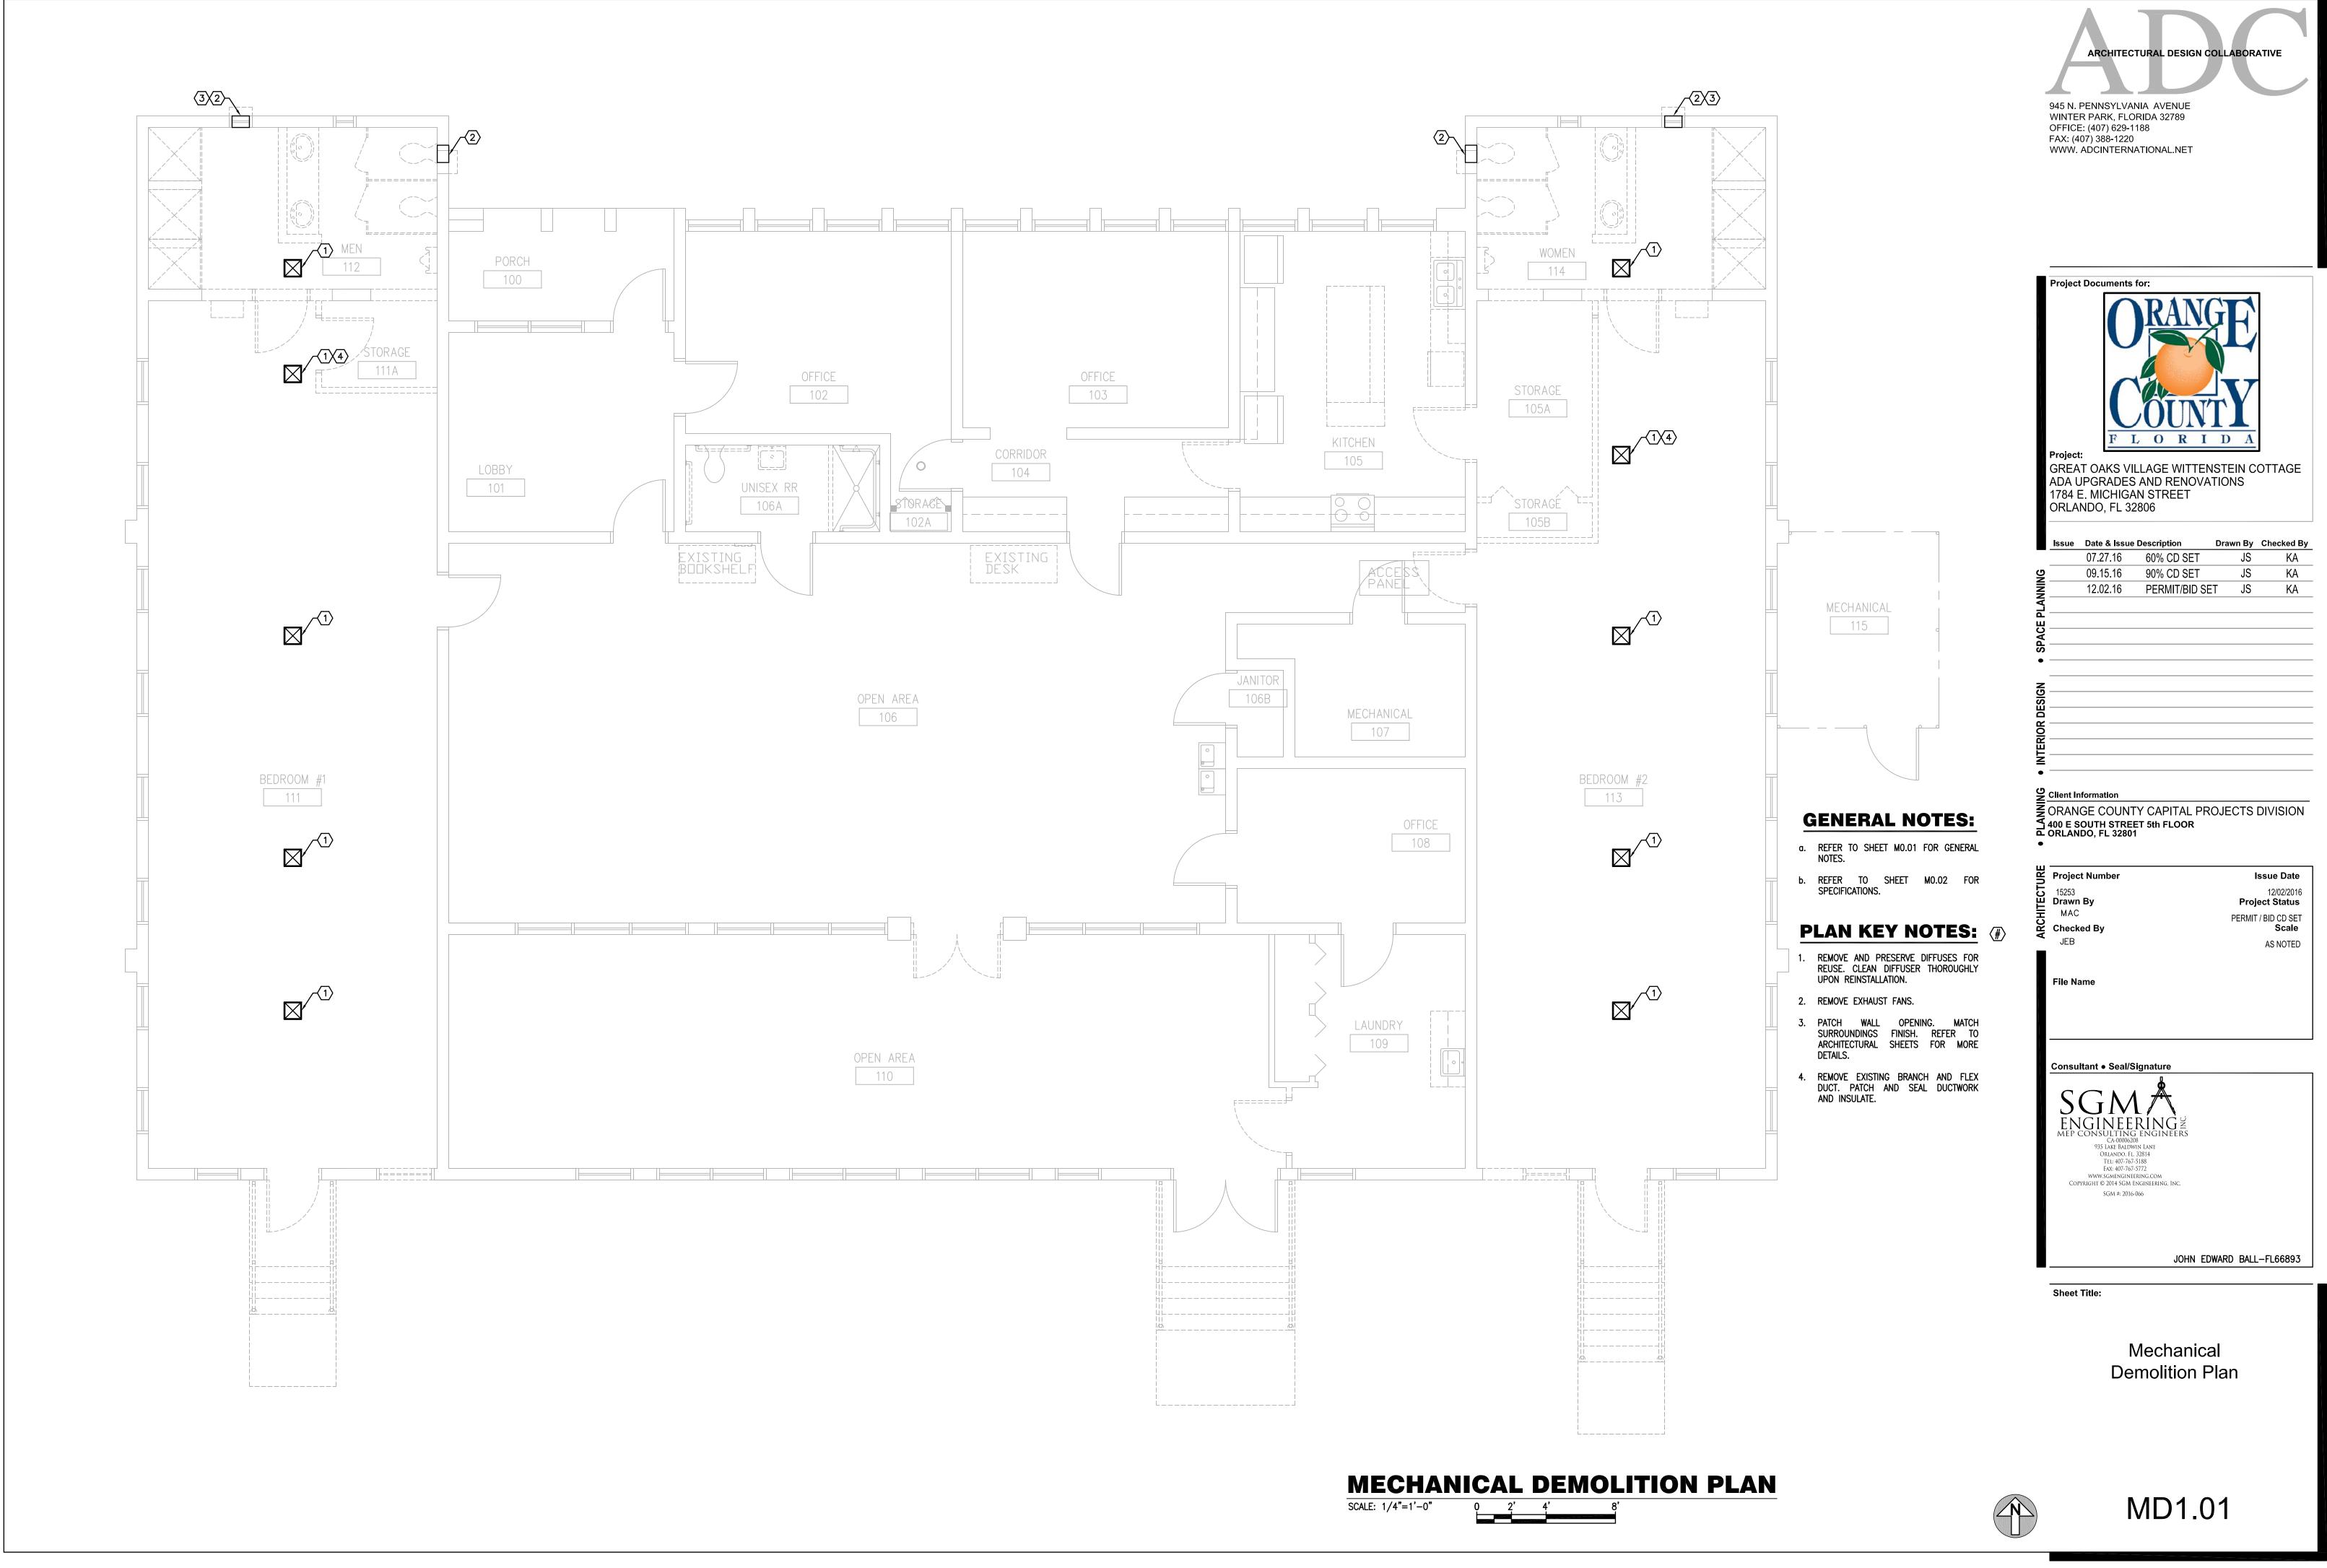


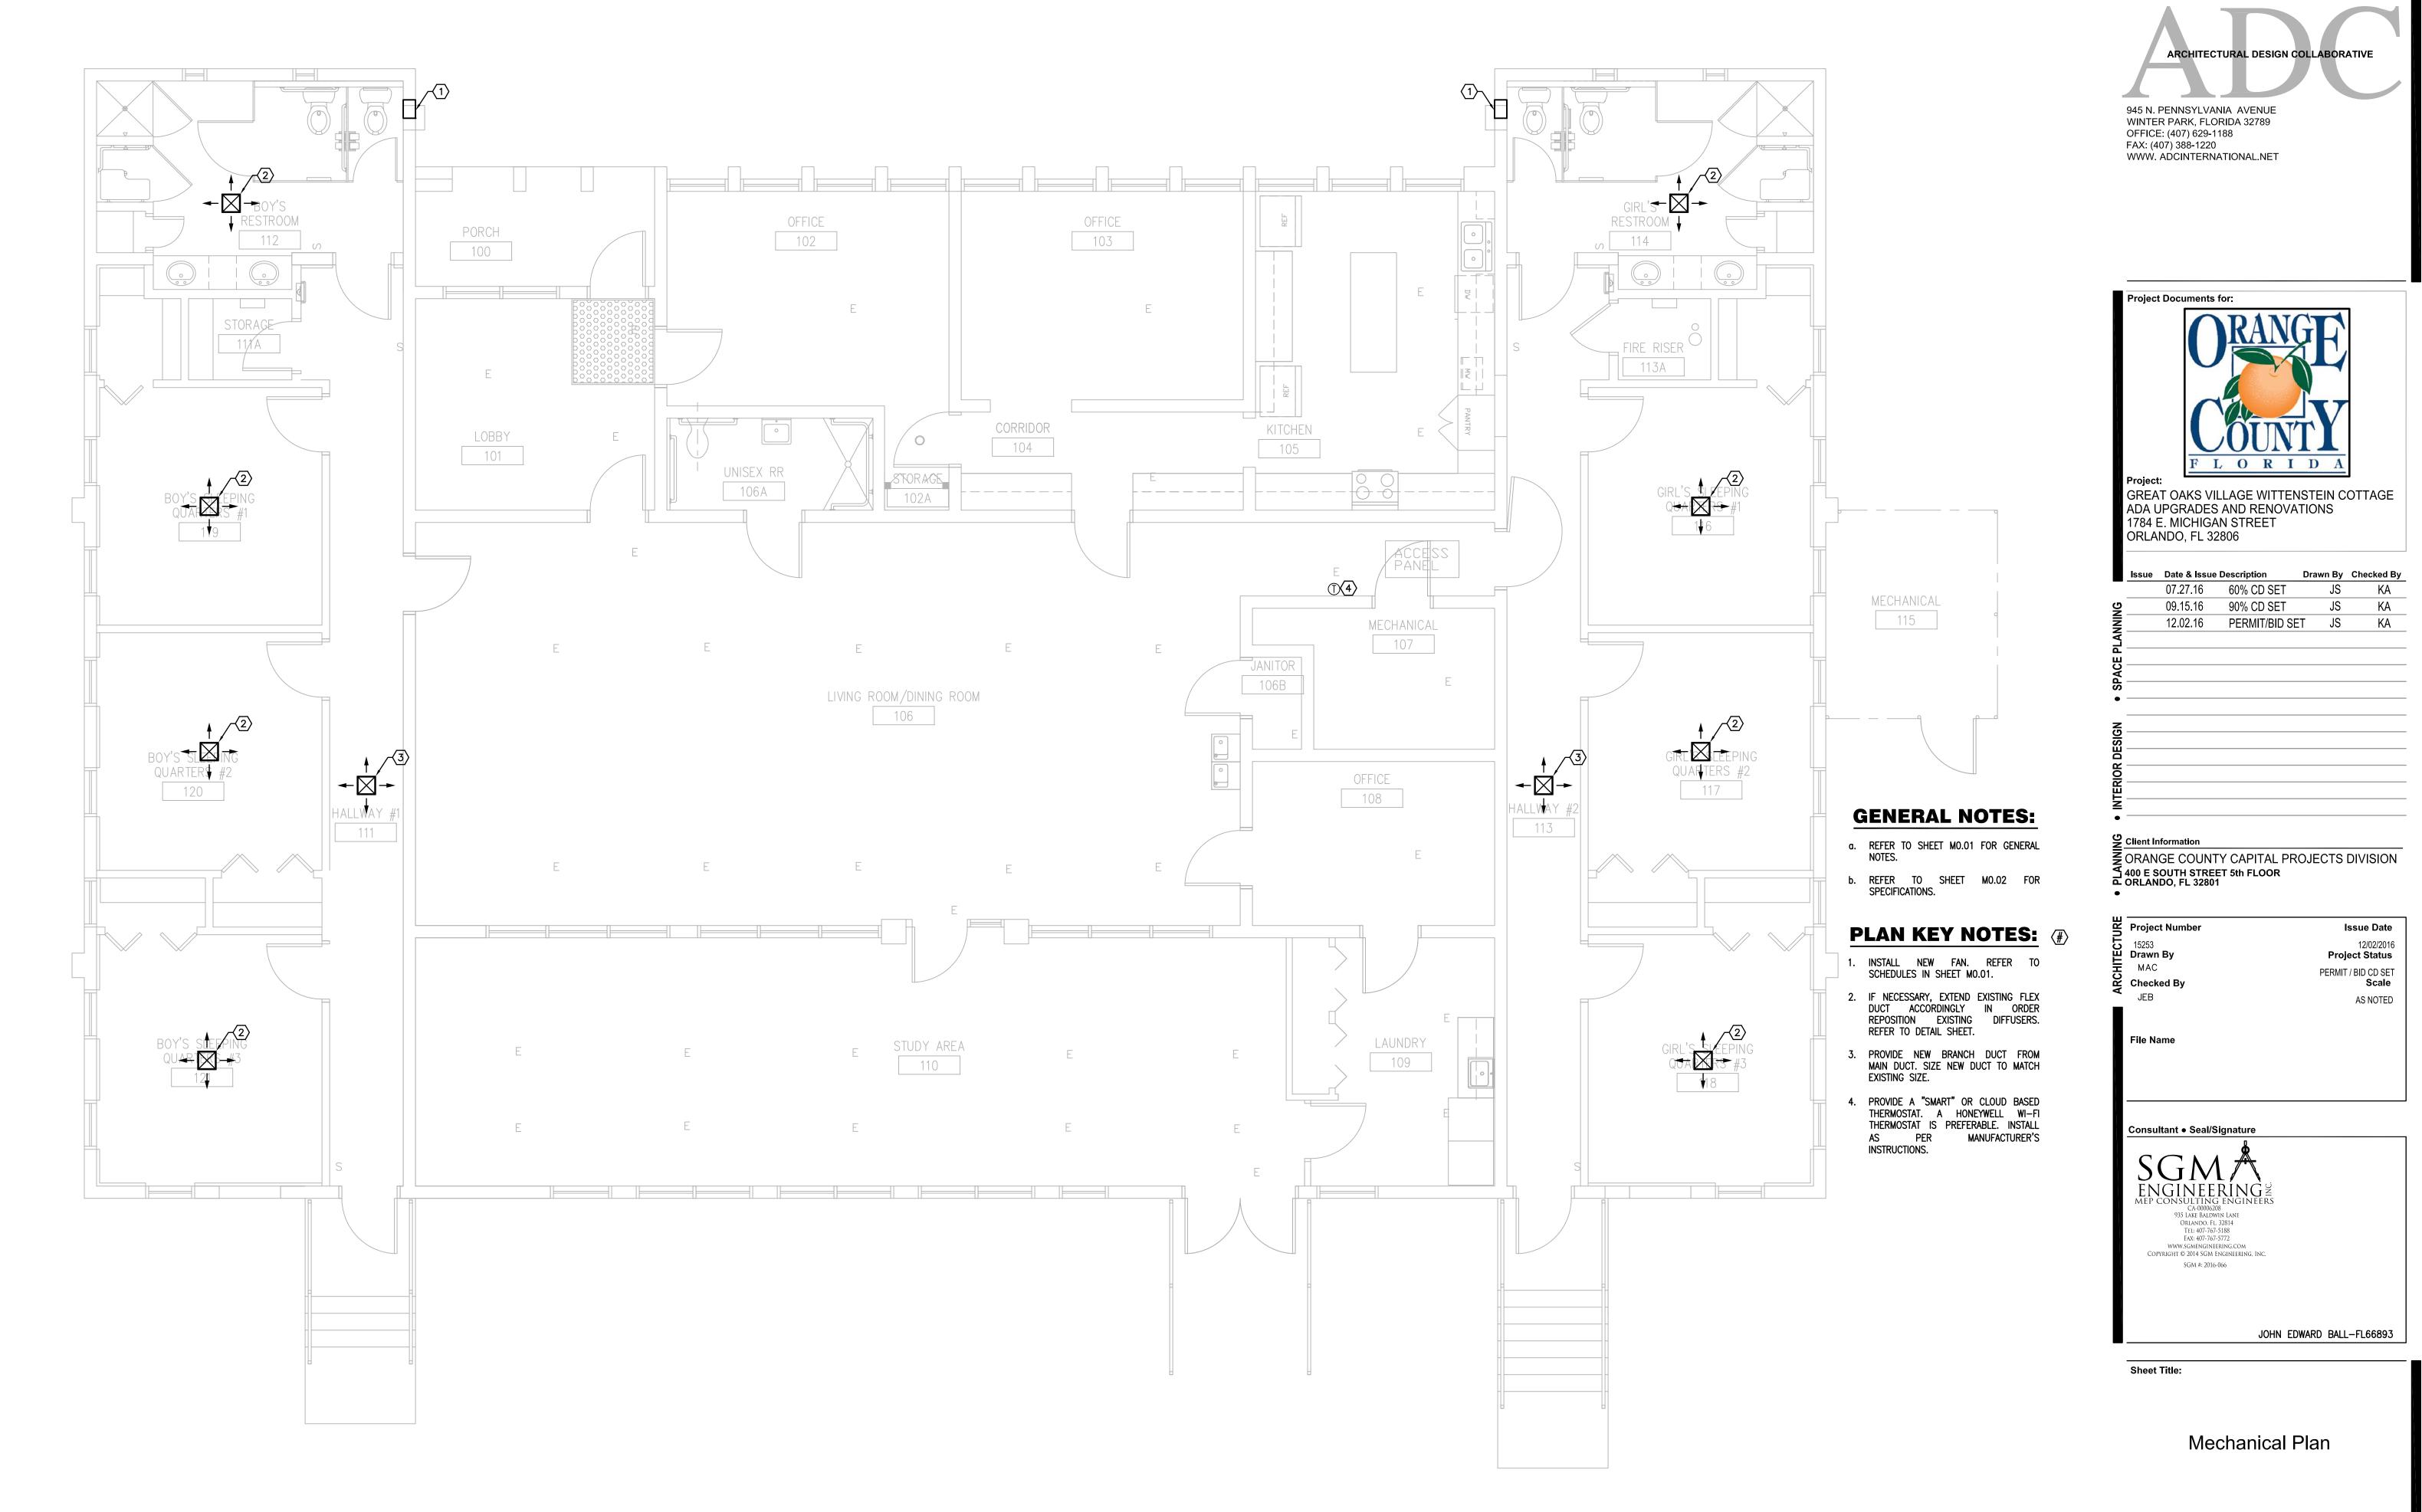

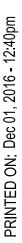







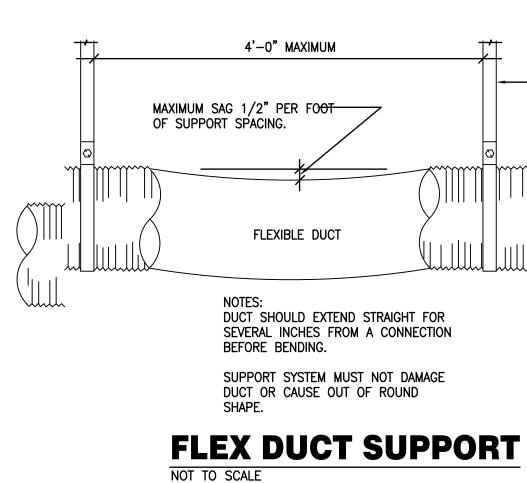


## **FLEX DUCT CONNECTION DETAIL** NOT TO SCALE

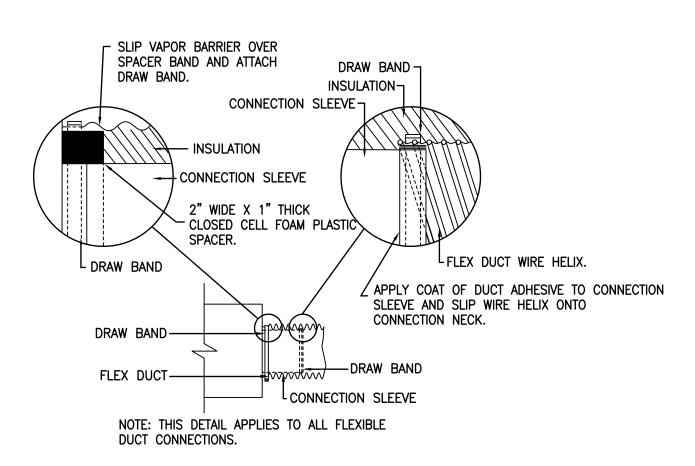


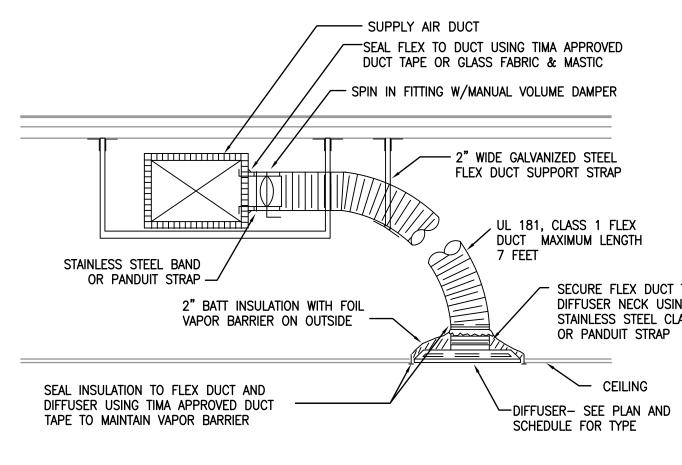

### **DUCT TO SUPPLY DIFFUSER CONN. DETAIL** NOT TO SCALE

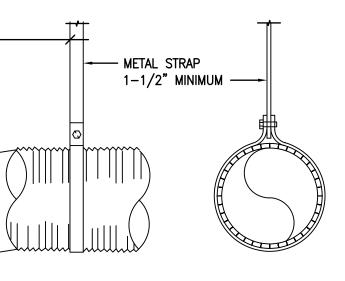



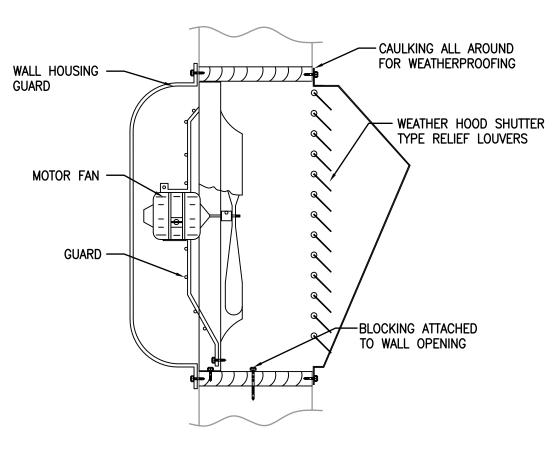

WALL EXHAUST FAN NOT TO SCALE

ARCHITECTURAL DE	SIGN COLLABORATIVE
945 N. PENNSYLVANIA AVENI	
WINTER PARK, FLORIDA 3278 OFFICE: (407) 629-1188 FAX: (407) 388-1220	
WWW. ADCINTERNATIONAL.N	ET
Project Documents for:	
Project: GREAT OAKS VILLAGE W	
ADA UPGRADES AND RE 1784 E. MICHIGAN STREE ORLANDO, FL 32806	
Issue Date & Issue Description	Drawn By Checked By
07.27.16 60% CD 09.15.16 90% CD	SET JS KA
	/BID SET JS KA
Client Information	
400 E SOUTH STREET 5th FLO ORLANDO, FL 32801	
Project Number	Issue Date
15253 <b>Drawn By</b> MAC	12/02/2016 Project Status
Checked By JLM	PERMIT / BID CD SET <b>Scale</b> AS NOTED
File Name	
Consultant ● Seal/Signature	]
SGMÅ	
MEP CONSULTING ENGINEE CA-00006208 935 Lake Baldwin Lane	
ORLANDO, FL. 32814 Tel: 407-767-5188 Fax: 407-767-5772 WWW.SGMENGINFERING.COM Copyright © 2014 SGM Engineering. Inc	
SGM #: 2016-066	
J( 	DHN EDWARD BALL-FL66893
Sheet Title:	
Mechanica	al Details
Mechanica	al Details

- SECURE FLEX DUCT TO DIFFUSER NECK USING STAINLESS STEEL CLAMP OR PANDUIT STRAP

CEILING

M5.01

	IG FIXTURES	POWER	DEVICES
<b>o</b>	1'x4' FLUORESCENT FIXTURE	Φ	SINGLE RECEPTACLE
0	2'x2' FLUORESCENT FIXTURE	ŧ	DUPLEX RECEPTACLE
		<b>—</b>	DOUBLE DUPLEX RECEPTACLE
<b>o</b>	2'x4' FLUORESCENT FIXTURE	€=	ABOVE COUNTER DUPLEX RECEPTACLE
	4' WALL MOUNT FLUORESCENT LUMINAIRE	<del>o</del>	DUPLEX RECEPTACLE, HALF SWITCHED
	4' WALL MOUNT FLUORESCENT LUMINAIRE, EMERGENCY	$\bigcirc$	SPECIAL PURPOSE RECEPTACLE
	1'x4' FLUORESCENT FIXTURE, BATTERY/EMERGENCY	°⊕	BLACK DUPLEX RECEPTACLE FOR COMPUTER WORKSTATION
			BLACK DUPLEX RECEPTACLE FOR COMPUTER WORKSTATION
<b>e</b>	2'x2' FLUORESCENT FIXTURE, BATTERY/EMERGENCY	°€	BLACK QUAD RECEPTACLE FOR COMPUTER WORKSTATION
	2'x4' FLUORESCENT FIXTURE, BATTERY/EMERGENCY	æ	CEILING MOUNTED RECEPTACLE
		<b>₽</b> ^F	RECESSED FLOOR RECEPTACLE
	4' FLUORESCENT STRIP FIXTURE		
⊢●──┤	4' FLUORESCENT STRIP FIXTURE, BATTERY/EMERGENCY		DUPLEX RECEPTACLE, GROUND FAULT
⊢∽ݤ──┤	4' FLUORESCENT STRIP FIXTURE, WALL MOUNTED		DUPLEX RECEPTACLE, GROUND FAULT, ABOVE COUNTER
<b>⊢_</b> ¶	4' FLUORESCENT STRIP FIXTURE, WALL MOUNTED,	▦	QUAD RECEPTACLE, GROUND FAULT
	BATTERY/EMERGENCY	PP	POWER POLE
	TRACK FIXTURE		DISCONNECT SWITCH
0	CEILING MOUNTED RECESSED, DOWN LIGHT		DISCONNECT SWITCH
0	CEILING MOUNTED RECESSED, EMERGENCY DOWN LIGHT	$(\mathbf{J})$	JUNCTION BOX
$\diamond$	CEILING MOUNTED RECESSED, WALL WASHER (ARROW	Ū	FLOOR MOUNTED JUNCTION BOX
	INDICATES DIRECTION OF WASH)	С	EQUIPMENT CONNECTION
Q	SURFACE MOUNTED LIGHTING FIXTURE		
$\mathbf{\Phi}$	WALL MOUNTED SCONCE FIXTURE, BATTERY/EMERGENCY	•	DOOR BELL PUSH BUTTON
Ð	EMERGENCY LIGHT FIXTURE	Т	TRANSFORMER
$\overline{\mathbf{X}}$	SINGLE FACE EXIT LIGHT FIXTURE ARROW	<b>С</b> Н	DOOR BELL
Ś	INDICATES DIRECTION OF EGRESS	$\sum$	
$\overline{\mathbf{x}}$	DOUBLE FACE EXIT LIGHT FIXTURE ARROW INDICATES	$\mathcal{N}$	MOTOR
	DIRECTION OF EGRESS		GROUND BUS BAR
SWITCH	ES		
\$	SWITCH	<b>FIRE AL</b>	ARM SYSTEM
\$2	SWITCH, 2 POLE		
\$2 \$3	SWITCH, 3-WAY	P	MANUAL FIRE ALARM PULL STATION
\$ _M	MOTOR RATED SWITCH	SA	FIRE ALARM COMBINATION SPEAKER/STROBE DEVICE (75 CANDELA MINIMUM, 110 CANDELA WHERE NOTED)
\$ _D	DIMMER SWITCH		
LIGHTIN	IG CONTROL DEVICES	ĭ X X X	FIRE ALARM COMBINATION HORN/STROBE DEVICE (75 CANDELA MINIMUM, 110 CANDELA WHERE NOTED)
		. ക	
CI	*PIR-CEILING MOUNT SENSOR 24 VDC/VAC, 11mA,	ΗĘ	FIRE ALARM STROBE ONLY, 75 CANDELA MINIMUM
	WATTSTOPPER CI-205 OR EQUAL.	F	FIRE ALARM SPEAKER - CEILING MOUNTED
DT	*DUAL ULTRASONIC/PIR-CEILING MOUNT SENSOR, 24 VDC/VAC, 35mA. WATTSTOPPER DT-305 OR EQUAL.		FIRE ALARM SPEAKER - WALL MOUNTED
-	, .	$\square$	135' HEAT DETECTOR
Ŵ	*DUAL ULTRASONIC/PIR-WALL MOUNT SENSOR, 24 VAC/VDC, 35mA. WATTSTOPPER DT-205 OR EQUAL.	(↓ _F	
^	*ULTRASONIC-CEILING CORRIDOR MOTION SENSOR, 24	( <b>↓</b> ) _R	HEAT DETECTOR – RATE OF RISE ONLY
< </td <td>VDC/VAC, 40mA. WATTSTOPPER WT-2250 OR EQUAL.</td> <td>(J_{R∕F}</td> <td>HEAT DETECTOR - COMBINATION: RATE OF RISE AND FIXED TEMP</td>	VDC/VAC, 40mA. WATTSTOPPER WT-2250 OR EQUAL.	(J _{R∕F}	HEAT DETECTOR - COMBINATION: RATE OF RISE AND FIXED TEMP
	PIR-WALL SWITCH DECORATOR MOTION SENSOR, 120/277 VAC,		
\$	800/1200W. WATTSTOPPER PW-100 OR EQUAL.	()	SMOKE DETECTOR
D1	DUAL ULTRASONIC/PIR-WALL SWITCH DECORATOR MOTION	SO	DUCT SMOKE DETECTOR $-$ "R" = RETURN, "S" = SUPPLY.
	SENSOR, 120/277VAC, 800/1200W. WATTSTOPPER DW-100 OR EQUAL.	^S ⊘≔-	PROVIDE LED SUPERVISORY INDICATOR FOR BOTH DETECTORS IN AN ACCESSIBLE LOCATION AND CLEARLY LABELED.
D2	DUAL ULTRASONIC/PIR-DUAL RELAY WALL SWITCH DECORATOR	-\$	
UZ	MOTION SENSOR, 120/277VAC, 800/1200W. WATTSTOPPER	f Z	DUCT SMOKE DETECTOR REMOTE TEST INDICATOR
_	DW-200 OR EQUAL. DUAL ULTRASONIC/PIR-MULTI-WAY WALL SWITCH DECORATOR	AIM	ADDRESSABLE INPUT MODULE
D3	MOTION SENSOR, 120/277VAC, 800/1200W. WATTSTOPPER	AOM	ADDRESSABLE OUTPUT MODULE
	DW-103 OR EQUAL.	MM	MONITOR MODULE
Р	POWER PACK 120/277 VAC; 20 AMPS, 225mA SECONDARY.		
	WATTSTOPPER BZ-150 OR EQUAL.	CM	CONTROL MODULE RELAY
	*FOR LOW VOLTAGE OCCUPANCY SENSORS, PROVIDE POWER PACK(S) 120/277 VAC; 20 AMPS, 225mA SECONDARY AS	<u>, WF</u> ,	WEATHERPROOF WATER FLOW SWITCH MONITOR MODULE CONNECTED SPRINKLER SYSTEM
	NEEDED FOR ZONE/AREA CONTROL. WATTSTOPPER BZ-150 OR		
	EQUAL.	<del>, VS ,</del>	WEATHERPROOF TAMPER SWITCH MONITOR MODULE CONNECTED TO SPRINKLER SYSTEM
POWER	DISTRIBUTION	"FACU"	FIRE ALARM CONTROL UNIT "FACU"
	120/208V PANELBOARD, RECESSED	<u>"FAAP"</u>	
	120/208V PANELBOARD, SURFACE MOUNT		FIRE ALARM ANNUNCIATOR PANEL "FAAP"
	,	"FATC"	FIRE ALARM TERMINAL CABINET "FATC", NEMA 1 RATED
	277/480V PANELBOARD, SURFACE MOUNT	<u>"FACP"</u>	FIRE ALARM CONTROL PANEL "FACP"
	277/480V PANELBOARD, RECESSED		
$\frown$	FEEDER OR BRANCH CIRCUIT CONCEALED IN WALL,	DDENALC	E DISTRIBUTION SYSTEM
	CEILING OR FLOOR HOMERUN CONSISTING OF ONE SINGLE-PHASE, 1-POLE	rnewij3	
1R1-1	CIRCUIT: (2) 12 AWG + (1) 12 AWG GND IN $3/4$ " CONDUIT,	[	
	UNLESS OTHERWISE NOTED. PANELBOARD AND CIRCUIT	r	
	DESIGNATION ARE INDICATED.		(P)OLE, (R)ACEWAY, (D)OUBLE GANG FLUSH, (PD) PEDESTAL
	HOMERUN CONSISTING OF ONE SINGLE-PHASE, 2-POLE		N = # OF DATA JACKS
1M1-1:3	CIRCUIT: (2) 12 AWG + (1) 12 AWG GND IN $3/4$ " CONDUIT,	│	COMMUNICATIONS "INFORMATION OUTLET" MOUNTED. AT RECE
	UNLESS OTHERWISE NOTED. PANELBOARD AND CIRCUIT DESIGNATIONS ARE INDICATED.	C X N	HEIGHT UNLESS OTHERWISE NOTED. MODULE AND FACEPLATE
			SPECIAL NOTES:
	HOMERUN CONSISTING OF TWO SINGLE-PHASE CIRCUITS: (3)		
	12 AWG + (1) 12 AWG GND IN 3/4" CONDUIT, UNLESS		1. DATA JACKS: EACH RJ45 CAT6 JACK FOR DATA SHALL BE CONNECTED
1R1-1,3	OTHERWISE NOTED. PANELBOARD AND CIRCUIT DESIGNATION ARE INDICATED.		DEDICATED UTP 4 PR CAT6 CABLE
1R1-1,3	ARE INDICATED.	<b>◄</b> [₩] F1	WALL TELEPHONE OUTLET FOR HOUSE PHONE. MOUNTED AT 52
1R1-1,3			FINISHED FLOOR TO TOP.
	HOMERUN CONSISTING OF THREE SINGLE-PHASE CIRCUITS: (4) 12 AWG + (1) 12 AWG GND IN $3/4$ " CONDUIT, UNLESS	<b>■</b> F1	
	HOMERUN CONSISTING OF THREE SINGLE-PHASE CIRCUITS: (4) 12 AWG + (1) 12 AWG GND IN 3/4" CONDUIT, UNLESS OTHERWISE NOTED. PANELBOARD AND CIRCUIT DESIGNATIONS		
	HOMERUN CONSISTING OF THREE SINGLE-PHASE CIRCUITS: (4) 12 AWG + (1) 12 AWG GND IN 3/4" CONDUIT, UNLESS OTHERWISE NOTED. PANELBOARD AND CIRCUIT DESIGNATIONS ARE INDICATED.		
	HOMERUN CONSISTING OF THREE SINGLE-PHASE CIRCUITS: (4) 12 AWG + (1) 12 AWG GND IN 3/4" CONDUIT, UNLESS OTHERWISE NOTED. PANELBOARD AND CIRCUIT DESIGNATIONS ARE INDICATED. HOMERUN CONSISTING OF ONE THREE-PHASE CIRCUITS: (3)	⊲sx	FLOOR TO TOP OF BACKBOX. $X = \#$ OF DATA JACKS
1R1-1,3,5	<ul> <li>HOMERUN CONSISTING OF THREE SINGLE-PHASE CIRCUITS:</li> <li>(4) 12 AWG + (1) 12 AWG GND IN 3/4" CONDUIT, UNLESS OTHERWISE NOTED. PANELBOARD AND CIRCUIT DESIGNATIONS ARE INDICATED.</li> <li>HOMERUN CONSISTING OF ONE THREE-PHASE CIRCUITS: (3) 12 AWG + (1) 12 AWG GND IN 3/4" CONDUIT, UNLESS OTHERWISE NOTED. PANELBOARD AND CIRCUIT DESIGNATIONS</li> </ul>		FLOOR TO TOP OF BACKBOX. $X = \#$ OF DATA JACKS
1R1-1,3,5	HOMERUN CONSISTING OF THREE SINGLE-PHASE CIRCUITS: (4) 12 AWG + (1) 12 AWG GND IN 3/4" CONDUIT, UNLESS OTHERWISE NOTED. PANELBOARD AND CIRCUIT DESIGNATIONS ARE INDICATED. HOMERUN CONSISTING OF ONE THREE-PHASE CIRCUITS: (3) 12 AWG + (1) 12 AWG GND IN 3/4" CONDUIT, UNLESS	⊲sx	FLOOR TO TOP OF BACKBOX. $X = #$ of data jacks FLOOR BOX data outlet. Data outlet installed in Floor E UTP HOMERUN TO COMM ROOM. $X = #$ of data jacks
1R1-1,3,5	<ul> <li>HOMERUN CONSISTING OF THREE SINGLE-PHASE CIRCUITS:</li> <li>(4) 12 AWG + (1) 12 AWG GND IN 3/4" CONDUIT, UNLESS OTHERWISE NOTED. PANELBOARD AND CIRCUIT DESIGNATIONS ARE INDICATED.</li> <li>HOMERUN CONSISTING OF ONE THREE-PHASE CIRCUITS: (3) 12 AWG + (1) 12 AWG GND IN 3/4" CONDUIT, UNLESS OTHERWISE NOTED. PANELBOARD AND CIRCUIT DESIGNATIONS</li> </ul>	↓sx	FLOOR TO TOP OF BACKBOX. $X = #$ OF DATA JACKS FLOOR BOX DATA OUTLET. DATA OUTLET INSTALLED IN FLOOR E UTP HOMERUN TO COMM ROOM. $X = #$ OF DATA JACKS 3/4" PLYWOOD BACKBOARD. BY DIVISION 16
1R1-1,3,5	<ul> <li>HOMERUN CONSISTING OF THREE SINGLE-PHASE CIRCUITS:</li> <li>(4) 12 AWG + (1) 12 AWG GND IN 3/4" CONDUIT, UNLESS OTHERWISE NOTED. PANELBOARD AND CIRCUIT DESIGNATIONS ARE INDICATED.</li> <li>HOMERUN CONSISTING OF ONE THREE-PHASE CIRCUITS: (3) 12 AWG + (1) 12 AWG GND IN 3/4" CONDUIT, UNLESS OTHERWISE NOTED. PANELBOARD AND CIRCUIT DESIGNATIONS</li> </ul>	⊲sx	FLOOR TO TOP OF BACKBOX. $X = #$ OF DATA JACKS FLOOR BOX DATA OUTLET. DATA OUTLET INSTALLED IN FLOOR E UTP HOMERUN TO COMM ROOM. $X = #$ OF DATA JACKS 3/4" PLYWOOD BACKBOARD. BY DIVISION 16 TELEVISION OUTLET MOUNTED AT 96" ABOVE FINISHED FLOOR.
1R1-1,3,5	<ul> <li>HOMERUN CONSISTING OF THREE SINGLE-PHASE CIRCUITS:</li> <li>(4) 12 AWG + (1) 12 AWG GND IN 3/4" CONDUIT, UNLESS OTHERWISE NOTED. PANELBOARD AND CIRCUIT DESIGNATIONS ARE INDICATED.</li> <li>HOMERUN CONSISTING OF ONE THREE-PHASE CIRCUITS: (3) 12 AWG + (1) 12 AWG GND IN 3/4" CONDUIT, UNLESS OTHERWISE NOTED. PANELBOARD AND CIRCUIT DESIGNATIONS</li> </ul>	↓sx	FLOOR BOX DATA OUTLET. DATA OUTLET INSTALLED IN FLOOR EUTP HOMERUN TO COMM ROOM. $X = #$ of data jacks

TYPE	DESCRIPTION	DESIGN SELECTION	DESIGN SELECTION	DESIGN SELECTION	VOLTS	LAMPS/FIXT.
A	6" RECESSED LED DOWNLIGHT. RETROFIT KIT AND SEPARATE CAN.	CREE # CR6 800L 30K E26 PROVIDE WITH NEW RETROFIT HOUSING	APPROVED EQUAL	APPROVED EQUAL	120	LED 800 LUMENS
В	SURFACE LED WRAPAROUND	RAB # GUS 436 YW	APPROVED EQUAL	APPROVED EQUAL	120	LED 4100 LUMENS
С	6" RECESSED LED DOWNLIGHT OVER MIRROR. RETROFIT KIT AND SEPARATE CAN.	CREE # CR6 800L 30K E26 PROVIDE WITH NEW RETROFIT HOUSING	APPROVED EQUAL	APPROVED EQUAL	120	LED 800 LUMENS
F	FLUSH MOUNTED LED LOW LEVEL STEP LIGHT	JUNO# IC113 LED-3K-840WH	APPROVED EQUAL	APPROVED EQUAL	120	LED (6 WATTS)
EM	SURFACE MOUNTED 2 HEAD EMERGENCY LIGHT	BEHGELLI# PEH-1	APPROVED EQUAL	APPROVED EQUAL	120	LED
X1	UNIVERSAL MOUNTED SINGLE FACE EXIT LIGHT	BEHGELLI# UNOSALR 1W	APPROVED EQUAL	APPROVED EQUAL	120	LED
X2	UNIVERSAL MOUNTED DOUBLE FACE EXIT LIGHT	BEHGELLI# UNOSALR 2W	APPROVED EQUAL	APPROVED EQUAL	120	LED

## **ABBREVIATIONS**

A	AMPERES	INC	IN
AE	AUDIO ENHANCEMENT	JB	JU
AFC	ABOVE FINISHED CEILING	kV	KIL
AFF	ABOVE FINISHED FLOOR	kVA	KIL
AFG	ABOVE FINISHED GRADE	kVAR	KIL
AIC	AMPERES INTERRUPTING		AM
	CAPACITY	kW	KIL
AL	ALUMINUM	kWH	KIL
AWG	AMERICAN WIRE GAUGE	LTG	LIC
BFC	BELOW FINISHED CEILING	m	ME
BFG	BELOW FINISHED GRADE	mm	MI
С	CONDUIT	MAX	MA
CAB	CABINET	MCB	MA
CFCI	CONTRACTOR FURNISHED	MCC	MC
	CONTRACTOR SUPPLIED	MCP	MC
CKT	CIRCUIT	MFR	MA
CLG	CEILING	МН	ME
CL	CENTERLINE	MIN	MI
CT's	CURRENT TRANSFORMERS	MISC	MIS
CU	COPPER	MTR	MC
DISC	DISCONNECT(ING)	MTD	MC
DWG	DRAWING(S)	MTG	MC
EA	EACH	NEC	NA
EF	EXHAUST FAN	OFOI	OW
EMT	ELECTRICAL METALLIC TUBING		OW
EQUIP	EQUIPMENT	PNL	PA
EUH	ELECTRIC UNIT HEATER	PSI	PU
EWC	ELECTRIC WATER COOLER	PVC	PC
EWH	ELECTRIC WATER HEATER	REC	RE
EXH	EXHAUST	RGS	RIC
EXIST	EXISTING	TEL	TE
EXP	EXPLOSION PROOF	TYP	TY
FA	FIRE ALARM	UON	UN
FLA	FULL LOAD AMPERES	V	VO
FLUOR	FLUORESCENT	VA	VO
GFCI	GROUND FAULT CIRCUIT	VFD	VA
	INTERRUPTER	W	WA
GFP	GROUND FAULT PROTECTION	WP	WE
GND	GROUND	XFMR	TR
HGT	HEIGHT		
HID	HIGH INTENSITY DISCHARGE		
HPS	HIGH PRESSURE SODIUM		
HOA	HAND-OFF-AUTOMATIC		
HP	HORSEPOWER		
HVAC	HEATING/VENTILATING/		
	AIR CONDITIONING		
HV	HIGH VOLTAGE		

INCANDESCENT
JUNCTION BOX
KILO-VOLTS KILO-VOLTS-AMPERES
KILO-VOLTS-
AMPERES REACTIVE
KILO-WATTS
KILO-WATT-HOURS
LIGHTING
METER
MILLIMETER
MAXIMUM
MAIN CIRCUIT BREAKER
MOTOR CONTROL CENTER
MOTOR CIRCUIT PROTECTOR
MANUFACTURER
METAL HALIDE
MISCELLANEOUS
MOTOR MOUNTED
MOUNTING
NATIONAL ELECTRICAL CODE
OWNER FURNISHED
OWNER INSTALLED
PANEL
PULL STATION INSIDE
POLYVINYL CHLORIDE
RECEPTACLE
RIGID GALVANIZED STEEL
TELEPHONE
TYPICAL
UNLESS OTHERWISE NOTED
VOLTS
VOLT-AMPERES
VARIABLE FREQUENCY DRIVE
WATTS
WEATHER PROOF
TRANSFORMER

### **BUTION SYSTEM**

	ARCHITEC	TURAL DESIGN CO	DLLABORATI	VE
		NIA AVENUE		
OFFICE FAX: (4	E: (407) 629-1 07) 388-1220			
Project	Documents	for:		
	C	RAN	E	
Project	-			
GREA ADA U 1784 E	T OAKS VI JPGRADES	ILLAGE WITTEN S AND RENOVAT AN STREET 2806		TAGE
Issue	Date & Issue 07.27.16	e Description 60% CD SET	Drawn By Cl JS	necked   KA
	09.15.16 12.02.16	90% CD SET PERMIT/BID SET	JS	KA
ORAN 400 e s		TY CAPITAL PRO ET 5th FLOOR 1	DJECTS DIV	/ISIOI
ORAN 400 E S ORLAN Projec	GE COUN ⁻ OUTH STRE	ET 5th FLOOR	Issu	ue Date
ORAN 400 E S ORLAN	GE COUN ⁻ OUTH STRE DO, FL 3280 t Number	ET 5th FLOOR	lssı Project	ue Date 2/02/201 Status
ORAN 400 E S ORLAN Projec 15253 Drawn	GE COUN ⁻ OUTH STRE DO, FL 3280 t Number By	ET 5th FLOOR	lssu Project PERMIT / BI	ue Date 2/02/201 Status D CD SE Scale
ORAN 400 E S ORLAN Projec 15253 Drawn JJB Check	GE COUN ⁻ OUTH STRE DO, FL 3280 t Number By ed By	ET 5th FLOOR	lssu Project PERMIT / BI	ue Date 2/02/201 Status
ORAN 400 E S ORLAN Projec 15253 Drawn JJB Check JLM	GE COUN OUTH STRE DO, FL 3280 t Number By ed By	ET 5th FLOOR	lssu Project PERMIT / BI	ue Date 2/02/201 Status D CD SE Scale
ORAN 400 E S ORLAN Projec 15253 Drawn JJB Check JLM File Na	GE COUN OUTH STRE DO, FL 3280 t Number By ed By ame	ET 5th FLOOR	lssu Project PERMIT / BI	ue Date 2/02/201 Status D CD SE Scale
ORAN 400 E S ORLAN Projec 15253 Drawn JJB Check JLM File Na Consu	GE COUN OUTH STRE DO, FL 3280 t Number By ed By ed By ame Itant • Seal/S GINEE CONSULTING CA-00062 935 LAKE BALD ORLANDO, FL TEL: 407-767 FAX: 407-767 KAY: 407-777 KAY: 407-777 KAY: 407-7777 KAY: 407-77777 KAY: 407-77777777777777777777777777777777777	Signature	lssu Project PERMIT / BI	ue Date 2/02/201 Status D CD SE Scale
ORAN 400 E S ORLAN Projec 15253 Drawn JJB Check JLM File Na Consu	GE COUN OUTH STRE DO, FL 3280 t Number By ed By ed By ame Itant • Seal/S GINEE CA-00062 935 LAKE BALDY ORLANDO, FI TEL: 407-767 FAX: 407-767	Signature	lssu Project PERMIT / BI	ue Date 2/02/201 Status D CD SE Scale
ORAN 400 E S ORLAN Projec 15253 Drawn JJB Check JLM File Na Consu	GE COUN OUTH STRE DO, FL 3280 t Number By ed By ed By ame Itant • Seal/S GINEE CA-00062 935 LAKE BALD ORLANDO, FL TEL: 407-767 FAX: 407-767 KAY: 407-777 KAY: 407-777 KAY: 407-7777 KAY: 407-77777 KAY: 407-77777777777777777777777777777777777	Signature	lssu Project PERMIT / BI	ue Date 12/02/201 Status D CD SE Scale S NOTED
ORAN 400 E S ORLAN Projec 15253 Drawn JJB Check JLM File Na Consu	GE COUN OUTH STRE DO, FL 3280 t Number By ed By ed By ame ditant • Seal/S GINEE CA-00062 935 LAKE BALDO ORLANDO, FL TEL: 407-767 FAX: 407-767 WWW.SGMENGINE YRIGHT © 2014 SGM SGM #: 2016	Signature	Issu Project PERMIT / BI A	Je Date 12/02/201 Status D CD SE Scale S NOTEI
ORAN 400 E S ORLAN Projec 15253 Drawn JJB Check JLM File Na Consu	GE COUN OUTH STRE DO, FL 3280 t Number By ed By ed By ame Itant • Seal/S GINEE CA-00062 935 LAKE BALDY ORLANDO, FI TEL: 407-763 FAX: 40	Signature	Issu Project PERMIT / BI A	ue Date 12/02/201 Status D CD SE Scale S NOTED

E0.01

## **GENERAL NOTES:**

- C. NFPA 72 NATIONAL FIRE CODE D. FLORIDA FIRE PREVENTION CODE (2010)
- (WITHIN 4").
- 3. ABSOLUTELY NO SPLICES WILL BE ALLOWED IN ANY SYSTEMS WIRES. PROVIDE FULL LENGTH WIRING BETWEEN DEVICES AND TERMINALS.
- 4. PROVIDE RACEWAYS FOR ALL WIRING.
- DIMENSIONS.

- 11. WHERE INSTALLATION ABOVE COUNTER IS INDICATED, INSTALL ITEM 0'-1" FROM BOTTOM OF BACKBOX TO TOP OF COUNTER (OR BACKSPLASH IF SO EQUIPPED). HORIZONTALLY ALIGN BOTTOM OF ITEMS WHERE MORE THAN ONE IS LOCATED ABOVE THE SAME COUNTER.
- 12. VISIT THE EXISTING FACILITY AND CAREFULLY EXAMINE THOSE PORTIONS OF THE BUILDING AND SITE AFFECTED BY THIS WORK BEFORE SUBMITTING PROPOSALS, SO AS TO BECOME FAMILIAR WITH THE EXISTING CONDITIONS AND DIFFICULTIES THAT WILL AFFECT EXECUTION OF THE WORK. SUBMISSION OF A PROPOSAL WILL BE CONSTRUED AS EVIDENCE THAT SUCH EXAMINATION HAS BEEN MADE AND LATER CLAIMS FOR LABOR, EQUIPMENT OR MATERIALS REQUIRED BECAUSE OF DIFFICULTIES ENCOUNTERED WILL NOT BE RECOGNIZED.
- 13. ALL 120V, 20A BRANCH CIRCUIT CONDUCTORS SHALL UTILIZE #12 COPPER CONDUCTORS MINIMUM THROUGHOUT.
- 14. A. EXCEPT WHERE SPECIFICALLY NOTED OTHERWISE, THE CONTRACTOR SHALL PROVIDE NEW CONDUIT FOR ALL CONDUCTORS THAT ARE INSTALLED AS A PART OF THIS PROJECT. INSULATED PLASTIC BUSHINGS ARE TO BE PROVIDED ON ALL CONDUIT STUB-OUTS AND stub-ups.
- B. UNLESS SPECIFICALLY INDICATED OTHERWISE, ALL EQUIPMENT, CONDUIT, WIRE AND ALL REQUIRED ACCESSORIES AND REQUIRED AS PART OF THE INSTALLATION AND USE OF STATED EQUIPMENT SHALL BE PROVIDED BY THE CONTRACTOR AS A PART OF THIS PROJECT.

AND NFPA COMPLIANT.

DRAWINGS AND SPECIFICATIONS.

TOUCHED UP.


- 15. 120 VOLT BRANCH CIRCUITS, WHERE THE LENGTH OF CIRCUIT CONDUCTORS COMPLETE FROM CIRCUIT BREAKER IN SOURCE PANEL TO ANY DEVICE ON THE CIRCUIT IS 101-175 FEET FROM THE PANEL, ARE TO HAVE #10 MINIMUM BRANCH CIRCUIT WIRING HOMERUN (3/4"C.) FROM PANEL CIRCUIT BREAKER TO FIRST DEVICE AND #12 BRANCH CIRCUIT WIRING THROUGHOUT THE REMAINDER OF THE CIRCUIT (CONDUIT SIZE PER SPEC AND NEC). FIRST 75 FT. OF COMBINED HOMERUN AND BRANCH CIRCUIT TO BE MINIMUM #10 WIRE (3/4"C.).
- 16. 120 VOLT BRANCH CIRCUITS, WHERE THE LENGTH OF CIRCUIT CONDUCTORS COMPLETE FROM CIRCUIT BREAKER IN SOURCE PANEL TO ANY DEVICE ON THE CIRCUIT IS 151-225 FEET FROM THE PANEL, ARE TO HAVE #10 MINIMUM BRANCH CIRCUIT WIRING HOMERUN (3/4"C.) FROM PANEL CIRCUIT BREAKER TO FIRST DEVICE AND #10 BRANCH CIRCUIT WIRING THROUGHOUT THE REMAINDER OF THE CIRCUIT (3/4"C.).
- 17. 120 VOLT BRANCH CIRCUITS, WHERE THE LENGTH OF CIRCUIT CONDUCTORS COMPLETE FROM CIRCUIT BREAKER IN SOURCE PANEL TO ANY DEVICE ON THE CIRCUIT IS 226 FEET OR MORE FROM THE PANEL, ARE TO HAVE #8 MINIMUM BRANCH CIRCUIT WIRING HOMERUN (1"C.) FROM PANEL CIRCUIT BREAKER TO FIRST DEVICE AND #10 BRANCH CIRCUIT WIRING THROUGHOUT THE REMAINDER OF THE CIRCUIT (3/4"C.). FIRST 125 FT. OF COMBINED HOMERUN AND BRANCH CIRCUIT TO BE MINIMUM #8 WIRE (1"C.).


- 1. ALL ELECTRICAL WORK AND MATERIALS SHALL BE IN COMPLIANCE WITH ALL GOVERNING CODES AND STANDARDS. THIS SHALL INCLUDE BUT NOT BE LIMITED TO THE FOLLOWING. A. NFPA 70 NATIONAL ELECTRICAL CODE (2011 EDITION-FBC ADOPTED JUNE 30, 2015) B. FLORIDA BUILDING CODE (2014 5th EDITION)
- E. LOCAL REQUIREMENTS OF THE AUTHORITY HAVING JURISDICTION
- 2. COORDINATE ALL POWER AND SYSTEMS DEVICES SO THAT POWER RECEPTACLES AND VOICE/DATA OUTLETS ARE LOCATED AT THE SAME HEIGHT AND ADJACENT TO EACH OTHER
- 5. LOCATE LIGHT FIXTURES PRIOR TO THE INSTALLATION OF JUNCTION BOXES AND CONDUITS. HEIGHTS SHOWN ON THE DRAWINGS FOR A SPECIFIC ITEM TAKE PRECEDENCE OVER HEIGHTS INDICATED ON THIS SCHEDULE.
- 6. HEIGHTS REQUIRED BY THE CURRENT EDITION OF "AMERICANS WITH DISABILITIES ACT" AND ALL OTHER APPLICABLE CODES, STANDARDS, AND ORDINANCES TAKE PRECEDENCE OVER ALL OTHER DIMENSIONS, EXCEPT SPECIFIC HEIGHTS SHOWN ON DRAWINGS.
- 7. HEIGHTS REQUIRED BY EQUIPMENT SUPPLIERS TAKE PRECEDENCE OVER ALL OTHER
- 8. ALL HEIGHTS ON THIS SCHEDULE AND ON THE DRAWINGS ARE FROM FINISHED FLOOR OR GRADE TO TOP OF EXPOSED PORTION OF ITEM (ie. COVERPLATE, HOUSING, OR ENCLOSURE).
- 9. MAXIMUM ACCEPTABLE TOLERANCE OF ALL DIMENSIONS IS 1/16 INCH. ITEMS IN TILE SURFACES SHALL BE INSTALLED AS CLOSE AS POSSIBLE TO THE DIMENSION GIVEN AND SHALL BE HORIZONTALLY AND VERTICALLY CENTERED AND ALIGNED WITH THE TILE JOINTS. 10. LOCATE CEILING MOUNTED ITEMS AS SHOWN ON THE ARCHITECTURAL REFLECTED CEILING
- PLAN(S). WHERE ITEM IS SHOWN ON ELECTRICAL PLAN AND NOT SHOWN ON REFLECTED CEILING PLAN, CONSULT THE ARCHITECT AND LOCATE ACCORDINGLY.


- C. WHERE THE CONTRACTOR PROPOSES ALTERNATE SOLUTIONS, DIFFERENT ROUTINGS OF CONDUIT, DIFFERENT LOCATIONS OF EQUIPMENT, ETC., THE CONTRACTOR SHALL BE RESPONSIBLE FOR ALL OF THE RAMIFICATIONS OF THE PROPOSED CHANGE THAT ARE NOT INCLUDED IN HIS PROPOSAL, BUT BECOME APPARENT AT A LATER DATE, AND SHALL BEAR THE CONSEQUENCES OF CORRECTING ANY AND ALL CONFLICTS, DEFICIENCIES OR OTHER PROBLEMS AT NO INCREASE IN COST OR INCREASE IN CONSTRUCTION TIME ALLOTTED.
- D. THE INSTALLATION OF ALL DEVICES, INCLUDING MOUNTING HEIGHTS, SHALL BE FULLY ADA
- E. THE CONTRACTOR SHALL INCLUDE IN HIS SCOPE, (1) THE LABOR AND MATERIALS REQUIRED FOR CREATING OPENINGS FOR CONDUIT PENETRATIONS THROUGH WALLS. SLABS AND ROOF STRUCTURES, AS WELL AS THE SEALING OF THESE PENETRATIONS, AND (2) THE ROUTING OF CONDUITS AROUND IMPENETRABLE OBSTACLES, SUCH AS POURED-IN-PLACE BEAMS, COLUMNS, LINTELS AND SIMILAR OBSTRUCTIONS.
- F. THE CONTRACTOR SHALL VERIFY THE EXACT DIRECTION OF ALL DOOR SWINGS PRIOR TO ROUGH-IN OF BOXES MOUNTED IN WALLS.
- G. IF THE INTENT OF THE ARCHITECT/ENGINEER WITH REGARD TO ANY DETAIL IS NOT CLEAR, OR IS CAPABLE OF MORE THAN ONE INTERPRETATION, SUCH MATTERS SHALL BE BROUGHT TO THE A/E IN WRITING BEFORE THE SUBMISSION OF BIDS, AND THE A/E SHALL ISSUE CORRECTION OR CLARIFICATION IN WRITING. OTHERWISE, NO EXTRA COSTS OR EXTENSIONS OF TIME WILL BE BE ALLOWED FOR THE WORK OR MATERIAL THAT THE A/E WILL REQUIRE, PROVIDED THAT IT COMES WITHIN A REASONABLE INTERPRETATION OF THE
- H. THE CONTRACTOR SHALL THOROUGHLY CLEAN ALL EQUIPMENT TO BE COMPLETELY FREE OF INTERNAL DEBRIS AND EXTERIOR PAINT, MARKS, DIRT AND ALL SCRATCHES SHALL BE


ASS N. PENNSYLVANIA AVENUE WINTER PARSYLVANIA AVENUE WINTER PARSYLVANIA AVENUE WINTER PARSYLVANIA AVENUE BY COMMENDIAL PROVENDIAL PR					
WINTER PARK, FLORIDA 32789 OFFICE: (407) 388-1220 WWW. ADCINTERNATIONAL.NET		ARCHITEC	TURAL DESIGN	COLLABORAT	IVE
WINTER PARK, FLORIDA 32789 PERICE: 407) 388-1220 WWW. ADCINTERNATIONAL NET Project Documents for: Project Documents for: Project Obcuments for: Project Documents for: Bisue Date & Issue Description Drawn By Checkee 07.27.16 60% CD SET JS K 07.27.16 60% CD SET JS K 12.02.16 PERMIT/BID SET JS K 13.02 PERMIT/BID SET JS K 14	$\square$				
PFICE: (407) 629-1188         XX: (407) 862-1220         WWW. ADCINTERNATIONAL.NET    roject Documents for:          Image: Contract of the state o					
AVWY. ADCINTERNATIONALINET  roject Documents for:  roject Number I 32806  roject Number I 32801  roject SUUTI L MUNDELL-FL7070  roject Number I 3281  roject SUUTI L MUNDELL-FL7070	FFICE	E: (407) 629-1	1188		
Image: Consultant + Seal/Signature         Consultant + Seal/Signature         Consultant + Seal/Signature         Consultant + Seal/Signature					
Project SREAT OAKS VILLAGE WITTENSTEIN COTTAG DATA DAKS VILLAGE WITTENSTEIN COTTAG DA UPGRADES AND RENOVATIONS TRATET DATA DO, FL 32806  ISUANDO, FL 32806  ISUANDO, FL 32806  ISUANDO, FL 32806  ISUANDO, FL 32807  ISUANDO,					
Project SREAT OAKS VILLAGE WITTENSTEIN COTTAG DAUPGRADES AND RENOVATIONS T784 E. MICHIGAN STREET ORLANDO, FL 32806  ISSUE Date & Issue Description Trawn By Checked O7.27.16 00% CD SET JS K 0.9.15.16 90% CD SET JS K 12.02.16 PERMIT/BID SET SIN FLOOR 12.02.16 PERMIT/BID SET SIN FLOOR 12.02.17 PERMIT/BID SET SIN FLOOR 13.02.17 PERMIT/BID SET SIN FLOOR 14.02.17 PERMIT/BI					
Project SREAT OAKS VILLAGE WITTENSTEIN COTTAG DAUPGRADES AND RENOVATIONS T784 E. MICHIGAN STREET ORLANDO, FL 32806            Issue         Date & Issue Description         Drawn By         Checked           09.15.16         90% CD SET         JS         K           12.02.16         PERMIT/BID SET         JS         L           Drawn By         JB         Project Statu         JS           JJB         Project Statu         Scat         JS         Scat           JLM         Seat/Signature         Scat         Scat         Scat           JLM         Scat         Scat         Scat         Scat           JLM         Scat         Scat         Scat         Scat <td></td> <td></td> <td></td> <td></td> <td></td>					
Project SREAT OAKS VILLAGE WITTENSTEIN COTTAG DAUPGRADES AND RENOVATIONS T784 E. MICHIGAN STREET ORLANDO, FL 32806  ISSUE Date & Issue Description Trawn By Checked O7.27.16 00% CD SET JS K 0.9.15.16 90% CD SET JS K 12.02.16 PERMIT/BID SET SIN FLOOR 12.02.16 PERMIT/BID SET SIN FLOOR 12.02.17 PERMIT/BID SET SIN FLOOR 13.02.17 PERMIT/BID SET SIN FLOOR 14.02.17 PERMIT/BI					
Project: GREAT OAKS VILLAGE WITTENSTEIN COTTAG ADA UPGRADES AND RENOVATIONS 1784 E. MICHIGAN STREET DRLANDO, FL 32806 Issue Date & Issue Description Drawn By Checker 07.27.16 60% CD SET JS K 09.15.16 90% CD SET JS K 09.15.16 90% CD SET JS K 12.02.16 PERMIT/BID SET JS K 12.02.17 PERMIT/BID SET JS K 12.02.17 PERMIT/BID SET JS K 12.02.18 PERMIT/BID SET JS K 12.02.19 PERMIT/BID SET JS K 12.02.19 PERMIT/BID SET JS K 12.02.10 PERMIT/BID SET JS K 12.02.10 PERMIT/BID SET JS K 12.02.20 PERMIT/BID SET JS K 12.02.21 PERMIT/BID SET JS K 12.02.21 PERMIT/BID SET JS K 12.02.21 PERMIT/BID SET JS K 12.02.21 PERMIT/BID SET JS K PERMIT/BID SET JS K 12.02.21 PERMIT/BID SET JS K 12.02.21 PERMIT/BID SET JS K 12.02.21 PERMIT/BID SET JS K PERMIT/BID SET	Project	Documents	for:		
Project: GREAT OAKS VILLAGE WITTENSTEIN COTTAG ADA UPGRADES AND RENOVATIONS 1784 E. MICHIGAN STREET ORLANDO, FL 32806 Issue Date & Issue Description Drawn By Checker 07.27.16 60% CD SET JS K 09.15.16 90% CD SET JS K 09.15.16 90% CD SET JS K 12.02.16 PERMIT/BID SET JS K 12.02.16 PERMIT/BID SET JS K 20.000 E SOUTH STREET SIN FLOOR DRANGE COUNTY CAPITAL PROJECTS DIVISION 15253 120202 Project Number Issue Dat 15253 120202 Project Statu JB Project Statu JB Project Number Issue Dat 100 E SOUTH STREET SIN FLOOR Project Number Issue Dat 100 E SOUTH STREET SIN FLOOR SCHE STREET SIN FLOOR SCHE STREET SIN FLOOR SIGNE STREET SIN FLO		(	KAN V OUN	TE TY	
SREAT OAKS VILLAGE WITTENSTEIN COTTAG ADA UPGRADES AND RENOVATIONS 1784 E. MICHIGAN STREET DRLANDO, FL 32806 Issue Date & Issue Description Drawn By Checker 07.27.16 60% CD SET JS K 09.15.16 90% CD SET JS K 12.02.16 PERMIT/BID SET JS K 12.02.16 PERMIT/BID SET JS K 20.000 ESOUTH STREET S	Project	-	LORI	D A	
1784 E. MICHIGAN STREET ORLANDO, FL 32806 Issue Date & Issue Description Drawn By Checked 07.27.16 60% CD SET JS K 09.15.16 90% CD SET JS K 12.02.16 PERMIT/BID SET JS K 12.02.16 PERMIT/BID SET JS K Checked DS COUNTY CAPITAL PROJECTS DIVISION DRANGE COUNTY CAPITAL PROJECTS DIVISION DRANGE COUNTY CAPITAL PROJECTS DIVISION DRANGE COUNTY CAPITAL PROJECTS DIVISION DO E SOUTH STREET 5th FLOOR DRANGE COUNTY CAPITAL PROJECTS DIVISION DO E SOUTH STREET 5th FLOOR DRANGE COUNTY CAPITAL PROJECTS DIVISION DO E SOUTH STREET 5th FLOOR DRANGE COUNTY CAPITAL PROJECTS DIVISION DO E SOUTH STREET 5th FLOOR DRANGE COUNTY CAPITAL PROJECTS DIVISION DO E SOUTH STREET 5th FLOOR DRANGE COUNTY CAPITAL PROJECTS DIVISION DO E SOUTH STREET 5th FLOOR DRANGE COUNTY CAPITAL PROJECTS DIVISION DO E SOUTH STREET 5th FLOOR DRANGE COUNTY CAPITAL PROJECTS DIVISION DO E SOUTH STREET 5th FLOOR DRANGE COUNTY CAPITAL PROJECTS DIVISION DO E SOUTH STREET 5th FLOOR DRANGE COUNTY CAPITAL PROJECTS DIVISION DIVISION BUS PROJECTS DRANGE COUNTY CAPITAL PROJECTS DIVISION DIVISION BUS PROJECTS SCALE REPORT AND PROJECTS DIVISION BUS PROJECTS DIVISION	GREA	T OAKS V			ΓTAG
Issue       Date & Issue Description       Drawn By       Checked         07.27.16       60% CD SET       JS       K.         09.15.16       90% CD SET       JS       K.         12.02.16       PERMIT/BID SET       JS       K.         Image: Second S	1784 E	E. MICHIGA	AN STREET		
07.27.16     60% CD SET     JS     K       09.15.16     90% CD SET     JS     K       12.02.16     PERMIT/BID SET     JS     K       12.02.17     CAPITAL PROJECTS DIVISIC     JS     JS       100 E SOUTH STREET 5th FLOOR     Scal     120220       Project Number     Issue Dat     120220       15253     120220     Project Statu       JB     PERMIT /BID CD S     Scal       JLM     AS NOTE     Scal       File Name     Scal     Scal        Scal     Scal        Scal     Scal        Scal     Scal     Scal        Scal     Scal     Scal        Scal     Scal     Scal        Scal     Scal     Scal       JLM     Scal     Scal     Scal        Scal     Scal <td< td=""><td></td><td></td><td></td><td></td><td></td></td<>					
12.02.16     PERMIT/BID SET     JS     K.       Image: Second State Stat	Issue		-	-	heckec K
2llent Information         DRANGE COUNTY CAPITAL PROJECTS DIVISIO         00 E SOUTH STREET 5th FLOOR         Project Number       Issue Dat         15253       12/02/20         Drawn By       Project Statu         JJB       Project Statu         JUM       AS NOTE         File Name       Scal         Consultant • Seal/Signature       Scal         Marcon List       Scal         Silene Renomination					K/
DRANGE COUNTY CAPITAL PROJECTS DIVISIO 100 E SOUTH STREET 5th FLOOR DRLANDO, FL 32801 Project Number Issue Dat 15253 12/02/20 Drawn By Project Statu JJB PERMIT / BID CD S Checked By Scal JLM AS NOTE File Name Consultant • Seal/Signature Consultant • Seal/Signature CONSULTING ENGINEERS CA0000208 VIS LAR BALOWIN LARE ORLANO. EL 3814 TE: 407-767-5188 CA: 407-767-5188 CONSULTING ENGINEERS CA: 407-767-5188 CA:					
DRANGE COUNTY CAPITAL PROJECTS DIVISIO 100 E SOUTH STREET 5th FLOOR DRLANDO, FL 32801 Project Number Issue Dat 15253 12/02/20 Drawn By Project Statu JJB PERMIT / BID CD S Checked By Scal JLM AS NOTE File Name Consultant • Seal/Signature Consultant • Seal/Signature Consultant • Seal/Signature CONSULTING ENGINEERS CA0000208 935 LARE BALOWIN LARE ORLANO, FL 32814 TE: 407-767-5188 PAGE OF L. 32814 TE: 407-767-5188 CONSULTING ENGINEERS CA0000208 935 LARE BALOWIN LARE ORLANO, FL 32814 TE: 407-767-5188 CONSULTING ENGINEERS CA0000208 100 CONSULTING ENGINEERS CA000208 100 CONSULTING ENGINEERS CA0000208 100 CONSUL					
DRANGE COUNTY CAPITAL PROJECTS DIVISIO 100 E SOUTH STREET 5th FLOOR DRLANDO, FL 32801 Project Number Issue Dat 15253 12/02/20 Drawn By Project Statu JJB PERMIT / BID CD S Checked By Scal JLM AS NOTE File Name Consultant • Seal/Signature Consultant • Seal/Signature Consultant • Seal/Signature CONSULTING ENGINEERS CA0000208 935 LARE BALOWIN LARE ORLANO, FL 32814 TE: 407-767-5188 PAGE OF L. 32814 TE: 407-767-5188 CONSULTING ENGINEERS CA0000208 935 LARE BALOWIN LARE ORLANO, FL 32814 TE: 407-767-5188 CONSULTING ENGINEERS CA0000208 100 CONSULTING ENGINEERS CA000208 100 CONSULTING ENGINEERS CA0000208 100 CONSUL					
DRANGE COUNTY CAPITAL PROJECTS DIVISIO 100 E SOUTH STREET 5th FLOOR DRLANDO, FL 32801 Project Number Issue Dat 15253 12/02/20 Drawn By Project Statu JJB PERMIT / BID CD S Checked By Scal JLM AS NOTE File Name Consultant • Seal/Signature Consultant • Seal/Signature Consultant • Seal/Signature CONSULTING ENGINEERS CA0000208 935 LARE BALOWIN LARE ORLANO, FL 32814 TE: 407-767-5188 PAGE OF L. 32814 TE: 407-767-5188 CONSULTING ENGINEERS CA0000208 935 LARE BALOWIN LARE ORLANO, FL 32814 TE: 407-767-5188 CONSULTING ENGINEERS CA0000208 100 CONSULTING ENGINEERS CA000208 100 CONSULTING ENGINEERS CA0000208 100 CONSUL					
DRANGE COUNTY CAPITAL PROJECTS DIVISIO 100 E SOUTH STREET 5th FLOOR DRLANDO, FL 32801 Project Number Issue Dat 15253 12/02/20 Drawn By Project Statu JJB PERMIT / BID CD S Checked By Scal JLM AS NOTE File Name Consultant • Seal/Signature Consultant • Seal/Signature Consultant • Seal/Signature CONSULTING ENGINEERS CA0000208 935 LARE BALOWIN LARE ORLANO, FL 32814 TE: 407-767-5188 PAGE OF L. 32814 TE: 407-767-5188 CONSULTING ENGINEERS CA0000208 935 LARE BALOWIN LARE ORLANO, FL 32814 TE: 407-767-5188 CONSULTING ENGINEERS CA0000208 100 CONSULTING ENGINEERS CA000208 100 CONSULTING ENGINEERS CA0000208 100 CONSUL					
DRANGE COUNTY CAPITAL PROJECTS DIVISIO 100 E SOUTH STREET 5th FLOOR DRLANDO, FL 32801 Project Number Issue Dat 15253 12/02/20 Drawn By Project Statu JJB PERMIT / BID CD S Checked By Scal JLM AS NOTE File Name Consultant • Seal/Signature Consultant • Seal/Signature CONSULTING ENGINEERS CA0000208 VIS LAR BALOWIN LARE ORLANO. EL 32814 TE: 407-767-5188 CA: 407-767-5188 CONSULTING ENGINEERS CA: 407-767-5188 CA: 407-767-5188 CONSULTING ENGINEERS CA: 407-767-5188 CA: 40					
DRANGE COUNTY CAPITAL PROJECTS DIVISIO 100 E SOUTH STREET 5th FLOOR DRLANDO, FL 32801 Project Number Issue Dat 15253 12/02/20 Drawn By Project Statu JJB PERMIT / BID CD S Checked By Scal JLM AS NOTE File Name Consultant • Seal/Signature Consultant • Seal/Signature Consultant • Seal/Signature CONSULTING ENGINEERS CA0000208 935 LARE BALOWIN LARE ORLANO, FL 32814 TE: 407-767-5188 PAGE OF L. 32814 TE: 407-767-5188 CONSULTING ENGINEERS CA0000208 935 LARE BALOWIN LARE ORLANO, FL 32814 TE: 407-767-5188 CONSULTING ENGINEERS CA0000208 100 CONSULTING ENGINEERS CA000208 100 CONSULTING ENGINEERS CA0000208 100 CONSUL					
Project Number       Issue Data         15253       12/02/20         Drawn By       Project Statu         JJB       PERMIT / BID CD S         Checked By       Scal         JLM       AS NOTE         File Name       Scal         Consultant • Seal/Signature       Scal         Mandologie E Consultant • Seal/Signature       Scal         SCOULTING ENGINEERS       Scal         Sister File Name       Scal         JUSTIN L. MUNDELL - FL7070			TY CAPITAL PF	ROJECTS DI	VISIC
15253 Drawn By JJB Checked By JLM ERMIT / BID CD S Scal JLM As NOTE File Name Consultant • Seal/Signature Consultant • Seal/Signature Consultant • Seal/Signature Consultant • Seal/Signature SCA0006208 VI LAR BALDWIN LANE ORANDO. L. 32814 TE: 407-767-5188 TE: 407-767-518 TE: 407-767-5	100 E S ORLAN	OUTH STRE DO, FL 3280	ET 5th FLOOR 1		
1202/20 Project Statu PERMIT / BID CD S Scal JLM AS NOTE File Name Consultant • Seal/Signature Consultant • Seal/Signature SCAU SCAU S	Proiec	t Number		lss	ue Dat
JJB Checked By JLM AS NOTE File Name Consultant • Seal/Signature Consultant • Seal/Signature Consultant • Seal/Signature Consultant • Seal/Signature Consultant • Seal/Signature SGA AGO SIGNA CONSULTING ENGINEERS CA0000208 SIS LAKE BALDWIN LANE ORLANDO, FL 32814 TE: 407-767-5188 EX: 407-767-5172 WWW.SGMENGINEERING. INC. SGM #: 2016-066 JUSTIN L. MUNDELL-FL7070	15253				12/02/20
JLM AS NOTE File Name Consultant • Seal/Signature SSGNARS ENGINEERING MEPCONSULTING ENGINEERS CA-0000208 935 LAKE BALDWIN LANE ORLANDO, FL 32814 TE: 407-767-5188 FAX: 407-767-5172 WASGMEGINEERING.COM COTARIGHT © 2014 SGM ENGINEERING. INC. SGM #: 2016-066 JUSTIN L. MUNDELL-FL7070	JJB	-		-	ID CD S
Consultant • Seal/Signature SSGNARS ENGINEERING MEP CONSULTING ENGINEERS CA-00006208 935 LAKE BALDWIN LANE ORLANDO, FL 32814 Ta: 407-767-5188 EAX: 400-768 EAX: 407-767-5188 EAX: 407-767-5188 E		<b>- ,</b>		A	
Consultant • Seal/Signature SSGNAA ENGINEERING ENGINEERING MP CONSULTING ENGINEERS CA-00006208 935 LAKE BALDWIN LANE ORLANDO, FL 32814 Ta: 407-767-5188 Ta: 407	File Na	ıme			
SGMARA ENGINEERING MEP CONSULTING ENGINEERS CA-00006208 935 LAKE BALDWIN LANE ORLANDO. FL. 32814 TEL: 407-767-5188 FAX: 407-767-5172 WWW.SGMEMGINEERING.COM COPYRIGHT © 2014 SGM ENGINEERING. INC. SGM #: 2016-066 JUSTIN L. MUNDELL-FL7070					
SGMARA ENGINEERING MEP CONSULTING ENGINEERS CA-00006208 935 LAKE BALDWIN LANE ORLANDO. FL. 32814 TEL: 407-767-5188 FAX: 407-767-5172 WWW.SGMEMGINEERING.COM COPYRIGHT © 2014 SGM ENGINEERING. INC. SGM #: 2016-066 JUSTIN L. MUNDELL-FL7070					
SGMARA ENGINEERING MEP CONSULTING ENGINEERS CA-00006208 935 LAKE BALDWIN LANE ORLANDO. FL. 32814 TEL: 407-767-5188 FAX: 407-767-5172 WWW.SGMEMGINEERING.COM COPYRIGHT © 2014 SGM ENGINEERING. INC. SGM #: 2016-066 JUSTIN L. MUNDELL-FL7070	Concur	tant e Soci"	Signaturo		
CA-00006208 935 LAKE BALDWIN LANE ORLANDO, FL. 32814 TEL: 407-767-5188 FAX: 407-767-5772 WWW.SGMENGINEERING.COM COPYRIGHT © 2014 SGM ENGINEERING, INC. SGM #: 2016-066 JUSTIN L. MUNDELL—FL7070	~	GN	1		
	ĒN	CONSULTING	G ENGINEERS		
Sheet Title:	EN MEP C	CONSULTING CA-000062 935 Lake Baldy Orlando, Fi Tel: 407-767 Fax: 407-767 WWW.Sgmengini Yright © 2014 Sgm	G ENGINEERS 208 WIN LANE L. 32814 7-5718 7-5772 EERING.COM ENGINEERING, INC.		
	EN MEP C	CONSULTING CA-000062 935 Lake Baldy Orlando, Fi Tel: 407-767 Fax: 407-767 WWW.Sgmengini Yright © 2014 Sgm	G ENGINEERS 208 WIN LANE 1. 32814 7-5188 7-5772 EERING.COM ENGINEERING, INC. 5-066	L. MUNDELL-F	L7070
	Copy	CONSULTING CA-000062 935 LAKE BALDD ORLANDO, FI TEL: 407-767 FAX: 407-767 WWW.SGMENGINI YRIGHT © 2014 SGM SGM #: 2016	G ENGINEERS 208 WIN LANE 1. 32814 7-5188 7-5772 EERING.COM ENGINEERING, INC. 5-066	L. MUNDELL—F	L7070
Notes	COPY	CONSULTING CA-000062 935 LAKE BALDO ORLANDO, FI TEL: 407-765 FAX: 407-765 WWW.SGMENGINI YRIGHT © 2014 SGM SGM #: 2010	G ENGINEERS 108 WIN LANE 1. 22814 7-5172 EERING.COM ENGINEERING, INC. 5-066 JUSTIN Ctrical Ge		Ľ7070


E0.02

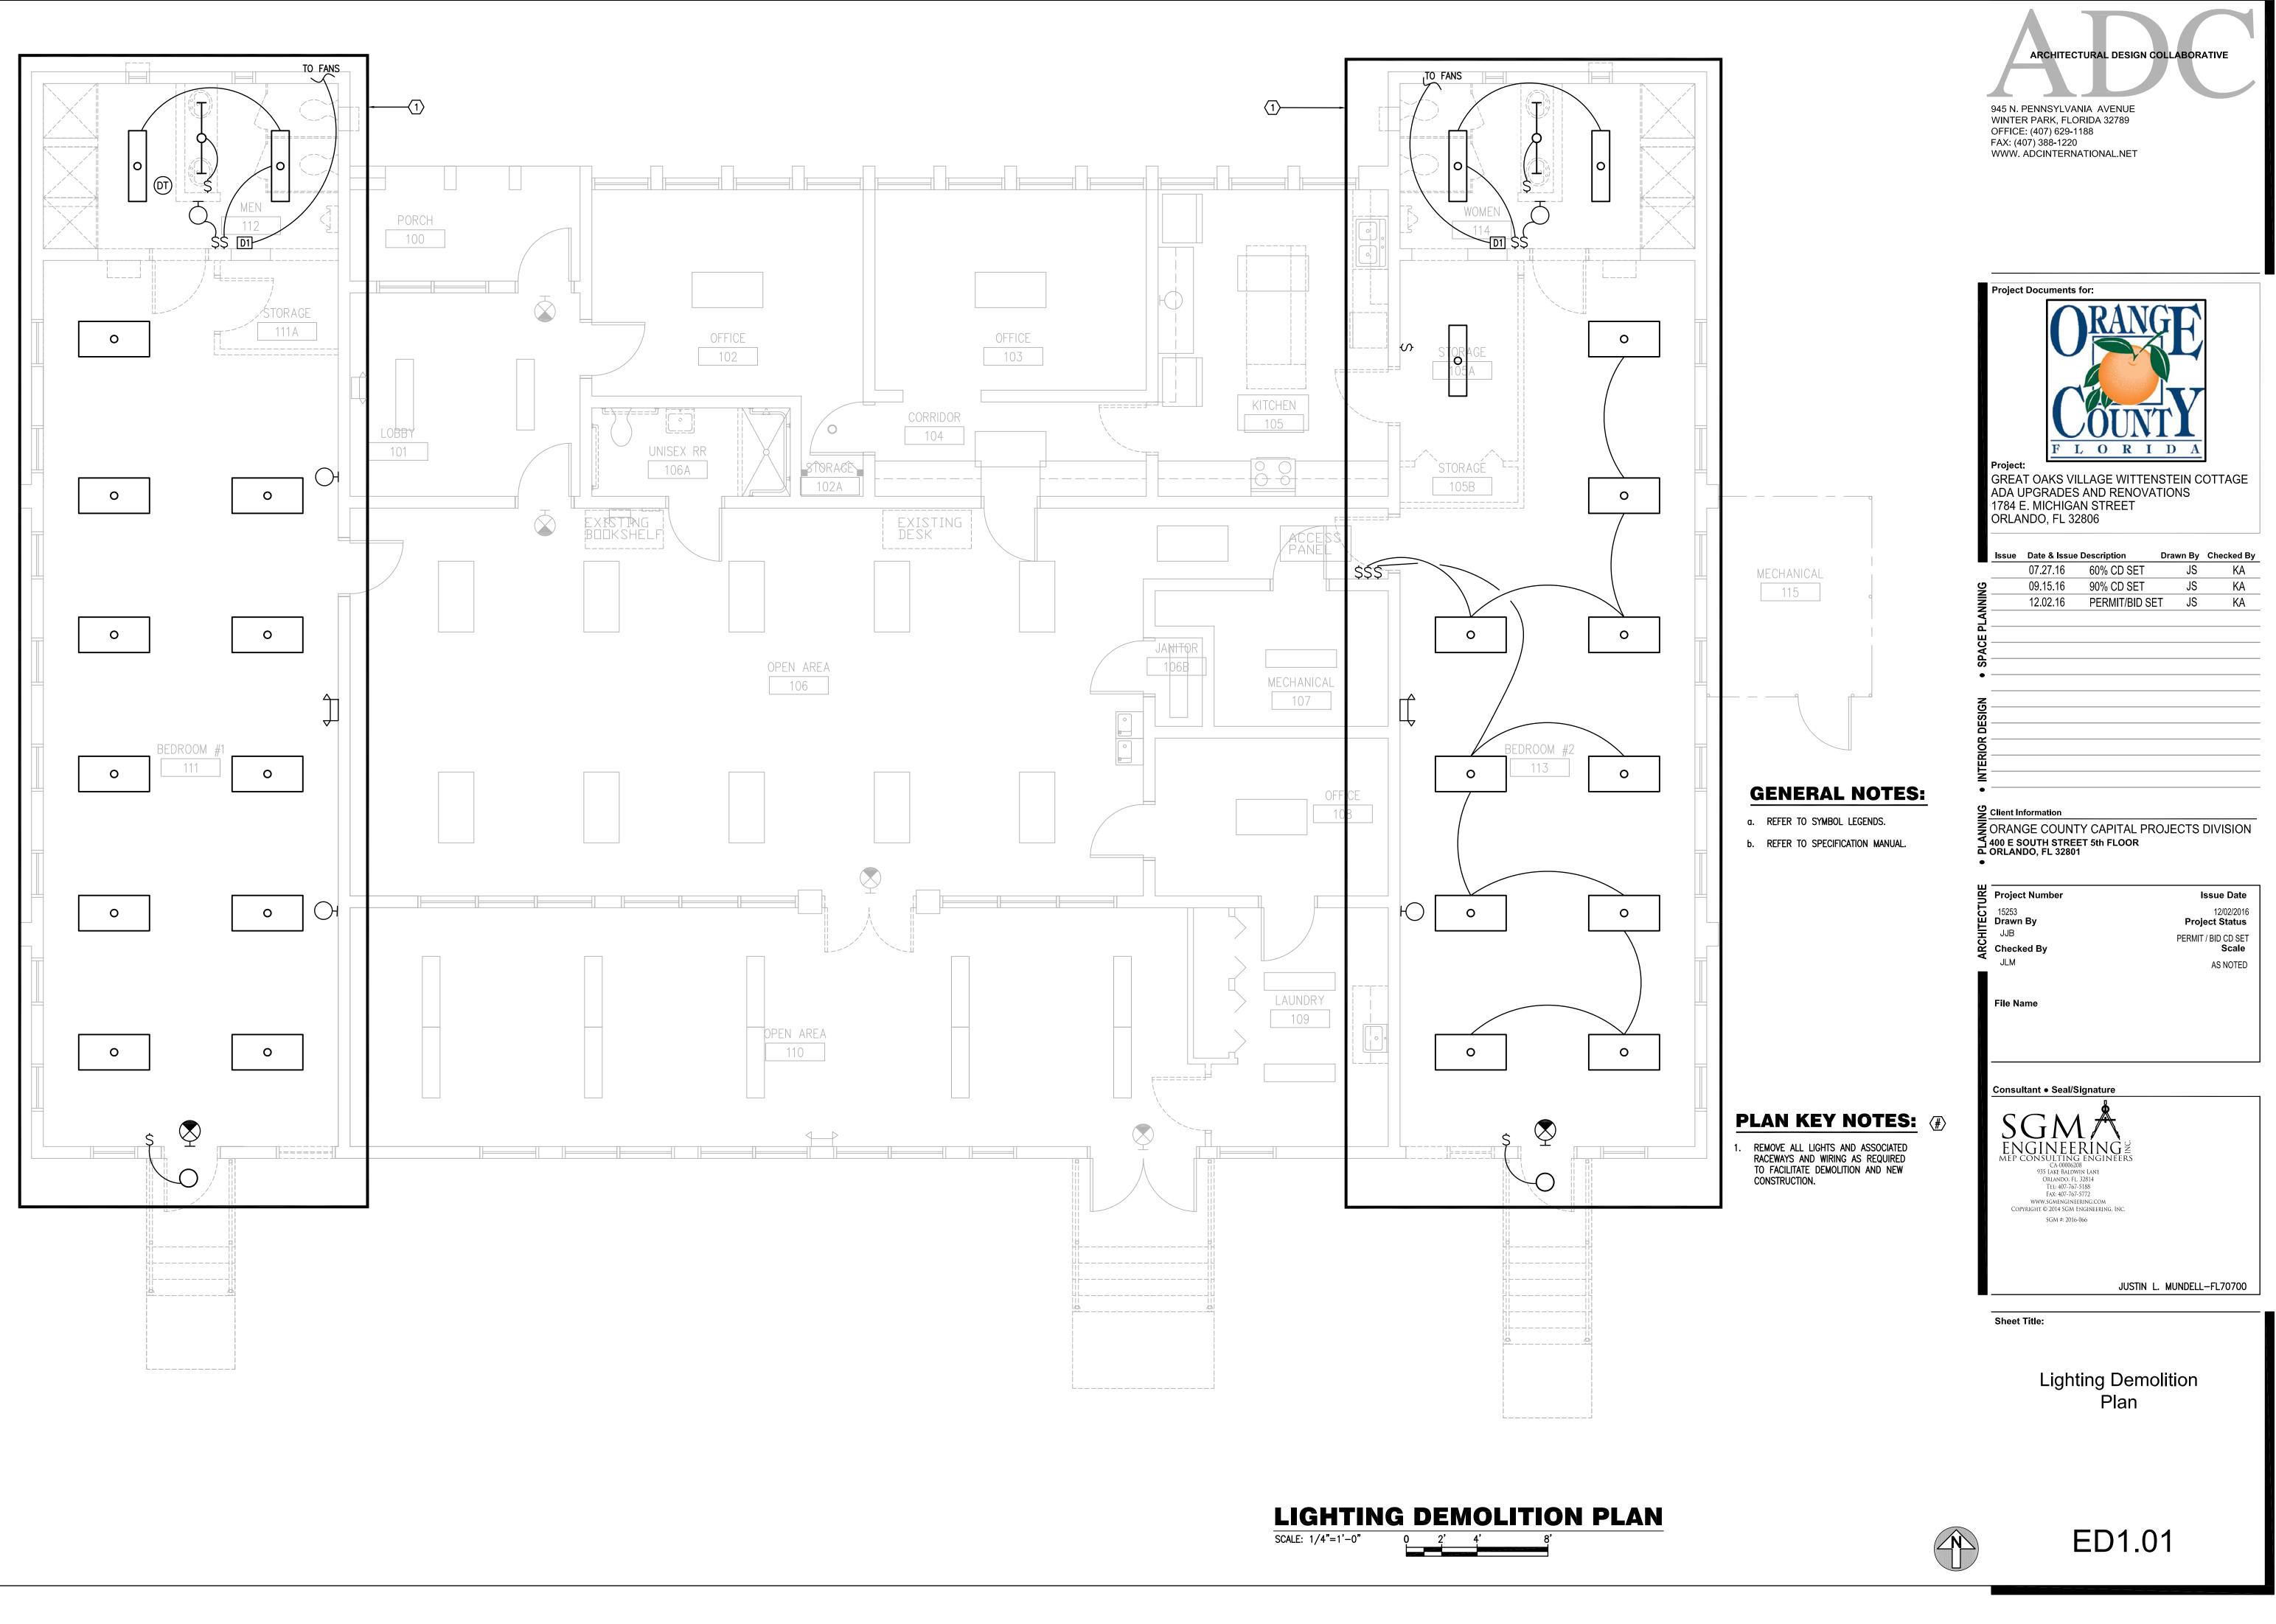

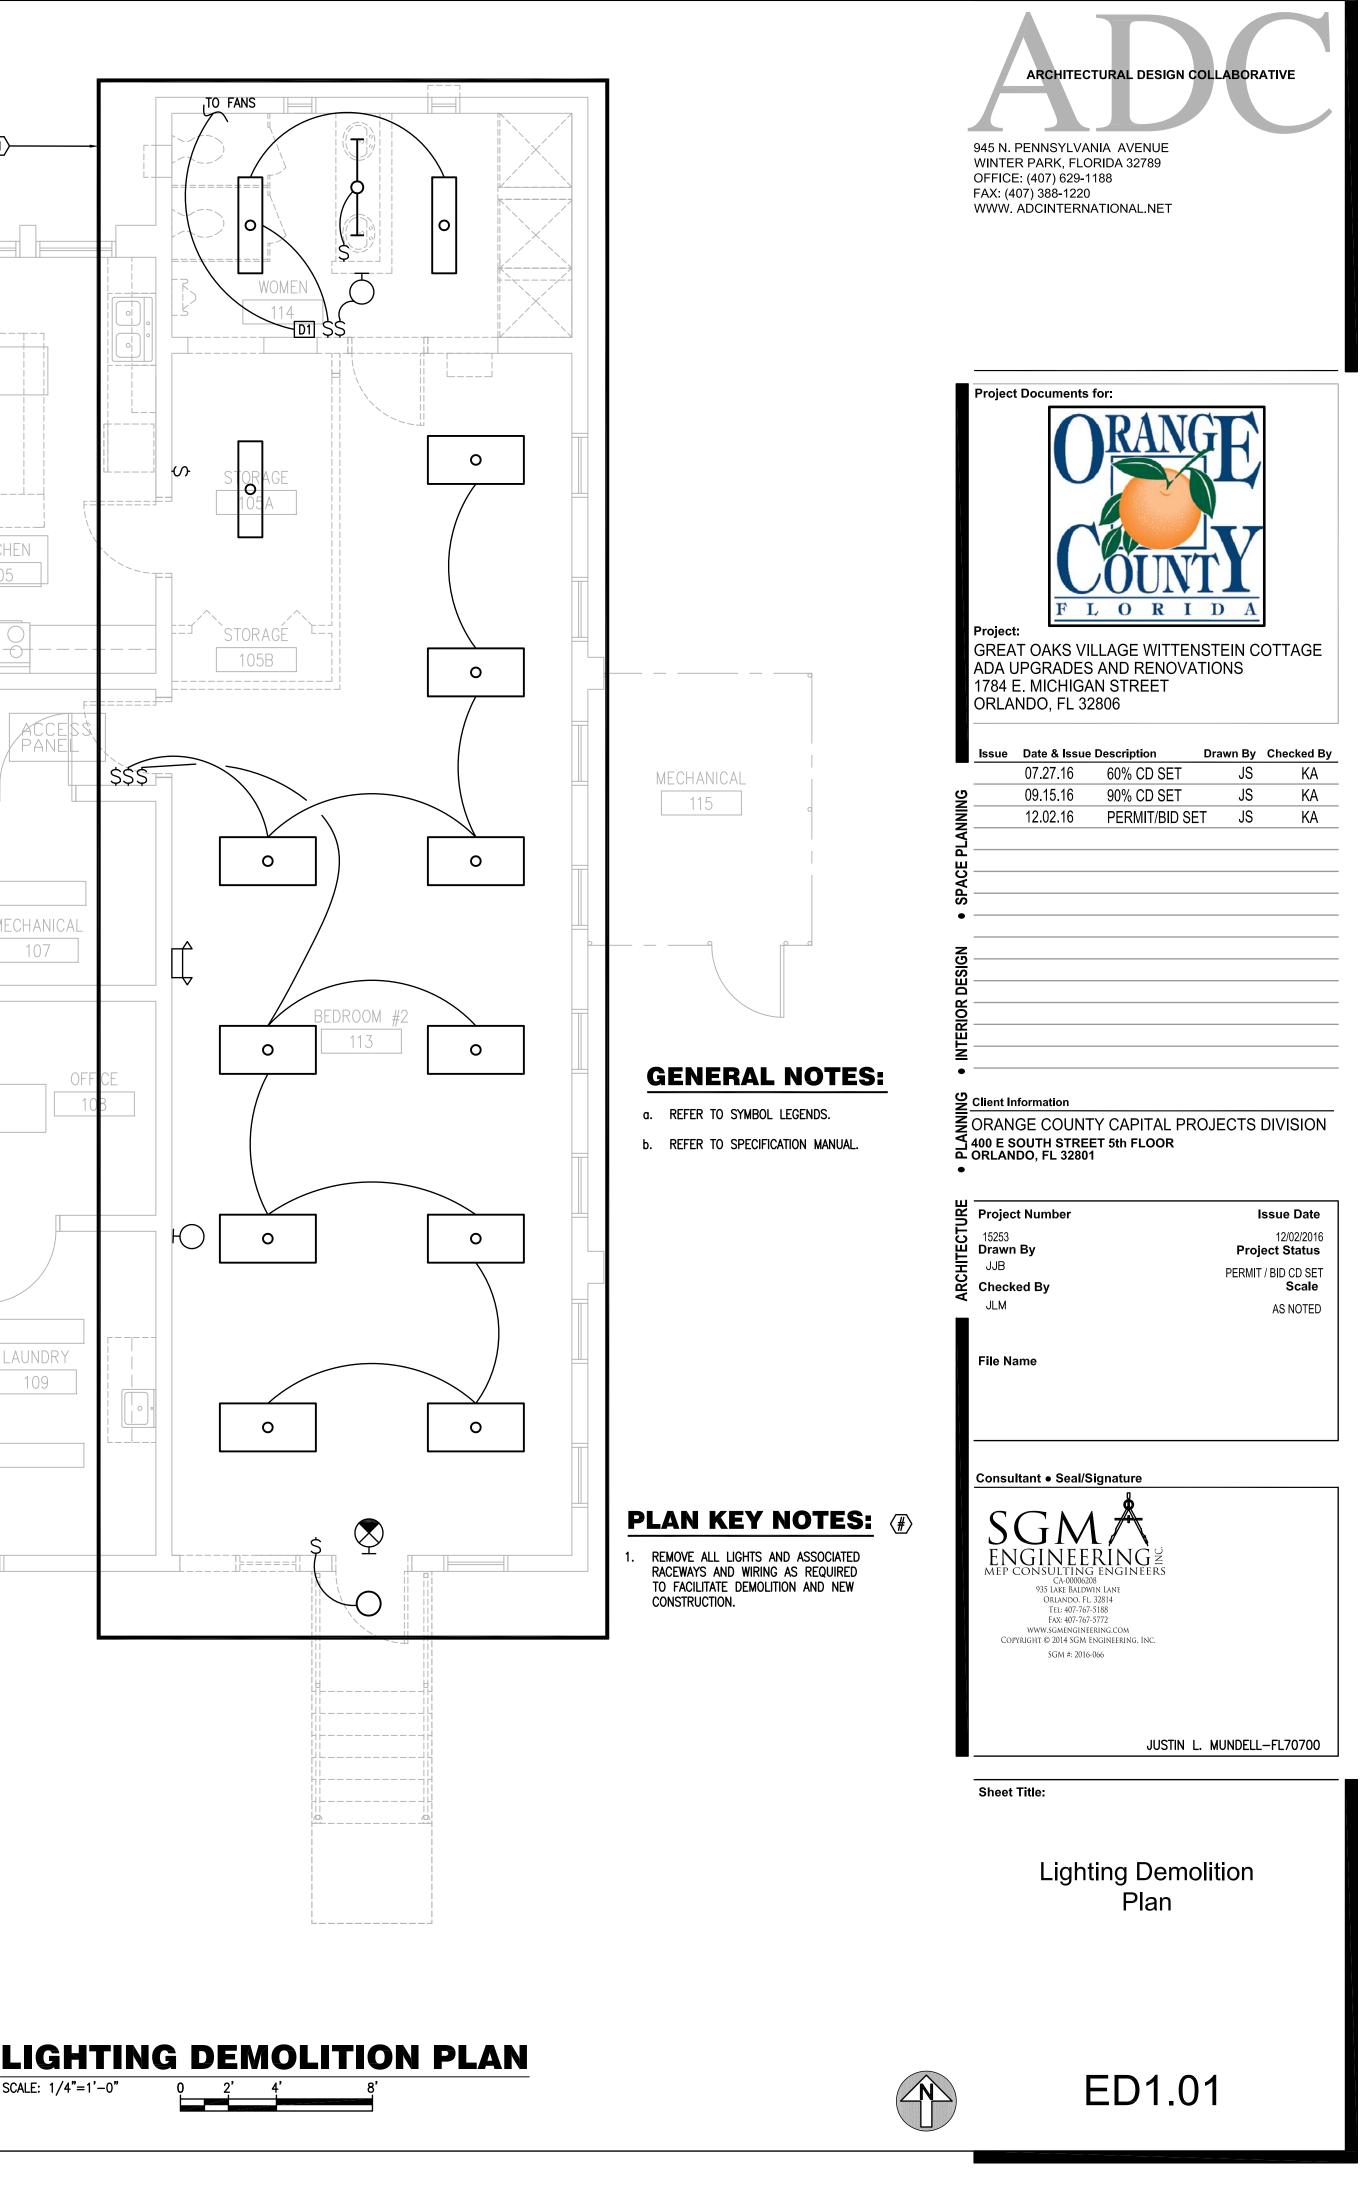


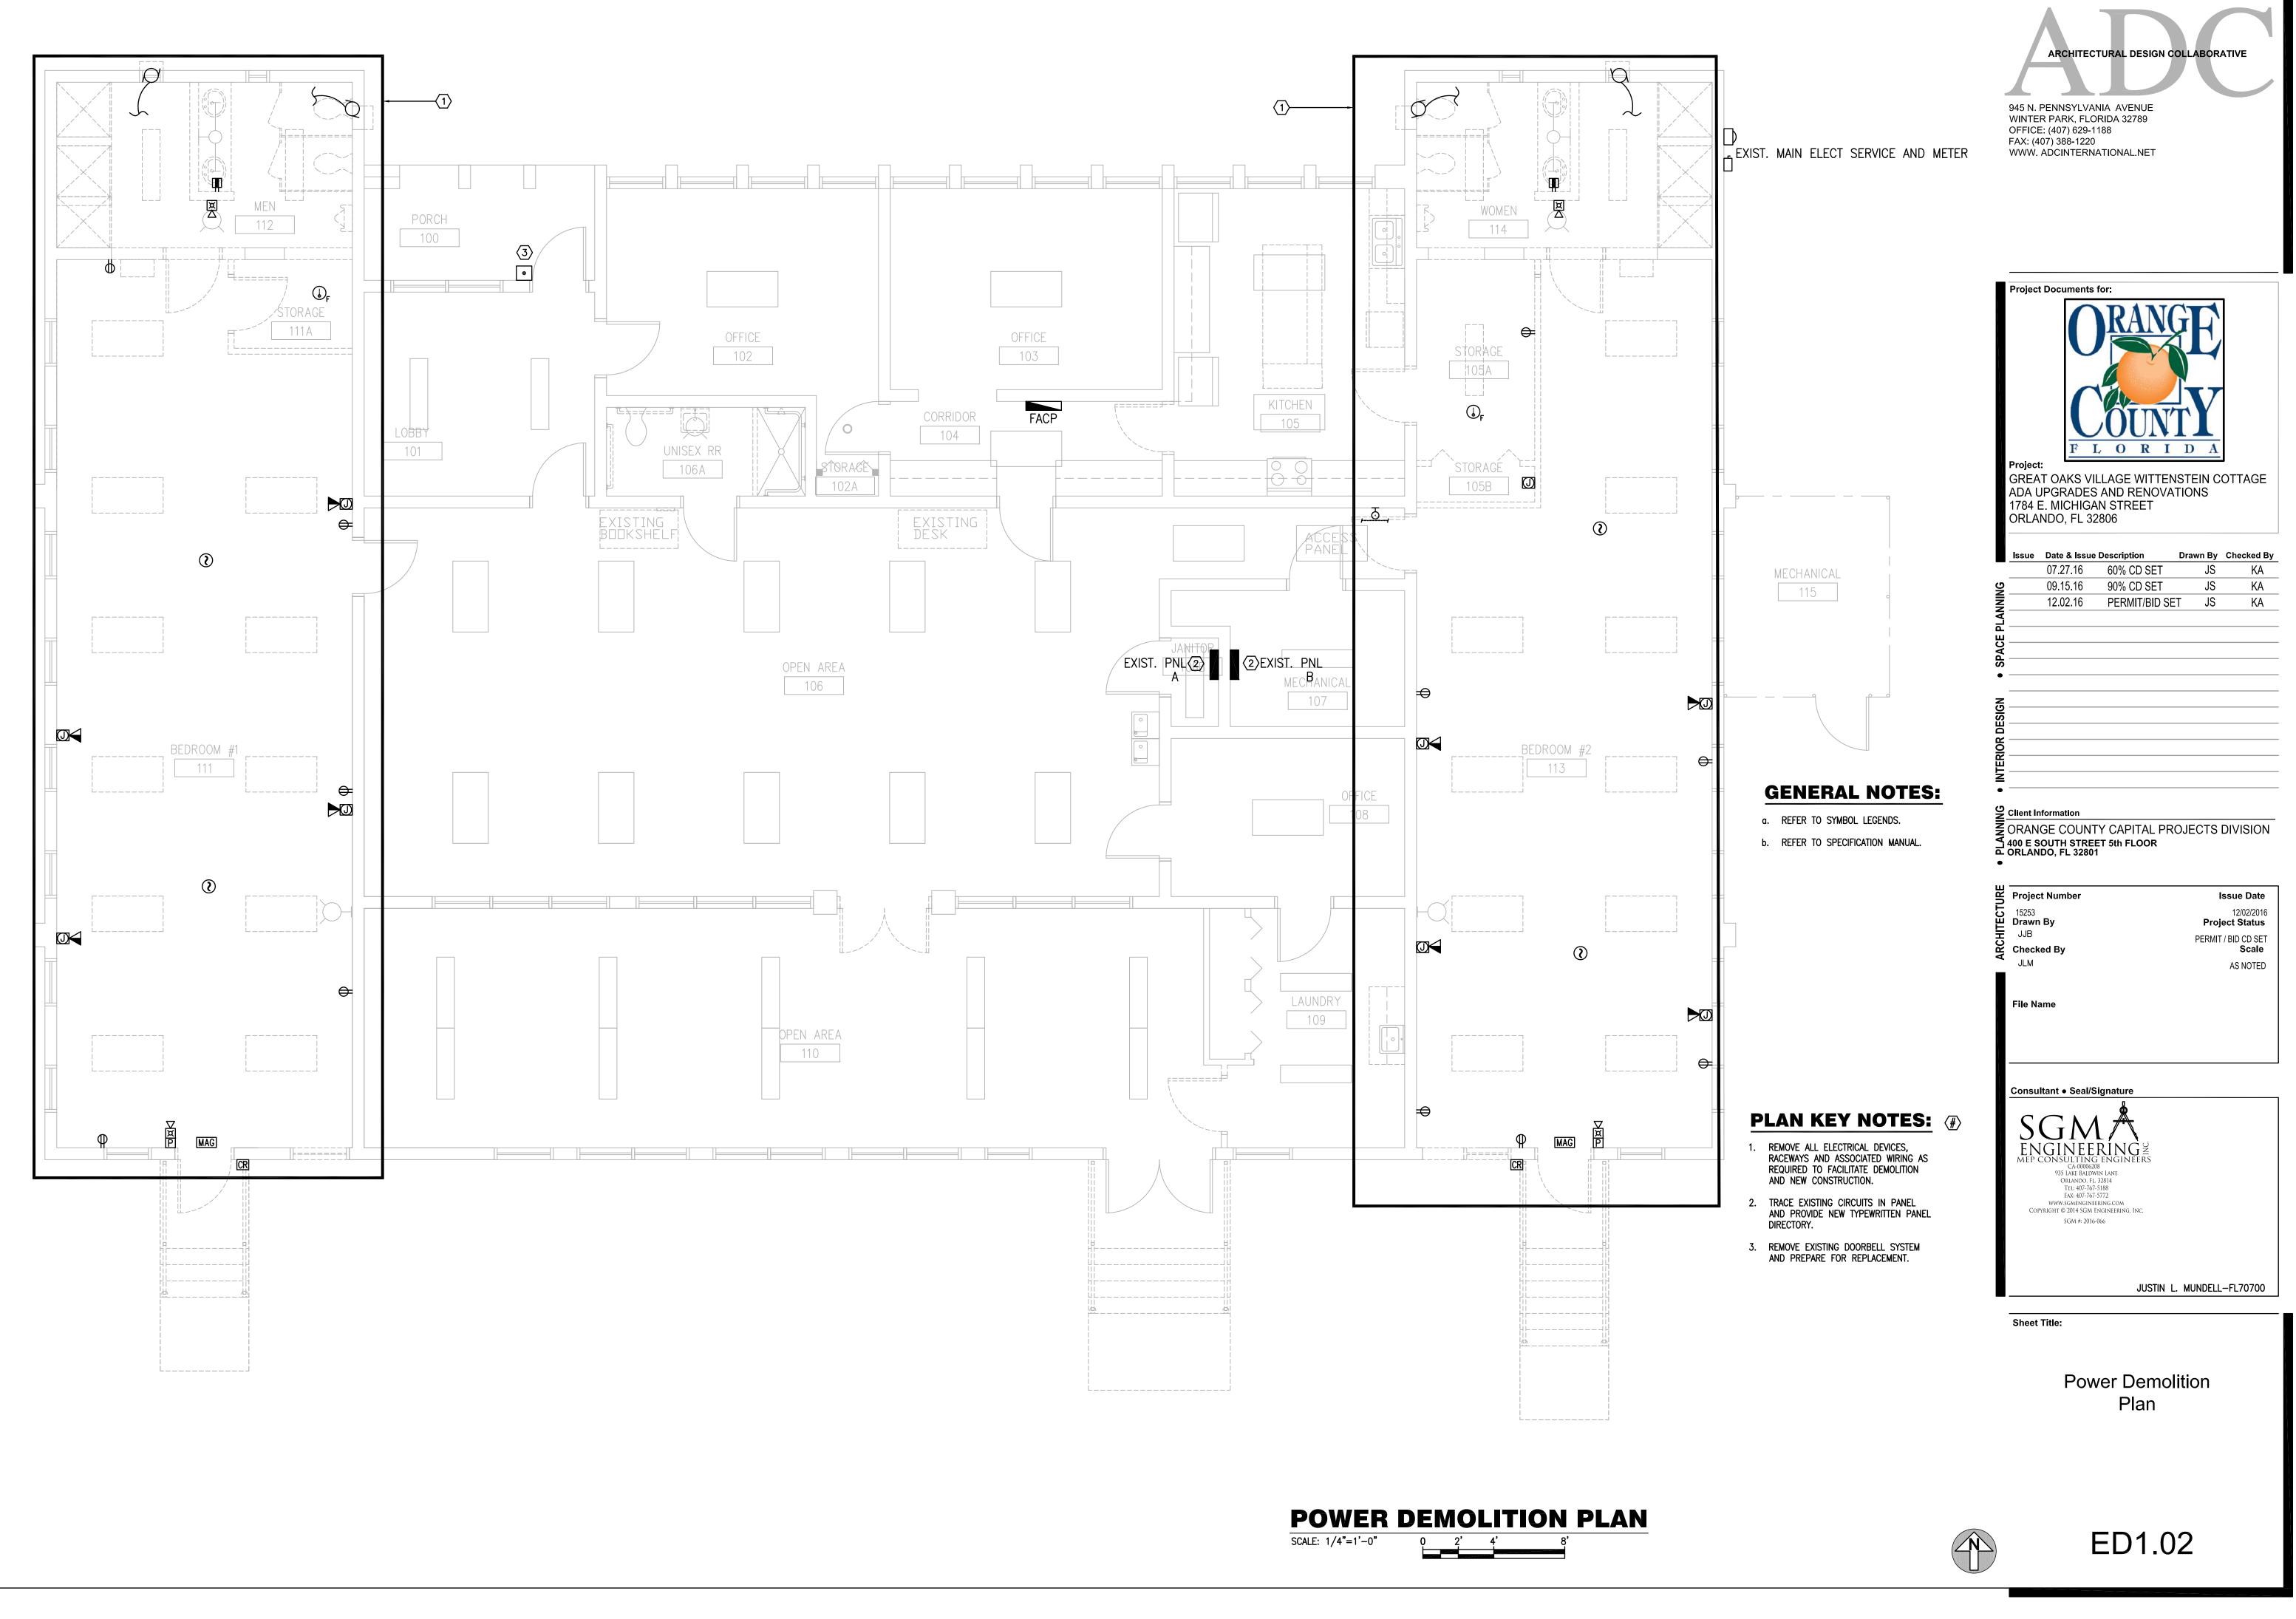

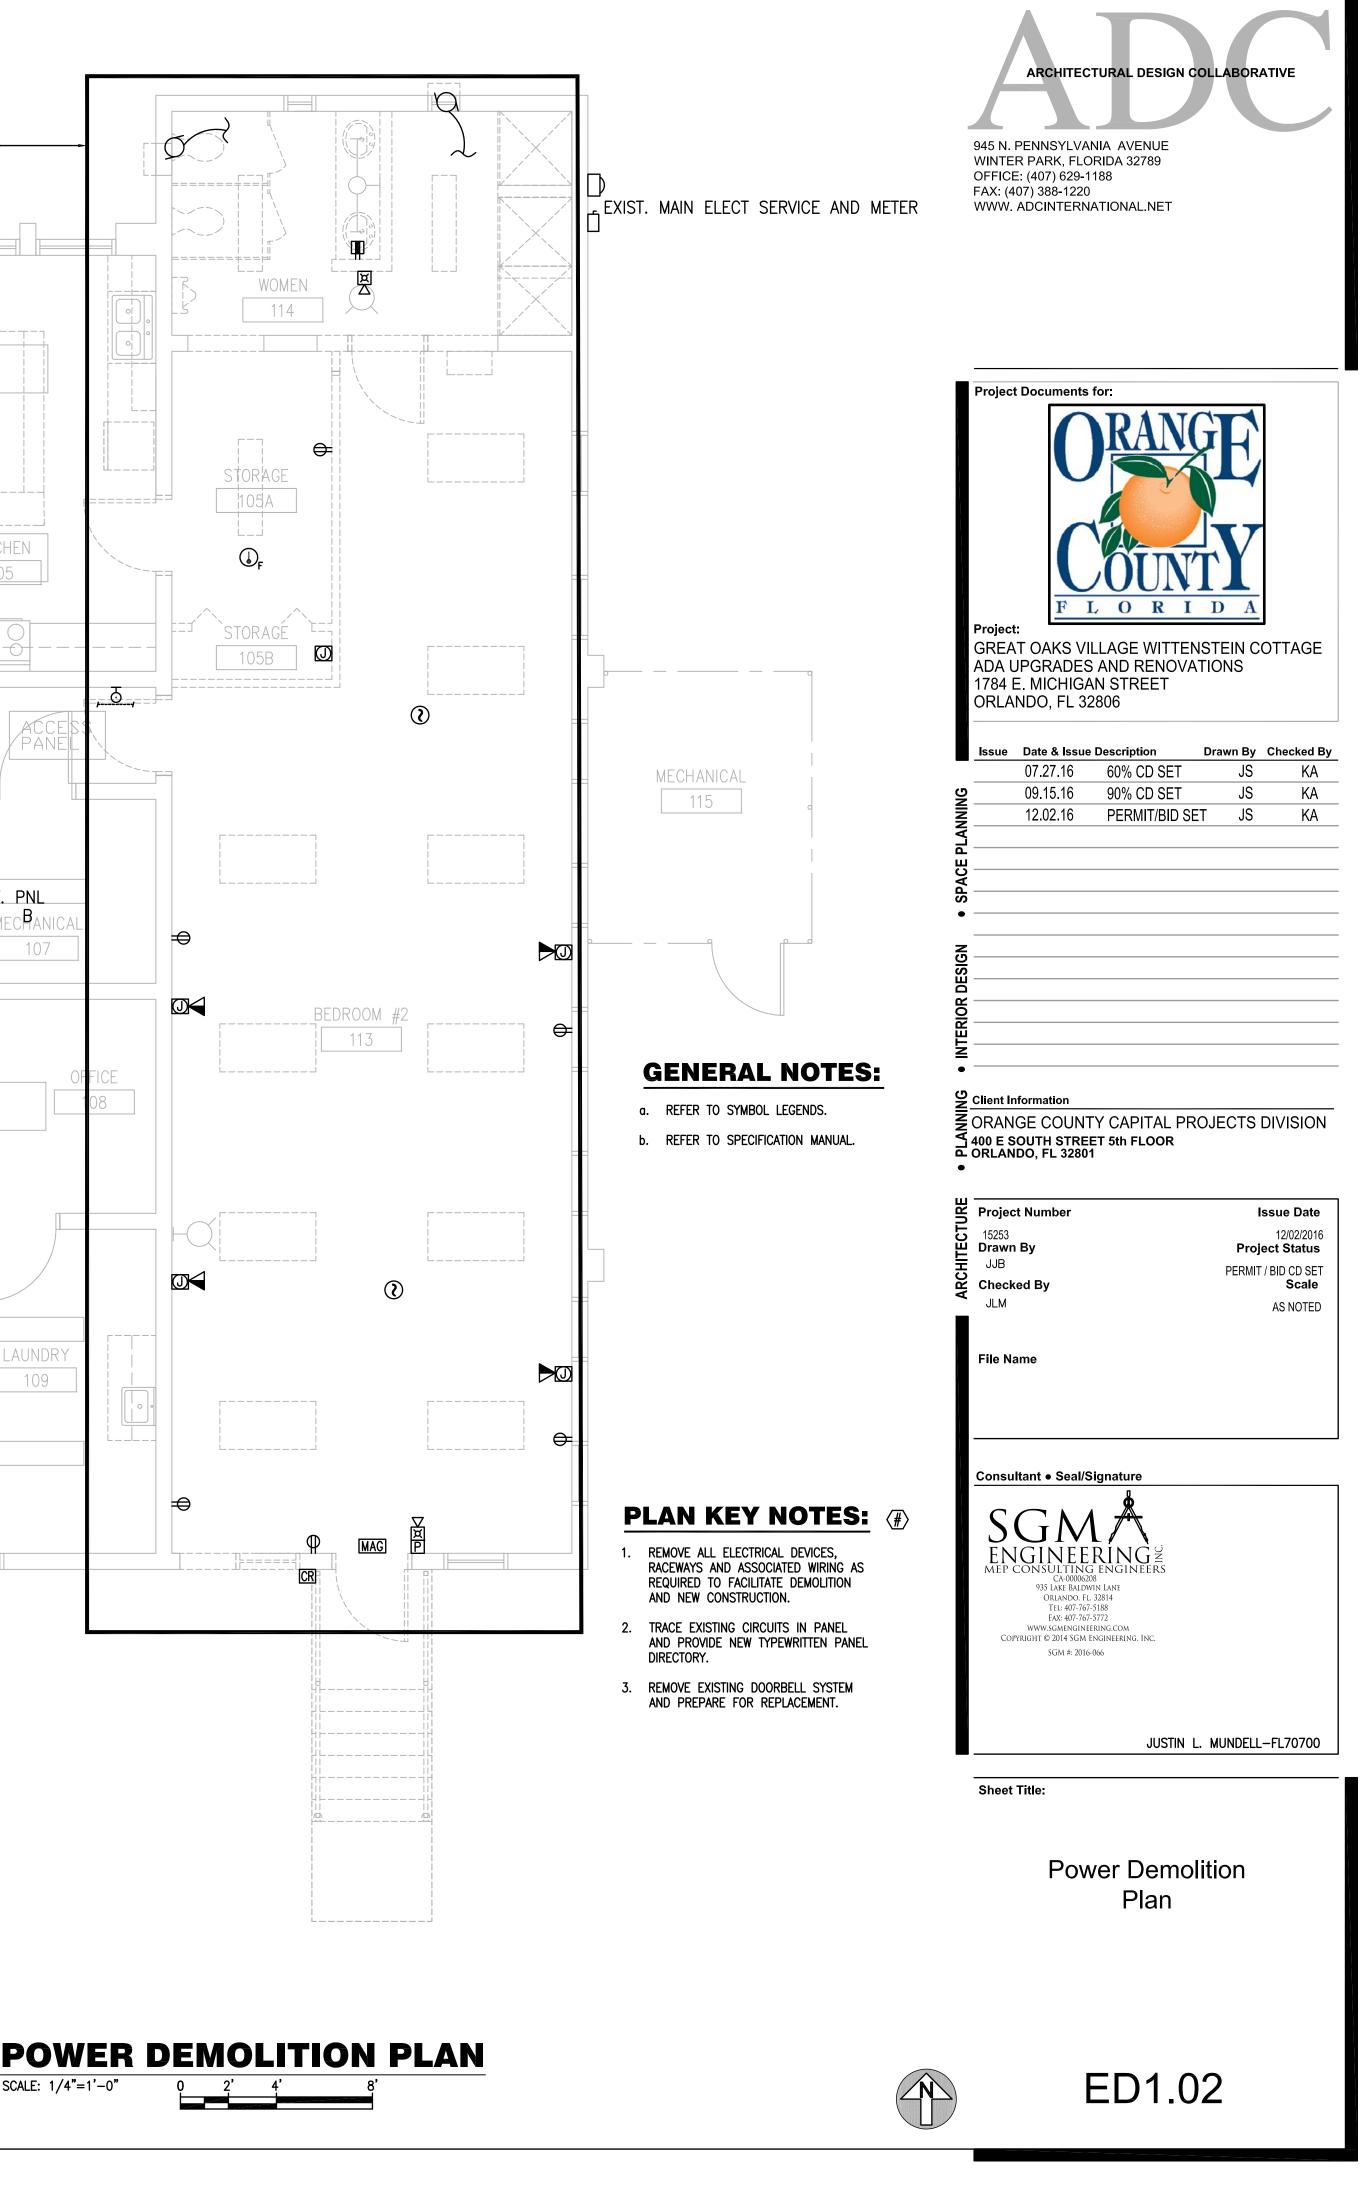

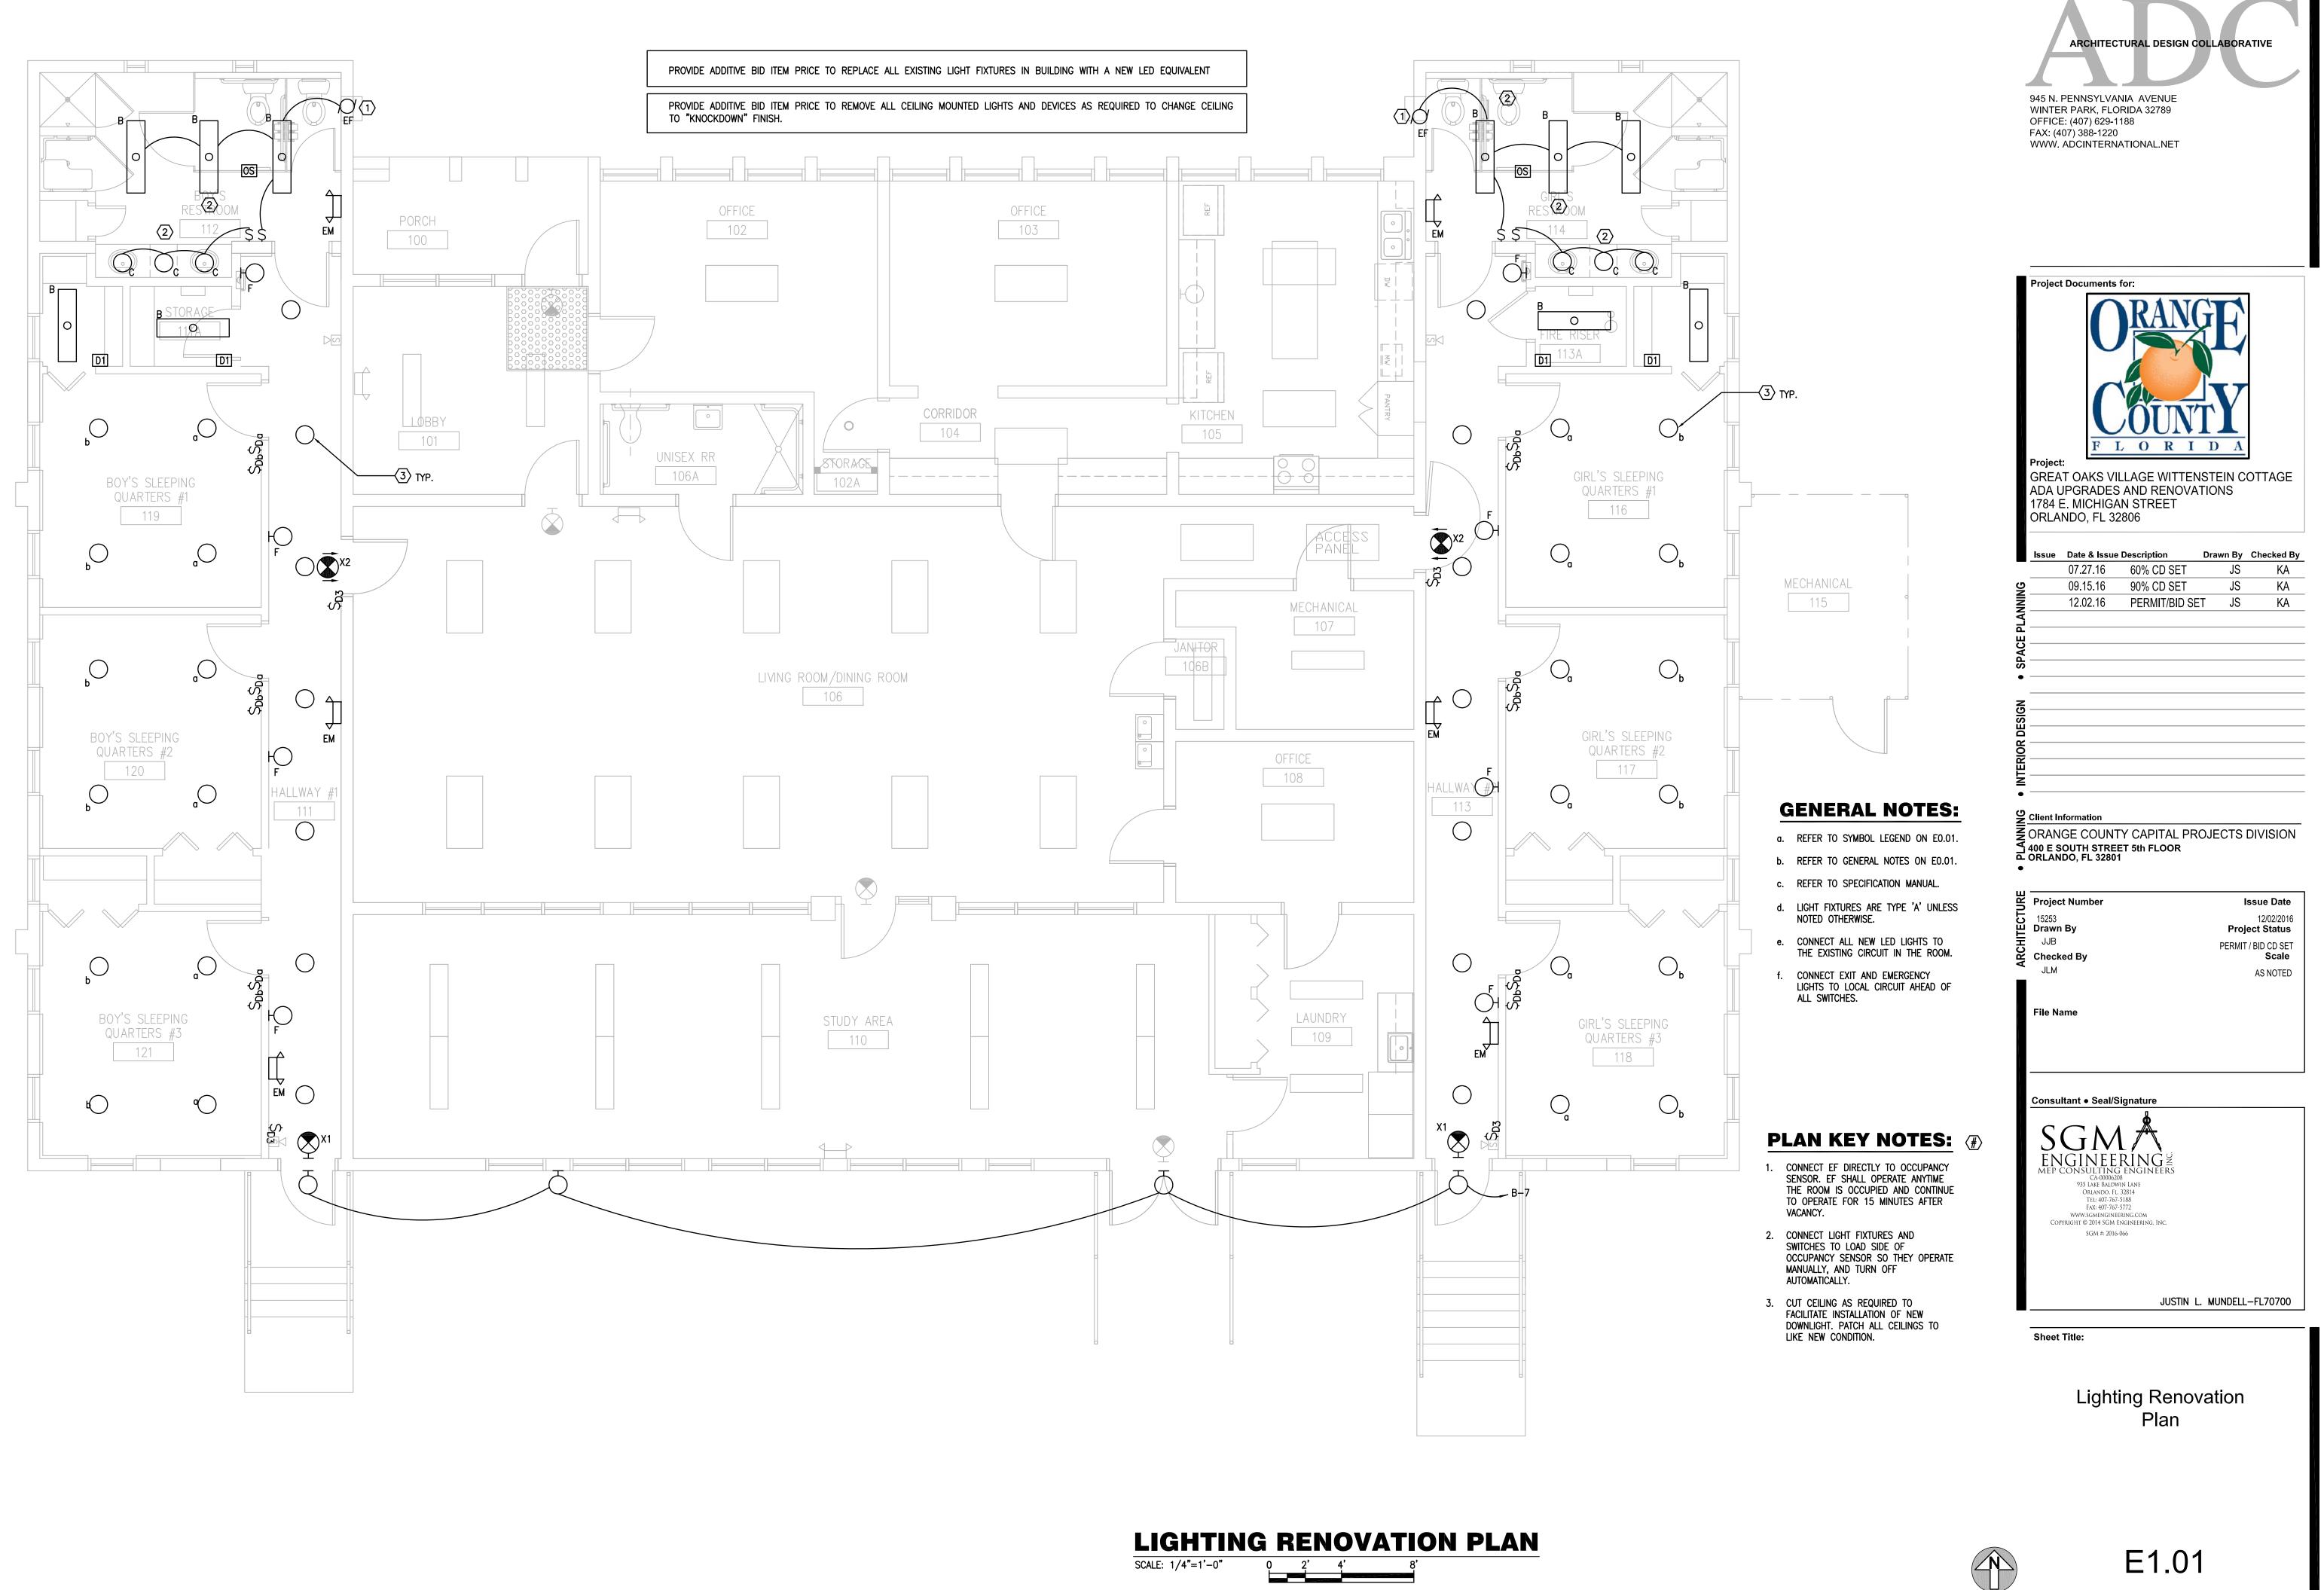



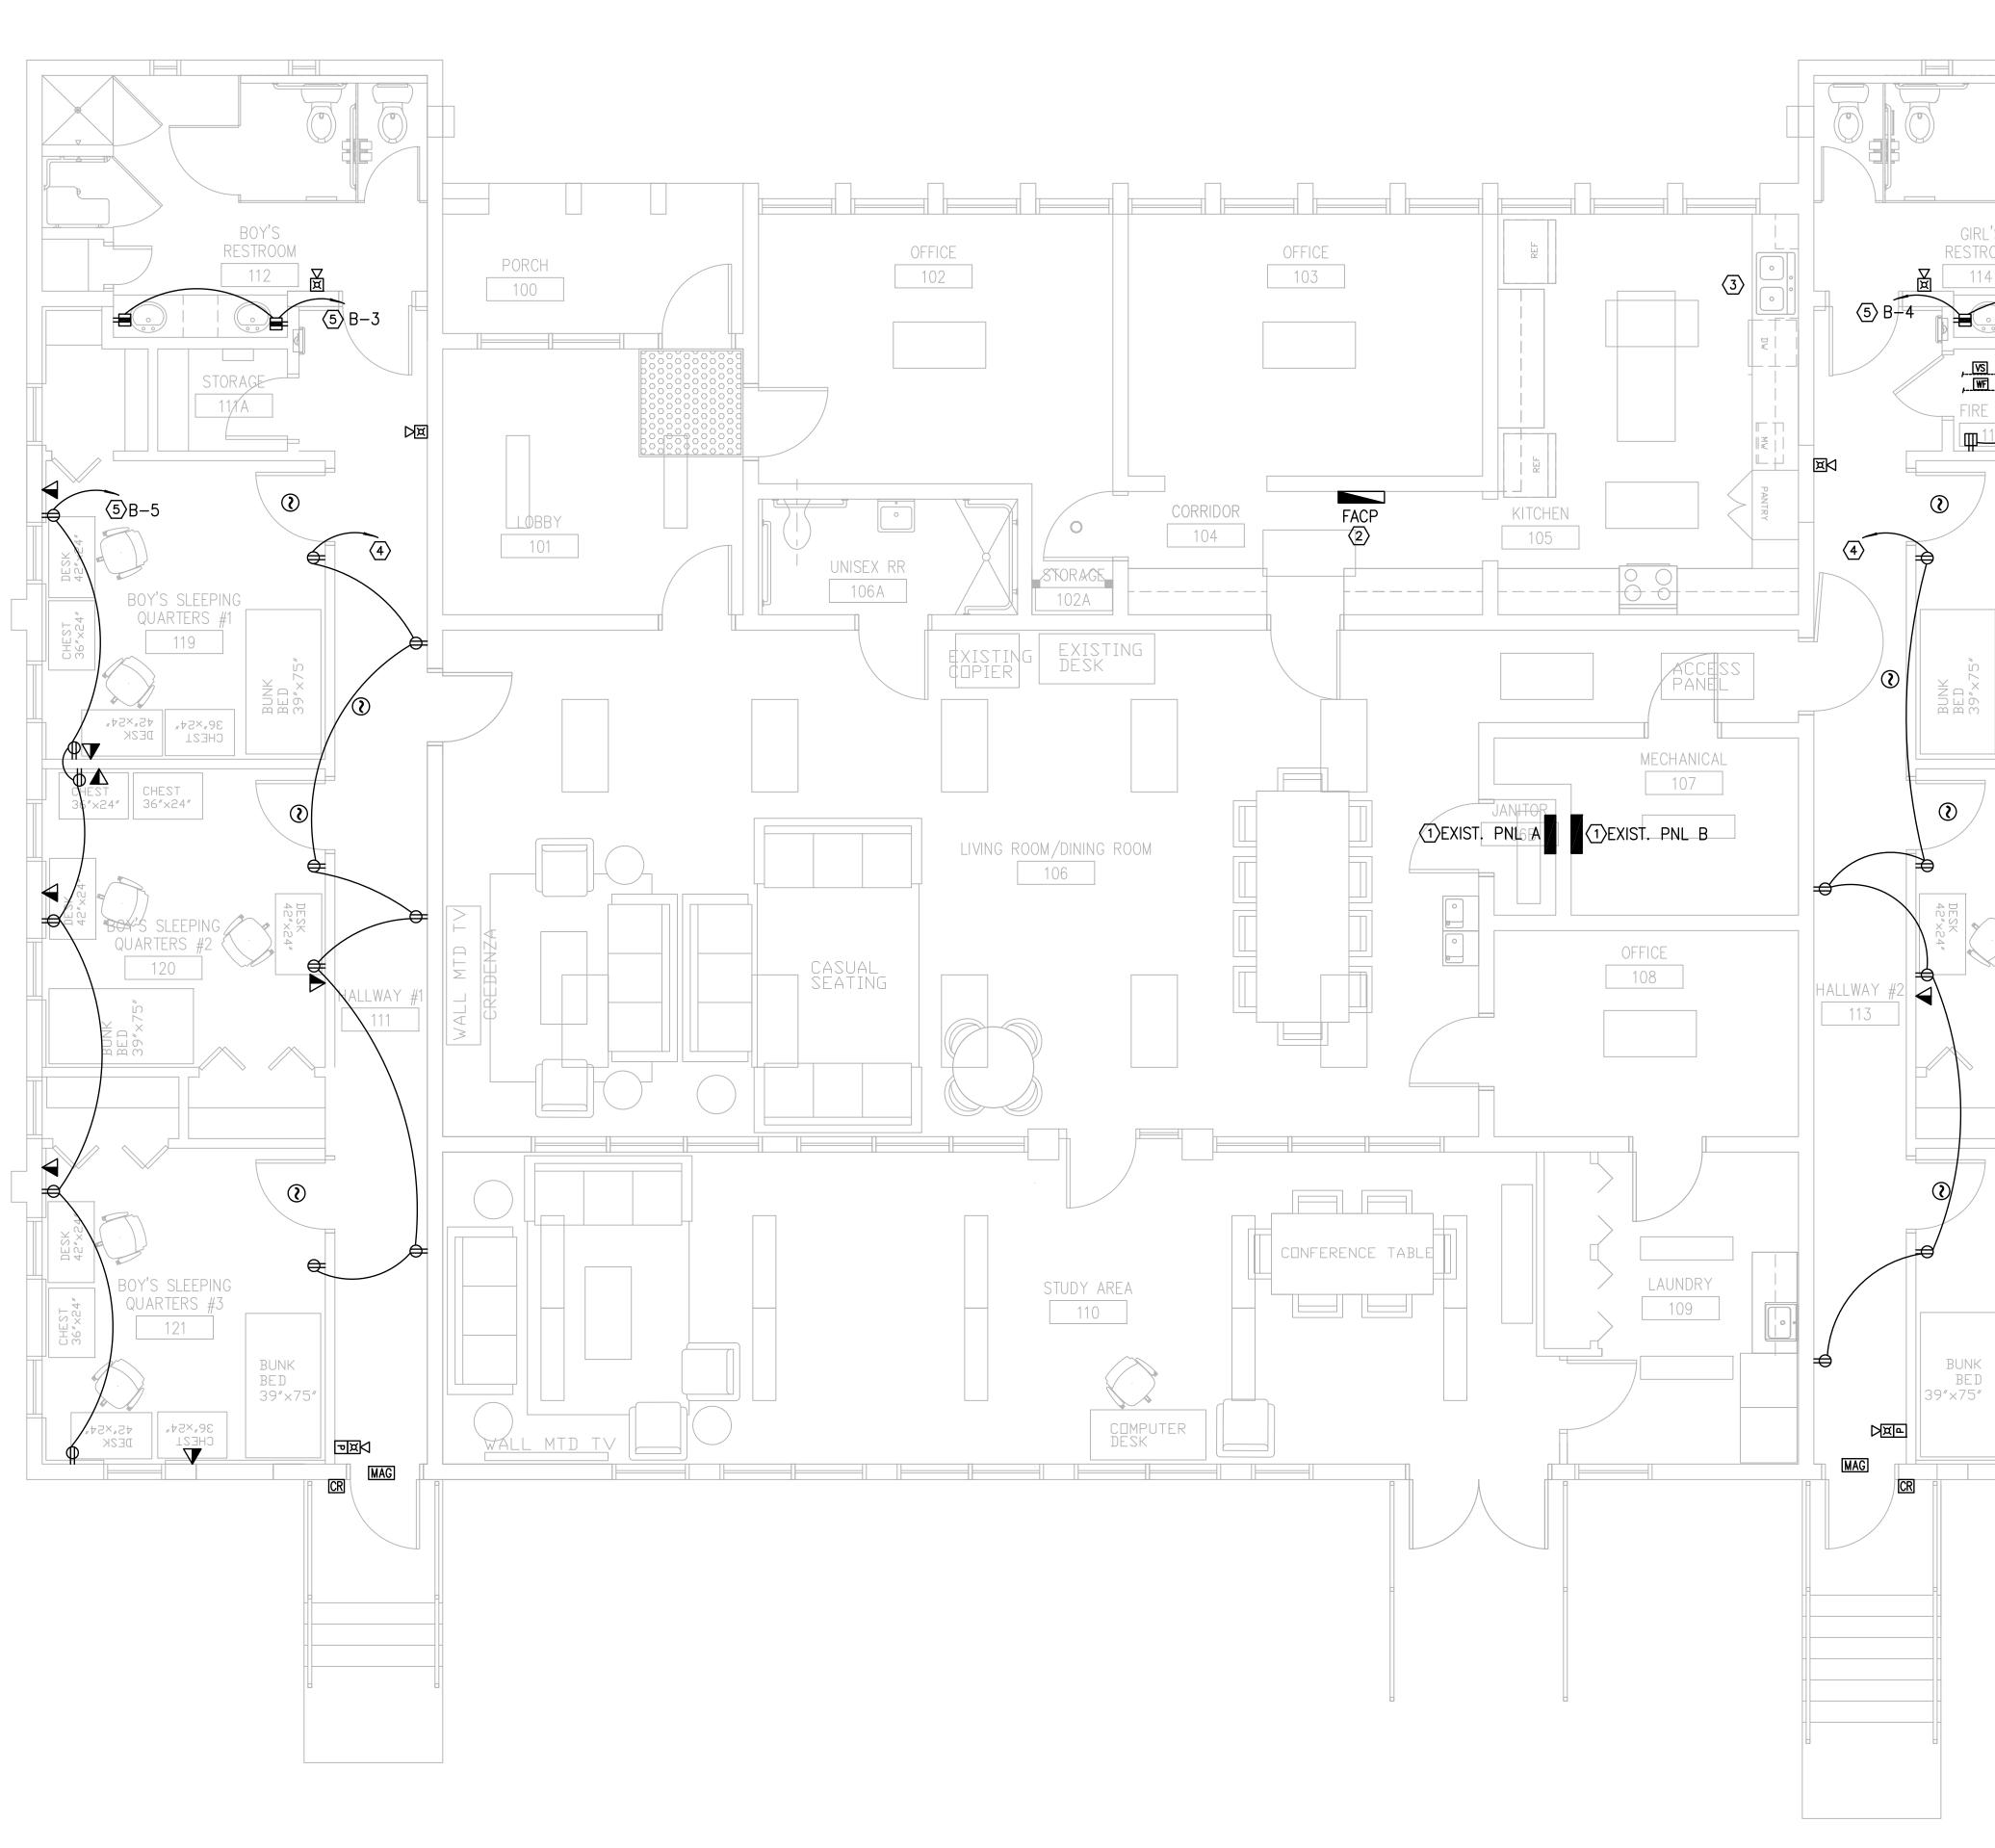

RINTED ON: Dec 01, 2016 - 12:40pm



EXIST. MAIN ELECT SERVICE AND METER	ARCHITECTURAL DESIGN COLLABORATIVE 945 N. PENNSYLVANIA AVENUE WINTER PARK, FLORIDA 32789 OFFICE: (407) 629-1188 FAX: (407) 388-1220 WWW. ADCINTERNATIONAL.NET
GRL'S SLEEPING QUARTERS #1 116 -++2+,2+ SGRL'S SLEEPING QUARTERS #1 116 -++2+,2+ SGRL'S SLEEPING QUARTERS #1 116 -++2+,2+ SGRL'S SLEEPING QUARTERS #1 115 	Project Documents for:         Image: Construction of the state o
GIRL'S SLEEP 17 17 17 17 17 17 17 17 17 17	<ul> <li>NOT Status</li> </ul>
GRL'S SLEEPING       GRL'S SLEEPING         UARTERS #3       FRACE         118       FRACE         Image: Strange of the stra	<section-header><section-header><section-header><section-header><section-header><section-header><section-header><section-header><text><text><text></text></text></text></section-header></section-header></section-header></section-header></section-header></section-header></section-header></section-header>
<ul> <li>6. MAKE CONNECTION TO NEW TAMPER SWITCHES AT NEW BACKFLOW PREVENTOR/PIV VALVES. VERIFY EXACT LOCATION ON SITE.</li> <li>7. MAKE CONNECTION TO NEW TAMPER AND FLOW SWITCHES AT NEW FIRE RISER.</li> </ul>	Power Renovation Plan

		MANUFACTURER:SQ. D.TYPE:NQODAIC RATING:10VOLTS L-N:120VOLTS L-L:240PHASE1	K / V V	AMPS			Main of S.e r Shunt	MC ML ATE	B: 0: D:	N/A 100 N/A	RED AMPS AMPS			F	PANEL NAME:EX PNL BLOCATION:MECH ROOMMOUNTING:SURFACENEMA TYPE:1WIDTH :20.00DEPTH :5.75	IN IN
N O T E S	CKT NO.	IDENTIFICATION	L O A D		/PHASE	(KVA)				AKER	LOAD/	/PHASE	. ,	L O A D	IDENTIFICATION	CKT N NO. E S
				A	В		TRIP	Р		TRIP		A	В			
	1	SPARE	S				20	1	1	20		0.90		Е	MICROWAVE	2
2	3	NEW GFI RECEPTS	R		0.36		20		1	20			0.36	R	NEW GFI RECEPTS	4 2
2	5	NEW BEDROOM RECEPTS	R	1.08			20	1	1	20		1.08		R	NEW BEDROOM RECEPTS	6 2
	7	SPARE	S						1					S	SPARE	8
	9	DATA RECEPT	R	0.36			20	1	1					S	SPARE	10
	11	OFFICE RECEPT	R		0.90		20	1	1	20			0.36	R	KITCHEN RECEPT	12
	13	DISPOSAL	Е	0.50			20	1	1	20		0.36		R	KITCHEN RECEPT	14
	15	GFI RECEPT	R		0.54		20	1	1	20			0.36	R	KITCHEN RECEPT	16
	17	REFRIGERATOR	Е	0.50			20	1	1	20		0.50		E	REFRIGERATOR	18
	19	PHONE SYSTEM	Е		0.50		20	1	1	20			0.60	E	DISHWASHER	20
	21	OFFICE RECEPT	R	0.90			20	1	1	20		0.90		E	MICROWAVE	22
	23	LAUNDRY RECEPT	Е		0.50		20	1	1	20			0.54	R	GFI RECEPT	24
	25	OFFICE RECEPT	R	1.08			20	1	1	20		0.36		R	GFI RECEPT	26
	27	FIRE ALARM PANEL	E		0.50		20	1				0.00	2.25	E		28
	29	EXIT/EM LIGHT CIRCUIT		0.50	0.00		20	1	2	30		2.25	2.20	E	WATER HEATER	30
				0.00								2.20				00
					SUB FF						ANK (NOT					
					50011							10020)				
								2								
			I	4.9	3.3							6.4	4.5	1		
				4.0	0.0	l					l	0.4	4.0	1		
				NN. LOAD (KVA)	DEMAND FACTOR	DEMAND LOAD		тот			ONNECTE CTED AN			_		
				(RVA)	FACIOR	(KVA)		21			L DEMAN			-		
		LIGHTING (L)		0.50	1.25	0.63			TO		MAND AN	1PS/PH:	80	)		
		RECEPTACLES 1ST 10 KVA(R)		8.64	1.00	8.64								-		
		RECEPTACLES OVER 10KVA(R)		0.00	0.50	0.00		NO								
		HVAC EQUIPMENT (H) APPLIANCES (A)		0.00	1.00	0.00								JR T	HE PANEL IN ACCORDANCE WITH	
		EQUIPMENT (E)		9.90	1.00	9.90					E AS SPE				NEW RECEPTACLES.	
		LARGEST MOTOR (M)		0.00	1.25	0.00		<u>~</u> . I								
		OTHER (O)		0.00	1.00	0.00										
		SPARE (S)		0.00	1.00	0.00										
		LINKED PANEL (P)	I	ICLUDED I	NABOVE	TOTALS										

D KVA:	19.04
PS/PH:	79
D KVA:	19.17
PS/PH:	80

WINTE OFFICE FAX: (4	R PARK, FLC E: (407) 629-1 07) 388-1220	188		
Project	Documents	for:		
	T OAKS VI	LOUNT LORII	EIN COT	TAGI
ADA U 1784 E	JPGRADES	S AND RENOVATIC AN STREET		
Issue		•	-	hecked
	07.27.16 09.15.16	60% CD SET 90% CD SET	JS JS	KA KA
	12.02.16	PERMIT/BID SET	JS	KA KA
	formation			
Client Ir ORAN 400 E S	GE COUNT	TY CAPITAL PROJE ET 5th FLOOR 1	ECTS DI	VISIO
Client Ir ORAN 400 E S ORLAN	GE COUNT	ET 5th FLOOR		VISIO ue Dat
Client Ir ORAN 400 E S ORLAN	GE COUN OUTH STRE DO, FL 3280	ET 5th FLOOR	Issu	ue Dat
Client Ir ORAN 400 E S ORLAN	GE COUNT OUTH STRE DO, FL 3280 t Number By	ET 5th FLOOR	Issu	ue Date 12/02/20 ⁻ : Statu:
Client Ir ORAN 400 E S ORLAN Projec 15253 Drawn	GE COUNT OUTH STRE DO, FL 3280 t Number By	ET 5th FLOOR	Issu Project PERMIT / BI	ue Dat 12/02/20 : Statu ID CD SB Scale
Client Ir ORAN 400 E S ORLAN Projec 15253 Drawn JJB Check	GE COUNT OUTH STRE DO, FL 3280 It Number By ed By	ET 5th FLOOR	Issu Project PERMIT / BI	ue Dat 12/02/20 : Statu D CD SE
Client Ir ORAN 400 E S ORLAN JJB Check JLM File Na	GE COUNT OUTH STRE DO, FL 3280 It Number By ed By	ET 5th FLOOR	Issu Project PERMIT / BI	ue Dat 12/02/20 : Statu ID CD SB Scale
Client Ir ORAN 400 E S ORLAN JJB Check JLM File Na Consu	GE COUNT OUTH STRE DO, FL 3280 It Number By ed By ed By ame	Signature	Issu Project PERMIT / BI	ue Dat 12/02/20 : Statu ID CD SI Scale
Client Ir ORAN 400 E S ORLAN JJB Check JLM File Na Consu	GE COUNT OUTH STRE DO, FL 3280 tt Number By ed By ed By ame Itant • Seal/S GINEE CONSULTINC CA-00062 935 LAKE BALDO ORLANDO, FL TEL: 407-767 FAX: 407-767 WWW.SGMENGINE YRIGHT © 2014 SGM	Signature	Issu Project PERMIT / BI A	ue Dat 12/02/20 Statu D CD SI Scal S NOTE
Client Ir ORAN 400 E S ORLAN JJB Check JLM File Na Consu	GE COUNT OUTH STRE DO, FL 3280 t Number By ed By ed By ame Itant • Seal/S GINEE CONSULTINC CA-00062 935 LAKE BALDW ORLANDO, FL TEL: 407-767 FAX: 407-767 WWW.SGMENGINE YRIGHT © 2014 SGM SGM #: 2016	Signature	Issu Project PERMIT / BI A	ue Dat 12/02/20 Statu D CD SI Scald S NOTE
Client Ir ORAN 400 E S ORLAN Projec 15253 Drawn JJB Check JLM File Na Consu	GE COUNT OUTH STRE DO, FL 3280 tt Number By ed By ed By ame Itant • Seal/S GINEE CONSULTING CA-00062 935 LAKE BALDO ORLANDO. FL TEL: 407-767 FAX: 407-767 VWW.SGMENGINE YRIGHT © 2014 SGM SGM #: 2016	Signature	Issu Project PERMIT / BI	ue Dat 12/02/20 Statu D CD SI Scal S NOTE

E4.01

١.		ENERAL	E. THE OPI
	Α.	. IT IS THE GENERAL CONTRACTOR'S RESPONSIBILITY TO OBTAIN ALL CONTRACT DOCUMENTS AND LATEST ADDENDA AND TO SUBMIT TO ALL SUBCONTRACTORS AND SUPPLIERS PRIOR TO THE SUBMITTAL OF SHOP DRAWINGS.	THI WE F. PR(
	В.	STRUCTURAL DRAWINGS SHALL BE USED IN CONJUNCTION WITH THE ARCHITECTURAL, MECHANICAL, ELECTRICAL, SHOP DRAWINGS AND SPECIFICATIONS. THE CONTRACTOR SHALL COORDINATE ALL ELEVATIONS	G. BUI
		AND DIMENSIONS, INCLUDING BUT NOT LIMITED TO THOSE FOR OPENINGS IN WALLS AND IN ROOF AND FLOOR SYSTEMS, WITH THE OTHER DISCIPLINES. THE GENERAL CONTRACTOR SHALL COMPARE ALL CONTRACT DRAWINGS AND REPORT ANY DISCREPANCY BETWEEN DISCIPLINES AND WITHIN A GIVEN DISCIPLINE TO THE	
	C.	ARCHITECT AND ENGINEER BEFORE PROCEEDING WITH THE AFFECTED PART OF THE WORK. . ALL DIMENSIONS, ELEVATIONS, AND ANY OTHER CONDITIONS OF ANY EXISTING STRUCTURES OR OTHER FEATURES SHALL BE VERIFIED BY THE GENERAL CONTRACTOR AND ANY DISCREPANCIES WITH THE CONTRACT	2.
		DRAWINGS REPORTED TO THE ARCHITECT AND ENGINEER BEFORE PROCEEDING WITH THE AFFECTED PART OF THE WORK. DURING THE CONSTRUCTION PROCESS, IT SHALL BE SOLELY THE CONTRACTOR'S	3.
	D.	RESPONSIBILITY TO MAINTAIN THE INTEGRITY OF THE EXISTING STRUCTURE AND TO PROTECT FROM DAMAGE ANY PORTIONS THAT ARE TO REMAIN. THE CONTRACTOR SHALL NOT OVERLOAD THE STRUCTURE DURING CONSTRUCTION. THE CONTRACTOR SHALL	
		BE RESPONSIBLE FOR CHECKING THE ADEQUACY OF THE STRUCTURE TO SUPPORT ANY APPLIED CONSTRUCTION LOADS, INCLUDING THOSE DUE TO CONSTRUCTION VEHICLES OR EQUIPMENT, MATERIAL HANDLING OR STORAGE, SHORING OR RESHORING, OR ANY OTHER CONSTRUCTION ACTIVITY. THE	III. CONCI
		CONTRACTOR SHALL SUBMIT CALCULATIONS SIGNED AND SEALED BY AN ENGINEER LICENSED IN THE STATE OF FLORIDA VERIFYING THE ADEQUACY OF THE STRUCTURE FOR ANY PROPOSED CONSTRUCTION LOADS	A. ALI B. PO
		THAT ARE IN EXCESS OF THE STATED DESIGN LOADS. THE STRUCTURAL ENGINEER IS NOT RESPONSIBLE TO DESIGN OR CHECK THE STRUCTURE FOR LOADS APPLIED TO THE STRUCTURE FOR ANY CONSTRUCTION ACTIVITY.	C. ALI D. CO 1.
		IF A CONFLICT EXISTS AMONG THE STRUCTURAL DRAWINGS, GENERAL NOTES, OR THE SPECIFICATIONS, THE STRICTEST REQUIREMENTS, AS INDICATED BY THE ENGINEER, SHALL GOVERN. THE STRUCTURE IS DESIGNED TO BE SELF SUPPORTING AND STABLE AFTER THE BUILDING IS COMPLETE.	
	1.	THE COMPLETED LATERAL—FORCE RESISTING SYSTEMS AND DIAPHRAGMS ARE REQUIRED FOR THE STRUCTURE TO RESIST LATERAL LOADS AND PROVIDE STABILITY UNDER GRAVITY LOADS. DURING THE CONSTRUCTION	2.
		PROCESS, THE CONTRACTOR SHALL PROVIDE ALL REQUIRED BRACING DURING CONSTRUCTION TO MAINTAIN THE STABILITY AND SAFETY OF ALL STRUCTURAL ELEMENTS UNTIL THE LATERAL-LOAD RESISTING OR STABILITY-PROVIDING SYSTEM IS COMPLETELY INSTALLED AND THE STRUCTURE IS COMPLETELY TIED	3. 4.
	G.	TOGETHER. THIS ALSO INCLUDES NECESSARY SHORING, SHEETING, GUYS OR TIE DOWNS. . UNLESS OTHERWISE NOTED, DETAILS SHOWN ON ANY DRAWING ARE TO BE CONSIDERED TYPICAL FOR ALL	5. 6.
		SIMILAR CONDITIONS. DETAILS LABELED TYPICAL DETAILS ON THE DRAWINGS SHALL APPLY TO ALL SITUATIONS OCCURRING ON THE PROJECT THAT ARE SIMILAR OR SAME TO THOSE SPECIFICALLY DETAILED. CONTRACTOR TO REVIEW SIMILAR LOCATIONS AND INCLUDE ANY REQUIRED MODIFICATIONS IN BID. SUCH DETAILS SHALL	E. ALI 1. 2.
	Н.	APPLY WHETHER OR NOT THEY ARE REFERENCED AT EACH LOCATION. . THE CONTRACTOR SHALL BE SOLELY RESPONSIBLE FOR ALL CONSTRUCTION MEANS AND METHODS AND FOR SAFETY PRECAUTIONS AND PROGRAMS. DURING THE CONSTRUCTION PROCESS, IT SHALL BE SOLELY THE	2. 3. 4.
	I	CONTRACTOR'S RESPONSIBILITY TO MAINTAIN THE INTEGRITY OF THE EXISTING STRUCTURE AND TO PROTECT FROM DAMAGE ANY PORTIONS THAT ARE TO REMAIN.	F. RE 1.
		BASE CONSULTANTS, INC., SHALL NOT BE RESPONSIBLE FOR THE ACTS OR OMISSION OF THE CONTRACTOR OR FOR THEIR FAILURE TO CARRY OUT THE WORK IN ACCORDANCE WITH THE CONTRACT DOCUMENTS. PERIODIC SITE OBSERVATION BY BASE CONSULTANTS, INC. IS SOLELY FOR THE PURPOSE OF DETERMINING	2.
		IF THE WORK OF THE CONTRACTOR IS PROCEEDING IN GENERAL CONFORMANCE WITH THE STRUCTURAL CONTRACT DOCUMENTS AND IS NOT EXHAUSTIVE OR CONTINUOUS TO CHECK THE QUALITY OR QUANTITY OF THE WORK.	3.
	К.	ALL STRUCTURES REQUIRE PERIODIC MAINTENANCE TO EXTEND LIFESPAN AND FOR STRUCTURAL INTEGRITY FROM EXPOSURE TO THE ENVIRONMENT. A PLANNED PROGRAM OF MAINTENANCE SHALL BE ESTABLISHED BY THE BUILDING OWNER. THIS PROGRAM SHALL INCLUDE SUCH ITEMS SUCH AS BUT NOT LIMITED TO	4.
		PAINTING OF STRUCTURAL STEEL, PROTECTIVE COATING FOR CONCRETE, SEALANTS, CAULKED JOINTS, EXPANSION JOINTS, CONTROL JOINTS, SPALLS AND CRACKS IN CONCRETE, AND PRESSURE WASHING OF	5.
	L.	EXPOSED STRUCTURAL ELEMENTS EXPOSED TO A SALT ENVIRONMENT OR OTHER HARSH CHEMICALS. REFER TO SPECIFICATION SECTION 01631 "PRODUCTS SUBSTITUTIONS" FOR SUBSTITUTION PROCEDURES. BASE CONSULTANTS, INC. RETAINS THE RIGHT TO REJECT ANY SUBSTITUTION REQUESTS.	6.
	М.	. ALL MASONRY WALLS SHOWN ON STRUCTURAL DRAWINGS HAVE BEEN DESIGNED TO RESIST THE REQUIRED CODE VERTICAL AND LATERAL FORCES APPLIED TO THEM IN THE FINAL CONSTRUCTED CONFIGURATION ONLY	G. TH DR
		ASSUMING FULL BRACING TOP, BOTTOM, AND/OR SIDE OF WALL AS SHOWN. IT IS THE RESPONSIBILITY OF THE CONTRACTOR TO PROPERLY AND ADEQUATELY BRACE ALL MASONRY WALLS AT ALL STAGES DURING CONSTRUCTION TO RESIST ERECTION LOADS AND LATERAL LOADS THAT COULD POSSIBLY BE APPLIED PRIOR	H. SE CO OT
	N.	TO COMPLETION OF CONSTRUCTION. . CONTRACTOR TO ISSUE REQUEST FOR INFORMATION (RFI) FOR ANY INFORMATION NOT CLEAR/NOT SHOWN IN THE DRAWINGS.	IN I. ALI
		. DO NOT SCALE DRAWINGS. . STRUCTURAL ENGINEER IS NOT RESPONSIBLE FOR THE DESIGN OF STEEL STAIRS, HANDRAILS,	IV. COI A. HOI STF
		CURTAIN/WINDOW WALL SYSTEMS, PRECAST, COLD FORMED METAL FRAMING OR OTHER SYSTEMS NOT SHOWN IN THE STRUCTURAL DRAWINGS. SUCH SYSTEMS SHALL BE DESIGNED, FURNISHED AND INSTALLED AS REQUIRED BY OTHER PORTIONS OF THE CONTRACT DOCUMENTS.	SH/ B. ALL
	Q.	. NO STRUCTURAL MEMBER SHALL BE CUT, NOTCHED OR OTHERWISE ALTERED UNLESS APPROVED IN WRITING BY THE ENGINEER OF RECORD. THE CONTRACTOR SHALL BE RESPONSIBLE FOR ANY AND ALL COSTS INCURRED BY ENGINEER OF RECORD FOR THE REVIEW.	COI C. ALL TES
		ANY TEXT CALLOUTS OR NOTES SHOWN ON PLANS OR DETAILS SUPERCEED ANY DRAWN ELEMENTS. ANY ITEM CALLED OUT ON PLAN SHALL BE INCLUDED IN THE CONTRACTOR'S SCOPE EVEN IF IT DOES NOT HAVE AN	DIR SH/
		ACCOMPANYING DETAIL.	D. USI E. REI HOI
.		ESIGN CRITERIA	F. VEF DIA G. PR(
		THE CONTRACT DOCUMENTS ARE BASED ON THE REQUIREMENTS OF THE FLORIDA BUILDING CODE 2014 WITH 2016 SUPPLEMENT. DEAD LOADS	AS MAS
		<ol> <li>PARTITIONS: 20 PSF</li> <li>MISCELLANEOUS CEILING AND HANGING MECHANICAL LOADS SUCH AS DUCT WORK AND SPRINKLER PIPES: 10 PSF</li> </ol>	1. 2. 3.
	C.	. LIVE LOADS 1. LIVE LOADS ARE BASED ON THE MORE RESTRICTIVE OF THE UNIFORM LOAD LISTED BELOW OR THE	4. 5.
		CONCENTRATED LOAD LISTED ACTING OVER A 6.25 SQUARE FOOT AREA. CATEGORY UNIFORM LOAD (PSF) a. PRIVATE ROOMS 40	H. PR REI A82
		b. PUBLIC ROOMS 100 c. ROOF 20	AT MIN
	D.	DESIGN WIND LOADS FOR STRENGTH DESIGN WITH A LOAD FACTOR OF 1.0: ULTIMATE WIND SPEED 139 MPH	I. TEF CEL COI
		EXPOSURE C RISK CATEGORY II COMPONENTS AND CLADDING WIND LOADS:	J. REF MA`
		ZONES EFFECTIVE AREA (SQ FT) 10 20 50 100	V. DEN A. REN
		WALLS: INTERIOR (4) $+54.3/-58.8$ $+51.9/-56.4$ $+48.7/-53.2$ $+46.4/-50.7$ EDGE (5) $+54.3/-72.4$ $+51.9/-67.6$ $+48.7/-61.2$ $+46.4/-56.4$ CORNER AND EDGE ZONES ARE 22.4 FEET WIDE.	ARI DAM
	RSF	HIP OF INSTRUMENTS OF SERVICE:	B. THE

•	THE CONTRACTOR SHALL VERIFY ALL MECHANICAL EQUIPMENT WEIGHTS, LOCATIONS AND ASSOCIATED OPENINGS WITH THE MECHANICAL CONTRACTOR AND SUBMIT SUCH INFORMATION PRIOR TO FABRICATION OF THE SUPPORTING STRUCTURE. PROMPTLY NOTIFY THE ENGINEER IF THE ACTUAL WEIGHT EXCEEDS THE WEIGHT SHOWN ON THE STRUCTURAL DRAWINGS. PROVISIONS SHALL BE MADE IN THE DETAILING, FABRICATION, AND ERECTION OF ALL CLADDING, PARTITIONS,	С
•	WALLS, ETC. TO ACCOUNT FOR FLOOR TO FLOOR DEFLECTIONS AND LATERAL FRAME DEFLECTION. BUILDING MOVEMENT AND DEFLECTIONS 1. THE BUILDING MOVEMENT SPECIFIED HEREIN IS ANTICIPATED TO OCCUR UNDER THE NOMINAL	D
	<ul> <li>(UNFACTORED) LOADS SPECIFIED BY THE BUILDING CODE AND SHALL BE CONSIDERED BY THE CONTRACTOR IN THE PERFORMANCE OF THE WORK.</li> <li>2. PROVISIONS SHALL BE MADE IN THE DETAILING, FABRICATION, AND ERECTION OF ALL CLADDING, PARTITIONS, WALLS, ETC. TO ACCOUNT FOR FLOOR TO FLOOR DEFLECTIONS AND LATERAL FRAME</li> </ul>	E.
	<ul> <li>DEFLECTION.</li> <li>3. LATERAL FRAME DEFLECTION (STORY DRIFT) UNDER WIND LOAD. THE DESIGN, FABRICATION AND INSTALLATION OF THE BUILDING CLADDING AND ALL WALL PARTITIONS SHALL CONSIDER LATERAL FRAME DEFLECTION IN THE PLANE OF THE CLADDING OR WALL OF ONE FLOOR RELATIVE TO AN ADJACENT FLOOR EQUAL TO THE FOLLOWING LIMITS: <ul> <li>a. TYPICAL FLOOR TO FLOOR: FLOOR HEIGHT/400</li> </ul> </li> </ul>	F.
	ONCRETE ALL CONCRETE CONSTRUCTION SHALL CONFORM TO THE CURRENT "ACI MANUAL OF CONCRETE PRACTICE".	G
}. 	ALL CONCRETE CONSTRUCTION SHALL CONFORM TO THE CORRENT ACT MANUAL OF CONCRETE FRACTICE. PORTLAND CEMENT SHALL CONFORM TO ASTM C-150, TYPE I OR II. ALL AGGREGATE FOR NORMAL WEIGHT CONCRETE SHALL MEET ASTM C 33. CONCRETE SHALL CONFORM TO THE FOLLOWING REQUIREMENTS: 1. CONCRETE 28 DAY COMPRESSIVE STRENGTH AND DENSITY REQUIREMENTS:	H I.
	STRENGTH CONC. MAX. AGGR. EXPOSURE USAGE (PSI) TYPE SIZE CLASS ALL CONCRETE NOT OTHERWISE SPECIFIED 4000 NWT 3/4" C1	J. K
	2. INDICATED CONCRETE TYPES SHALL BE PROPORTIONED FOR MAXIMUM WATER CEMENT RATIO OF 0.45. 3. NWT = NORMAL WEIGHT CONCRETE.	
	<ol> <li>ALL CONCRETE SHALL HAVE ALLOWABLE UNIT SHRINKAGE OF 0.03% AT 28 DAYS. (SEE ASTM C157)</li> <li>ALL SLABS TO RECEIVE MOISTURE SENSITIVE FLOOR COVERINGS SHALL HAVE MAXIMUM WATER/ CEMENT RATIO OF 0.45.</li> </ol>	VI.
. •	<ul> <li>6. EXTERIOR CONCRETE SLABS SHALL HAVE 1% TO 6% ENTRAINED AIR</li> <li>ALL REINFORCEMENT SHALL CONFORM TO THE FOLLOWING SPECIFICATIONS:</li> <li>1. ALL REINFORCING, UNO: ASTM A615 GRADE 60</li> <li>2. DEFORMED BAR ANCHORS (DBA): ASTM A496 (75 KSI)</li> <li>3. WELDED REINFORCING: ASTM A706</li> <li>4. WELDED WIRE REINFORCEMENT (WWR):</li> </ul>	
•	<ul> <li>a. DEFORMED WIRE: ASTM A 497 (70 KSI)</li> <li>REINFORCEMENT DETAILING:</li> <li>1. REINFORCEMENT SHALL BE DETAILED AND PLACED IN ACCORDANCE WITH ACI 315.</li> <li>2. PLACEMENT OF WELDED WIRE REINFORCEMENT: WHEREVER WELDED WIRE REINFORCEMENT IS SPECIFIED AS REINFORCEMENT, IT SHALL BE CONTINUOUS ACROSS THE ENTIRE CONCRETE SURFACE AND NOT</li> </ul>	
	<ul> <li>INTERRUPTED BY BEAMS OR GIRDERS. LAP WWR ONE CROSSWIRE SPACING PLUS 2".</li> <li>REINFORCING STEEL COVERAGE: THE CONCRETE COVER FOR REINFORCEMENT LAYERS NEAREST TO THE SURFACE SHALL BE IN ACCORDANCE WITH ACI 318 UNLESS NOTED OTHERWISE IN THE SPECIFICATIONS OR ON THE DRAWINGS.</li> <li>REINFORCEMENT SHALL BE SECURELY PLACED TO PREVENT DISPLACEMENT DURING CONCRETE PLACEMENT. PROVIDE THE FOLLOWING CONCRETE COVER FOR REINFORCING [TABLE 3.3.2.3 OF ACI</li> </ul>	V
	301–99], UNLESS SPECIFICALLY DETAILED OTHERWISE. 5. PROVIDE DOWELS TO MATCH REINFORCEMENT SIZE AND SPACING INDICATED FOR ALL STRUCTURAL	V
	<ul> <li>ELEMENTS, UNLESS OTHERWISE INDICATED.</li> <li>6. WHEREVER WELDED WIRE REINFORCEMENT IS SPECIFIED AS REINFORCEMENT, IT SHALL BE CONTINUOUS ACROSS THE ENTIRE CONCRETE SURFACE AND PROPERLY LAPPED PER ACI 318, 12.18 AND 12.19.</li> <li>THERE SHALL BE NO HORIZONTAL CONSTRUCTION JOINTS IN CONCRETE POURS UNLESS SHOWN ON THE DRAWINGS. THE ARCHITECT/ENGINEER SHALL APPROVE ALL DEVIATIONS OR ADDITIONAL JOINTS IN WRITING.</li> </ul>	A B
1.	SEE ARCHITECTURAL AND MECHANICAL DRAWINGS FOR LOCATIONS OF OPENINGS AND SLEEVES IN CONCRETE WALLS AND SUPPORTED FLOORS. SPREAD REINFORCEMENT AT OPENINGS AND SLEEVES UNLESS OTHERWISE SHOWN. DO NOT CUT REINFORCEMENT. SEE TYPICAL REINFORCEMENT DETAILS FOR OPENINGS IN SLABS AND WALLS FOR ADDITIONAL REQUIREMENTS. ALUMINUM SHALL NOT BE EMBEDDED IN ANY CONCRETE.	С
•	CONCRETE MASONRY: HOLLOW CONCRETE BLOCK (MASONRY) UNITS SHALL BE NORMAL WEIGHT WITH A MINIMUM COMPRESSIVE STRENGTH OF 1900 PSI ON THE NET AREA AND 1000 PSI ON THE GROSS AREA ( $F'M = 1500PSI$ ) AND SHALL CONFORM TO ASTM C-90 AND SAMPLED IN ACCORDANCE WITH ASTM C140. ALL MORTAR FOR USE IN MASONRY SHALL CONFORM TO ASTM C-270, TYPE M OR S. AVERAGE	
•	COMPRESSIVE STRENGTH AT 28DAYS OF AT LEAST 1800PSI. ALL GROUT FOR USE IN MASONRY SHALL CONFORM TO ASTM C-476, MIN. 3000 PSI. GROUT SHALL BE TESTED IN ACCORDANCE WITH ASTM C109. FOR FILLING SPACES LESS THAN 4" IN ONE OR BOTH DIRECTIONS, USE GROUT PROPORTIONED PER ASTM C476. SLUMP AT THE FINAL POINT OF DISCHARGE	D
•	SHALL BE 8 TO 11 INCH. USE OF AIR ENTRAINING ADMIXTURE IS NOT ALLOWED. REINFORCING BARS TO MEET ASTM A-615, GRADE 60. ALL GROUTS SHALL BE PLACED WITHIN 1- 1/2 HOURS FROM INTRODUCING WATER.	E.
	VERTICAL AND HORIZONTAL REINFORCING SHALL BE CONTINUOUS AND LAPPED A MINIMUM OF 48 BAR DIAMETERS.	F.
•	PROVIDE VERTICAL REINFORCEMENT IN CELLS OF CONCRETE MASONRY UNITS (FULLY EMBEDDED IN GROUT) AS SHOWN ON DRAWINGS. MINIMUM REINFORCEMENT OF EXTERIOR, PERIMETER, OR LOAD-BEARING MASONRY SHALL BE AS FOLLOWS: 1. ONE #5 AT EACH CORNER	G
	<ol> <li>ONE #5 AT EACH CORNER</li> <li>ONE #5 AT BOTH SIDES OF OPENINGS UP TO 12 FEET WIDE</li> <li>TWO #5 OR ONE #7 AT BOTH SIDES OF OPENINGS OVER 12 FEET WIDE</li> <li>ONE #5 AT MAXIMUM SPACING OF 48" O.C.</li> </ol>	
•	5. HEAVIËR REINFORCEMENT MAY BE REQUIRED BY DETAILS IN THE DRAWINGS PROVIDE #9 TRUSS TYPE JOINT REINFORCEMENT AT 16"OC FOR TYPICAL HORIZONTAL REINFORCING. REINFORCEMENT SHALL BE FABRICATED FROM HIGH STRENGTH, COLD DRAWN WIRE CONFORMING TO ASTM A82. TRUSSES SHALL BE GALVANIZED AFTER FABRICATION. ALSO PLACE THREE ROWS OF REINFORCEMENT AT 8" O.C. IMMEDIATELY ABOVE ALL OPENINGS AND AT TOP OF WALLS. SIDE LAP OF RAILS SHALL BE A MINIMUM OF 6".	
•	TERMINATE ALL HORIZONTAL AND VERTICAL REINFORCEMENT OF THE BOND BEAM INTO A VERTICAL GROUTED CELL WITH A STANDARD HOOK. PROVIDE CORNER BARS SUCH THAT HORIZONTAL REINFORCEMENT IS CONTINUOUS ALL CMU TO BE LAID IN STACK BOND PATTERN. REFER TO ARCHITECTURAL DRAWINGS FOR THE EXTENT OF MASONRY WALLS. NON-LOAD BEARING WALLS MAY NOT BE SHOWN ON THE STRUCTURAL DRAWINGS.	
	DEMOLITION	

DEMOLITION REMOVE STRUCTURE FROM TOP DOWN. DO NOT ALLOW DEBRIS TO PILE UP OR FALL ON SLABS WHICH ARE TO REMAIN IN PLACE. PROVIDE PLYWOOD AND/OR PLANKING TO CUSHION AND PROTECT SLABS FROM DAMAGE. REPAIR OR REPLACE DAMAGED SLABS, BEAMS, OR GIRDERS AS DIRECTED BY OWNER. THESE DRAWINGS ARE INTENDED TO DEFINE LIMITS OF REMOVAL OF STRUCTURAL ELEMENTS AND

- STEEL EXPOSED, PROVIDE THE FOLLOWING:
- 1. CHIP CONCRETE FROM AROUND THE STEEL TO A DEPTH OF 1".
- MANUFACTURERS.
- INDICATED ON DRAWINGS.
- ERECTION OF THE NEW CONSTRUCTION.
- OPERATION IS SCHEDULED TO SHUT DOWN.
- OF ANY UTILITY SYSTEM A MINIMUM OF 3 DAYS PRIOR TO COMMENCING WORK.

- BRACING AND SUPPORTS. ARCHITECT AND/OR ENGINEER.

POST-INSTALLED ANCHORS

- INTENDED LOAD.
- D. ACCEPTABLE PRODUCTS ARE: 1. "CRACKED CONCRETE" MECHANICAL ANCHORS: a. "HILTI KB-TZ" BY HILTI.
- 2. "CRACKED CONCRETE" ADHESIVE ANCHORS: a. "HIT RE500-SD" BY HILTI.


VII. SPECIALITY ENGINEERING REQUIREMENTS


VIII. SUBMITTALS

- SENT TO THE STRUCTURAL ENGINEER PRIOR TO THE START OF CONSTRUCTION.
- ERECTION SHALL BE FROM REVIEWED SHOP DRAWINGS.
- **REVIEW:**
- 1. CONCRETE MIX DESIGNS
- 2. REINFORCING STEEL 3. MISCELLANEOUS STEEL
- 4. EXPANSION ANCHORS
- 5. PREFABRICATED CANOPY STRUCTURE (1, 3)
- SEALED BY A REGISTERED ENGINEER IN THE STATE OF FLORIDA APPROVED.
- THAT MAY OCCUR HEREON.




ALL REPORTS, PLANS, SPECIFICATIONS, FIELD DATA AND NOTES AND OTHER DOCUMENTS, INCLUDING ALL DOCUMENTS ON ELECTRONIC MEDIA, PREPARED BY THE DESIGN PROFESSIONAL AS INSTRUMENTS OF SERVICE SHALL REMAIN THE PROPERTY OF THE DESIGN PROFESSIONAL

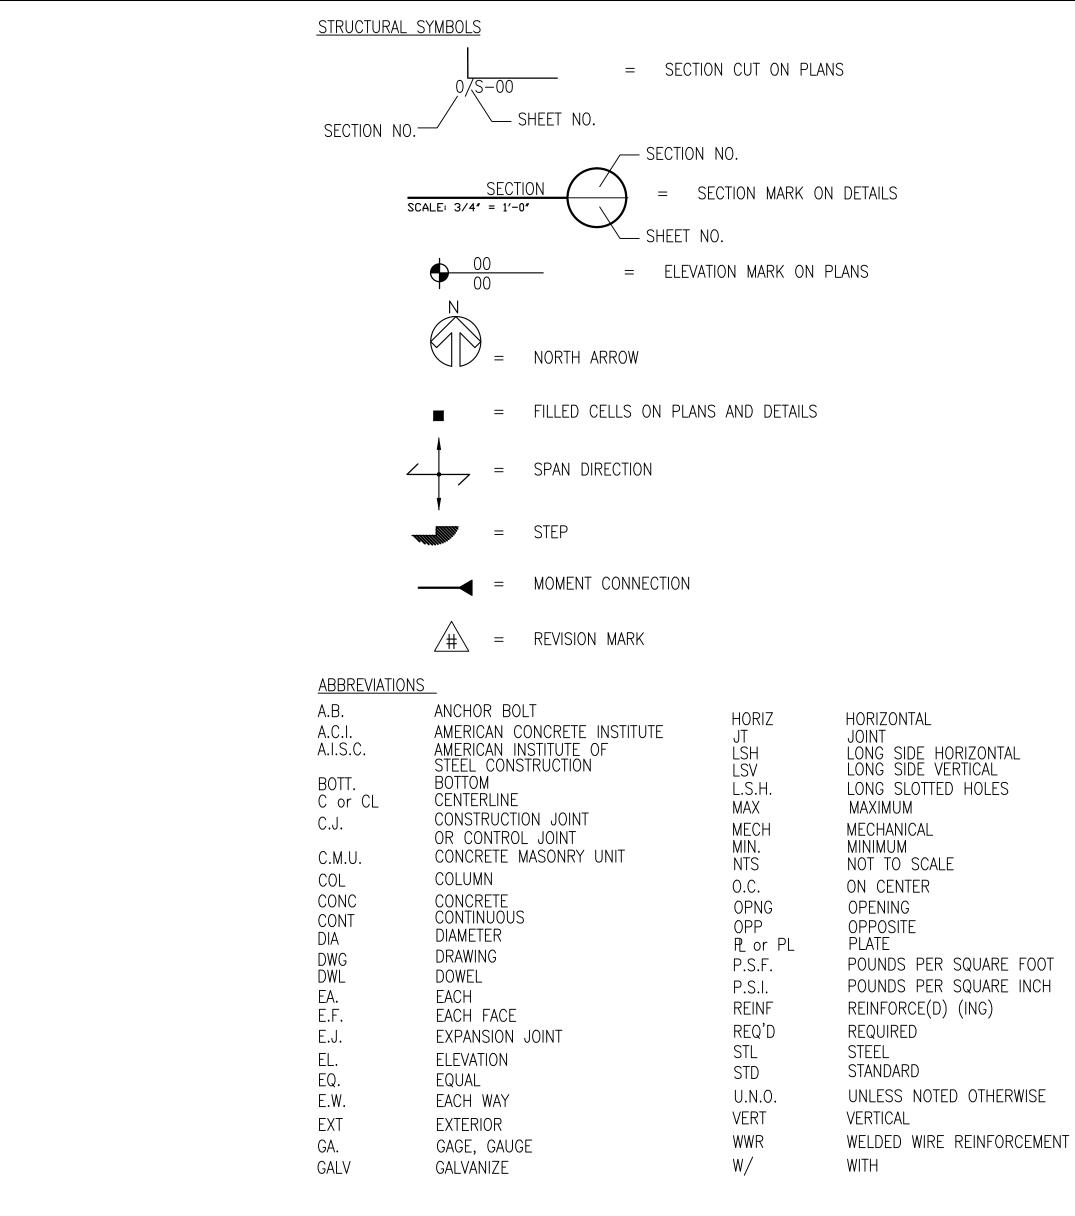

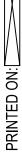


OWNERSHIP OF INSTRUMENTS OF SERVICE:

ALL REPORTS, PLANS, SPECIFICATIONS, FIELD DATA AND NOTES AND OTHER DOCUMENTS, INCLUDING ALL DOCUMENTS ON ELECTRONIC MEDIA, PREPARED BY THE DESIGN PROFESSIONAL AS INSTRUMENTS OF SERVICE SHALL REMAIN THE PROPERTY OF THE DESIGN PROFESSIONAL.

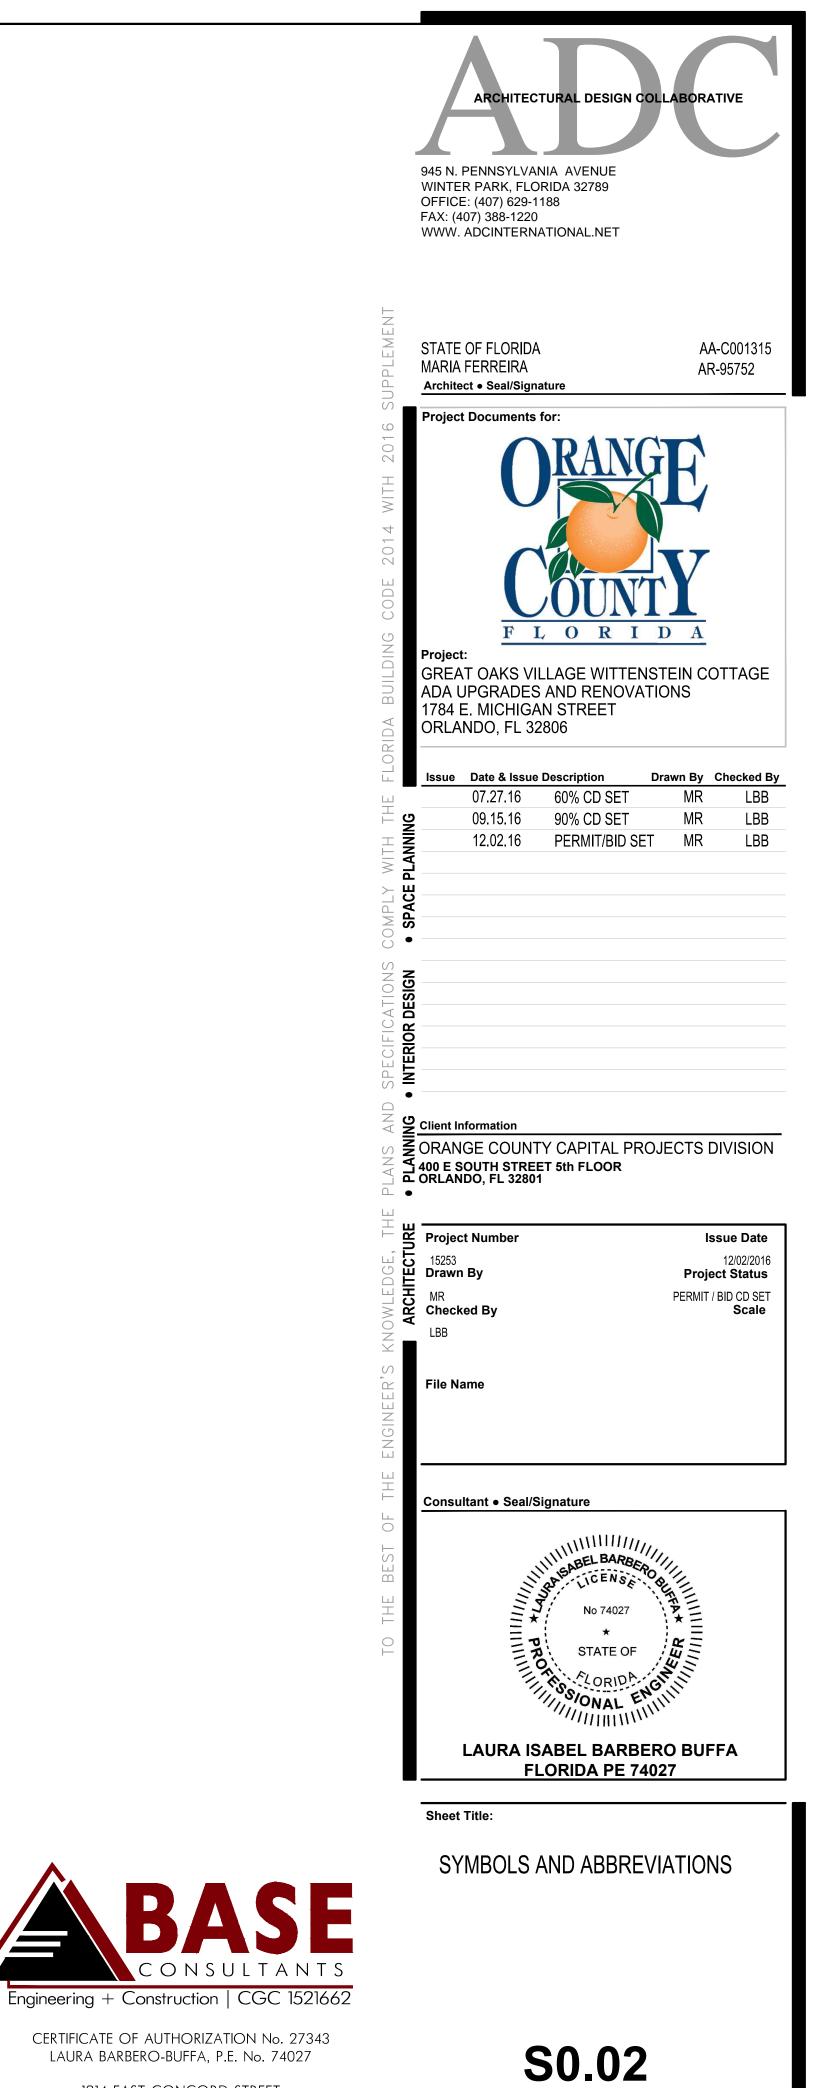

1214 EAST CONCORD STREET ORLANDO, FLORIDA 32803 P: 407.377.7227

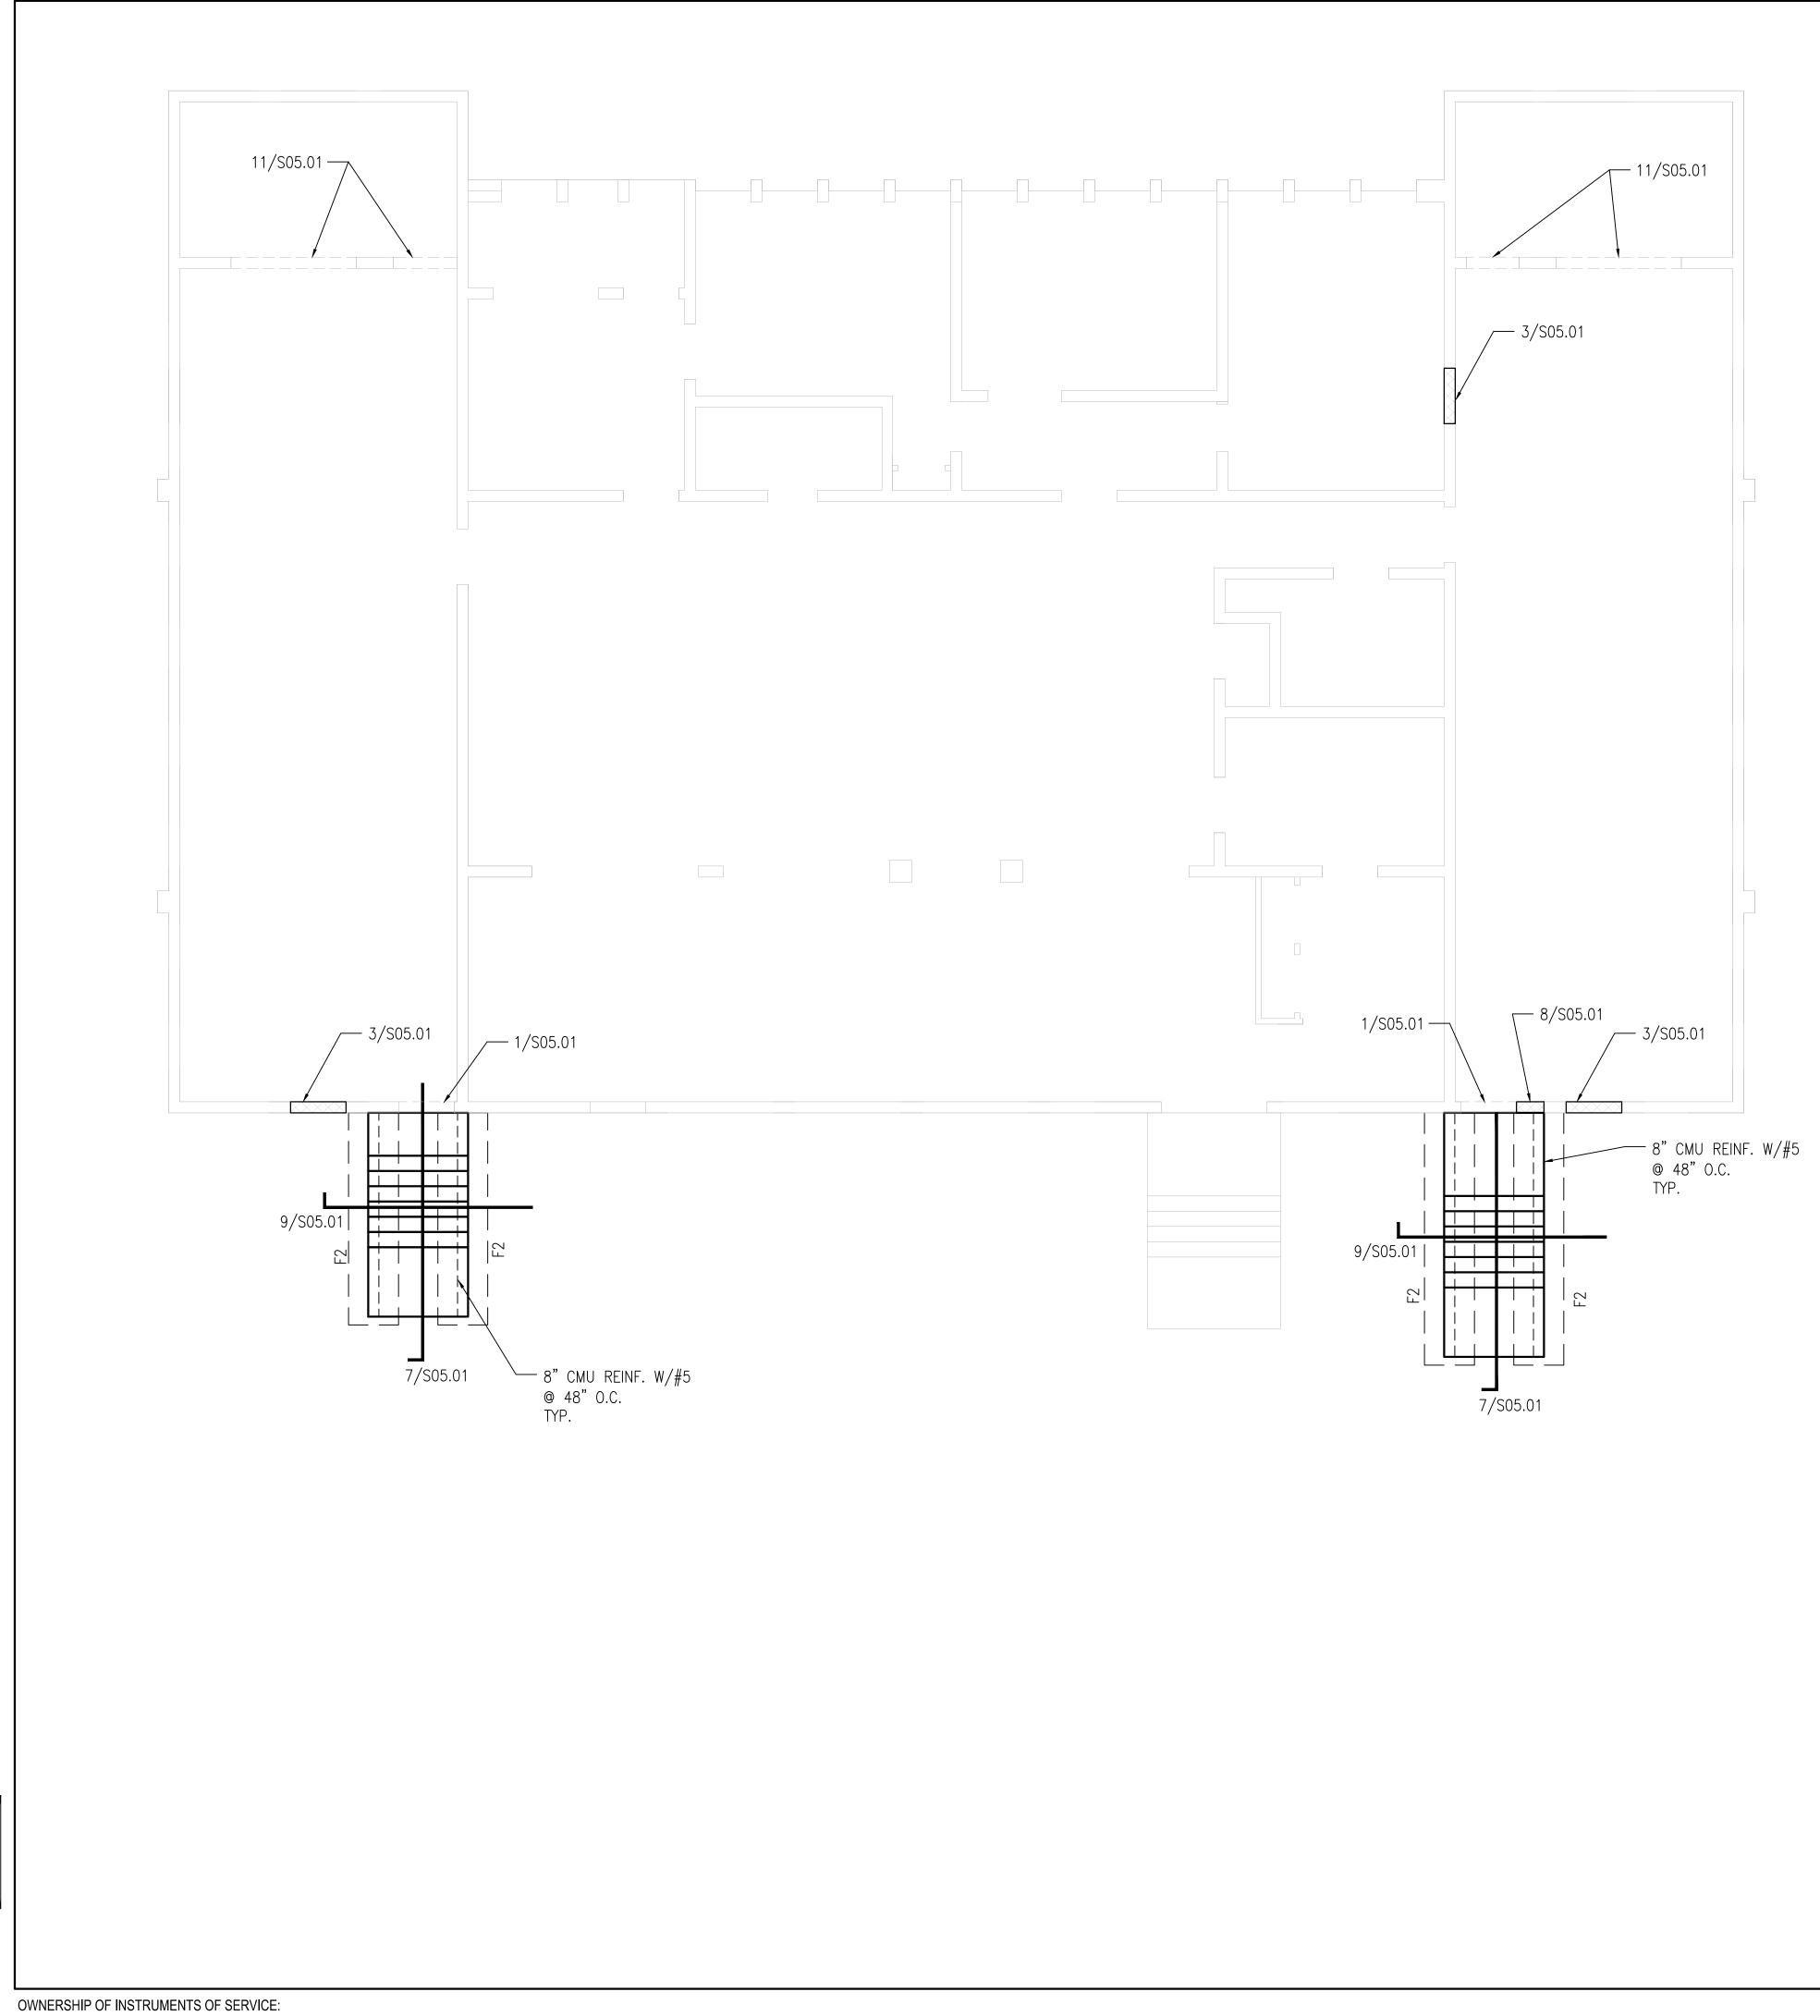

ALL REPORTS, PLANS, SPECIFICATIONS, FIELD DATA AND NOTES AND OTHER DOCUMENTS, INCLUDING ALL DOCUMENTS ON ELECTRONIC MEDIA, PREPARED BY THE DESIGN PROFESSIONAL AS INSTRUMENTS OF SERVICE SHALL REMAIN THE PROPERTY OF THE DESIGN PROFESSIONAL.

## SEE GENERAL NOTES AND TOP OF ALL FOOTINGS AT SLAB ON GRADE IS 5" THI 6x6-W2.9xW2.9. SEE GENE WATER/CEMENT RATIO. CONTRACTOR TO VERIFY AL DISCREPANCY TO THE ARC CONTRACTOR TO VERIFY AL PRIOR TO CONSTRUCTION. REFER TO MECHANICAL, EL PENETRATIONS AND UNDER ALL CONFLICTS THAT EXIST SEE SHEET S05.01 FOR FI 8. ALL FOOTINGS SHALL BE O U.N.O. PROVIDE (2)-#4 x 4'-0" CORNERS.

<u>FOUNDATION NOTES:</u>
 SEE GENERAL NOTES AND SPECIFICATIONS FOR ADDITIONAL INFORMATION.
 TOP OF ALL FOOTINGS AT ELEVATION -1'-4" U.N.O.
 SLAB ON GRADE IS 5" THICK NORMAL WEIGHT CONCRETE REINFORCED WITH WWR

6x6-W2.9xW2.9. SEE GENERAL NOTES FOR CONCRETE STRENGTH AND MAXIMUM WATER/CEMENT RATIO.

 CONTRACTOR TO VERIFY ALL DIMENSIONS AND EXISTING CONDITIONS AND REPORT ANY DISCREPANCY TO THE ARCHITECT AND ENGINEER.
 CONTRACTOR TO VERIFY ALL SLAB EDGE AND STAIR WITH ARCHITECTURAL DRAWINGS DRIOD TO CONSTRUCTION

6. REFER TO MECHANICAL, ELECTRICAL AND PLUMBING DRAWINGS FOR SLAB PENETRATIONS AND UNDERGROUND UTILITIES. INFORM THE ENGINEER OF RECORD OF ALL CONFLICTS THAT EXIST BETWEEN FOOTINGS AND UTILITIES.

SEE SHEET S05.01 FOR FOUNDATION AND SLAB ON GRADE TYPICAL DETAILS.
 ALL FOOTINGS SHALL BE CENTERED UNDER THE WALL OR COLUMN THEY SUPPORT,

9. PROVIDE  $(2) - \#4 \times 4' - 0''$  ADDITIONAL SLAB REINFORCEMENT AT ALL RE-ENTRANT CORNERS.

10. FOUNDATION LEGEND:

a. F2: 2'-3" WIDE X 1'-2" DEEP CONT. REINF. W/(3)-#5 CONT. & #5 @ 12" O.C. BOTTOM.

ARCHITECTURAL DESIGN COLLABORATIVE 945 N. PENNSYLVANIA AVENUE WINTER PARK, FLORIDA 32789 OFFICE: (407) 629-1188 FAX: (407) 388-1220 WWW. ADCINTERNATIONAL.NET STATE OF FLORIDA AA-C001315 MARIA FERREIRA AR-95752 Architect 

Seal/Signature Project Documents for: FLORIDA Project: GREAT OAKS VILLAGE WITTENSTEIN COTTAGE ADA UPGRADES AND RENOVATIONS 1784 E. MICHIGAN STREET ORLANDO, FL 32806 Issue Date & Issue Description Drawn By Checked By 07.27.16 60% CD SET MR LBB 09.15.16 90% CD SET MR LBB 12.02.16 PERMIT/BID SET MR LBB Client Information A CRANGE COUNTY CAPITAL PROJECTS DIVISION 400 E SOUTH STREET 5th FLOOR ORLANDO, FL 32801 Project Number Issue Date 15253 Drawn By 12/02/2016 Project Status MR PERMIT / BID CD SET Checked By Scale 3/16"= 1'-0" LBB File Name Consultant • Seal/Signature STATE OF LAURA ISABEL BARBERO BUFFA FLORIDA PE 74027 Sheet Title: FOUNDATION AND WALL PLAN


**S02.03** 



CERTIFICATE OF AUTHORIZATION No. 27343 LAURA BARBERO-BUFFA, P.E. No. 74027

> 1214 EAST CONCORD STREET ORLANDO, FLORIDA 32803 P: 407.377.7227



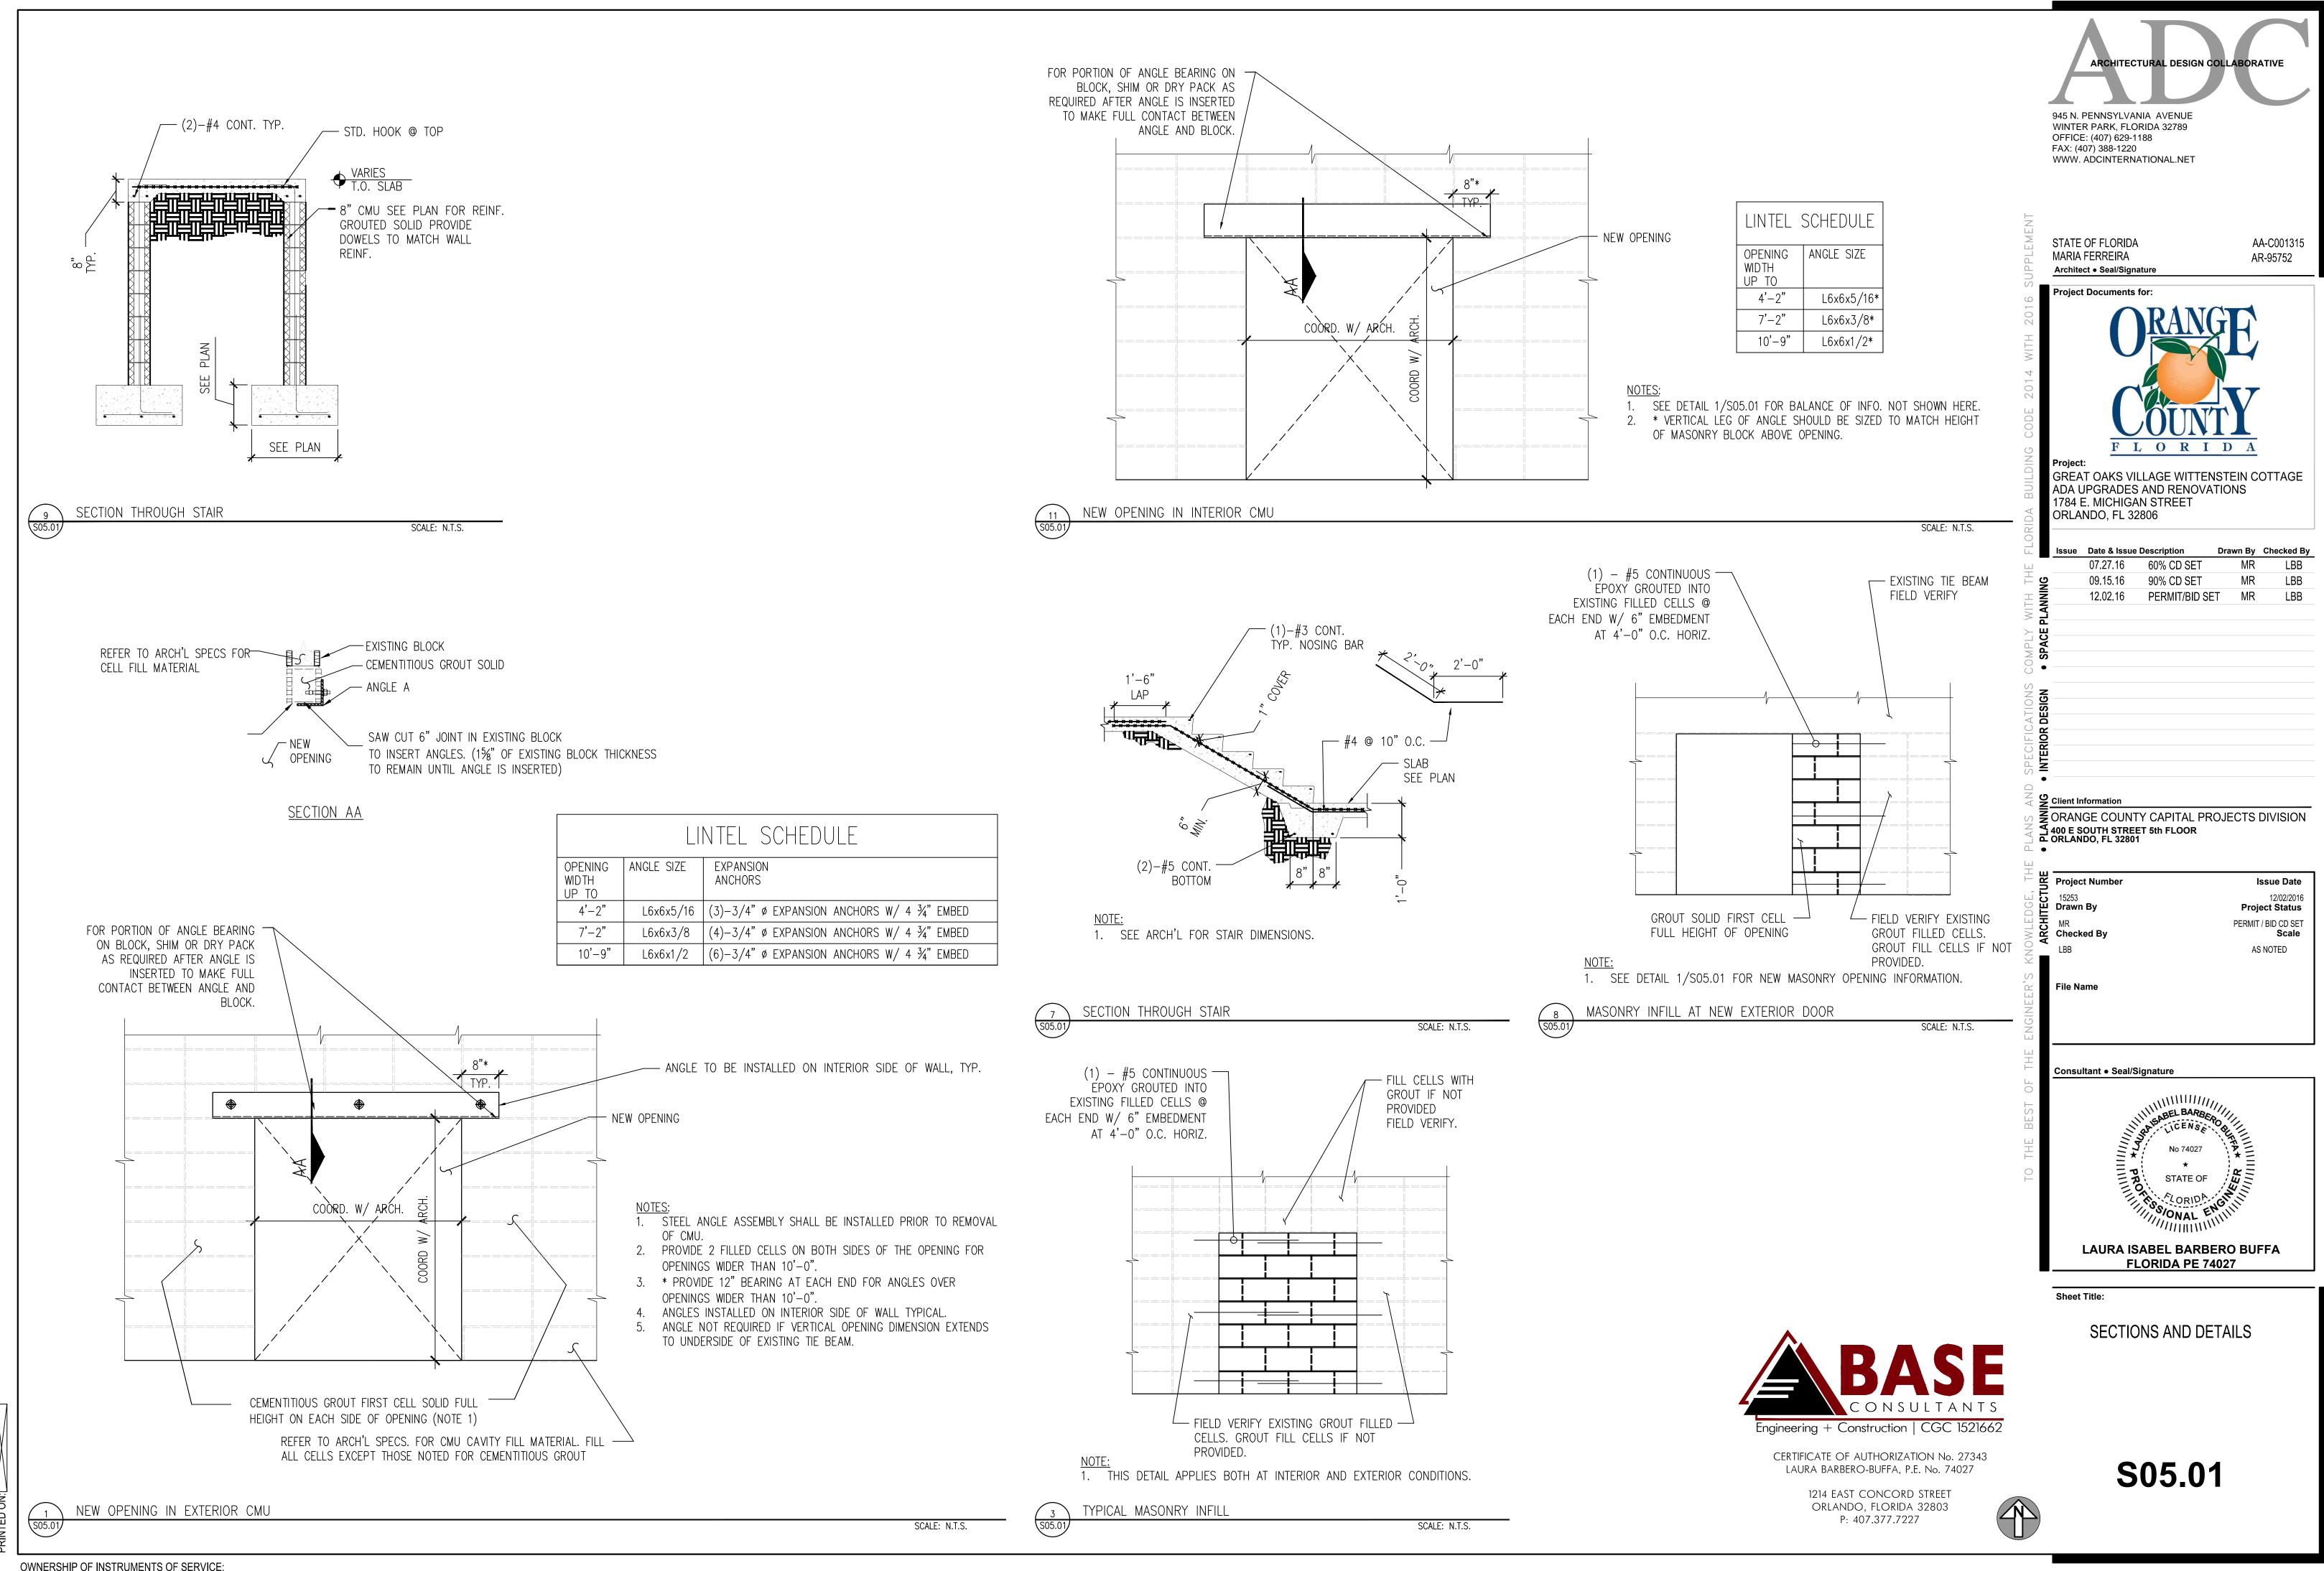

OWNERSHIP OF INSTRUMENTS OF SERVICE:

ANSI( HORS								
3/4"	Ø	EXPANSION	ANCHORS	W/	4	³ ⁄4"	EMBED	
3/4"	Ø	EXPANSION	ANCHORS	W/	4	³ ⁄4"	EMBED	
3/4"	Ø	EXPANSION	ANCHORS	W/	4	3⁄4"	EMBED	

ALL REPORTS, PLANS, SPECIFICATIONS, FIELD DATA AND NOTES AND OTHER DOCUMENTS, INCLUDING ALL DOCUMENTS ON ELECTRONIC MEDIA, PREPARED BY THE DESIGN PROFESSIONAL AS INSTRUMENTS OF SERVICE SHALL REMAIN THE PROPERTY OF THE DESIGN PROFESSIONAL