ORANGE COUNTY CONVENTION CENTER

ORANGE COUNTY MAYOR

TERESA JACOBS



DISTRICT 1 COMMISSIONER

S. SCOTT BOYD

DISTRICT 2 COMMISSIONER

FRED BRUMMER



DISTRICT 3 COMMISSIONER

PETE CLARKE

DISTRICT 4 COMMISSIONER

JENNIFER THOMPSON


DISTRICT 5 COMMISSIONER

TED EDWARDS

DISTRICT 6 COMMISSIONER

TIFFANY MOORE RUSSELL


OCCC WEST BUILDING TUNNEL DOMESTIC WATER AND COMPRESSED AIR PIPING REPLACEMENT

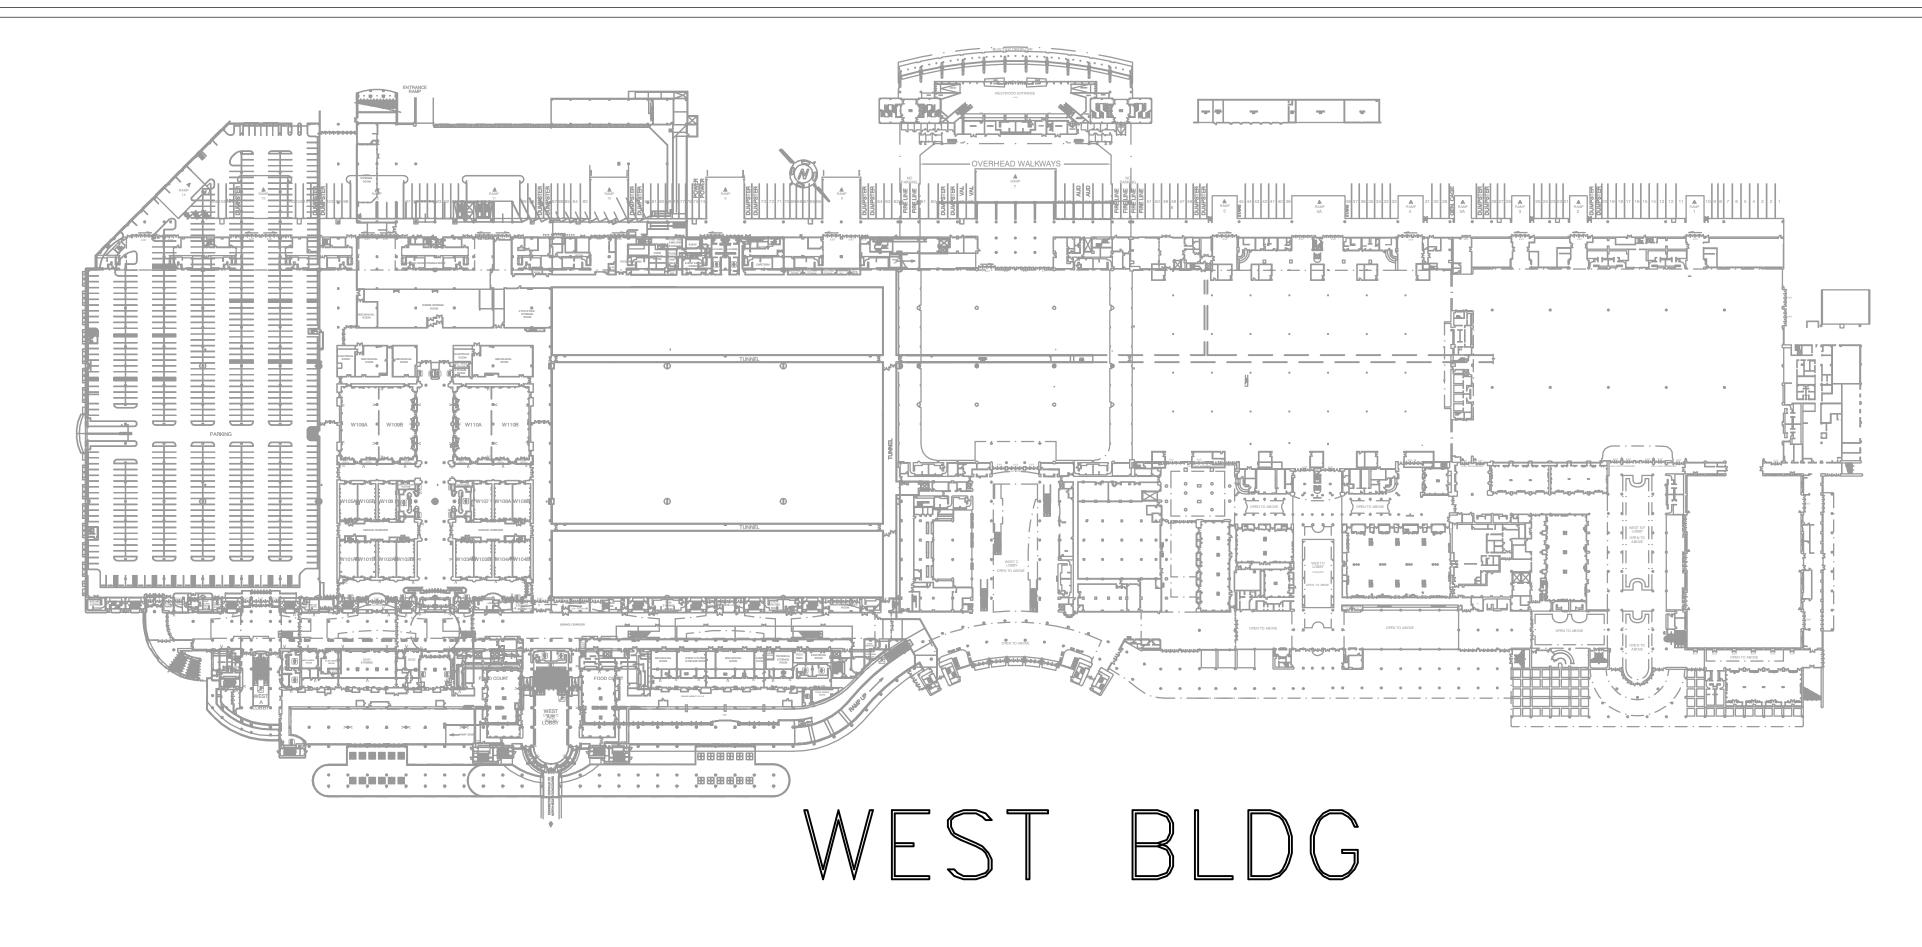






100% Bid Documents
APRIL 23, 2014

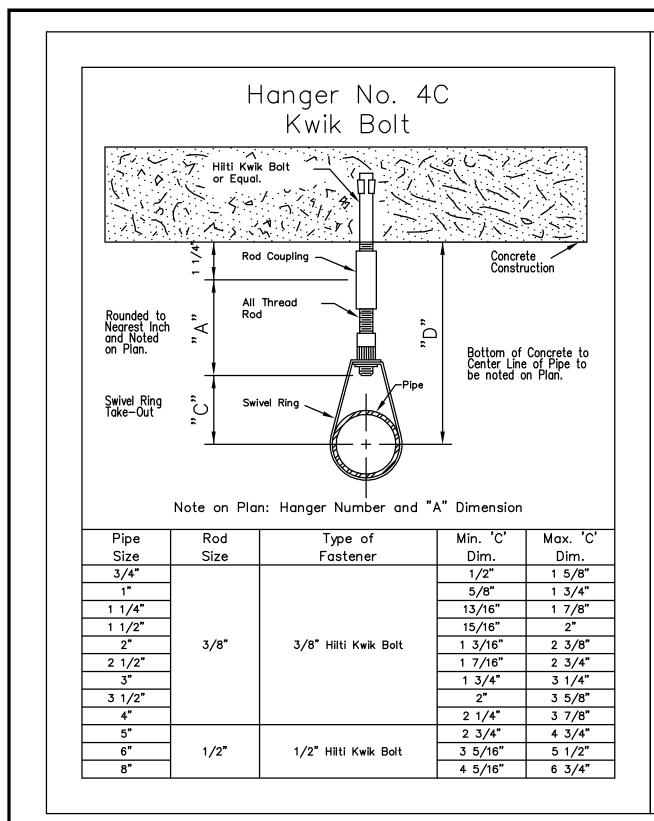

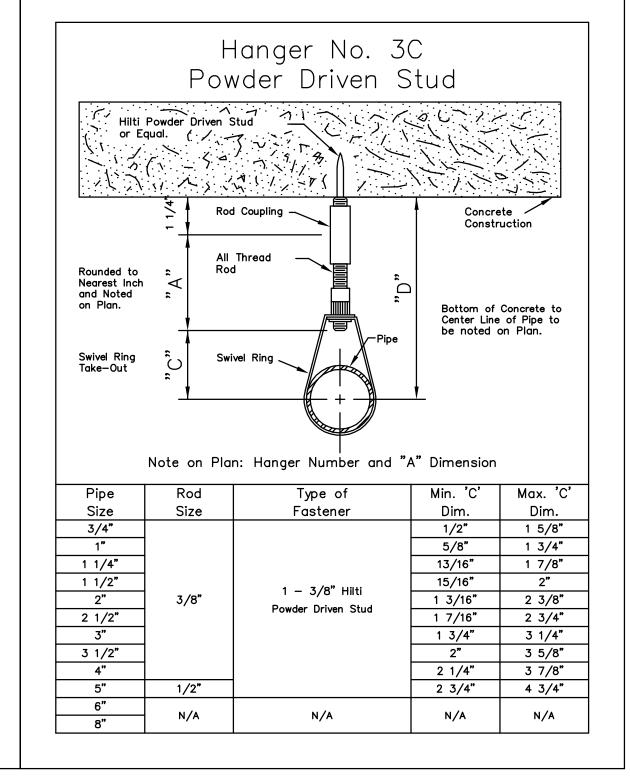

1 HANGER DETAIL NOT TO SCALE

		COMPI	RESSED	ESSED AIR EQUIPMENT SCHEDULE			
TAG #	LOCATED ON DRAWING #	M.F.G.	MODEL NO.	SYSTEM CAPACITY	DISCHARGE TANK	REMARKS	
PCD-1	P1.1.19 P1.1.20 P1.1.25	INGERSOLL RAND	PNLD II 28	100 TO 30,000 CFM	28 OZ.	PROVIDE SUPPORT BRACKETS AND SHELF FOR INSTALLATION OF PNEUMATIC DRAIN ABOVE DRAIN TRENCH/DRAIN SUMP. SECURE PNEUMATIC DRAIN TO SHELF. PIPING SHALL BE ROUTED LOW FOR DISCHARGE.	

GENERAL NOTES - PLUMBING

- 1. PLUMBING CONTRACTOR SHALL BE RESPONSIBLE FOR PROVIDING ALL NECESSARY FITTINGS AS REQUIRED BY ALL APPLICABLE CODES AND GOVERNING AUTHORITIES.
- 2. PLUMBING CONTRACTOR SHALL VERIFY AND CORRECT AS REQUIRED TO MEET ALL CODES AND REGULATIONS ANY POSSIBLE DISCREPANCIES BETWEEN TYPE AND SIZE OF CONNECTION SPECIFIED IN PLUMBING FIXTURE SCHEDULE AND FIXTURES ACTUALLY INSTALLED ON THE SITE.
- 3. PLUMBING CONTRACTOR SHALL COORDINATE ALL WORK WITH EXISTING CONDITIONS.
- 4. PLUMBING CONTRACTOR SHALL FIELD VERIFY ALL GIVEN MEASUREMENTS PRIOR TO LAYING AND CONNECTING PIPING.
- 5. PLUMBING CONTRACTOR SHALL BE RESPONSIBLE FOR PROVIDING ALL NECESSARY SUPPORTING DEVICES FOR ALL FIXTURES INCLUDED IN CONTRACT OR HEREIN SPECIFIED OR OTHERWISE.
- 6. ALL PIPE AND FITTINGS SHALL BE DOMESTICALLY MANUFACTURED IF POSSIBLE (MADE IN USA) AND SHALL BE MARKED WITH THE SEAL OF APPROVAL OF THE NATIONAL SANITATION FOUNDATION.
- 7. PLUMBING SYSTEM WAS DESIGNED USING THE 2010 FBC.
- 8. PLUMBING THE CONTRACTOR IS EXPECTED TO ORDER ALL MATERIALS IN SUFFICIENT TIME TO AVOID DELAYING THE COMPLETION OF THE PROJECT. DELAY IN DELIVERIES WILL NOT BE CONSIDERED A JUSTIFIABLE REASON FOR SUBMISSION OF SUBSTITUTE MATERIALS.
- 9. PLUMBING CONTRACTOR SHALL VISIT AND CAREFULLY EXAMINE THOSE PORTIONS OF THE BUILDING AFFECTED BY THIS WORK BEFORE SUBMITTING PROPOSALS SO AS TO BECOME FAMILIAR WITH EXISTING CONDITIONS AND DIFFICULTIES THAT WILL AFFECT EXECUTION OF THE WORK. SUBMISSION OF A PROPOSAL WILL INDICATE THAT SUCH EXAMINATION BY THE CONTRACTOR HAS BEEN MADE. LATER CLAIMS FOR LABOR, EQUIPMENT OR MATERIALS REQUIRED BECAUSE OF DIFFICULTIES ENCOUNTERED WILL NOT BE RECOGNIZED.
- 10. UNFORESEEN CONDITIONS MAY EXIST. COOPERATION WITH OTHER TRADES IN ROUTING AND/OR BURIAL DEPTHS AS DETERMINED DURING CONSTRUCTION AND AS DIRECTED BY THE ARCHITECT MAY BE NECESSARY. IT IS INTENDED THAT SUCH DEVIATIONS SHALL BE CONSIDERED AS PART OF THIS CONTRACT. THE PLANS ARE NOT COMPLETELY TO SCALE. PLUMBING CONTRACTOR IS TO FIELD VERIFY DIMENSIONS OF ALL SITE UTILITIES, ETC., PRIOR TO BID AND INCLUDE ANY DEVIATIONS IN THE CONTRACT.
- 11. PROJECT WILL NOT CONSIDERED COMPLETE UNTIL CONTRACTOR PROVIDES DETAILED AS—BUILTS AS PROJECT WAS INSTALLED.

PLUMBING DESIGN CRITERIA

PLUMBING GENERAL PROVISIONS

- 1. PROVIDE ALL LABOR, MATERIALS AND EQUIPMENT FOR A COMPLETE AND PROPERLY OPERATING PLUMBING SYSTEM.
- 2. CODES AND STANDARDS: ALL PLUMBING WORK SHALL BE IN STRICT COMPLIANCE WITH ALL GOVERNING CODES.

PLUMBING PIPING SYSTEMS:


- 1. CPVC PIPING:
 - a. SCHEDULE 80 CPVC LISTED AS CORZAN.
 - b. 2010 FLORIDA BUILDING CODE PLUMBING, TABLE 605.3/4/5 CPVC PIPING AND FITTINGS THAT COMPLY WITH ASTM D2846, ASTM F347, ASTM F438, ASTM F439, ASTM F441, ASTM F442, ASSE 1061, AND CSA B137.6.
 - c. CPVC JOINT SOLVENT (2-PART) AND THE REQUIREMENTS OF COMPLIANCE WITH ASTM D2846 AND ASTM F493. FOR SCHEDULE 80 CPVC PIPING, THREADED JOINTS COMPLYING WITH ASME B1.20.1 ARE ALLOWED AS AN ALTERNATIVE JOINTING METHOD CHARLOTTE SEAL GASKETS, ASTM C-564, CISPI-HSN.
 - d. PLUMBING CODE 2010, CHAPTER 3, TABLE 308.5 HANGER SPACING OR MANUFACTURER'S RECOMMENDATIONS. MORE STRINGENT SHALL APPLY.
- 2. COMPRESSED AIR PIPING:
 - a. ALUMINUM COMPRESSED AIR PIPING.b. 2010 FLORIDA PLUMBING CODE.
 - c. ASME B31.1 and B31.3 .
 - d. MAXIMUM WORKING PRESSURE 188 PSI FROM -4°F TO +140°F AND 232 PSI FROM -4°F TO +115°.
 - e. FITTINGS SHALL BE FROM PIPE MANUFACTURER'S COMPRESSED AIR SYSTEM

SHEET NO.	PLUMBING SHEET INDEX FOR OCCC WEST TUNNEL	SCALE
P0.0.1	GENERAL NOTES AND LEGEND - PLUMBING	NONE
P1.0.0	OVERALL PLAN WEST BUILDING HALL C AND HALL D TUNNEL - PLUMBING	1"=80'-0"
P1.1.19	PARTIAL PLUMBING PLAN - AREA C19	1/8=1'-0"
P1.1.20	PARTIAL PLUMBING PLAN - AREA C20	1/8=1'-0"
P1.1.25	PARTIAL PLUMBING PLAN - AREA D25	1/8=1'-0"
P1.1.26	PARTIAL PLUMBING PLAN - AREA D26	1/8=1'-0"





OCCC WEST BUILDING TUNNEL DOMESTIC WATER AND COMPRESSED AIR PIPING REPLACEMENT

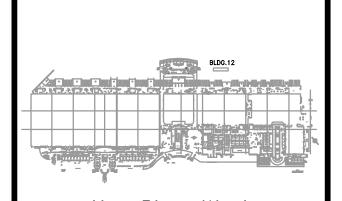

Revisions

No.	Date	Description

MPE PROJ#: 2012—188F

Designed By: RD

Drawn By: AG/RD

Checked By: BWP

Issue Date: APRIL 23, 2014


Drawing Scale: NONE

GENERAL NOTES & LEGENDS PLUMBING

100% BID DOCUMENTS

Drawing No

P0.0.1

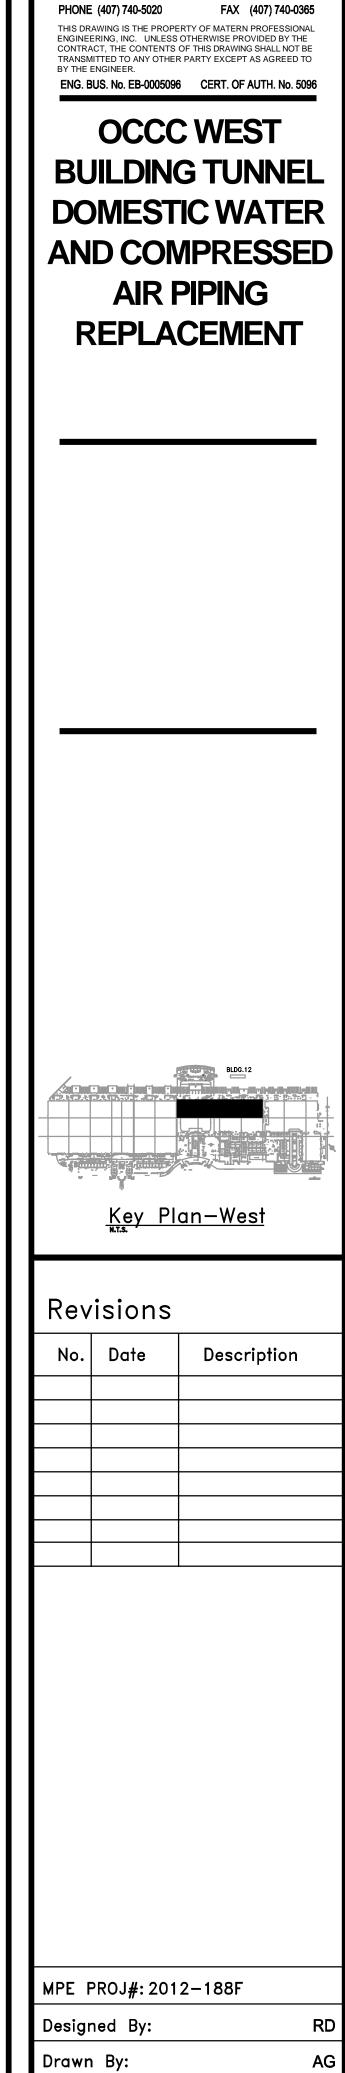

ENGINEERING

ORLANDO I Fort Myers I Jacksonville I Tampa

Matern Professional Engineering, Inc

130 Candace Drive Maitland, FI 32751-3331

TUNNEL-PLUMBING

100% BID DOCUMENTS

Drawing No.

Issue Date: APRIL 23, 2014

OVERALL PLAN

WEST BUILDING

HALL C & HALL D

Checked By:

Drawing Scale:

P1.0.0

