

ORANGE COUNTY CONVENTION CENTER

ORANGE COUNTY MAYOR
TERESA JACOBS



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DISTRICT 4 COMMISSIONER
JENNIFER THOMPSON

DISTRICT 1 COMMISSIONER
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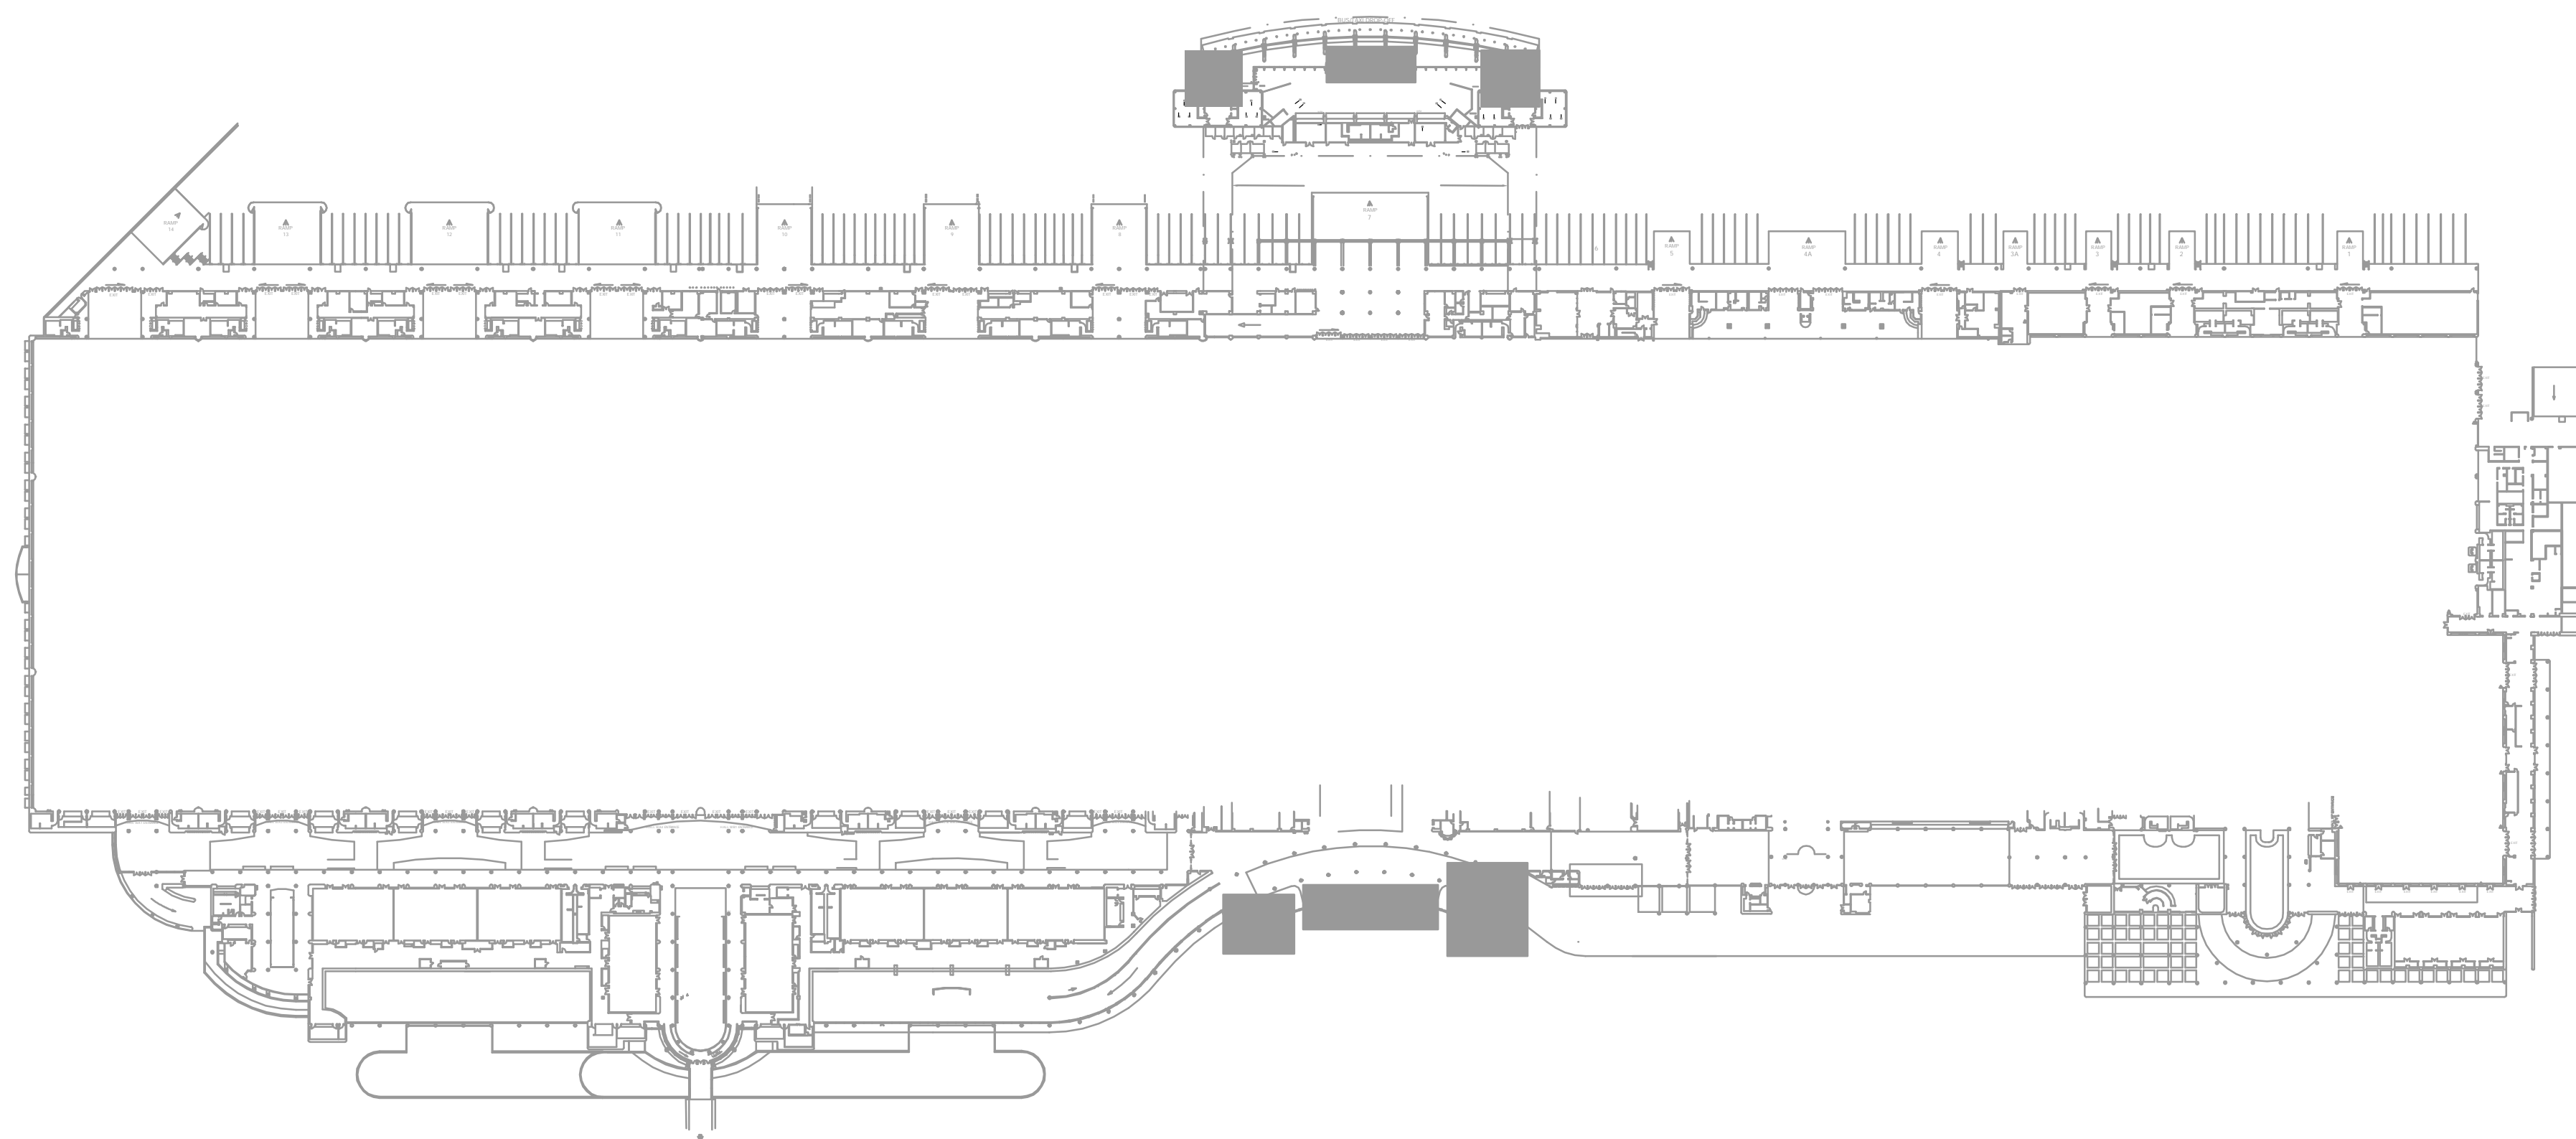
DISTRICT 5 COMMISSIONER
TED EDWARDS

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Orange
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Convention
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DISTRICT 6 COMMISSIONER
TIFFANY MOORE RUSSELL

WEST BUILDING PHASE I - ELECTRICAL POWER UPGRADES



WEST BLDG

SHEET NO.	ARCHITECTURAL SHEET INDEX FOR	SCALE
A-100	SYMBOLS, NOTES, SPECIFICATION, & CODE INFORMATION	NONE
A-101	ENLARGED FENCING FLOOR PLAN AND DETAILS	VARIES

SHEET NO.	ELECTRICAL SHEET INDEX FOR	SCALE
E.0.01	GENERAL NOTES, FIXTURE SCHEDULE, & SHEET INDEX	NONE
E-1.1.1	OVERALL PLAN - ELECTRICAL	VARIES
E-1.1.12	POWER PLAN - BUILDING 12	1/8" = 1'-0"
E-2.4.01	ENLARGED ROOM PLAN & EQUIPMENT ELEVATIONS	VARIES
E-2.4.02	ENLARGED ROOM PLAN & EQUIPMENT ELEVATIONS	VARIES
E-2.4.03	ENLARGED ROOM PLAN & EQUIPMENT ELEVATIONS	VARIES
E-2.5.01	ELECTRICAL SCHEDULES	NTS
ES.2.01	POWER RISER DIAGRAMS	NTS
ES.2.02	POWER RISER DIAGRAMS	NTS
ES.2.03	POWER RISER DIAGRAMS	NTS
E9.1.01	ELECTRICAL DETAILS	NTS

KEY PLAN
N.T.S.

mp
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MAY 7, 2013

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ABBREVIATIONS

<p>A/C AIR CONDITIONING ACT ACOUSTICAL CEILING TILE or ACOUSTICAL TREATMENT AD AREA DRAIN or AREA DEVELOPMENT AFF ABOVE FINISHED FLOOR ALUM ALUMINUM APPROX APPROXIMATELY ARF ACRYLIC RESIN FLOORING AHU AIR HANDLING UNIT BD BOARD BF BRICK FACE BLDG BUILDING BO BOTTOM BOH BACK OF HOUSE BOT BOTTOM CFOI CONTRACTOR FURNISHED OWNER INSTALLED CJ CONTROL JOINT CLG CEILING CLR CLEAR CMU CONCRETE MASONRY UNIT CO CLEAN OUT COL COLUMN CONC CONCRETE CONT CONTINUOUS CPT CARPET CT CERAMIC TILE</p> <p>D DEPTH DBL DOUBLE DET DETAIL DIA DIAMETER DIAG DIAGONAL DMP DISTRESSED METAL PROCESS DN DOWN DS DOWN SPOUT DWG DRAWING DWP DISTRESSED WOOD PROCESS DWR DRAWER DL DEAD LOAD (E) EXISTING EA EACH EDF ELECTRICAL DRINKING FOUNTAIN EER ELECTRONIC EQUIPMENT ROOM EH EYEHOOK EIFS EXTERIOR INSULATION & FINISH SYSTEM EJ EXPANSION JOINT EL ELEVATION ELEC ELECTRICAL EQ EQUAL EQUIP EQUIPMENT EXP EXPOSED EXT EXTERIOR</p> <p>FBR FABRIC FD FLOOR DRAIN FDN FOUNDATION FF FINISH FLOOR FFE FINISH FLOOR ELEVATION FHC FIRE HOSE CABINET FMG FACTORY MUTUAL GLOBAL FRT FIRE RETARDANT TREATED FIN FINISH FLR FLOOR FOC FACE OF CONCRETE FOF FACE OF FINISH FOM FACE OF MASONRY FOS FACE OF STUD FRP FIBERGLASS REINFORCED PLASTIC FS FLOOR SINK or FINISH SEALER FT FEET GA GAUGE GALV GALVANIZED GFRG GLASS FIBER REINFORCED CONCRETE GFRG GLASS FIBER REINFORCED GYPSUM GAL GALLON GL GLASS GYP BD GYPSUM BOARD H HIGH HB HOSE BIBB HM HOLLOW METAL HORIZ HORIZONTAL HP HIGH POINT HR HOUR HT HEIGHT HVAC HEATING VENTILATING & AIR CONDITIONING ID INSIDE DIAMETER INSUL INSULATION INT INTERIOR JT JOINT KEC KITCHEN EQUIPMENT CONTRACTOR KDN KILN DRIED KDAT KILN DRIED AFTER TREATMENT LAV LAVATORY LL LIVE LOAD LP LOW POINT MAINT MAINTENANCE MATL MATERIAL MAX MAXIMUM</p>	<p>MBSR MODIFIED BITUMINOUS SHEET ROOFING MCC MOTOR CONTROL CENTER MECH MECHANICAL MET METAL MEZZ MEZZANINE MFA METAL FACE MFR MANUFACTURER MIN MINIMUM MISC MISCELLANEOUS MO MASONRY OPENING MRT MOISTURE RESISTANT TREATMENT</p> <p>(N) NEW NIC NOT IN CONTRACT NR NOT RATED NTS NOT TO SCALE NRCNA NATIONAL ROOFING CONTRACTORS ASSOCIATION ON CENTER OCC OPERATOR CONTROL CONSOLE OCP OPERATOR CONTROL PANEL OD OUTSIDE DIAMETER or OVERFLOW DRAIN OFI OWNER FURNISHED ITEM OFOI OWNER FURNISHED OWNER INSTALLED OFCI OWNER FURNISHED CONTRACTOR INSTALLED OPP OPPOSITE P.S.I. POUNDS PER SQUARE INCH PF PLASTER FACE PL PLATE PLAM PLASTIC LAMINATE PLYWD PLYWOOD PNT PAINT POC POINT OF CONNECTION POS POINT OF SALE PR PAIR PREP PREPARATION PROJ PROJECTION PSF POUNDS PER SQUARE FPPT PT PRESSURE TREATED QT QUARRY TILE</p> <p>R RISER R or RAD RADIUS RBC RESILIENT BASE COVE RBS RESILIENT BASE STRAIGHT RC REINFORCED CONCRETE RD ROOF DRAIN RCP REFLECTED CEILING PLAN REF REFERENCE REQD REQUIRED RF RESILIENT FLOOR RM ROOM RO ROUGH OPENING RS ROUGH SAWN</p> <p>SC SOLID CORE SF SQUARE FEET or STONE FACE SHT SHEET SIM SIMILAR SPF SPECIAL FINISH SQ SQUARE SQ FT SQUARE FEET or SQAURE FOOT SS STAINLESS STEEL SSP SANITARY SHEET PLASTIC ST STONE STD STANDARD STL STEEL STRUCT STRUCTURAL SUSP SUSPENDED S4S SURFACED FOUR SIDES SYP SOUTHERN YELLOW PINE T TREAD T&G TONGUE AND GROOVE TEL TELEPHONE</p> <p>TOC TOP OF CONCRETE or CURB TOM TOP OF MASONRY TOP TOP OF PARAPET TOS TOP OF STEEL TOW TOP OF WALL TYP TYPICAL UL UNDERWRITERS LABORATORIES INC. UNLESS NOTED OTHERWISE UPH UPHOLSTERY VCT VINYL COMPOSITION TILE VERT VERTICAL VIF VERIFY IN FIELD</p> <p>W WIDE WITH WITH WC WALL COVERING OR WATER CLOSET W/O WITHOUT WF WOOD FACE WD WOOD WDB WOOD BASE WDF WOOD FLOOR WP WORK POINT WR WATER RESISTANT</p>
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SYMBOLS

○ FIXTURE—SURFACE CEILING MOUNTED
○-H FIXTURE—SURFACE WALL MOUNTED
○-C FIXTURE—PENDANT CEILING MOUNTED
○-R FIXTURE RECESS CEILING MOUNTED
○-W FIXTURE—RECESS WALL MOUNTED
○-H CHARACTER FIXTURE—SURFACE CEILING MOUNTED
○-H CHARACTER FIXTURE—SURFACE WALL MOUNTED
○-H CHARACTER FIXTURE—PENDANT CEILING MOUNTED
○-H ACCENT LIGHT FIXTURE—RECESS CEILING MOUNTED
○ BURIAL UPLIGHT—FLUSH GRADE MOUNTED
/ ANGLE
| CHANNEL
R PLATE
∅ CENTER LINE
∅ DIAMETER or ROUND
□ SQUARE
● WORK POINT or ELEV. BENCH MARK
⊙ LIGHTNING ROD ARRESTER
⊕ SPEAKER MOUNTING LOCATION (ELEVATION)
⊕ ELECTRICAL FIXTURE MOUNTING LOCATION (ELEVATION)

▭ WALL MOUNTED
⊗ CEILING MOUNTED
⊗ WALL MOUNTED
EXIT SIGNS
NUMBER FOR DETAILS
A-541 LETTER FOR ENLARGED PLANS
SHEET ON WHICH DETAIL OCCURS

DETAIL
NUMBER
2
A-611 SHEET ON WHICH ELEVATION OCCURS

ELEVATION
NUMBER
2
A-501 SHEET ON WHICH SECTION OCCURS
OVERALL BUILDING SECTION

WALL SECTION
NUMBER FOR DETAIL
LETTER FOR SECTION
A-201 A-542 SHEET NUMBER
A-304 SHEET(S) WHERE REFERENCED FROM

DETAIL/SECTION CROSS REFERENCE
3 NUMBER OF ELEVATION SET
1 ELEVATION NUMBER
4 A-611 1
4 A-611 2
2 SHEET ON WHICH ELEVATION IS SHOWN

INTERIOR ELEVATION
ROOM IN WHICH FIXTURE APPEARS
FIXTURE NUMBER
FX-101A-19
1/A-635 SHEET ON WHICH FIXTURE IS SHOWN
DETAIL REFERENCE

FIXTURE IDENTIFICATION
BASE MATERIAL
REFER TO A-410 SHEET
WD 110 MF-12 SPF 101
COLOR/FINISH TREATMENT
REFER TO A-410 SHEET
SEE SPEC. APPENDIX FOR THEMED FACADE TEXTURE DEFINITIONS.

INTERIOR AND EXTERIOR FINISH REFERENCES
SF-XXX SPECIAL FINISHES
ROOM 101 ROOM NUMBER
xx SPECIALTY ITEMS

▭ MOUNTED FLUORESCENT LIGHT FIXTURE
○ FLUORESCENT FIXTURE—RECESS CEILING MOUNTED
○ FLUORESCENT FIXTURE—SURFACE CEILING or WALL MOUNTED
○ FLUORESCENT FIXTURE—PENDANT or CHAIN CEILING MOUNTED
○ ACCENT LIGHT FIXTURE
○ OVERHEAD SPEAKER
○ PUBLIC ADDRESS SPEAKER
○ ANUNCIATOR
○ MANUAL PULL STATION
○ JUNCTION BOX—RECESSED CEILING MOUNTED
○ JUNCTION BOX—FLUSH IN FLOOR UNO
○ INTERCOM OUTLET—WALL MOUNTED
○ TELEPHONE OUTLET—WALL MOUNTED
○ SMOKE/HEAT DETECTOR—SURFACE CEILING MOUNTED
○ THERMOSTAT
○ PENDANT SPRINKLER HEAD
○ UPRIGHT SPRINKLER HEAD
○ SPRINKLER HEAD W/ 12"x12" HEAT BAFFLE
○ SPRINKLER HEAD — WALL MOUNTED
NUMBER or POUND
& AND
@ AT
△ DELTA
P PENNY
□ SQUARE FEET
XXXX DOOR NUMBER
DOOR
F-1 FENCE / GATE NUMBER
FENCE / GATE
XX LOUVER NUMBER
LOUVER
X WINDOW NUMBER
WINDOW

TICK INDICATES TOP SURFACE AS SHOWN IN WALL TYPE SCHEDULE
WALL TYPE NUMBER
WALL SCHEDULE
H1 = FLOOR TO UNDER SIDE OF ROOF OR PLATFORM
H2 = 6" ABOVE CEILING.
FIRE RESISTANCE DESIGNATION
1 = ONE HOUR
2 = TWO HOUR
3 = THREE HOUR
INSULATION DESIGNATION
T = THERMAL INSULATION
S = SOUND INSULATION
SCHEDULED PARTITION

WALL TYPE
17 FIXTURE NUMBER

TOILET ACCESSORIES
REVISION
2

COLUMN LINES
SUFFIX: A5 = 5lb ABC EXTINGUISHER
A10 = 10lb ABC EXTINGUISHER
B = 5.5lb 40BC EXTINGUISHER
C5 = 5lb CO2 EXTINGUISHER
C10 = 10lb CO2 EXTINGUISHER
W = 2 1/2 GALLON WATER EXTINGUISHER
SUFFIX: S = SURFACE MOUNTED CABINET
SH = SURFACE MOUNTED HOOK WITH BACKBOARD
SR = SEMI-RECESSED CABINET
R = RECESSED CABINET
FIRE EXTINGUISHER CABINET
SEE DRAWING A-201 MATCHLINE
MATCH LINE

CODE INFORMATION

APPLICABLE CODES		
Building :	FLORIDA BUILDING CODE	Edition : 2010
Mechanical :	FLORIDA MECHANICAL CODE	Edition : 2010
Plumbing :	FLORIDA PLUMBING CODE	Edition : 2010
Gas :	FLORIDA GAS CODE	Edition : 2010
Electrical :	FLORIDA ELECTRICAL CODE	Edition : 2010
Fire :	FLORIDA FIRE PREVENTION CODE	Edition : 2010
ACCESSIBILITY:	FLORIDA ACCESSIBILITY CODE	Edition : 2009 w/2012 AMENDMENT
Energy:	EPCOT ENERGY EFFICIENCY CODE	Edition : 2010
FIRE/LIFE SAFETY:	FLORIDA FIRE PREVENTION CODE	Edition : 2010

CONSTRUCTION

Type of Construction : TYPE II-A (CHAPTER 6)
Sprinklered or Non-sprinklered : SPRINKLERED
Total Floor Area of Chain Link Electrical Area : 132 S.F.

OCCUPANCY


GROUP F-3 (Low Occupancy Equipment Rooms)
Occupancy(s) / Group Classification : 2 persons

MATERIALS LEGEND


<p> ACOUSTICAL INSULATION ACOUSTICAL TILE BATT INSULATION PORTLAND CEMENT PLASTER PORTLAND CEMENT PLASTER OVER METAL LATH COMPRESSIBLE FILLER CONCRETE CONCRETE MASONRY UNIT EARTH</p>	<p> GLASS GYPSUM BOARD RIGID INSULATION METAL PLYWOOD WOOD BLOCKING CONTINUOUS WOOD MEMBER FINISHED WOOD MEMBER EXTERIOR INSULATION & FINISH SYSTEM</p>
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MATERN PROFESSIONAL ENGINEERING
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OCCC WEST BUILDING PHASE I - ELECTRICAL POWER UPGRADES



KDJ ARCHITECTS, INC.
ARCHITECTS
510 North Julia Street
Jacksonville, Florida 32202

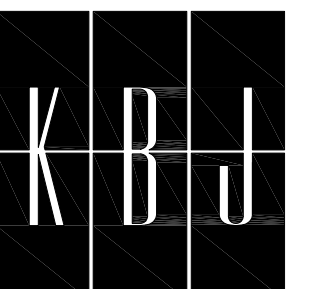

Revisions

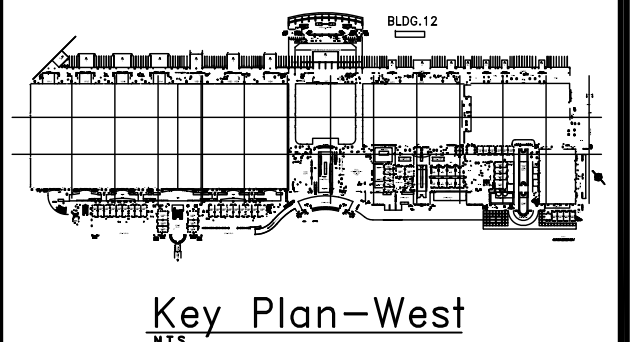No.	Date	Description

NOTES

- GENERAL CONTRACTOR TO VERIFY DATUM ELEVATION WITH OWNER PRIOR TO START OF ANY WORK.
- ANY DAMAGED FIREPROOFING MATERIAL DISCOVERED DURING PROJECT CONSTRUCTION TO BE RETURNED TO ORIGINAL INTEGRITY.
- DIMENSIONS SHOWN ON FLOOR PLANS ARE TO FACE OF FINISHED WALL, FACE OF MASONRY, FACE OF CONCRETE OR TO STRUCTURAL GRID LINES UNLESS OTHERWISE NOTED.

MPE PROJ#: 2012-188B
Designed By: R. BEYER
Drawn By: R. BEYER
Checked By: R. BEYER
Issue Date: MAY 7, 2013
Drawing Scale:
Drawing Title:

SYMBOLS, NOTES, ABBREVIATIONS, and CODE INFORMATION

BID DOCUMENTS

Drawing No.


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OCCC WEST BUILDING PHASE I - ELECTRICAL POWER UPGRADES



KBJ Architects, Inc.
 AAG20007
 213 North Julia Street
 Jacksonville, Florida 32202
 800 Dealey Avenue, Suite 301
 Orlando, Florida 32801



Key Plan - West

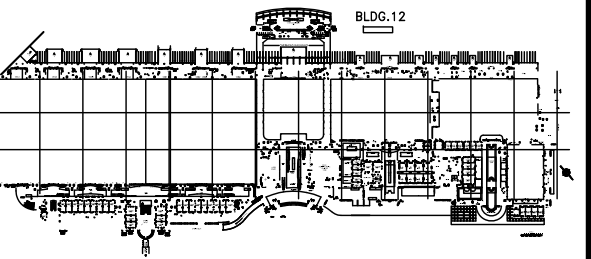Revisions

No.	Date	Description

MPE PROJ#: 2012-188B

Designed By: **R. BEYER**

Drawn By: **R. BEYER**

Checked By: **R. BEYER**

Issue Date: MAY 7, 2013

Drawing Scale:


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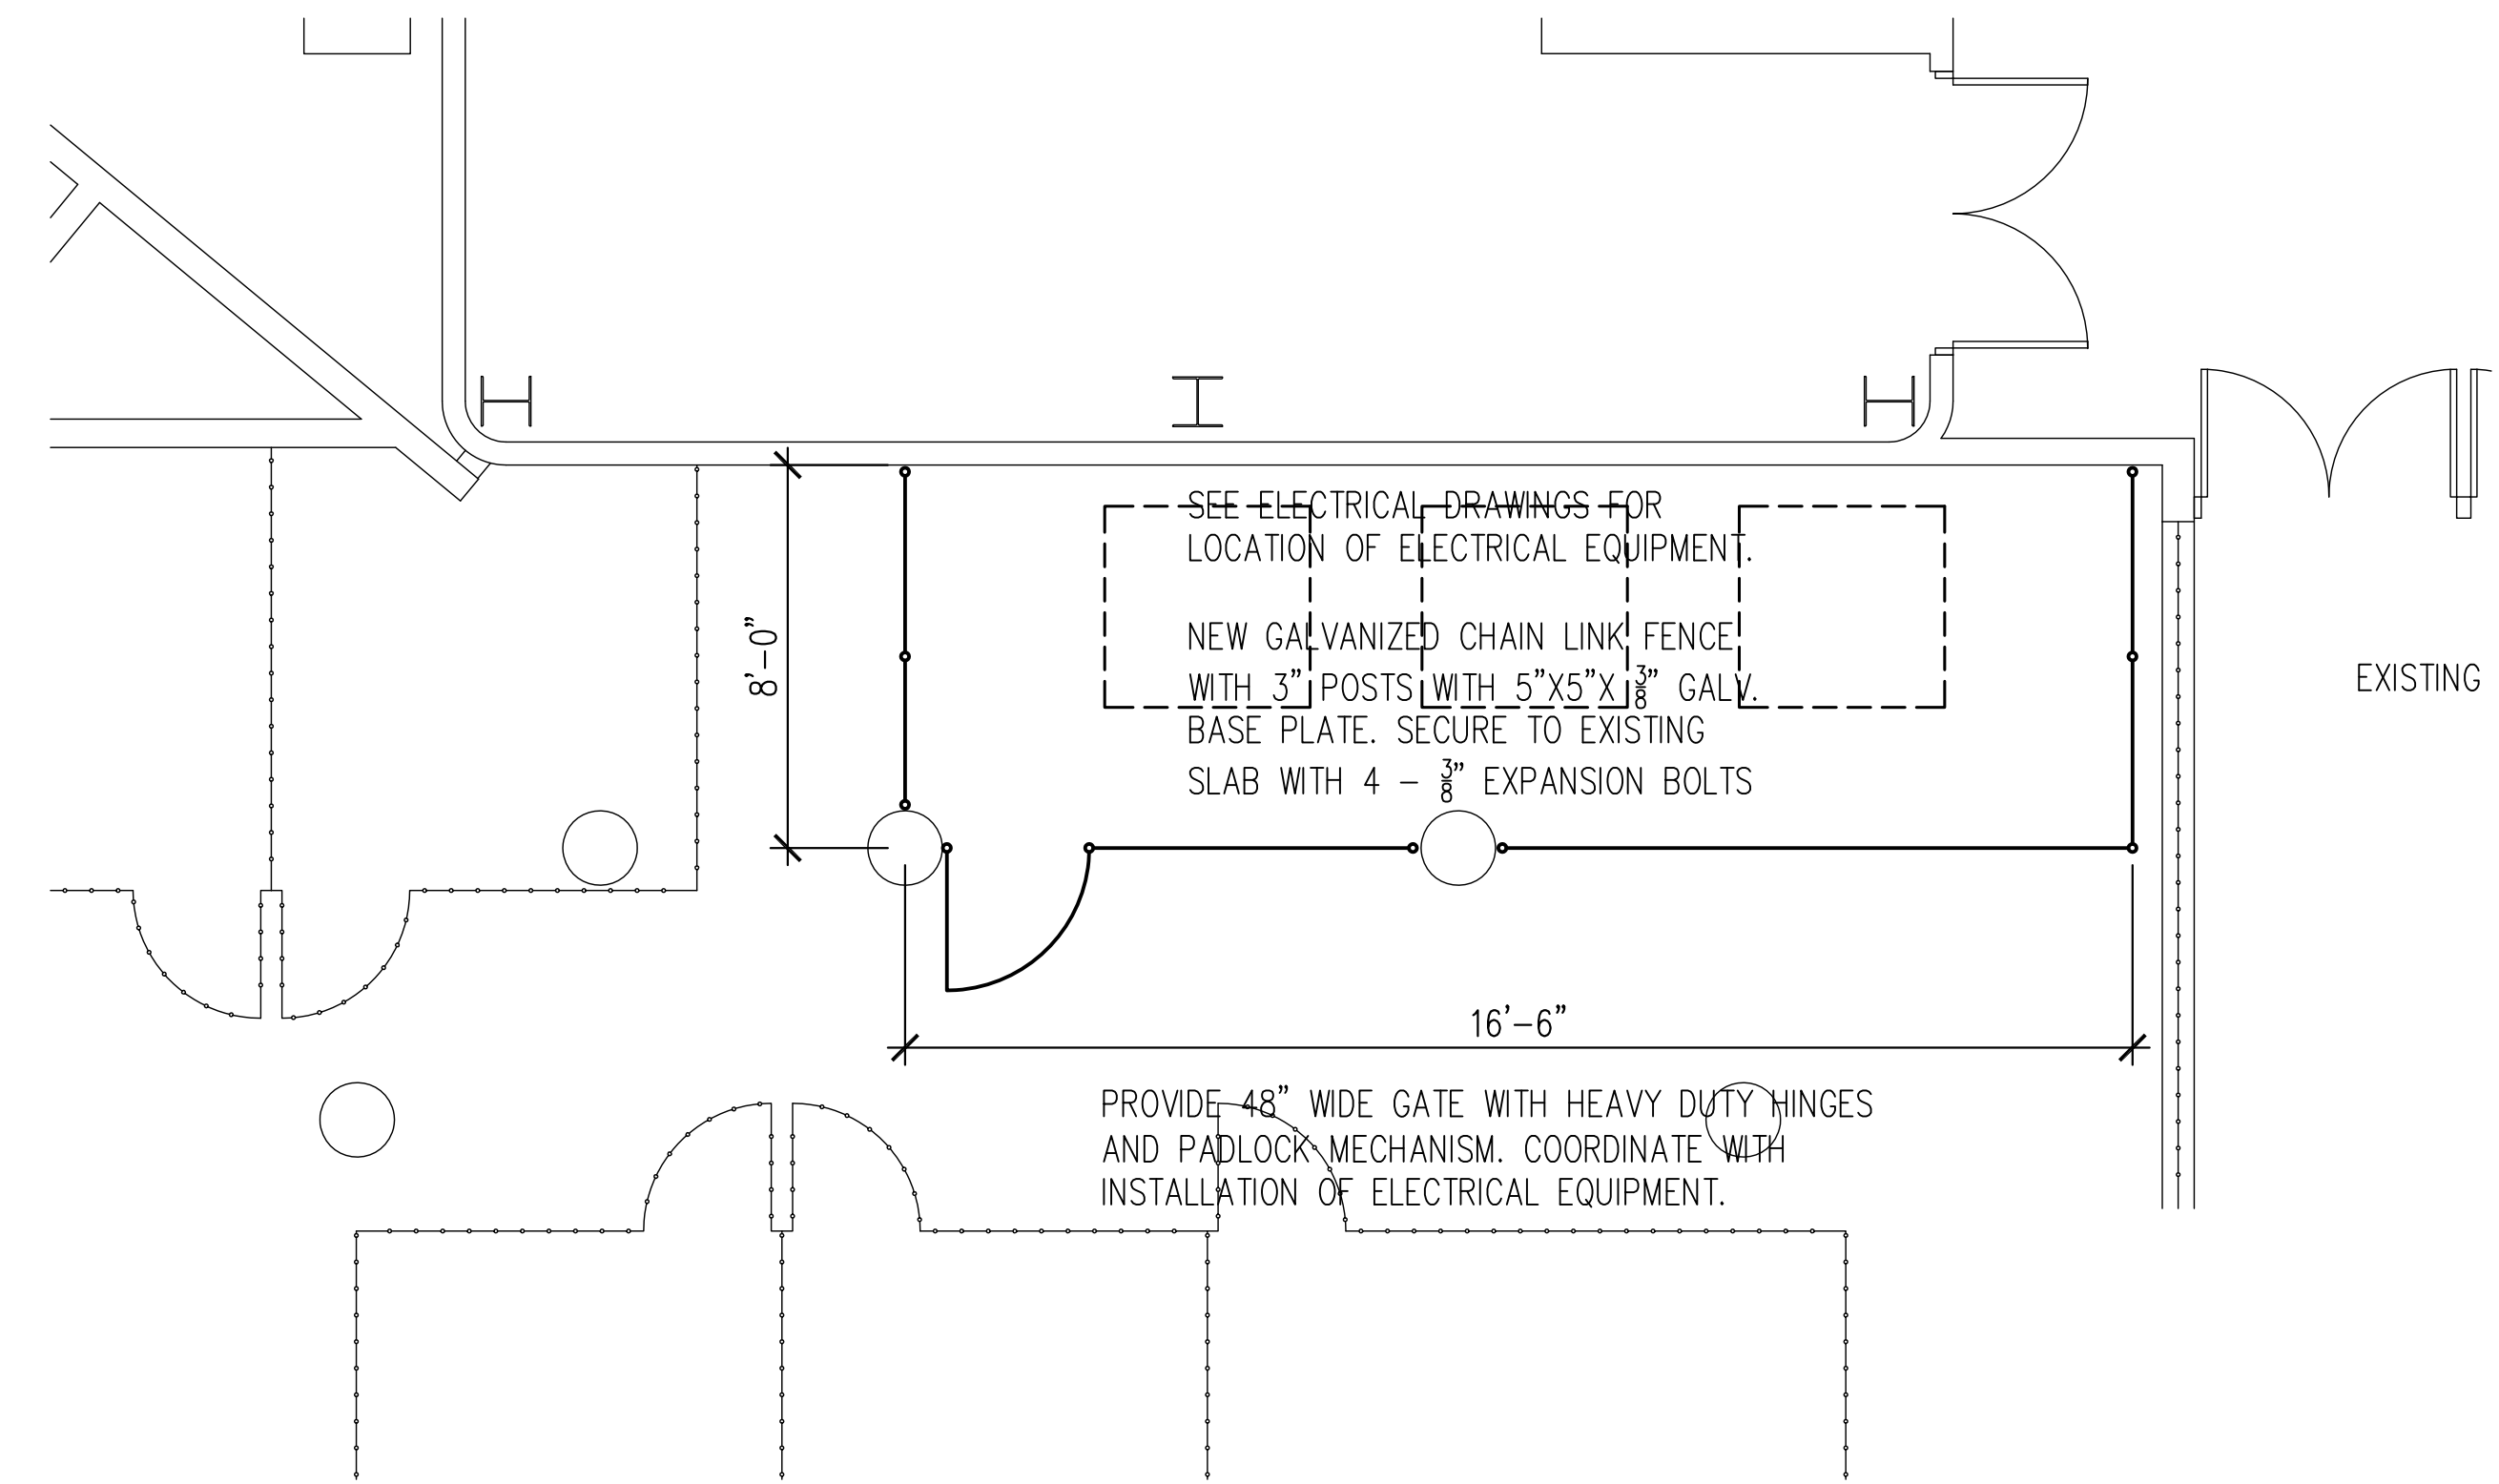
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Drawing No.

A-101




1 PARTIAL OCCC WEST BUILDING HALL D FLOOR PLAN
 A-101 SCALE: 1/16" = 1'-0"

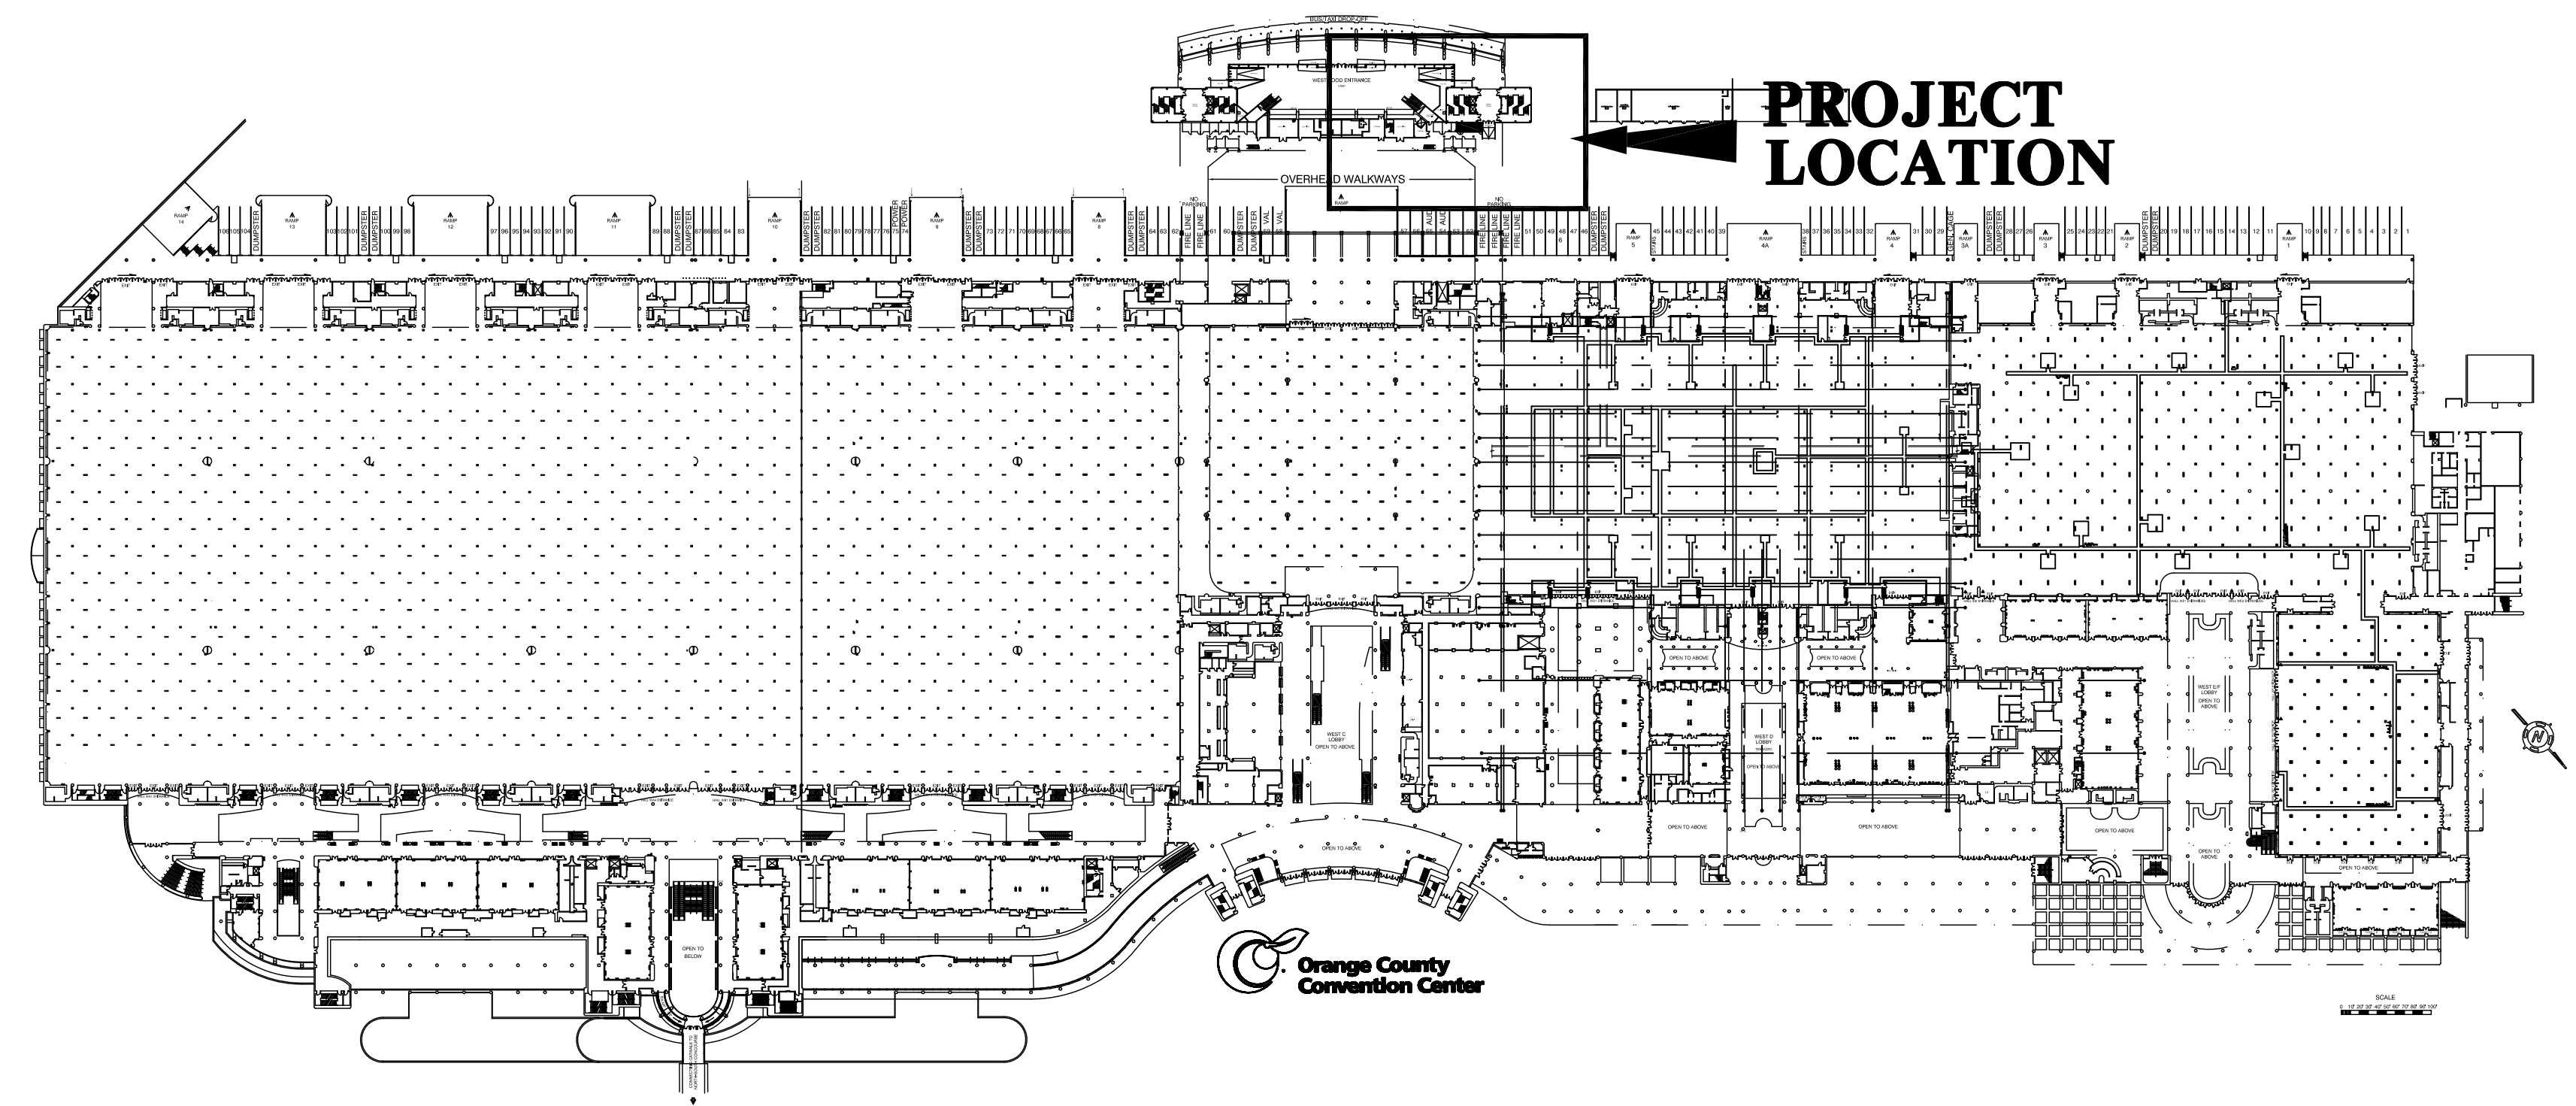


2 ELECTRICAL GENERATOR FENCE ENCLOSURE
 A-101 SCALE: 3/8" = 1'-0"



3 IMAGE OF FENCE POST SECURED TO CONCRETE
 A-101 SCALE: N.T.S.

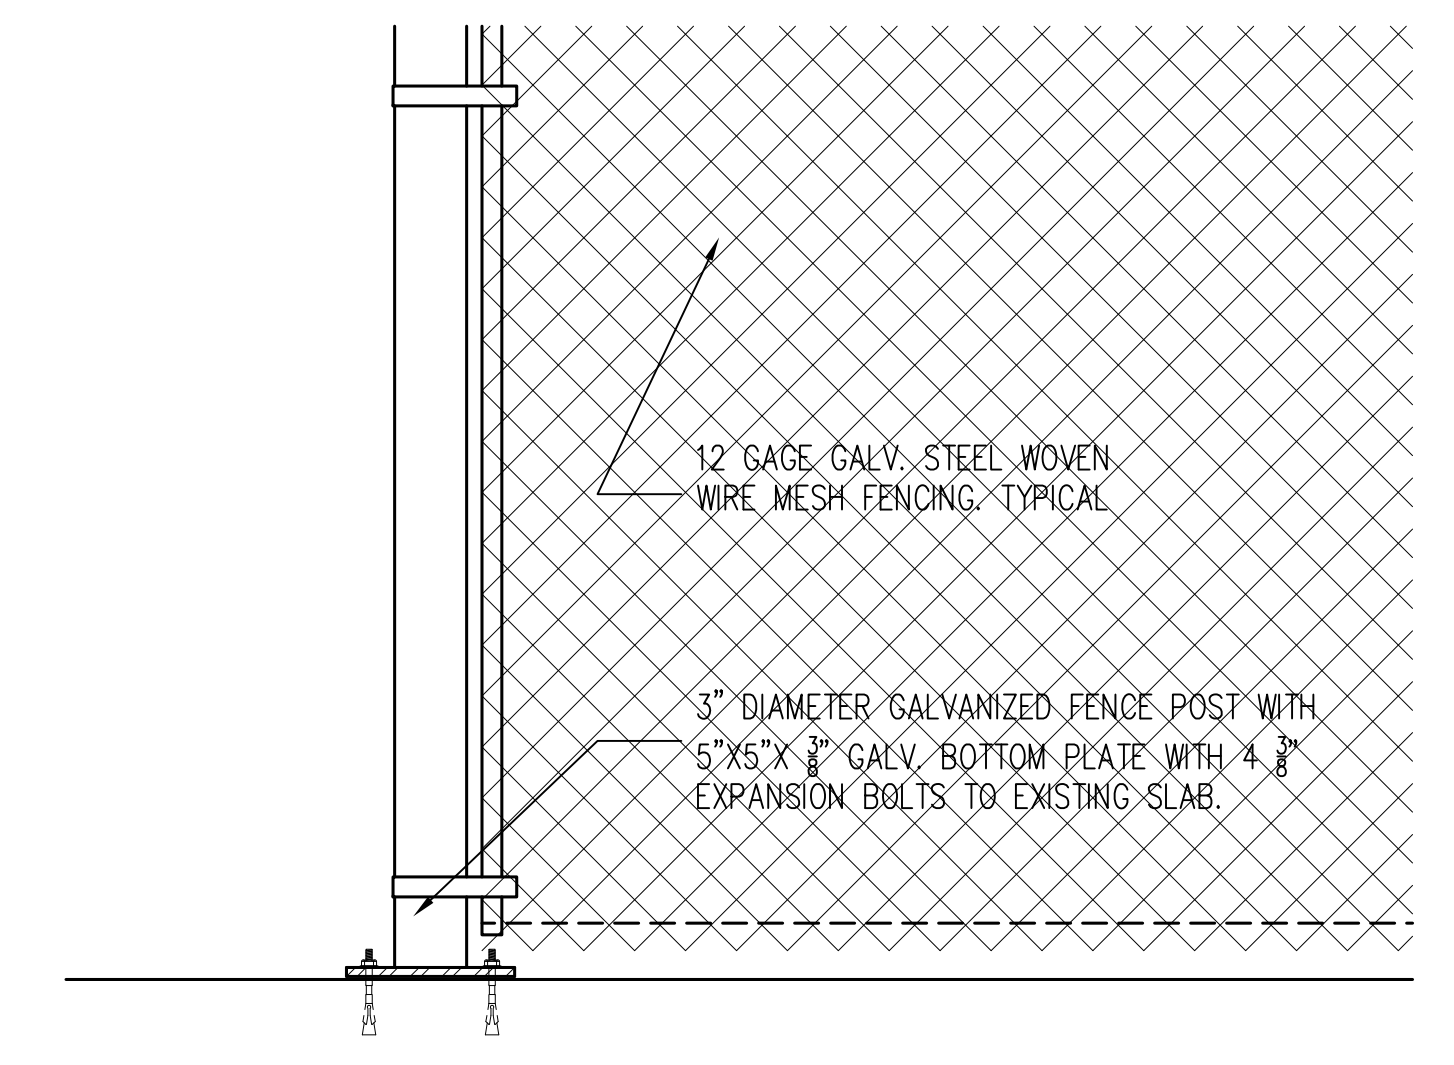

4 SECTION AT NEW GALV. FENCE POST
 A-101 SCALE: 1 1/2" = 1'-0"

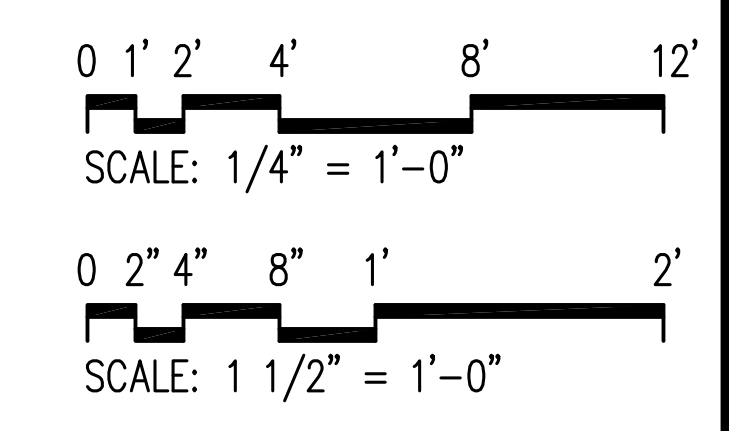

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GENERAL NOTES

- ALL 277V, 20A CIRCUIT HOMERUNS OVER 100 FT. SHALL BE #10 CU. MINIMUM, UNLESS OTHERWISE NOTED.
- ALL 277V, 20A CIRCUITS WITH HOMERUNS OVER 150 FT. SHALL BE #10 CU. THROUGHOUT ENTIRE CIRCUIT MINIMUM, UNLESS OTHERWISE NOTED.
- NO MULTI-WIRE BRANCH CIRCUITS ARE TO BE USED. EACH CIRCUIT IS TO HAVE SEPARATE INDIVIDUAL NEUTRAL.
- VERIFY EXACT LOCATION OF ALL MECH. EQUIP. INCLUDING WALL SWITCHES, TSTATS, ETC. WITH MECH. CONTRACTOR AND MECH. DRAWINGS.
- REFER TO MECHANICAL EQUIPMENT SCHEDULE, FOR RESPECTIVE CONDUIT/CONDUCTORS, DISCONNECTS, MISC. EQUIPMENT REQUIRED FOR ALL MECHANICAL AND PLUMBING EQUIPMENT. REFER TO PANEL SCHEDULES FOR CIRCUITS NUMBERS OF CIRCUITS FOR MECHANICAL AND PLUMBING EQUIPMENT.
- VISIT AND CAREFULLY EXAMINE THOSE PORTIONS OF THE BUILDING AND SITE AFFECTED BY THIS WORK BEFORE SUBMITTING PROPOSALS, SO AS TO BECOME FAMILIAR WITH EXISTING CONDITIONS AND DIFFICULTIES THAT WILL AFFECT EXECUTION OF THE WORK. SUBMISSION OF A PROPOSAL WILL BE CONSTRUED AS EVIDENCE THAT SUCH EXAMINATION HAS BEEN MADE AND LATER CLAIMS FOR LABOR, EQUIPMENT OR MATERIALS REQUIRED BECAUSE OF DIFFICULTIES ENCOUNTERED WILL NOT BE RECOGNIZED.
- READ SPECIFICATIONS.
- SEE RISER DIAGRAMS AND BUILDING PLANS.
- ALL EMPTY CONDUITS ARE TO HAVE PULL-STRINGS PROVIDED IN THEM.
- SPLICES IN POWER AND LIGHTING OUTLET BOXES SHALL BE KEPT TO A MINIMUM, PULL CONDUCTORS THROUGH TO DEVICES, EQUIPMENT CABINETS/PANELBOARDS. SPLICING IN WIREWAYS IS NOT PERMITTED UNLESS SPECIAL WRITTEN PERMISSION IS GRANTED BY A/E.
- CONTRACTOR SHALL INCLUDE IN HIS BID THE TRANSPORT AND DISPOSAL OR RECYCLING OF ALL WASTE MATERIALS GENERATED BY THIS PROJECT IN ACCORDANCE WITH ALL RULES, REGULATIONS AND GUIDELINES APPLICABLE. CONTRACTOR SHALL COMPLY FULLY WITH FLORIDA STATUTE 403.1186 REGARDING MERCURY CONTAINING DEVICES AND LAMPS. LAMPS, BALLASTS AND OTHER MATERIALS SHALL BE TRANSPORTED AND DISPOSED OF IN ACCORDANCE WITH ALL DEP AND EPA GUIDELINES APPLICABLE AT TIME OF DISPOSAL. CONTRACTOR SHALL PROVIDE OWNER WITH WRITTEN CERTIFICATION OF ACCEPTED DISPOSAL.
- MOUNT ALL DISCONNECT SWITCHES FOR MECHANICAL EQUIPMENT WITHIN 6 FT. OF EQUIPMENT CONNECTION POINT. VERIFY LOCATION OF POINT OF CONNECTION WITH EQUIPMENT INSTALLER PRIOR TO ELECTRICAL ROUGH-IN. (DRAWINGS ONLY SHOW DIAGRAMMATIC LOCATION OF CONNECTION).
- PROVIDE, INSTALL AND CONNECT ONE 30 AMP DUPLEX RECEPTACLE IN CAST WEATHERPROOF BOX WITH WEATHERPROOF COVER WITHIN 25 FEET OF ALL MECHANICAL EQUIPMENT INSTALLED ON ROOFS OR IN ATTICS. CONNECT RECEPTACLES TOGETHER (MAXIMUM OF SIX PER CIRCUIT) WITH #10 WIRE AND CONNECT TO CLOSEST 120 VOLT PANEL. CONNECT TO 20 AMP 1 POLE SPARE CIRCUIT BREAKER AND RELABEL BREAKER "ROOF RECEPT.".
- EXISTING CONDITIONS INDICATED ARE TAKEN FROM EXISTING CONSTRUCTION DOCUMENTS, VARIOUS SURVEYS, AND FIELD INVESTIGATIONS. IT IS TO BE UNDERSTOOD THAT UNFORESEEN CONDITIONS PROBABLY EXIST AND NEW WORK MAY NOT BE FIELD LOCATED EXACTLY AS SHOWN ON THE DRAWINGS. COOPERATION WITH OTHER TRADES IN ROUTING AND/OR BURIAL DEPTHS AS DETERMINED DURING CONSTRUCTION AND AS DIRECTED BY THE ENGINEER MAY BE NECESSARY AND IT IS INTENDED THAT SUCH DEVIATIONS SHALL BE CONSIDERED A PART OF THIS CONTRACT. IT IS ALSO UNDERSTOOD THAT THE PLANS ARE NOT COMPLETELY TO SCALE. THIS CONTRACTOR IS TO FIELD VERIFY DIMENSIONS OF ALL SITE UTILITIES, ETC., PRIOR TO BID AND INCLUDE ANY DEVIATIONS IN THE CONTRACT.
- REMOVE EXISTING POWER, LIGHTING, SYSTEMS, MATERIAL AND EQUIPMENT WHICH ARE MADE OBSOLETE OR WHICH INTERFERE WITH THE CONSTRUCTION OF THE PROJECT.
- REINSTALL ANY SUCH POWER, LIGHTING, SYSTEMS, MATERIALS AND EQUIPMENT WHICH ARE REQUIRED TO REMAIN ACTIVE FOR THE FACILITY TO BE FULLY FUNCTIONAL.
- ALL EXISTING ELECTRICAL IS NOT SHOWN. IT IS THE CONTRACTORS RESPONSIBILITY TO BECOME FAMILIAR WITH ALL EXISTING CONDITIONS PRIOR TO BID, AND INCLUDE IN HIS BID THE REMOVAL OF ALL ELECTRICAL EQUIPMENT, WIRE, CONDUIT, DEVICES, FIXTURES, ETC. THAT IS NOT BEING REUSED, BACK TO ITS SOURCE.
- ALL RECEPTACLES, DEVICES AND EQUIPMENT NOT SHOWN, AND IN AREAS OUTSIDE OF REMODELING SHALL REMAIN ACTIVE UNLESS OTHERWISE NOTED. FURNISH AND INSTALL ACCESSIBLE JUNCTION BOXES AND REWORK EXISTING CIRCUITS AS REQUIRED TO MAINTAIN CIRCUIT CONTINUITY TO RECEPTACLES, DEVICES AND EQUIPMENT REMAINING.
- ALL CONDUIT TO BE CONCEALED UNLESS IMPOSSIBLE DUE TO EXISTING CONDITIONS (I.E. EXPOSED CEILINGS, BUILDING EXTERIOR WALL RUNS, IMPOSSIBLE UNDERGROUND RUNS). CONCEAL ALL CONDUITS ABOVE CEILINGS OR IN WALL/COUNTERS.
- ALL NEW DEVICES TO BE FLUSH MOUNTED UNLESS SPECIFICALLY NOTED OTHERWISE.
- PROVIDE NEW TYPED PANEL DIRECTORIES FOR ALL EXISTING AND NEW PANELBOARDS FOR PANELBOARDS ASSOCIATED WITH CONTRACT WHETHER SHOWN ON PLANS OR NOT REGARDLESS IF SCHEDULES/CIRCUITRY HAS BEEN CHANGED.
- PROVIDE NEW PHENOLIC LABELS (PER SPEC'S) ON ALL (2) TWO POLE AND (3) THREE POLE CIRCUIT BREAKERS WITHIN ALL EXISTING AND NEW PANELBOARDS ASSOCIATED WITH CONTRACT WHETHER SHOWN ON PLANS OR NOT REGARDLESS IF SCHEDULES/CIRCUITRY HAS BEEN CHANGED.
- ALL EXISTING AND NEW CIRCUIT BREAKERS WITHIN EACH EXISTING PANELBOARD SHALL BE THE SAME MFG. TYPE, STYLE AND A.I.C. RATING OF EXISTING PANELBOARD REGARDLESS OF WHAT IS SHOWN ON PANEL SCHEDULE. FIELD VERIFY ALL EXISTING PANELBOARD(S) RELATED WITH CONTRACT AND REPLACE CIRCUIT BREAKERS AS NECESSARY TO COMPLY WITH THIS REQUIREMENT.
- ALL CONCRETE, WALL PATCHING, CEILING REPAIR, WALL FINISHES, AND OTHER GENERAL WORK REQUIRED FOR INSTALLING ELECTRICAL SYSTEMS SHALL BE REPAIRED TO "LIKE NEW/ORIGINAL CONDITION." (COORDINATE WITH GENERAL CONTRACTOR PRIOR TO BID.)
- ALL OPENINGS IN FIRE RATED WALLS AND FLOORS, ETC. MADE BY RENOVATION SHALL BE SEALED AND FIREPROOFED. PROVIDE AND INSTALL FIRESTOPPING ON ALL NEW OR EXISTING CONDUIT AND/OR CABLE THAT PENETRATES ANY FIRE RATED NEW OR EXISTING WALL IN ALL AREAS AFFECTED BY THIS PROJECT. VERIFY LOCATION OF FIRE RATED WALLS WITH ARCHITECTURAL PLANS PRIOR TO BID. FIRESTOPPING SYSTEM SHALL BE AS REQUIRED BY UL FOR RATING OF WALLS AND CONDUIT/CABLE PENETRATION.
- DASHED ITEMS INDICATE EXISTING TO REMAIN.
- "R" ADJACENT TO DEVICE INDICATES EXISTING TO BE REMOVED COMPLETE.
- ALL ITEMS REMOVED AND NOT RE-USED SHALL BE IMMEDIATELY TURNED OVER TO OWNER AS THEY ARE MADE AVAILABLE BY RENOVATION. REMOVE ITEMS FROM JOB SITE AND DELIVER TO OWNERS STORAGE LOCATION(S) AS DIRECTED BY PROJECT MANAGER. DISCARD COMPLETE ITEMS WHICH OWNER ELECTS TO REFUSE.
- CONTRACTOR MAY REUSE EXISTING CONDUIT (MIN. OF 10' LENGTHS) AND ASSOCIATED FITTINGS, PULL BOXES, ETC., WHICH ARE IN "LIKE NEW CONDITION" AND WHICH MEET THE INTENT OF THE SPECIFICATIONS FOR NEW PRODUCTS. WHERE EXISTING RACEWAYS ARE REUSED, THE CONTRACTOR SHALL REMOVE EXISTING WIRING, PULL IN NEW WIRING, AND CONNECT TO NEW DEVICES AS SHOWN ON THE DRAWINGS AND CALLED FOR IN THE SPECIFICATIONS. REUSE OF EXISTING DEVICES AND WIRING SHALL NOT BE ALLOWED UNLESS SPECIFICALLY NOTED OTHERWISE. ALL EXISTING CONDUITS THAT ARE REUSED SHALL BE PERMANENTLY IDENTIFIED IN ACCORDANCE WITH THE SPECIFICATIONS.
- THIS PROJECT SHALL BE COMPLIANCE WITH THE 2010 FLORIDA BUILDING CODE AND 2008 NEC.

SYMBOL LEGEND					
SYMBOL	DESCRIPTION	DESIGN SELECTION	APPROVED SUBSTITUTION	APPROVED SUBSTITUTION	REMARKS
+	OUTLET BOX AND FLUORESCENT FIXTURE IN COVE OR MILLWORK. COORDINATE WITH ARCHITECTURAL PLANS	SEE FIXTURE SCHEDULE			d
○	CEILING OUTLET BOX AND FLUORESCENT FIXTURE	SEE FIXTURE SCHEDULE			d
○	CEILING OUTLET BOX AND HID, FLUORESCENT OR INCANDESCENT FIXTURE	SEE FIXTURE SCHEDULE			d
○	WALL OUTLET BOX AND HID, FLUORESCENT OR INCANDESCENT FIXTURE	SEE FIXTURE SCHEDULE			d
○	CEILING OUTLET BOX AND LIGHT FIXTURE ON EMERGENCY SYSTEM BRANCH CIRCUIT	SEE FIXTURE SCHEDULE			d
○	WALL OUTLET BOX AND HID, FLUORESCENT OR INCANDESCENT FIXTURE ON EMERGENCY SYSTEM BRANCH CIRCUIT	SEE FIXTURE SCHEDULE			d
□	120/208V BRANCH CIRCUIT PANELBOARD SURFACE MOUNTED	SQUARE "D"	G.E.	SIEMENS	i
□	277/480V BRANCH CIRCUIT PANELBOARD SURFACE MOUNTED	SQUARE "D"	G.E.	SIEMENS	i
□	LIGHTING CONTROL OR DIMMER PANEL - SURFACE MOUNTED				
□	TRANSFORMER	SQUARE "D"	G.E.	SIEMENS	i
□	RELAY, AS NOTED				
□	CONTROL AND/OR POWER CONNECTION ON EQUIPMENT				i
□	DISCONNECT SWITCH, SIZE AS NOTED	SQUARE "D"	G.E.	SIEMENS	g, i
⌈	BRANCH CIRCUIT CONDUIT CONCEALED ABOVE CEILING OR IN WALL. SLASH MARKS INDICATE NUMBER OF CONDUCTORS (GROUND WIRE NOT SHOWN). TWO CONDUCTORS PLUS GROUND REQUIRED (UNLESS OTHERWISE NOTED OR MARKED).				
⌈	120V BRANCH CIRCUIT CONDUIT CONCEALED ABOVE CEILING OR IN WALL.				
⌈	HOME RUN WIRING. ONE CIRCUIT PER ARROW HEAD				

NOTES:

- ALL DEVICES TO BE GREY WITH SMOOTH METAL #302 S.S. PLATES UNLESS OTHERWISE NOTED.
- DASHED ITEM DENOTES "EXISTING".
- "R" BY DEVICE DENOTES EXISTING TO BE REMOVED COMPLETELY.
- "H" BY DEVICE DENOTES DEVICE TO BE MOUNTED HORIZONTALLY.
- MOUNT SWITCHES AT 48" AFF TO TOP.
- SEE SPECIFICATIONS FOR ADDITIONAL REQUIREMENTS.
- ALL ITEMS NOTED ON THE LEGENDS DO NOT NECESSARILY APPEAR ON PLANS.

REMARKS:

- SUPPORT OUTLET BOX FROM STRUCTURE WITH (1) 3/8" ALL THREADS MINIMUM. BOXES LARGER THAN 25 SQUARE INCHES SHALL BE SUPPORTED WITH (2) 3/8" ALL THREADS MINIMUM.
- JUNCTION/OUTLET BOX SHALL BE SIZED AS REQUIRED FOR CONDUCTOR/DEVICE FILL PER N.E.C.
- PROVIDE KINDORF MFG. RACK FOR FREE STANDING APPLICATIONS. KINDORF SHALL BE PVC COATED FOR EXTERIOR APPLICATIONS. ALL CUT ENDS ARE TO BE SEALED.
- WHEN SURFACE JUNCTION BOX SYMBOL IS COMBINED WITH DEVICE SYMBOL, PROVIDE APPROPRIATE SURFACE PLATE FOR OUTLET APPLICATION.
- MAINTAIN WORKING CLEARANCES IN STRICT ACCORDANCE WITH N.E.C. COORDINATE EXACT LOCATION OF EQUIPMENT WITH ALL DISCIPLINES (I.E. STRUCTURAL, HVAC, PLUMBING, FIRE PROTECTION, KITCHEN, MILLWORK, ETC.) PRIOR TO ROUGH-IN TO MAINTAIN CLEARANCES.


FIRE ALARM SYSTEM SYMBOL LEGEND			
SYMBOL	DESCRIPTION	MOUNTING HEIGHT	MOUNTING
Ⓜ	AHJ/EXHAUST FAN SHUT-DOWN RELAY, ADDRESSABLE	WITHIN THREE FEET (3') OF STARTER	SURFACE

DEMOLITION LEGEND

- REMOVE ALL ELECTRICAL ASSOCIATED WITH THIS ITEM, COMPLETE BACK TO ITS SOURCE. SOURCE IS CONSIDERED TO BE FIRST UPSTREAM DEVICE OR CIRCUIT BREAKER THAT FEEDS THIS AFFECTED CIRCUIT. SEE GENERAL NOTES AND SPECIFICATIONS FOR ADDITIONAL REQUIREMENTS.
- REMOVE ALL ELECTRICAL IN AREA OF REMODEL/RENOVATION COMPLETE BACK TO ITS SOURCE. SOURCE IS CONSIDERED TO BE FIRST UPSTREAM DEVICE OR CIRCUIT BREAKER OUTSIDE OF AREA OF REMODEL THAT FEEDS CIRCUITS/DEVICES WITHIN AREA OF REMODEL/RENOVATION. SEE GENERAL NOTES AND SPECIFICATIONS FOR ADDITIONAL REQUIREMENTS.

- EXISTING WALLS TO BE REMOVED COMPLETE.
- EXISTING WALLS TO REMAIN.

OCCC WEST BUILDING PHASE I - ELECTRICAL POWER UPGRADES

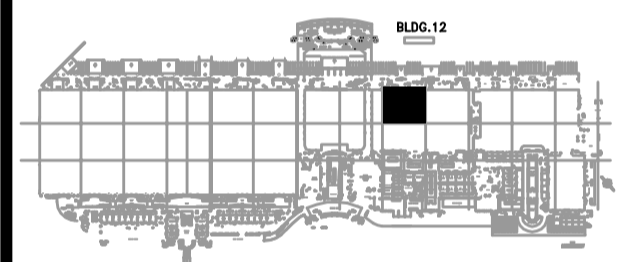

Key Plan - West

Revisions

No.	Date	Description

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Designed By: RB
Drawn By: AG/RB
Checked By: CT
Issue Date: MAY 7, 2013
Drawing Scale: NONE


GENERAL NOTES AND LEGENDS

BID DOCUMENTS

Drawing No. **E0.0.1**

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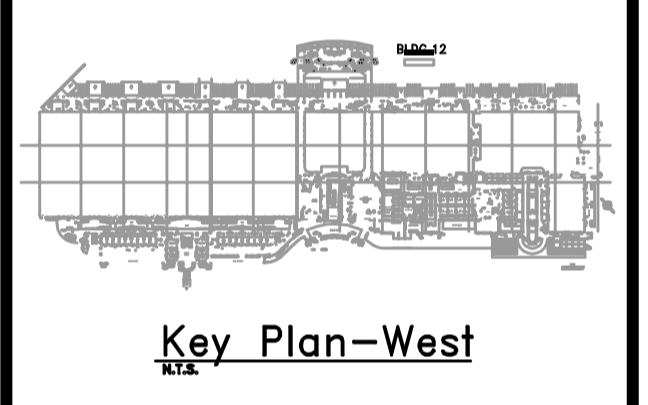
POWER PLAN - BUILDING 12
 1/8"=1'-0"
 0 4' 8' 16'

- GENERAL NOTES**
1. REFER TO GENERAL NOTES FOR THIS DISCIPLINE.
 2. REFER TO SPECIFICATIONS.
 3. ALL HEX NOTES NOT NECESSARILY USED ON ALL SHEETS.
 4. EXISTING CONDUITS ROUTING IS UNKNOWN.
 5. ALL WORK SHALL BE STRICTLY COORDINATED WITH CONVENTION CENTER STAFF.

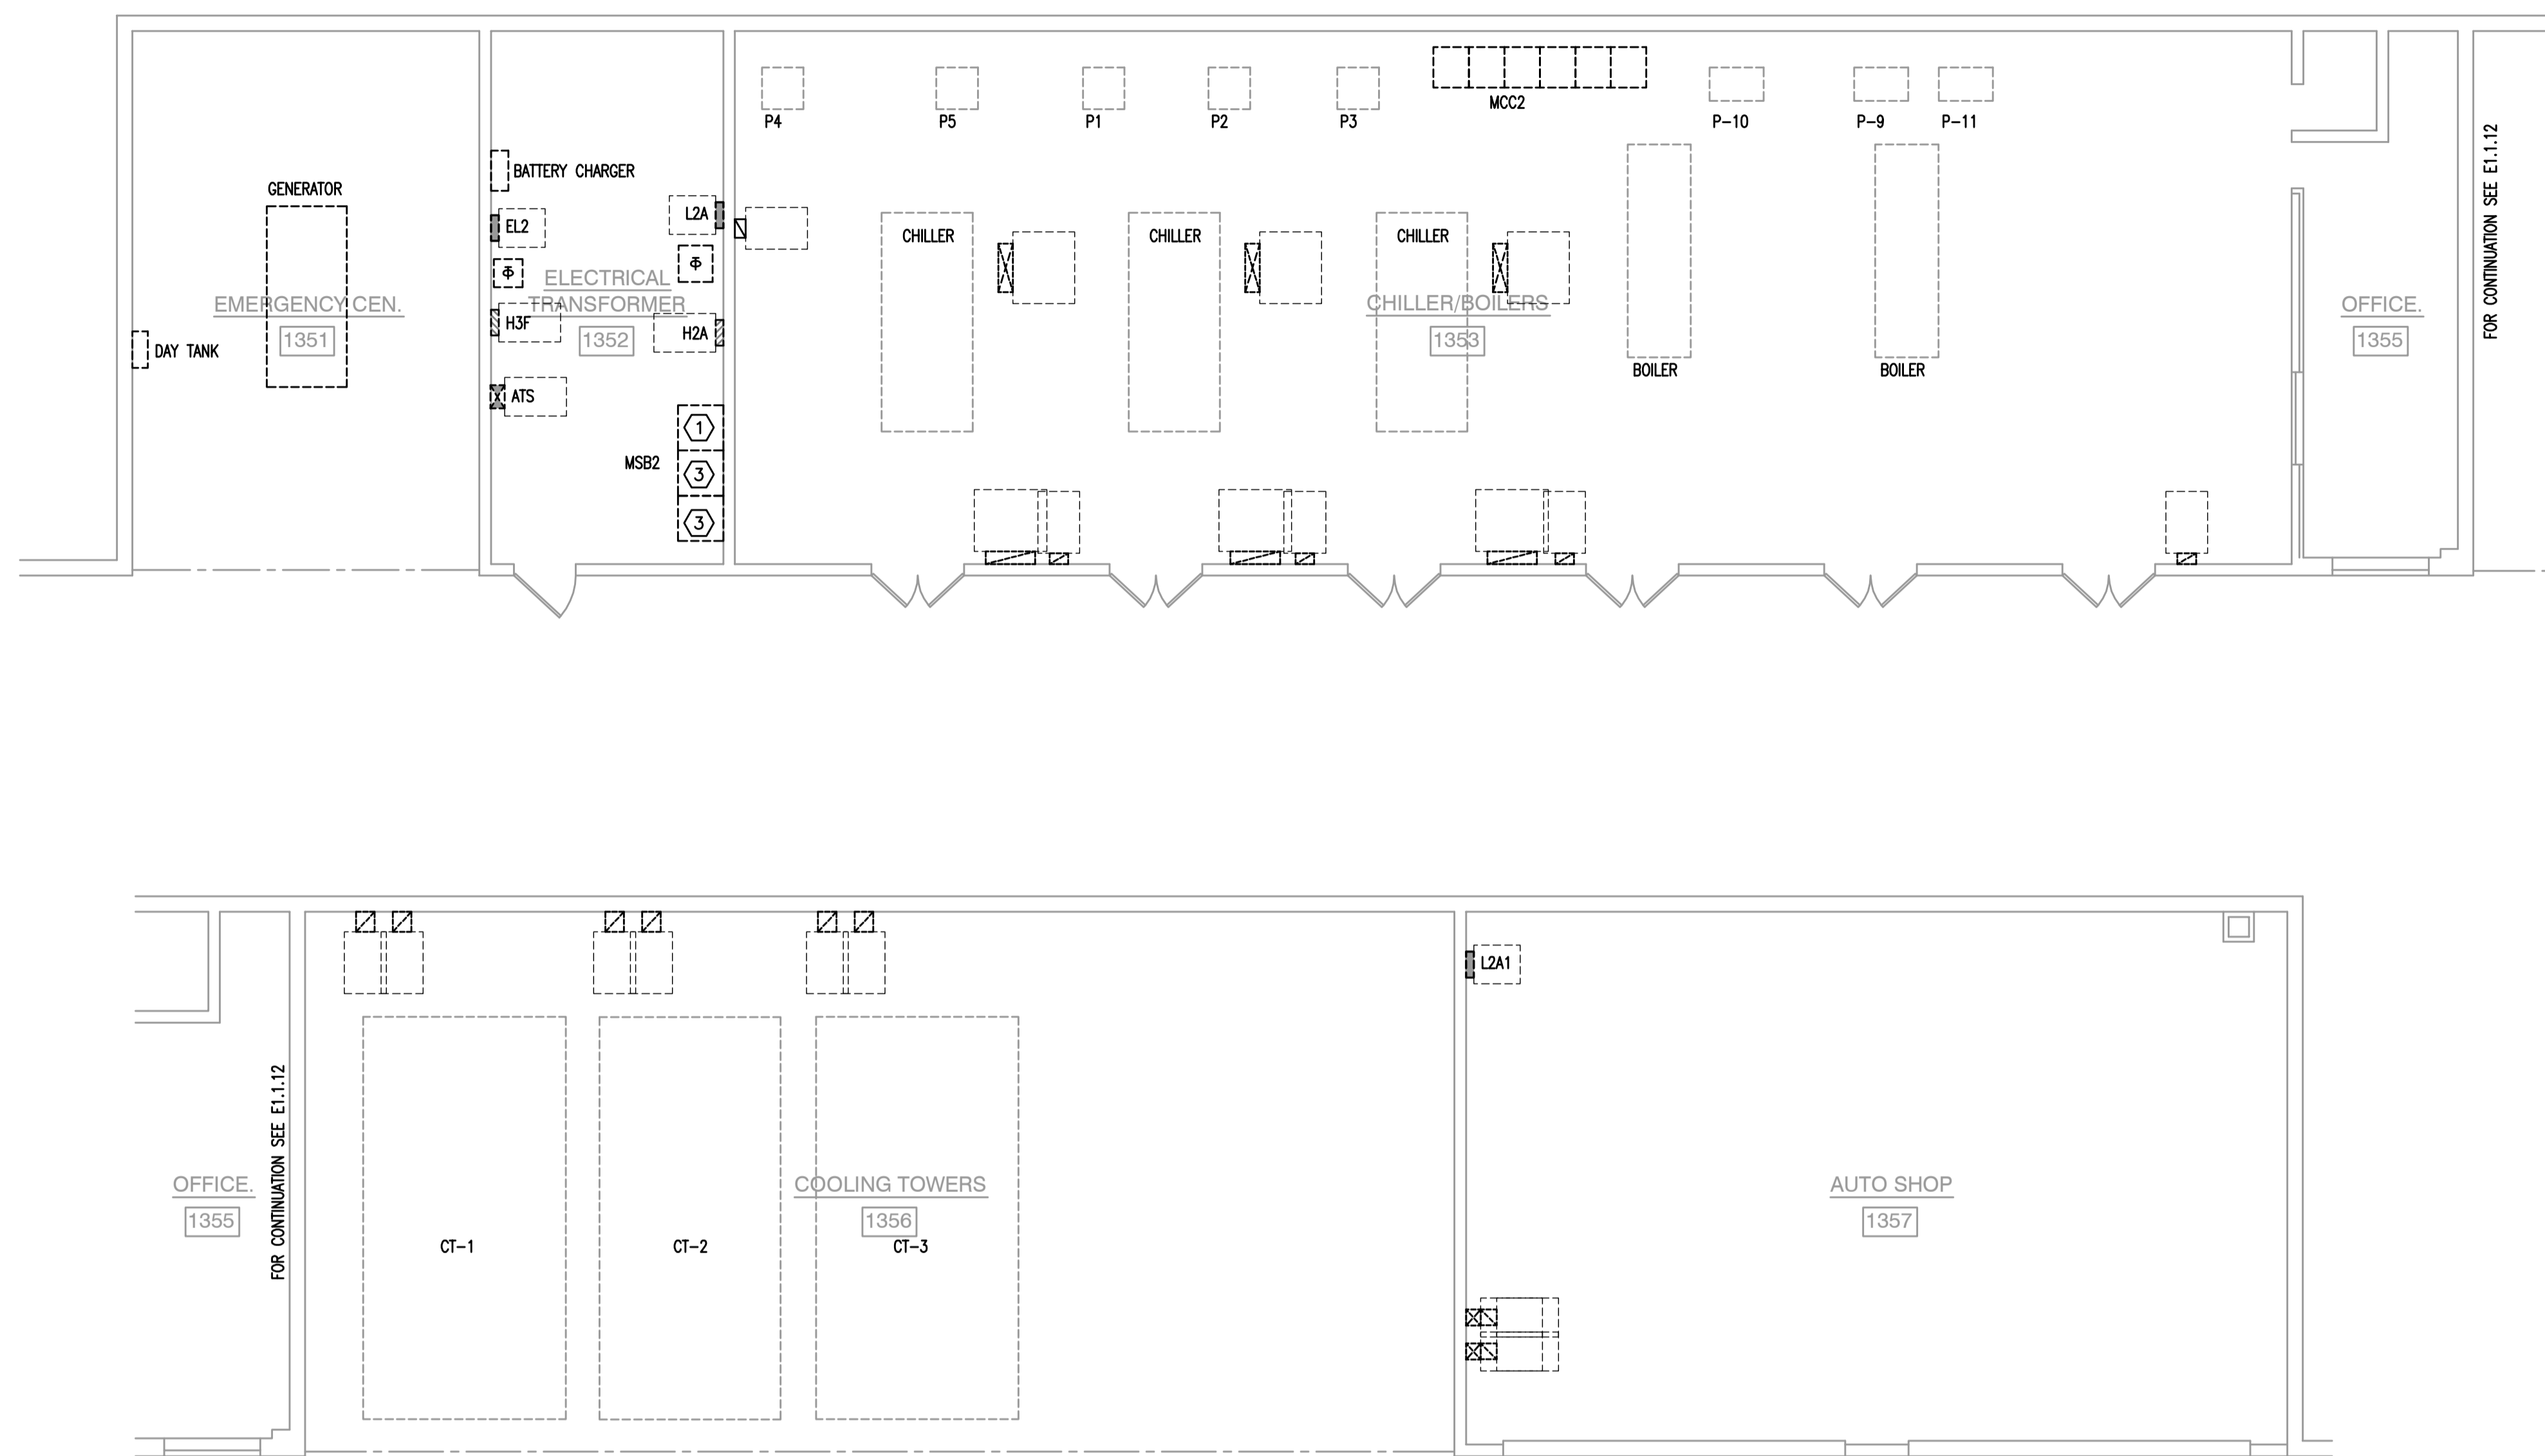- HEX NOTES**
- ① REMOVE EXISTING SWITCHBOARD MAIN AND PREPARE FOR RECONNECTION OF FEEDER TO NEW MSB.
 - ② CONNECT EXISTING FEEDER TO NEW MSB-2
 - ③ DISCONNECT EXISTING FEEDERS AND CONDUIT AND PREPARE TO RECONNECT TO NEW MSB-2 DISTRIBUTION SECTIONS.
 - ④ RECONNECT EXISTING FEEDERS AND CONDUIT AND PREPARE TO NEW BREAKERS IN NEW DISTRIBUTION SECTION. PROVIDE ALL ELECTRICAL AS REQUIRED TO FACILITATE REPLACEMENT OF DESTINATION SECTIONS.

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OCCC WEST BUILDING PHASE I - ELECTRICAL POWER UPGRADES




Revisions

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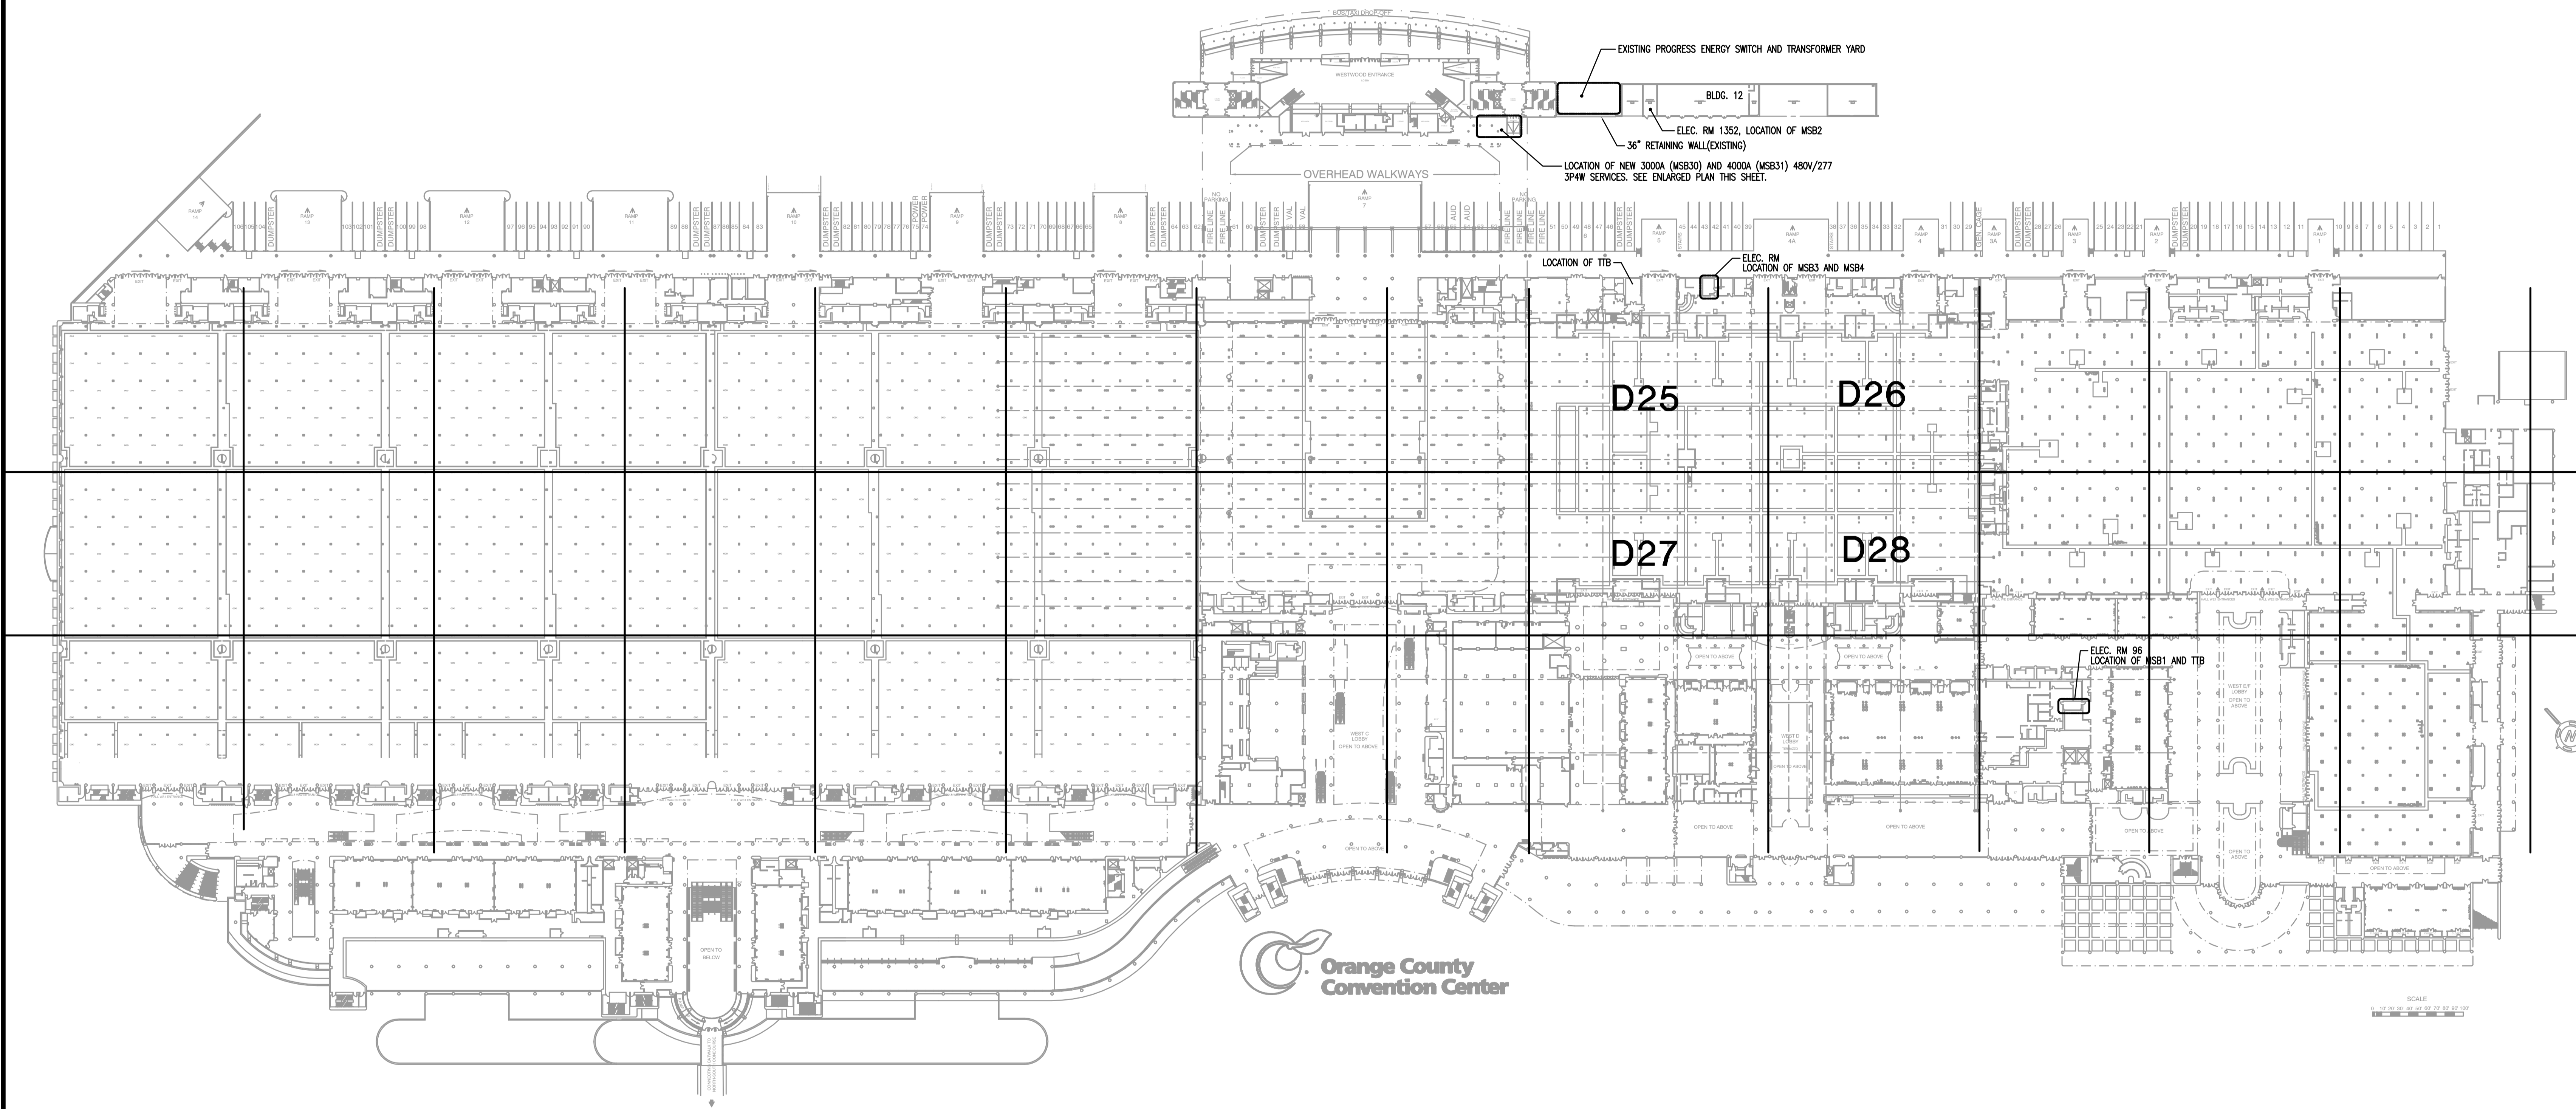
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 Drawn By: AG/RB
 Checked By: CT
 Issue Date: MAY 7, 2013
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 Drawing Title:

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 Drawing No.
E1.1.12


OCCC WEST BUILDING PHASE I - ELECTRICAL POWER UPGRADES

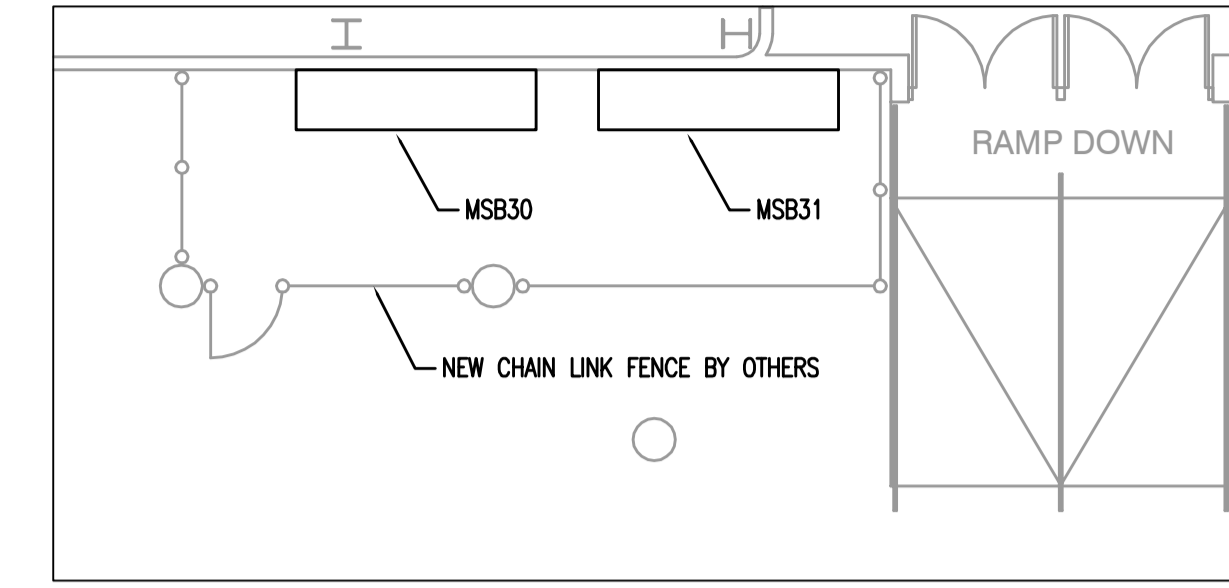

ENLARGED PLAN
 1/8"=1'-0"
 0 4' 8' 16'



OVERALL PLAN - ELECTRICAL
 1"=80'-0"
 0 40' 80' 160'

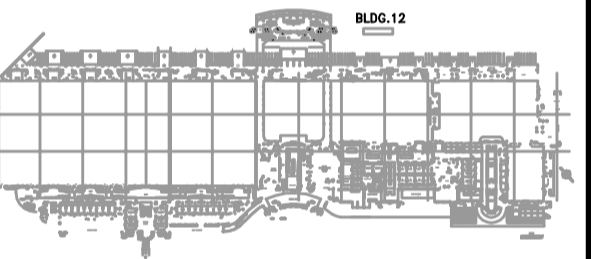

Key Plan—West

Revisions

No.	Date	Description

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 Designed By: CT/RB
 Drawn By: AG/RB
 Checked By: CET
 Issue Date: MAY 7, 2013
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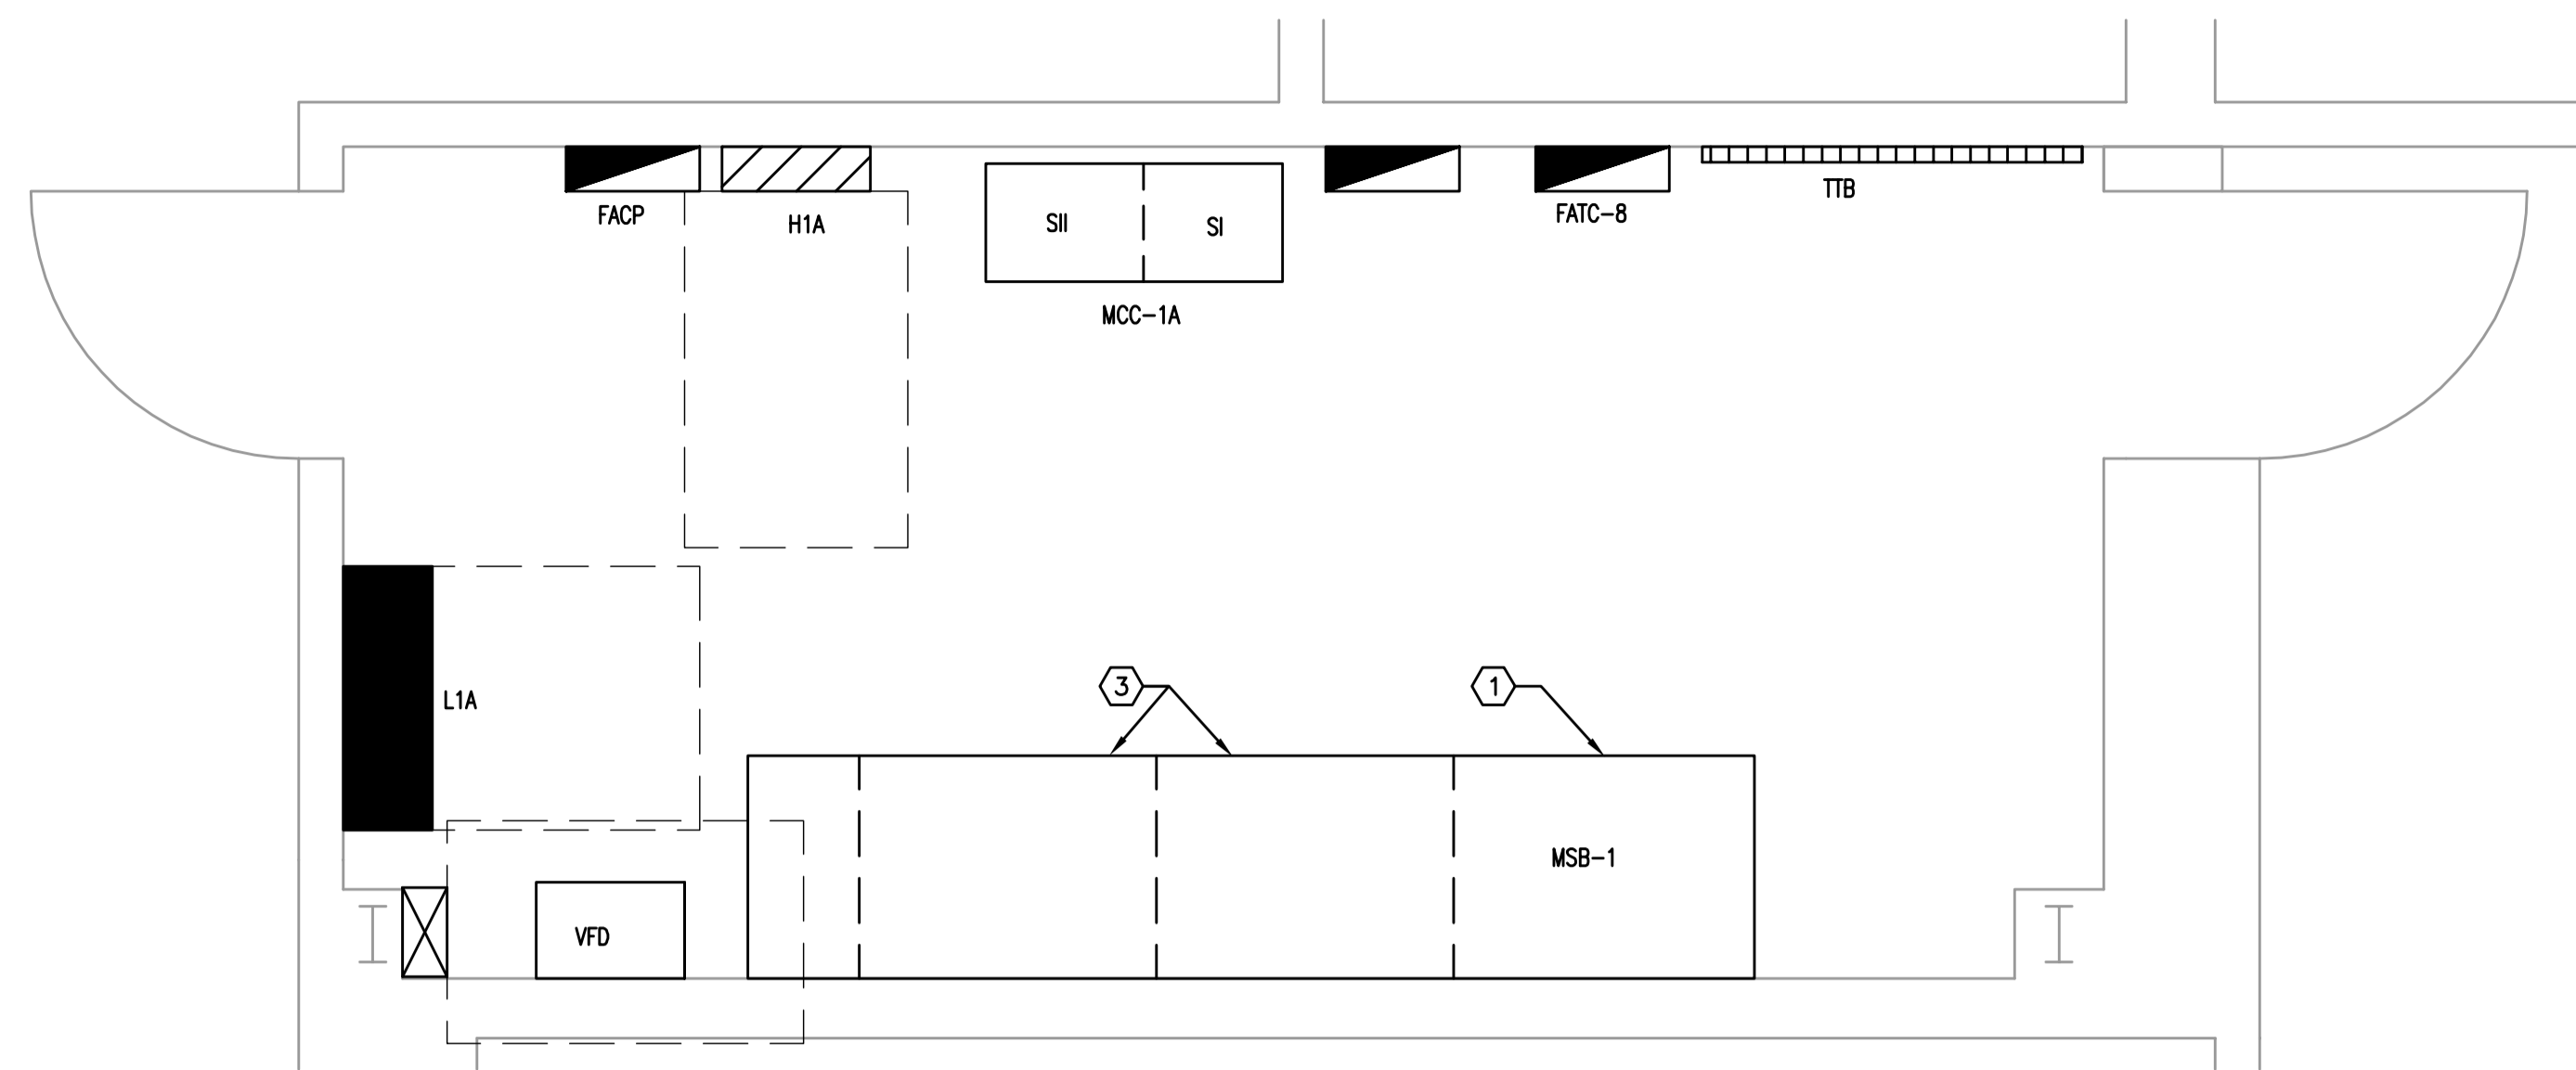
OVERALL PLAN ELECTRICAL

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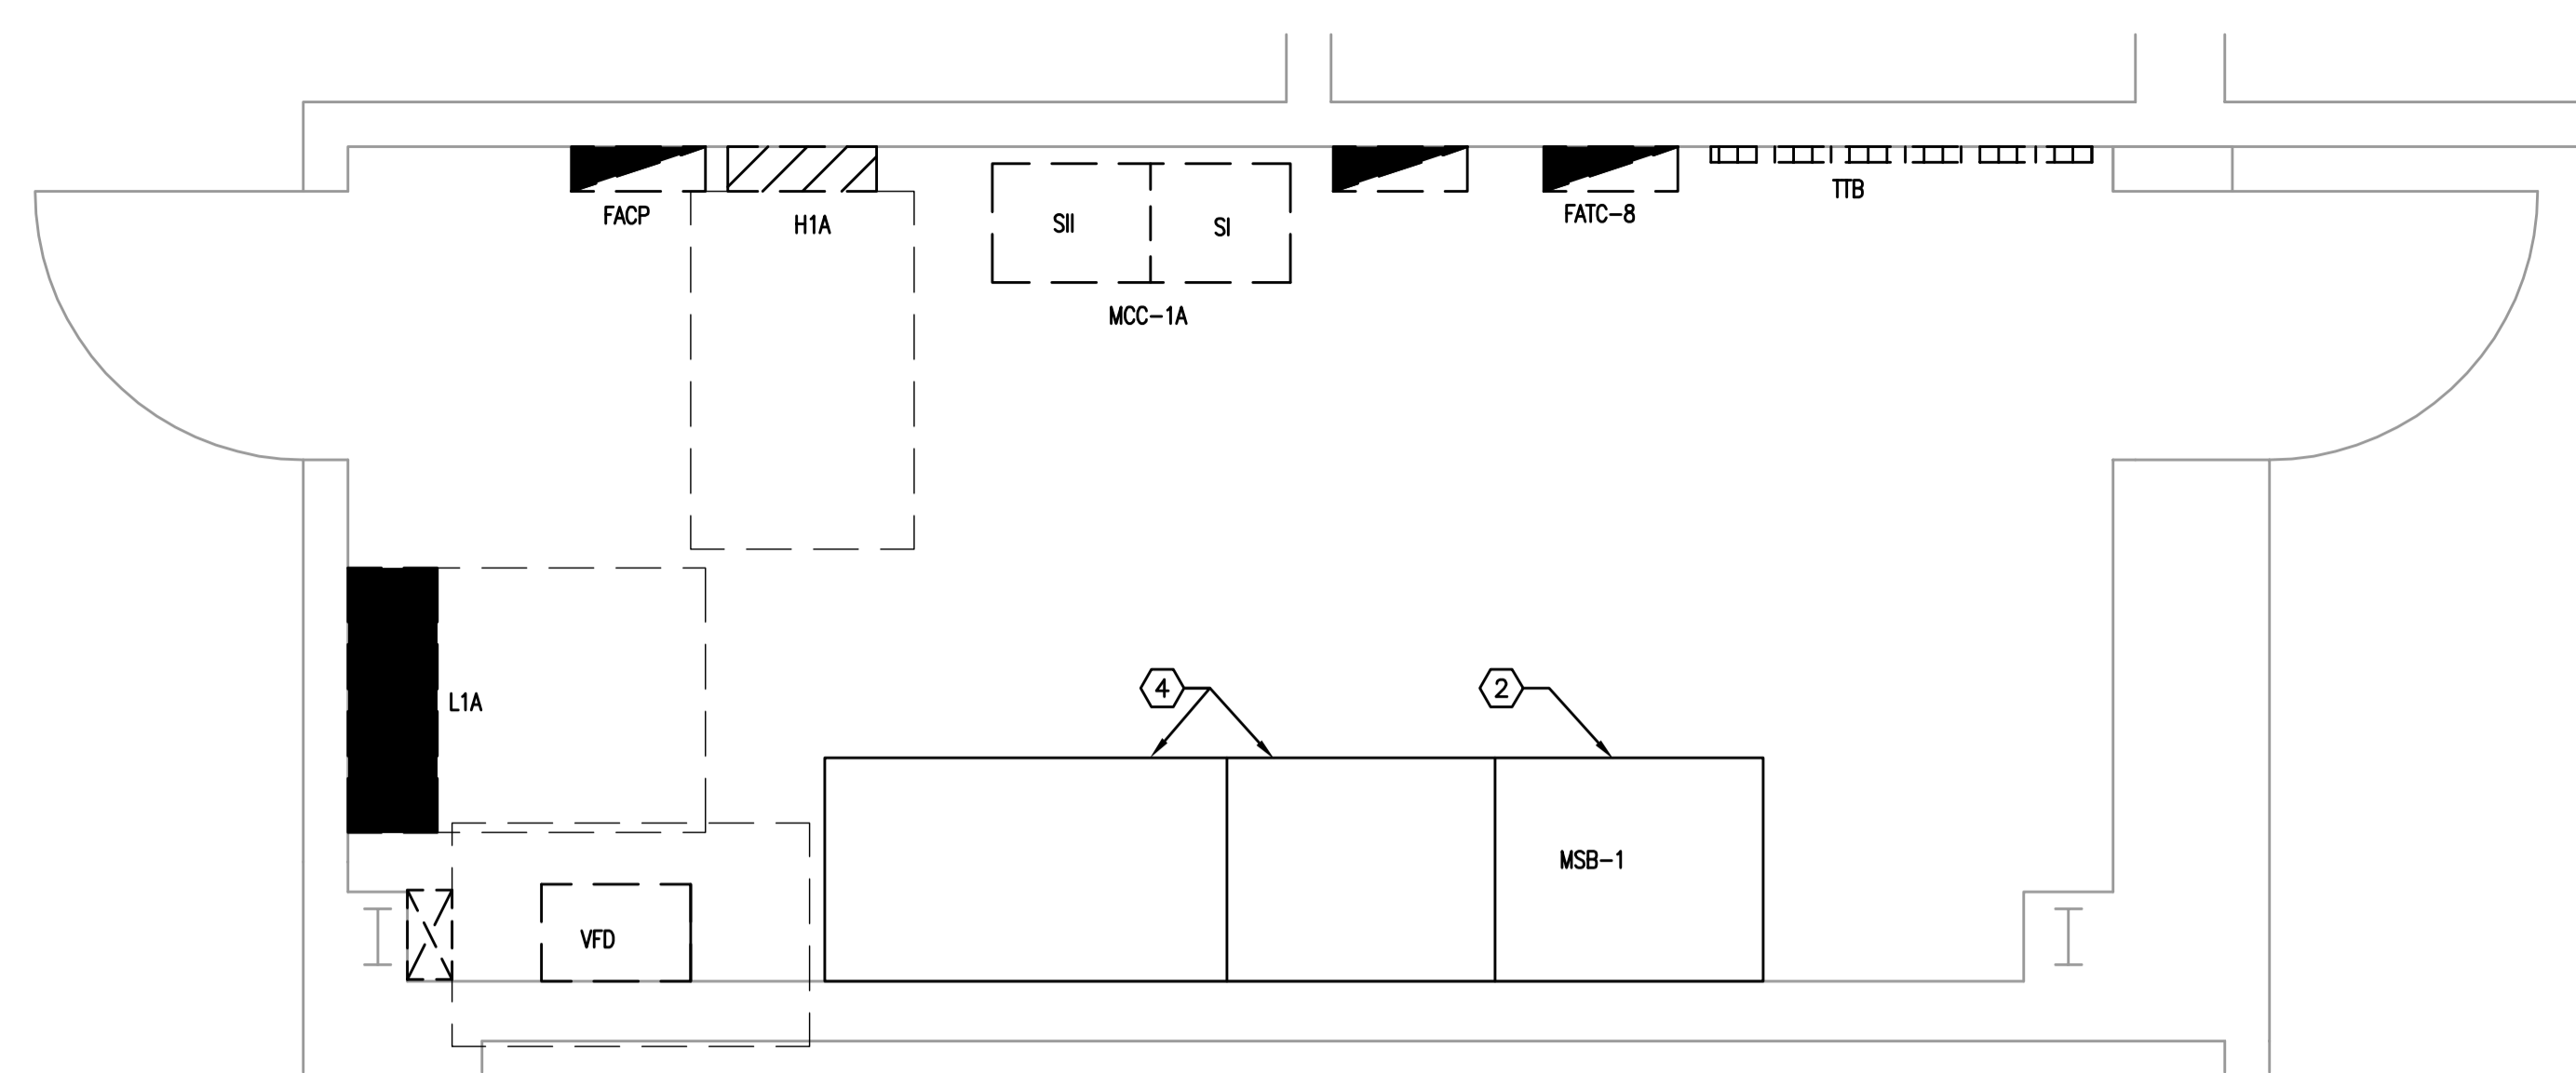
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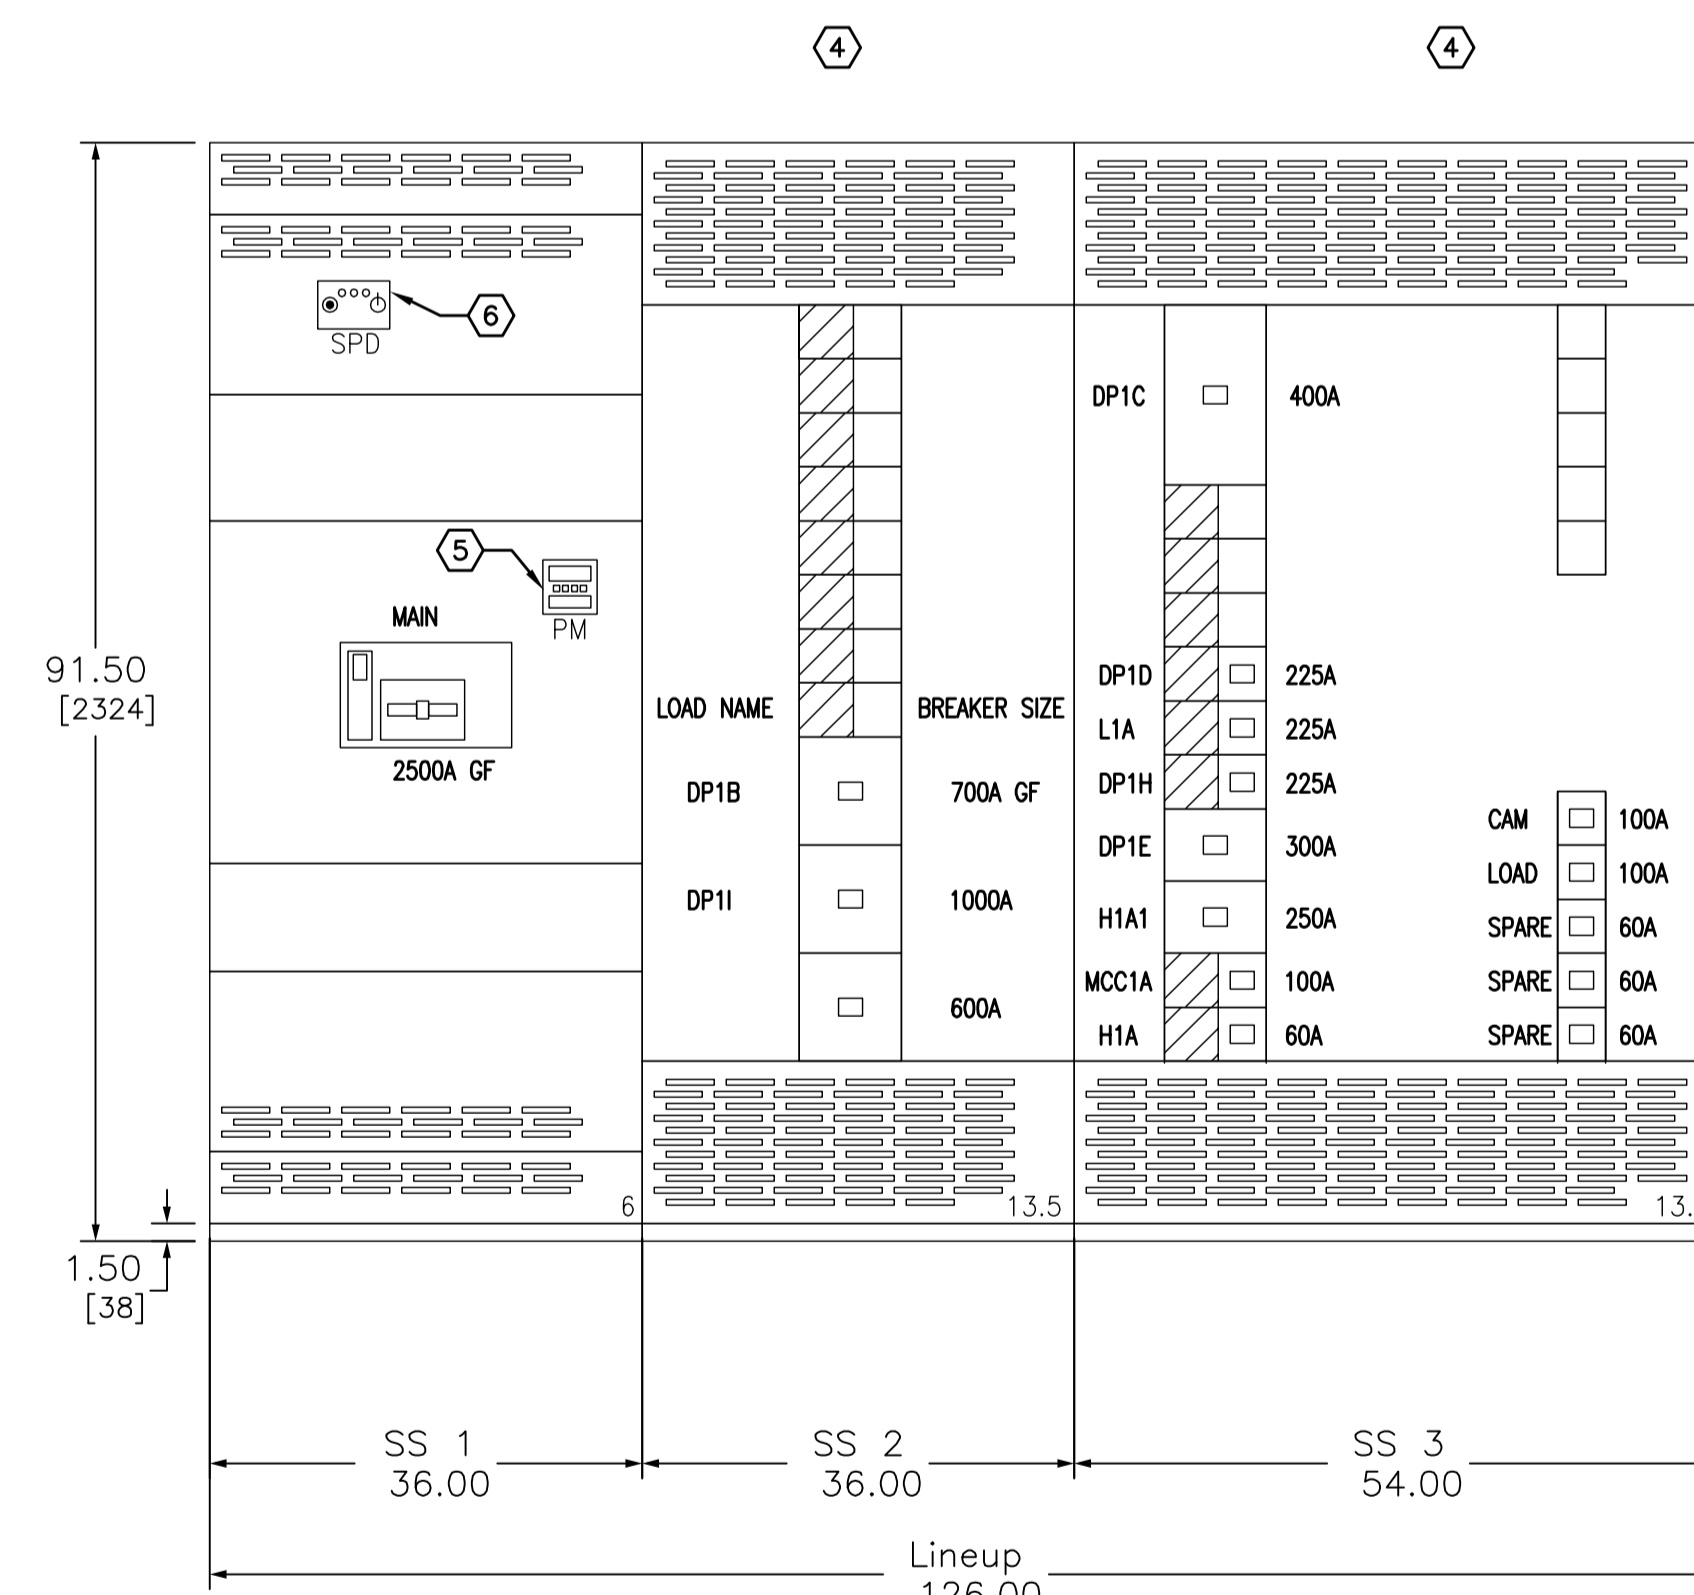
ENLARGED PLAN - ELECTRICAL RM 96 (DEMOLITION)
 1/2"=1'-0"
 0 1' 2' 4'



ENLARGED PLAN - ELECTRICAL RM 96 (RENOVATION)
 1/2"=1'-0"
 0 1' 2' 4'

MAIN		MCC	
2500A GF		MCC1A □ 100A	CAM □ 100A
		LOAD □ 100A	H1A □ 60A
		SPARE □ 60A	SPARE □ 60A
	DP1B □ 700A GF		
	DP1I □ 1000A	DP1E □ 300A	
	□ 600A	DP1C □ 400A	
		H1A1 □ 250A	
		DP1D □ 225A	
		L1A □ 225A	
		DP1H □ 225A	

ELEVATION - MSB1 (EXISTING)
 NOT TO SCALE



ELEVATION - MSB1 (NEW)
 NOT TO SCALE

GENERAL NOTES


- REFER TO GENERAL NOTES FOR THIS DISCIPLINE.
- REFER TO SPECIFICATIONS.
- NO MULTI-WIRE BRANCH CIRCUITS ARE TO BE USED. EACH CIRCUIT IS TO HAVE SEPARATE INDIVIDUAL NEUTRAL.
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- WHERE CONDUIT ROUTING IS SHOWN, THE CONDUITS ARE SHOWN FOR DIAGRAMMATIC PURPOSES AND ARE NOT NECESSARILY REPRESENTATIVE OF EXACT PLACEMENT.

HEX NOTES

- REMOVE EXISTING SWITCHGEAR MAIN AND PREPARE FOR RECONNECTION OF FEEDER TO NEW MSB.
- RECONNECT EXISTING FEEDER TO NEW MSB-1
- DISCONNECT EXISTING FEEDERS AND CONDUIT AND PREPARE TO RECONNECT TO NEW MSB-1 SECTIONS.
- RECONNECT EXISTING FEEDERS AND CONDUIT TO NEW BREAKERS IN NEW DISTRIBUTION SECTION. PROVIDE ALL ELECTRICAL AS REQUIRED TO FACILITATE REPLACEMENT OF DISTRIBUTION SECTIONS.
- PROVIDE POWER MONITORING SYSTEM. PROVIDE CAT-6 HOMERUN TO ITB REQUIRED BY CONVENTION CENTER STAFF.
- PROVIDE NEW SURGE PROTECTIVE DEVICE. REFER TO SPECIFICATIONS FOR ADDITIONAL REQUIREMENTS.

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OCCC WEST BUILDING PHASE I - ELECTRICAL POWER UPGRADES

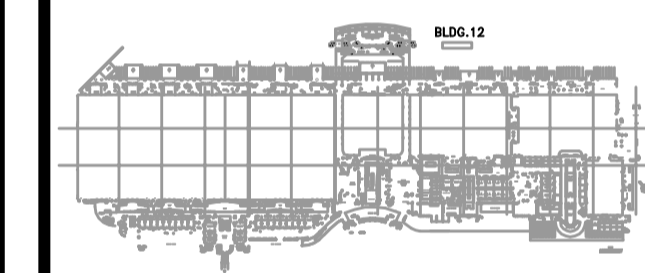

Key Plan - West

Revisions

No.	Date	Description

MPE PROJ#: 2012-188B

Designed By: RB

Drawn By: AG/RB

Checked By: CT

Issue Date: MAY 7, 2013

Drawing Scale: VARIES


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ENLARGED ROOM PLAN & EQUIPMENT ELEVATIONS

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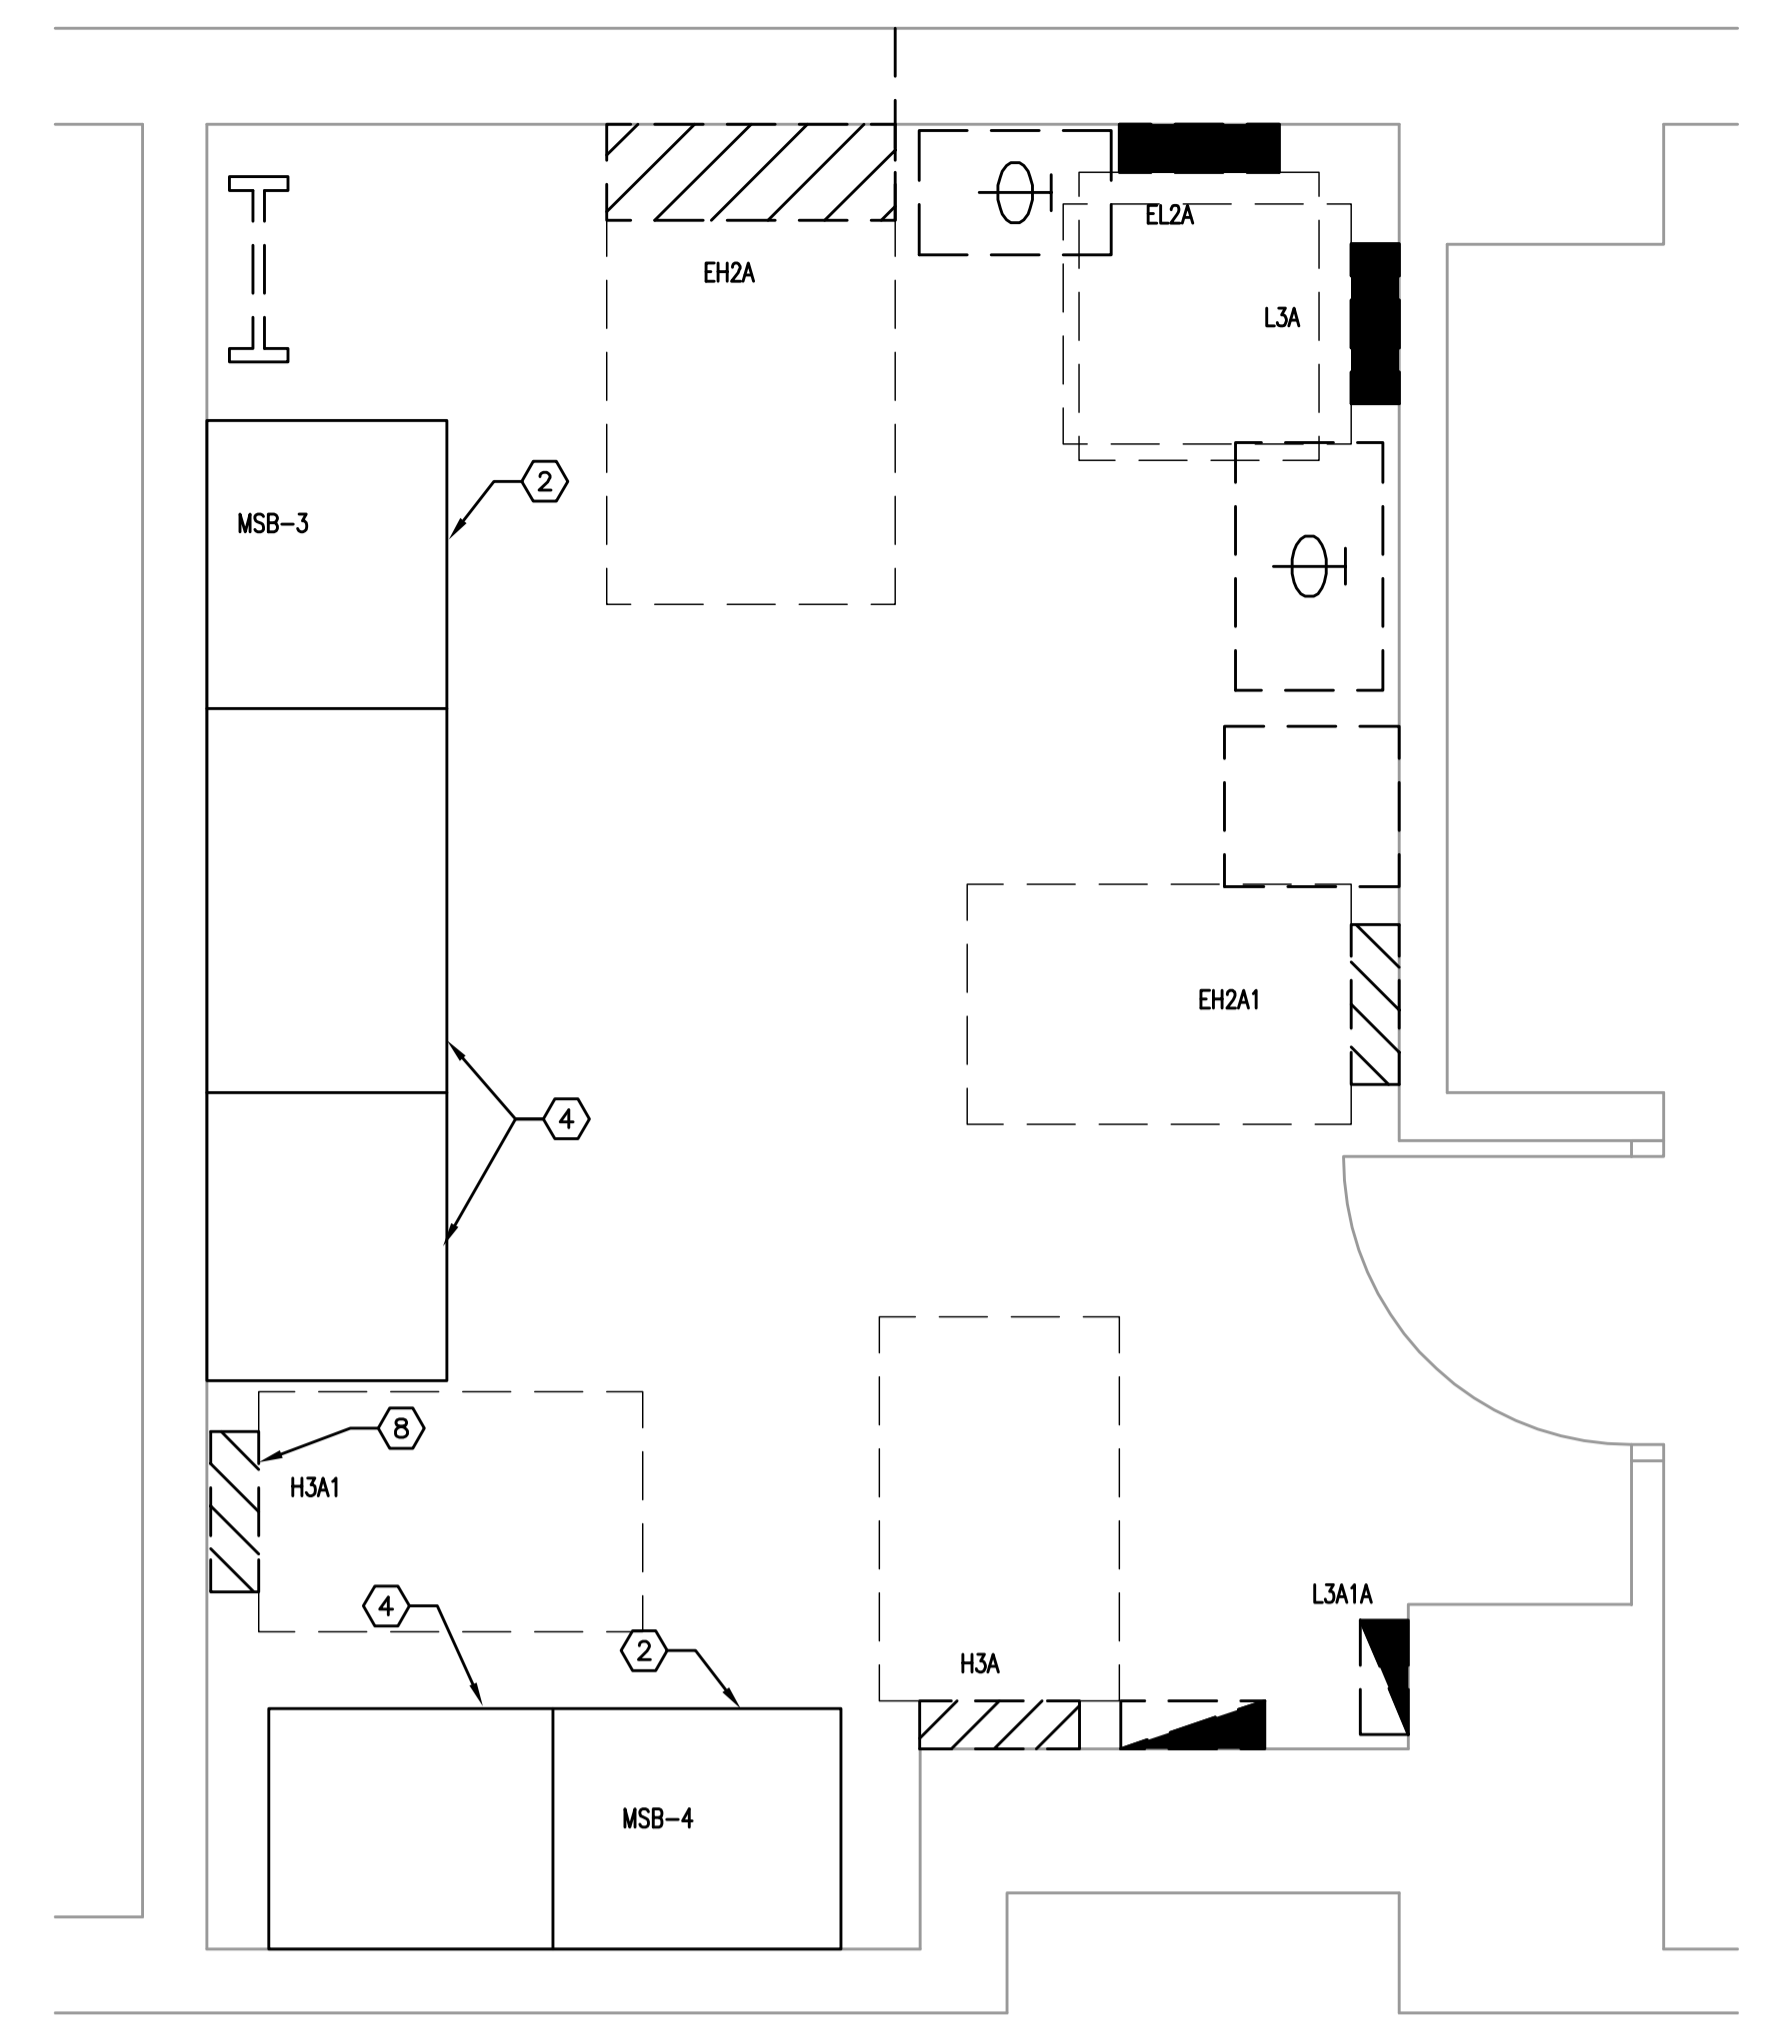
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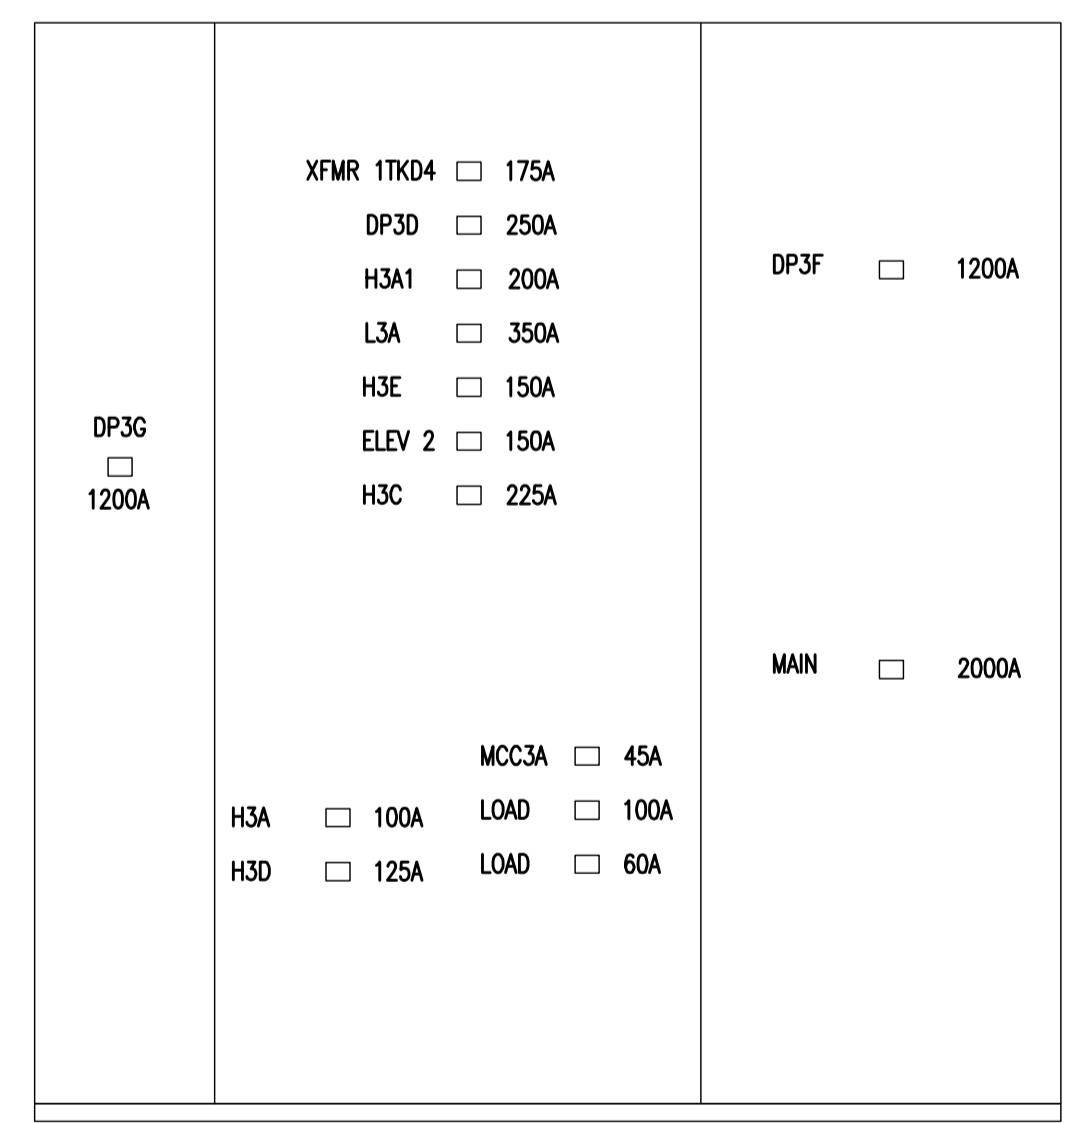
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 DRAWN BY: AG/RB
 CHECKED BY: CT
 ISSUE DATE: MAY 7, 2013
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 DRAWING TITLE: ENLARGED ROOM PLAN & EQUIPMENT ELEVATIONS
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 DRAWING NO. E2.4.02




ENLARGED PLAN - ELECTRICAL RM (DEMOLITION)
 1/2"=1'-0"
 0 1' 2' 4'

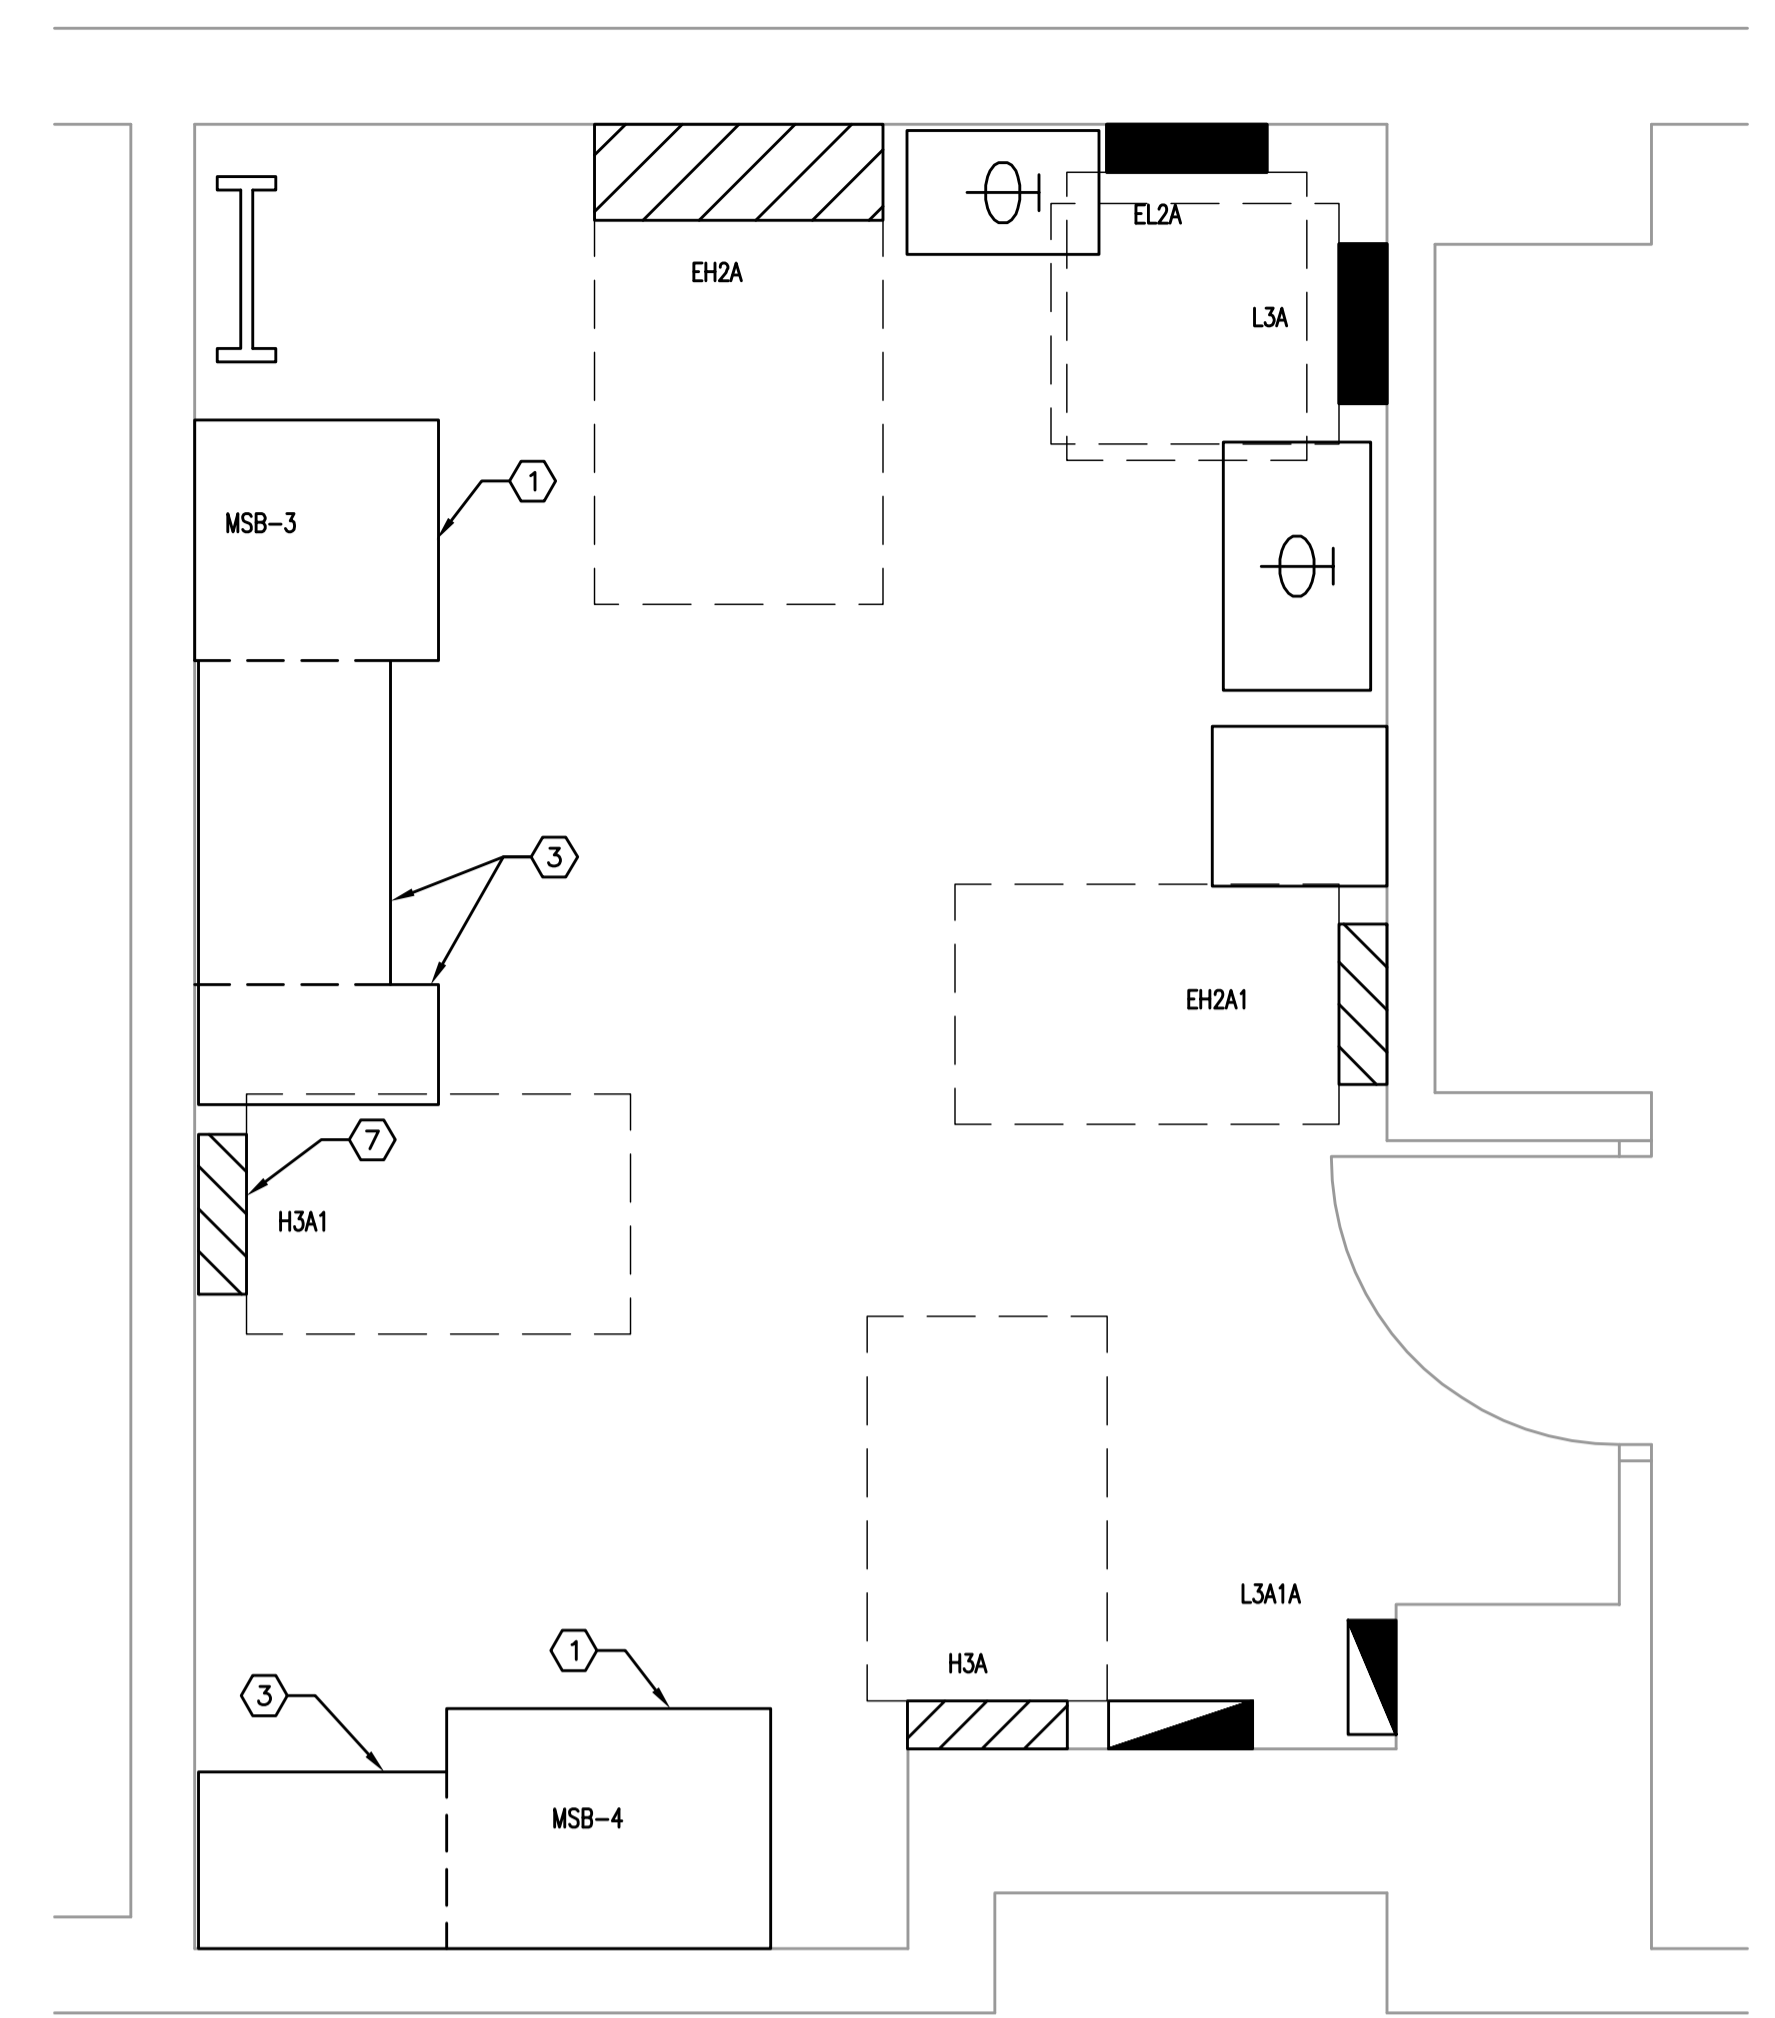


ENLARGED PLAN - ELECTRICAL RM (RENOVATION)
 1/2"=1'-0"
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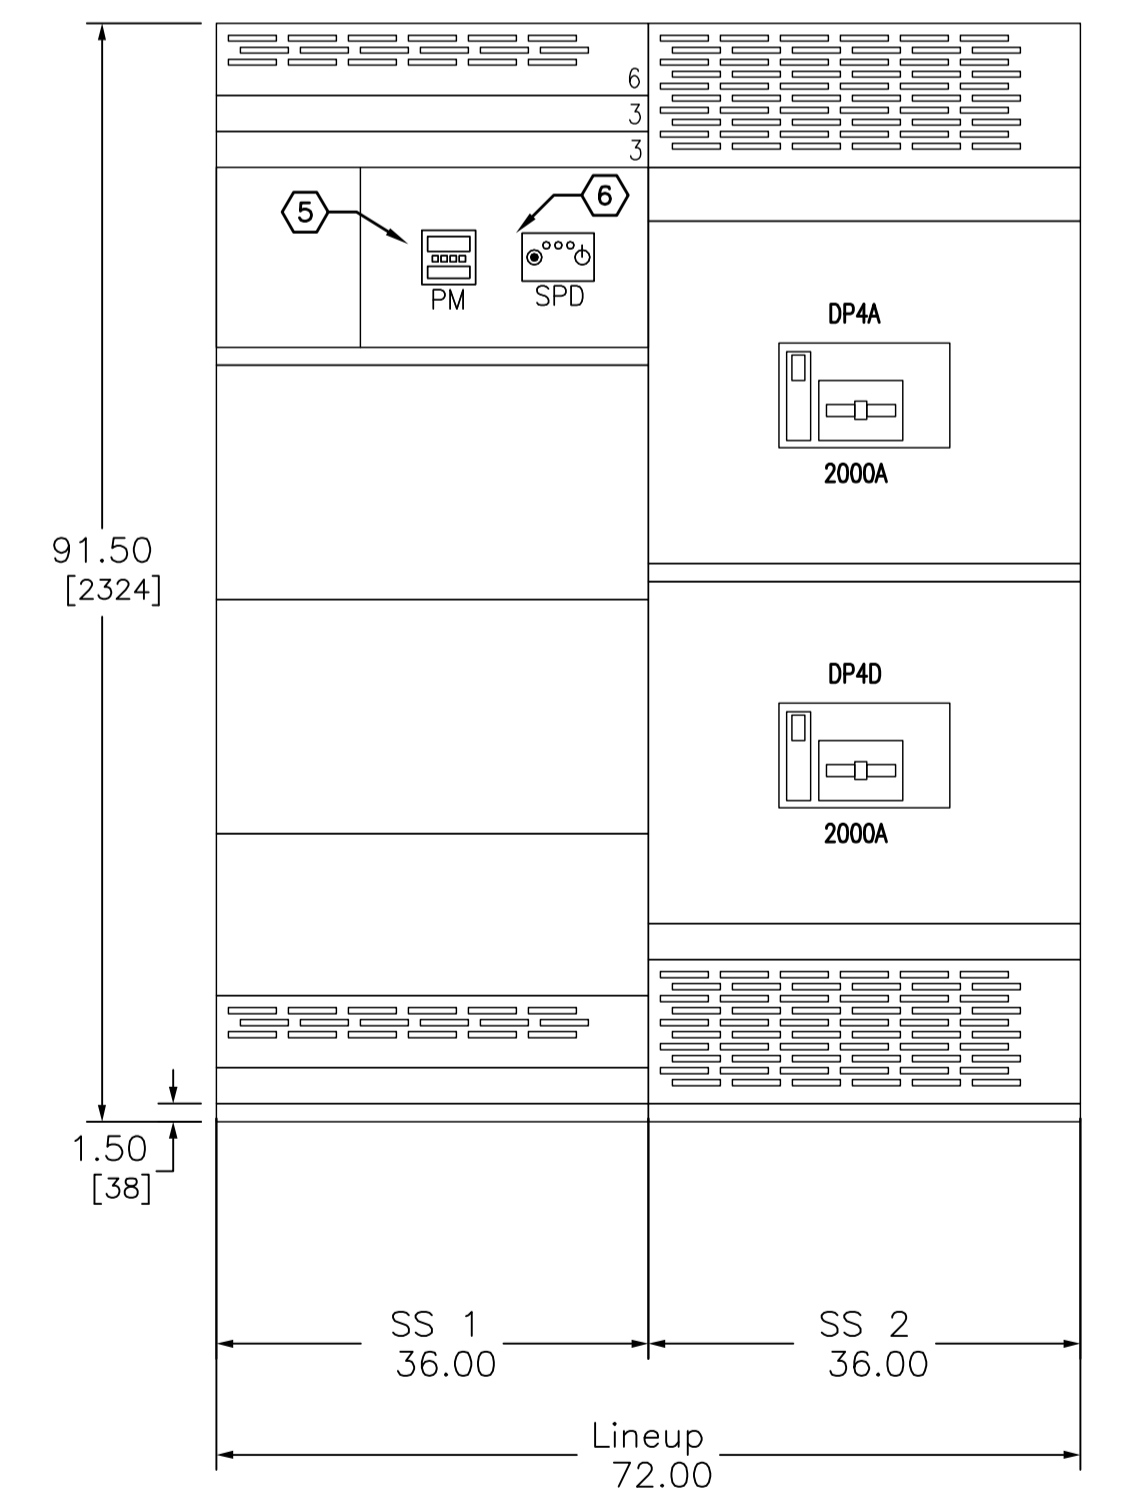
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 NOT TO SCALE



ELEVATION - MSB3 (NEW)
 NOT TO SCALE

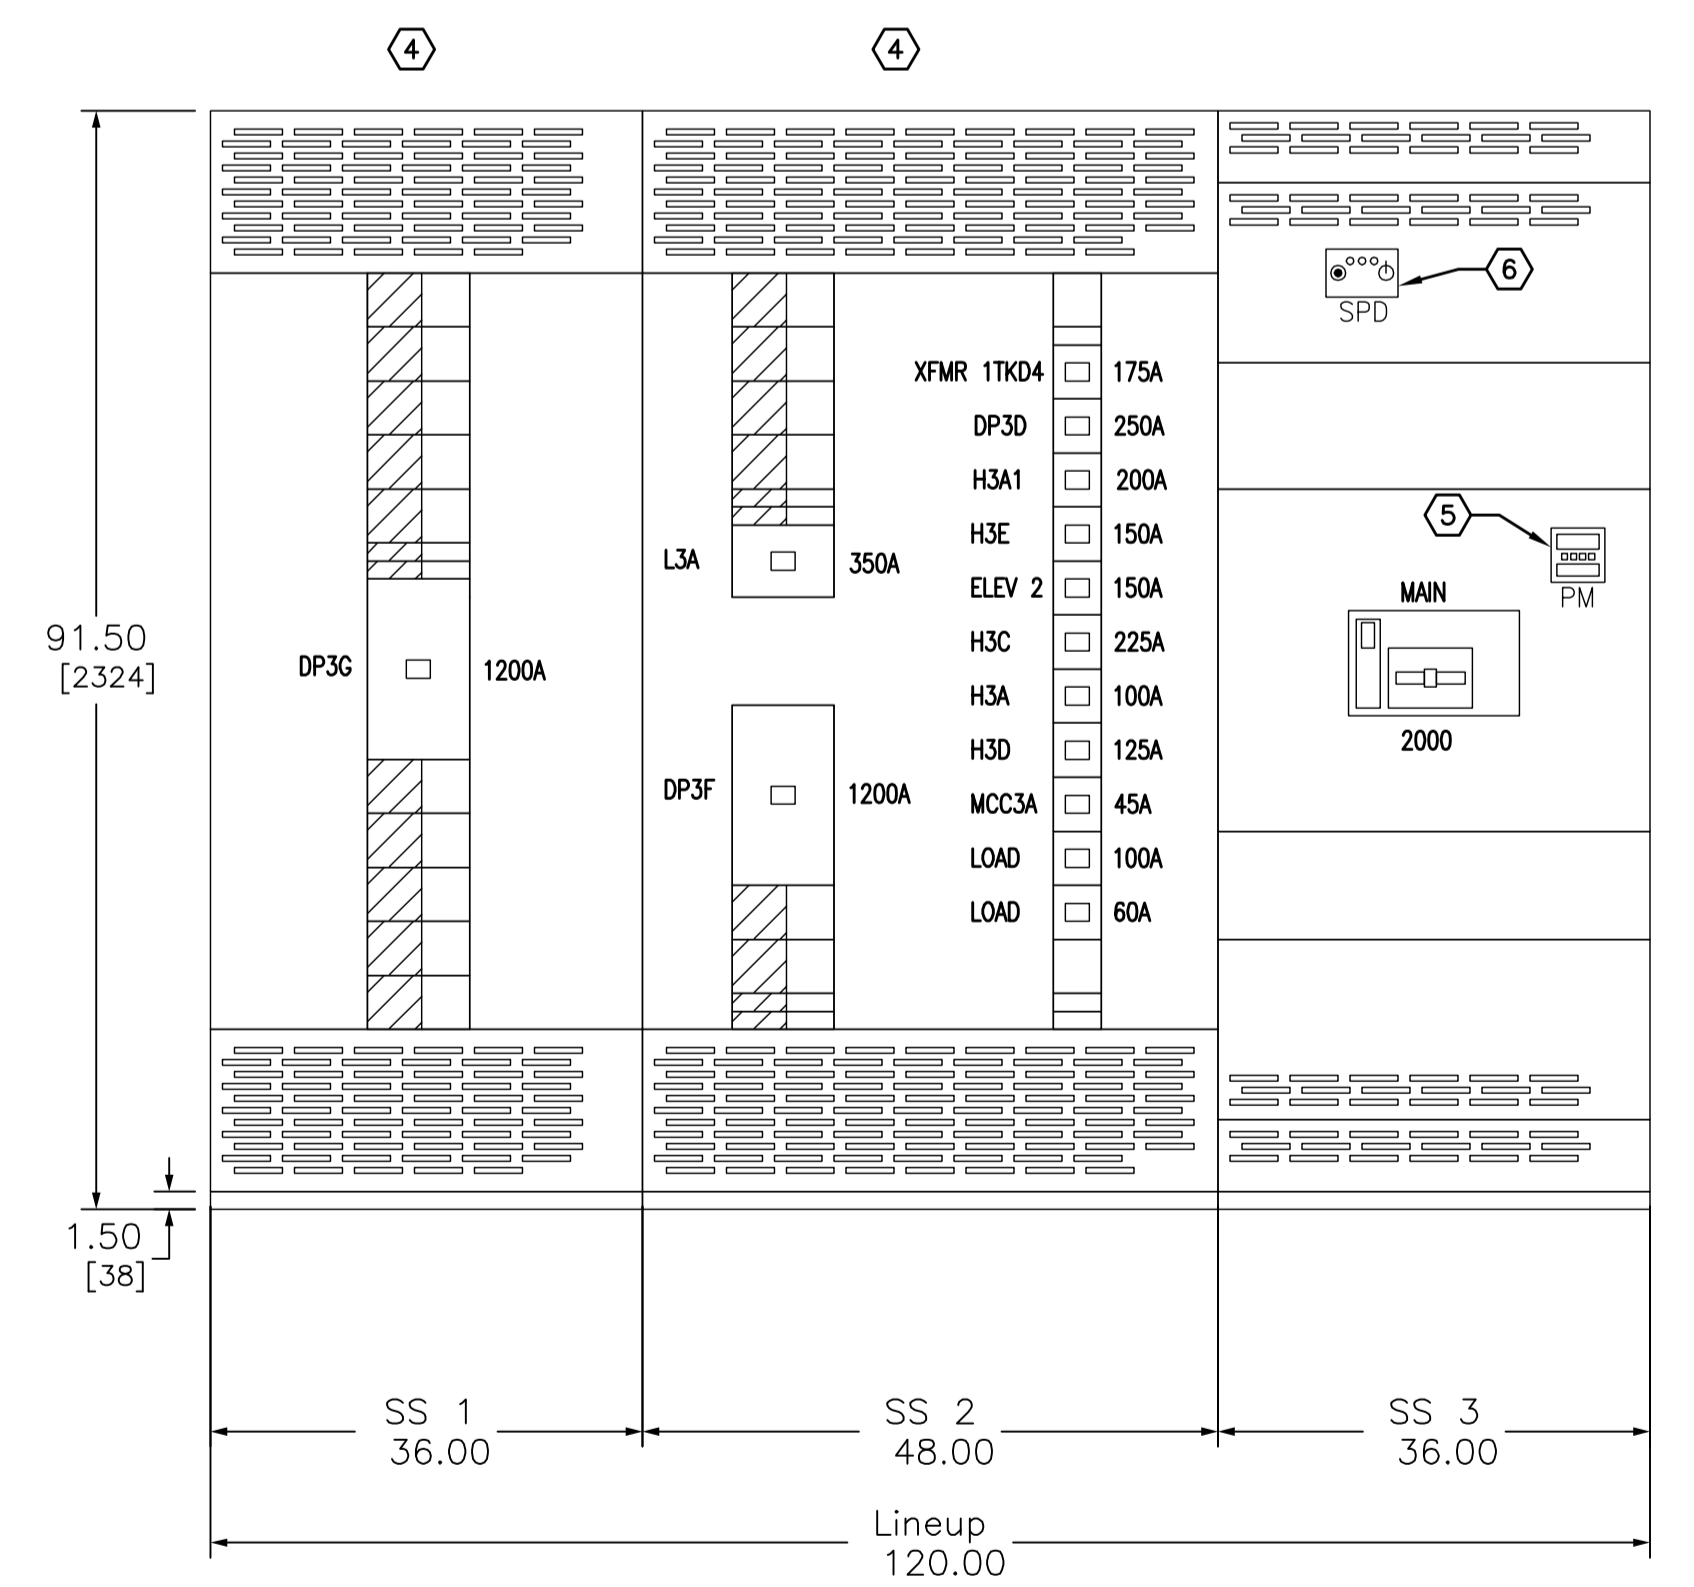

ELEVATION - MSB4 (EXISTING)
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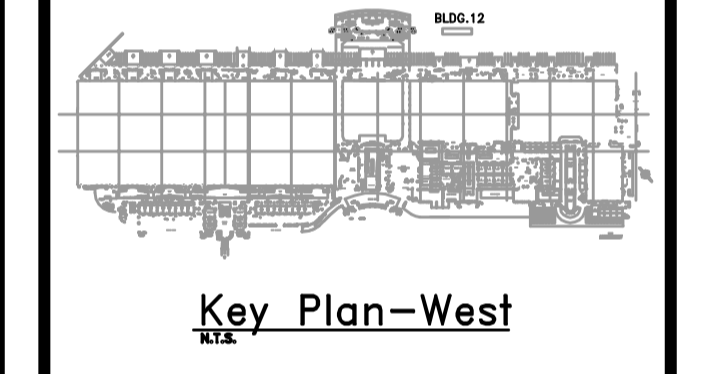


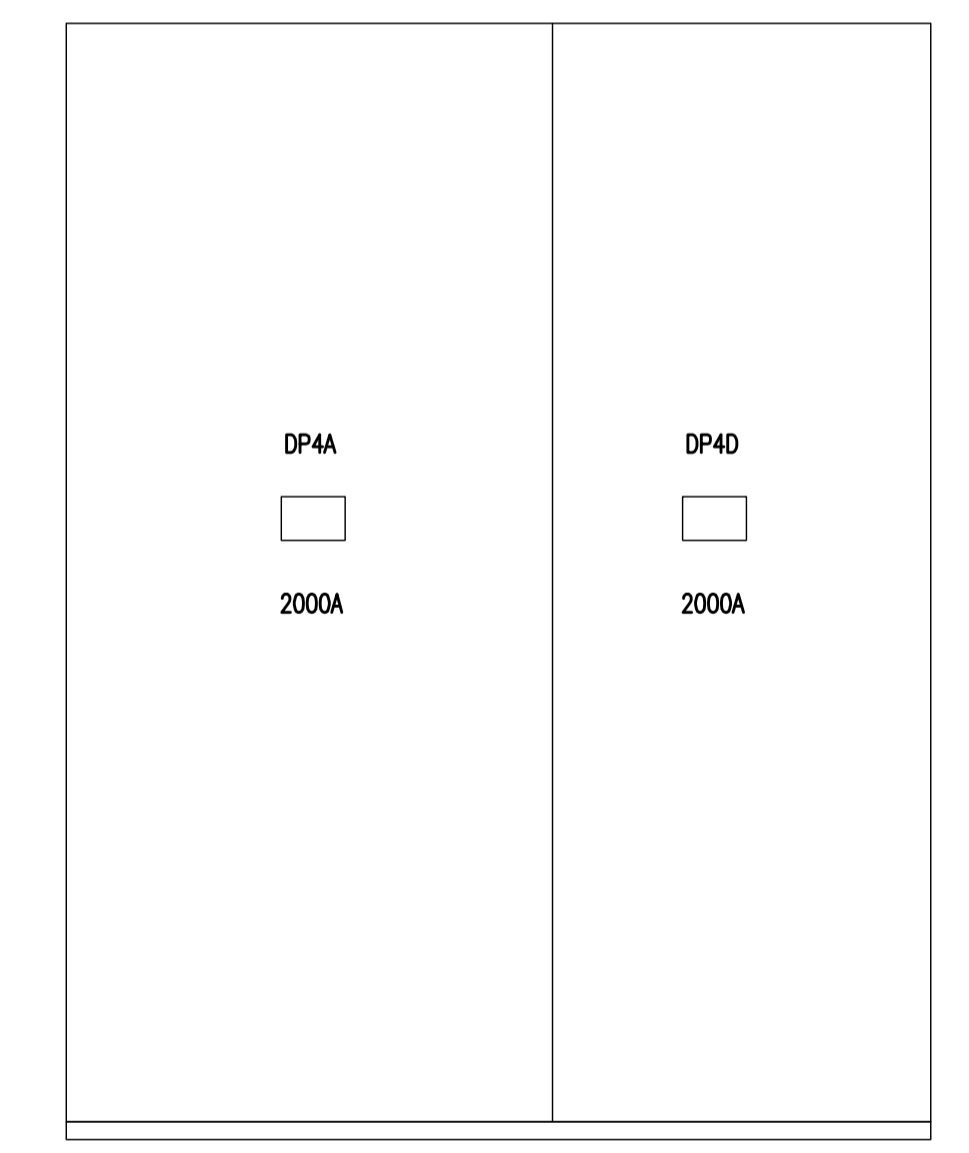ELEVATION - MSB4 (NEW)
 NOT TO SCALE

- GENERAL NOTES**
- REFER TO GENERAL NOTES FOR THIS DISCIPLINE.
 - REFER TO SPECIFICATIONS.
 - NO MULTI-WIRE BRANCH CIRCUITS ARE TO BE USED. EACH CIRCUIT IS TO HAVE SEPARATE INDIVIDUAL NEUTRAL.
 - ALL HEX NOTES NOT NECESSARILY USED ON ALL SHEETS.
 - EXISTING CONDUIT ROUTING IS UNKNOWN.
 - WHERE CONDUIT ROUTING IS SHOWN, THE CONDUITS ARE SHOWN FOR DIAGRAMMATIC PURPOSES AND ARE NOT NECESSARILY REPRESENTATIVE OF EXACT PLACEMENT.

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OCCC WEST BUILDING PHASE I - ELECTRICAL POWER UPGRADES



Revisions

No.	Date	Description


- HEX NOTES**
- REMOVE EXISTING SWITCHGEAR MAIN AND PREPARE FOR RECONNECTION OF FEEDER TO NEW MSB.
 - RECONNECT EXISTING FEEDER TO NEW MSB-1
 - DISCONNECT EXISTING FEEDERS AND CONDUIT AND PREPARE TO RECONNECT TO NEW MSB-1 SECTIONS.
 - RECONNECT EXISTING FEEDERS AND CONDUIT TO NEW BREAKERS IN NEW DISTRIBUTION SECTION. PROVIDE ALL ELECTRICAL AS REQUIRED TO FACILITATE REPLACEMENT OF DISTRIBUTION SECTIONS.
 - PROVIDE POWER MONITORING SYSTEM. PROVIDE CAT-6 HOMERUN TO TTB AS REQUIRED BY CONVENTION CENTER STAFF.
 - PROVIDE NEW SURGE PROTECTIVE DEVICE. REFER TO SPECIFICATIONS FOR ADDITIONAL REQUIREMENTS.
 - EQUIPMENT TO BE RELOCATED. SEE RENOVATION PLAN.
 - NEW LOCATION OF RELOCATED EQUIPMENT.

MPE PROJ#: 2012-188B
 Designed By: RB
 Drawn By: AG/RB
 Checked By: CT
 Issue Date: MAY 7, 2013
 Drawing Scale: 1/8"=1'-0"
 Drawing Title:
ENLARGED ROOM PLAN & EQUIPMENT ELEVATIONS
 BID DOCUMENTS
 Drawing No.
E2.4.02

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ELECTRICAL TRANSFORMER


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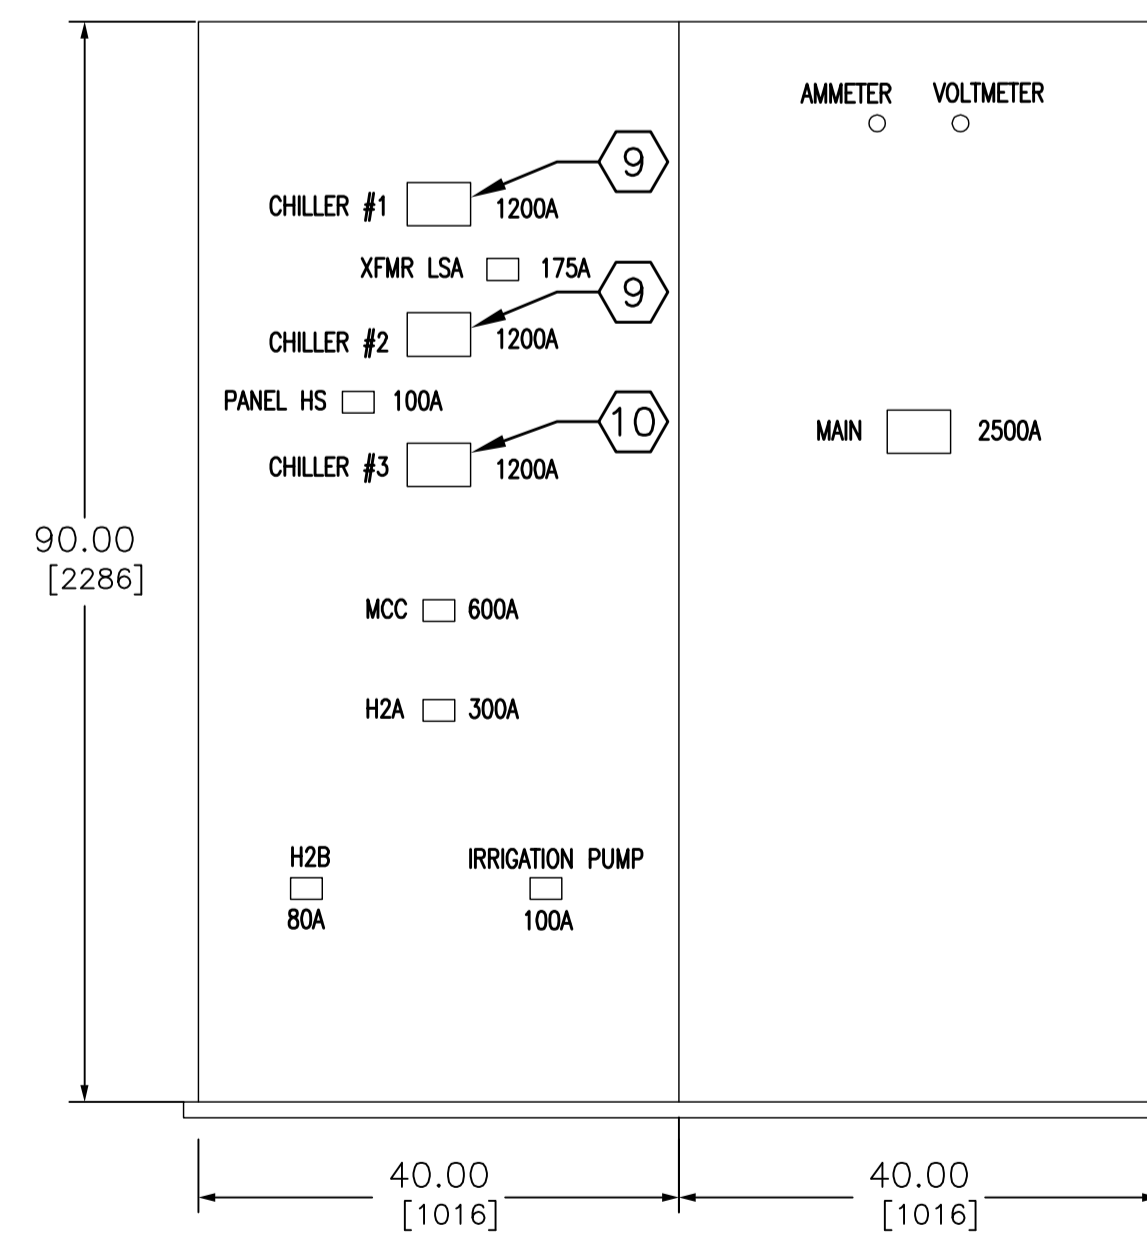
ENLARGED PLAN - ELECTRICAL RM (DEMOLITION)
 1/2"=1'-0"
 0 1' 2' 4'

ELECTRICAL TRANSFORMER

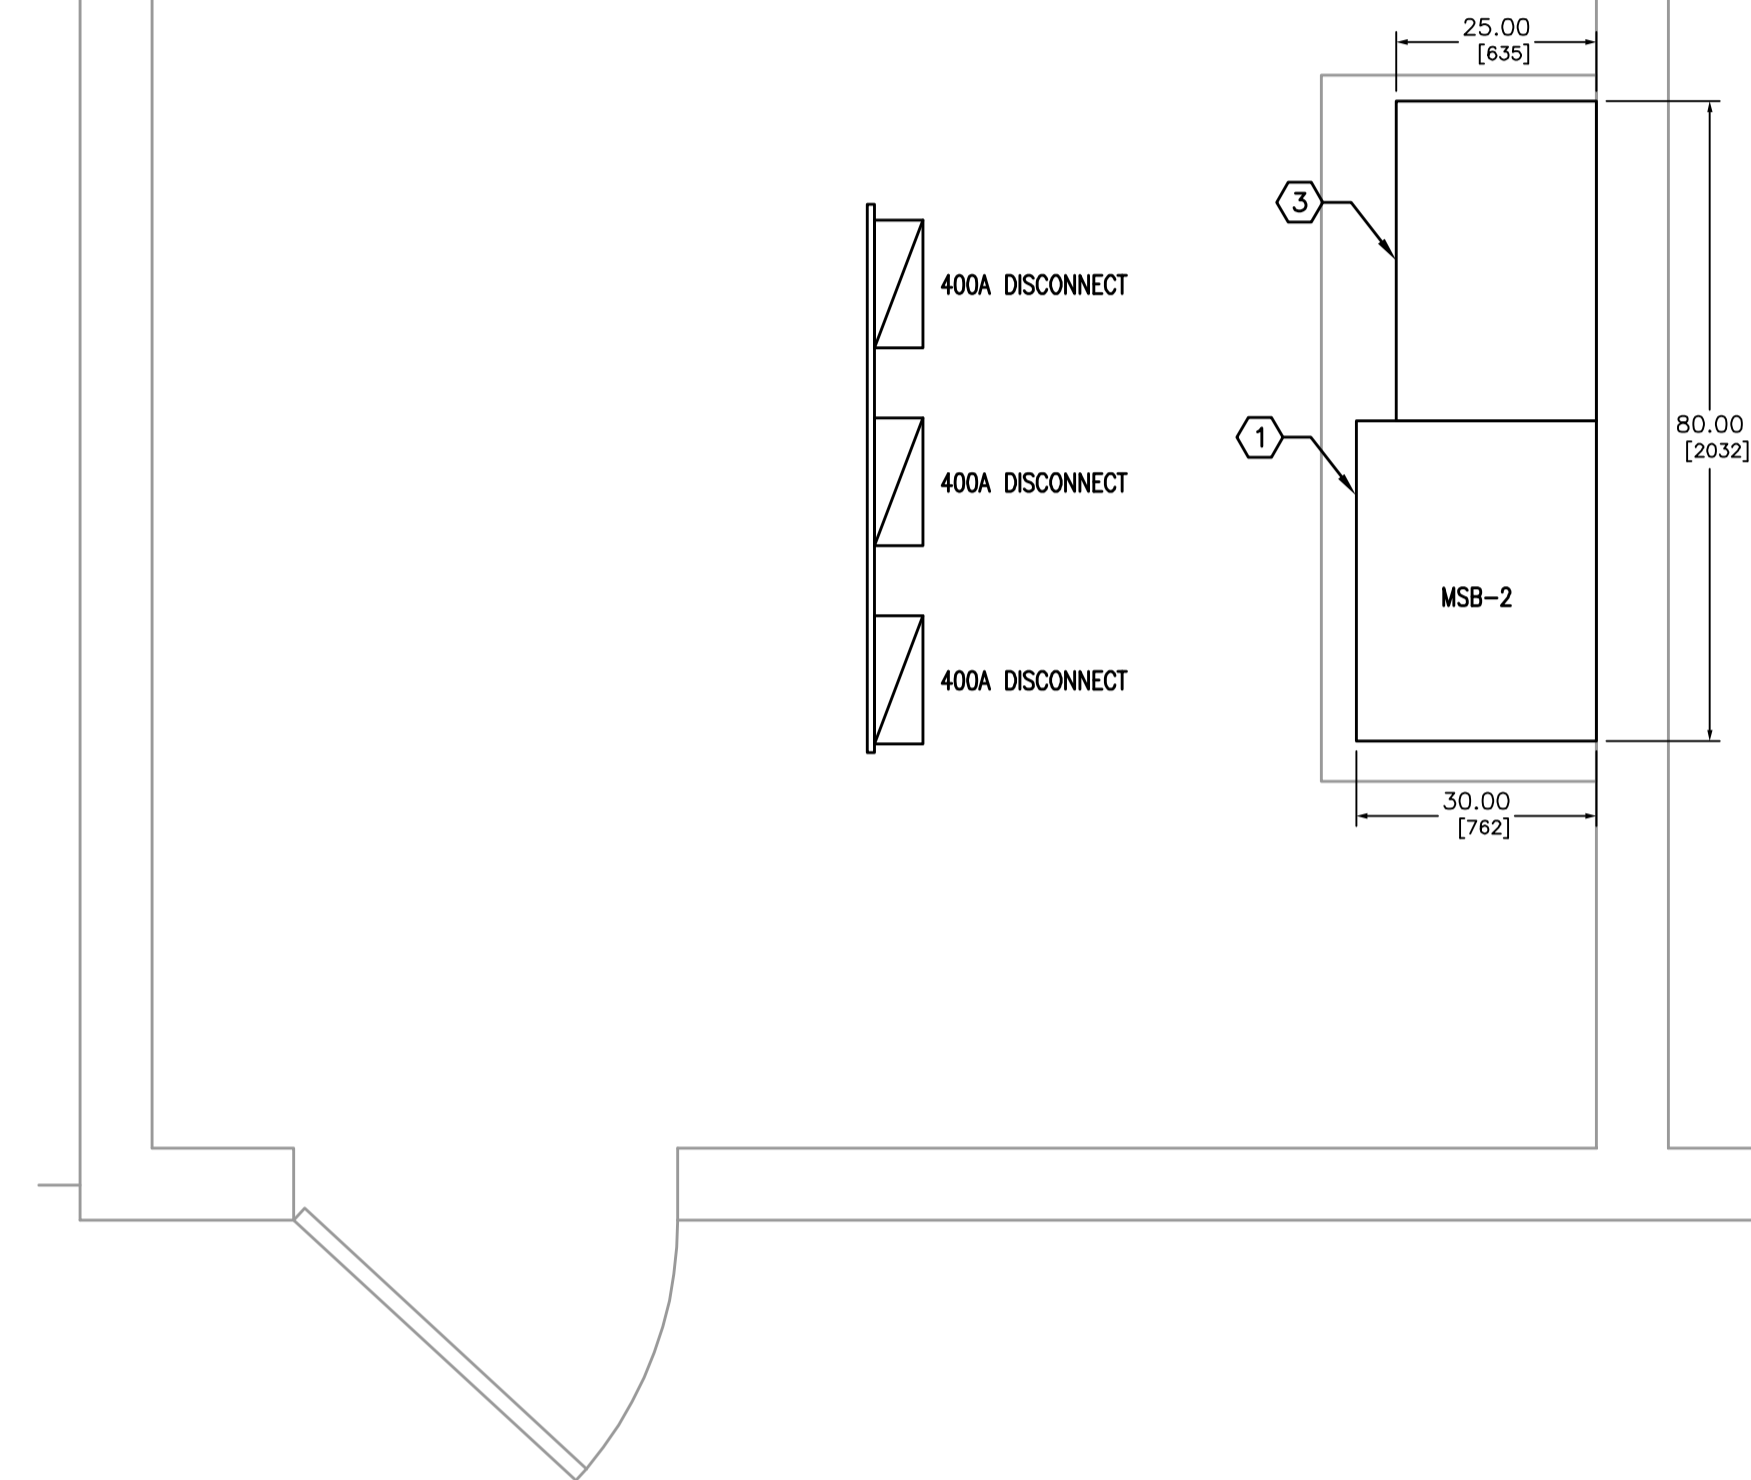
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ENLARGED PLAN - ELECTRICAL RM (RENOVATION)
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 0 1' 2' 4'



ELEVATION - MSB2 (EXISTING)
 NOT TO SCALE

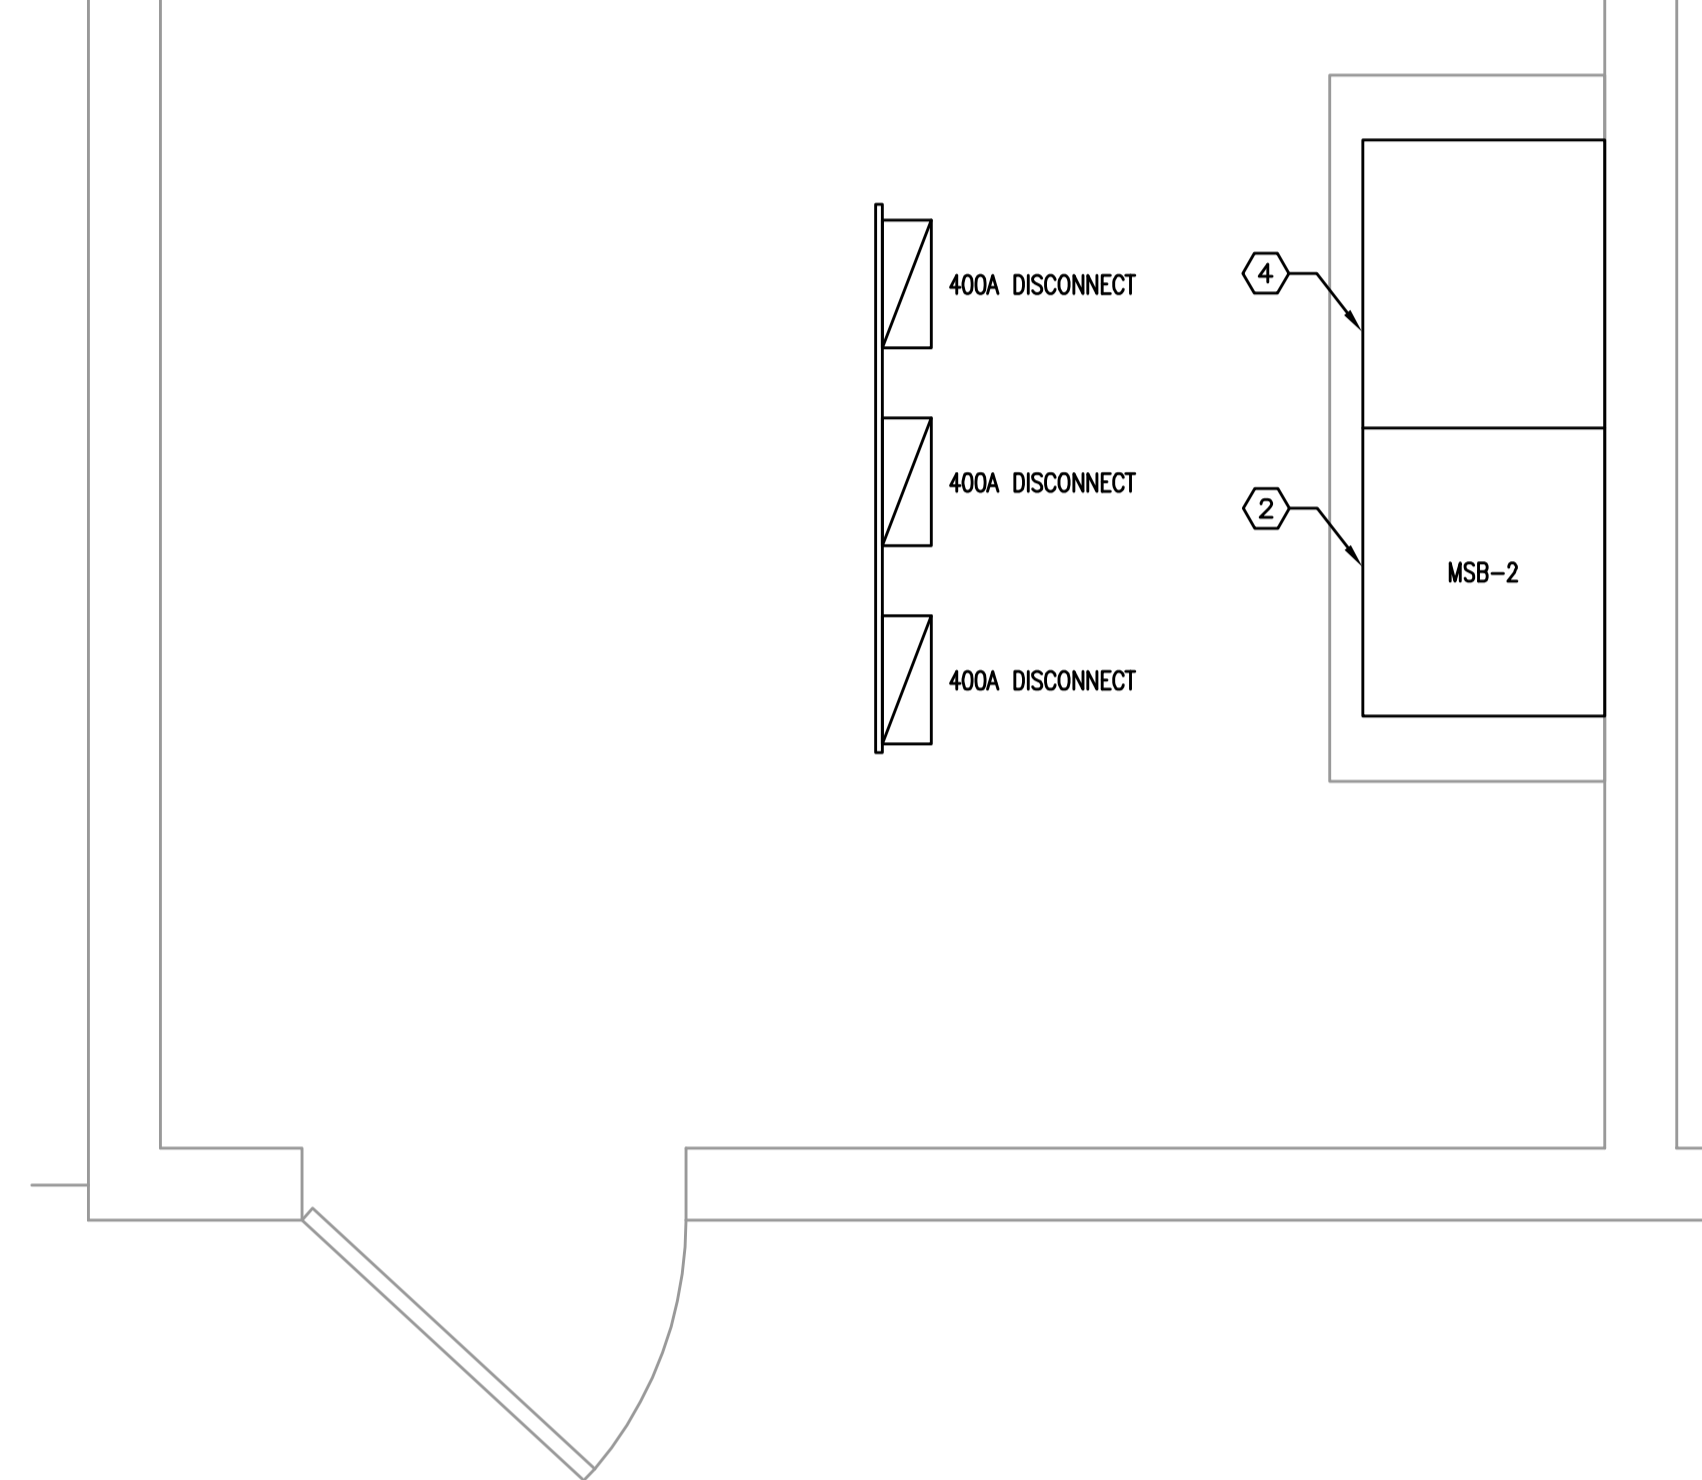


ELEVATION - MSB2 (NEW)
 NOT TO SCALE

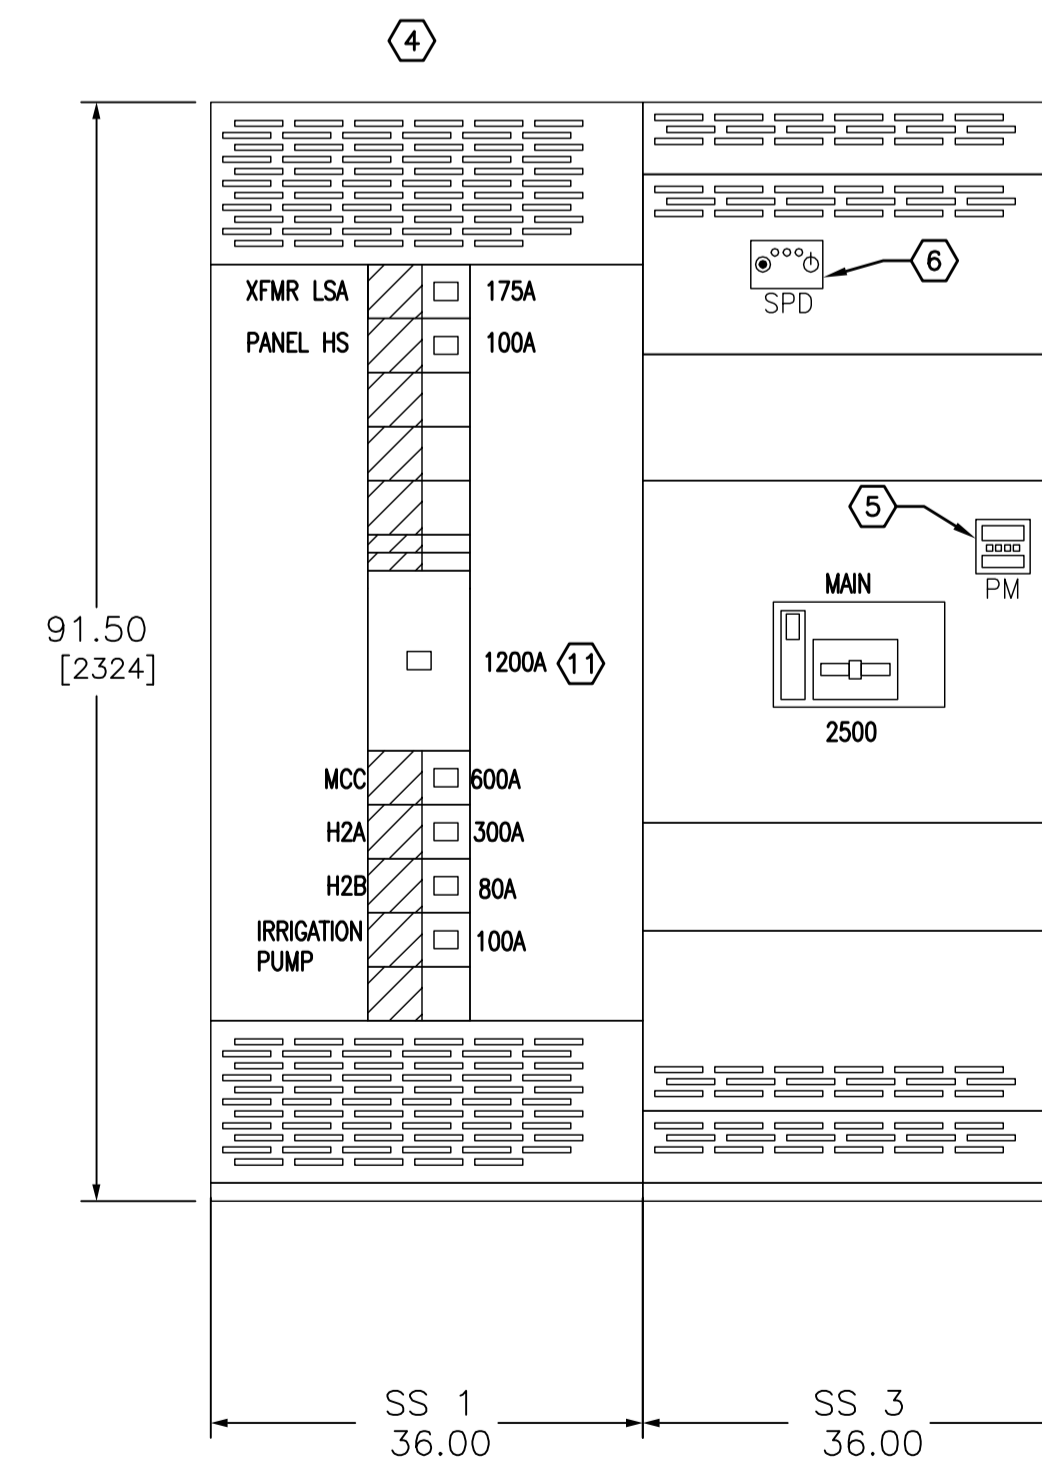GENERAL NOTES

- 1) REFER TO GENERAL NOTES FOR THIS DISCIPLINE.
- 2) REFER TO SPECIFICATIONS.
- 3) NO MULTI-WIRE BRANCH CIRCUITS ARE TO BE USED. EACH CIRCUIT IS TO HAVE SEPARATE INDIVIDUAL NEUTRAL.
- 4) ALL HEX NOTES NOT NECESSARILY USED ON ALL SHEETS.
- 5) EXISTING CONDUIT ROUTING IS UNKNOWN.
- 6) WHERE CONDUIT ROUTING IS SHOWN, THE CONDUITS ARE SHOWN FOR DIAGRAMMATIC PURPOSES AND ARE NOT NECESSARILY REPRESENTATIVE OF EXACT PLACEMENT.


HEX NOTES

- ① REMOVE EXISTING SWITCHGEAR MAIN AND PREPARE FOR RECONNECTION OF FEEDER TO NEW MSB.
- ② RECONNECT EXISTING FEEDER TO NEW MSB-1
- ③ DISCONNECT EXISTING FEEDERS AND CONDUIT AND PREPARE TO RECONNECT TO NEW MSB-1 SECTIONS.
- ④ RECONNECT EXISTING FEEDERS AND CONDUIT TO NEW BREAKERS IN NEW DISTRIBUTION SECTION. PROVIDE ALL ELECTRICAL AS REQUIRED TO FACILITATE REPLACEMENT OF DISTRIBUTION SECTIONS.
- ⑤ PROVIDE POWER MONITORING SYSTEM. PROVIDE CAT-6 HOMERUN TO TIB AS REQUIRED BY CONVENTION CENTER STAFF.
- ⑥ PROVIDE NEW SURGE PROTECTIVE DEVICE. REFER TO SPECIFICATIONS FOR ADDITIONAL REQUIREMENTS.
- ⑦ EQUIPMENT TO BE RELOCATED. SEE RENOVATION PLAN.
- ⑧ NEW LOCATION OF RELOCATED EQUIPMENT.
- ⑨ SPARE BREAKER. EQUIPMENT NO LONGER IN USE.
- ⑩ CIRCUIT BREAKER CURRENTLY FEEDING THREE (3) 400A DISCONNECTS FOR SITE LIGHTING.
- ⑪ NEW CIRCUIT BREAKER TO RE-FEED EXISTING (3) 400A DISCONNECTS.

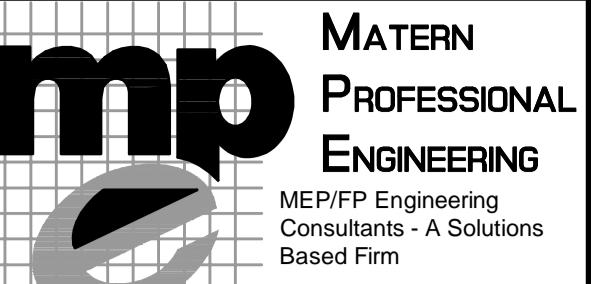

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OCCC WEST BUILDING PHASE I - ELECTRICAL POWER UPGRADES

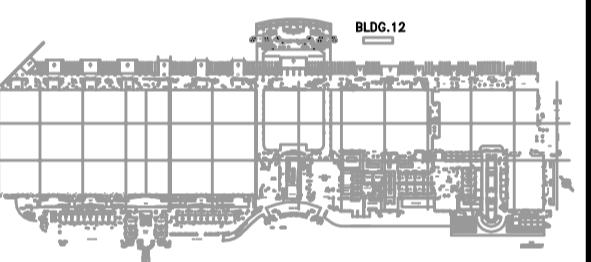

Key Plan - West

Revisions

No.	Date	Description

MPE PROJ#: 2012-188B


Designed By: RB
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 Checked By: CT
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 Drawing Scale: 1/8"=1'-0"

Drawing Title:
ENLARGED ROOM PLAN & EQUIPMENT ELEVATIONS

BID DOCUMENTS
 Drawing No.

E2.4.03

OCCC WEST BUILDING PHASE I - ELECTRICAL POWER UPGRADES

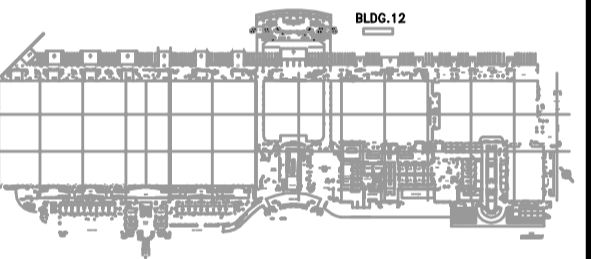

Key Plan - West

Revisions

No.	Date	Description

MPE PROJ#: 2012-188B

Designed By: RB

Drawn By: AG/RB

Checked By: CT

Issue Date: MAY 7, 2013

Drawing Scale: NTS

Drawing Title:
ELECTRICAL SCHEDULES

BID DOCUMENTS

Drawing No.

E2.5.01

FEEDER SCHEDULE: OCCC Phase I MEP Upgrades		DATE:	3/4/2013	COPYRIGHT: ME, LLC 2009	VERSION: A3d	REV: Jan 11, 2012							
FEEDER FEEDING	OCF AMP SIZE	VOLTS	FEEDER AMPACITY	FEEDER VOLTAGE DROP (%)	WIRE/PHASE	NEUTRAL WIRE	GROUND WIRE	EXTRA NEUTRAL	FEEDER MATERIAL	PARALLEL RUNS	CONDUIT SIZE (IN)	SHORT CIRCUIT AMPS AT PANEL	ERROR CODE
MSB 30	3000	480	3325	0.50%	#750 KCMIL	#750 KCMIL	----		COPPER	7	4		
MSB 31	4000	480	4275	0.52%	#750 KCMIL	#750 KCMIL	----		COPPER	9	4		

NOTES:
 1) CONDUIT SIZE IS BASED ON 2008 N.E.C. FOR EMT, IMC, RMC, FLEXIBLE METAL AND SCHED 40 PVC. IF ANY OTHER TYPE OF CONDUIT/TUBING IS USED, THE CONTRACTOR SHALL RESIZE CONDUIT AND SIZE AS REQUIRED TO COMPLY WITH THE N.E.C.
 2) USE CABLE REDUCERS AT TERMINATIONS AS REQUIRED TO COORDINATE OVERSIZED PHASE OR NEUTRAL CONDUCTORS WITH TERMINATION LUG SIZE OR PROVIDE TERMINATION LUGS SIZED FOR FEEDERS.
 3) CONTRACTOR IS TO MEGGER TEST ALL FEEDERS PER SPECIFICATIONS.

SECTION I WITH MAINS	COPYRIGHT ME, LLC 06/01/03	VERSION: B2	REVISED: 10/18/12	WIDTH: 42.0	DEPTH: 36.0
VOLTS LN: 277	SWITCHBOARD: MSB 30	EXISTING: NO			
VOLTS PH: 480	MLQ(™):				
PHASE: 3	MCB: 3000	NEMA 3R:			
MOUNTING: SURFACE	SHTRIP: YES	DRAWOUT SWBD: YES			
TYPE: GED-2	GFP: YES	FRONT ACCESS: YES			
MFR: SQ D					

GENERAL NOTES:
 (1) ALL C.B.'S FEEDING HVAC EQUIPMENT TO BE HACR TYPE.
 (2) ALL C.B.'S FEEDING ELEV EQUIP TO BE SHUNT TRIP TYPE.
 (3) ALL C.B.'S FEEDING ELEV EQUIP TO BE SIZED AS RECD BY MFR.
 (4) ALL C.B.'S FEEDING HID LTG TO BE HID RATED.
 (5) NO MULTIWIRE BRANCH CKTS ARE ALLOWED
 (6) NOT USED.
 (7) SECTION I TO INCLUDE MCB/MLO AND METERS

NOTES AND REFERENCE NOTES:
 MFR = SIZE CB PER MFR. RECOMMENDATIONS.
 \$ = NEW CB IN EXIST SPACE
 & = REPLACE EXIST CB WITH NEW
 SH = SHUNT TRIP C.B.
 AF = ARC FAULT CB

OPTIONAL CALC: NO
 ACTUAL CONN LOAD: KVA AMP
 DEMAND: KVA AMP
 TOTAL AMPS C PH: KVA AMP
 TRANSFORMER SIZE: KVA AMP
 ERROR CODE

DESCRIPTION	CONN	TYPE	AMPS	AMPS	AMPS	C.B. AMPS	C.B. POLE	REF NOTE	CKT. NO.	CKT. NO.	REF NOTE	C.B. POLE	C.B. AMPS	AMPS	AMPS	AMPS	DESCRIPTION	CONN	TYPE	
FUTURE PANEL: DL3H	14.0					400	3		1	2										
	14.0								3	4										
FUTURE PANEL: DL3J	14.0					400	3		5	6										
	14.0								7	8										
	14.0								9	10										
FUTURE PANEL: DL3K	14.0					400	3		11	12										
	14.0								13	14										
	14.0								15	16										
	14.0								17	18										
SPACE							3		19	20										
									21	22										
SPACE							3		23	24										
									25	26										
									27	28										
SPACE							3		29	30										
									31	32										
									33	34										
SPACE							3		35	36										
									37	38										
									39	40										
									41	42										

SECTION I WITH MAINS	COPYRIGHT ME, LLC 06/01/03	VERSION: B2	REVISED: 10/18/12	WIDTH: 44.0	DEPTH: 60.0
VOLTS LN: 277	SWITCHBOARD: MSB 31	EXISTING: NO			
VOLTS PH: 480	MLQ(™):				
PHASE: 3	MCB: 4000	NEMA 3R: YES			
MOUNTING: SURFACE	SHTRIP: YES	DRAWOUT SWBD: YES			
TYPE: GED-2	GFP: YES	FRONT ACCESS: YES			
MFR: SQ D					

GENERAL NOTES:
 (1) ALL C.B.'S FEEDING HVAC EQUIPMENT TO BE HACR TYPE.
 (2) ALL C.B.'S FEEDING ELEV EQUIP TO BE SHUNT TRIP TYPE.
 (3) ALL C.B.'S FEEDING ELEV EQUIP TO BE SIZED AS RECD BY MFR.
 (4) ALL C.B.'S FEEDING HID LTG TO BE HID RATED.
 (5) NO MULTIWIRE BRANCH CKTS ARE ALLOWED
 (6) NOT USED.
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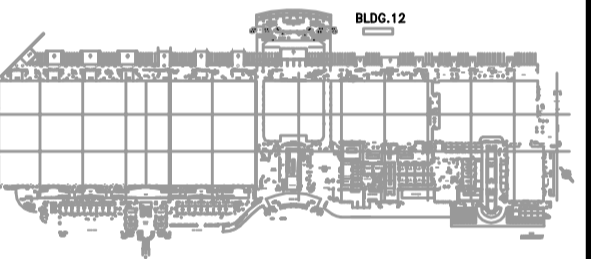
NOTES AND REFERENCE NOTES:
 MFR = SIZE CB PER MFR. RECOMMENDATIONS.
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 AF = ARC FAULT CB

OPTIONAL CALC: NO
 ACTUAL CONN LOAD: KVA AMP
 DEMAND: KVA AMP
 TOTAL AMPS C PH: KVA AMP
 TRANSFORMER SIZE: KVA AMP
 ERROR CODE

DESCRIPTION	CONN	TYPE	AMPS	AMPS	AMPS	C.B. AMPS	C.B. POLE	REF NOTE	CKT. NO.	CKT. NO.	REF NOTE	C.B. POLE	C.B. AMPS	AMPS	AMPS	AMPS	DESCRIPTION	CONN	TYPE	
FUTURE PANEL: DP3H	14.0					1200	3		1	2										
	14.0								3	4										
FUTURE PANEL: DP3J	14.0					1200	3		5	6										
	14.0								7	8										
	14.0								9	10										
FUTURE PANEL: DP3K	14.0					1200	3		11	12										
	14.0								13	14										
	14.0								15	16										
	14.0								17	18										
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OCCC WEST BUILDING PHASE I - ELECTRICAL POWER UPGRADES



Key Plan - West

Revisions


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Drawn By:	AG/RB
Checked By:	CT
Issue Date:	MAY 7, 2013
Drawing Scale:	1/8"=1'-0"

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 BID DOCUMENTS


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OCCC WEST BUILDING PHASE I - ELECTRICAL POWER UPGRADES




Revisions

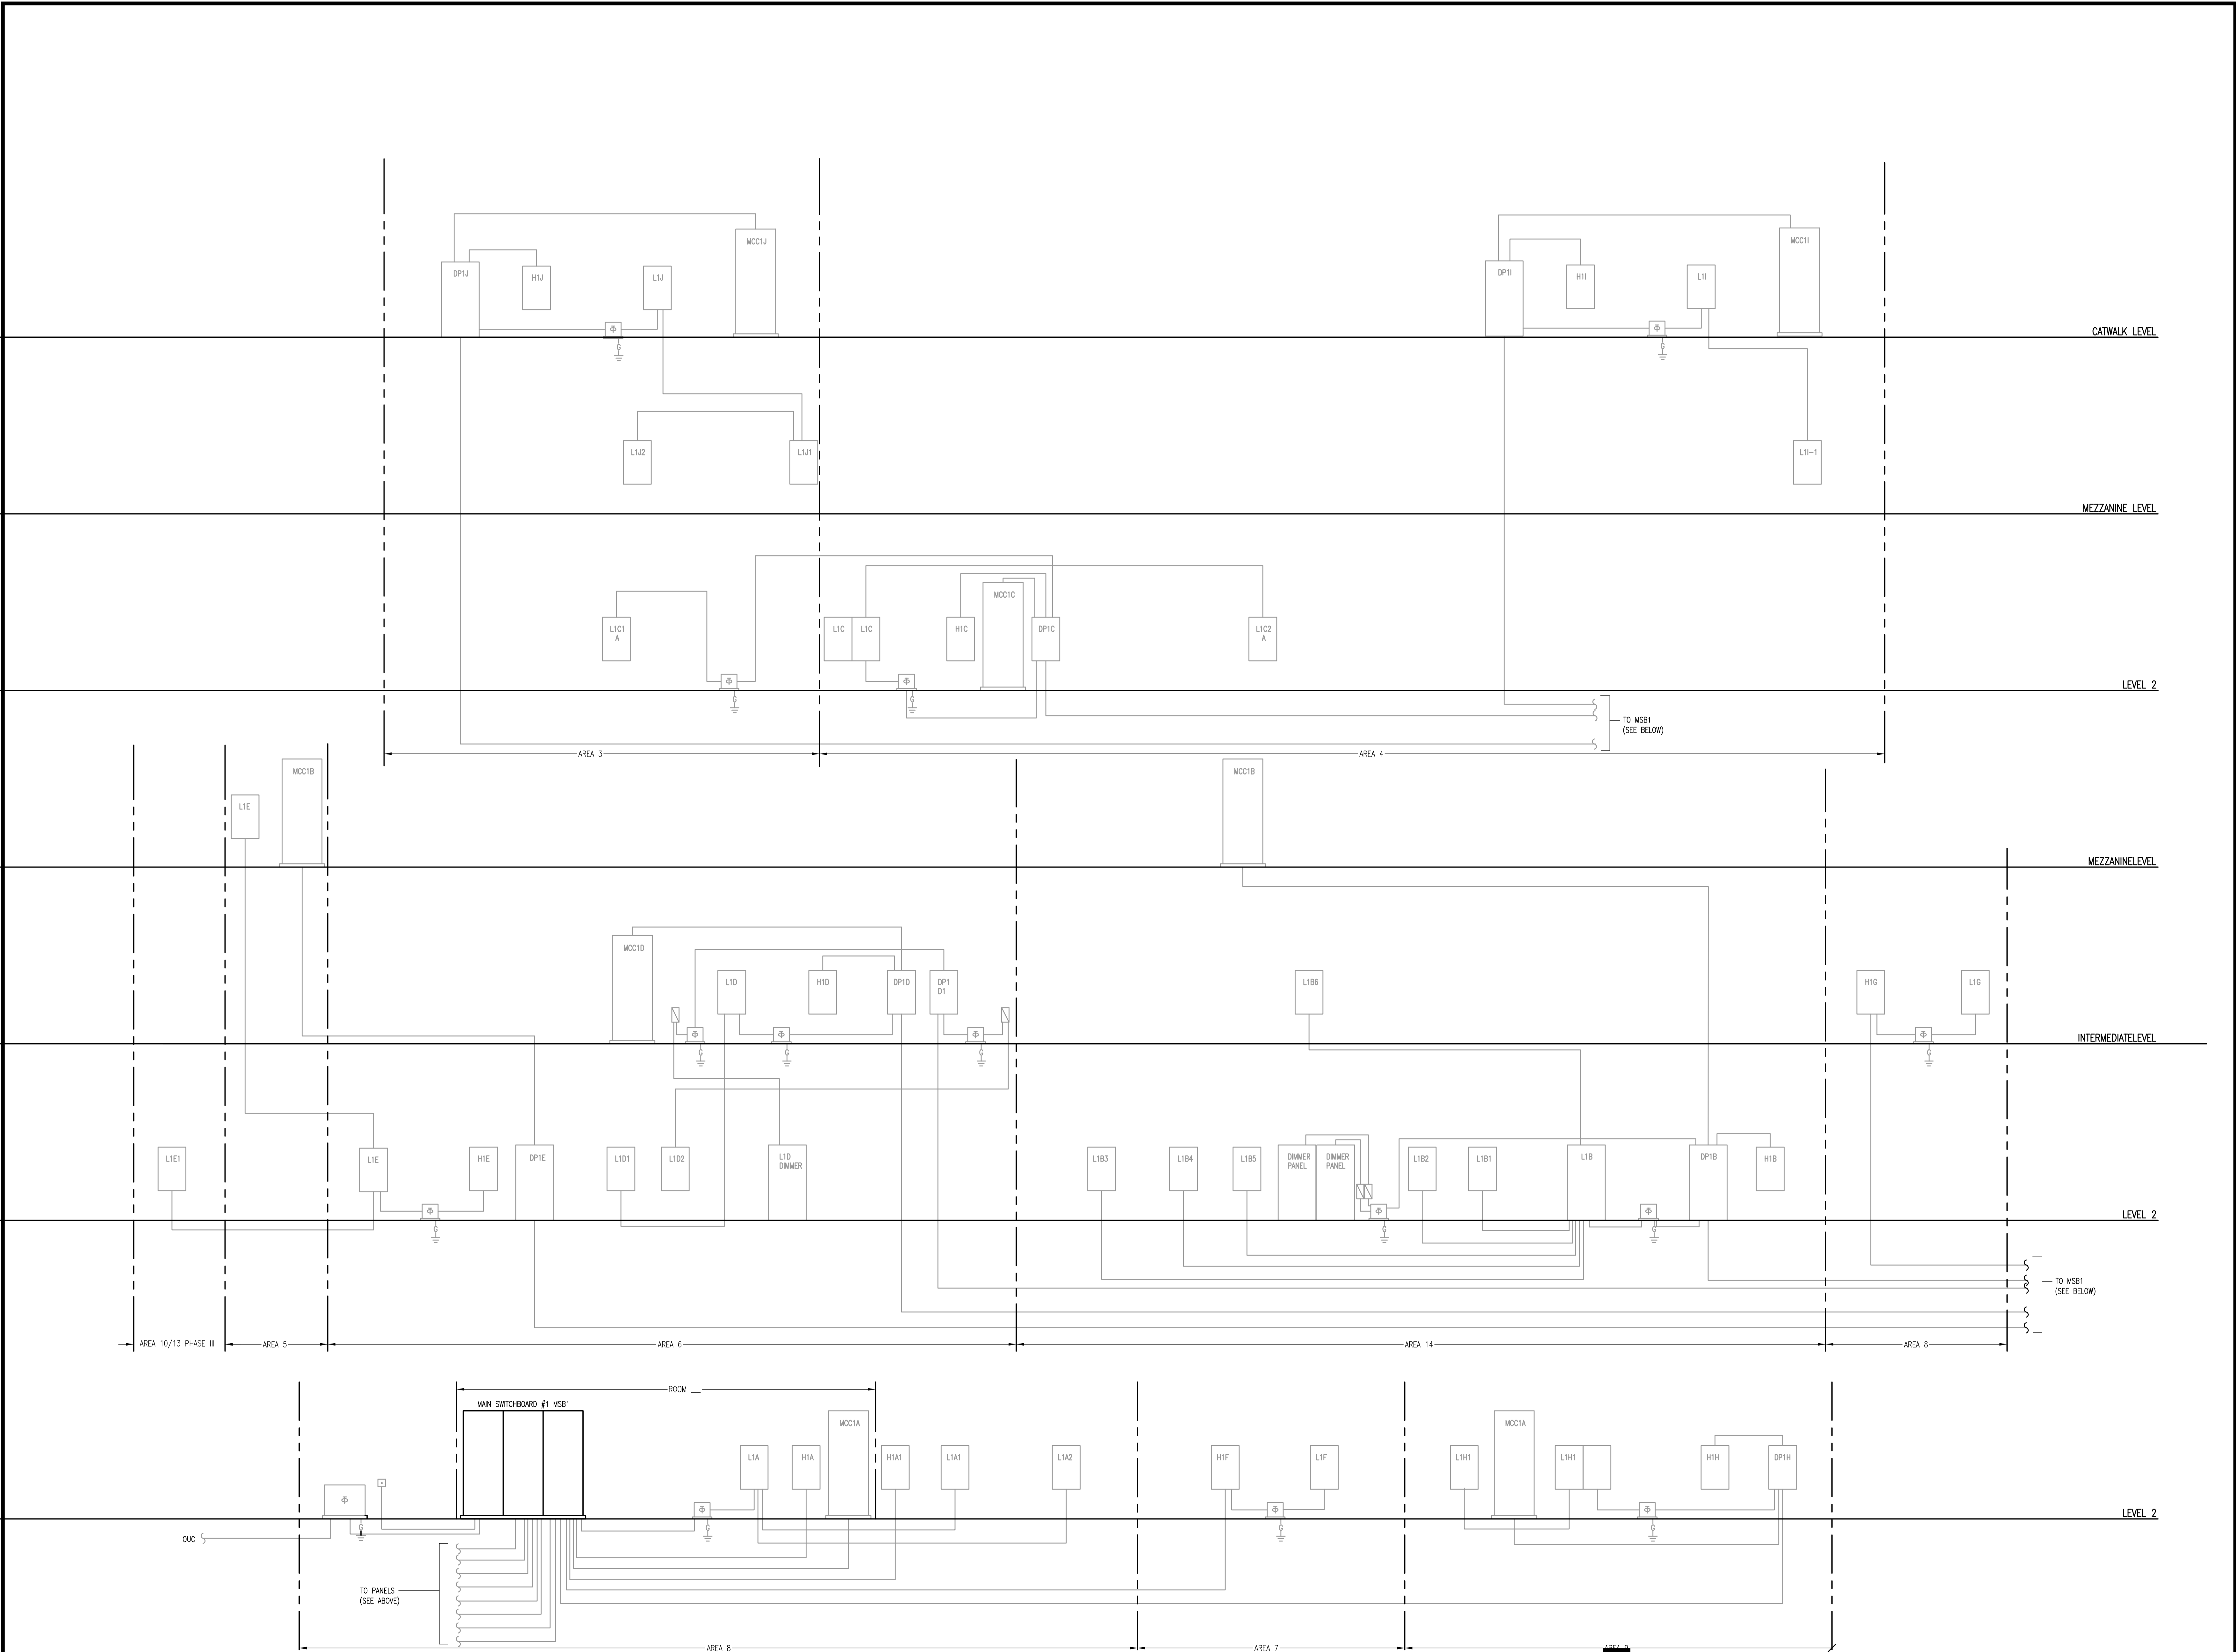No.	Date	Description

MPE PROJ#: 2012-188B
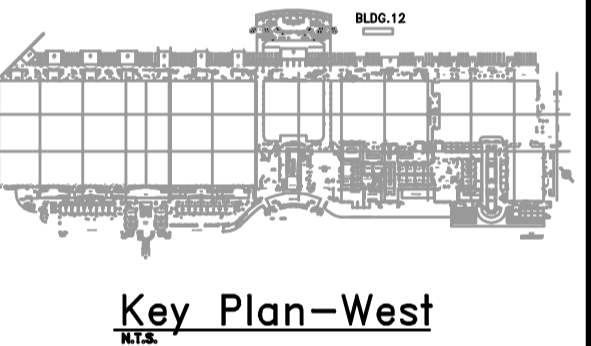
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Drawn By:	AG/RB
Checked By:	CT
Issue Date:	MAY 7, 2013
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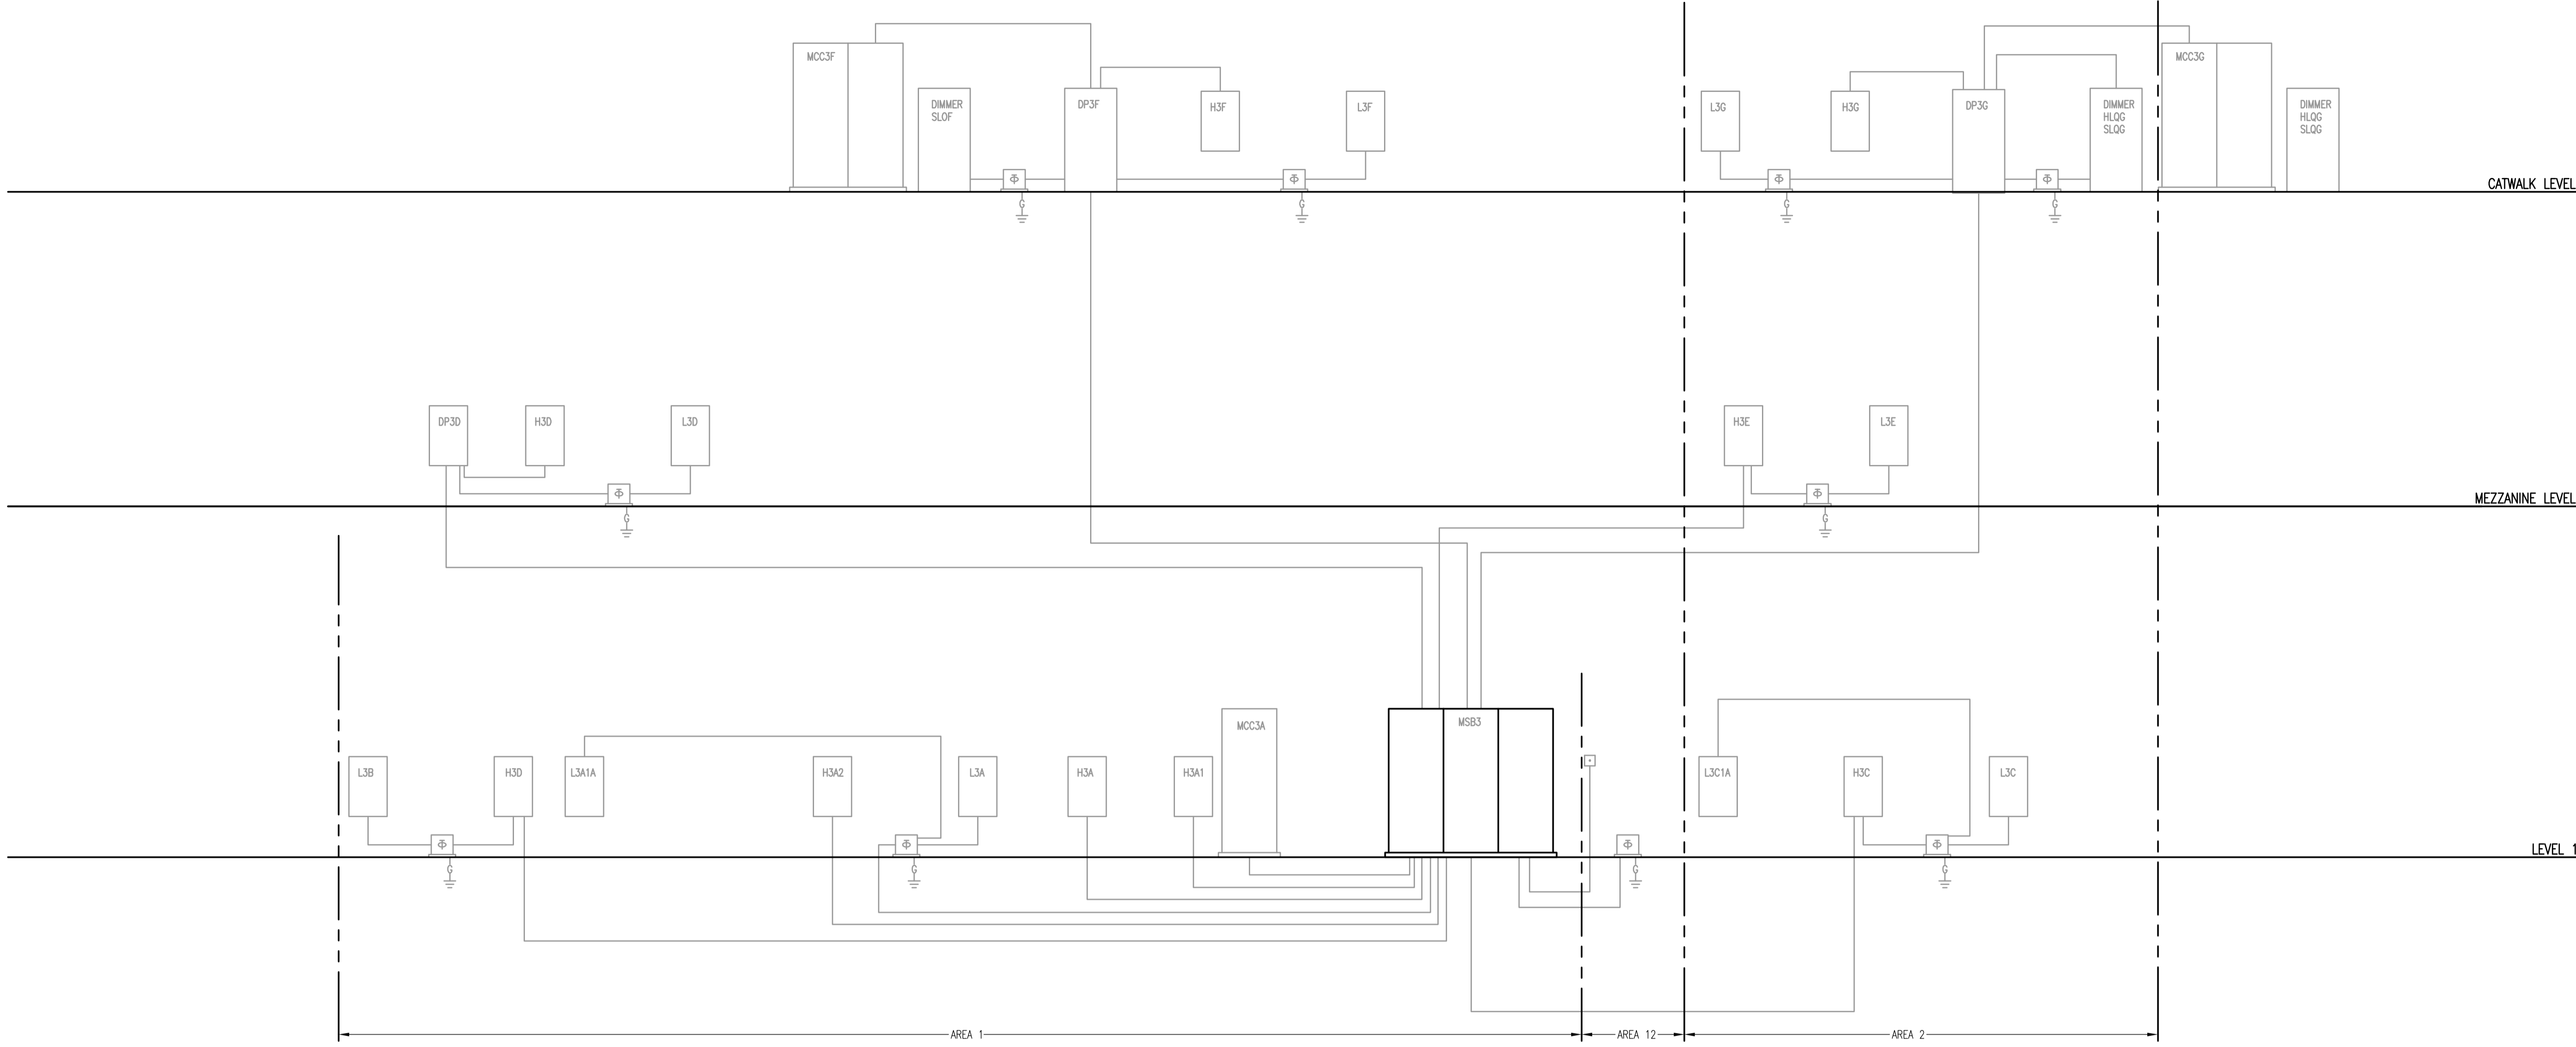
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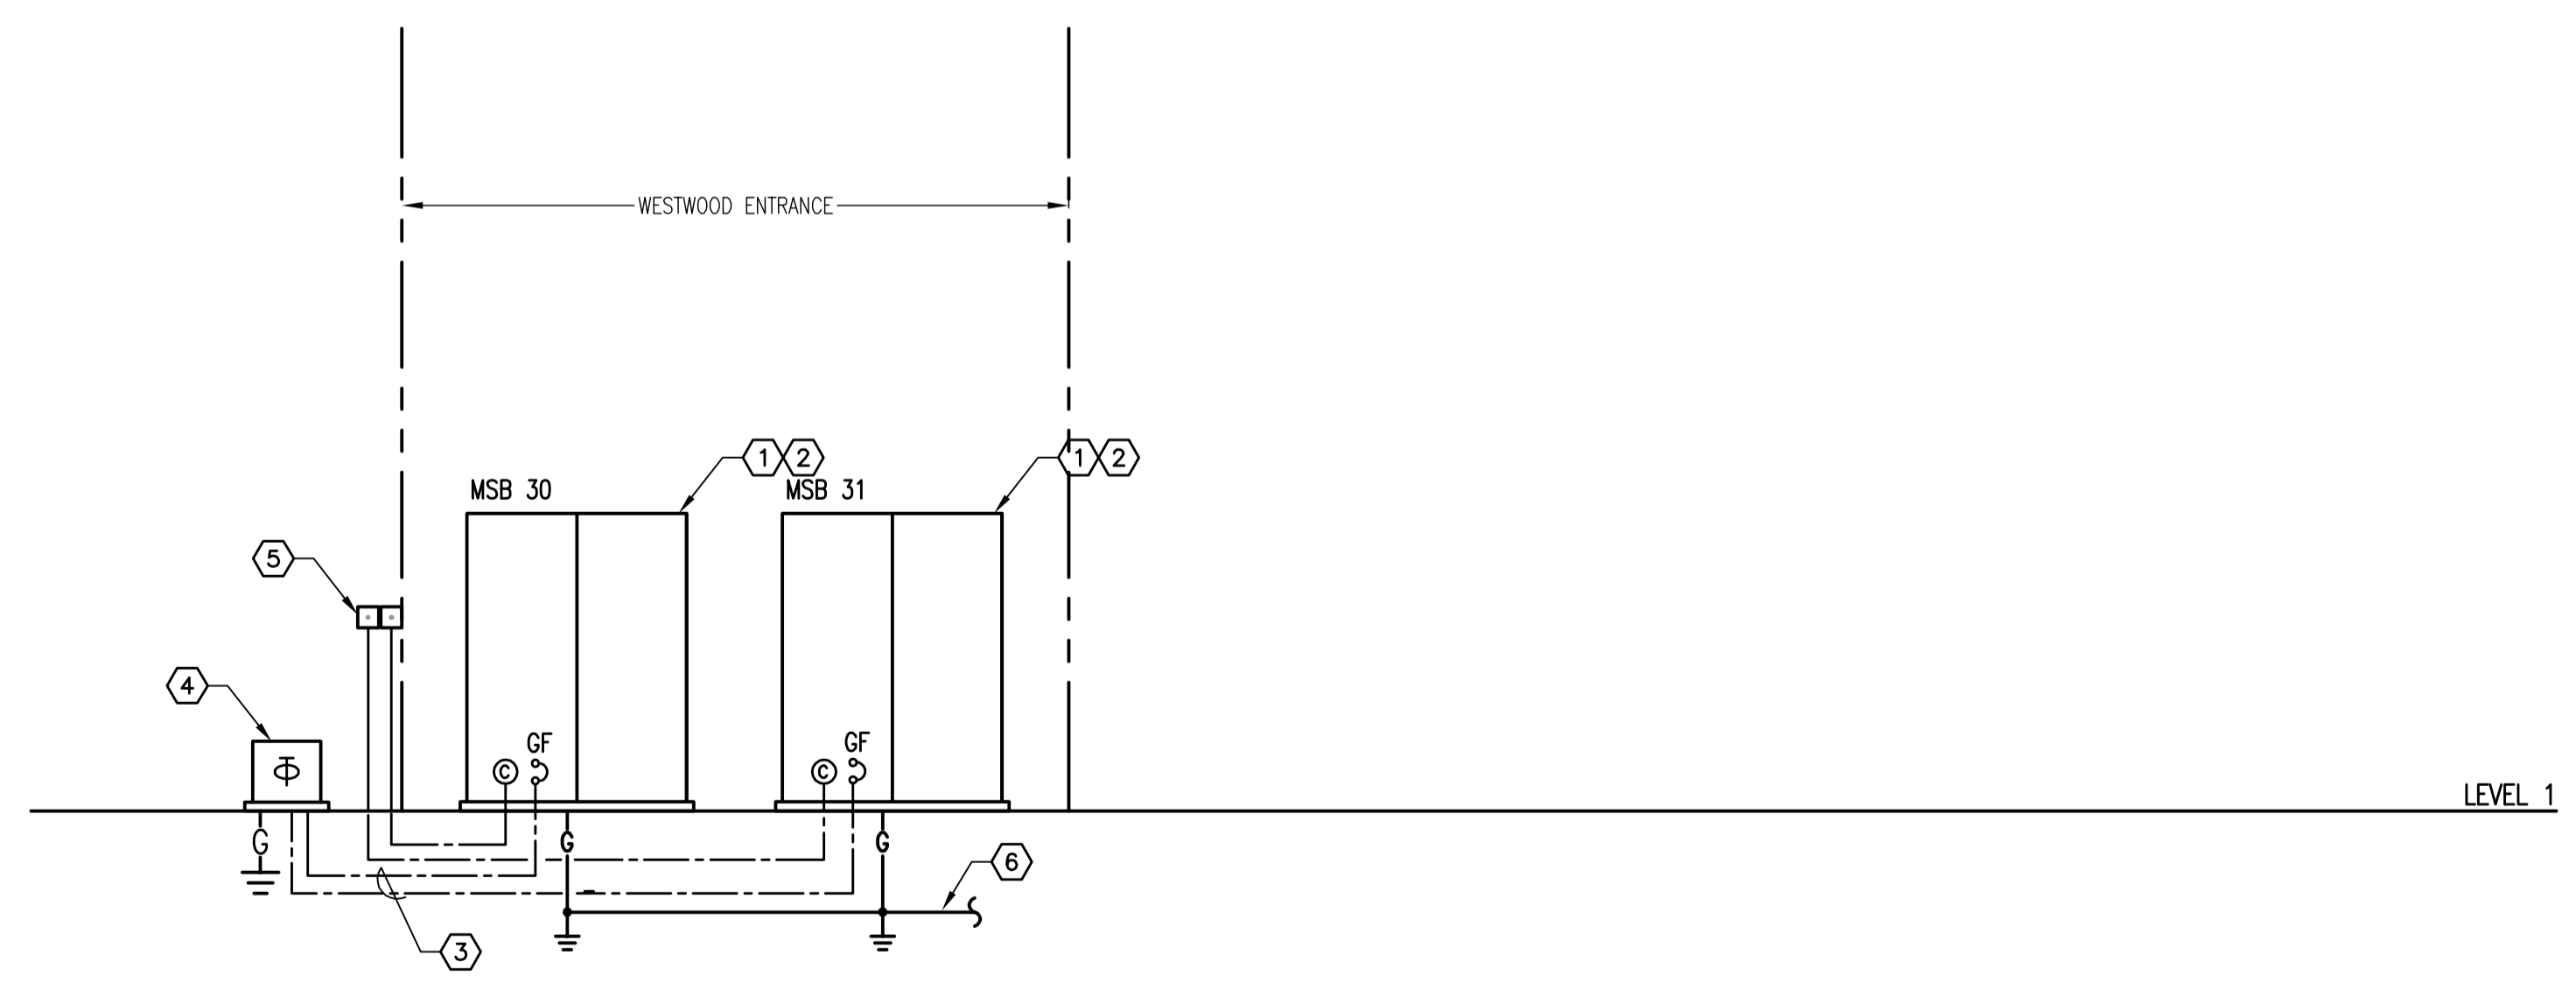
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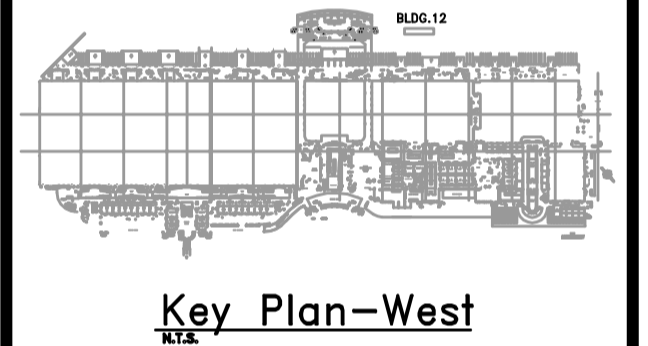


POWER RISER DIAGRAM NEW SERVICES
NOT TO SCALE

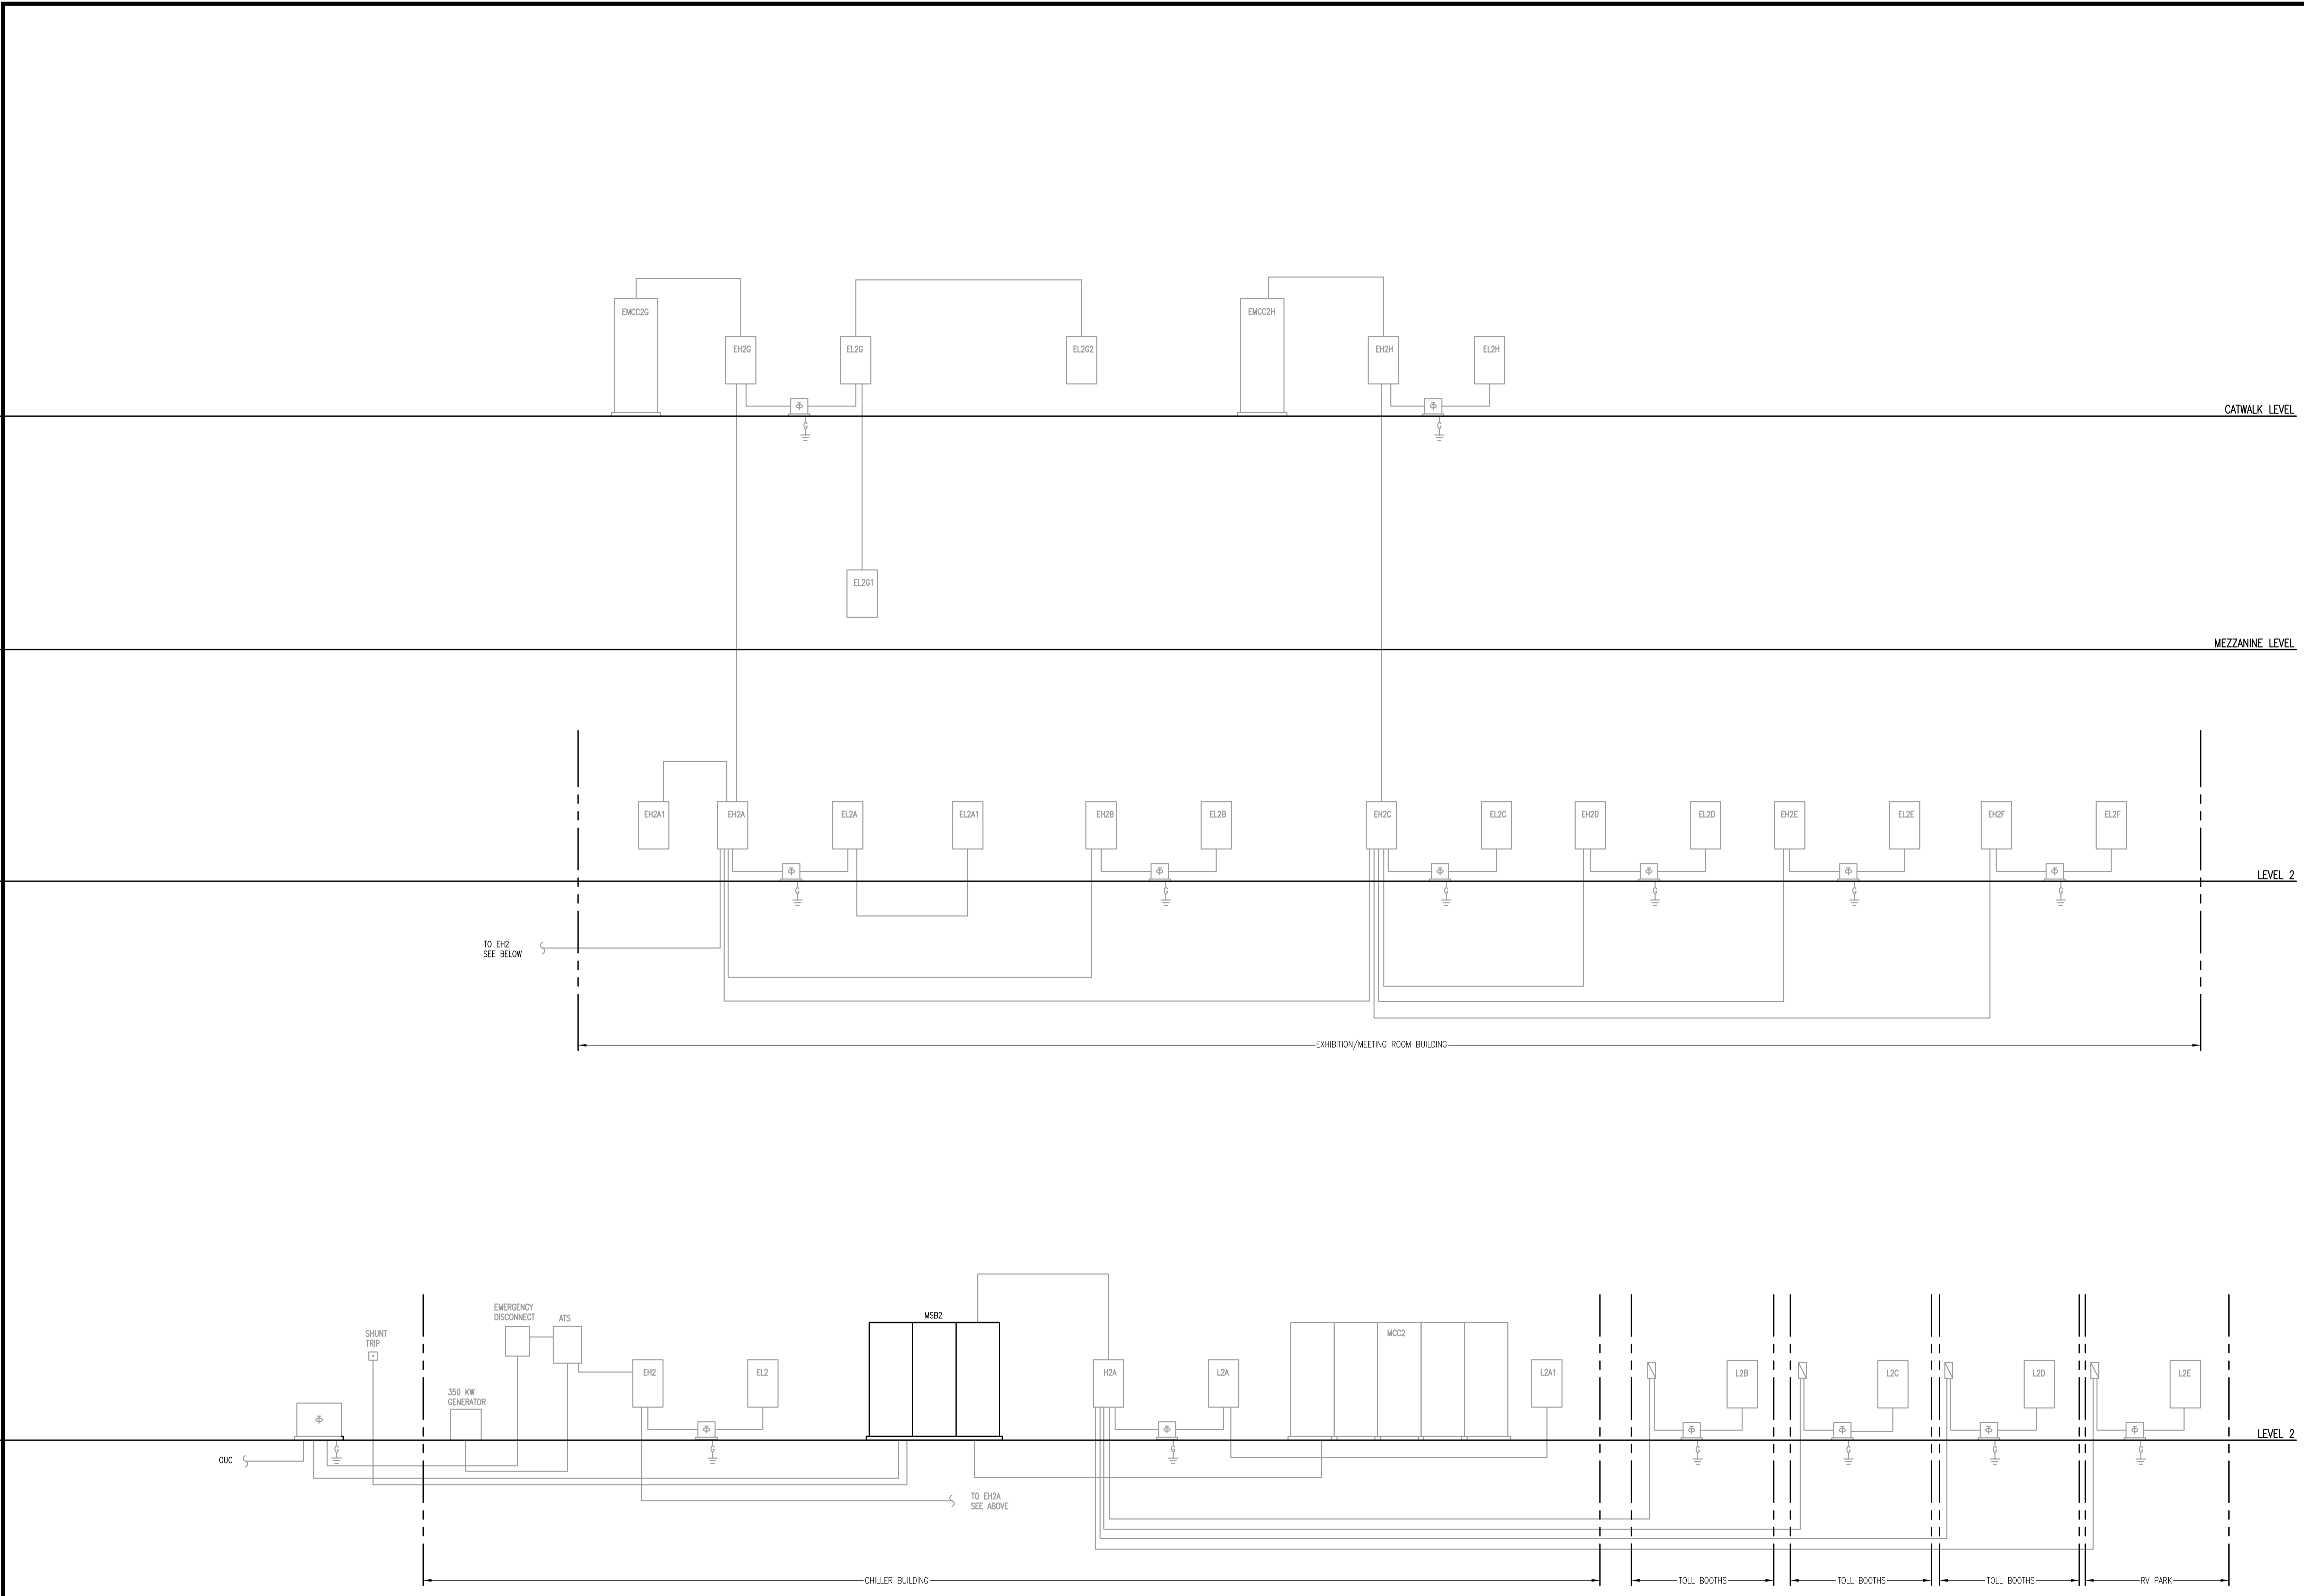- GENERAL NOTES**
- 1) REFER TO GENERAL NOTES FOR THIS DISCIPLINE.
 - 2) REFER TO SPECIFICATIONS.
 - 3) NO MULTI-WIRE BRANCH CIRCUITS ARE TO BE USED. EACH CIRCUIT IS TO HAVE SEPARATE INDIVIDUAL NEUTRAL.
 - 4) REWORK/RELOCATE EXISTING ELECTRICAL AS REQUIRED TO FACILITATE REMODELING.
 - 5) CONTRACTOR SHALL MAINTAIN CONTINUITY TO EXISTING DEVICES REMAINING.
 - 6) ALL DISCONNECTING MEANS (SWITCHES) FEEDING FAN TERMINAL BOXES SHALL BE MOTOR RATED SWITCHES.

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OCCC WEST BUILDING PHASE I - ELECTRICAL POWER UPGRADES



Revisions


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- HEX NOTES**
- 1) OWNER-DIRECT PURCHASED SWITCHGEAR WITH NEMA 3R ENCLOSURE. CONTRACTOR SHALL COORDINATE DELIVERY AND PROVIDE ALL ELECTRICAL AS REQUIRED FOR INSTALLATION.
 - 2) REFER TO PANEL SCHEDULES
 - 3) REFER TO FEEDER SCHEDULES
 - 4) NEW PROGRESS ENERGY TRANSFORMER FED FROM PRIMARY METERED SOURCE. COORDINATE ALL REQUIREMENTS WITH PROGRESS ENERGY PRIOR TO BID.
 - 5) SHUNT TRIP BUTTON FOR NORMAL POWER SERVICE. LABEL "MAIN POWER SHUT OFF MSB 30" OR MSB 31". FEEDING CATWALK PHASE 1"
 - 6) PROVIDE 3/0 COPPER COMMON GROUNDING ELECTRODE CONDUCTOR TO SAME COMMON GROUNDING ELECTRODES AS OTHER 29 SERVICES PER NEC 250.58


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 Checked By: CT
 Issue Date: MAY 7, 2013
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 Drawing Title:
POWER RISER DIAGRAM
 BID DOCUMENTS
 Drawing No.
E5.2.03

OCCC WEST BUILDING PHASE I - ELECTRICAL POWER UPGRADES

- CIRCLE NOTES**
- ① ARRANGEMENT FOR MULTIPLE SEPARATELY DERIVED SYSTEM MAY BE MODIFIED FOR THE GROUNDING ELECTRODE CONDUCTOR AS ALLOWED BY NEC 250.30 (A) (4), USING TAPS FROM COMMON CONDUCTOR. CONTRACTOR TO SUBMIT WIRING DIAGRAM FOR APPROVAL.
 - ② 2/0 INSULATED COPPER GROUND TIED TO CAMPUS GROUNDING LOOP

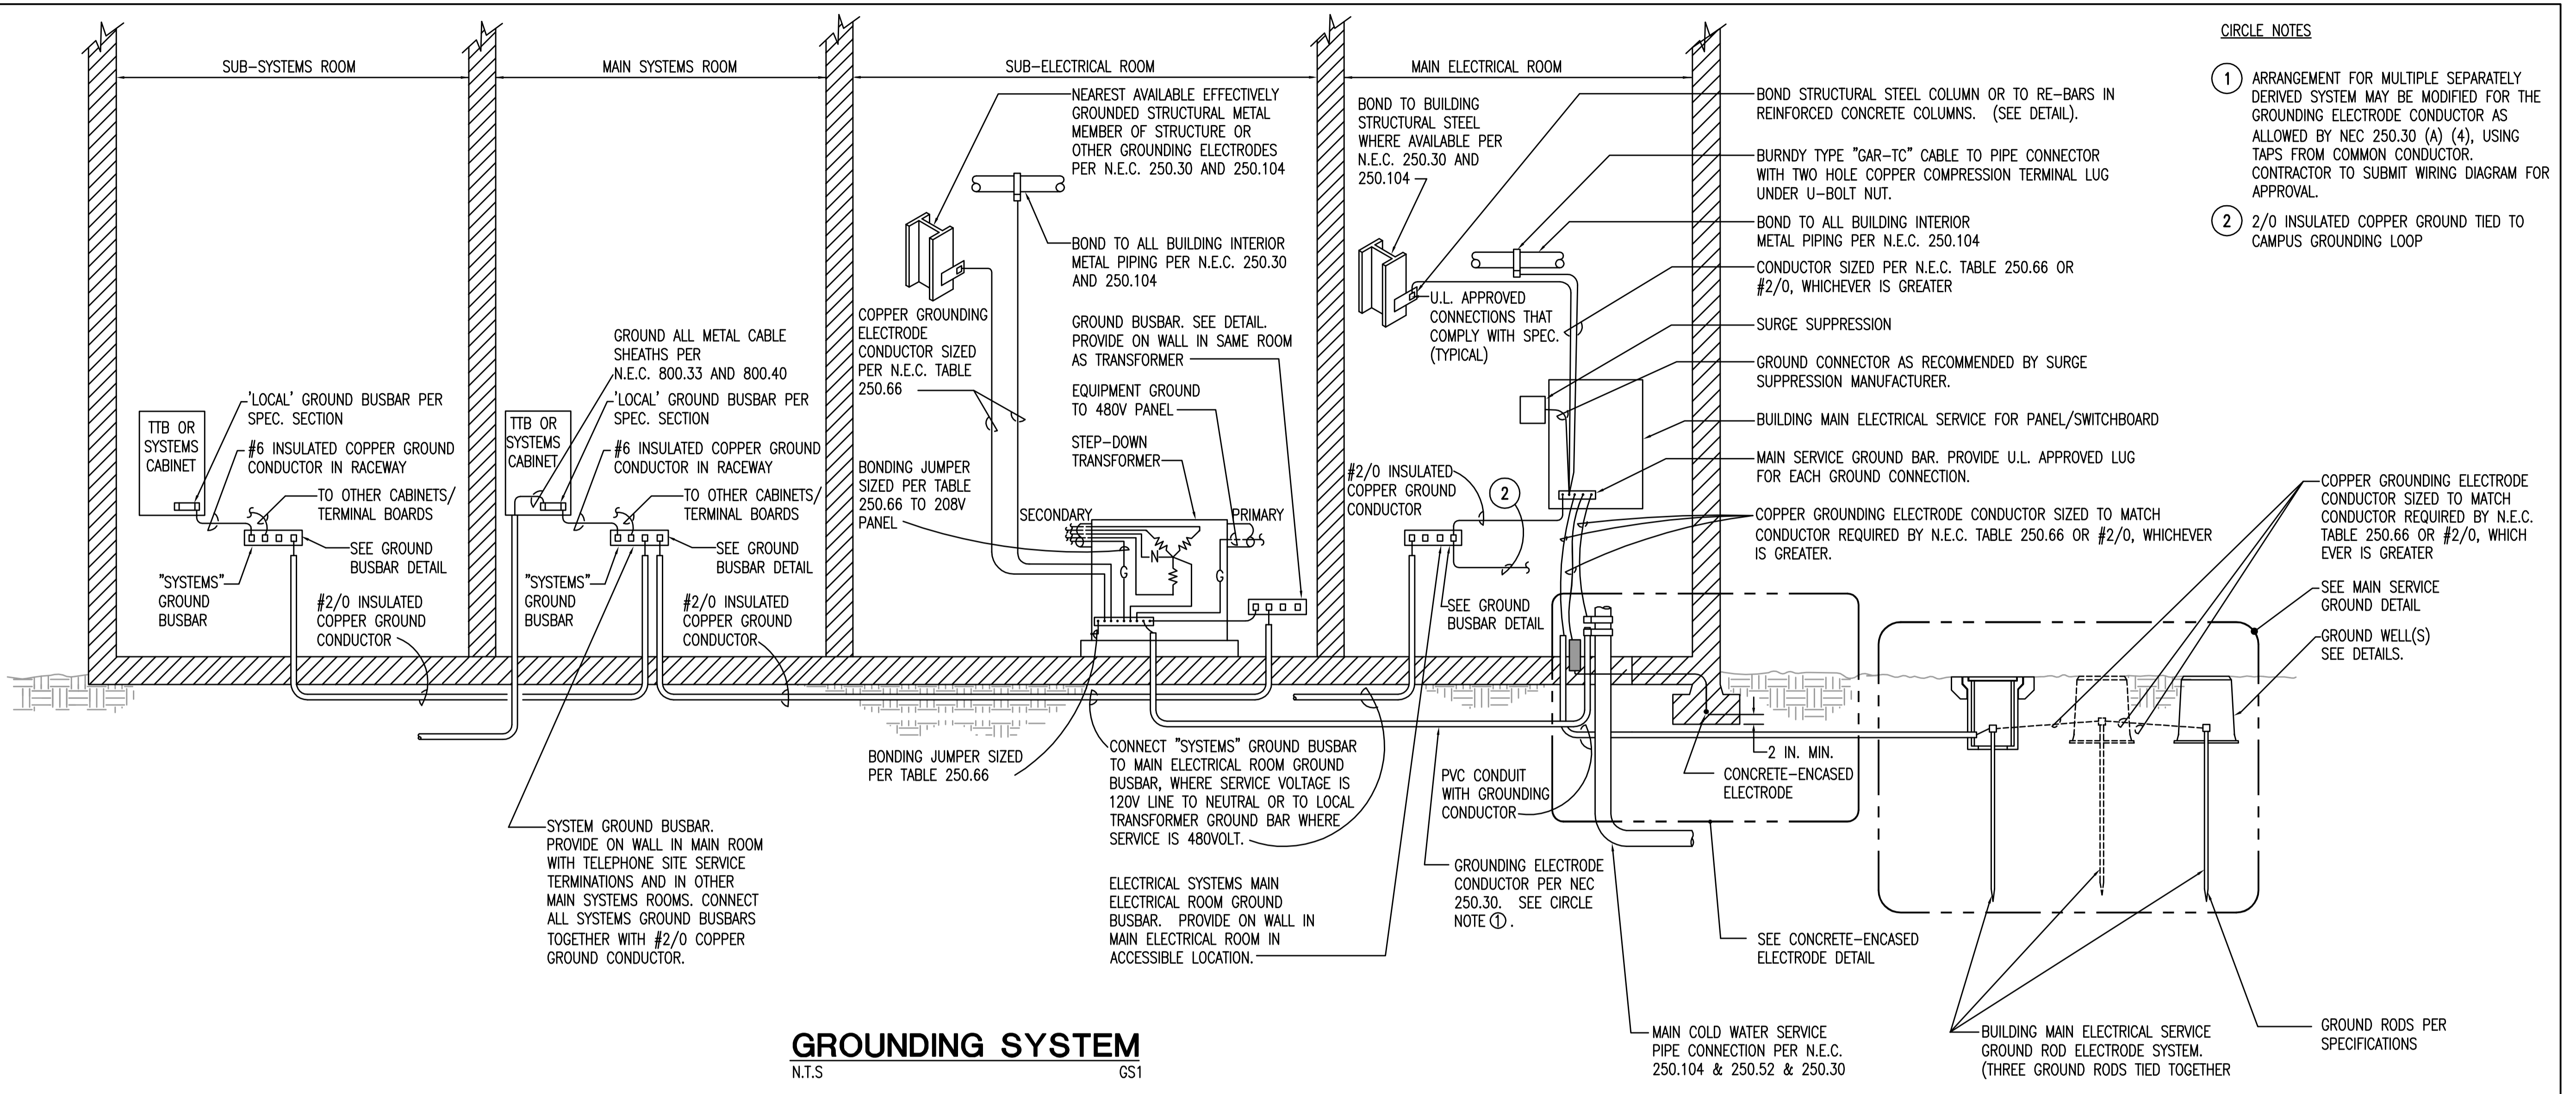

GROUNDING SYSTEM
 N.T.S. GS1

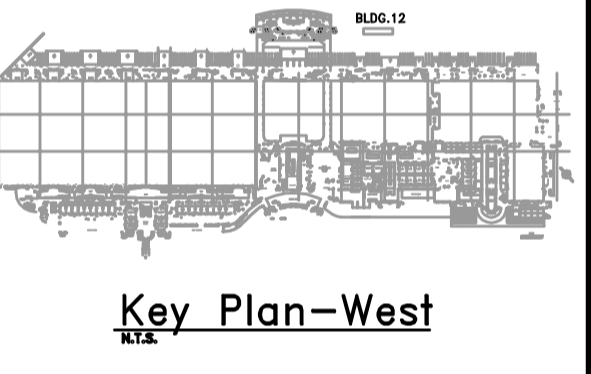

Revisions

No.	Date	Description

MPE PROJ#: 2012-188B

Designed By: RB
 Drawn By: AG/RB
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 Issue Date: MAY 7, 2013
 Drawing Scale: NTS

Drawing Title:
ELECTRICAL DETAILS

BID DOCUMENTS

Drawing No.
E9.1.01

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