ORANGE COUNTY LIBRARY SYSTEM

BRANCH RESTROOM REFURBISHMENT

SOUTHEAST BRANCH LIBRARY 5575 S. SEMORAN BLVD. ORLANDO, FL 32822

PROJECT TEAM

OWNER

ORANGE COUNTY LIBRARY SYSTEM 101 E. CENTRAL BLVD. ORLANDO, FL 32801 PHONE: 407-835-7635

ENGINEER

ELECTRICAL ALERS ENGINEERING GROUP, LLC NICHOLAS V. ALERS, P.E. FL#48176

PERMITTING AGENCY

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OFFICE OF PERMITTING SERVICES
400 SOUTH ORANGE AVE.
ORLANDO, FLORIDA 32801
PHONE: 407-246-2271


ARCHITECT

RLARCHITECTURE, INC.
301 S SWEETWATER COVE BLVD.
LONGWOOD, FLORIDA 32779
RONALD LANG, AIA, FL#AR0016218
PHONE: 407-756-7833

ENGINEER

MECHANICAL/PLUMBING TAGS ENGINEERING TUGCE AGSAK, PE. FL#68336

LOCATION MAP

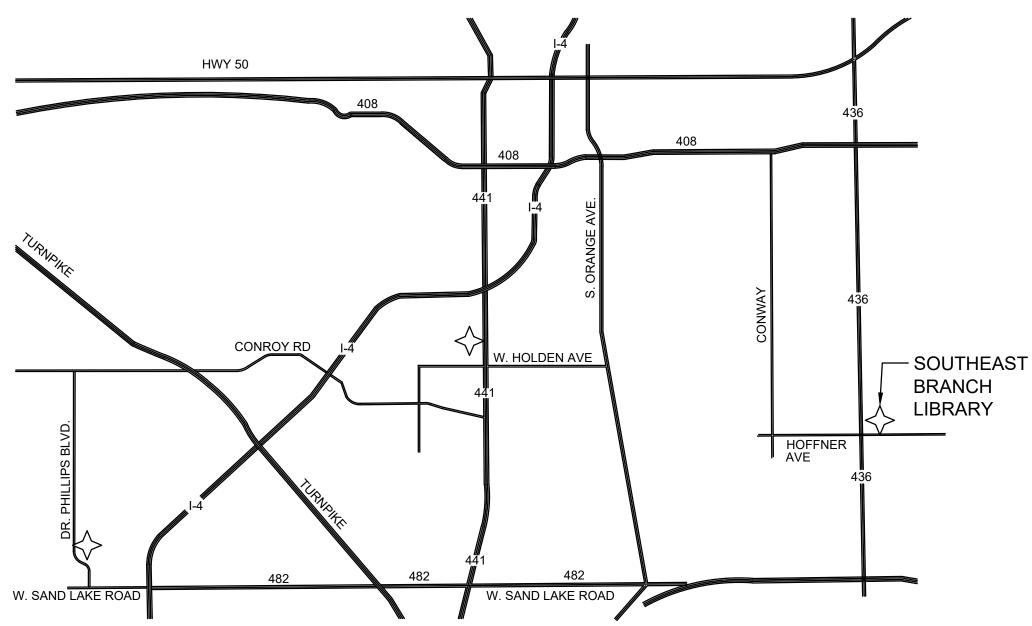

REFER TO MECHANICAL

REFER TO MECHANICAL

EXISTING SECURITY CAMERA DOME

EXHAUST CRILLE

ACCESS PANEL

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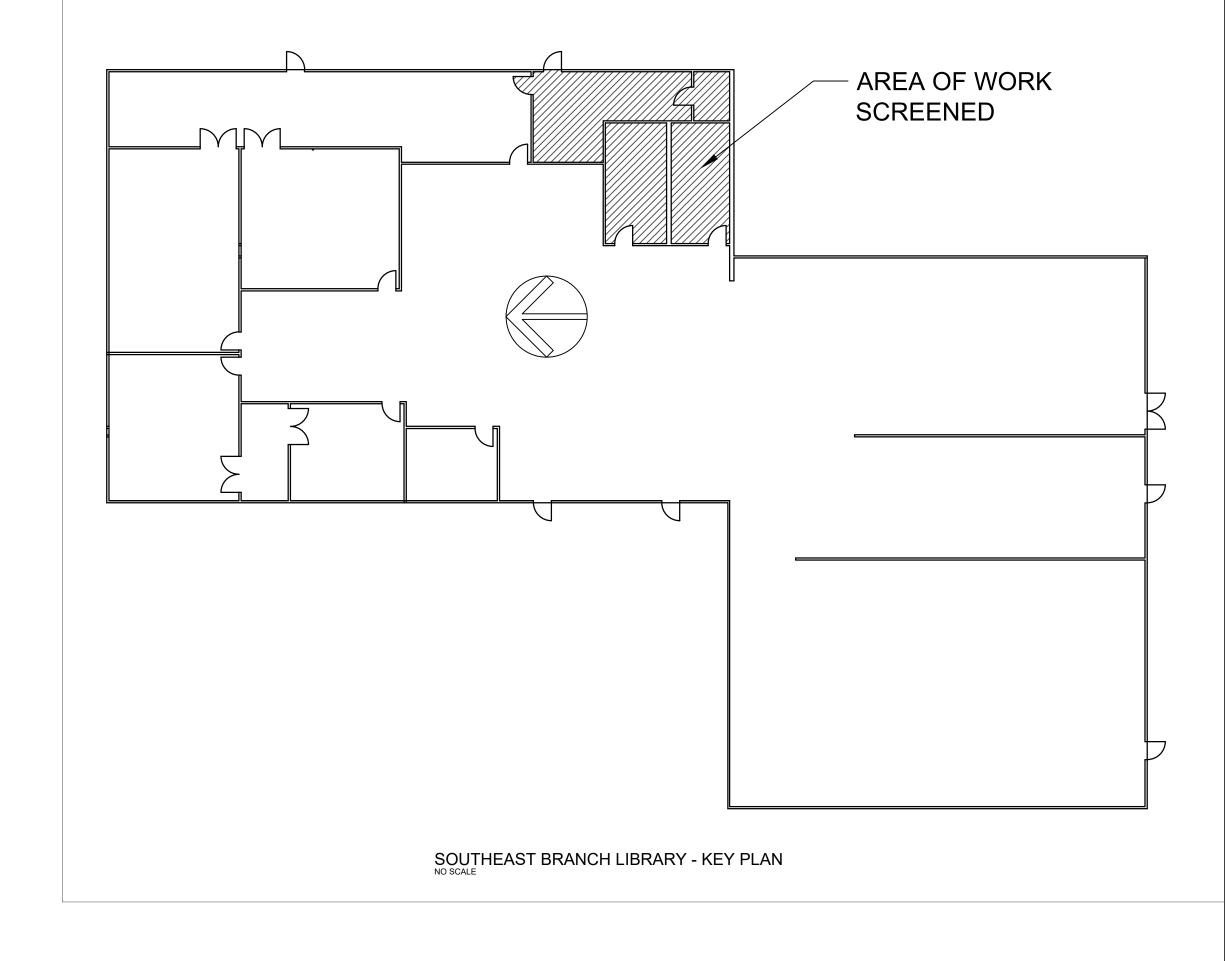
TOP OF STEEL

UNLESS NOTED OTHERWISE

VINYL COMPOSITION TILE

VERIFY IN THE FIELD

UNDERCUT



LIBRA 00

S R

C M

ORANG

ARCHITECTURE

Architecture

Planning

Programming

RLArchitecture

301 S SWEETWATER COVE BLVD

LONGWOOD, FL 32779 (407) 756-7833

RONALD N. LANG

AR0016218 A PERED AR

AR0016218 RLA PROJ. NO:

DRAWN BY: CHECKED BY: 03/22/19

REVISED

DRAWING TITLE:

GENERAL NOTES & **LEGENDS**

A-1.01

APPLICABLE BUILDING CODES

2017 FLORIDA BUILDING CODE, 6TH EDITION ACCESSIBILITY 2017 FLORIDA BUILDING CODE, 6TH EDITION BUILDING

2017 FLORIDA BUILDING CODE, 6TH EDITION ENERGY CONSERVATION 2017 FLORIDA BUILDING CODE, 6TH EDITION EXISTING BUILDING

2017 FLORIDA BUILDING CODE, 6TH EDITION MECHANICAL 2017 FLORIDA BUILDING CODE, 6TH EDITION PLUMBING 2017 FLORIDA BUILDING CODE, 6TH EDITION TEST PROTOCOLS

2017 FLORIDA ENERGY CODE, 6TH EDITION 2014 NATIONAL ELECTRICAL CODE (NFPA 70) 2017 FLORIDA FIRE PREVENTION CODE, 6TH EDITION

LIFE SAFETY LEGEND

W/DIRECTIONAL ARROW

W/DIRECTIONAL ARROWS

PULL STATION

 \square (

HORN WITH STROBE

SPEAKER/HORN

SMOKE DETECTOR

HEAT DETECTOR

AND EXIT WIDTH IN INCHES

AND EXIT WIDTH IN INCHES

ILLUMINATED EXIT SIGH, SINGLE FACE,

ILLUMINATED EXIT SIGH, DOUBLE FACE,

Ν₩

E₩

<u>40</u>

EXISTING CONSTRUCTION

DEMOLISHED CONSTRUCTION

2017 FBC TEST PROTOCOLS NFPA & NFPA 101 (2012) AS INCORPORATED INTO FFPC, 6TH EDITION

DESCRIPTION OF THE WORK

THE PROJECT IS LIMITED TO THE REFURBISHMENT OF THE EXISTING PUBLIC RESTROOMS, STAFF RESTROOM AND STAFF KITCHEN/BREAKROOM. THE REFURBISHMENT INVOLVES NEW FLOOR, WALL AND CEILING FINISHES, NEW LIGHTING, AND THE REPLACEMENT OF ALL TOILET FIXTURES AND ACCESSORIES. THE EXISTING WATER AND SEWAGE SYSTEMS WILL BE UTILIZED FOR THE IMPROVEMENTS.

COVER SHEET

DRAWING INDEX

A-1.01 GENERAL NOTES AND LEGENDS A-1.1 SOUTHEAST DEMO & RENOVATION PLANS


A-1.2 SOUTHEAST INTERIOR ELEVATIONS & DETAILS IN-1 SOUTHEAST INTERIORS - TILE PATTERNS & FINISHES


E-100 ELECTRICAL SPECIFICATIONS & PANELS

E-101 SOUTHEAST DEMOLITION PLAN

E-102 SOUTHEAST LIGHTING PLAN E-103 SOUTHEAST POWER PLAN

M-2.01 SOUTHEAST MECHANICAL PLAN P- 2.01 SOUTHEAST PLUMBING FLOOR PLANS, NOTES & SCHEDULES

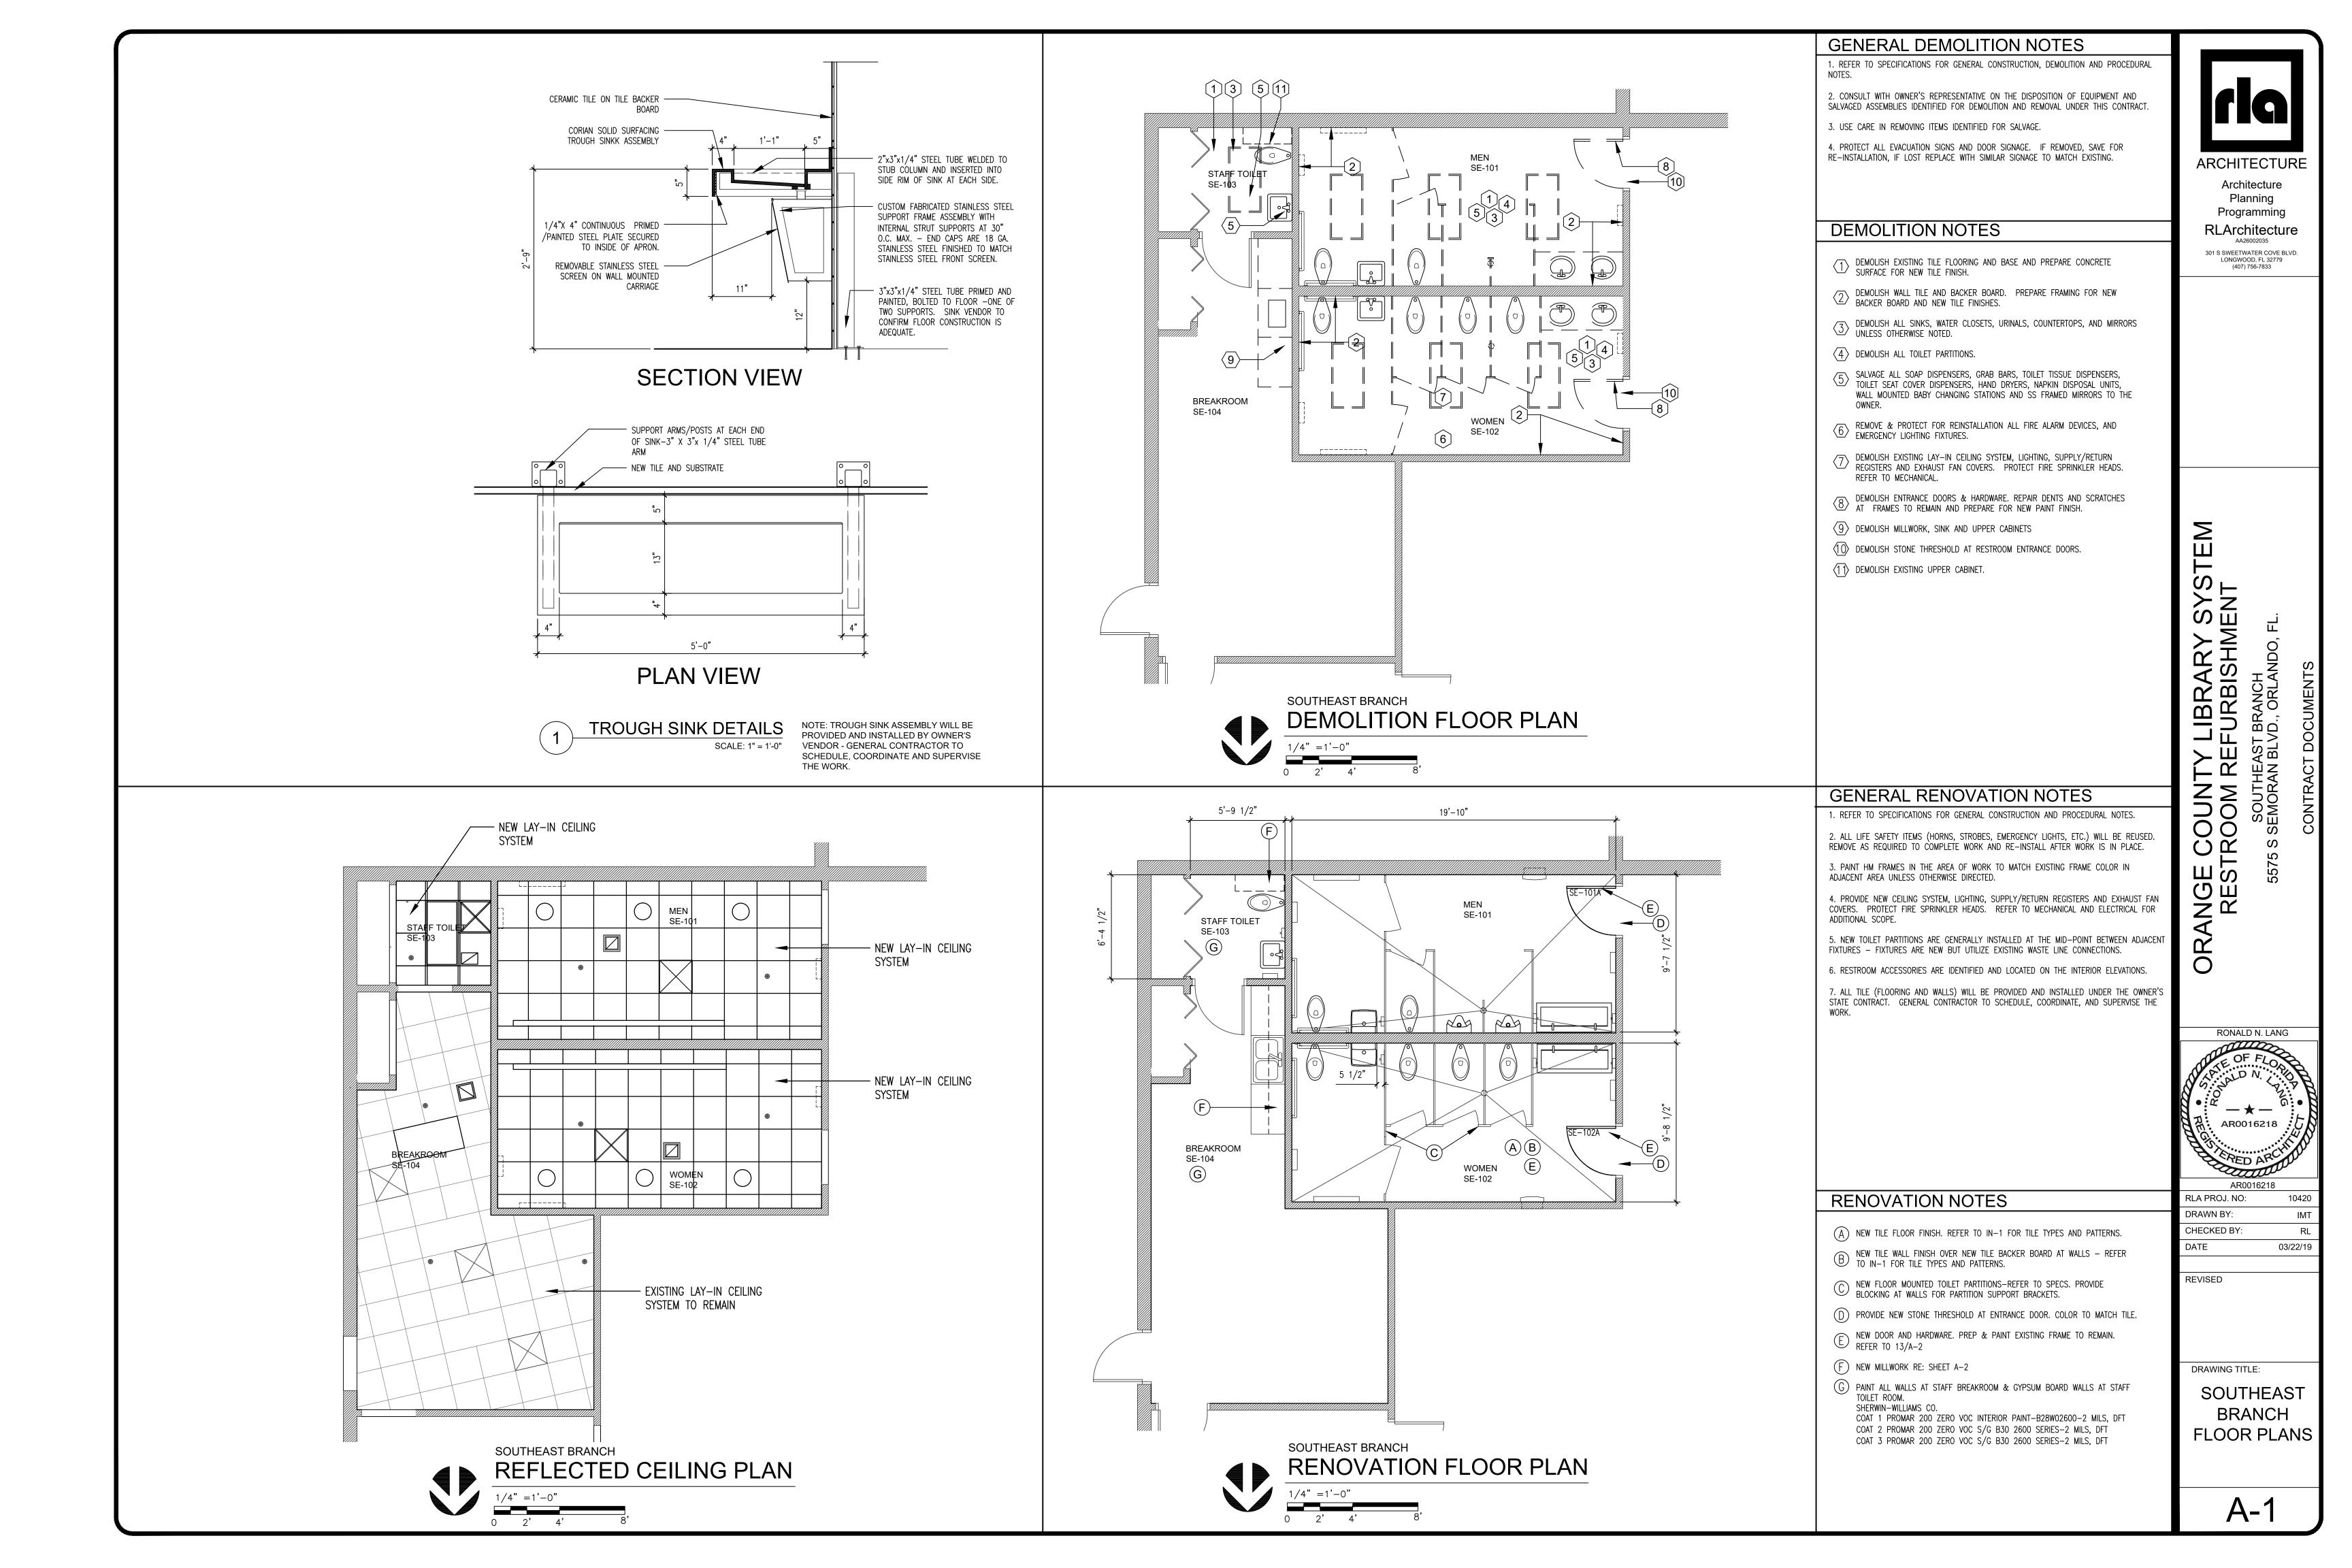

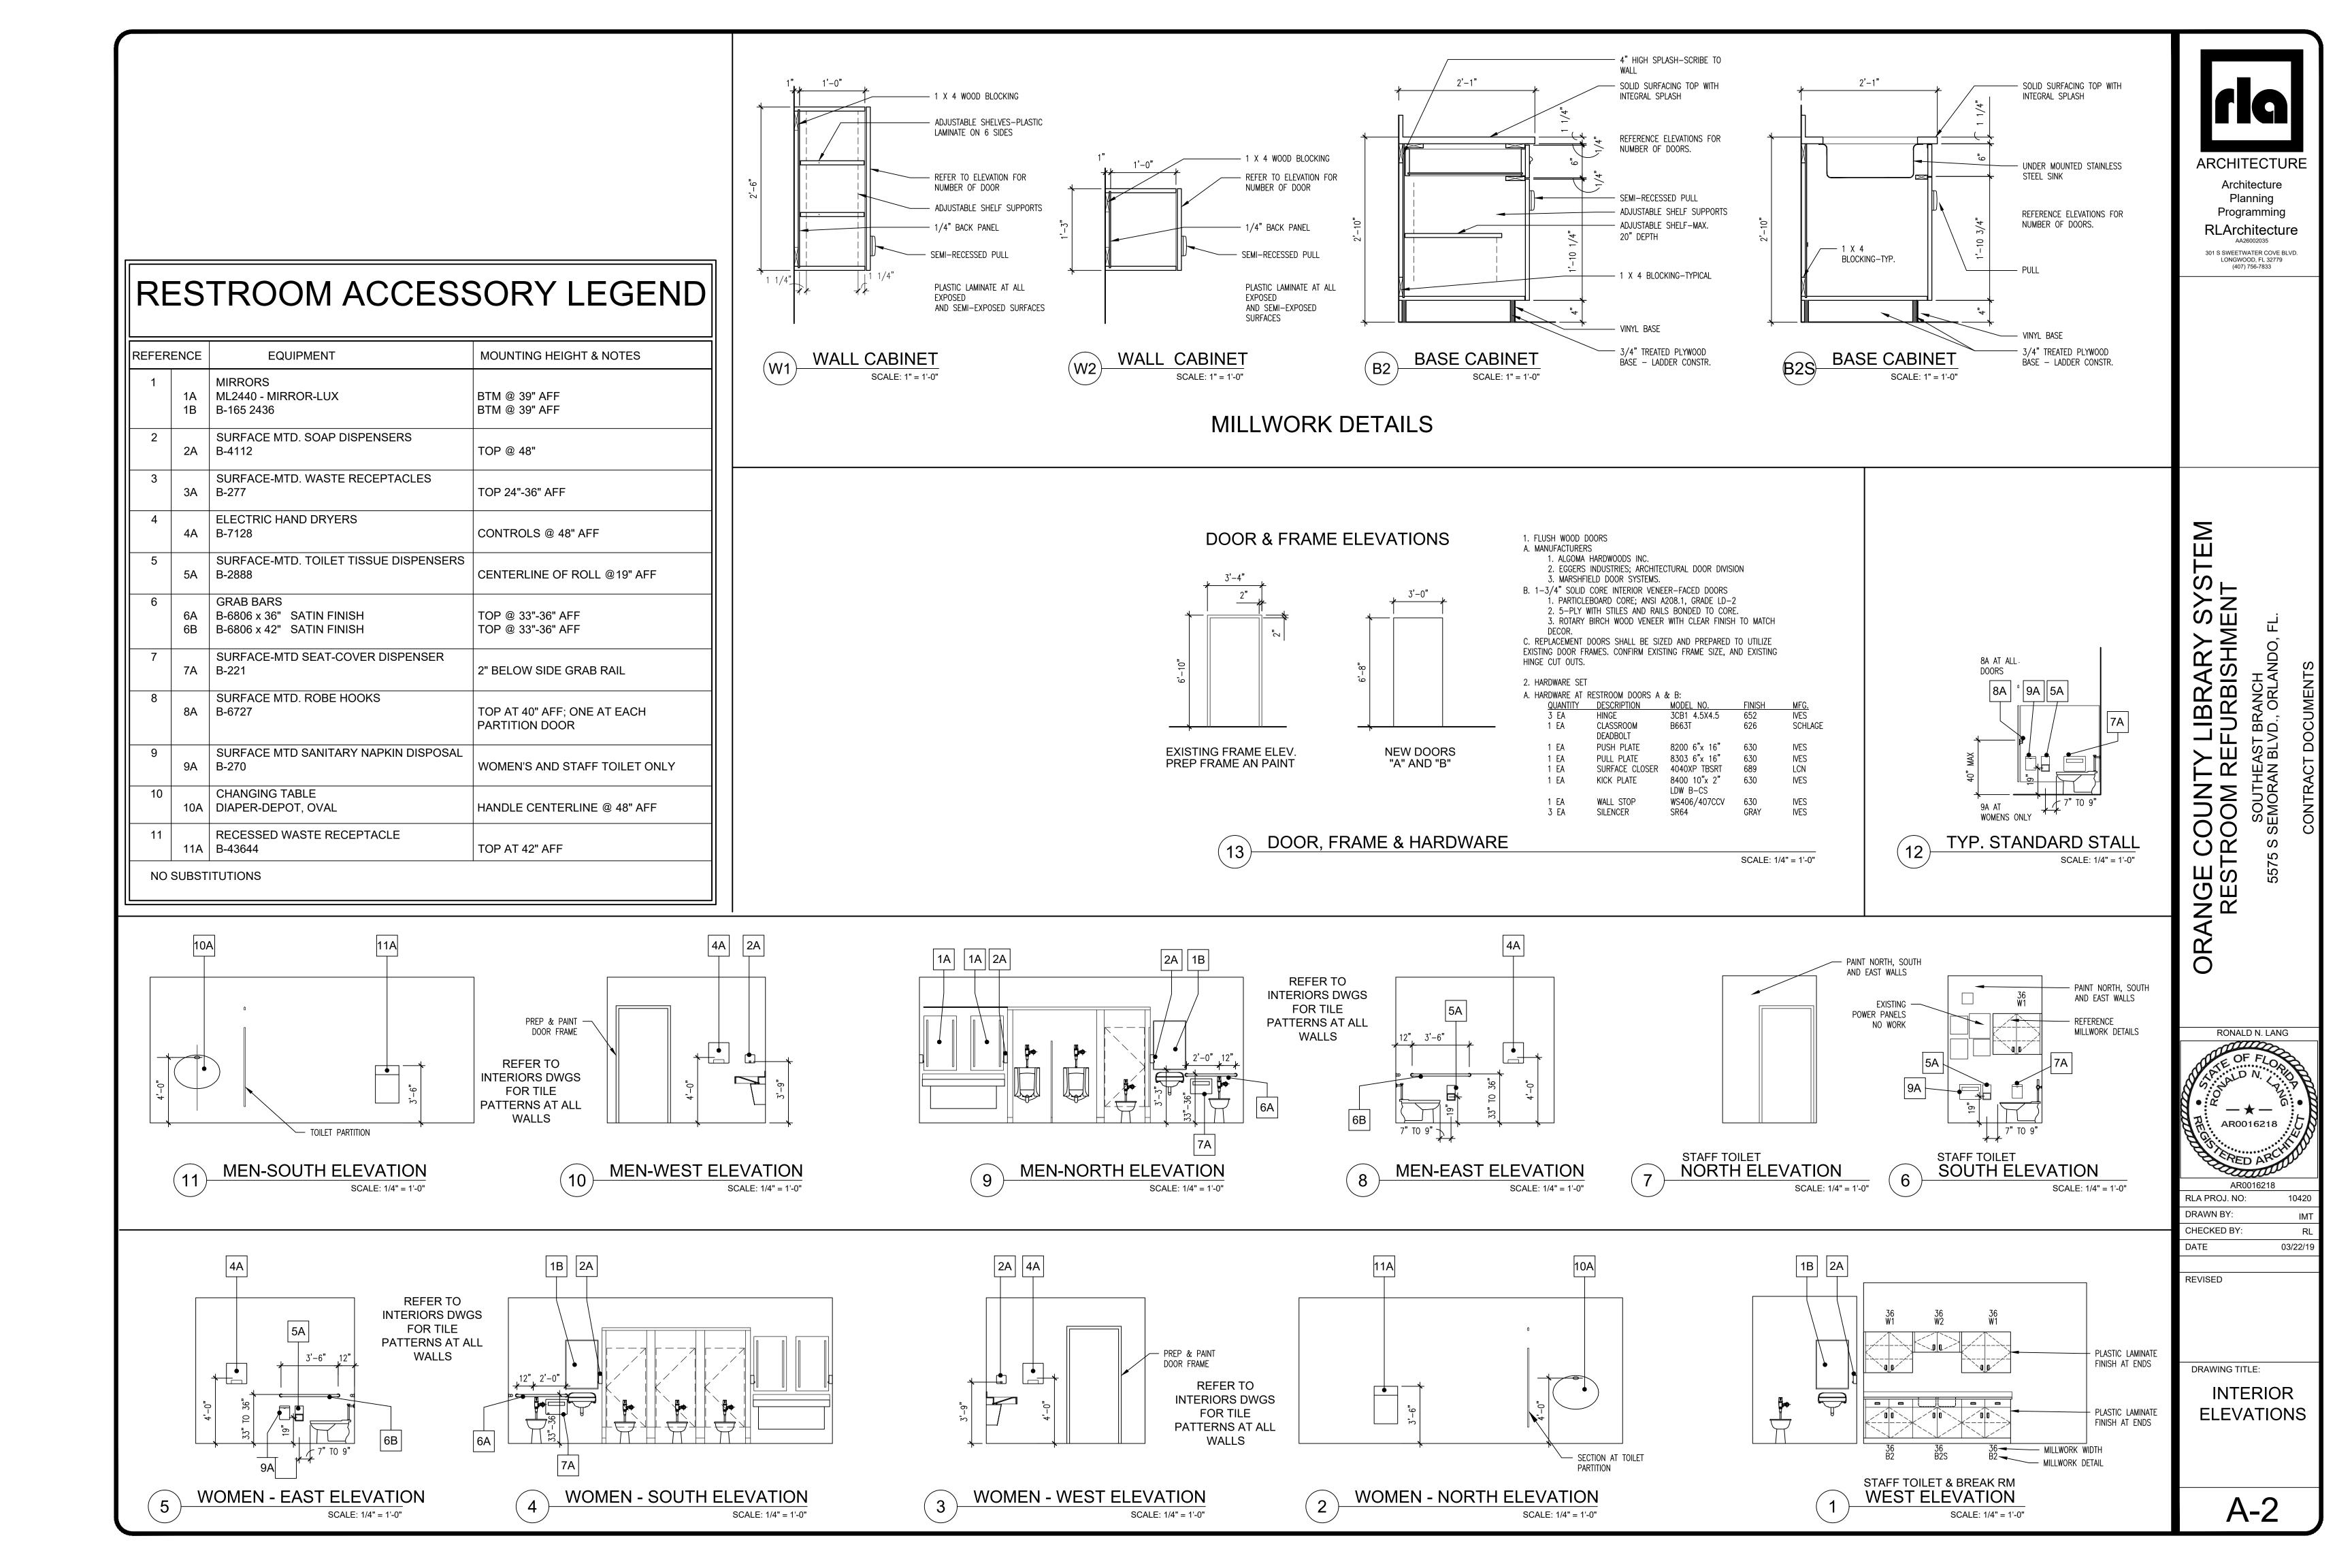

PROVIDE ALL LABOR, MATERIALS AND EQUIPMENT FOR A COMPLETE & PROPERLY OPERATING SYSTEM.

CODES AND STANDARDS: ALL ELECTRICAL WORK SHALL BE IN STRICT COMPLIANCE WITH THE 2014 NATIONAL ELECTRICAL CODE, THE LOCAL COUNTY ELECTRICAL CODE AND POWER COMPANY. ALL MATERIALS SHALL BE NEW AND FREE FROM DEFECTS, & SHALL BEAR THE UNDERWRITERS' LABEL.

CONTRACTOR SHALL THOROUGHLY INVESTIGATE SITE BEFORE BIDDING. NO CHANGES WILL BE ALLOWED IN CONTRACT PRICE FOR WORK REQUIRED TO COMPLY WITH EXISTING CONDITIONS.

ALL ELECTRICAL WORK SHALL BE DONE IN A NEAT AND WORKMANLIKE MANNER.

SPECIAL REQUIREMENTS: SUBMIT FIVE (5) COPIES OF TECHNICAL INFORMATION ON ALL EQUIPMENT IN BINDER. MARK—UP PRINTS OF THE DESIGN DRAWINGS WITH RED PENCIL AS ITEMS ARE INSTALLED, AND SUBMIT TWO COPIES SHOWING AN ACCURATE "AS—BUILT" RECORD OF THE ENTIRE SYSTEM. TEST EACH ITEM OF EQUIPMENT, AND SUBMIT TABULATED TEST INFORMATION, SECURE FROM THE MANUFACTURER'S REPRESENTATIVE A CHECK—OUT MEMO ON EACH ITEM OF EQUIPMENT. GIVE THE OWNER INSTRUCTION IN THE OPERATION OF THE SYSTEM. SECURE FROM THE OWNER A SIGNED MEMO STATING THAT TECHNICAL INFORMATION, AS—BUILT DRAWINGS AND INSTRUCTIONS IN OPERATION HAVE BEEN RECEIVED; SUBMIT COPY TO THE ARCHITECT.

RACEWAYS AND FITTINGS: ALL RACEWAYS SHALL BE GALVANIZED RIGID STEEL WITH LOCKNUTS AND BUSHINGS, WITH THE EXCEPTION THAT WHERE SPECIFICALLY ALLOWED BY THE NATIONAL ELECTRICAL CODE AND APPLICABLE LOCAL CODES, BRANCH CIRCUIT RACEWAYS MAY BE (E.M.T.) ELECTRICAL METALLIC TUBING OR PVC SCHEDULE 40. (PVC MAY BE USED BELOW GRADE ONLY.) E.M.T. SHALL BE JOINED WITH STEEL COMPRESSION TYPE FITTINGS.

BASIC MATERIALS AND METHODS

CONDUCTORS: BRANCH CIRCUIT CONDUCTORS SHALL BE (#12 UNLESS OTHERWISE NOTED) "THW OR THWN" COPPER (NO ALUMINUM SHALL BE PERMITTED UNLESS SPECIFICALLY NOTED OTHERWISE). ALL BRANCH CIRCUITS SHALL BE WIRED WITH COLOR—CODED WIRE WITH THE SAME COLOR USED FOR A PHASE THROUGHOUT. COLOR—CODE SHALL BE AS FOLLOWS: PHASE A—BLACK, PHASE B— RED, PHASE C— BLUE, NEUTRAL— WHITE, GROUND— GREEN.

MC CABLE AS PERMITTED BY THE NEC IS ALLOWED FOR BRANCH CIRCUITS. MC CABLE SHALL HAVE A GREEN, INSULATED GROUNDING CONDUCTOR.

16200 ELECTRICAL SERVICE SYSTEM

- 1.01 IN GENERAL, ALL ELECTRICAL EQUIPMENT, METALLIC CONDUIT, MOTOR FRAMES, PANEL— BOARDS, ETC., SHALL BE GROUNDED WITH A SEPARATE GREEN SYSTEM GROUNDING CONDUCTOR RUN FROM THE MAIN SWITCH GROUND TO ALL PANELS AND FROM GROUNDING LUGS ON EACH PANEL TO EACH BRANCH CIRCUIT DEVICE AND FIXTURE IN ACCORDANCE WITH THE SPECIFIC RULES OF ARTICLE 250 OF THE NATIONAL ELECTRICAL CODE. ALL PANELS SHALL HAVE A SEPARATE NEUTRAL BAR ISOLATED FROM STANDARD NEUTRAL BAR FOR GROUNDING.
- 1.02 THE FACILITIES AND EQUIPMENT REQUIRED TO PROVIDE ALL ELECTRIC POWER FOR CONSTRUCTION, LIGHTING, BALANCING AND TESTING CONSUMED PRIOR TO FINAL ACCEPTANCE OF THE PROJECT SHALL BE PROVIDED UNDER THE ELECTRICAL CONTRACT.
- 16300 ELECTRICAL DISTRIBUTION SYSTEM
- 1.01 ALL WIRING DEVICES SHALL BE SPECIFICATION GRADE. SWITCHES SHALL BE QUIET TYPE. RECEPTACLES SHALL HAVE GROUND TERMINAL. SEE EQUIPMENT SCHEDULE.
- 16400 LIGHTING FIXTURES
- ALL LIGHT FIXTURES SHALL BE FURNISHED COMPLETE WITH LAMPS, AND ALL NECESSARY MOUNTING HARDWARE, HANGERS AND TRIM.
 LIGHT FIXTURES SHALL BE BID AS SPECIFIED IN THE LIGHTING
 FIXTURE SCHEDULE. ALL FLUORESCENT BALLASTS SHALL BE AUTO—
 RESET, CLASS P, ETL, CBM WITH EXTERNAL FUSE AND FUSE
 HOLDER. ALL FLUORESCENT LAMPS AND BALLASTS TO BE ENERGY
 SAVING TYPE.

BRANCH CIRCUIT WIRING NOTES:

- VOLTAGE DROP SHALL BE SIZED FOR A MAXIMUM VOLTAGE DROP
 OF 3 PERCENT AT DESIGN LOAD. (FBC 13-413.1.ABC.1.2 BRANCH
 CIRCUITS.)
- WIRING IS SHOWN ON DRAWINGS ONLY FOR SPECIFIC ROUTES OR SPECIAL CONDITIONS.
- 2. WIRING AND CONDUIT SHALL BE REQUIRED BETWEEN ALL OUTLETS INDICATED WITH CIRCUIT NUMBERS AND PANEL DESIGNATIONS.
- ALL SWITCH CONTROLS SHALL BE PROVIDED WITH WIRING AND 3. CONDUIT AS REQUIRED.
- ALTHOUGH ALL BRANCH CIRCUIT WIRE AND CONDUIT IS NOT SHOWN,
 4. IT IS INTENT OF THESE DOCUMENTS THAT A COMPLETE BRANCH CIRCUIT WIRING SYSTEM BE INSTALLED.
- PROVIDE A GREEN GROUND CONDUCTOR IN ALL CIRCUITS, APPROPRIATELY SIZED INCREASE CONDUITS TO ACCOMMODATE 5. GROUND CONDUCTOR.

UNLESS SHOWN OTHERWISE (BRANCH CIRCUITING INSTRUCTIONS):

- 6. 1600 WATTS MAXIMUM PER 20A/1P BRANCH CIRCUIT, UNLESS SHOWN OTHERWISE.
 - 6 CONV. OUTLETS MAXIMUM PER 20A/1P BRANCH CIRCUIT.

FEEDER NOTES:

VOLTAGE DROP FEEDER CONDUCTORS SHALL BE SIZED FOR A MAXIMUM VOLTAGE DROP OF 2 PERCENT AT DESIGN LOAD. (FBC 13-413.1.ABC.1.1 FEEDERS.)

ELECTRICAL DEMOLITION NOTES

ELECTRICAL CONTRACTOR SHALL VISIT AND EXAMINE THE SITE PRIOR TO CONSTRUCTION TO ASCERTAIN THE EXISTING CONDITIONS AND LIMITS OF DEMOLITION AND CONSTRUCTION.

COORDINATE SEQUENCING WITH OWNER & OTHER CONTRACTORS.

DEVICES & CONNECTIONS SHOWN ON PLANS WERE TAKEN FROM A SITE VISITATION. THESE PLANS MAY NOT BE ENTIRELY ACCURATE. THEY ARE INTENDED TO GIVE THE CONTRACTOR A GENERAL IDEA OF WHAT EQUIPMENT IS BEING REMOVED, DISCONNECTED OR RETAINED. THE CONTRACTOR SHALL BE RESPONSIBLE FOR FIELD INSPECTION OF SITE TO DETERMINE ACTUAL CONDITIONS OF THE INSTALLATION AND/OR THE EXISTING EQUIPMENT BEFORE SUBMITTING BID.

IT WILL BE THE CONTRACTOR'S RESPONSIBILITY TO PROTECT AND MAINTAIN THE INTEGRITY OF REMAINING DEVICES OR EQUIPMENT, AND ANY SUCH CONNECTION SHALL BE CONCEALED UNLESS LOCATED IN UNFINISHED AREAS.

DISCONNECT, REMOVE OR RELOCATE ALL EXISTING ELECTRICAL MATERIAL AND EQUIPMENT THAT INTERFERES WITH NEW INSTALLATION. THIS INCLUDES BUT IS NOT LIMITED TO PANELS, LIGHTING FIXTURES, WIRING DEVICES, SIGNAL EQUIPMENT, EXHAUST FANS, BASEBOARD HEATERS, UNIT HEATERS, ECT.

SEE MECHANICAL DRAWINGS FOR HEATERS, EXHAUST FANS, ETC., WHICH MUST BE DISCONNECTED BY THE CONTRACTOR FOR REMOVAL OR ABANDONMENT BY MECHANICAL CONTRACTOR.

REMOVE ALL CONDUIT WIRE, BOXES AND FASTENING DEVICES, AS REQUIRED TO AVOID ANY INTERFERENCE WITH NEW INSTALLATION.

ABANDONED CONDUIT SHALL BE CAPPED AT BOTH ENDS.

ANY PRESENT FLOOR OUTLETS OCCURRING SHALL BE CAPPED

FLUSH WITH FLOOR.

ALL REMOVED EQUIPMENT SHALL BE DISPOSED OF BY THIS CONTRACTOR UNLESS DIRECTED TO DO OTHERWISE BY THE OWNER.

WHERE WORK BY THE GENERAL CONTRACTOR (WALL REMOVAL, NEW OR RELOCATED WALL OPENING, ETC..) RESULTS IN THE REMOVAL, RELOCATION OF REFEEDING OF ELECTRICAL DEVICES OR LIGHTING FIXTURES, THE ELECTRICAL CONTRACTOR SHALL DISCONNECT AND RECONNECT AS REQUIRED ALL ACTIVE DEVICES SOME TO SUIT CONFLICTING EQUIPMENT.

THE COVERS ON ALL JUNCTION OR PULL BOXES IN UNFINISHED AREAS SHALL BE MARKED WITH A "MAGIC MARKER" TO INDICATE CIRCUIT NUMBER & SERVING PANEL OF CONDUCTORS OR SYSTEM CABLES ASSOCIATED WITH EACH BOX.

CONTRACTOR CAN REUSE EXISTING UNDERSLAB CONDUIT IF APPLICABLE FOR PULLING NEW CIRCUIT WIRING.

EXISTING PANEL					С							200A,2I	•		SINGLE PANEL	Χ
240/120 V	/OLTS	3	PHASE	4	WIRE		200		AMPS	S	M.C.B	X	M.L.O.		DOUBLE PANEL	
	KAIC		_				-				-		- ,		SURFACE	Χ
TYPE: S	SQUARE	- D	NEMA	1											RECESSED	
	NQOD		-		,										-	
<u> </u>	IQUD															
			KVA			П	Р	PHASE					KVA			
LOAD		OTHER	REC	LTG	BK	PL	Α		С	PL	BK	LTG	REC	OTHER	LOAD	
A/C					2/60	1	X			2	1/20				SPARE	
						3				4	1/20				EXIT AND EMERGENCY LIG	HTS
SPARE					1/20	5			Χ	6	1/20				POWER POLE	
SPARE					1/20	7	X			8	1/20				EXIT AND EMERGENCY LIG	HTS
SHOWROOM RECEPTACLES					1/20	9				10	1/20				SHOW ROOM OUTLETS	;
RR OUTLS ACCESS CONTROL					1/20	11			Χ	12	1/20				POWER POLE	
EXHAUST FAN KITCHEN					1/20	13	X			14	1/20				SHOW ROOM OUTLETS	;
RECEPTACLE					1/20	15				16	1/20				SPARE	
HANDICAPPED DRYERS					1/20	17			Χ	18	2/30				WATER HEATER	
GHT STAFF RESTR MENS BOTH ADA D	RYER				1/20	19	X			20						
A/C ROOF TOP					2/40	21				22	2/60				AHU	
						23			X	24						
A/C ROOF TOP					2/50	25	X			26	2/20				AHU	
						27				28						
SPACE						29			X	30					SPACE	
SUB TOTALS		0.00	0.00	0.00								0.00	0.00	0.00	SUB TOTALS	
TOTAL CONN. KVA TOTAL DEMAND KVA VOLTAGE DEMAND AMPS		- -	0.00 0.00 240 0.00								-	0.00 1.25 0.00	0.00 * 0.00	1.0	CONNECTED KVA DEMAND FACTOR DEMAND KVA	

GENERAL NOTE:

EXISTING PANEL BOARD SCHEDULES SHOWN ARE BASED ON OUR SITE VISIT.
DEMOLITION SCOPE OF WORK WILL AFFECT THE FINAL CIRCUITS THAT WILL
BE LEFT. PROVIDE NEW PANEL SCHEDULE DIRECTORIES DEPICTING THESE

EXISTING				D					_				V	SINGLE PANEL	X
240/120 VOLTS	1	PHASE	3	WIRE		200		AMP:	S	M.C.B		M.L.O.	X	DOUBLE PANEL	V
22KAIC														SURFACE	\underline{X}
TYPE: SQUAF	RE D	NEMA	1	_										RECESSED	
NQOD															
	_														
		KVA				I.F.	HASE					KVA			
LOAD	OTHER	REC	LTG	BK	PL	Α		С	PL	BK	LTG	REC	OTHER	LOAD	
AIR HANDLER #6				2/60	1	X			2	2/60				AIR HANDLER	R #5
					3			X	4						
ROOF TOP				2/50	5	X			6	2/50				AC ROOF TO)P
					7			Χ	8						
COPIER				1/20	9	Χ			10	1/20				OFFICE LIGH	TS
CLOCK				1/20	11			X	12	1/20				OFFICE LIGH	TS
OFFICE RECEP				1/20	13	Χ			14	1/20				OFFICE LIGH	TS
OFFICE RECEP				1/20	15			X	16	1/20				OFFICE LIGH	TS
OFFICE RECEP				1/20	17	X			18	1/20				FRONT LIGHT	TS
OFFICE RECEP				1/20	19			X	20	1/20				FRONT LIGHT	TS
FRONT LIGHTS				1/20	21	Χ			22	1/20				FRONT LIGHT	TS
WORK ROOM LIGHTS				1/20	23			X	24	1/20				FRONT LIGHT	TS
FRONT LIGHTS				1/20	25	X			26	1/20				BACK WALL LIC	GHTS
FRONT LIGHTS				1/20	27			X	28	1/20				EMERG LIGH	YS
BACK LIGHTS				1/20	29	X			30	1/20				BACK LIGHT	S
EXISTING LOAD				1/20	31			X	32	1/20				FLOOR BOX	X
EXISTING LOAD				1/20	33	Χ			34	1/20				FLOOR BOX	X
EXISTING LOAD				1/20	35			Χ	36	1/20				EXISTING LO	AD
EXISTING LOAD				1/20	37	X			38	1/20				EXISTING LOA	AD
EXISTING LOAD				1/20	39			X	40	1/20				EXISTING LO	AD
EXISTING LOAD				1/20	41	Х			42	1/20				EXISTING LO	AD
SUB TOTALS	0.00	0.00	0.00								0.00	0.00	0.00	SUB TOTAL	S
TOTAL CONN. I	AV	0.00									0.00	0.00	0.00	CONNECTED KVA	1
TOTAL DEMAN	D KVA	0.00									1.25	1.0	1.0	DEMAND FACTOR	3
VOLTAGE		240									0.00	0.00	0.00	DEMAND KVA	

EXISTING PA		_			В							200A,2			SINGLE PANEL _	>
240/120 VOL	LTS	3	PHASE ₋	4	WIRE		200		AMP:	S	M.C.B	Х	M.L.O.		DOUBLE PANEL	
22 KAI	С														SURFACE	>
TYPE: SQI	JARE D	1	NEMA	1											RECESSED	
NQC	OD		_		=										_	
			10.70		I			2114.05		1			10.74		T	
LOAD	OTI	ıED	KVA	LTO	DIC	DI		PHASE		D.	DIC	LTO	KVA	OTUED.	1045	
LOAD	OII	HER	REC	LTG	BK	PL	A		С	PL	BK	LTG	REC	OTHER		
EXISTING LOAD					1/20	1	Х			2	2/50				EXISTING LOAD	
EXISTING LOAD					1/20	5				4					EXISTING LOAD	
EXISTING LOAD EXISTING LOAD					1/20	7	Х		X	6 8	2/60				AHU#2	
EXISTING LOAD					1/20	9	^			10	1/20				EXISTING LOAD	
EXISTING LOAD					1/20	11			X	12	1/20				EXISTING LOAD	
EXISTING LOAD					1/20	13	X		^	14	1/20				EXISTING LOAD	
EXISTING LOAD					1/20	15				16	1/20				EXISTING LOAD	
EXISTING LOAD					1/20	17			X	18	1/20				EXISTING LOAD	
EXISTING LOAD					1/20	19	X			20	1/20				EXISTING LOAD	
EXISTING LOAD					1/20	21				22	1/20				EXISTING LOAD	
EXISTING LOAD					1/20	23			X	24	1/20				EXISTING LOAD	
EXISTING LOAD					1/20	25	X			26	1/20				EXISTING LOAD	
EXISTING LOAD					1/20	27				28	1/20				EXISTING LOAD	
SPACE						29			X	30	1/20				SPACE	
SUB TOTALS	0.	00	0.00	0.00								0.00	0.00	0.00	SUB TOTALS	
TOTAL CONN. KVA			0.00									0.00	0.00	0.00	CONNECTED KVA	
TOTAL DEMAND KY		_	0.00								-	1.25	*		DEMAND FACTOR	
VOLTAGE		-	240									0.00	0.00	0.00	DEMAND KVA	

EXIST	ING PAN	EL			Α										SINGLE PANEL	X
240/12	20 VOLTS	3	PHASE	4	WIRE		200		AMP	S	M.C.B		M.L.O.	X	DOUBLE PANEL	
22	KAIC	-	-		-				-		•		_		SURFACE	X
TYPE:		E D	NEMA	1											RECESSED	
111 2.	NQOD			<u>'</u>	_										NEOLOOLD	
	NQOD	_														
			KVA				F	PHASI	E				KVA			
LOAI)	OTHER	REC	LTG	BK	PL	Α		С	PL	BK	LTG	REC	OTHER	LOAD	
AHU-	1				2/60	1	Х			2	2/60				AHU-4	
	-					3				4						
COPIE	R				2/30	5			X	6	2/60				A/C	
	-					7	Х			8						
HAND DF	RYER				1/20	9				10	2/60				A/C	
REF	<u> </u>				1/20	11			X	12						
WATER CO	OOLER				1/20	13	X			14	1/20				HAND DRYEF	₹
MENS DF	RYER				1/20	15				16	1/20				REC	
SEC PA	NEL				1/20	17			X	18	1/20				WOMENS DRY	ER
VENDING M	ACHINE				1/20	19	X			20	1/20				HAND DRYEF	₹
RECEPTACLE	GENERAL				1/20	21				22	1/20				FRONT DESK RE	ECP
NEW OFFICE AI	REA RECEP				1/20	23			X	24	1/20				MANAGERS OFFICE	RECP
NEW OFFICE AI	REA RECEP				1/20	25	Х			26	1/20				ROOM 140	
NEW COM	1P RM				1/20	27				28	1/20				ROOM 140	
NEW COM	IP RM				1/20	29			X	30					SPACE	
SUB TOT	ΓALS	0.00	0.00	0.00								0.00	0.00	0.00	SUB TOTALS	(II
	ONN. KVA		0.00									0.00	0.00		CONNECTED KVA	
	EMAND KVA		0.00									1.25	*		DEMAND FACTOR	
VOLTAGE			240								,	0.00	0.00	0.00	DEMAND KVA	
DEMAND	AMPS		0.00													



ARCHITECTURE

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AA26002035

301 S SWEETWATER COVE BLVD.

LONGWOOD, FL 32779


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RESTROOM REFURBISHMENT
SOUTHEAST BRANCH



RLA PROJ. NO: 10420

DRAWN BY: IL

CHECKED BY: NVA

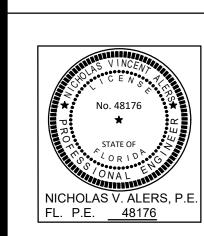
DATE 03/22/19

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SOUTHEAST ELECTRICAL SPECIFICATIONS & PANELS

E100



DEMOLITION PLANKEY NOTES:

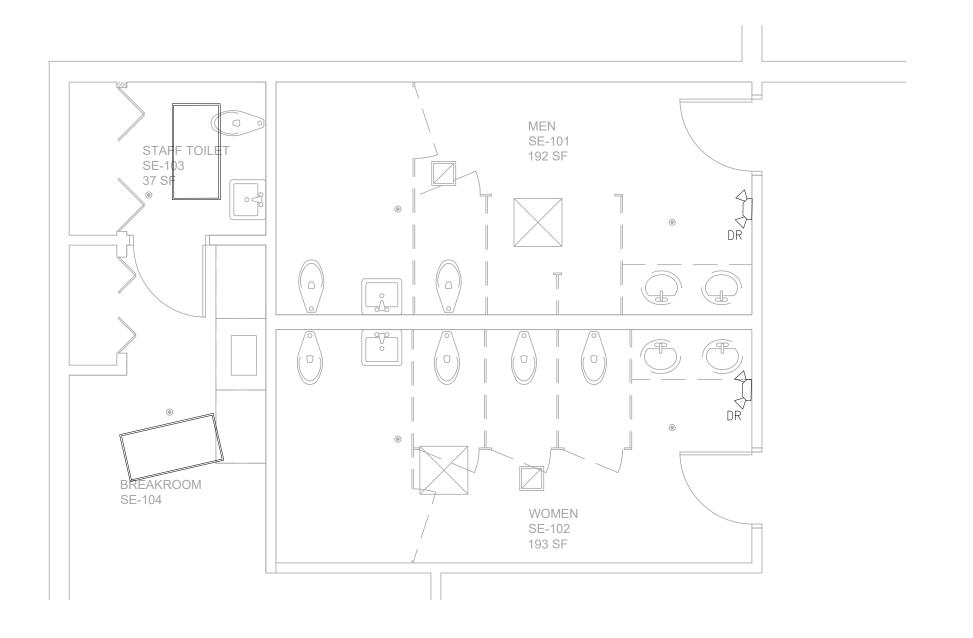DR= DISCONNECT AND REMOVE. PULL BACK WIRING TO SOURCE AND REMOVE IN ITS ENTIRETY INCLUDING THE CONDUIT. FIELD VERIFY CIRCUIT FROM EXISTING PANELS. SEE SHEET E100

E= EXISTING TO REMAIN


ORANGE COUNTY LIBRARY SYSTEM RESTROOM REFURBISHMENT SOUTHEAST BRANCH 5575 S SEMORAN BLVD., ORLANDO, FL.

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RLA PROJ. NO:	10420
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CHECKED BY:	NVA
DATE	03/22/19

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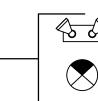
SOUTHEAST DEMO PLAN

E101

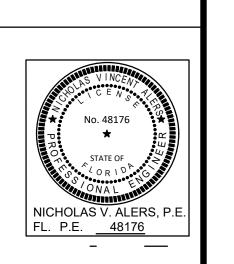

LIGHTING FIXTURE SPECIFICATIONS:

PROVIDE HOT LEG OF CIRCUIT AHEAD -OF SWITCH




LED EMERGENCY LIGHTING UNIT W/NICAD BATTERY WHITE. 12W LED LITHONA ELM2 LED 120V.

120V, 10W, LED FACE EXIT SIGN W/BATTERY BACK-UP, BEGHELLI UNO SA-LR-2-W

DAYLED TROFFER 2X4 DAY-BRITE RECESSED-2TLG56L840-4-21-UNV-DIM

1-POLE SWITCH, 2-POLE SWITCH, 3-WAY, 4-WAY, DIMMER SWITCH (1000W \$ $\$_2$ $\$_3$ $\$_4$ $\$_P$ $\$_{OC}$ MIN.), P INDICATES PILOT LIGHT - 48" A.F.F, SWITCH-OCCUPANCY SENSOR TYPE

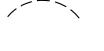

LIGHTING BRANCH CIRCUIT BETWEEN ROOMS. SWITCHED LEG AND LIGHTING CIRCUIT WITHIN A ROOM SHOWN AS SOLID LINE.



BRANCH CIRCUIT CONDUIT CONCEALED ABOVE CEILING OR IN WALL. SLASH MARKS INDICATE NUMBER OF CONDUCTORS, SHORT SLASH IS NEUTRAL, LONG SLASH IS HOT (GROUND WIRE NOT SHOWN). LONG SLASH WITH FLAG INDICATES AN EXTRA GROUND FOR ISOLATED GROUND BRANCH CIRCUITS. 2 #12, #12G MINIMUM (UNLESS OTHERWISE NOTED OR MARKED). QUANTITY OF ARROWS INDICATES QUANTITY OF HOMERUNS TO PANELBOARD.

LETTER NEXT TO DEVICE INDICATES THE FOLLOWING SCOPE:


N = NEW DEVICE. PROVIDE (2)#12, (1)#12 GND IN 3/4" EMT CONDUIT TO CIRCUIT.

E = EXISTING TO REMAIN IN SERVICE

GENERAL NOTES:

 CONNECT NEW LIGHTING TO EXISTING CIRCUIT WITH (2)#12, (1)#12 GND IN 3/4" EMT C. VERIFY IN FIELD CIRCUIT. SEE SHEET E100



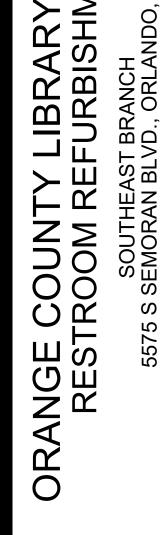


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DRAWN BY:	IL
CHECKED BY:	NVA
DATE	03/22/19

REVISED

DRAWING TITLE


SOUTHEAST LIGHTING PLAN

E102

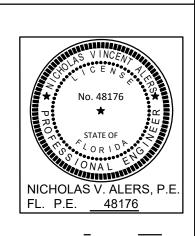SOUTHEAST BRANCH LIBRARY NEW LIGHTING PLAN

1/4" =1'-0"
0 2' 4' 8'



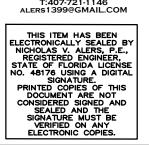

PRIN DO CONS S SIG V ELI

Φ_{GFI}Φ_{AF}Φ Φ Φ Φ_{DC} CIRCUIT INTERRUPTER TYPE, ARC FAULT CIRCUIT INTERRUPTER TYPE, ORANGE ISOLATED GROUND TYPE, WEATHERPROOF TYPE, DEDICATED DUPLEX RECEPTACLE, TWIST LOCK AND DROP CORD, WINDOW SIGN.

FLOOR MOUNTED RECEPTACLE

ELECTRICAL SYMBOL LEGEND

<u>DESCRIPTION</u>

120/208 OR 120/240V PANELBOARD - FLUSH MOUNTED, SURFACE MOUNTED

DISCONNECT SWITCH

QUAD RECEPTACLE AT 18" 20A,120V.

SPECIAL RECEPTACLE - 18"A.F.F. NEMA TYPE SHOWN ON PLANS.


LETTER NEXT TO DEVICE INDICATES THE FOLLOWING SCOPE:

N = NEW DEVICE. PROVIDE (2)#12, (1)#12 GND IN 3/4" EMT CONDUIT TO CIRCUIT.

E = EXISTING TO REMAIN IN SERVICE

GENERAL NOTES:

 CONNECT NEW RECEPTACLES TO EXISTING CIRCUIT WITH (2)#12, (1)#12 GND IN 3/4" EMT C. VERIFY IN FIELD CIRCUIT. SEE SHEET E100

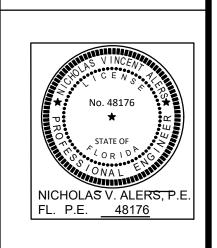

ORANGE COL RESTROC

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DATE	03/22/19

REVISED

DRAWING TITLE:

SOUTHEAST POWER PLAN

E103

SOUTHEAST BRANCH

FLOOR FINISH PLAN

KEYNOTES FLOOR PATTERN LEGEND

PFT-1

PFT-2

PFT-3

WALL PATTERN LEGEND

PWT-1

PWT-3

SOUTHEAST BRANCH

1 EXISTING FLOOR FINISH TO REMAIN.

2 PROVIDE AND INSTALL VCT-1 WHERE DEMOLITION OCCURS. REFERENCE A SERIES SHEETS FOR EXTENT.

3 COUNTERTOP, SSF-1. CABINETS, PL-1

4 TILE GROUT TO ALIGN WITH PLUMBING FIXTURE CENTERLINE.

5 GROUT LINES ON WET WALL TO ALIGN WITH WALL PATTERN. REFERENCE ELEVATIONS.

FINISH IDENTIFICATION

PORCELAIN WALL TILE (PWT)

PWT-1 MANUFACTURER: CROSSVILLE PATTERN: EMPIRE COLOR: CORSICAN CREME Vs80 FINISH: UNPOLISHED

SIZE: 12"X24"

NOT USED

MANUFACTURER: CROSSVILLE PATTERN: SHADES COLOR: CLAY AV 245

PORCELAIN FLOOR TILE (PFT)

PFT-1 MANUFACTURER: CROSSVILLE PATTERN: EMPIRE COLOR: CORSICAN CREME Vs80 FINISH: UNPOLISHED SIZE: 12"X24"

MANUFACTURER: CROSSVILLE PATTERN: EMPIRE COLOR: MARQUIS GREIGE Vs83 FINISH: UNPOLISHED SIZE: 12"X24"

<u>PFT-3</u> MANUFACTURER: CROSSVILLE PATTERN: SHADES COLOR: CLAY AV 245 FINISH: UNPOLISHED SIZE: 6"X24"

PORCELAIN WALL BASE (PWB)

MANUFACTURER: CROSSVILLE PATTERN: EMPIRE COLOR: CORSICAN CREME Vs80 FINISH: UNPOLISHED SIZE: 4"X24" BULLNOSE

GROUT
MAPEI - COLOR TO BE SELECTED

VINYL COMPOSITION TILE (VCT)

MANUFACTURER: ARMSTRONG PATTERN: STANDARD EXCELON COLOR: TO BE SELECTED

SIZE: 12"X12"

RESILIENT BASE (RB)

MATCH EXISTING

PAINT (PT)

COLOR AND FINISH TO MATCH EXISTING REMARKS: WALLS

PT-2
COLOR AND FINISH TO MATCH EXISTING **REMARKS: DOOR FRAMES**

MANUFACTURER: SHERWIN WILLIAMS COLOR: CEILING WHITE REMARKS: GYPSUM BOARD CEILING

TOILET PARTITIONS (TPT)

MATERIAL: STAINLESS STEEL FINISH: SATIN

SOLID SURFACE FABRICATION (SSF)

MANUFACTURER: CORIAN COLOR: ARROWROOT


PLASTIC LAMINATE (PL)

MANUFACTURER: WILSONART PATTERN: LOFT OAK COLOR: 7968K-12


FINISH: SOFT GRAIN WITH AEON


FINISH NOTES


- INTERIOR FINISHES TO COMPLY WITH NFPA 101, SECTION 14.3.3 INTERIOR FINISHES.
- PER NFPA 101, SECT. 14.3.3 INTERIOR WALL AND CEILING FINISH MATERIALS TO BE CLASS B MINIMUM, UNO.
- 3. PER NFPA 101, SECT 14.4.4 INTERIOR FLOOR FINISH SHALL COMPLY WITH 10.2.7
- 4. INTERIOR WALL AND CEILING FINISH MATERIALS TO COMPLY WITH NFPA 286.
- PROVIDE METAL TRIM FINISHING STRIPS AT ALL TILE FLOORING TRANSITIONS.
- FLOORING TRANSITIONS TO COMPLY WITH FLORIDA BUILDING CODE, SIXTH EDITION, SECTION 303.
- REFERENCE FLOOR AND WALL LEGEND FOR FINISH CODE.
- 8. FLOOR TRANSITIONS BETWEEN ROOMS TO BE CENTERLINE OF DOOR UNLESS NOTED OTHERWISE.
- REFER TO REFLECTED CEILING PLAN SHEETS FOR CEILING HEIGHTS AND DESIGN COORDINATION.
- 10. PROVIDE AND INSTALL SATIN ANODIZED METAL COVE TRIM AT INSIDE CORNERS OF FLOOR TILE TO WALL TILE TRANSITION. TRIM TO BE SCHLUTER DILEX-AHK.
- 11. NEW TOILET PARTITIONS TO BE TPT-1.
- 12. NEW BASE AND UPPER CABINETS TO BE PL-1, UNLESS NOTED OTHERWISE.
- 13. ALL TILE (FLOORING AND WALL) WILL BE PROVIDED AND INSTALLED UNDER OWNER'S STATE CONTRACT. THE GENERAL CONTRACTOR WILL SCHEDULE, COORDINATE, AND SUPERVISE THE WORK.

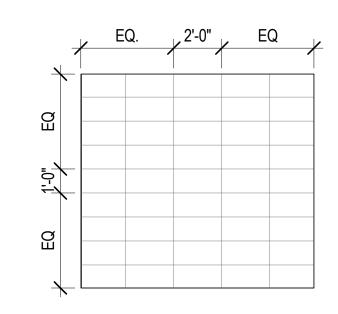



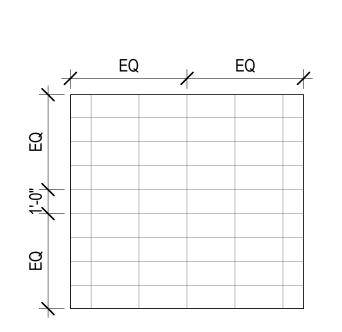


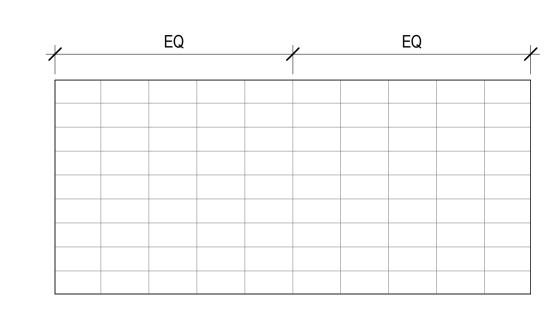

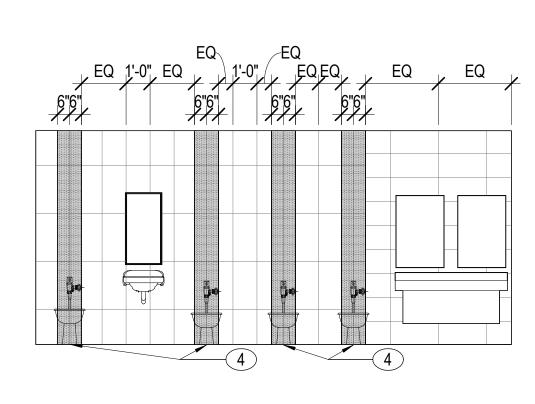


WOMEN - SOUTH ELEVATION


SCALE: 1/4" = 1'-0"

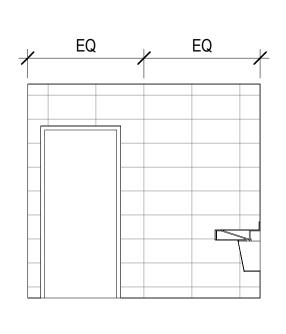


MEN - WEST ELEVATION

SCALE: 1/4" = 1'-0"

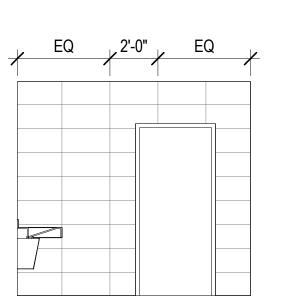


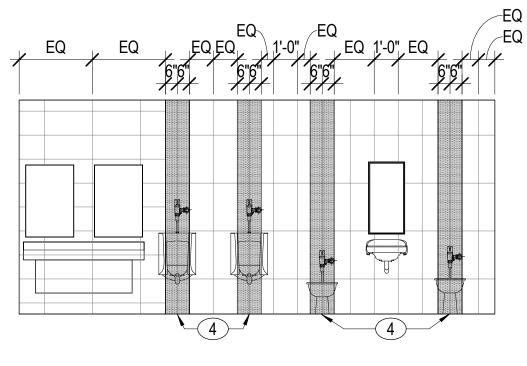


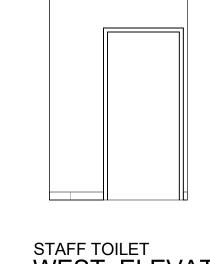

STAFF TOILET
WEST ELEVATION


SCALE: 1/4" = 1'-0"

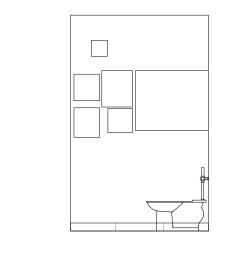

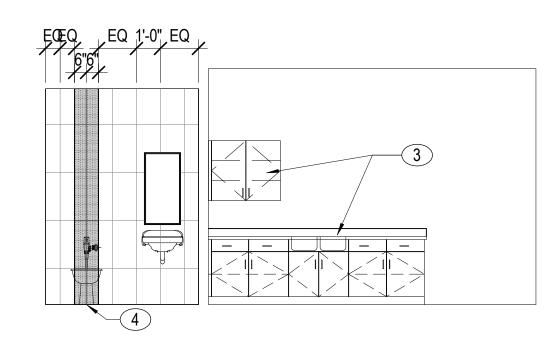

STAFF TOILET & BREAK RM WEST ELEVATION

SCALE: 1/4" = 1'-0"

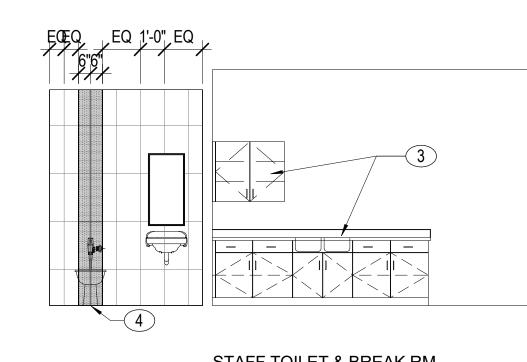

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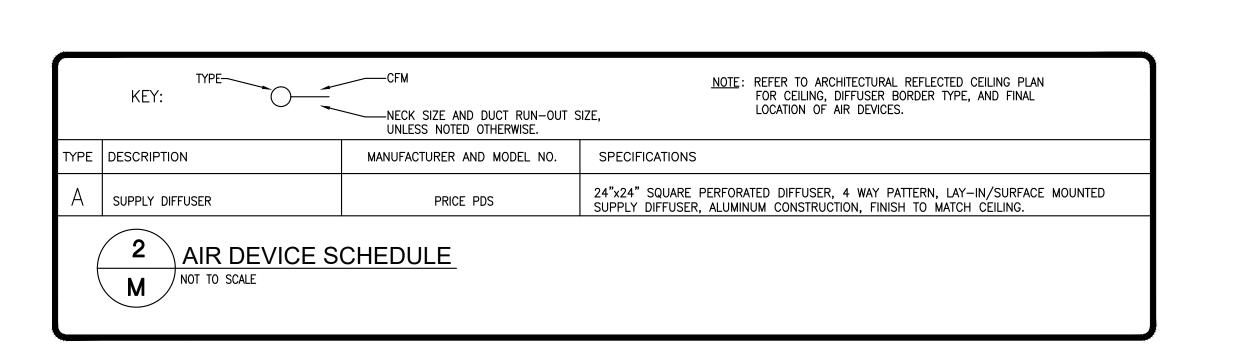
RONALD N. LANG RLA PROJ. NO:

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DRAWING TITLE:

SOUTHEAST **BRANCH FINISHES**

IN-1








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ORANGE COUNTY LIBRARY SYSTEM RESTROOM REFURBISHMENT SOUTHEAST BRANCH
5575 S SEMORAN BLVD., ORLANDO, FL.
CONTRACT DOCUMENTS

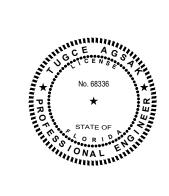


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DRAWING TITLE: SE MECHANICAL FLOOR PLAN

M2.01



1 EXISTING EQUIPMENT TO REMAIN IN NEW CEILING GRID. REPLACE GRILLE ONLY IN KIND. CONTRACTOR SHALL CONFIRM THE EQUIPMENT IS IN GOOD OPERATING CONDITION.

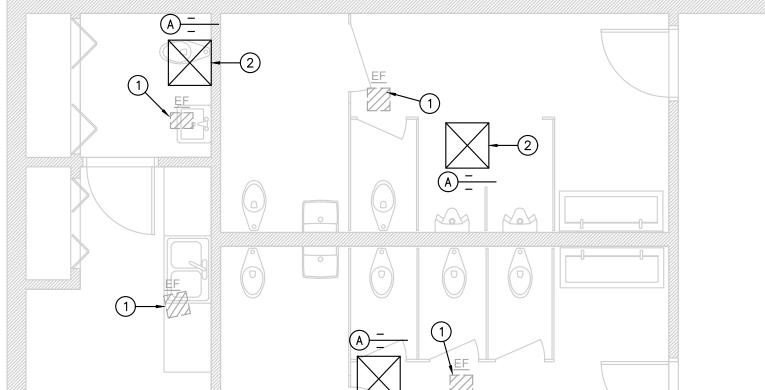2 REPLACE ALL EXISTING AIR DEVICES WITH NEW. USE EXISTING TAPS AND NECK SIZES.

MECHANICAL KEY NOTES:



FIRE PROTECTION KEY NOTES:


- 1 EXISTING PLUMBING FIXTURES TO BE REMOVED AND RETURNED TO OWNER. UNUSED SANITARY, VENT AND WATER PIPING SHALL BE CAPPED BELOW GRADE, ABOVE CEILING AND/OR BEHIND WALL IN ACCORDANCE WITH CODE. RECONNECT FIXTURES TO EXISTING PIPING IN WALL. FLOOR DRAINS TO REMAIN IN PLACE.
- 2 PROVIDE TEMPERATURE LIMITING DEVICES IN ACCORDANCE WITH FBPC-2017 SECTION 416.5 FOR LAVATORIES. MIXING VALVE SHALL BE WATTS LFMMV OR APPROVED EQUAL. TEMPERATURE SHALL NOT EXCEED 104°F.
- (1) EXISTING SPRINKLER HEADS AND PIPING TO REMAIN.

PLUMBING GENERAL NOTES:


- 1. COORDINATE EXACT LOCATION OF ALL PLUMBING SYSTEMS AND DEVICES IN CABINETS AND AT FIXTURE LOCATIONS WITH GENERAL CONTRACTOR PRIOR TO INSTALLATION.
- 2. PLUMBING CONTRACTOR SHALL PROVIDE ANY ADDITIONAL OFFSETS AND FITTINGS REQUIRED FOR PROPER INSTALLATION
- 3. ALL PLUMBING INSTALLATION AND MATERIALS SHALL BE IN STRICT ACCORDANCE WITH ALL LOCAL, STATE AND FEDERAL CODES AND APPLICABLE STANDARDS, REGULATIONS AND AUTHORITIES HAVING JURISDICTION OVER THIS PROJECT.
- 4. SANITARY DRAINAGE PIPING SHALL SLOPE NO LESS THAN 1/4" FALL PER FOOT FOR PIPES SMALLER THAN 3" AND 1/8" FALL PER FOOT FOR PIPES 3" AND LARGER.
- 5.. SEE ARCHITECTURAL DRAWINGS FOR EXACT PLUMBING FIXTURE LOCATIONS, MOUNTING HEIGHTS, DIMENSIONS, AND HANDICAPPED REQUIREMENTS.
- 6. ALL WORK AND EQUIPMENT SHALL MEET THE REQUIREMENT OF THE MOST RECENTLY REVISED VERSION OF ALL APPLICABLE LAWS, RULES, REGULATION, AND ORDINANCES OF FEDERAL, STATE, AND LOCAL AUTHORITIES, WHETHER INDICATED ON THE DRAWINGS OR NOT.
- 7. ADHERE TO THE DRAWINGS WHEN REQUIREMENTS ARE STRICTER THAN CODE REQUIREMENTS AND ARE PERMITTED UNDER THE CODE.
- REPORT ANY ALTERATION TO AND/OR DEVIATIONS FROM THE DRAWINGS AS REQUIRED BY THE ABOVE AUTHORITIES TO THE ARCHITECT AND SECURE HIS APPROVAL BEFORE STARTING ALTERATIONS.
- 9. THE CONTRACTOR SHALL REQUEST SUPPLEMENTARY INSTRUCTIONS FROM THE ARCHITECT IN ALL CASES OF DOUBT AS TO THE WORK INTENDED, OR IF ADDITIONAL EXPLANATION IS NEEDED.
- 10. PLUMBING CONTRACTOR SHALL INSTALL DIELECTRIC UNIONS AT ALL CONNECTIONS OF DISSIMILAR METALS.
- 11. PLUMBING FIXTURES AND EQUIPMENT SHALL BE INSTALLED COMPLETE WITH TRIM AND ALL OTHER APPURTENANCES REQUIRED TO CONNECT TO ROUGH-IN PIPING AT FLOORS AND WALLS UNLESS OTHERWISE SPECIFIED.
- 12. ALL EXISTING PLUMBING FIXTURES AND EQUIPMENT THAT ARE NOT REUSED SHALL BE RETURNED TO THE OWNER.
- 13. ALL ABOVE FLOOR DOMESTIC WATER PIPING SHALL BE TYPE L HARD DRAWN COPPER CONFORMING TO ASTM B88.
- 14. ALL DRAINAGE AND VENT PIPING SHALL BE SCHEDULE 40 PVC. PIPE AND FITTINGS WITH SOLVENT WELDED JOINTS.
- 15. <u>DOMESTIC WATER PIPING:</u>
- A PROVIDE VALVE IN BRANCH LINES TO EACH PIECE OF WATER CONSUMING EQUIPMENT OR FIXTURE. STOP VALVES SATISFY THIS REQUIREMENT.
- B. CLEANING WATER PIPING; CLEAN ALL WATER PIPING. INCLUDE SURGE TANKS, STORAGE VESSELS, AND ALL COMPONENTS AND DEVICES IN THE PIPING SYSTEM. FLUSH THOROUGHLY, STERILIZE WITH CHLORINE SOLUTION FOR MINIMUM 24 HOURS, THEN FLUSH CLEAN. STRENGTH OF CHLORINE SOLUTION AND METHODS MUST COMPLY WITH CITY CODE AND HEALTH AUTHORITIES. AT COMPLETION, THERE MUST BE NO DISCERNIBLE ODOR. POST WARNINGS UNTIL STERILIZATION IS COMPLETE.

16. DOMESTIC HOT WATER PIPING SYSTEMS:

- A. <u>PIPE:</u> MATERIALS SHALL BE 1" THICK FACTORY MOLDED FIBERGLASS PIPE COVERING, DENSITY NOT LESS THAN 3 LBS PER CU.FT., CONDUCTIVITY (K) NOT HIGHER THAN .25 AT 100°F MEAN TEMPERATURE DIFFERENCE, WITH FACTORY ATTACHED WHITE AS-J JACKET.
- FITTING AND OTHER COMPONENTS: MATERIALS SHALL BE PRE-MOLDED OR JOB FORMED COVER OF SAME MATERIAL AS PIPE COVERING. FINISHED INSULATION THICKNESS SHALL NOT BE LESS THAN ADJACENT PIPE.

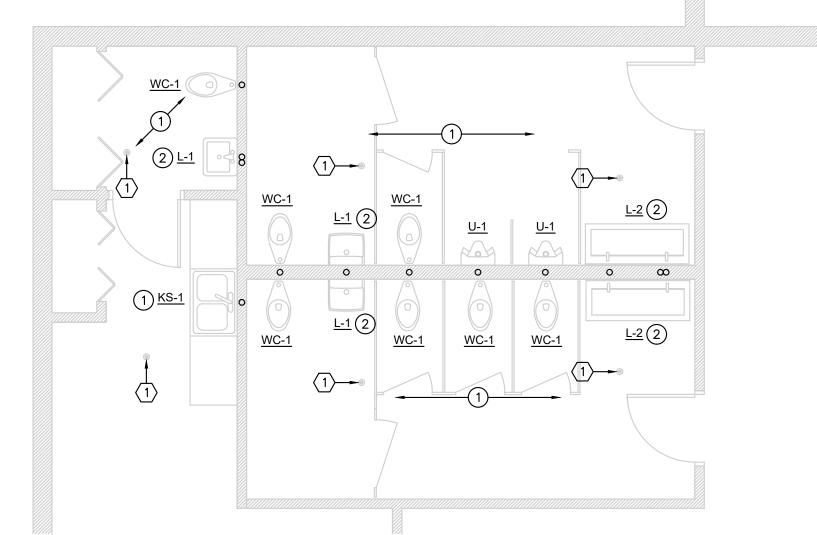



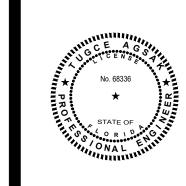

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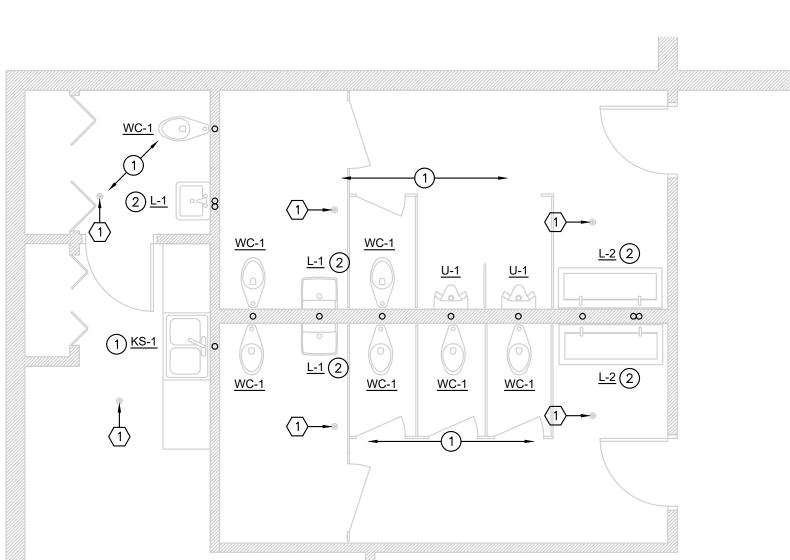
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TITLE: **PLUMBING** FLOOR PLANS **NOTES AND** SCHEDULES



	PLUMBING FIXTURE SCHEDULE													
CONNECTION SIZES SPECIFICATIONS														
P-NO.	FIXTURE DESCRIPTION	MOUNTING HEIGHT	C.W.	H.W.	WASTE	VENT	MANUFACTURER	MODEL #	FLUSH VALVE	FAUCET	NOTES			
L-1	WHITE LAVATORY SINK & FAUCET, WALL MOUNT	SEE ARCH FOR MOUNTING HEIGHT	1/2"	1/2"	2"	1-1/2"	AMERICAN STANDARD	LUCERNE 0356.041		CHICAGO FAUCETS 116.201.AB.1	WALL MOUNT, NEW VALVE STOPS AND TRAP WRAP; WHITE VITREOUS CHINA WITH FRONT OVERFLOW, SINGLE HOLE, WHITE FINISH. FAUCET — CHICAGO FAUCETS #116.201.AB.1, ELECTRONIC SENSOR FAUCETS, DECK MOUNT, SINGLE HOLE HYTRONIC, DUAL BEAM INFRARED SENSOR, 0.5 GPM VANDAL PROOF NON—AERATING SPRAY, BATTERY POWERED. PROVIDE W/ TEMPERATURE MIXING VALVE.			
L-2	60"x22"x5" WALL MOUNTED DECK LAVATORY SYSTEM W/ TWO DECK MOUNTED FAUCETS	SEE ARCH FOR MOUNTING HEIGHT	1/2"	1/2"	2"	1-1/2"	B. SHEA SURFACES	CUSTOM		CHICAGO FAUCETS 116.201.AB.1	SINK — B. SHEA SURFACES #CUSTOM, DECK MOUNTED, MONOLITHIC CONSOLE, TWO STATION LAVATORY, PROVIDE W/ SINK CONNECTOR, MOUNTING HARDWARE PROVIDED BY OTHERS. FAUCET — CHICAGO FAUCETS #116.201.AB.1, ELECTRONIC SENSOR FAUCETS, DECK MOUNT, SINGLE HOLE HYTRONIC, DUAL BEAM INFRARED SENSOR, 0.5 GPM VANDAL PROOF NON—AERATING SPRAY, BATTERY OPERATED.			
KS-1	33"x22"x6" DOUBLE BOWL, KITCHEN SINK, TOP MOUNT	SEE ARCH FOR MOUNTING HEIGHT	1/2"	1/2"	2"	1-1/2"	AMERICAN STANDARD	COLONY 22DB.6332283S.075		AMERICAN STANDARD 7074000.075	SINK - AMERICAN STANDARD #COLONY 22DB.63322B3S.075, 50/50 DOUBLE BOWL SINK, 3-HOLE, 20 GAUGE STAINLESS STEEL, ADA COMPLIANT. FAUCET - AMERICAN STANDARD #7074000.075, 1.5 GPM, METAL DECK AND HANDLE.			
WC-1	WATER CLOSET	REFER TO ARCHITECTURAL PLANS FOR EXACT MOUNTING HEIGHT	1/2"	-	4"	2"	ZURN	Z5615-BWL	ZURN ZZTR6200EV		TOILET — ZURN #Z5645—BWL, FLOOR MOUNT, VITREOUS CHINA, SIPHON JET FLUSHING, ELONGATED FRONT RIM, 1—1/2" TOP SPUD, ADA COMPLIANT, PROVIDE W/ ZURN #Z5955SSELSTS SEAT. FLUSH VALVE — ZURN #ZZTR6200EV, 1.28 GPF, CHROME PLATED, MECHANICAL MANUAL OVERRIDE BUTTON. BATTERY OPERATED.			
U-1	URINAL WALL HUNG 0.5 GPF	REFER TO ARCHITECTURAL PLANS FOR EXACT MOUNTING HEIGHT	3/4"	-	3"	2"	ZURN	Z5755-U	ZURN ZZTR6203ULF		URINAL — ZURN #Z5755—U, WALL MOUNT, VITREOUS CHINA, INTEGRAL TRAP, 3/4" TOP CONNECTION SPUD. FLUSH VALVE — ZURN #ZZTR6203ULF, 0.125 GPF, CHROME PLATED, MECHANICAL MANUAL OVERRIDE BUTTON. BATTERY POWERED.			