CONSTRUCTION PLANS FOR: BERRY DEASE ROAD WATER MAIN EXTENSION AND

FORCE MAIN REPLACEMENT PROJECT

BOARD OF COUNTY COMMISSIONERS

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PREPARED BY:


CPH, INC.

1117 East Robinson Street, Orlando, Fl. 32801 Phone: 407.425.0452 Fax: 407.648.1036 Certificate of Authorization No. 3215

ATTENTION IS DIRECTED TO THE FACT THAT THESE PLANS MAY HAVE BEEN REDUCED IN SIZE BY REPRODUCTION. THIS MUST BE CONSIDERED WHEN OBTAINING SCALED DATA. DIMENSION INFORMATION SHOULD NOT BE OBTAINED BY SCALING THE PLANS.

ORANGE COUNTY UTILITIES DEPARTMENT
ENGINEERING DIVISION
COUNTY, FLORIDA

COUNTY SEQUENCE NUMBER: 80806ORANGE COUNTY CAPITAL NUMBER: FM: 1539-0043 WM: 1450-60

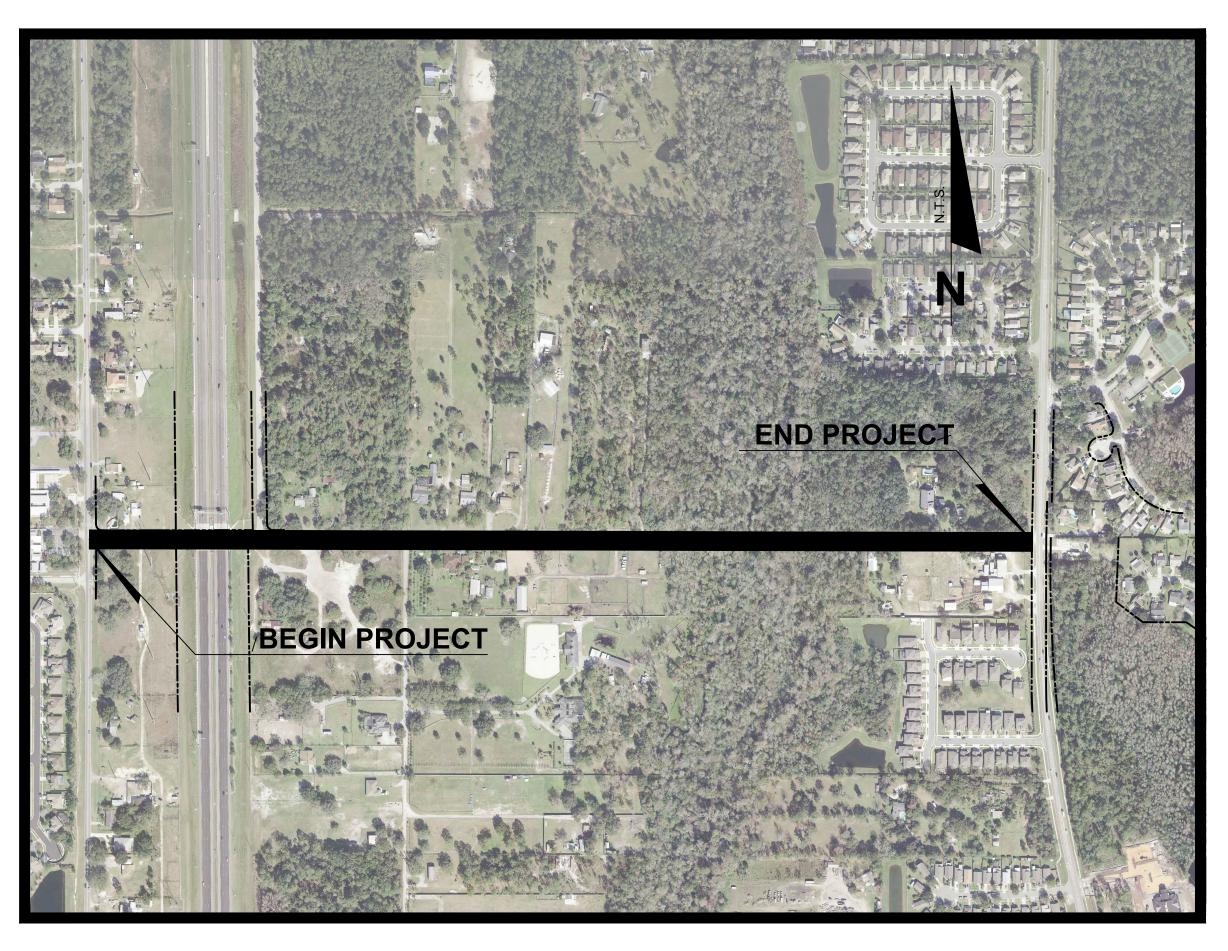

VICINITY MAP

DRAWING INDEX

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14 OF 21	C105	SITE PLAN AND PROFILE - STA. 123+80 TO STA. 129+80
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	UTILITY CONTACTS	
UTILITIES	COMPANY	TELEPHONE
WATER	ORANGE COUNTY UTILITIES DEPARTMENT	(407) 254-9680
SANITARY SEWER	ORANGE COUNTY UTILITIES DEPARTMENT	(407) 254-9680
RECLAIMED WATER	ORANGE COUNTY UTILITIES DEPARTMENT	(407) 254-9680
ELECTRIC	DUKE ENERGY	(407) 359-4404
TELEPHONE	CENTURY LINK	(407) 830-3279
CABLE - TV	SPECTRUM	(407) 532-8509
GAS	TECO (PEOPLE GAS)	(407) 532-8509
SUNSHINE 811 (SSOCOF, INC)		(800) 432-4770 OR 811
OCU CONSTRUCTION DIVISION		(407) 254-9798
OCU ENGINEERING DIVISION		(407) 254-9900
OCU CONSTRUCTION DIVISION	S INSPECTOR	(407) 254-9798
OCU DISPATCH OPERATOR		(407) 836-2777

NOTE: THIS LISTING IS PROVIDED AS AN AID. IT IS THE RESPONSIBILITY OF THE CONTRACTOR TO NOTIFY AND ARRANGE FOR FIELD LOCATION OF ALL FACILITIES THAT WILL BE ENCOUNTERED DURING CONSTRUCTION.

<u>LEGEND</u> OPEN CUT AND RESTORE ROADWAY REMOVE AND REPLACE EXISTING STABILIZED DIRT DRIVEWAY REMOVE AND REPLACE EXISTING CONCRETE DRIVEWAY WM EXISTING OCU WATER MAIN TO REMAIN PROPOSED OCU WATER MAIN SAN EXISTING OCU GRAVITY MAIN TO REMAIN FM EXISTING OCU FORCE MAIN TO REMAIN PROPOSED OCU FORCE MAIN FM EXISTING OCU FORCE MAIN TO BE REMOVED EXISTING STORM SEWER RIGHT OF WAY LINE

Abbreviation Legend:

A)	- ACTUAL	MES	- MITERED END SECTION
,	- AIR CONDITIONER		- MANHOLE
ACSM	- AMERICAN CONGRESS ON SURVEYING & MAPPING		- METAL LIGHT POLE
	- AMERICANS WITH DISABILITIES ACT		- MILES PER HOUR
	- AMERICAN LAND TITLE ASSOCIATION		- METAL POWER POLE
	- APPROXIMATE	N/A	- NOT APPLICABLE
	- AIR RELEASE VALVE - AVENUE		RTH AMERICAN VERTICAL DATUM
	- AVENGE - AVERAGE		- NORTH AMERICAN DATUM - NATURAL GROUND
	- BEARING BASIS		- NATIONAL GROUND - NATIONAL GEODETIC SURVEY
,	- BACK FLOW PREVENTER		IONAL GEODETIC VERTICAL DATUM
BLK	- BLOCK	N & D - NAIL	
	- BUILDING	NO.	- NUMBER
	- BOULEVARD	NR	- NON-RADIAL
	- BENCH MARK	NSPS	- NATIONAL SOCIETY OF
	- BACK OF CURB - BACK OF WALK		FESSIONAL SURVEYORS
	- BUILDING SETBACK LINE	NT NTS	- NON-TANGENT - NOT TO SCALE
	- BARBED WIRE FENCE	OD	- OUTSIDE DIAMETER
	- DENOTES SHEET NUMBERING FOR ENGINEERING PLANS	ORB	- OFFICIAL RECORDS BOOK
	- CALCULATED	OR	- OFFICIAL RECORDS
	- CHORD	OUL	- OVERHEAD UTILITY LINES
	- CABLE TELEVISION RISER	OTL	- OVERHEAD TRAFFIC LINES
	- CHORD BEARING	\ /	- PLAT
	- CONCRETE BLOCK STRUCTURE		- PLAT BOOK
	- CERTIFIED CORNER RECORD		- POINT OF CURVATURE
	- CURB & GUTTER - CATCH INLET		- POINT OF COMPOUND CURVATURE
	- CENTERLINE	PCP PFF	- PERMANENT CONTROL POINT - PROPOSED FINISHED FLOOR
	- CHAIN LINK FENCE		- PAGE
	- CONCRETE MONUMENT		- PAGES
	- CORRUGATED METAL PIPE		- POINT OF INTERSECTION
	- CLEANOUT		- PARKER KAYLON
CONC	- CONCRETE		- POINT OF BEGINNING
	- CORNER	POC	- POINT OF COMMENCEMENT
	RUGATED PLASTIC PIPE	POL	- POINT ON LINE
	- COUNTY UTILITY EASEMENT	PP	- POWER POLE
	- CROSSWALK SIGNAL		- POINT OF REVERSE CURVATURE
	- DELTA		- PERMANENT REFERENCE MONUMENT
,	- DESCRIPTION - DEED BOOK		- PROFESSIONAL SURVEYOR & MAPPER
	- DEED BOOK - DIAMETER AT BREAST HEIGHT IN INCHES		- POINT OF TANGENCY
	- DRAINAGE EASEMENT		- POLYVINYL CHLORIDE PIPE - PAVEMENT
	- DEPARTMENT	R31E	- RANGE 31 EAST
	- DUCTILE IRON PIPE	R	- RADIUS
	- DRIVE		- RADIAL
D/U	- DRAINAGE AND UTILITY EASEMENT		- REINFORCED CONCRETE PIPE
,	- ENGINEERING PLAN	REC	- RECOVERED
	- ELECTRIC JUNCTION BOX	REV	- REVISION
	- UNDERGROUND ELECTRICAL LINES		- RADIUS POINT
	- ELECTRIC		- RIGHT-OF-WAY
	- ELEVATION - ELLIPTICAL		- REGISTERED LAND SURVEYOR
	- END OF INFORMATION		- RADIUS POINT
	- EDGE OF PAVEMENT		- UNDERGROUND RECLAIM WATER LINE - RECLAIMED WATER METER
	- FIELD BOOK		- SPECIAL EASEMENT
	- FLORIDA DEPARTMENT OF TRANSPORTATION		- SECTION 31
F	- FINISH FLOOR		- SANITARY SEWER MANHOLE
:GI	- FLAT GRATE INLET		- STATE PLANE
	- FIBERGLASS LIGHT POLE	SQ	- SQUARE
	- FIRE HYDRANT		- SQUARE FEET
	- FORCE MAIN		- STREET
	- FOUND - FLORIDA POWER AND LIGHT		RM DRAINAGE MANHOLE
	- FLORIDA FOWER AND LIGHT - FLORIDA STATUTES		- SIDEWALK - TANGENT BEARING
	- GRID (STATE PLANE)		- TANGENT BEARING - TOWNSHIP 22 SOUTH
•	- UNDERGROUND GAS LINES		- TELEPHONE
	- GOVERNMENT	TL	- OVERHEAD TRAFFIC SIGNAL LINES
	- GROUND PENETRATING RADAR		- TOP OF BANK
STMH	- GREASE TRAP MANHOLE		- TOE OF SLOPE
	- HIGH DENSITY POLYETHYLENE PIPE	TR	- TELEPHONE RISER
	- HOG WIRE FENCE	TRANS	- TRANSFORMER
	- IDENTIFICATION	TSB	- TRAFFIC SIGNAL BOX
	- IRRIGATION CONTROL VALVE	TSSP	- TRAFFIC SIGNAL SUPPORT POLE
	- INFORMATION	TVL	- UNDERGROUND CABLE TV LINES
	- INVERT - IRON PIPE	(TYP) - TYP	
	- IRON PIPE & CAP		- UTILITY EASEMENT - UNKNOWN
	- IRON FIFE & CAF - IRON ROD		- UNKNOWN - UNDERGROUND TELEPHONE LINES
	- IRON REBAR & CAP		- WITH
	- IRRIGATION		- UNDERGROUND WATER LINE
	- ARC LENGTH		- WOOD LIGHT POLE
	- LICENSED BUSINESS NUMBER		- WATER METER
	- LIGHT POLE		- WORK PROGRAM
,	- MEASURED		- WOOD POST FENCE
	- MAP BOOK		- WOOD POWER POLE
ИBX	- MAILBOX	WV	- WATER VALVE

DESCRIPTION LINE IS 2 INCHES AT FULL SIZE (IF NOT SCALE ACCORDINGLY)

ORANGE COUNTY
UTILITIES DEPARTMENT
ENGINEERING DIVISION

9150 CURRY FORD ROAD ORIANDO TI



A Full Service A & E Firm M/E/P Planners

1117 East Robinson Street ~ Orlando, FL 32801 ~ Phone: 407.425.0452

Eng. C.O.A. No. 3215 Survey L.B. No. 7143 Arch. Lic. No. AA2600926

LOCATION MAP, DRAWING INDEX & LEGEND BERRY DEASE ROAD WATER MAIN EXTENSION AND FORCE MAIN REPLACEMENT PROJECT

	BID SET	Γ
	OCU FILE NO.: 85506	SCALE: AS SHOWN
	DESIGNED BY: DEM	DRAWING NO. :
	DRAWN BY: GNP	G-200
DAVID E. MAHLER	CHECKED BY: DEM	G-200
PROFESSIONAL ENGINEER FLORIDA LICENSE #50041	CADD FILE: O28509 Cover	SHEET: 2 OF

GENERAL CONSTRUCTION NOTES

- ALL WORK AND REQUIREMENTS FROM THE NOTES IN THIS PAGE SHALL BE A REQUIREMENT OF THE CONTRACT AND EXECUTED BY THE CONTRACTOR AT NO ADDITIONAL COST.
- 1. THE UTILITIES IMPROVEMENTS AND ADJUSTMENTS SHOWN ON THESE DRAWINGS ARE INTENDED TO MAINTAIN THE INTEGRITY OF THE ORANGE COUNTY WATER AND WASTEWATER SYSTEMS. THE DRAWINGS DO NOT INCLUDE WORK PERFORMED ON, OR FOR UTILITY SYSTEMS OWNED BY OTHERS, UNLESS STATED OTHERWISE ON THE DRAWINGS.
- 2. CONTRACTOR SHALL EXERCISE EXTREME CAUTION WHEN EXCAVATING IN PROXIMITY OF WATER MAINS, WASTEWATER FORCE MAINS, GRAVITY MAINS AND RECLAIMED WATER MAINS. LOCATIONS OF EXISTING UTILITIES AS SHOWN ARE APPROXIMATE RECORD DRAWING INFORMATION FROM ORANGE COUNTY, GPR INVESTIGATIONS AND FIELD LOCATES. THE CONTRACTOR SHALL FIELD VERIFY THE EXISTENCE AND LOCATION OF ALL ABOVEGROUND AND UNDERGROUND UTILITIES. CONTRACTOR SHALL CONTACT UTILITY OWNERS AT LEAST SEVEN (7) DAYS PRIOR TO CONSTRUCTION AND A MINIMUM OF 48 HOURS PRIOR TO ANY EXCAVATION. ORANGE COUNTY SHALL BE NOTIFIED IN WRITING IMMEDIATELY IF ANY DISCREPANCIES ARE IDENTIFIED OR IF CONFLICTS EXIST.
- 3. THE ORANGE COUNTY UTILITIES CONSTRUCTION DIVISION SHALL BE NOTIFIED AT LEAST SEVEN (7) DAYS PRIOR TO ANY CONSTRUCTION ACTIVITY, OR PRIOR TO ANY ACTIVITY REQUIRING THE PRESENCE OF OR AN ACTION BY UTILITIES STAFF SUCH AS SCHEDULING VALVE OPERATION, PRESSURE TESTING, PIPE CONNECTION, PUMP STATION OPERATIONS OR SHUTDOWNS, ETC.
- 4. WATER, WASTEWATER AND REUSE VALVES, PUMP STATIONS OR OTHER UTILITY INFRASTRUCTURE ARE TO BE OPERATED ONLY BY ORANGE COUNTY UTILITIES PERSONNEL. ALL VALVES BEING INSTALLED ARE TO REMAIN CLOSED DURING CONSTRUCTION.
- 5. ALL EXISTING WATER MAIN, FORCE MAINS, GRAVITY PIPES AND OTHER UTILITY FACILITIES WITHIN THE LIMITS OF THE PROJECT SHALL BE SUPPORTED AND PROTECTED AGAINST DAMAGE DURING CONSTRUCTION.
- 6. THE ORANGE COUNTY WATER DIVISION (407-254-9850) AND THE ORANGE COUNTY WATER RECLAMATION DIVISION (407-254-9680) SHALL BE NOTIFIED AT LEAST SEVEN (7) DAYS IN ADVANCE TO SCHEDULE MAIN TIE-INS AND VALVE OPERATIONS.
- 7. WATER, WASTEWATER AND REUSE VALVES ARE TO BE OPERATED BY ORANGE COUNTY UTILITIES STAFF COORDINATED BY OCU RPR (407-254-9798). ALL VALVES BEING INSTALLED ARE TO REMAIN CLOSED DURING CONSTRUCTION.
- 8. FOR OPERATION OF ORANGE COUNTY PUMP STATIONS THE CONTRACTOR SHALL COORDINATE ALL PUMP STATION OPERATION AND SHUT DOWN WITH AN ORANGE COUNTY UTILITIES RPR (407-254-9798).
- 9. FLUSHING, HYDROSTATIC TESTING AND DISINFECTING OF WATER MAINS SHALL BE PERFORMED BY THE CONTRACTOR IN ACCORDANCE WITH AWWA SPECIFICATIONS C-600, C-651 AND THE PROJECT SPECIFICATIONS. FITTINGS AND MINOR REPLACEMENT SEGMENTS REQUIRED TO MAKE CONNECTIONS TO EXISTING WATER LINES SHALL BE THOROUGHLY DISINFECTED BY SWABBING THE ENTIRE INTERIOR WITH A MINIMUM 5% CHLORINE SOLUTION PRIOR TO INSTALLATION. CONTRACTOR SHALL PROVIDE ALL NECESSARY EQUIPMENT, MATERIALS, AND MANPOWER TO ACCOMPLISH THESE OPERATIONS. AUTHORIZED ORANGE COUNTY UTILITIES PERSONNEL SHALL BE PRESENT DURING THE TEST. COORDINATE WITH ORANGE COUNTY UTILITIES RPR AT LEAST SEVEN (7) DAYS PRIOR TO START THIS WORK.
- 10. ALL EXISTING WATER MAINS AND FORCE MAINS SHALL REMAIN IN SERVICE UNTIL THE PROPOSED WATER MAINS OR FORCE MAINS ARE ACCEPTED FOR SERVICE AND ALL SERVICES ARE TRANSFERRED TO THE NEW MAINS. THE CONTRACTOR SHALL COORDINATE WITH THE WATER AND WASTEWATER DEPARTMENT AT LEAST FIVE (5) WORKING DAYS IN ADVANCE FOR ALL THE TIE-INS REQUIRING SHUT DOWN OF EXISTING MAINS. IN GENERAL, ALL SUCH SHUTDOWNS SHALL BE LIMITED TO THE HOURS BETWEEN NINE (9) A.M. AND THREE (3) P.M., MONDAY TO FRIDAY.
- 11. ALL EXISTING AND NEW OCU WATER AND SEWER VALVES, VALVE BOXES, AND MANHOLES SHALL BE PROTECTED AND ADJUSTED TO FINISHED GRADE AS SHOWN ON THE DRAWINGS. VALVE AND VALVE BOXES SHALL REMAIN ACCESSIBLE AT ALL TIMES. ANY VALVES THAT MIGHT BE COVERED DURING CONSTRUCTION SHALL BE MARKED WITH A MARKER (GREEN FOR SEWER AND BLUE FOR WATER), A MINIMUM OF FOUR (4) FEET ABOVE GRADE. ALL VALVES UNDER CONSTRUCTION ARE TO REMAIN CLOSED DURING CONSTRUCTION.
- 12. THE CONTRACTOR SHALL PROTECT EXISTING SERVICE CONNECTIONS DURING CONSTRUCTION AND SHALL COORDINATE THE RELOCATION OF SERVICES WITH THE ORANGE COUNTY RESIDENT PROJECT REPRESENTATIVE. THE CONTRACTOR WILL RELOCATE EXISTING SERVICES AS NECESSARY AND AS DIRECTED BY ORANGE COUNTY PERSONNEL.
- 13. SEE DETAIL SHEET FOR SEPARATION REQUIREMENTS BETWEEN WATER MAINS, SEWER MAINS AND OTHER PIPELINES AND MAINS. NO CONCRETE ENCASEMENT OF PIPES WILL BE PERMITTED.
- 14. WHEN USING SCALED DATA CONSIDER THAT THESE PLANS MAY HAVE ALTERED IN SIZE DURING REPRODUCTION.
- 15. WHEN OBTAINING DATA AND INFORMATION FROM THE PLANS, FIGURES SHALL BE USED IN REFERENCE TO SCALED DIMENSIONS AND LARGER SCALE DRAWINGS IN PREFERENCE TO SMALLER SCALE DRAWINGS.
- 16. DEWATER AS NECESSARY TO PREVENT WATER FROM ENTERING THE TRENCH DURING EXCAVATION AND PIPE INSTALLATION. PIPE SHALL NOT BE LAID IN WATER. ALL EXCAVATIONS SHALL BE BACKFILLED AT THE END OF EACH WORKDAY AND PIPE OPENINGS SHALL BE SEALED WITH WATERTIGHT MJ. PLUGS, PLYWOOD OR FILTER FABRIC IS NOT ACCEPTABLE.
- 17. ALL EXISTING FIRE HYDRANTS THAT ARE REMOVED SHALL BE DISPOSED OF BY THE CONTRACTOR. THE OWNER RESERVES THE RIGHT TO SALVAGE. NEW FIRE HYDRANTS SHALL BE LOCATED AS SHOWN ON THE PLANS AND COORDINATED WITH THE OWNER'S REPRESENTATIVE. HYDRANTS NOT IN SERVICE SHALL BE COVERED OR MARKED TO SHOW THEY ARE OUT OF SERVICE. HYDRANTS SHALL BE CONSTRUCTED FACING THE ROAD AND ADJUSTED TO FINAL ROAD GRADES.
- 18. PIPE LENGTHS SHOWN ON PLANS ARE APPROXIMATE. ACTUAL LENGTHS ARE TO BE DETERMINED DURING CONSTRUCTION.
- 19. ALL STATIONS AND OFFSETS REFER TO BASELINE OF STATIONING.
- 20. MAINTAIN EMERGENCY VEHICLE ACCESS TO ALL BUSINESSES AND RESIDENCES AT ALL TIMES.
- 21. ALL FITTINGS ON EXISTING MAINS ARE ASSUMED TO HAVE THRUST BLOCKS. CONTRACTOR SHALL USE CAUTION WHEN WORKING IN THESE AREAS.
- 22. LOCAL RESIDENTIAL AND COMMERCIAL BUSINESS ACCESS SHALL BE MAINTAINED AT ALL TIMES. PROVIDE WRITTEN NOTIFICATION TO RESIDENTS/PROPERTY OWNERS SEVEN (7) DAYS PRIOR TO IMPLEMENTING ANY ROADWAY OR DRIVEWAY CLOSURE.
- 23. THE CONTRACTOR SHALL EXERCISE EXTREME CAUTION WHEN EXCAVATING IN PROXIMITY OF WATER MAINS, WASTEWATER FORCE MAINS, GRAVITY MAINS, AND RECLAIMED WATER MAINS. MAIN LOCATIONS SHOWN ON PLANS ARE NOT EXACT OR GUARANTEED. CONTRACTOR IS RESPONSIBLE FOR FIELD VERIFYING EXISTING UTILITY LOCATIONS. CONTRACTOR IS RESPONSIBLE TO PROVIDE ALL NECESSARY SUPPORTS AND RESTRAINTS ON EXISTING LINES TO ALLOW FOR NEW CONSTRUCTION.
- 24. ALL MAINS SHALL BE CONSTRUCTED AS SHOWN ON THE PLANS. A MINIMUM COVER OF 36 INCHES SHALL BE MAINTAINED ON ALL MAINS, WHERE IT IS NOT OTHERWISE SPECIFIED ON PLANS OR DIRECTED BY THE ENGINEER. ALL DIRECTION CHANGES IN THE PIPE BOTH HORIZONTAL AND VERTICAL SHALL BE BY THE USE OF FITTINGS UNLESS OTHERWISE NOTED OR DIRECTED BY THE ENGINEER.

- 25. ALL PIPE SHALL BE RESTRAINED IN ACCORDANCE WITH THE RESTRAINT TABLES SHOWN ON THE DETAIL SHEETS. IN ADDITION, ALL FITTINGS SHALL BE MECHANICAL JOINT RESTRAINED. NO THRUST BLOCKS SHALL BE PERMITTED WITHOUT WRITTEN PERMISSION OF ORANGE COUNTY UTILITIES. RESTRAIN EXISTING PIPE WHERE REQUIRED IN ACCORDANCE WITH THE RESTRAINT TABLES.
- 26. PIPE SIZES SHOWN ON PLANS ARE MINIMUM INSIDE DIAMETER.
- 27. WHERE MINIMUM SEPARATION BETWEEN UTILITIES OR STORM SEWERS IS REQUIRED, THE DISTANCE IS MEASURED FROM THE OUTSIDE EDGE OF PIPE TO OUTSIDE EDGE OF PIPE.
- 28. RESTORE ALL EXISTING IMPROVEMENTS AND DISTURBED AREAS TO ORIGINAL CONDITION OR BETTER. PAVEMENT TO BE RESTORED IN ACCORDANCE WITH THE PAVEMENT RESTORATION DETAILS SHOWN ON THE CONSTRUCTION DETAIL SHEETS.
- 29. ALL CONNECTIONS TO EXISTING MAINS SHALL BE MADE BY THE CONTRACTOR ONLY AFTER THE PROPOSED CONNECTION PROCEDURE AND WORK SCHEDULE HAVE BEEN REVIEWED AND ACCEPTED BY THE OWNER. THE CONTRACTOR SHALL SUBMIT A WRITTEN REQUEST TO THE OWNER A MINIMUM OF FIVE (5) WORKING DAYS PRIOR TO SCHEDULING ANY CONNECTIONS. THE REQUEST SHALL REFERENCE THE PROFESSIONAL LAND SURVEYOR CERTIFIED COMPLETED AS-BUILT RECORD DRAWINGS PREVIOUSLY SUBMITTED AND SHALL OUTLINE THE FOLLOWING:
- a. POINTS OF CONNECTION, FITTINGS TO BE USED, METHODS OF FLUSHING AND DISINFECTION AND VERIFICATION OF RESTRAINT ON EXISTING PIPE.
- b. ESTIMATED CONSTRUCTION TIME FOR THE CONNECTIONS.
- THE OWNER SHALL REVIEW THE SUBMITTAL WITHIN FIVE (5) WORKING DAYS AFTER RECEIVING IT AND INFORM THE CONTRACTOR REGARDING APPROVAL OR DENIAL OF THE REQUEST. IF THE OWNER REJECTS THE REQUEST, THE CONTRACTOR SHALL RESUBMIT THE REQUEST MODIFYING IT IN A MANNER ACCEPTABLE TO THE OWNER. ALL CONNECTIONS SHALL ONLY BE MADE ON THE AGREED UPON DATE AND TIME. SHOULD THE CONTRACTOR NOT INITIATE AND COMPLETE THE CONNECTION WORK IN THE AGREED UPON MANNER, HE SHALL

BE REQUIRED TO RESCHEDULE THE CONNECTION BY FOLLOWING THE PROCEDURE OUTLINED ABOVE.

- 30. PROTECT EXISTING IMPROVEMENTS TO THE MAXIMUM EXTENT POSSIBLE. ALL DAMAGED SIDEWALK, ROADWAY PAVEMENT AND OTHER IMPROVEMENTS SHALL BE RESTORED TO ORIGINAL CONDITION.
- 31. ALL COUNTY ROADS TO BE OPEN CUT SHALL BE APPROVED BY ORANGE COUNTY PUBLIC WORKS PRIOR TO OPEN-CUTS. SUBMIT A MAINTENANCE OF TRAFFIC (MOT) PLAN CONFORMING TO ORANGE COUNTY RIGHT-OF-WAY UTILIZATION REGULATIONS TO ORANGE COUNTY PUBLIC WORKS A MINIMUM OF FOURTEEN (14) DAYS PRIOR TO ANY WORK WITHIN COUNTY RIGHT-OF-WAY. A COPY OF THIS PLAN SHALL ALSO BE SUBMITTED TO THE ENGINEER AND UTILITY COUNTY RPR. NOTIFY THE COUNTY PUBLIC WORKS DEPARTMENT AND UTILITY DEPARTMENT RPR 24 HOURS PRIOR TO ANY OPEN CUT OF ROADWAYS OR JACK AND BORE OPERATIONS WITHIN THE COUNTY RIGHT-OF-WAY. TWO WAY TRAFFIC MUST BE MAINTAINED AT ALL TIMES DURING THE COURSE OF CONSTRUCTION. MAINTAIN A SET OF COUNTY APPROVED CONSTRUCTION PLANS AND MOT PLANS AT THE CONSTRUCTION SITE AT ALL TIMES WHEN WORKING WITHIN THE COUNTY RIGHT-OF-WAY.
- 32. WATER AND SEWER LINE MARKERS SHALL BE PLACED EVERY 1,000 FT AND AT ALL VALVE AND DIRECTIONAL CHANGES. SEE VALVE AND PIPING MARKING DETAILS. NO MARKERS ARE REQUIRED AT VALVES ADJACENT TO FIRE HYDRANTS, OR IN RESIDENTIAL SUBDIVISIONS.
- 33. IMMEDIATELY AT ONSET OF CONSTRUCTION, CONTRACTOR SHALL FIELD VERIFY HORIZONTAL AND VERTICAL LOCATIONS OF ALL EXISTING UTILITIES CRITICAL TO COMPLETING THE PROJECT (INCLUDING WATER, SEWER, POWER, TELEPHONE, GAS, AND CABLE TV) AND SHALL EVALUATE POTENTIAL CONFLICTS IN A WRITTEN REPORT. ANY CONFLICTS SHALL BE REPORTED TO ENGINEER/OWNER IMMEDIATELY UPON DISCOVERY AND DETAILED IN THE REPORT.
- 34. NO VALVE BOXES, METERS, PORTIONS OF MANHOLES, OR OTHER APPURTENANCES OF ANY KIND RELATING TO ANY UNDERGROUND UTILITIES SHALL BE LOCATED IN ANY PORTION OF A CURB-AND-GUTTER SECTION. CONTRACTOR SHALL ADVISE ENGINEER IMMEDIATELY UPON DISCOVERY OF A POTENTIAL CONFLICT.
- 35. WHERE REQUIRED, AT NO ADDITIONAL COST TO THE COUNTY, THE CONTRACTOR SHALL USE TEMPORARY SHEETING OR TRENCH BOXES TO MINIMIZE THE SIZE OF EXCAVATIONS AND PROTECT EXISTING ROADWAYS, UTILITIES AND OTHER FACILITIES. CONTRACTOR TO COMPLY WITH OSHA TRENCH SAFETY REQUIREMENTS AT ALL TIMES
- 36. CONTRACTOR TO PROVIDE DETAILED AS-BUILT DRAWINGS OF ALL UTILITIES UNCOVERED IN TRENCHES. THE AS-BUILTS SHALL RECORD LOCATION, SIZE, TYPE, ELEVATION AND OWNER OF ALL UTILITY FACILITIES UNCOVERED. THIS INFORMATION SHALL BE ADDED TO THE ASSET TABLES.
- 37. CONTRACTOR WILL NEED TO INSTALL NEW FORCE MAIN AND WATER MAIN PRIOR TO REMOVAL OF EXISTING WATER AND WASTEWATER SYSTEMS. REMOVE OLD FORCE MAIN TO INSTALL NEW WATER MAIN ON AERIAL CROSSING.
- 38. ALL NEW VALVES BEING INSTALLED SHALL REMAIN CLOSED DURING CONSTRUCTION. KEEP VALVES ON ALL WET TAPS CLOSED UNTIL CLEARED BY FDEP.
- 39. MAKE TEMPORARY CONNECTIONS TO AN EXISTING POTABLE WATER SOURCE; FLUSH OUT NEW WATER MAIN WITH POTABLE WATER (USE "JUMPER" ASSEMBLY WITH BACKFLOW PREVENTER TO MAKE TEMPORARY CONNECTIONS TO AN EXISTING WATER SOURCE.)
- 40. IN ALL LOCATIONS FOR CONNECTIONS TO EXISTING PRESSURIZED MAINS, CONTRACTOR SHALL BE REQUIRED TO RESTRAIN THE EXISTING MAINS IN ACCORDANCE WITH THE RESTRAINT TABLE.
- 41. IN ALL LOCATIONS WHERE NEW UTILITY LINES ARE BEING INSTALLED IN EXISTING ROAD, CONTRACTOR WILL BE REQUIRED TO OPEN CUT AND RESTORE ROAD.
- 42. FOR ALL NEW WATER SERVICE LINE REPLACEMENTS, CONTRACTOR SHALL REPLACE THE SERVICE LINE FROM THE ACTIVE MAIN ALL OF THE WAY TO THE METER SHUTOFF VALVE.
- 43. NEW MANHOLE TOPS HAVE BEEN ESTIMATED ON THEIR RELATION TO THE ROADWAY PGL AND THE OFFSET FROM THIS ALIGNMENT. CONTRACTOR IS RESPONSIBLE FOR SETTING FINAL TOP ELEVATION BASED UPON THE FINAL ROADWAY CONSTRUCTION GRADE.
- 44. FOR ALL PRESSURIZED UTILITY LINES THAT ARE TO REMAIN IN SERVICE IN THE AREAS OF DEMUCKING; THE CONTRACTOR SHALL BE REQUIRED TO INSTALL MECHANICAL RESTRAINTS ON ALL JOINTS. THE CONTRACTOR SHALL ALSO PROVIDE ALL REQUIRED SUPPORT AND PROTECTION OF THE UTILITY LINES TO MAINTAIN SERVICE TO ALL CUSTOMERS ON THESE SYSTEMS.
- 45. CONTRACTOR SHELL BE REQUIRED TO AS-BUILT ALL EXISTING WATER AND SANITARY FACILITIES THAT ARE REMAINING AND LOCATED WITHIN THE ROADWAY PROJECT LIMITS IN THE RIGHT OF WAY.

OCU GENERAL NOTES:

- 1. THE CONTRACTOR SHALL EXERCISE EXTREME CAUTION WHEN EXCAVATING IN PROXIMITY OF WATER MAINS, WASTEWATER FORCE MAINS, GRAVITY MAINS AND RECLAIMED WATER MAINS. MAIN LOCATIONS SHOWN ON PLANS MAY NOT BE EXACT. THE CONTRACTOR IS RESPONSIBLE FOR FIELD VERIFYING EXISTING UTILITY LOCATIONS.
- 2. SHOULD A PIPE EMERGENCY OCCUR, THE CONTRACTOR SHALL IMMEDIATELY NOTIFY THE OCU DISPATCH OPERATOR (407-836-2777) AND THE OCU RPR.
- 3. THE CONTRACTOR SHALL NOTIFY THE OCU CONSTRUCTION DIVISION AT LEAST SEVEN DAYS PRIOR TO COMMENCEMENT OF THE CONSTRUCTION PROJECT BY CALLING (407) 254-9798.
- 4. THE CONTRACTOR SHALL NOTIFY THE OCU CONSTRUCTION DIVISION AT LEAST 48 HOURS PRIOR TO ANY UTILITIES CONSTRUCTION BY CALLING (407) 254-9798.
- 5. THE MATERIALS, PRODUCTS, AND CONSTRUCTION OF ALL UTILITIES CONNECTING TO THE OCU SYSTEM SHALL BE IN CONFORMANCE WITH THE ORANGE COUNTY UTILITIES STANDARDS AND CONSTRUCTION SPECIFICATIONS MANUAL.
- 6. ALL OCU MAINS AND FACILITIES WITHIN THE LIMITS OF THE PROJECT SHALL BE SUPPORTED AND PROTECTED AGAINST DAMAGE DURING CONSTRUCTION.
- 7. THE CONTRACTOR, AT THE CONTRACTOR'S EXPENSE, SHALL IMMEDIATELY REPAIR ALL DAMAGES TO OCU MAINS AND FACILITIES. IF THE REPAIR IS NOT MADE IN A TIMELY MANNER. AS DETERMINED BY OCU, OCU MAY PERFORM REQUIRED REPAIRS AND CLEANUP. THE CONTRACTOR WILL BE CHARGED FOR ALL EXPENSES ASSOCIATED WITH THE REPAIR.
- 8. ONLY OCU SHALL OPERATE OCU WATER, WASTEWATER, AND RECLAIMED WATER VALVES. THE CONTRACTOR SHALL COORDINATE VALVE OPERATION WITH THE OCU INSPECTOR. FOR OPERATION OF MAINS NOT OWNED BY OCU. IT IS THE CONTRACTOR'S RESPONSIBILITY TO COORDINATE WITH THE APPROPRIATE UTILITY REPRESENTATIVE.
- 9. CONSTRUCTION ACTIVITIES SHALL NOT CAUSE INTERRUPTIONS IN WATER, WASTEWATER, OR RECLAIMED WATER SERVICE. THE CONTRACTOR SHALL COORDINATE PRE-APPROVED INTERRUPTIONS OF SERVICE WITH THE OCU RPR 7 WORKING DAYS IN ADVANCE.
- 10. THE CONTRACTOR SHALL PROVIDE FOR BYPASSING AND/OR HAULING WASTEWATER DURING APPROVED INTERRUPTIONS OF WASTEWATER FLOWS AND CONNECTIONS. THE CONTRACTOR SHALL SUBMIT A BYPASS PLAN SIGNED AND SEALED BY A PROFESSIONAL ENGINEER TO OCU FOR APPROVAL PRIOR TO IMPLEMENTATION BY CONTRACTOR.
- 11. ALL VALVES INSTALLED AS PART OF THIS CONSTRUCTION PROJECT SHALL REMAIN CLOSED DURING CONSTRUCTION. KEEP VALVES ON ALL WET TAPS CLOSED UNTIL CLEARED BY FDEP. DO NOT CONNECT NEWLY CONSTRUCTED WATER MAINS TO ANY EXISTING WATER MAINS UNLESS CLEARED BY FDEP AND OCU.
- 12. FOR PVC PIPE THAT WILL BE OWNED AND MAINTAINED BY OCU, NO PIPE BENDING IS ALLOWED. ALIGNMENT CHANGE SHALL BE MADE ONLY WITH SLEEVES AND FITTINGS.
- 13. FOR NON-PVC PIPE THAT WILL BE OWNED AND MAINTAINED BY OCU, LONG RADIUS CURVES, EITHER HORIZONTAL OR VERTICAL, MAY BE INSTALLED WITH STANDARD PIPE BY DEFLECTIONS AT THE JOINTS. MAXIMUM DEFLECTIONS AT PIPE JOINTS, FITTINGS AND LAYING RADIUS FOR THE VARIOUS PIPE LENGTHS SHALL NOT EXCEED 75 PERCENT OF THE PIPE MANUFACTURER'S RECOMMENDATION.
- 14. CONTRACTOR WILL NEED TO PROTECT WETLANDS DURING ALL CONSTRUCTION.

BID SET

SCALE: AS SHOWN

DRAWING NO.

G-300

SHEET: 3 OF

DATE **DESCRIPTION** LINE IS 2 INCHES (IF NOT SCALE ACCORDINGLY



AT FULL SIZE

ORANGE COUNTY UTILITIES DEPARTMENT ENGINEERING DIVISION

9150 CURRY FORD ROAD ORLANDO, FL. 32825



Eng. C.O.A. No. 3215 Survey L.B. No. 7143 Arch. Lic. No. AA2600926 Lndscp. Lic. No. LC000029


M/E/P

Planners

GENERAL NOTES BERRY DEASE ROAD WATER MAIN EXTENSION AND FORCE MAIN REPLACEMENT PROJECT

	OCU FILE NO.: 85506
	DESIGNED BY: DEM
	DRAWN BY: GNP
DAVID E. MAHLER PROFESSIONAL ENGINEER	CHECKED BY: DEM
	CADD FILE: O28509 Cover



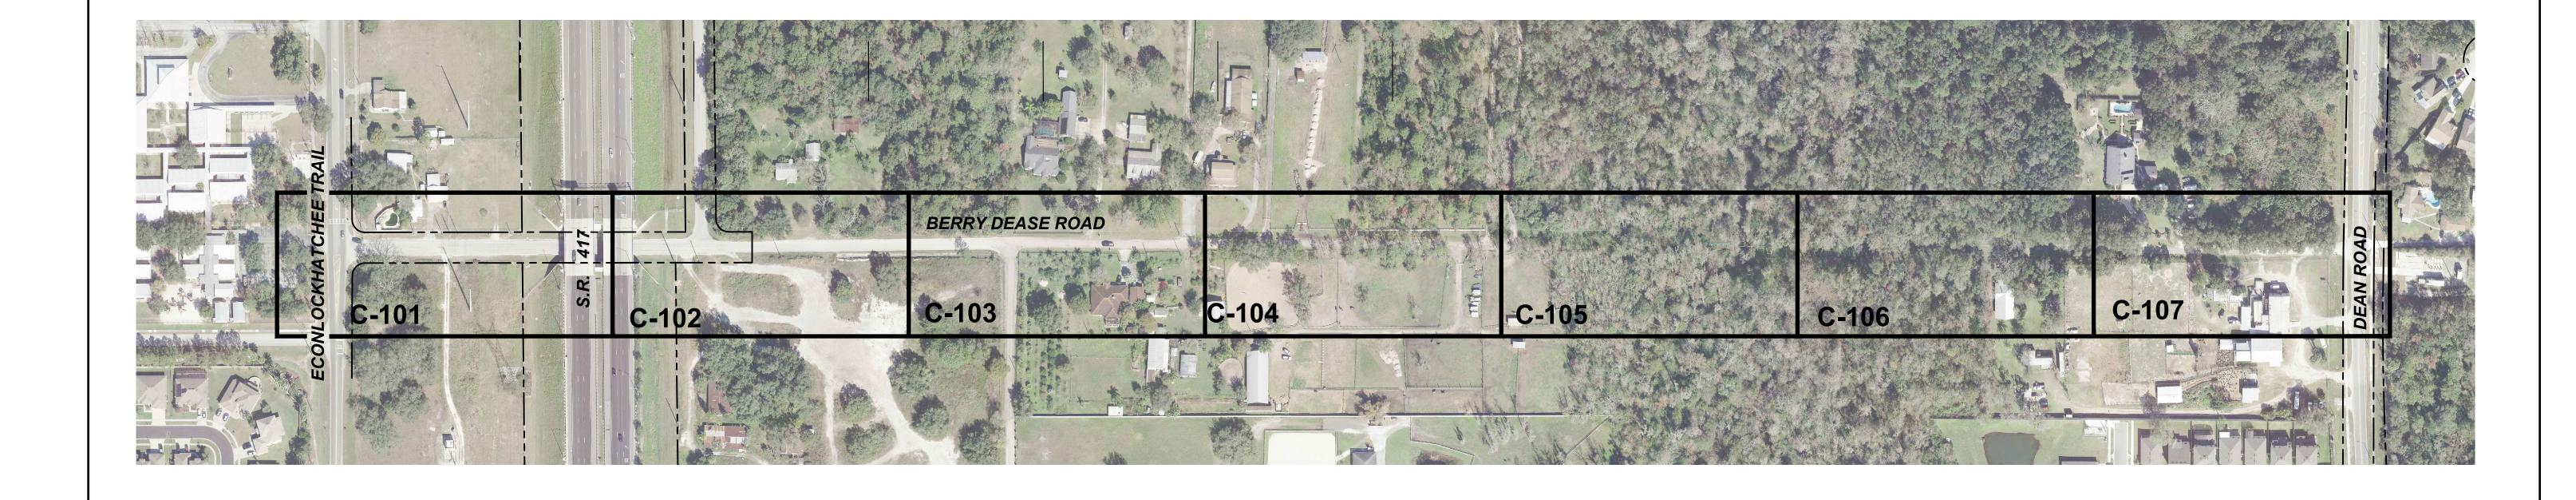

REV	DATE	DESCRIPTION		ORANGE		A Full Service A & E Firm	Licenses:	VEV CHEET		OCU FILE NO.: 85506	SCALE: AS SHOWN
				UNIC			Eng. C.O.A. No. 3215	KEY SHEET		DESIGNED BY: DEM	
			LINE IS 2 INCHES		UTILITIES DEPARTMENT	Architects M / E / P	Survey L.B. No. 7143	BERRY DEASE ROAD		DEGICITED DT. DEW	DRAWING NO. :
			AT FULL SIZE	TY TY		Engineers Hamilers	Arch. Lic. No. AA2600926	WATER MAIN EXTENSION AND		DRAWN BY: GNP	G-400
			(IF NOT SCALE ACCORDINGLY)	COUNTI	ENGINEERING DIVISION	www.cphcorp.com	Lndscp. Lic. No. LC0000298		DAVID E. MAHLER	CHECKED BY: DEM	1 G-4 00
1 1				GOVERNMENT				FORCE MAIN REPLACEMENT PROJECT			CUEET 4 OF 04
				FLORIDA	9150 CURRY FORD ROAD ORLANDO, FL. 32825	1117 East Robinson Street ~ Orlando, FL 32801 ~ Pho	one: 407.425.0452		FLORIDA LICENSE #50041	CADD FILE: O28509 Cover	SHEET: 4 OF 21

Bid Item	Reference ID	Description	Unit	Quantity	Sheet C-101	Sheet C-102	Sheet C-103	Sheet C-104	Sheet C-105	Sheet C-106	Sheet C-107
1	10.110.110	Mobilization, Demobilization, Bonds, and Permits (not to exceed 5% of the total of all bid items except bid items under section 10.1 General)	LS	1							
2	10.120.110	Preconstruction Audio-Video Documentation	LS	1							
3	10.130.110	Indemnification	LS	1							
4	10.140.110	Project Record Drawings	LS	1							
5	10.150.110	Maintenance of Traffic	LS	1							
6	11.110.110	Erosion and Sediment Control	LS	1							
7	11.110.110	Silt Fence	LS	1							
8	11.120.110	Clearing and Grubbing	LS	1							
9	11.210.110	Concrete Base	SY	567		356	211				
10	11.241.110	Open Cut and Restore Asphalt Road	SY	586		356	211				19
11	11.245.110	Open Cut and Restore Stabilized Dirt Road	SY	1438			380	863	60	83	52
12	11.250.110	Remove and Replace Concrete Driveway	SY	37							37
13	11.270.110	Remove and Replace Storm Crossing Drain Pipe and MES	LF	92				48	44		
14	11.330.110	Removal and Replacement of Concrete Pile Caps	EA	5					5		
15	11.530.110	Remove and Dispose of Existing 24" DIP FM	LF	1917				272	580	580	485
16	11.530.111	Cut and Remove 42" DIP WM	LF	40	10	30					
17	12.110.114	Furnish and Install 16" DIP WM with Fittings	LF	3033		341	580	580	444	580	508
18	12.110.114.001	Furnish and Install 16" Flanged Long Span DIP WM	LF	160					160		
19	12.110.115	Furnish and Install 6" DIP WM	LF	20		20					
20	12.130.115	Furnish and Install 24" PVC FM with Fittings	LF	1320				277	175	400	468
21	12.210.111	Furnish and Install 6" Gate Valve	EA	1		1					
22	12.210.115	Furnish and Install 16" Gate Valve	EA	4		1		1	2		
23	12.220.116	Furnish and Install 6" Plug Valve	EA	2					1	1	
24	12.220.117	Furnish and Install 24" Plug Valve	EA	4				1	1	1	1
25	12.230.118	Furnish and Install 42" Butterfly Valve	EA	2	1	1					
26	12.310.117	Furnish and Install 20"x16" Tapping Sleeve and Valve	EA	1							1
27	12.310.118	Furnish and Install 24" Tapping Sleeve & Valve	EA	1				1			
28	12.510.115	Furnish and Install 16" Line Stop	EA	1	1						
29	12.510.116	Furnish and Install 24" Line Stop and Cap	EA	2				1			1
30	12.520.110	Furnish and Install 2" Air Release Valve	EA	1					1		
31	12.530.110	Furnish and Install 4" Offset Air Release Valve	EA	3				1	1	1	
32	12.540.110	Furnish and Install New Fire Hydrant Assembly	EA	2		1					1
33	12.580.110	Furnish and Install 42" Plug	EA	1		1					
34	12.630.115	Furnish and Install 30" HDPE FM Directional Drill	LF	585					405	180	

BID SET

	DESCRIPTION	DATE	KEV
LINE IS 2 INCHES			
AT FULL SIZE			
(IF NOT SCALE ACCORDI			

ORANGE COUNTY
UTILITIES DEPARTMENT
ENGINEERING DIVISION
www.cphco 9150 CURRY FORD ROAD ORLANDO, FL. 32825



Licenses: Eng. C.O.A. No. 3215 Survey L.B. No. 7143 Arch. Lic. No. AA2600926

SUMMARY OF PAY ITEMS BERRY DEASE ROAD WATER MAIN EXTENSION AND FORCE MAIN REPLACEMENT PROJECT

	OCU FILE NO.: 85506	SCALE	: AS	SHOV	٧N
	DESIGNED BY: DEM	DRA	1IWA	NG NC). :
	DRAWN BY: GNP	C	<u>.</u>	500	n
DAVID E. MAHLER	CHECKED BY: DEM	G	, – ,	יטכ	J
PROFESSIONAL ENGINEER FLORIDA LICENSE #50041	CADD FILE: O28509 Cover	SHEET:	5	OF	20

OSCEOLA PALM BEACH BROWARD VICINITY MAP

Abbreviation Legend:

MITERED END SECTION

- METAL LIGHT POLE

METAL POWER POLE

- NORTH AMERICAN DATUM

NATIONAL GEODETIC SURVEY

PROFESSIONAL SURVEYORS

- NORTH AMERICAN VERTICAL DATUM

NATIONAL GEODETIC VERTICAL DATUM

- MILES PER HOUR

NOT APPLICABLE

NATURAL GROUND

NAIL AND DISK

- NATIONAL SOCIETY OF

 OFFICIAL RECORDS BOOK OFFICIAL RECORDS

- OVERHEAD UTILITY LINES

- POINT OF CURVATURE

- OVERHEAD TRAFFIC LINES

- POINT OF COMPOUND CURVATURE

- PERMANENT CONTROL POINT

PROPOSED FINISHED FLOOR

POINT OF INTERSECTION

POINT OF COMMENCEMENT

POINT OF REVERSE CURVATURE

- PERMANENT REFERENCE MONUMENT

- PROFESSIONAL SURVEYOR & MAPPER

PARKER KAYLON

POWER POLE

PAVEMENT

RADIUS

RECOVERED

REVISION

RANGE 31 EAST

RADIUS POINT

- RIGHT-OF-WAY

RADIUS POINT

SECTION 31

SQUARE

STATE PLANE

SQUARE FEET

- SIDEWALK

- TELEPHONE

TOP OF BANK

- TOE OF SLOPE

TRANSFORMER

UTILITY FASEMENT

WOOD LIGHT POLE

WORK PROGRAM

WOOD POST FENCE

- WOOD POWER POLE

WATER METER

WATER VALVE

TYPICAL

UNKNOWN

— WITH

SPECIAL EASEMENT

TANGENT BEARING

TELEPHONE RISER

- TRAFFIC SIGNAL BOX

TOWNSHIP 22 SOUTH

R31E

REV

R/W

SEC 31

(SP)

S/W

TELE

TOE

TRANS

TSSP

UTL

SQ FT

POINT OF REGINNING

POINT OF TANGENCY

- POLYVINYL CHLORIDE PIPE

- REINFORCED CONCRETE PIPE

REGISTERED LAND SURVEYOR

- RECLAIMED WATER METER

SANITARY SEWER MANHOLE

STORM DRAINAGE MANHOLE

- OVERHEAD TRAFFIC SIGNAL LINES

- TRAFFIC SIGNAL SUPPORT POLE

- UNDERGROUND CABLE TV LINES

- UNDERGROUND TELEPHONE LINES

- UNDERGROUND WATER LINE

- UNDERGROUND RECLAIM WATER LINE

NON-RADIAL

NON—TANGENT

- PLAT

PLAT BOOK

OUTSIDE DIAMETER

MANHOLE

ACTUAL

APPROX - APPROXIMATE

AVERAGE

BLOCK

BUILDING

BOULEVARD

- BENCH MARK

- BACK OF CURE

- BACK OF WALK

CALCULATED

CHORD BEARING

CURB & GUTTER

CHAIN LINK FENCE

CONCRETE MONUMENT

- CORRUGATED METAL PIPE

CORRUGATED PLASTIC PIPE

- COUNTY UTILITY EASEMENT

- DIAMETER AT BREAST HEIGHT IN INCHES

- FLORIDA DEPARTMENT OF TRANSPORTATION

- DRAINAGE AND UTILITY EASEMENT

UNDERGROUND ELECTRICAL LINES

- CROSSWALK SIGNAL

DRAINAGE FASEMENT

- DUCTILE IRON PIPE

ENGINEERING PLAN

END OF INFORMATION

EDGE OF PAVEMENT

- FLAT GRATE INLET

FLORIDA STATUTES

- GRID (STATE PLANE)

FIBERGLASS LIGHT POLE

- FLORIDA POWER AND LIGHT

UNDERGROUND GAS LINES

- GREASE TRAP MANHOLE

- IRRIGATION CONTROL VALVE

- GROUND PENETRATING RADAR

- HIGH DENSITY POLYETHYLENE PIPE

FLECTRIC JUNCTION BOX

CATCH INLET

CENTERLINE

CLEANOUT

DESCRIPTION

DEPARTMENT

ELEVATION

- FIELD BOOK

- FINISH FLOOR

FIRE HYDRANT

GOVERNMENT

HOG WIRE FENCE

- IRON PIPE & CAP

IRON REBAR & CAR

IDENTIFICATION

INFORMATION

– INVFRT

IRON PIPE

IRON ROD

IRRIGATION

LIGHT POLE

MEASURED

- MAP BOOK

MAILBOX

ARC LENGTH

FOUND

ELLIPTICAL

DEED BOOK

CONCRETE

CORNER

CHORD

ALTA

ARV

AVG

BLDG

BOW

BSL BWF

CATV

CONC

COR

CWS

DEPT

D/U

ELLIF

EOI

FDOT

FGLP

FHYD

FP&L

GOV'T

HDPE

INFO

IP&C

IR&C

INV

AIR CONDITIONER

AIR RELEASE VALVE

BACK FLOW PREVENTER

BUILDING SETBACK LINE

- CABLE TELEVISION RISER

- CONCRETE BLOCK STRUCTURE

- CERTIFIED CORNER RECORD

BARBED WIRE FENCE

- BEARING BASIS

- AMERICAN CONGRESS ON SURVEYING & MAPPING

- DENOTES SHEET NUMBERING FOR ENGINEERING PLANS ORB

AMERICANS WITH DISABILITIES ACT

- AMERICAN LAND TITLE ASSOCIATION

BOUNDARY & TOPOGRAPHIC SURVEY

ORANGE COUNTY UTILITIES

BERRY DEASE ROAD LYING IN

SECTIONS 31 & 32-TOWNSHIP 22 SOUTH-RANGE 31 EAST SECTIONS 5 & 6-TOWNSHIP 23 SOUTH-RANGE 31 EAST ORANGE COUNTY, FLORIDA

Surveyed Area:

A PORTION OF BERRY DEASE ROAD BEGINNING AT STATE ROAD 417 AND RUNNING EAST TO S DEAN ROAD.

Reference Material

1) CYPRESS SPRINGS UNIT ONE, AS RECORDED IN PLAT BOOK 18, PAGES 25 AND 26 OF THE PUBLIC RECORDS OF ORANGE COUNTY, FLORIDA.

2) COUNTRYWALK UNIT II, AS RECORDED IN PLAT BOOK 21, PAGES 106 AND 107 OF THE PUBLIC RECORDS OF ORANGE COUNTY, FLORIDA.

3) SAVINA PARK, AS RECORDED IN PLAT BOOK 82, PAGES 23 AND 24 OF THE PUBLIC RECORDS OF ORANGE COUNTY, FLORIDA.

Symbol Legend:

RECLAIMED WATER METER

RECLAIMED WATER VALVE

SANITARY SEWER MANHOLE

TELEPHONE CABLE RISER

TELEPHONE JUNCTION BOX

1 - WIRE HEIGHTS (SEE CHART)

∠ VENT (AS NOTED)

DETECTABLE WARNING AREA

CONCRETE LIGHT POLE (DUAL)

CONCRETE LIGHT POLE (TRIPLE)

CONCRETE LIGHT POLE (QUAD)

NOT TO SC	JALE
arv ⋈ – air release valve	2 - PARKING SPACES (2)
🗣 — BORING HOLE LOCATION	$\frac{\overline{3}}{3}$ - REVISION NUMBER (3)
## - BRICK PAVERS	RWM — RECLAIMED WATER MET
CTV — CABLE TV RISER	RWV → RECLAIMED WATER VAL
Δ - CENTRAL ANGLE	
CONCRETE -	S - SANITARY SEWER MANH
O CLEAN OUT	SV - SANITARY SEWER VALV
— CONCRETE MITERED END SECTION	■ – SCHEDULE B ITEM NUM
- CONCRETE RIP RAP	◀ - GROUND LIGHT
- CONCRETE UTILITY POLE	- SECTION CORNER
41 - COUNTY ROAD SYMBOL	⊡ – 4" X 4" CM LB #7143
DUAL SUPPORT SIGN	● - 5/8" IR&C LB #7143
© — ELECTRICAL MANHOLE	SIGN
EJB — ELECTRICAL JUNCTION BOX	 SITE BENCH MARK
E - ELECTRIC OUTLET	D - STORM SEWER MANHOL
E - ELECTRIC RISER	F - STRIPING (DIRECTIONAL
FIGOR HOUT	- TELEPHONE CABLE RISE
- FLOOD LIGHT	T TELEPHONE MANHOLE
- FOUND CONCRETE MONUMENT (AS	TIB TELEPHONE JUNCTION I
— FOUND IRON PIPE (AS NOTED)	- TEST HOLE
— FOUND IRON REBAR (AS NOTED)	TSB − TRAFFIC SIGNAL BOX
— FOUND/SET NAIL (AS NOTED)	TRAFFIC SIGNAL SUPPO
	₩ - WATER METER
	WS - WATER SERVICE
(ct) – GOPHER TORTOISE HOLE	— WATER SPIGOT
— GRATE INLET	WS - WATER SPRINKLER
G - GREASE TRAP MANHOLE	wv – Water valve
← − GUY ANCHOR	W - WELL
👃 — HANDICAP PARKING SPACE	🛆 — WETLAND FLAG
— INTERSTATE SYMBOL	√ – WOOD UTILITY POLE
PICT - IRRIGATION CONTROL VALVE	U – UNKNOWN MANHOLE
CONCRETE LIGHT POLE	CONCRETE PAVERS
☆ - LIGHT POLE	DETECTABLE WARNING
□⊕□ — LIGHT POLE (DUAL)	□●□ - CONCRETE LIGHT POLE
□⊕□ — LIGHT POLE (TRIPLE)	CONCRETE LIGHT POLE
□ – LIGHT POLE (QUAD)	□□□ - CONCRETE LIGHT POLE
■ – MAILBOX	Ú UNK – UNKNOWN RISER
O MONITOD WELLS	<u> </u>

Sign Legend. SCHEDULE B ITEM NUMBER (8) (R1) — ROW NUMBER SIGN (B) ── BUS STOP SIGN (DE) — DEAD END SIGN (DNE) \longrightarrow DO NOT ENTER SIGN (R5-1) (HC) - HANDICAP SIGN (HC) ___ DUAL HANDICAP SIGN (KR) — KEEP RIGHT SIGN (LTO) — LEFT TURN ONLY (ME) o MEDIAN SIGN (ND) — NO DUMPING SIGN (NL) \longrightarrow NO LEFT TURN SIGN (R3-2)(NLI) - NO LITTERING SIGN (NO) ── NO OUTLET SIGN TRAFFIC SIGNAL SUPPORT POLE (FL) - NO PARKING FIRE LANE SIGN (NOR) $\overline{}$ NO RIGHT TURN SIGN (R3-1) (NTT) - NO THRU TRAFFIC SIGN (NOT) \longrightarrow NO TRUCKS (R5-2) (NP) - NO PARKING SIGN (1W) $\overline{}$ ONE WAY SIGN (R6-2) (PE) — PEDESTRIAN CROSSING SIGN (RTO) - RIGHT TURN ONLY

(SL) - SPEED LIMIT SIGN

(ST) \longrightarrow STOP SIGN (R1-1)

(TZ) $-\infty$ TOW AWAY ZONE SIGN

(TE) ── TRUCK ENTRANCE SIGN

(SS) — STREET SIGN

(U) — UNKNOWN SIGN

(WL) ── WEIGHT LIMIT SIGN

(WW) - WRONG WAY SIGN

YIELD SIGN

Index of Sheets COVER SHEET V-104

Surveyor's Certification:

TOPOGRAPHIC SURVEY TOPOGRAPHIC SURVEY TOPOGRAPHIC SURVEY

NOTE: THIS SURVEY IS NOT VALID WITHOUT SHEETS 6 THROUGH 9 OF 20

Eng. = ENGINEERINGL.B. = LICENSED BUSINESS C.O.A. = CERTIFICATE OF AUTHORIZATION Arch.= ARCHITECTURA Landscp. = LANDSCAPE N/A = NOT APPLICABLE Lic. = LICENSED N_0 . = NUMBER P.O. = POST OFFICE © = COPYRIGHT

Chapter 5J-17 of the Florida Administrative Code, pursuant to FS 472.027.

For the Firm By: Thomas J. Galloway, PSM Professional Surveyor and Mapper

DESCRIPTION REV DATE LINE IS 2 INCHES (IF NOT SCALE ACCORDINGLY

Line Legend:

NOT TO SCALE

- - 1 - = 1 FOOT CONTOURS

- -5 - = 5 FOOT CONTOURS

----x---- = BARBED WIRE FENCE

────────── = BROKEN LINE

— ug — = BURIED GAS

--- uc --- = BURIED CABLE

--- UE --- = BURIED ELECTRIC

--- UFO --- = BURIED FIBER OPTICS

--- SAN --- = BURIED SANITARY LINES

---- TC ---- = BURIED TRAFFIC CONTROL

---- = EASEMENT LINES (EXISTING)

 $-\cdot -\cdot -\cdot -\cdot = EASEMENT LINES (PROPOSED)$

--- EOW --- = EDGE OF WATER LINES

= EXISTING DRAINAGE PIPES

----- FW ----- = FIRE WATER MAIN LINES

___ IRR ___ = IRRIGATION LINES

= RAILROAD TRACKS

= STONE WALL LINES

____ TOB ____ = TOP OF BANK LINES

___ TOE ___ = TOE OF SLOPE LINES

___ UNK ___ = UNKNOWN BURIED LINES

____ = SECTION LINES

 \cdot = TREE LINES

______ = VINYL FENCE

____ = WOOD FENCE

____ : ___ = WETLAND LINE

____ TRAV ___ = TRAVERSE LINES

____ = RIGHT-OF-WAY LINES

--- HW --- = HOT WATER SUPPLY LINES

—— OTL —— = OVERHEAD TRAFFIC LINES

___ OHU ___ = OVERHEAD UTILITY LINES

--- UT --- = BURIED TELEPHONE LINE

--- UW --- = BURIED WATER LINES

—---- = CENTER LINE R/W

——O——O—— = CHAIN LINK FENCE

----- = ADJOINER PROPERTY LINES

--- UCTV --- = BURIED CABLE TELEVISION

--- URW --- = BURIED RECLAIMED WATER LINE

--- FM --- = BURIED SANITARY SEWER FORCE MAIN LINE

= EXISTING DRAINAGE PIPES (OUTFALL NOT LOCATED)

ORANGE COUNTY *UTILITIES DEPARTMEN* ENGINEERING DIVISION



- MONITOR WELLS

- NAIL & DISC (AS NOTED)

- PULL BOX (AS NOTED)

Full Service A & E Firm M/E/P Engineers Planners Environmental Structural

500 West Fulton Street ~ Sanford, FL 32771 ~ Phone: 407.322.6841

Eng. C.O.A. No. 3215 Survey L.B. No. 7143 Arch. Lic. No. AA2600926 Lndscp. Lic. No. LC0000298

500 West Fulton S Sanford, Fl. 32771 Ph: 407.322.6841 Eng. C.O.A. No. 3215 Survey L.B. No. 7143 Arch. Lic. No. AA2600926

Lndscp. Lic. No. LC0000298

Florida Registration No. 6549 **OCU FILE NO.**: 85506 SCALE: N/A APPROVED BY: T.J.G **DRAWING NO.: DRAWN BY:** R.D.B. CHECKED BY: R.L.R. SHEET: 6 OF 20 CADD FILE: O28509.dwg

I hereby certify that the attached "Boundary & Topographic Survey" of the

hereon-described property is true and correct to the best of my knowledge, information

and belief as surveyed in the field on September XX, 2015. I further certify that this

"Boundary & Topographic Survey" meets the standards of practice set forth in Rule

9150 CURRY FORD ROAD ORLANDO, FL. 32825

andscape Architects Surveyors www.cphcorp.com Traffic/Transportation

TOPOGRAPHIC SURVEY

TELION O THE RELEASE THE POLLOWING TO BEING THE MONTH TIME MONTH
VERTICAL DATUM OF 1988 (NAVD '88) AND SAID ELEVATIONS ARE BASED ON VERTICAL CONTROL BENCHMARKS
SUPPLIED BY ORANGE COUNTY SURVEY DEPARTMENT AS FOLLOWS:
DESIGNATION # A1490015.
DESIGNATION # ATT-50015.
ELEVATION = 82.811 FEET (NAVD '88)

"SURVEY MAP AND REPORT OR THE COPIES THEREOF ARE NOT VALID WITHOUT THE SIGNATURE AND THE ORIGINAL

"ADDITIONS OR DELETIONS TO SURVEY MAPS OR REPORTS BY OTHER THAN THE SIGNING PARTY OR PARTIES IS

THE SITE BENCHMARKS FOR THIS TOPOGRAPHIC SURVEY ARE DISPLAYED ON THE RESPECTIVE SURVEY FILE. THESE BENCHMARKS ARE BASED ON A CLOSED VERTICAL CONTROL LOOP HAVING AN ACTUAL ERROR OF CLOSURE OF 0.01' WHICH MEETS THE ALLOWABLE CLOSURE OF 0.052'. THIS FIELDWORK WAS PERFORMED USING A TOPCON LEVEL MODEL #DL101-C AND REFERENCES THE FOLLOWING PUBLISHED BENCHMARKS AS ESTABLISHED BY THE NORTH AMERICAN

a) DESIGNA ELEVATION = 82.811 FEET (NAVD 88)

Survey Notes:

b) DESIGNATION # <u>L1149065</u>. ELEVATION = 77.840 FEET (NAVD '88)

SITE BENCHMARKS ARE AS SHOWN ON SHEETS 2 THROUGH 4 OF 4.

4. THIS SURVEY IS NOT VALID WITHOUT SHEETS 1 THROUGH 4 OF 4.

RAISED SEAL OF A FLORIDA LICENSED SURVEYOR AND MAPPER."

PROHIBITED WITHOUT WRITTEN CONSENT OF THE SIGNING PARTY OR PARTIES."

- 5. THE LAST DAY FIELD WORK WAS PERFORMED WAS (DATE); ALL BOUNDARY CORNERS WERE RECOVERED OR
- SET AS NOTED HEREON.
- THE "AREA DESCRIPTION" HEREON WAS PREPARED BY THE SURVEYOR PER THE CLIENT'S REQUEST.

- 8. HAVING CONSULTED THE NATIONAL FLOOD INSURANCE PROGRAM, FLOOD INSURANCE RATE MAP (FIRM) COMMUNITY PANEL NO. 120179-0290-F REVISED DATE SEPTEMBER 25, 2009, THE SUBJECT PROPERTY APPÈARS TO LIE IN ZONE X, WHICH ARE AREAS DETERMINED TO BE OUTSIDE THE 0.2% ANNUAL CHANCE FLOOD PLAIN AND LIES IN ZONE <u>AE</u>, WHICH ARE SPECIAL FLOOD HAZARD AREAS INUNDATED BY 100 YEAR FLOOD WITH BASE FLOOD ELEVATIONS DEPICTED AS 68.9 FEET (NAVD '88), THIS DETERMINATION WAS BASED ON GEOSPATIAL DATA DOWNLOADED FROM WWW.FEMA.GOV. THIS DETERMINATION WAS BASED ON A GRAPHIC INTERPOLATION OF SAID MAP AND NOT ON ACTUAL
- 9. THE APPARENT USE OF THE LAND, AS CLASSIFIED BY THE STANDARDS OF PRACTICE SET FORTH IN RULE CHAPTER 5J-17 OF THE FLORIDA ADMINISTRATIVE CODE, PURSUANT TO FS 472.027, FLORIDA ADMINISTRATIVE CODE ESTABLISHES THAT THE MINIMUM RELATIVE ACCURACY FOR THIS TYPE OF BOUNDARY SURVEY MEET THE HORIZONTAL CONTROL ACCURACY OF 1'/10,000 FEET FOR A HIGH RISK SURVEY. THE MEASUREMENTS AND CALCULATIONS OF THE CLOSED GEOMETRIC FIGURES WERE FOUND TO MEET THIS ACCURACY REQUIREMENT. THE EQUIPMENT USED TO VERIFY THE HORIZONTAL CONTROL ON THE SUBJECT SURVEY WAS A TOPCON GPS HIPER II.
- 10. HORIZONTAL WELL-IDENTIFIED FEATURES IN THIS SURVEY AND MAP HAVE BEEN MEASURED TO AN ESTIMATED HORIZONTAL POSITIONAL ACCURACY OF 0.05 (FT). THE EQUIPMENT USED TO LOCATE THE FEATURES WAS A LEICA SCANSTATION P30, TOPCON PS-103A ROBOTIC TOTAL STATION AND TOPCON GPS HIPER II.
- 11. THIS SURVEY WAS PREPARED WITHOUT THE BENEFIT OF AN ABSTRACT OR OPINION OF TITLE. NO INSTRUMENTS OF RECORD REFLECTING EASEMENTS, RIGHTS-OF-WAY, AND/OR OWNERSHIP WERE FURNISHED TO THIS SURVEYOR
- 12. FENCES EXISTING ON, OVER OR ADJACENT TO SUBJECT PROPERTY, ARE DISPLAYED HEREON; OWNERSHIP WHETHER SINGULAR OR JOINT WAS NOT DETERMINED BY THIS SURVEY.
- HAVE BEEN MEASURED TO AN ESTIMATED VERTICAL POSITIONAL ACCURACY OF 0.01 (FT)."

13. VERTICAL FEATURE ACCURACY: "ELEVATIONS OF WELL-IDENTIFIED FEATURES CONTAINED IN THIS SURVEY AND MAP


- LOCATION OF THE FLAGS AND PAINT MARKINGS ESTABLISHED BY VARIOUS UTILITY COMPANY REPRESENTATIVES.
- 15. STATE PLANE INFORMATION SHOWN HEREON IS BASED ON THE NORTH AMERICAN DATUM OF 1983 (1990) USING CONTROL POINTS FROM THE NGS DATA SHEETS PUBLISHED AT WWW.LABINS.ORG AND ARE AS FOLLOWS:


14. THE UNDERGROUND UTILITIES LABELED FM AND UW DISPLAYED ON SHEET 4 OF 4 ARE A RESULT OF THE FIELD


- a) DESIGNATION # GIS 0132 RH HAM JONES, PID #AK7130 = N 1,523,378.55 FEET, E 543,185.33 FEET
- b) DESIGNATION # GIS 0206 KIRBY GREEN, PID #AK7287 = N 1,507,529.28 FEET, E 585,747.84 FEET


THE EQUIPMENT USED TO TRANSFER THE STATE PLANE INFORMATION FROM THE ABOVE REFERENCED CONTROL


- 17. THE DISPLAYED LIMITS OF WETLANDS ARE BASED UPON THE FIELD LOCATION OF FLAGS OR STAKES SET BY CPH ENGINEERING ENVIRONMENTAL DEPARTMENT AND LOCATED BY THE SURVEYOR ON OCTOBER 10, 2015.
- 18. DIMENSIONS ARE SHOWN RELATIVE TO UNITED STATES STANDARD FEET AND DECIMALS THEREOF, UNLESS THE OBJECT SHOWN IS COMMONLY IDENTIFIED IN INCHES, I.E. TREE DIAMETER, PIPE DIAMETER, ETC. TREES DEPICTED ARE COMMON NAMES AND MEASURED AND LABELED AS DIAMETER AT BREAST HEIGHT IN INCHES.
- 19. THE UNDERGROUND UTILITIES DEPICTED BY PIPE LINETYPES ARE APPROXIMATE IN NATURE BASED UPON AN INSPECTION OF THE MANHOLE, GRATE, ETC. OF EACH FACILITY, EXISTING PIPES WERE NOT LAMPED OR REMOTELY VIEWED FOR OBSTRUCTIONS OR CONNECTIVITY.

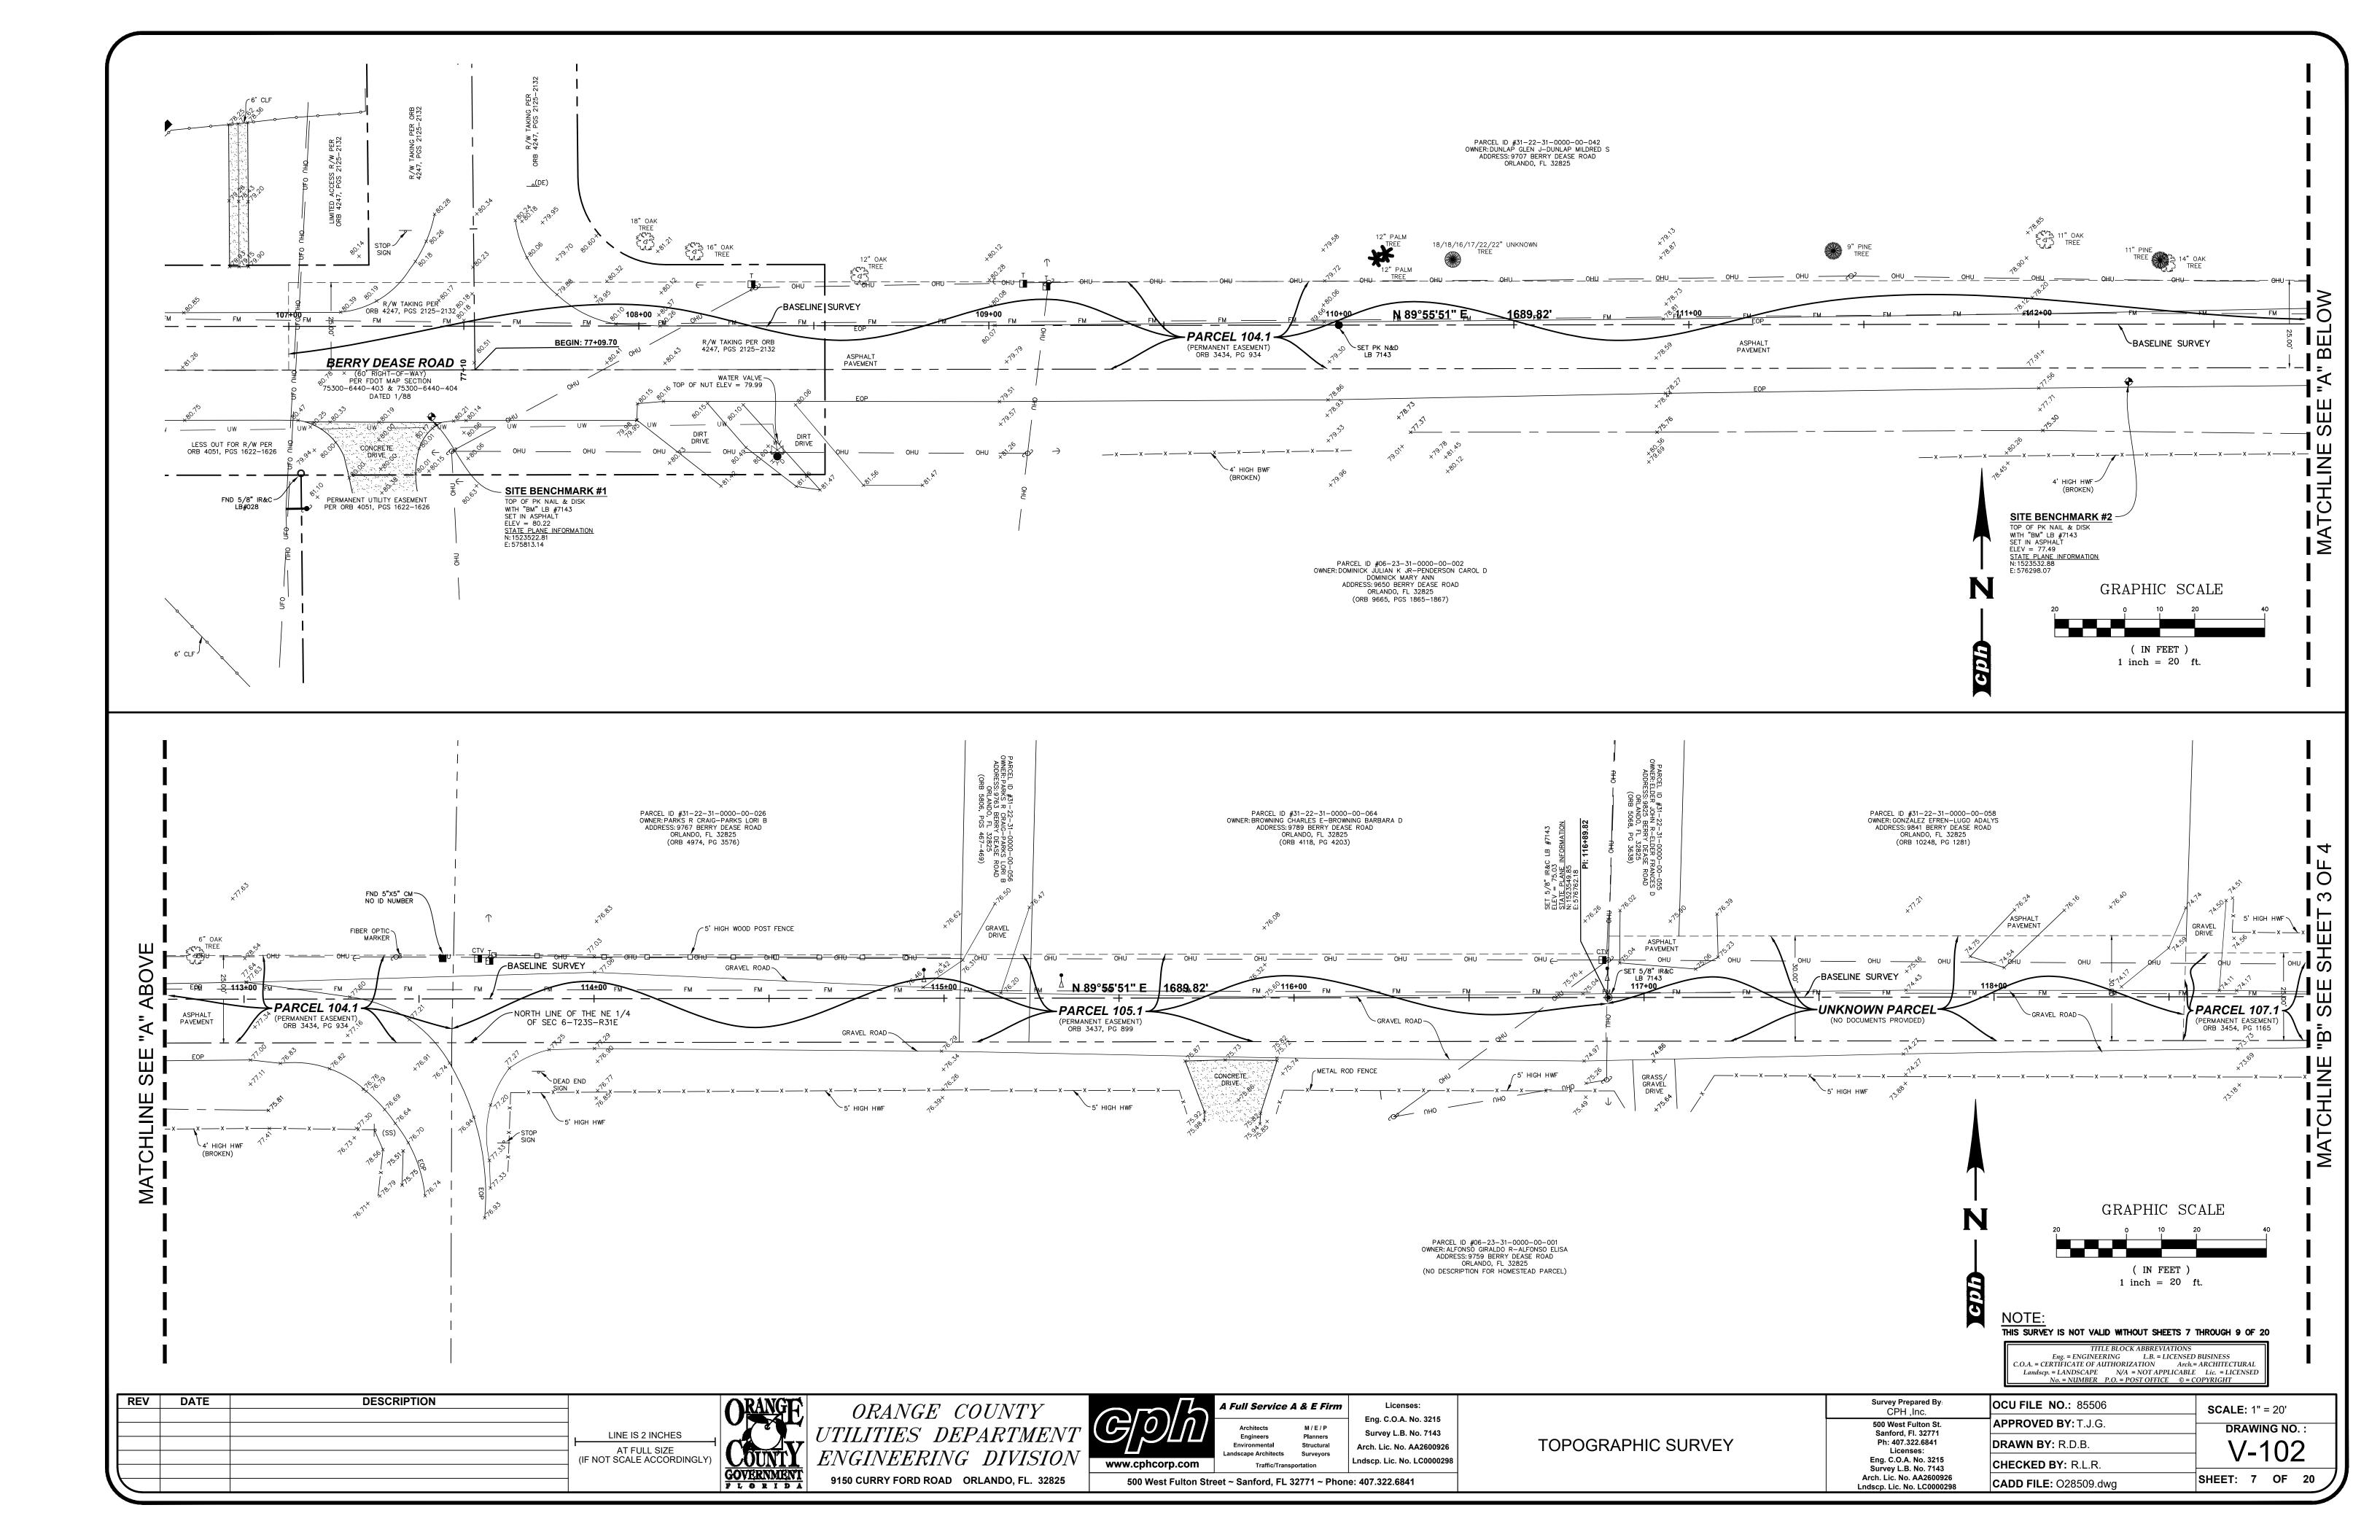


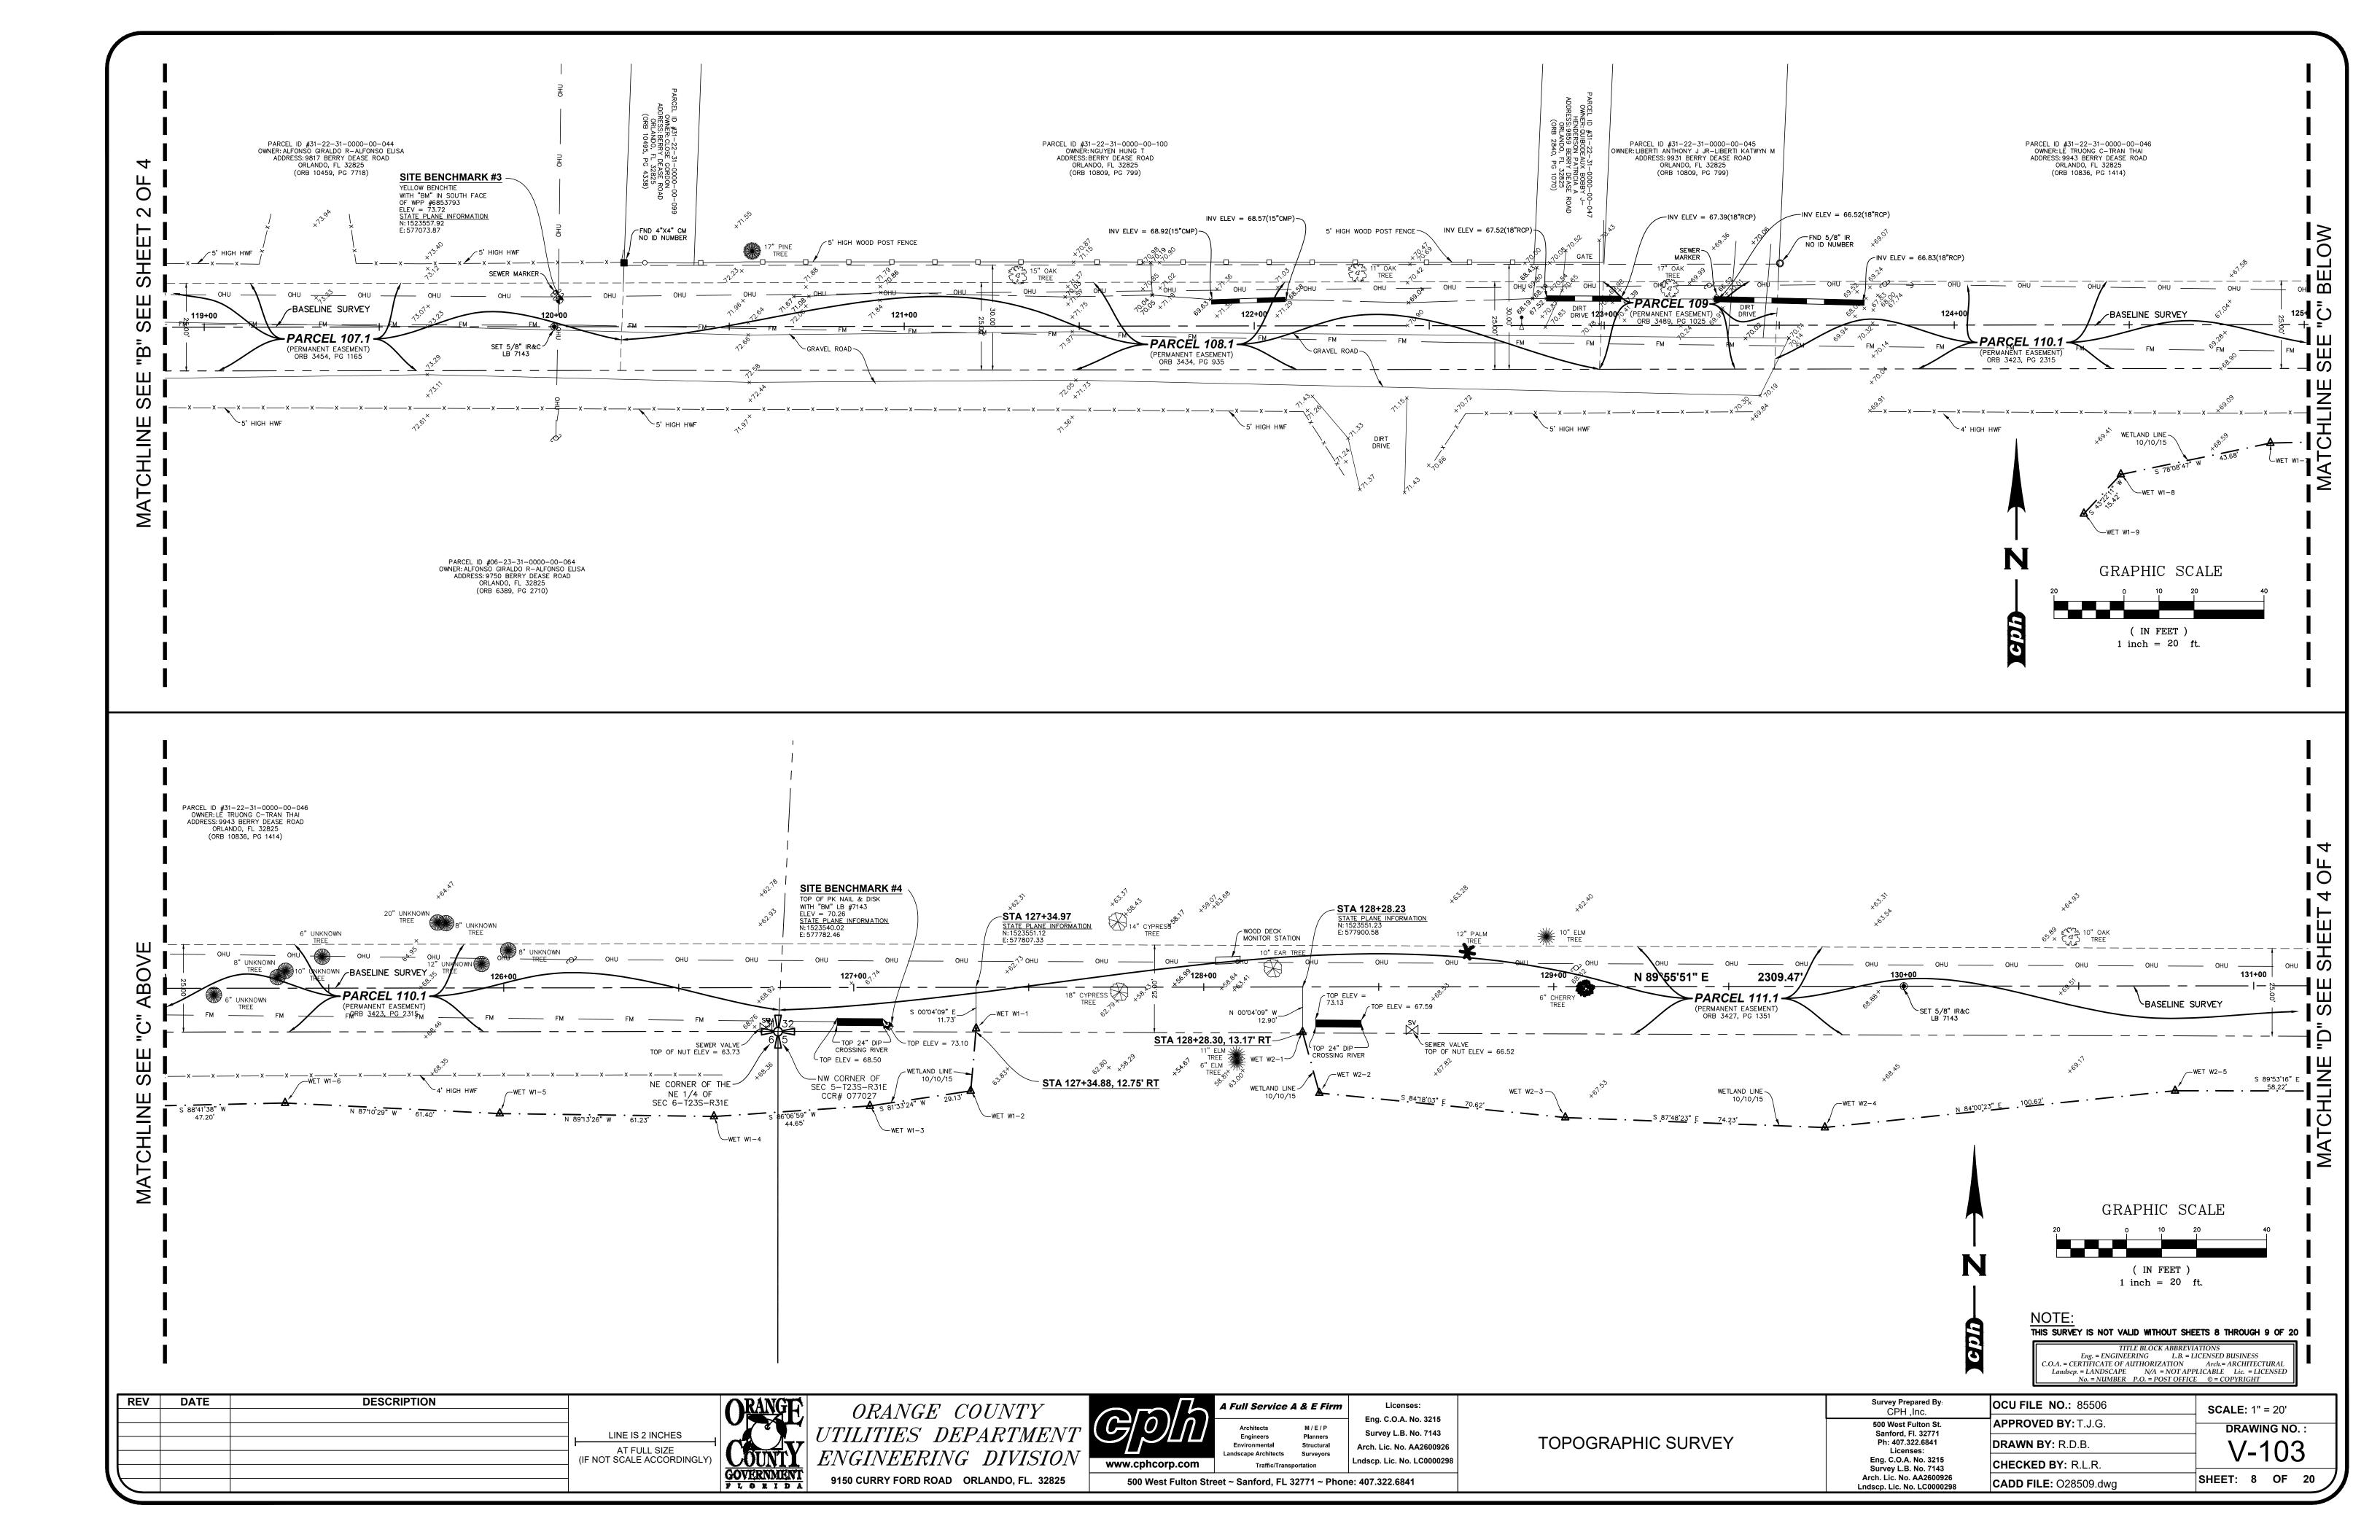


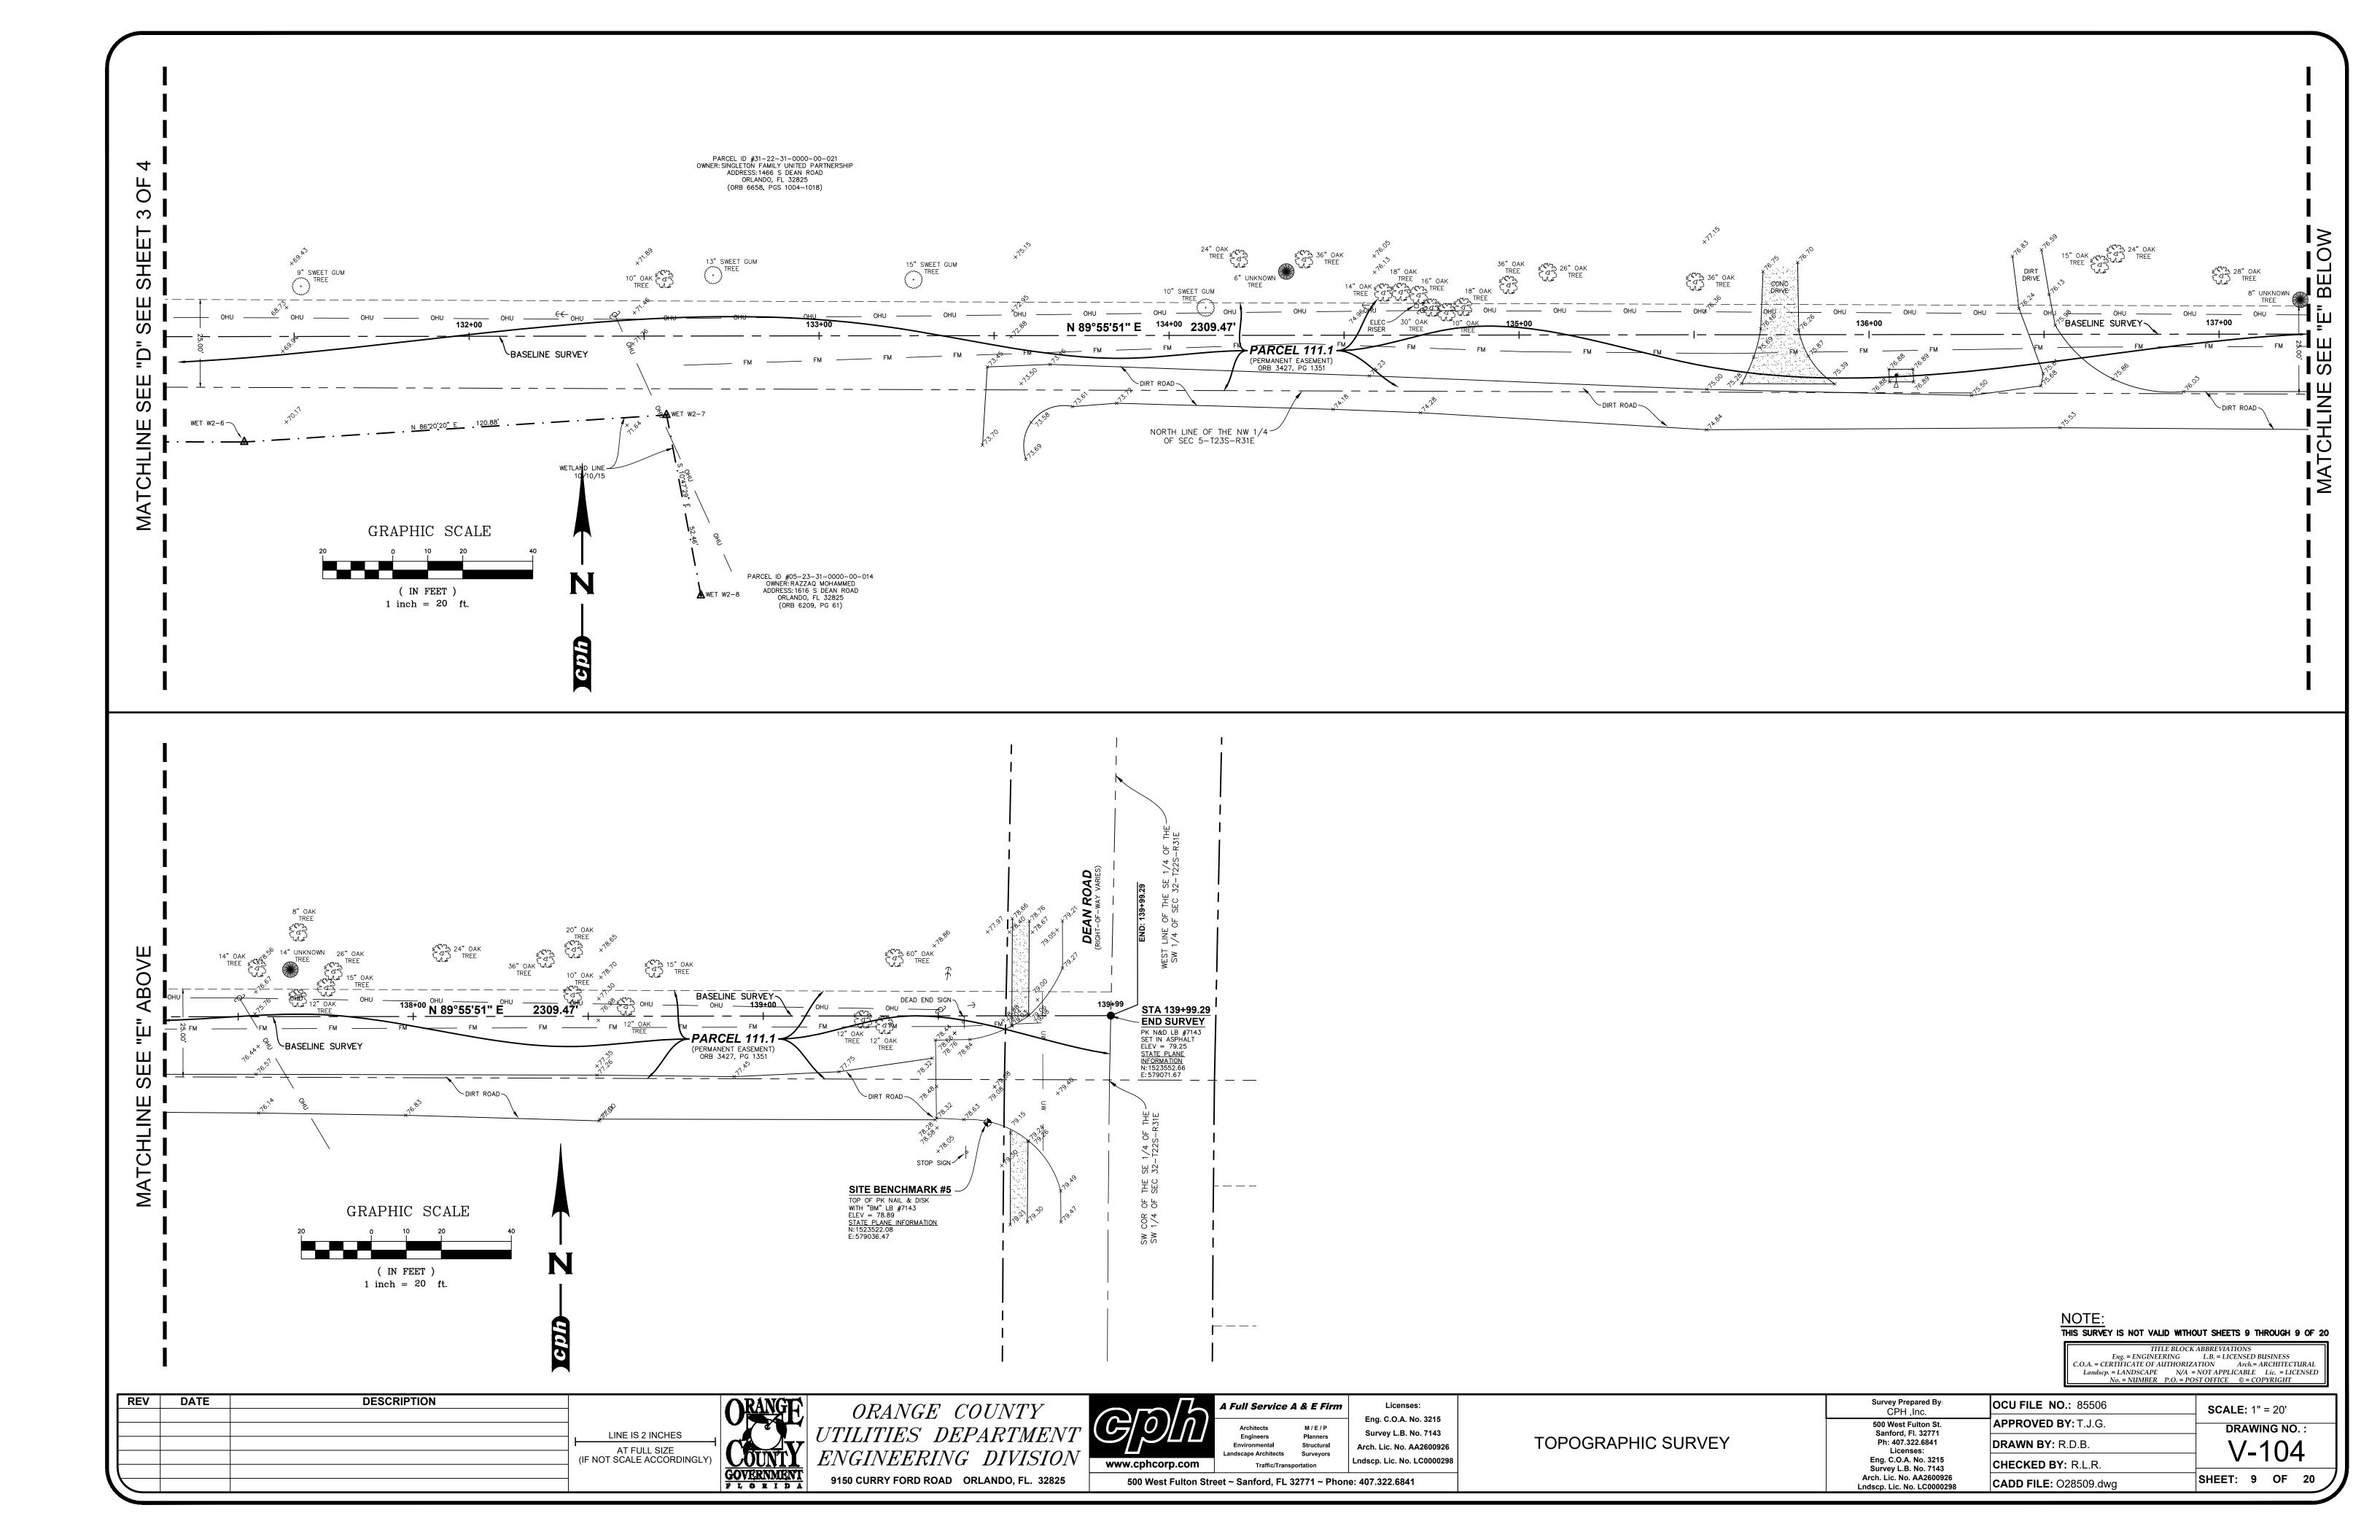


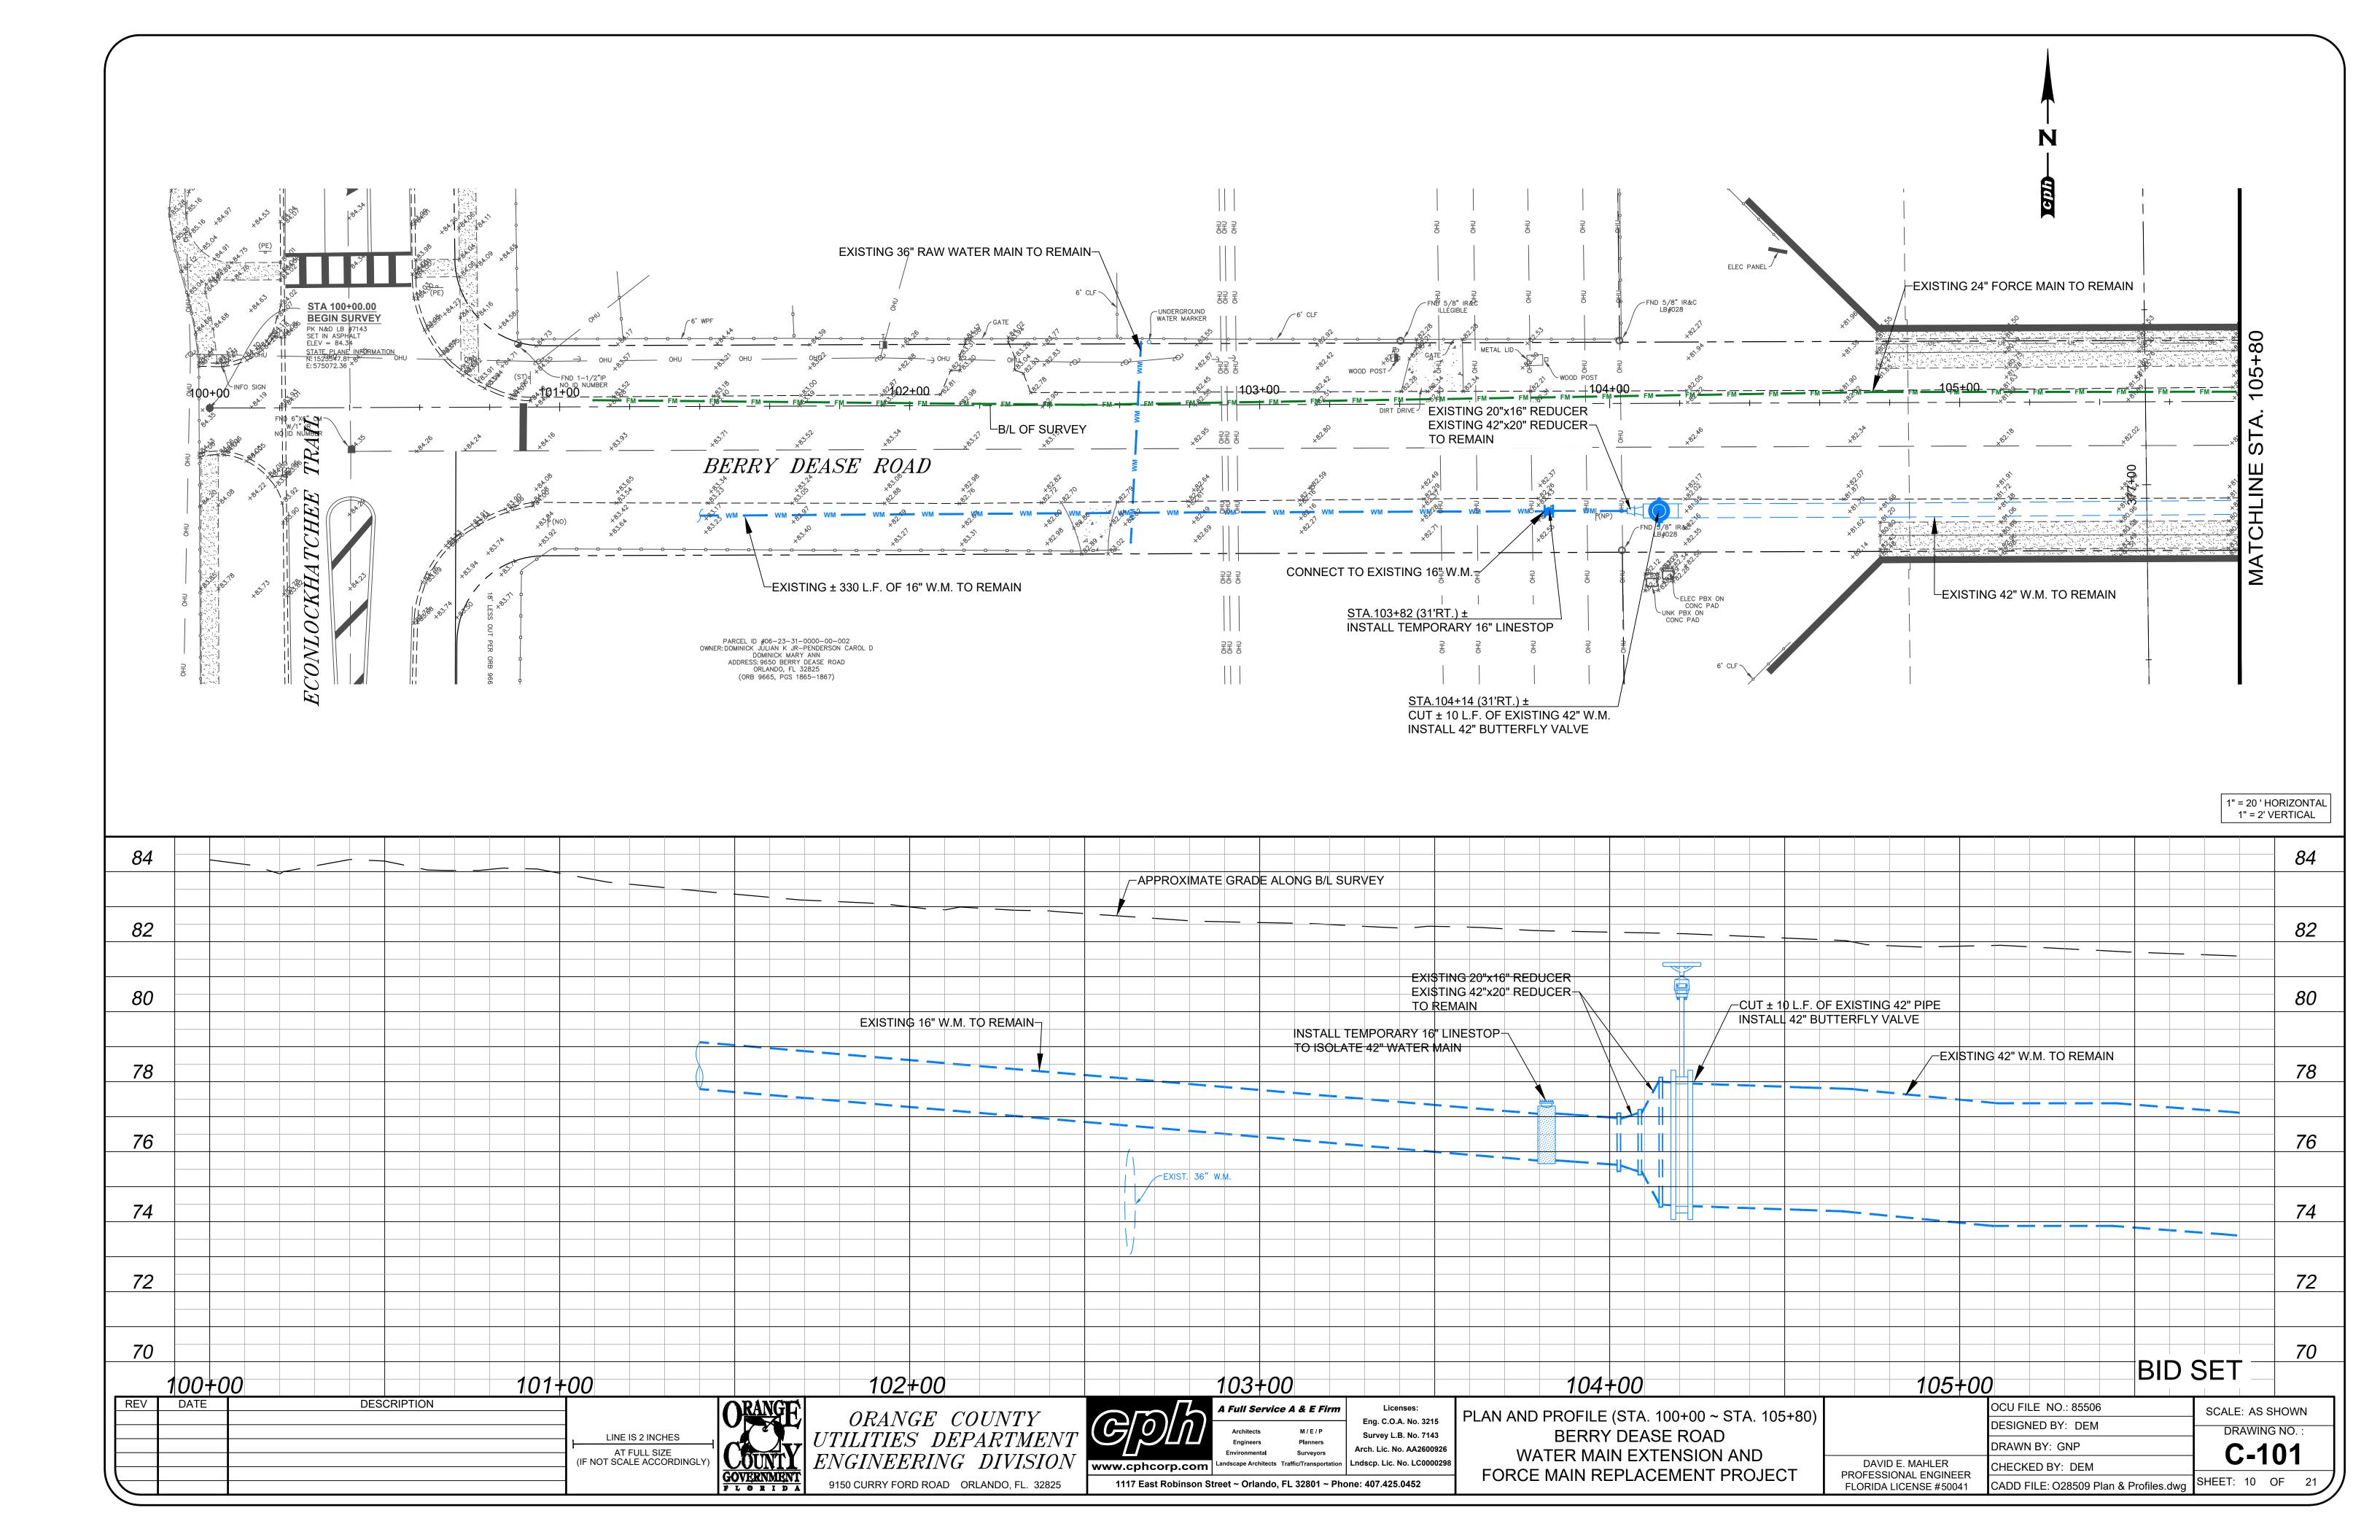


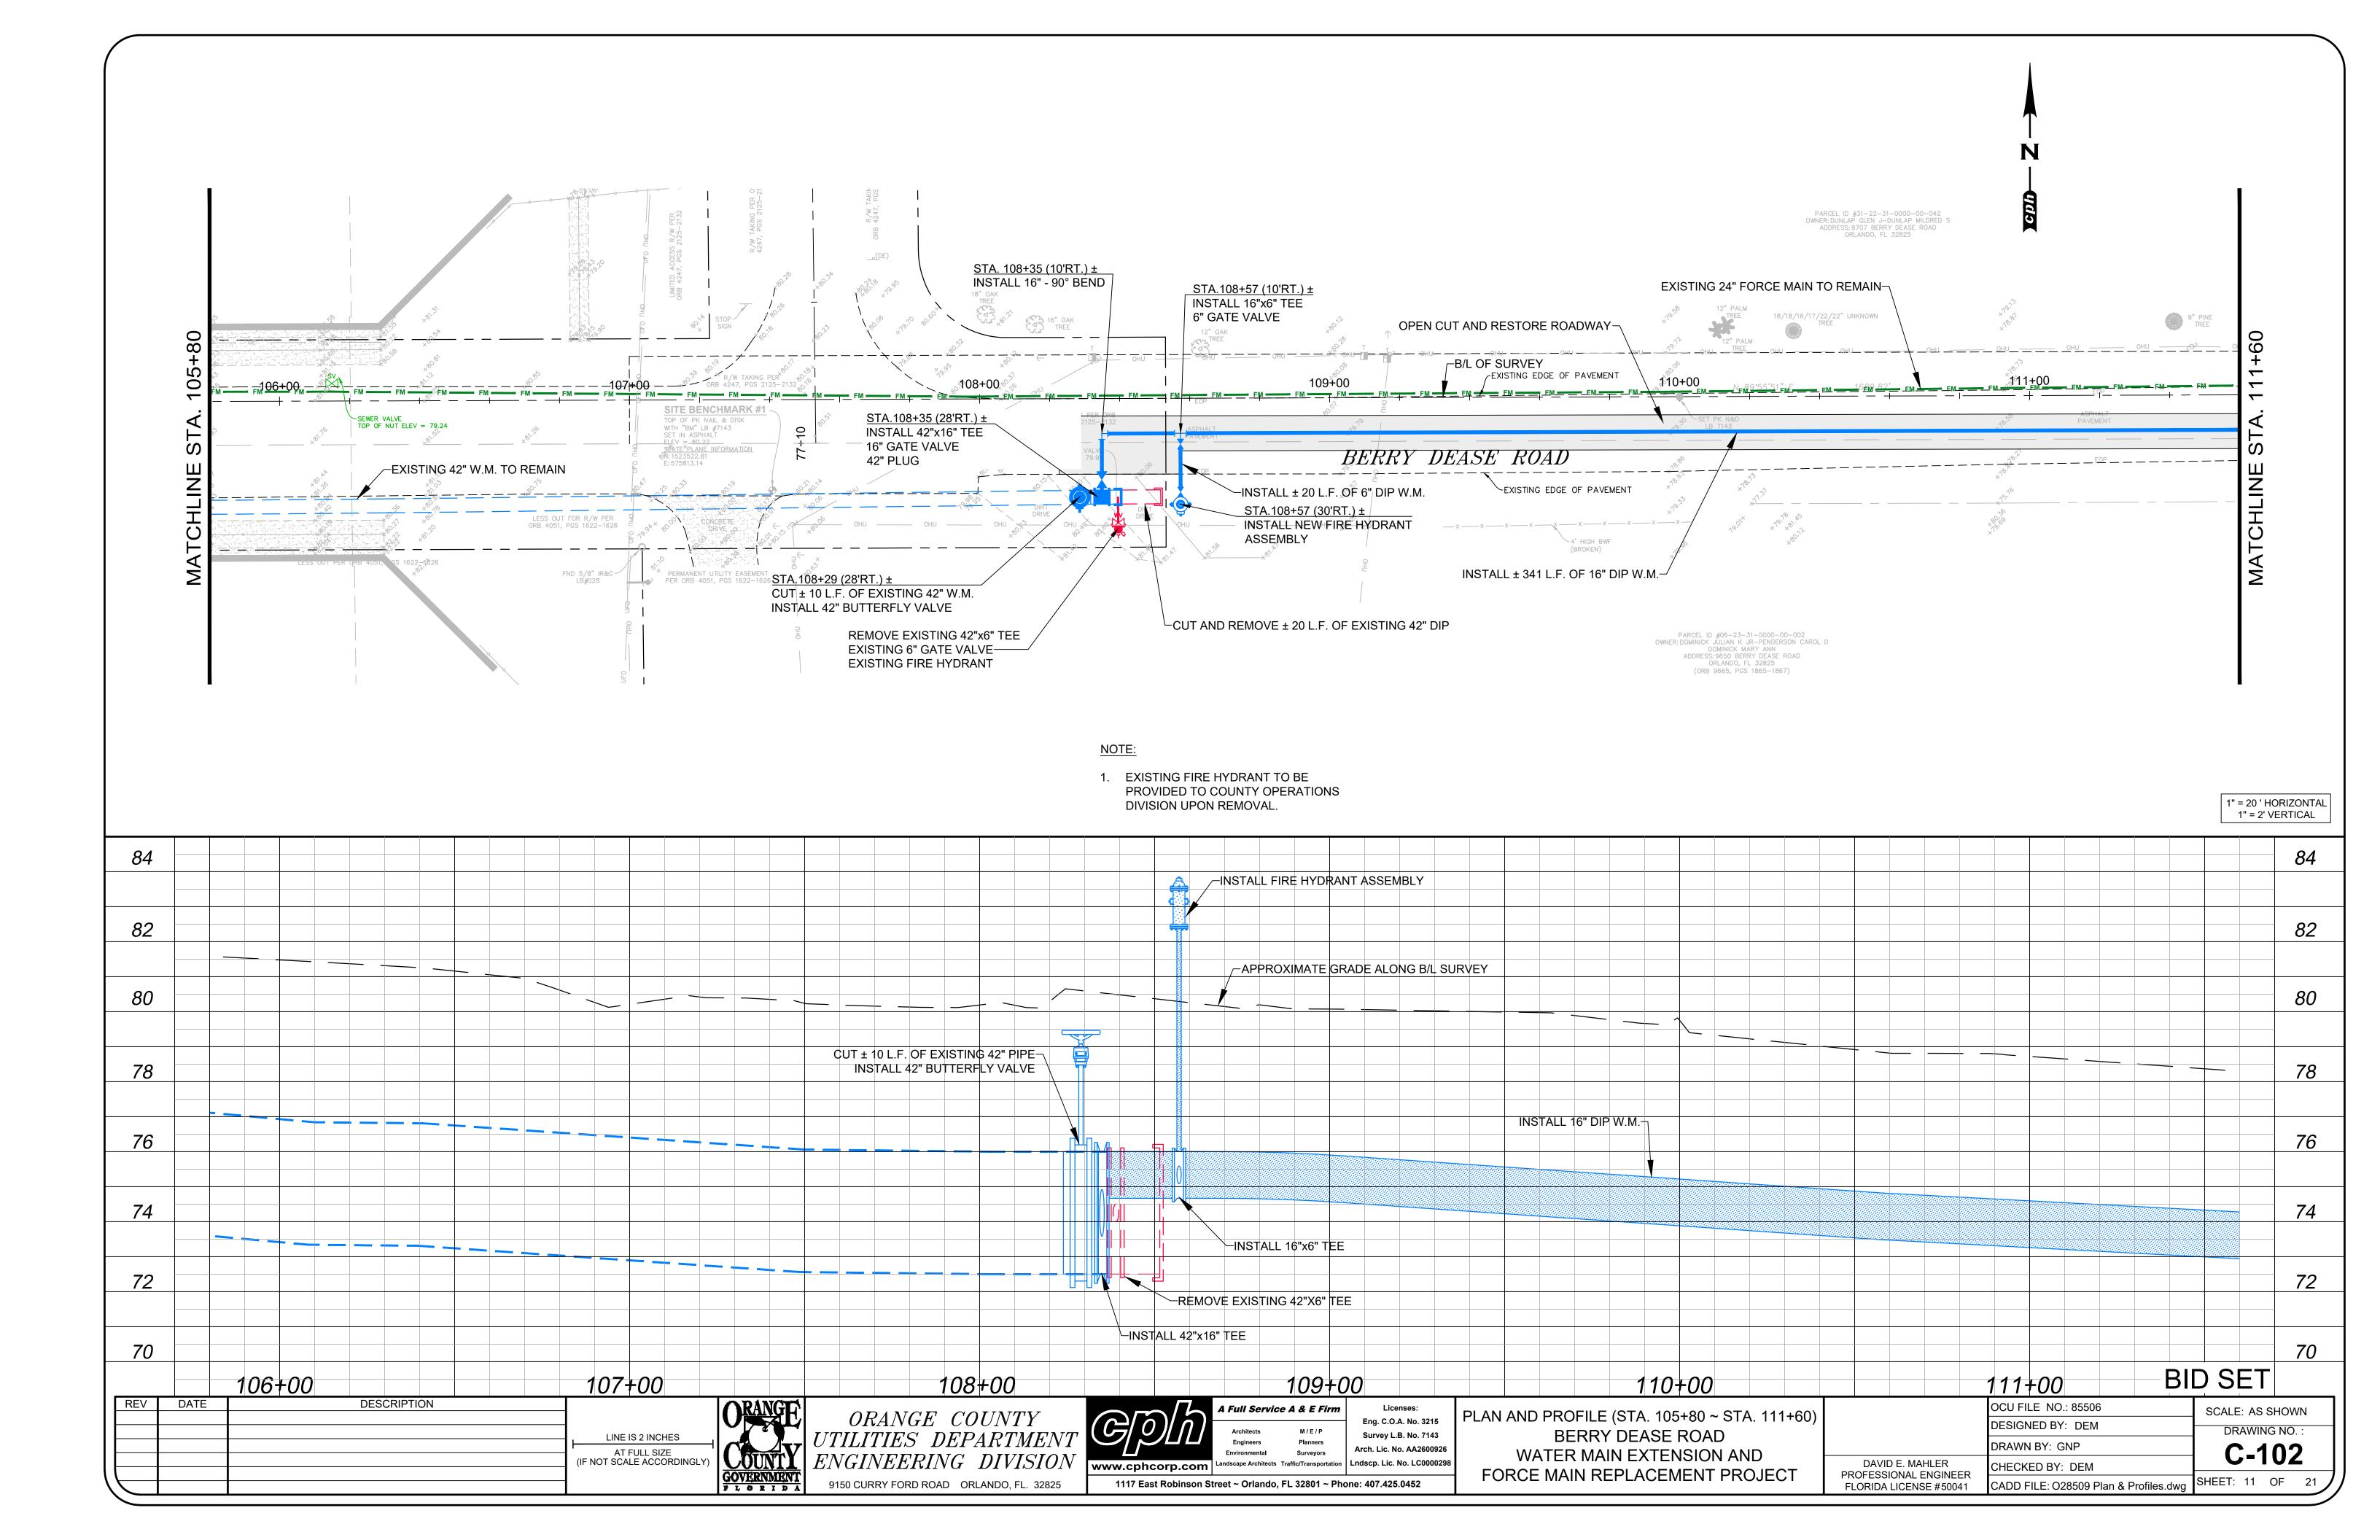


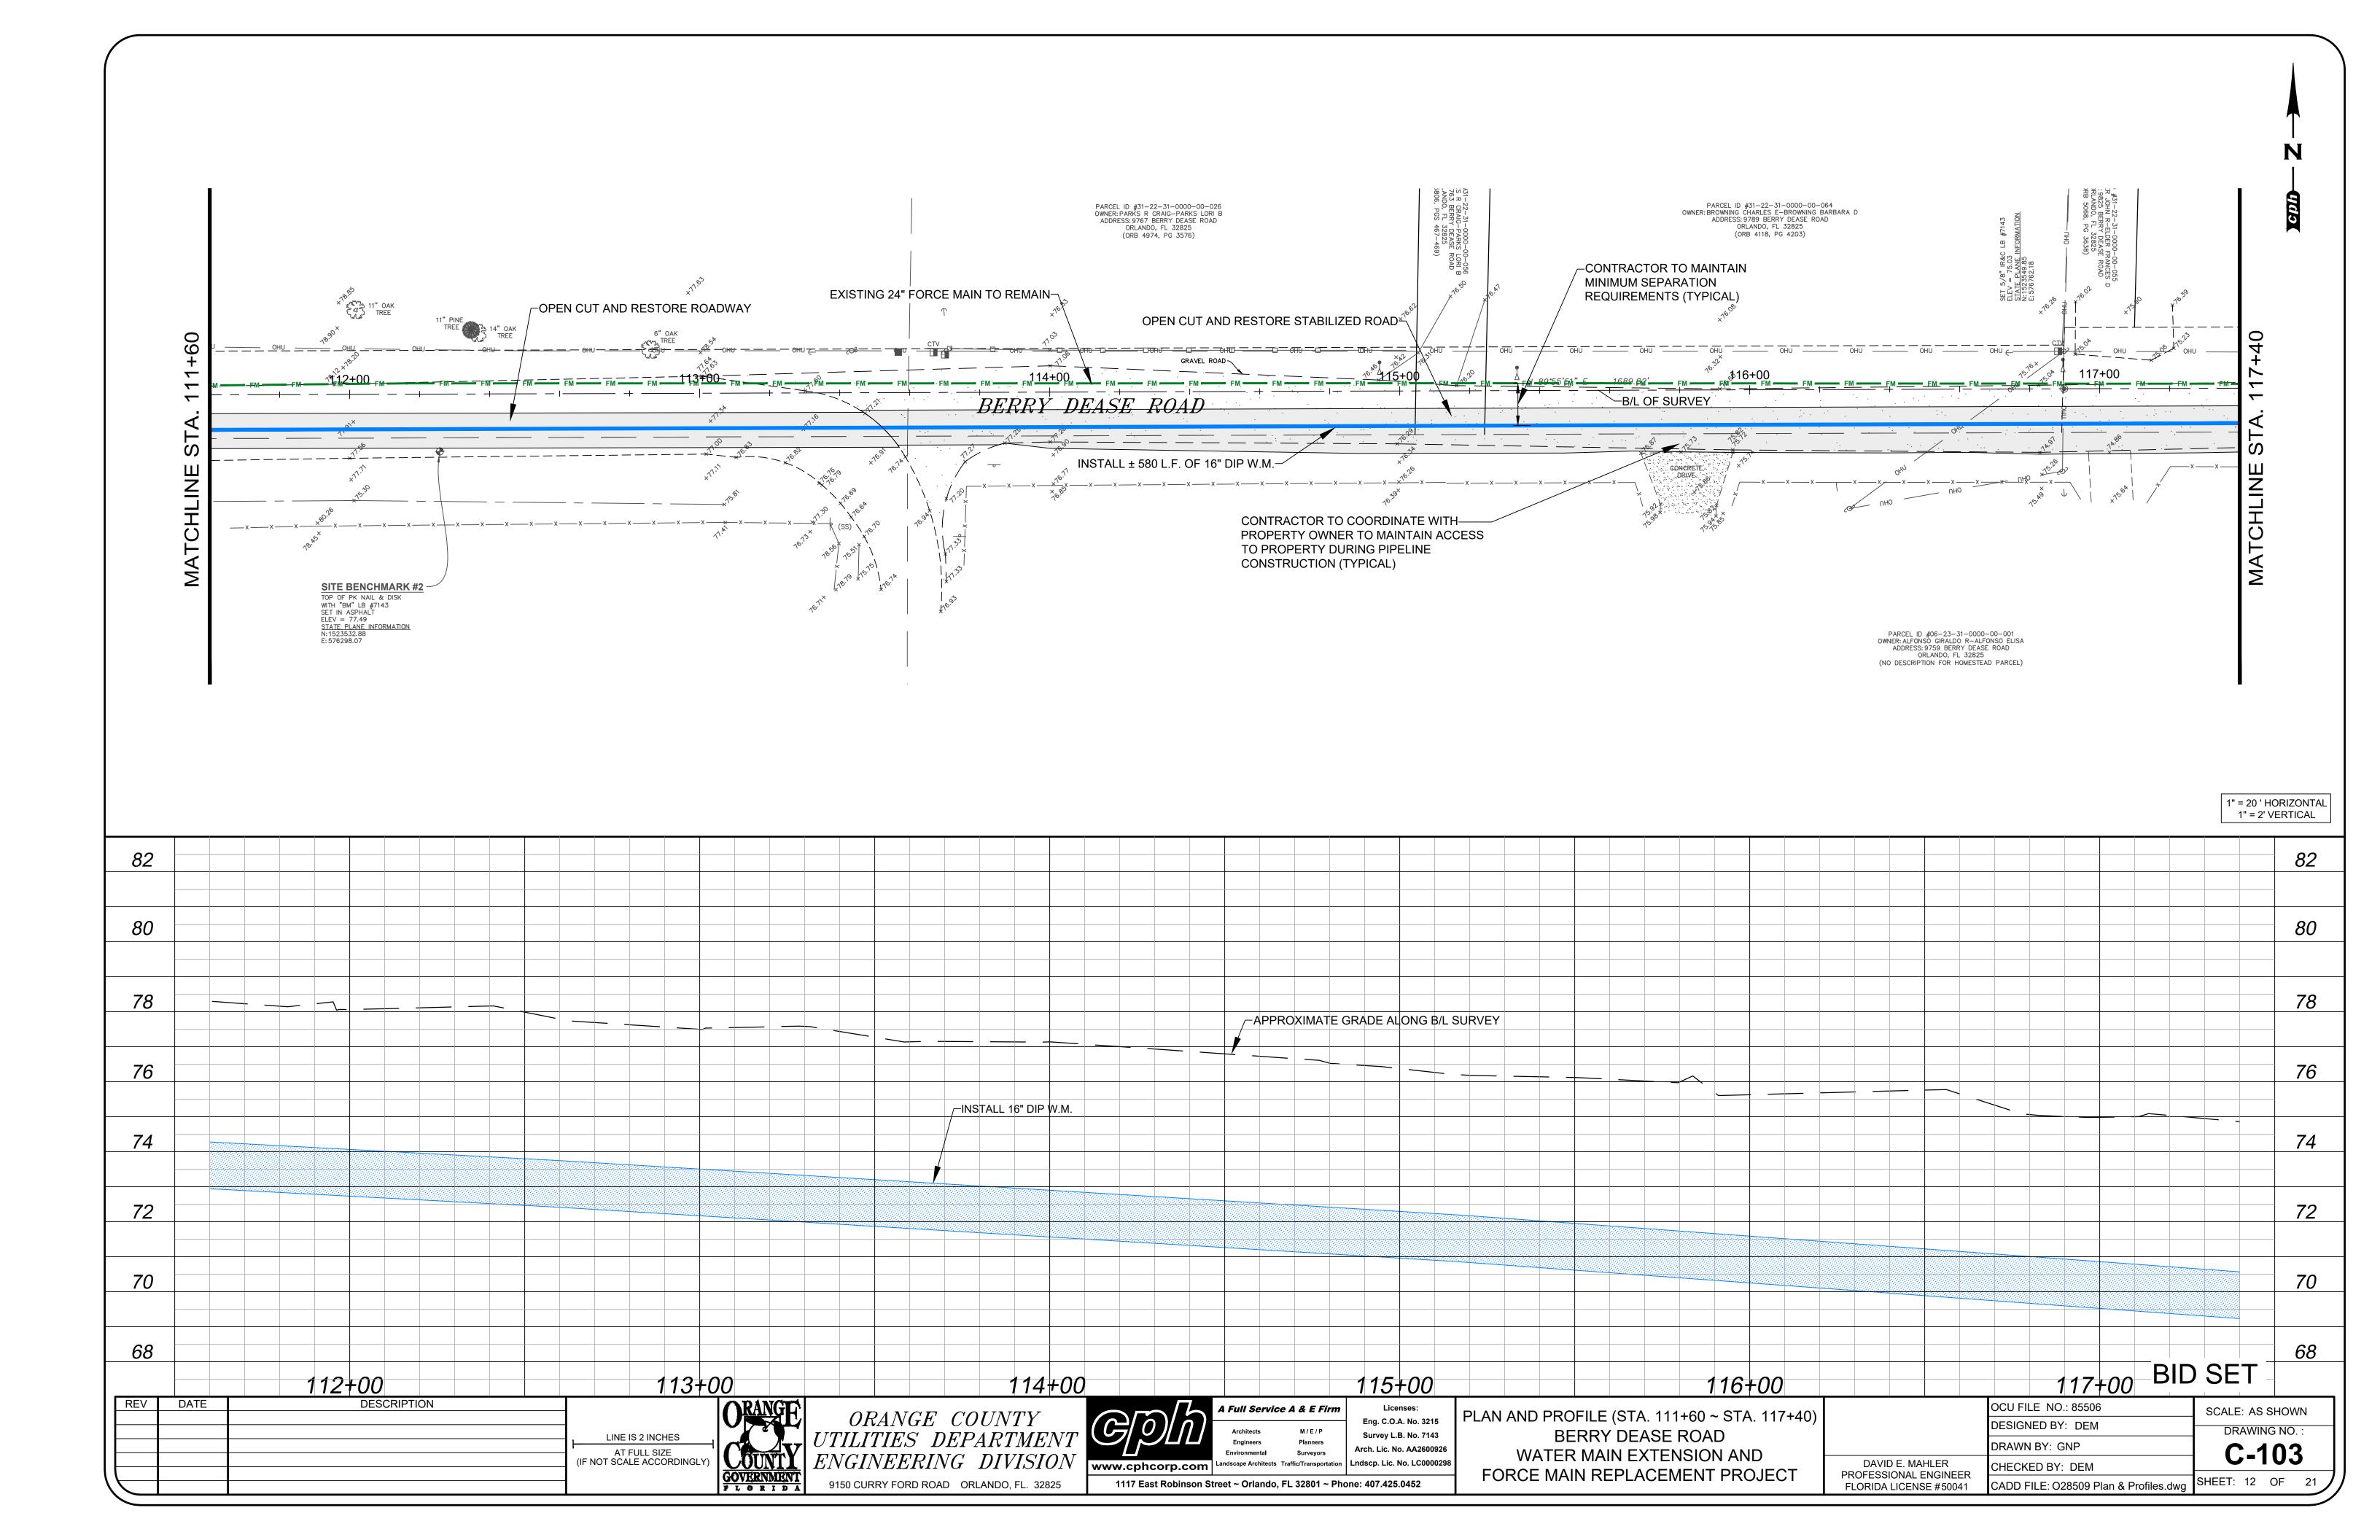

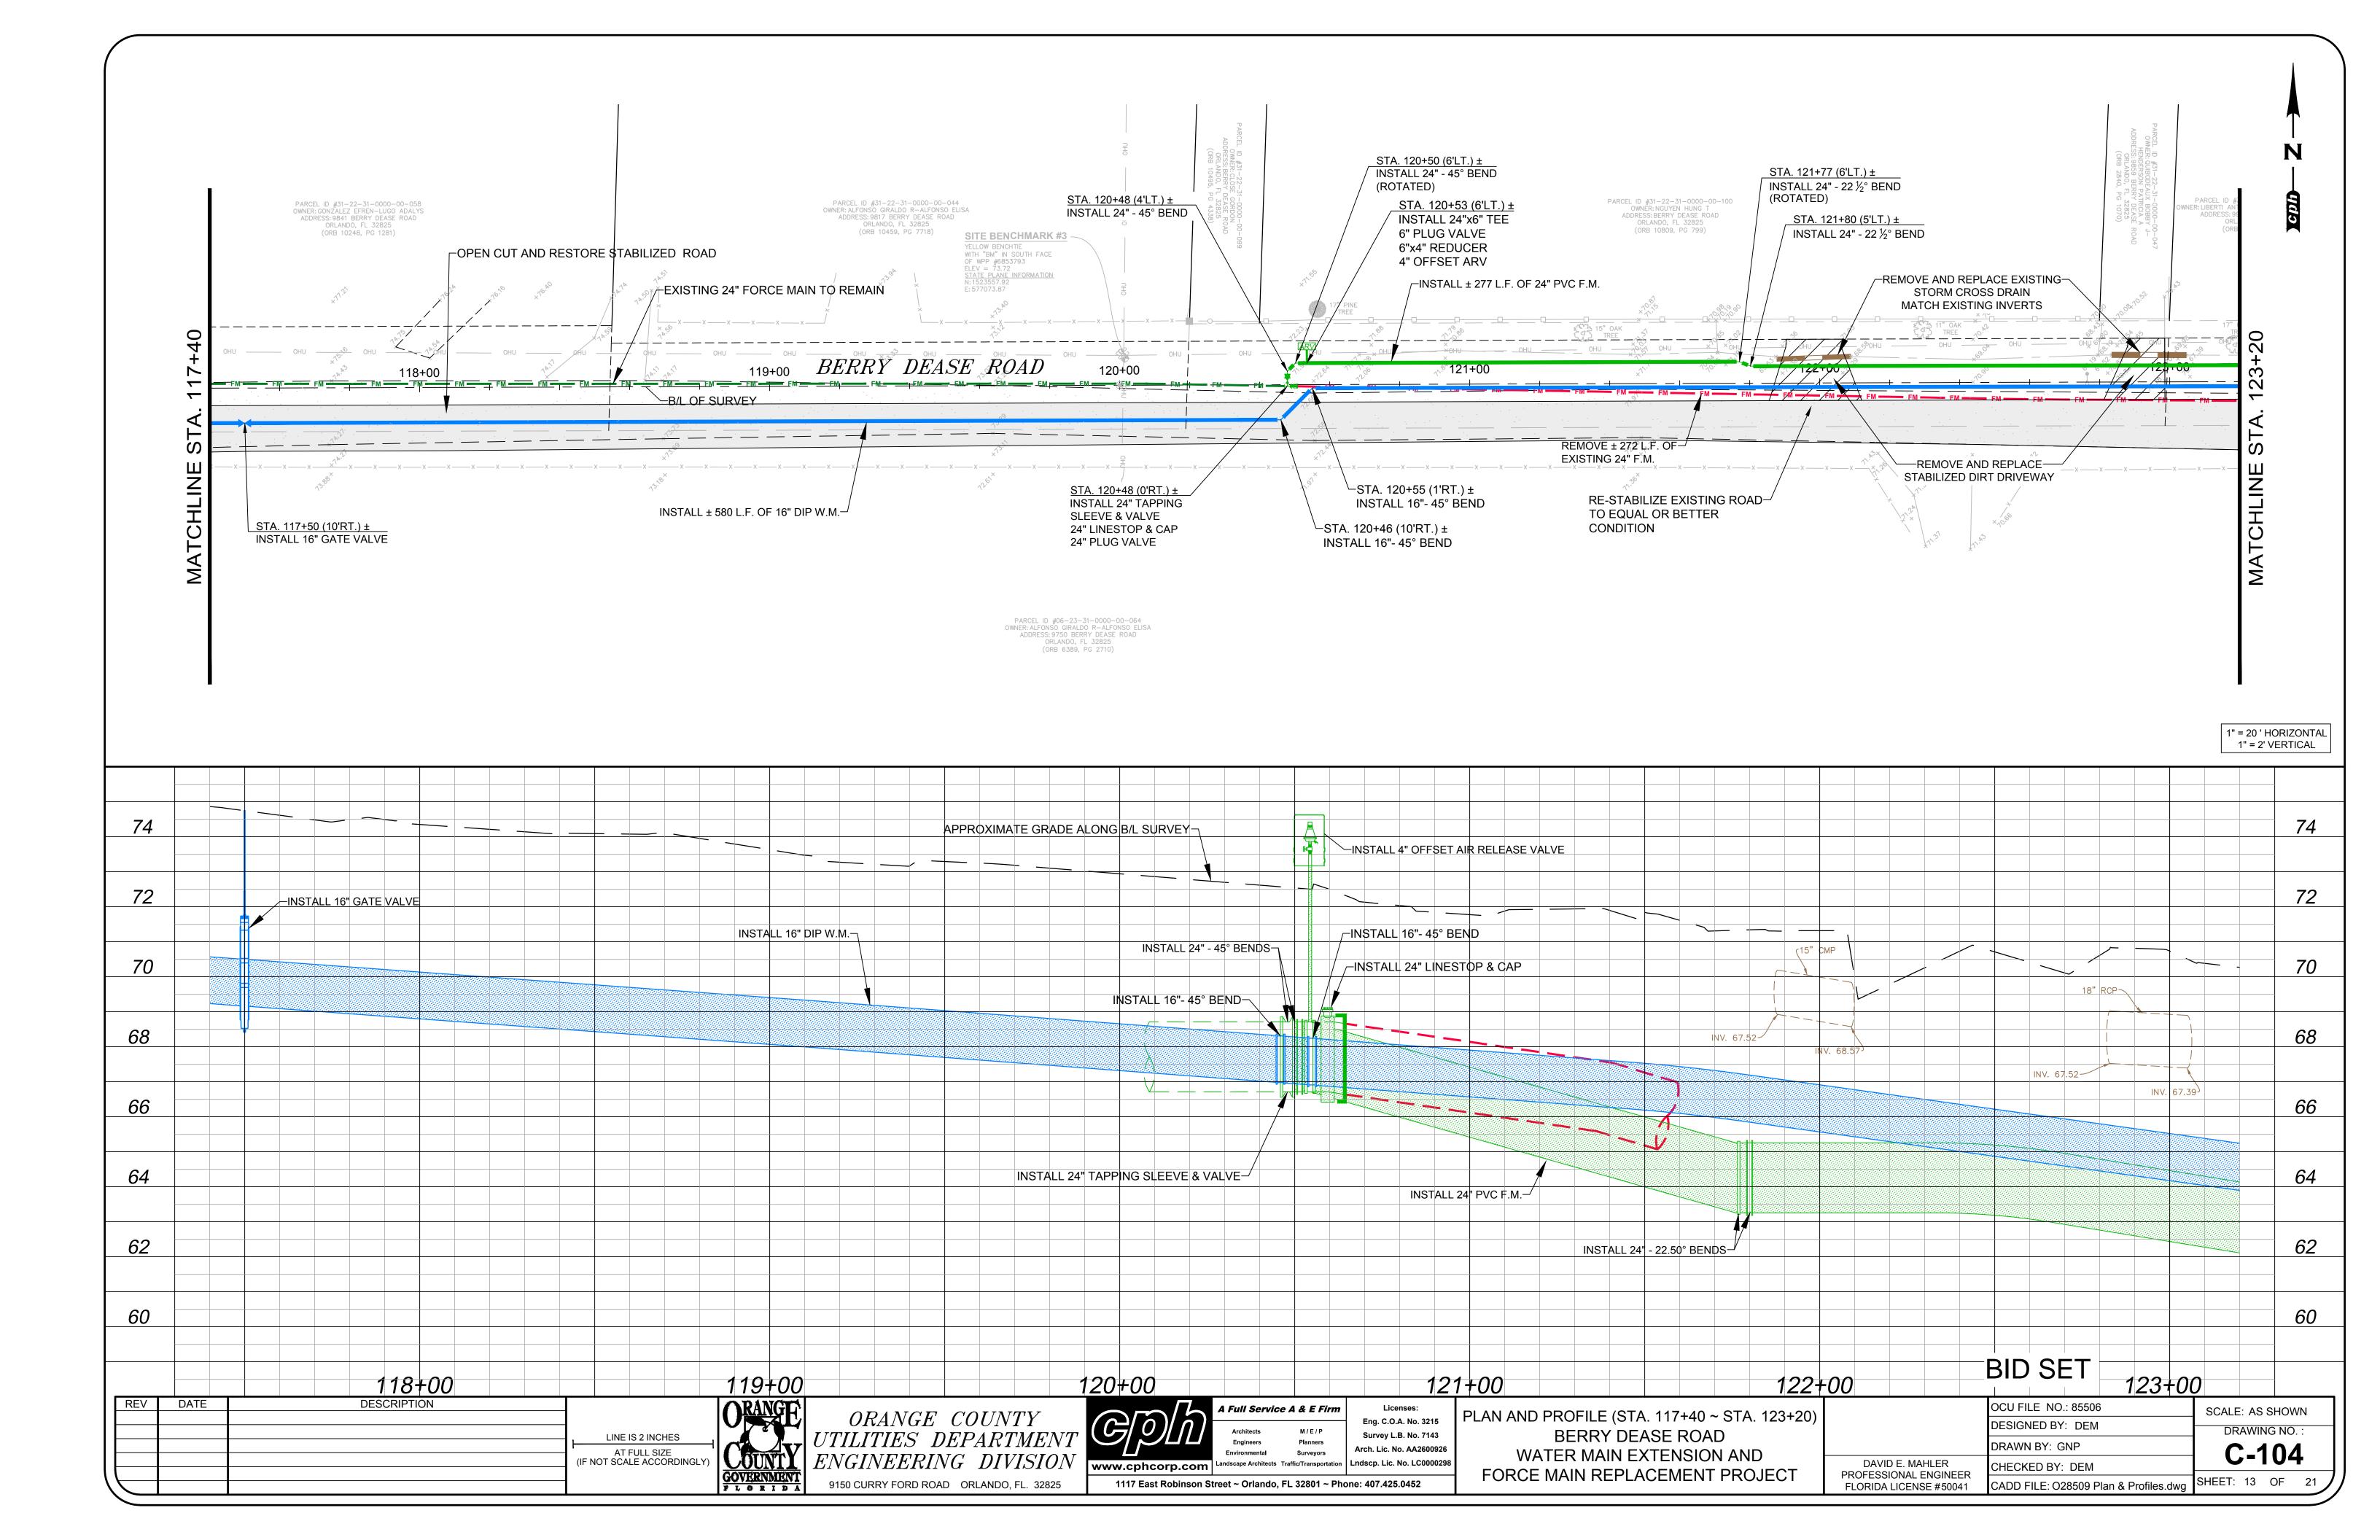

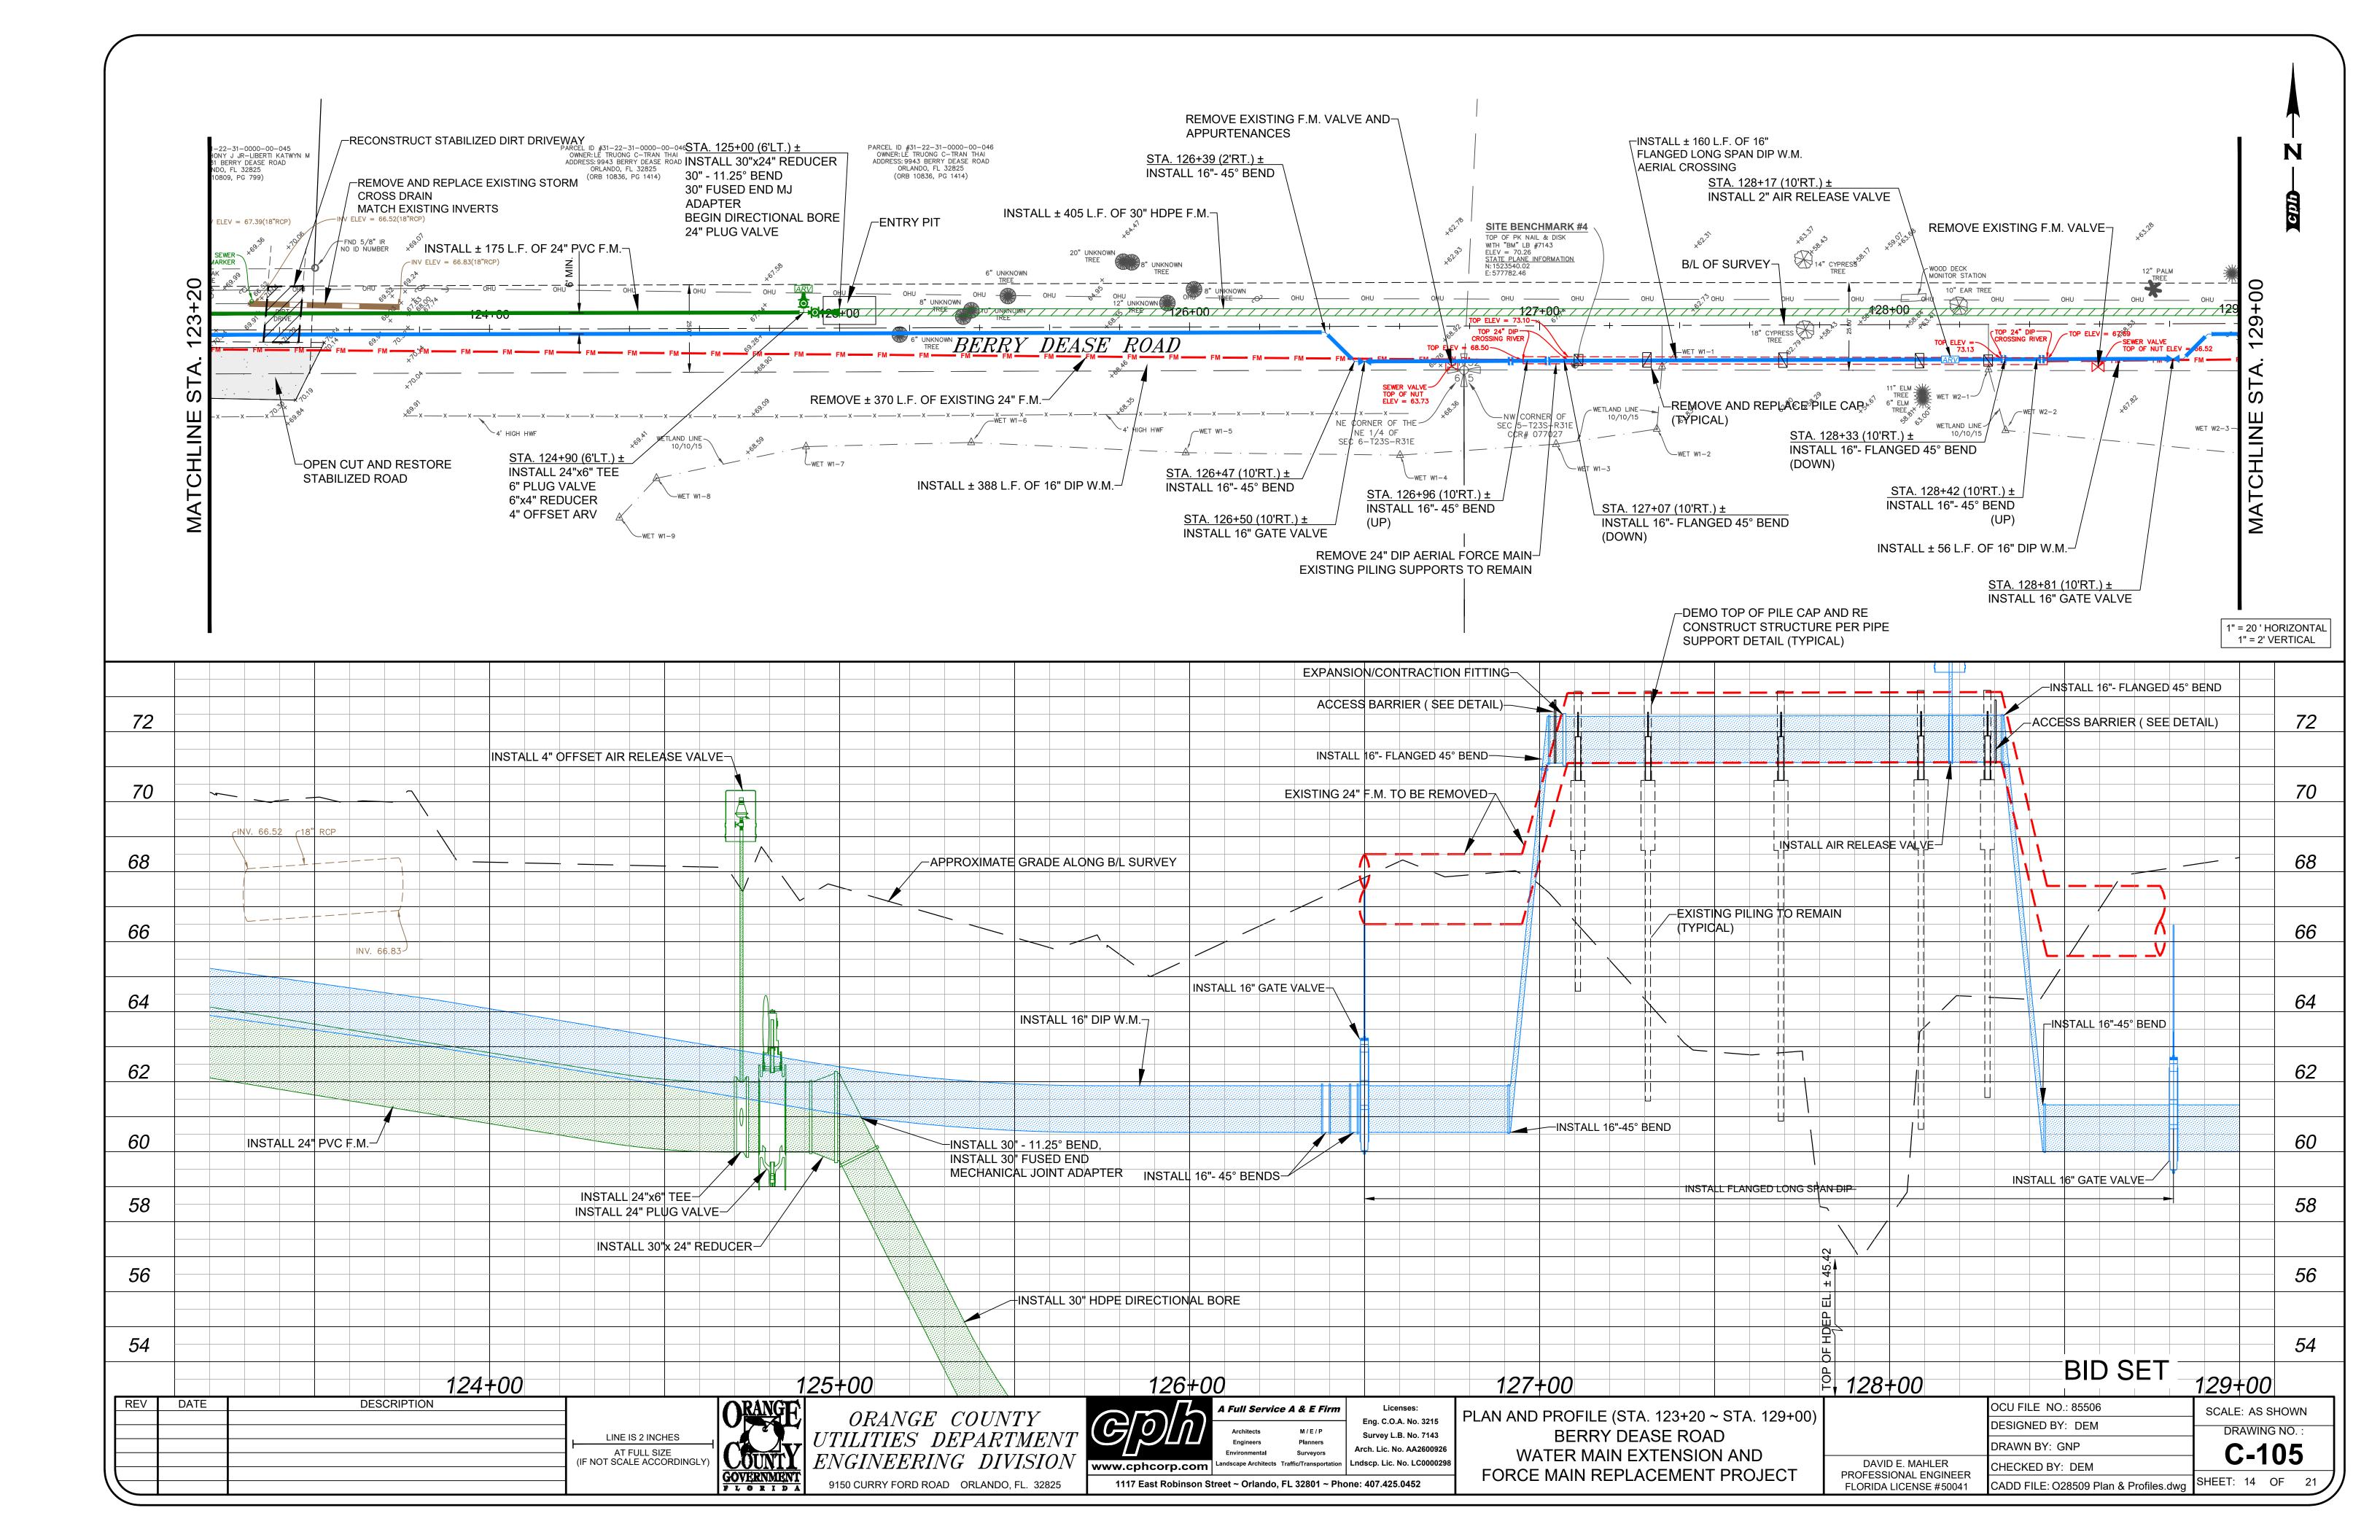

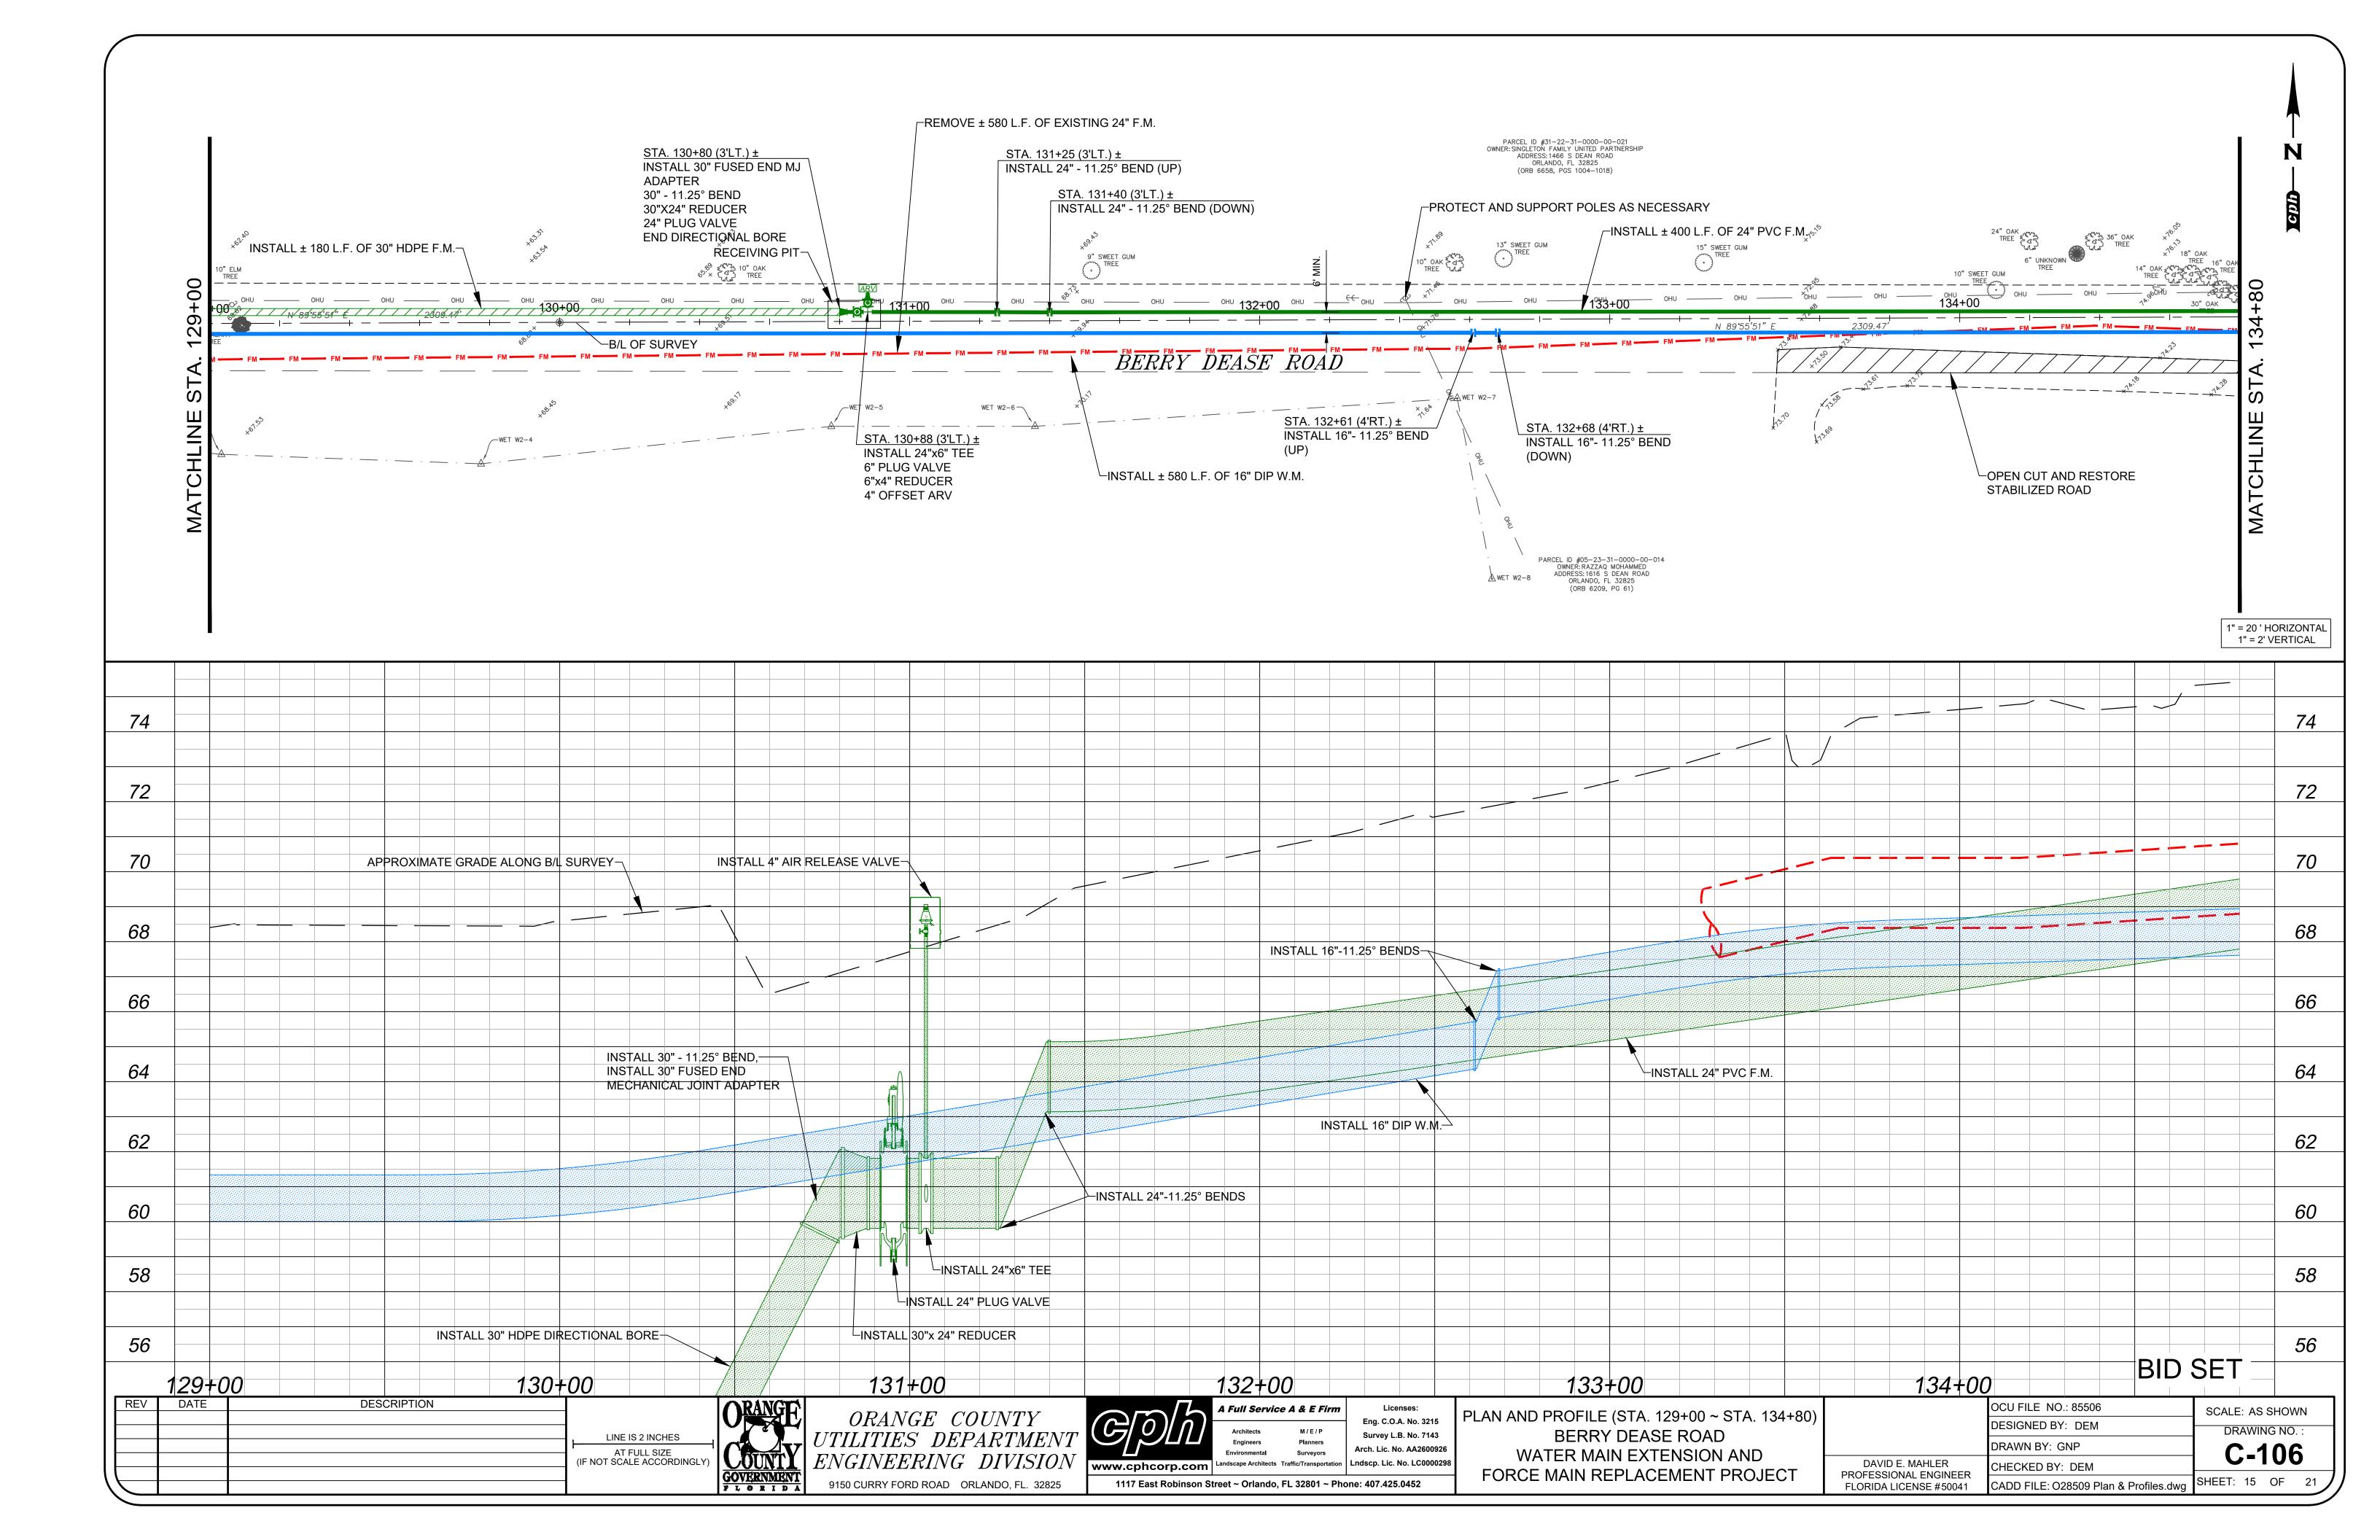

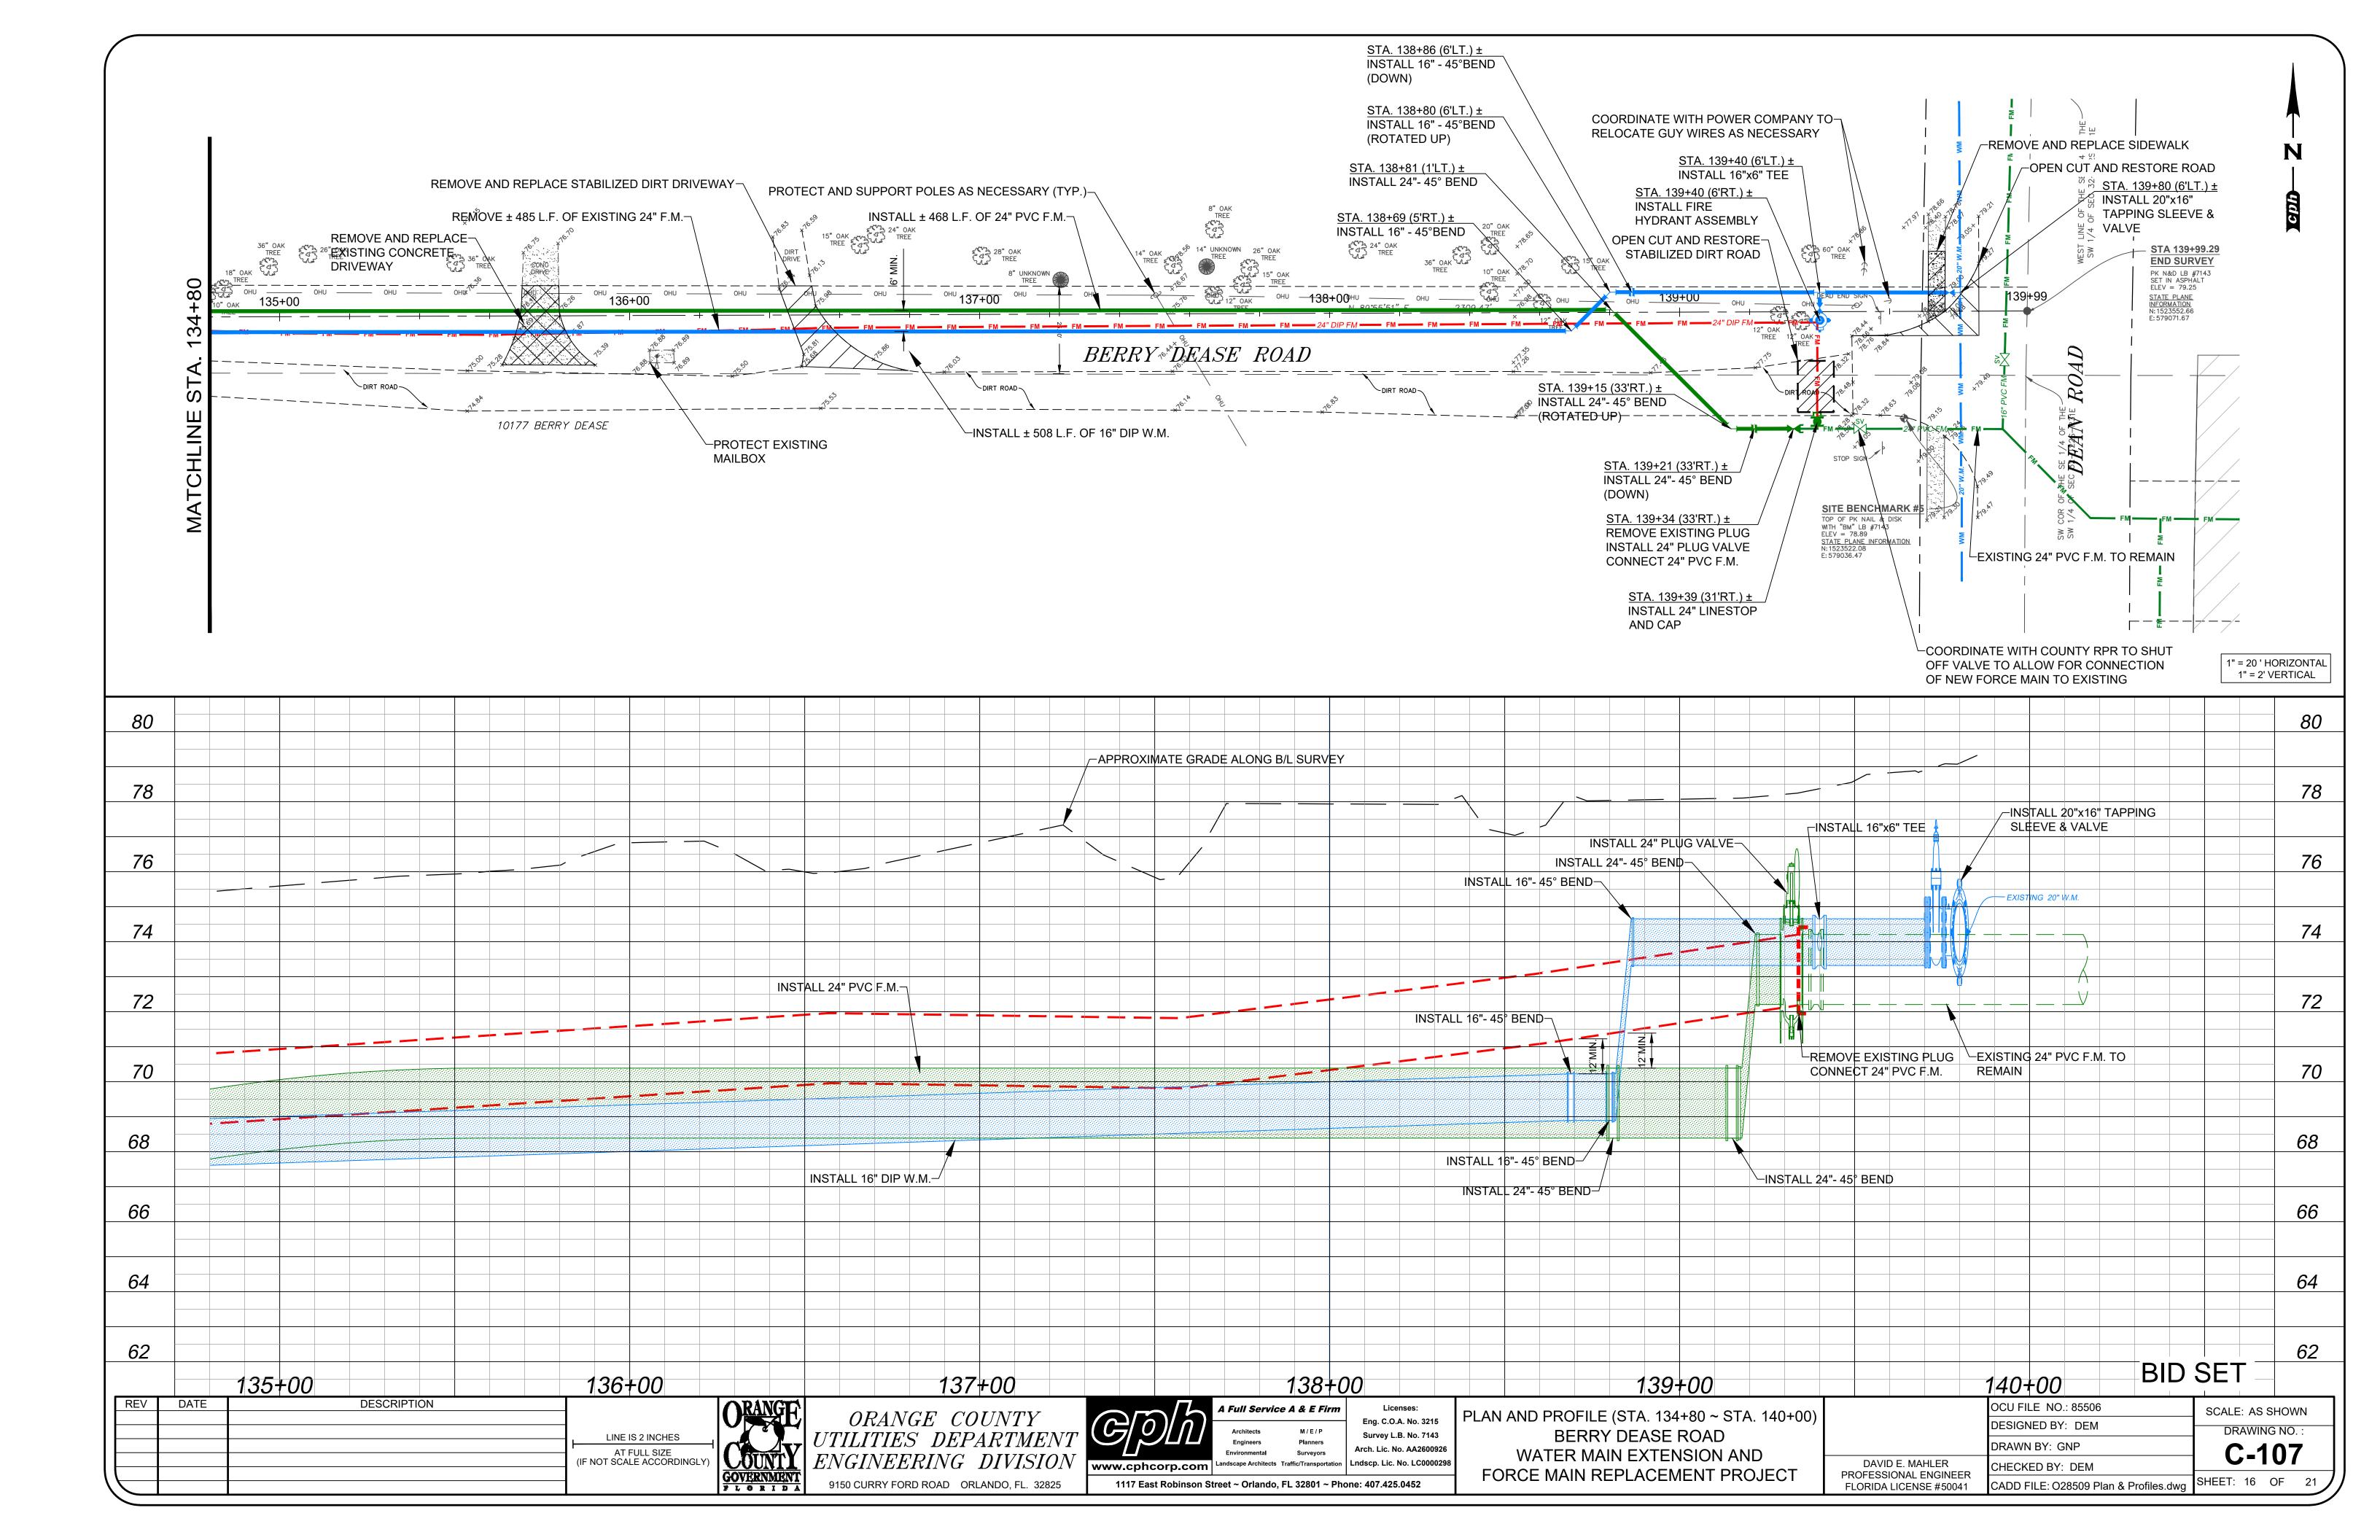

NOTES:

1. INITIAL BACKFILL: SELECT COMMON FILL COMPACTED TO 95% (98% UNDER PAVEMENT) OF THE MAXIMUM DENSITY AS PER AASHTO T-180.


BEDDING

UNDISTURBED EARTH


(SEE NOTES 7 & 8)

- 2. TRENCH BACKFILL: COMMON FILL COMPACTED TO 95% (98% UNDER PAVEMENT) OF THE MAXIMUM DENSITY AS PER AASHTO T-180.
- 3. TYPE A BEDDING MATERIAL SHALL CONFORM TO FDOT NO. 57 AGGREGATE.
- 15" MAX. (12" MIN.) FOR PIPE DIAMETER LESS THAN 24" AND 24" MAX (12" MIN) FOR PIPE DIAMETER 24" AND LARGER.
- 5. WATER SHALL NOT BE PERMITTED IN THE TRENCH DURING CONSTRUCTION.
- ALL PIPE TO BE INSTALLED WITH BELL FACING UPSTREAM TO THE DIRECTION OF THE FLOW.
- 7. BEDDING DEPTH SHALL BE 4" MINIMUM FOR PIPE DIAMETER UP TO 12" AND 6" MINIMUM FOR PIPE DIAMETER 16" AND LARGER.
- 8. DEPTH FOR REMOVAL OF UNSUITABLE MATERIAL SHALL GOVERN DEPTH OF BEDDING ROCK BELOW THE PIPE. UTILITIES SHALL DETERMINE IN THE FIELD REQUIRED REMOVAL OF UNSUITABLE MATERIAL TO REACH SUITABLE FOUNDATION.
- 9. FINAL RESTORATION IN IMPROVED AREAS SHALL BE IN COMPLIANCE WITH ALL APPLICABLE REGULATIONS OF GOVERNING AGENCIES. SURFACE RESTORATION WITHIN ORANGE COUNTY RIGHT-OF-WAY SHALL COMPLY WITH REQUIREMENTS OF R/W UTILIZATION REGULATIONS AND ROAD CONSTRUCTION SPECIFICATIONS.


ORANGE COUNTY UTILITIES
STANDARDS AND CONSTRUCTION SPECIFICATIONS MANUAL

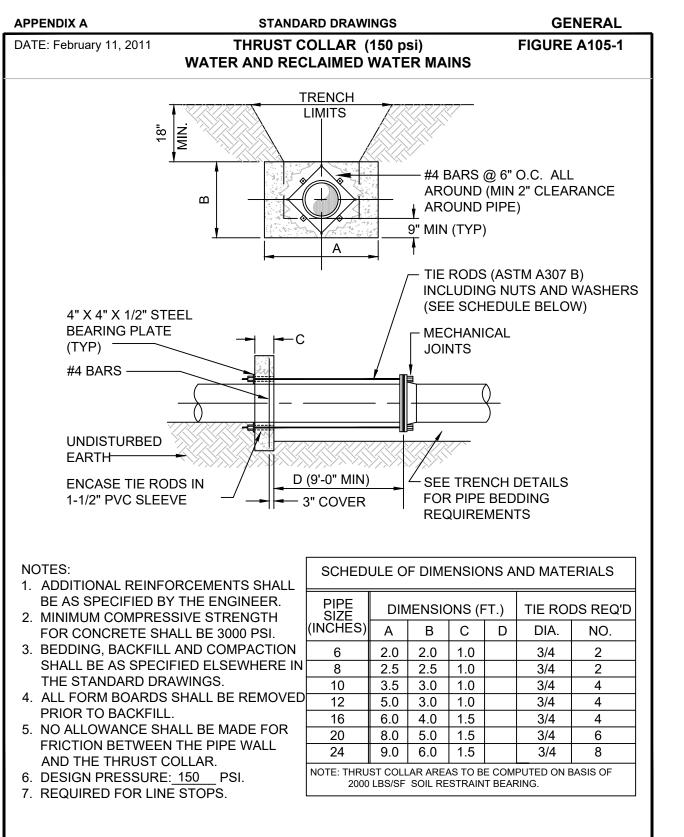

ORANGE COUNTY UTILITIES
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ORANGE COUNTY UTILITIES STANDARDS AND CONSTRUCTION SPECIFICATIONS MANUAL

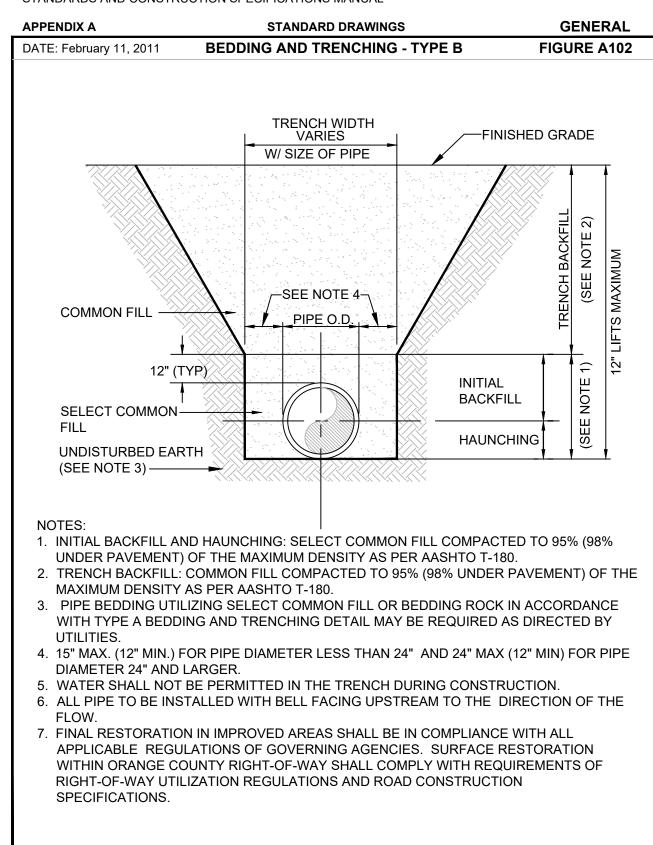

ORANGE COUNTY UTILITIES STANDARDS AND CONSTRUCTION SPECIFICATIONS MANUAL

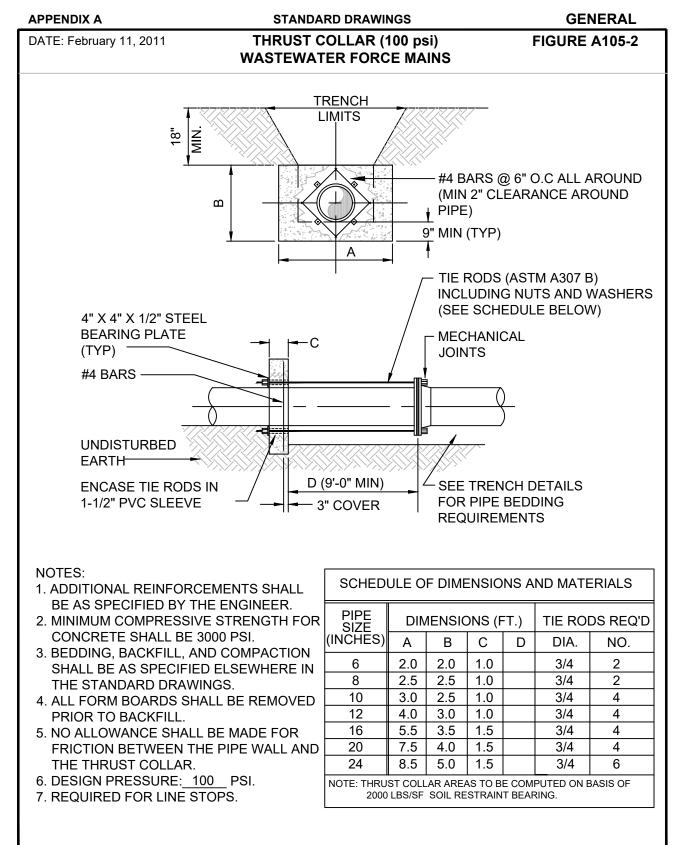APPENDIX A OATE: February 11, 2011		TRAIN EWAT	GENERAL FIGURE A104-2								
MINIMUM LENGTH (FT) TO BE RESTRAINED ON EACH SIDE OF FITTING(S)											
TYPE	_			PV	'C PIF	E SIZ	E				
ITP	4"	6"	8"	10"	12"	16"	20"	24"	30"	36"	
90° BEND	18	24	31	38	43	55	65	75	88	100	
45° BEND	8	10	13	15	18	23	26	31	38	43	
22-1/2° BEI	ND 4	5	6	8	9	11	13	15	18	20	
11-1/4° BEI	ND 2	3	4	5	6	8	9	10	11	13	
PLUG OR E OF TEE	RANCH 38	50	65	79	90	117	139	163	204	223	
VALVE	20	25	32	40	45	59	70	82	98	112	
REDUCER		VARIES BY SIZE; TO BE DETERMINED BY THE DESIGN ENGINEER.									
NOTES: 1. FITTINGS SHALL 2. INSTALL FULL LI LENGTH SHOWN 3. WHERE TWO OF	ENGTH JOINTS N IN THE TABLE R MORE FITTING	WITH E. GS ARI	TOTA E IN S	L LEN	IGTH S, SEI	EQUA	L TO	OR G	REAT	ER THAN	


- 4. ALL INLINE VALVES SHALL BE RESTRAINED.
- 5. WHERE INTERNAL RESTRAINED JOINTS ARE USED, THE ENTIRE BELL SHALL BE PAINTED RED
- 6. LENGTHS SHOWN IN THE TABLE WERE CALCULATED IN ACCORDANCE WITH PROCEDURES OUTLINED IN "THRUST RESTRAINT DESIGN FOR DUCTILE IRON PIPE" GUIDELINES PUBLISHED BY DIPRA, USING THE ASSUMPTIONS SHOWN BELOW:

WORKING PRESSURE: 100 PSI
SOIL DESIGNATION: SM (SAND SILT)
LAYING CONDITIONS: 3
DEPTH OF COVER: 3 FT
SAFETY FACTOR: 1.5

CONVERSION FACTOR FOR PVC PIPE: 1.25

THE DESIGN ENGINEER SHALL INCREASE THE VALUES IN THE TABLE AS WARRANTED BY SITE-SPECIFIC PARAMETERS, SUCH AS SOIL DESIGNATIONS AND LAYING CONDITIONS.

ORANGE COUNTY UTILITIES STANDARDS AND CONSTRUCTION SPECIFICATIONS MANUAL

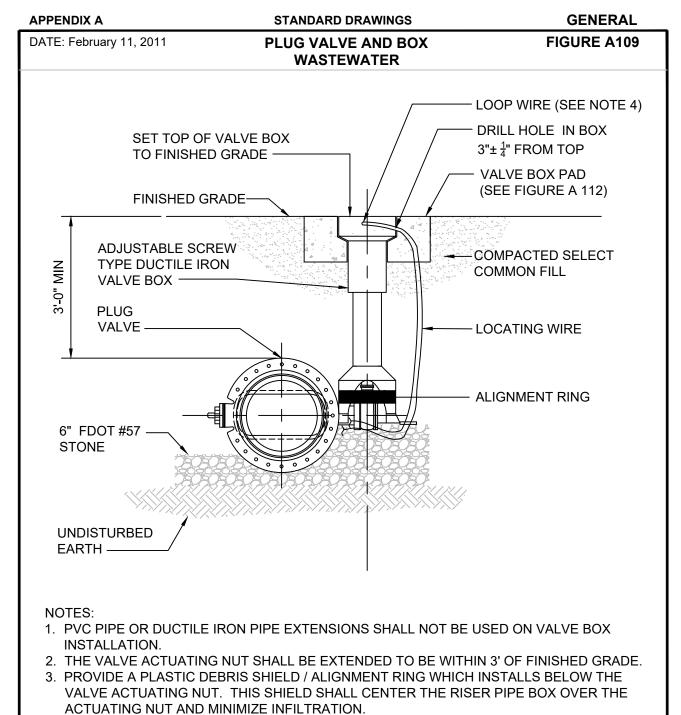

- LOCATING WIRE SHALL BE CONTINUOUS WITH NO SPLICES AND SHALL EXTEND 12" ABOVE TOP OF COLLAR. WIRE SHALL BE COLOR CODED TO MATCH THE UTILITY INSTALLED.
 FOR NEW CONSTRUCTION, THE VALVE BOX SHALL BE ADJUSTED TO MIDRANGE TO
- ALLOW FOR FUTURE BOX ADJUSTMENTS.

 6. REFER TO FIGURE A111 FOR INSTALLATIONS AT A DEPTH OF 6' OR GREATER.

ORANGE COUNTY UTILITIES
STANDARDS AND CONSTRUCTION SPECIFICATIONS MANUAL

WATER AND RECLAIMED WATER MAINS MINIMUM LENGTH (FT) TO BE RESTRAINED ON EACH SIDE OF FITTING(S) PIPE SIZE TYPE 4" | 6" | 8" | 10" | 12" | 16" | 20" | 24" | 30" | 36" 90° BEND 25 | 36 | 46 | 55 | 64 | 65 | 77 | 89 | 105 | 120 10 | 15 | 19 | 23 | 26 | 27 | 32 | 37 | 44 | 50 45° BEND 5 | 8 | 9 | 11 | 13 | 13 | 15 | 18 | 21 | 24 22-1/2° BEND 11-1/4° BEND PLUG OR BRANCH 53 | 74 | 97 | 117 | 135 | 138 | 166 | 194 | 231 | 265 OF TEE VALVE 27 | 38 | 49 | 59 | 68 | 69 | 83 | 97 | 116 | 133 VARIES BY SIZE; TO BE DETERMINED BY THE **REDUCER** DESIGN ENGINEER.

STANDARD DRAWINGS

RESTRAINED PIPE TABLE

GENERAL

FIGURE A104-1

NOTES:

APPENDIX A

DATE: February 11, 2011


- 1. FITTINGS SHALL HAVE RESTRAINED JOINTS UNLESS OTHERWISE INDICATED.
- 2. INSTALL FULL LENGTH JOINTS WITH TOTAL LENGTH EQUAL TO OR GREATER THAN LENGTH SHOWN IN THE TABLE.
- 3. WHERE TWO OR MORE FITTINGS ARE IN SERIES, SELECT FITTING RESTRAINT LENGTH THAT YIELDS THE LONGEST RESTRAINT DISTANCE.
- 4. ALL INLINE VALVES SHALL BE RESTRAINED.
- 5. WHERE INTERNAL RESTRAINED JOINTS ARE USED, THE ENTIRE BELL SHALL BE
- PAINTED RED.
 6. LENGTHS SHOWN IN THE TABLE WERE CALCULATED IN ACCORDANCE WITH
- PROCEDURES OUTLINED IN "THRUST RESTRAINT DESIGN FOR DUCTILE IRON PIPE"
 GUIDELINES PUBLISHED BY DIPRA, USING THE ASSUMPTIONS SHOWN BELOW:

WORKING PRESSURE: 150 PSI
SOIL DESIGNATION: SM (SAND SILT)
LAYING CONDITIONS: 3
DEPTH OF COVER: 3 FT
SAFETY FACTOR: 1.5
CONVERSION FACTOR FOR PVC PIPE: 1.25

THE DESIGN ENGINEER SHALL INCREASE THE VALUES IN THE TABLE AS WARRANTED BY SITE-SPECIFIC SOIL DESIGNATIONS, LAYING CONDITIONS, PIPE MATERIAL, ETC. FOR DIP ENCASED IN POLYETHYLENE, INCREASE THE GIVEN VALUE BY A FACTOR OF


FOR DIP ENCASED IN POLYETHYLENE, INCREASE THE GIVEN VALUE BY A FACTOR OF 1.25.

ORANGE COUNTY UTILITIES
STANDARDS AND CONSTRUCTION SPECIFICATIONS MANUAL

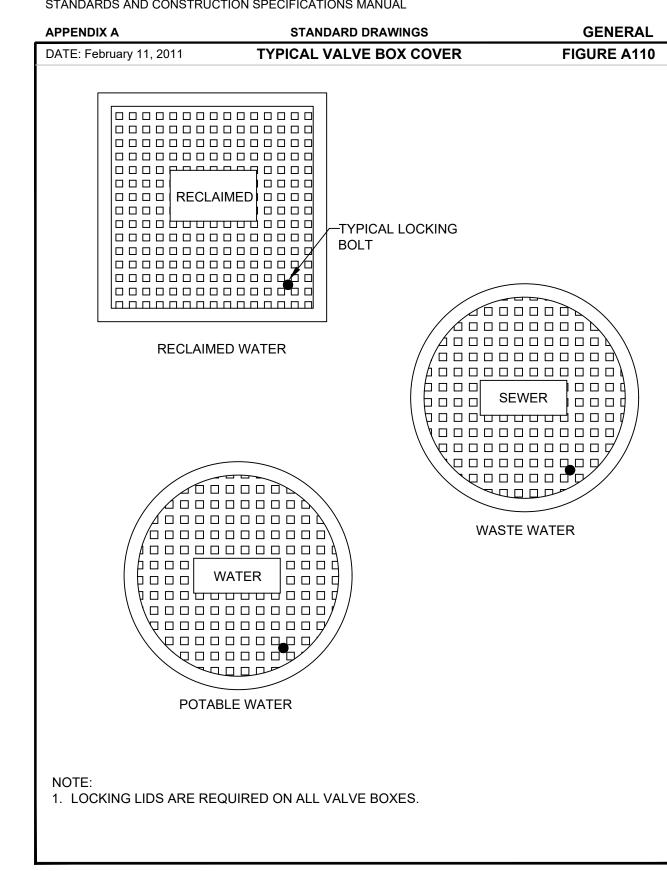


										<u> </u>
REV	DATE	DESCRIPTION	ORANGE		A Full Service A & E Firm	Licenses:	CONSTRUCTION DETAILS		OCU FILE NO.: 85506	SCALE: N.T.S.
			ORANGE	$ORANGE\ COUNTY$		Eng. C.O.A. No. 3215	CONSTRUCTION DETAILS		DESIGNED BY: DEM	
			LINE IS 2 INCHES	IITIIITIFS DEPARTMENT	Architects M / E / P	Survey L.B. No. 7143	BERRY DEASE ROAD			DRAWING NO. :
			AT FULL SIZE		Engineers Planners Environmental Surveyors	Arch. Lic. No. AA2600926			DRAWN BY: GNP	— D-100
			(IF NOT SCALE ACCORDINGLY)	ENGINEERING DIVISION	www.cphcorp.com Landscape Architects Traffic/Transportation	Lndscp. Lic. No. LC0000298	WATER MAIN EXTENSION AND	DAVID E. MAHLER	CHECKED BY: DEM	D-100
$I \leftarrow$			GOVERNMENT	0450 CLIDDY FORD DOAD ODLANDO EL 22025	1117 East Robinson Street ~ Orlando, FL 32801 ~ Pho	no: 407 425 0452	FORCE MAIN REPLACEMENT PROJECT	PROFESSIONAL ENGINEER	CADD FILE CONTROL COLUMN	SHEET: 17 OF 21
			FLORIDA	9150 CURRY FORD ROAD ORLANDO, FL. 32825	Titi Last Robinson Street ~ Onando, FL 32001 ~ File	JIIE. 401.425.0452		FLORIDA LICENSE #50041	CADD FILE: 028509 Cover	

ORANGE COUNTY UTILITIES STANDARDS AND CONSTRUCTION SPECIFICATIONS MANUAL

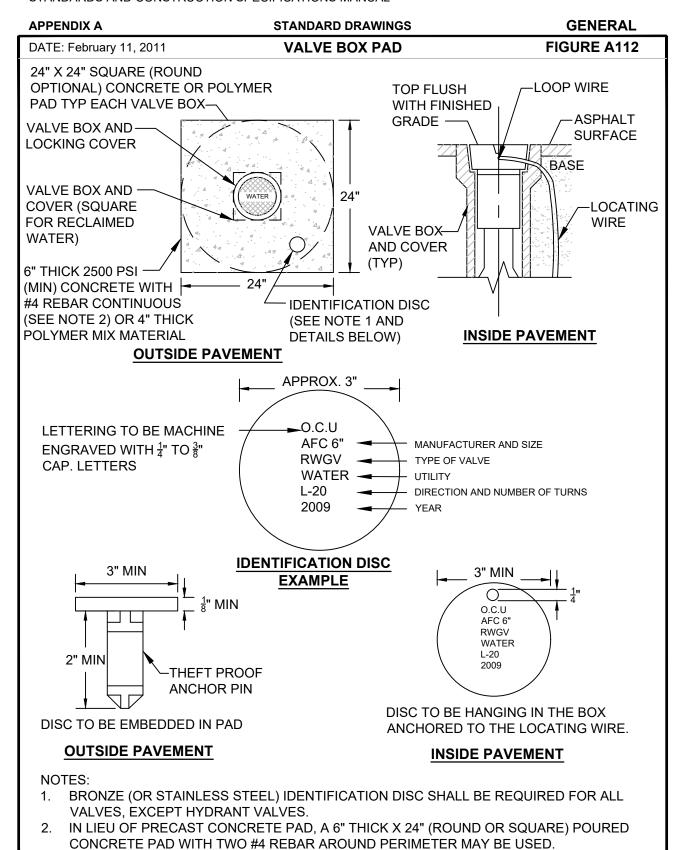

ORANGE COUNTY UTILITIES STANDARDS AND CONSTRUCTION SPECIFICATIONS MANUAL

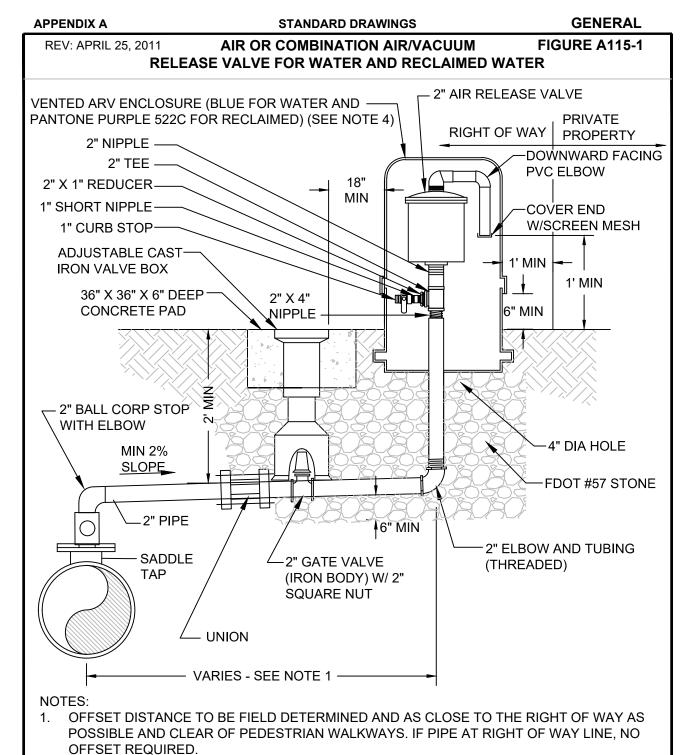

ABOVE DETAIL APPLIES TO A 2" ARV. FOR LARGER ARVS, PIPE DIAMETER SHALL BE

3. ALL PIPING, VALVES, AND APPURTENANCES TO BE BRASS OR 316 S.S. EXCEPT WHERE


4. THE ENCLOSURE VENTS MUST BE CAPABLE OF ALLOWING AT LEAST THE SAME AMOUNT

EQUAL TO THE SIZE OF THE ARV .

SPECIFIED OTHERWISE.


OF AIRFLOW AS THE VALVE.

ORANGE COUNTY UTILITIES STANDARDS AND CONSTRUCTION SPECIFICATIONS MANUAL

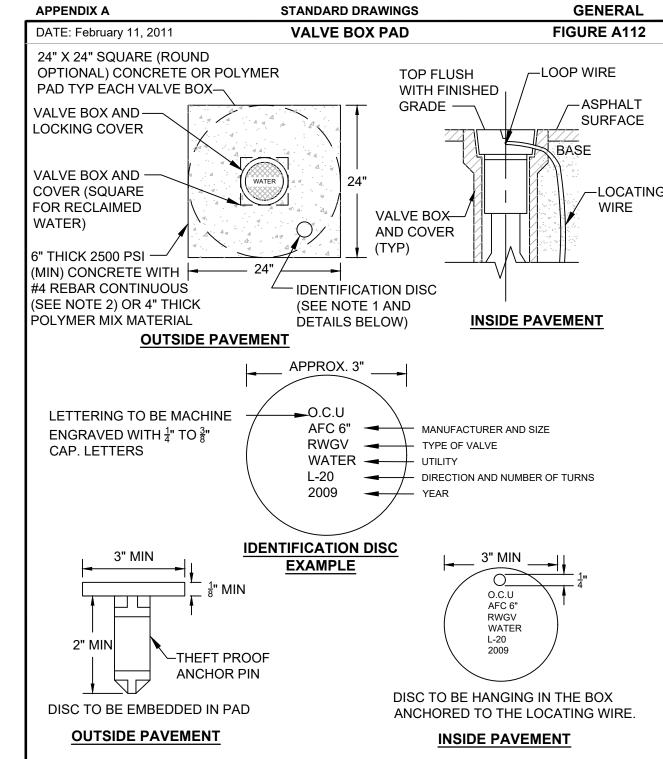

- BRONZE (OR STAINLESS STEEL) IDENTIFICATION DISC SHALL BE REQUIRED FOR ALL VALVES, EXCEPT HYDRANT VALVES.
- IN LIEU OF PRECAST CONCRETE PAD, A 6" THICK X 24" (ROUND OR SQUARE) POURED CONCRETE PAD WITH TWO #4 REBAR AROUND PERIMETER MAY BE USED.

ORANGE COUNTY UTILITIES STANDARDS AND CONSTRUCTION SPECIFICATIONS MANUAL

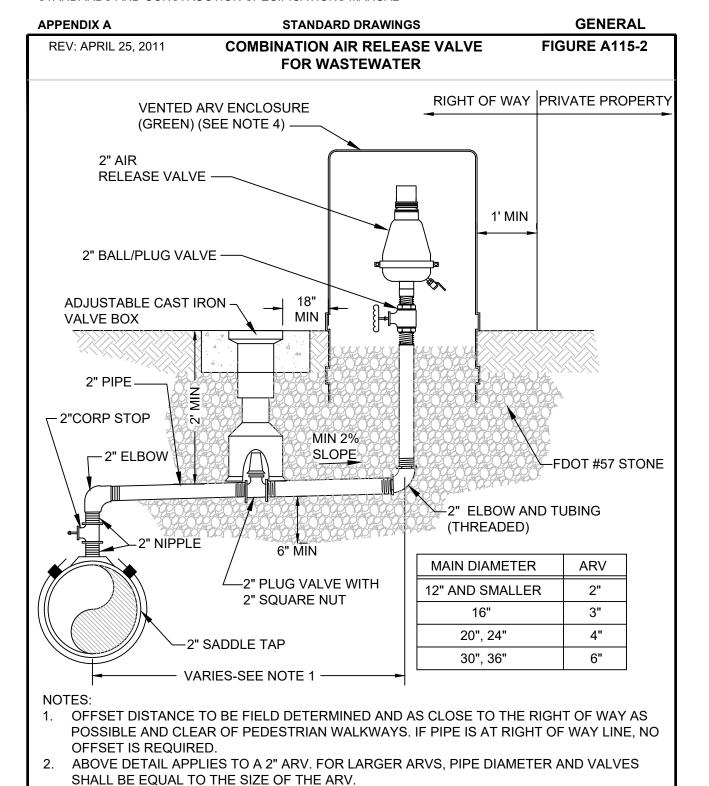


ALL PIPING, VALVES AND APPURTENANCES TO BE BRASS OR 316 S.S. EXCEPT WHERE

THE ENCLOSURE VENTS MUST BE CAPABLE OF ALLOWING AT LEAST THE SAME AMOUNT

SPECIFIED OTHERWISE.

OF AIRFLOW AS THE VALVE.

ORANGE COUNTY UTILITIES STANDARDS AND CONSTRUCTION SPECIFICATIONS MANUAL

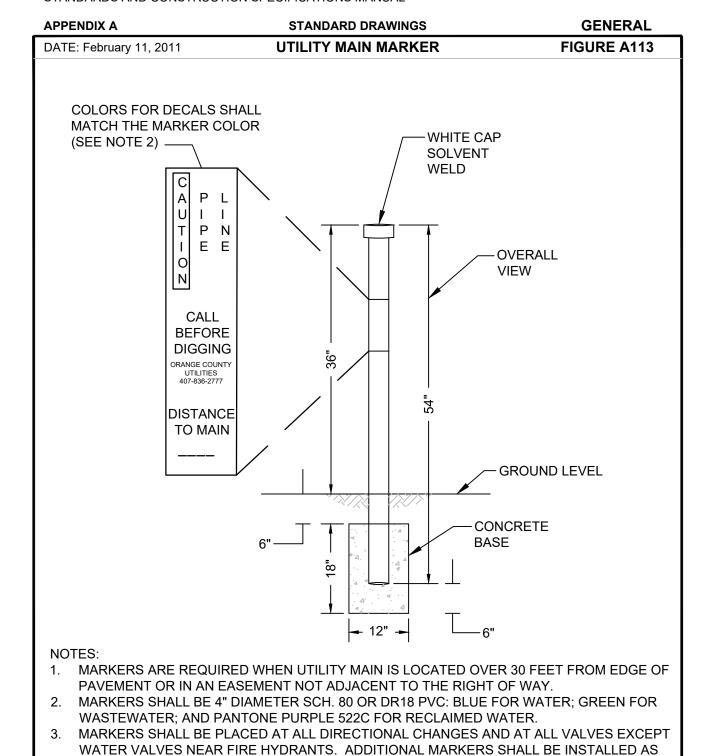

NEEDED SO THAT THE DISTANCE BETWEEN MARKERS DOES NOT EXCEED 1000 FEET.

STANDARD DRAWINGS


GENERAL

STANDARDS AND CONSTRUCTION SPECIFICATIONS MANUAL


APPENDIX A

HORIZONTAL & VERTICAL SEPARATION REQUIREMENTS PROPOSED UTILITY POTABLE WATER RECLAIMED WASTEWATER (GRAVITY & FM) HORIZ VERT HORIZ
PROPOSED UTILITY POTABLE WATER POT
PROPOSED WATER WATER (GRAVITY & FM) STORM SEWING SEWING STORM SEWING S
HORIZ VERT
IPUIADIE WAIER I IIV I I I I I I I I
NOTE 1 NOTE 1 & 3 NOTE 3 NOTE 3 NOTE 3 NOTE 1 & 3 NOTE
RECLAIMED 3' 12" 3' 12" 3' NOTE 1 & 3' NOTE 1 NOTE 1 NOTE 1 12" NOTE 1 N
WASTEWATER 6' 12" 3' 12" 3' NOTE 1 12" NOTE 1 12" NOTE 1 12" NOTE 1 NOTE
RIGHT OF WAY 3' NOTE 1 N/A 3' NOTE 1 N/A N/A N/A N/A N/A
 NOTES: THIS SEPARATION REQUIREMENT IS TO PROVIDE ACCESSIBILITY FOR CONSTRUCT MAINTENANCE. THREE FEET OF HORIZONTAL SEPARATION IS THE MINIMUM FOR PI WITH THREE FEET OF COVER. FOR PIPES INSTALLED AT GREATER DEPTHS, PROVADDITIONAL FOOT OF SEPARATION FOR EACH ADDITIONAL FOOT OF DEPTH. THE 18-INCH SEPARATION REQUIREMENT APPLIES WHEN THE STORM PIPE CROSS ABOVE THE OCU MAIN, AND WHEN THE STORM PIPE HAS A DIAMETER EQUAL TO O GREATER THAN 24 INCHES. OTHERWISE, THE REQUIRED SEPARATION IS 12 INCHES. THIS SEPARATION REQUIREMENT COMPLIES WITH MINIMUM FDEP SEPARATION REQUIREMENTS OUTLINED IN 62-555.314, FAC. VARIANCES FROM THE FDEP REQUIREMENTS MUST COMPLY WITH 62-555.314(5), FAC AND MUST BE APPROVED INDIVIDUALLY BY BOTH FDEP AND OCU. DISTANCES GIVEN ARE FROM OUTSIDE OF PIPE TO OUTSIDE OF PIPE. NO WATER PIPE SHALL PASS THROUGH OR COME IN CONTACT WITH ANY PART OF SANITARY OR STORM WATER MANHOLE OR STRUCTURE.


ORANGE COUNTY UTILITIES STANDARDS AND CONSTRUCTION SPECIFICATIONS MANUAL

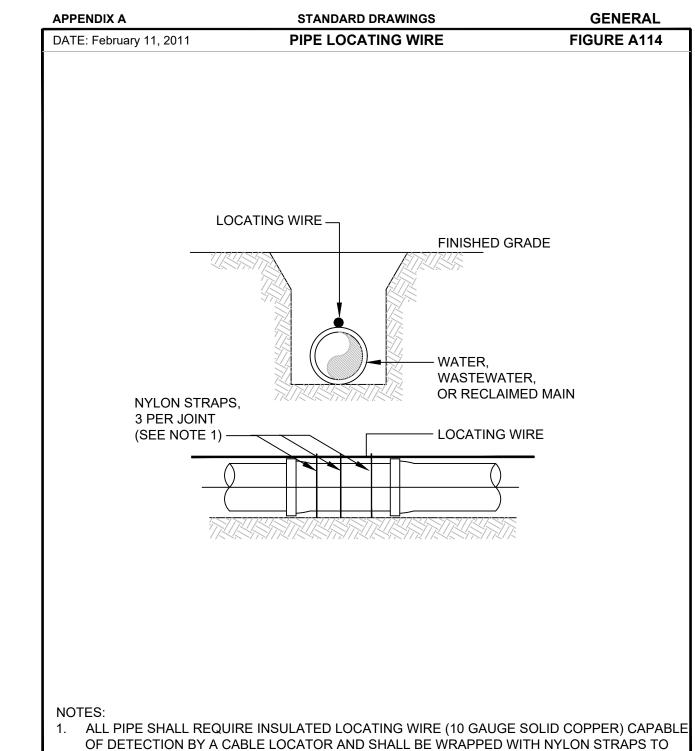


- OF DETECTION BY A CABLE LOCATOR AND SHALL BE WRAPPED WITH NYLON STRAPS TO TOP CENTERLINE OF THE PIPE.
- LOCATING WIRE SHALL BE CONTINUOUS INSIDE VALVE BOXES AND SHALL EXTEND 12"
- ABOVE TOP OF COLLAR. WIRE INSULATION SHALL BE COLOR CODED FOR THE TYPE OF PIPE BEING INSTALLED.

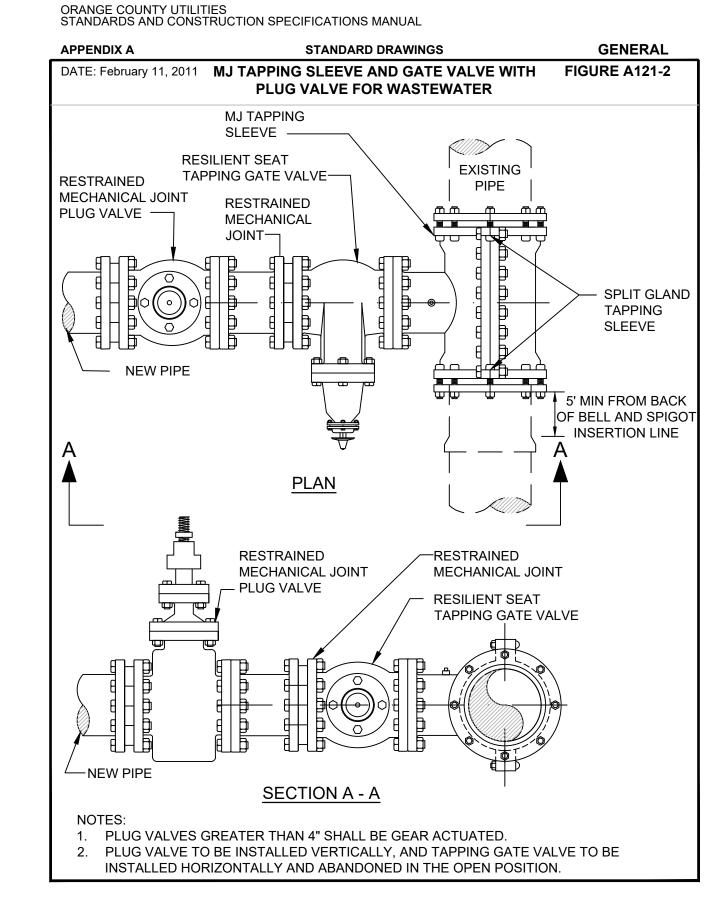

REV	DATI	TE DESCRIPTION	∩ RA	ANGE		A Full Service A & E Firm	Licenses:	CONSTRUCTION DETAILS		OCU FILE NO.: 85506	SCALE: N.T.S.
					ORANGE COUNTY	Architects M / E / P Engineers Planners	Eng. C.O.A. No. 3215			DESIGNED BY: DEM	DRAWING NO. :
			LINE IS 2 INCHES AT FULL SIZE	77	UTILITIES DEPARTMENT	Engineers Planners Environmental Surveyors	Survey L.B. No. 7143 Arch. Lic. No. AA2600926	BERRY DEASE ROAD		DRAWN BY: GNP	D-110
			(IF NOT SCALE ACCORDINGLY)	UNTI	ENGINEERING DIVISION	www.cphcorp.com	Lndscp. Lic. No. LC0000298	WATER MAIN EXTENSION AND	DAVID E. MAHLER	CHECKED BY: DEM	טוו-ט
			GOVER F L O	RIDA	9150 CURRY FORD ROAD ORLANDO, FL. 32825	1117 East Robinson Street ~ Orlando, FL 32801 ~ Pho	one: 407.425.0452	FORCE MAIN REPLACEMENT PROJECT	PROFESSIONAL ENGINEER FLORIDA LICENSE #50041	CADD FILE: O28509 Cover	SHEET: 18 OF 21

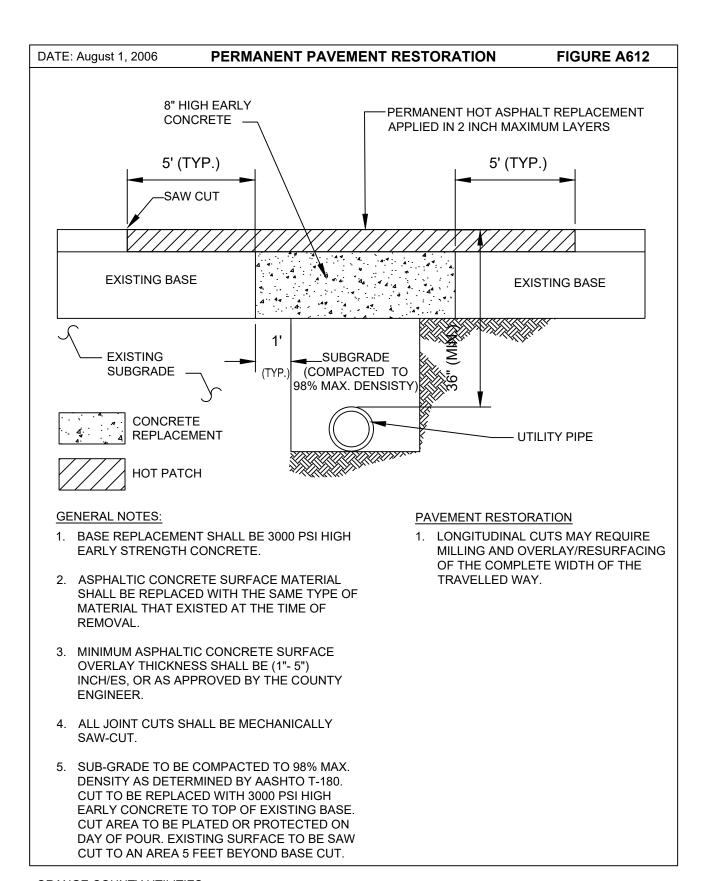


ORANGE COUNTY UTILITIES STANDARDS AND CONSTRUCTION SPECIFICATIONS MANUAL

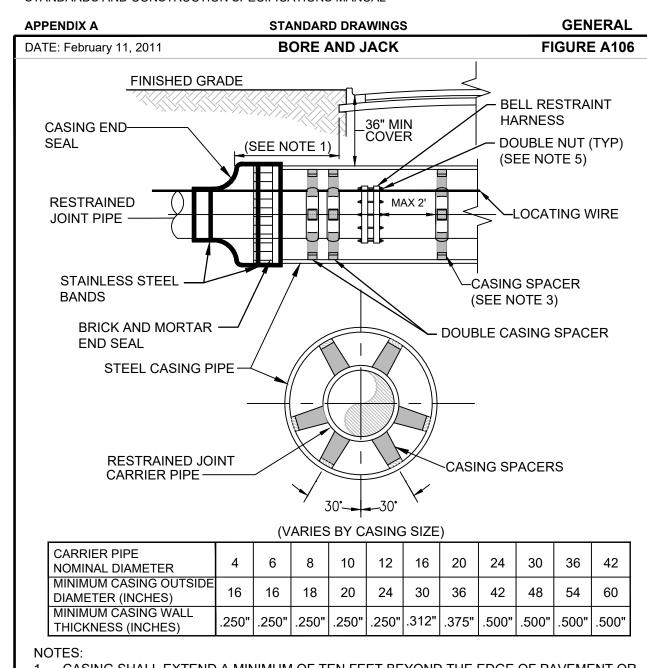


- CASING SHALL EXTEND A MINIMUM OF TEN FEET BEYOND THE EDGE OF PAVEMENT OR MEET FDOT REQUIREMENTS, WHICHEVER IS GREATER.
 REQUIREMENTS OF OTHER JURISDICTIONS SHALL BE MET. WHEN CONSTRUCTION IS
- WITHIN FDOT JURISDICTION, ADDITIONAL REQUIREMENTS OF THE "FDOT UTILITY ACCOMMODATION GUIDE" SHALL BE MET .


 3. DISTANCE BETWEEN SPACERS TO BE PER MANUFACTURER'S SPECIFICATIONS, OR MAX
- OF 6.5', WHICHEVER IS MORE STRINGENT.
- 4. USE OF FLOWABLE FILL IN THE ANNULAR SPACE BETWEEN THE CASING AND CARRIER PIPE IS PROHIBITED.
- PIPE IN CASING SHALL HAVE A MECHANICAL BELL RESTRAINT HARNESS WHERE RODS
 ARE DOUBLE NUTTED TO PRECLUDE OVERBELLING THE JOINT DURING PUSHING CARRIER
 PIPE CASING.

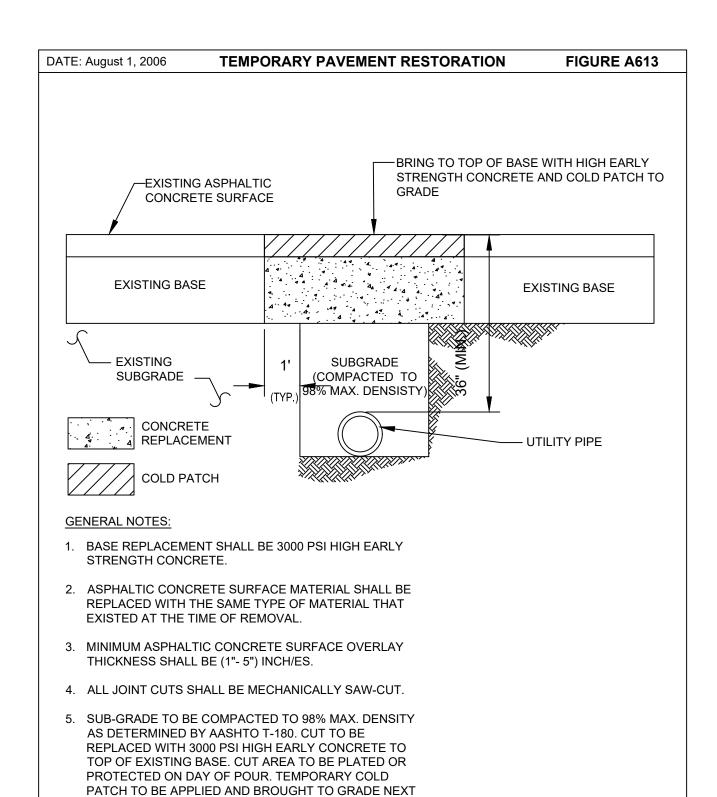


ORANGE COUNTY UTILITIES STANDARDS AND CONSTRUCTION SPECIFICATIONS MANUAL

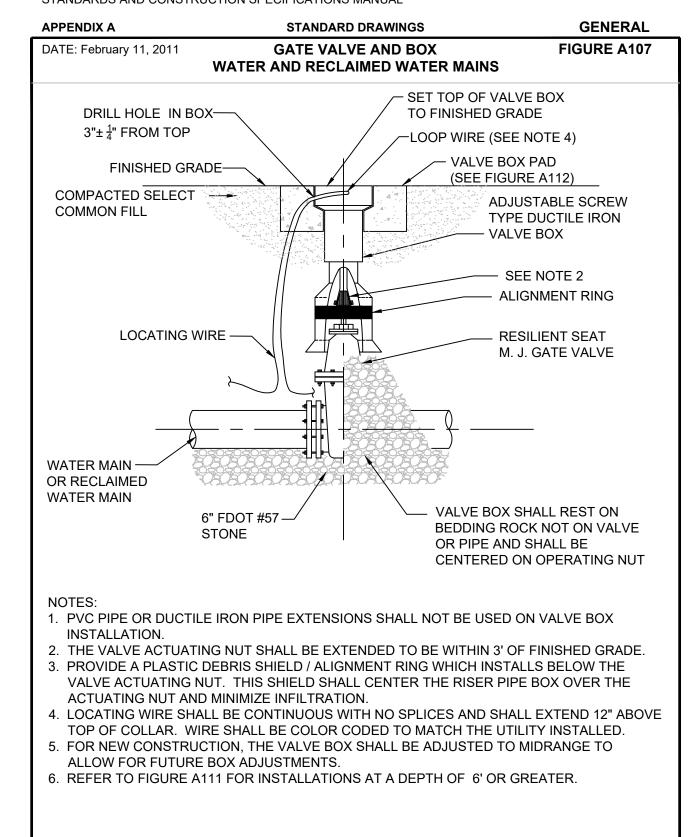

ORANGE COUNTY UTILITIES STANDARDS AND CONSTRUCTION SPECIFICATIONS MANUAL

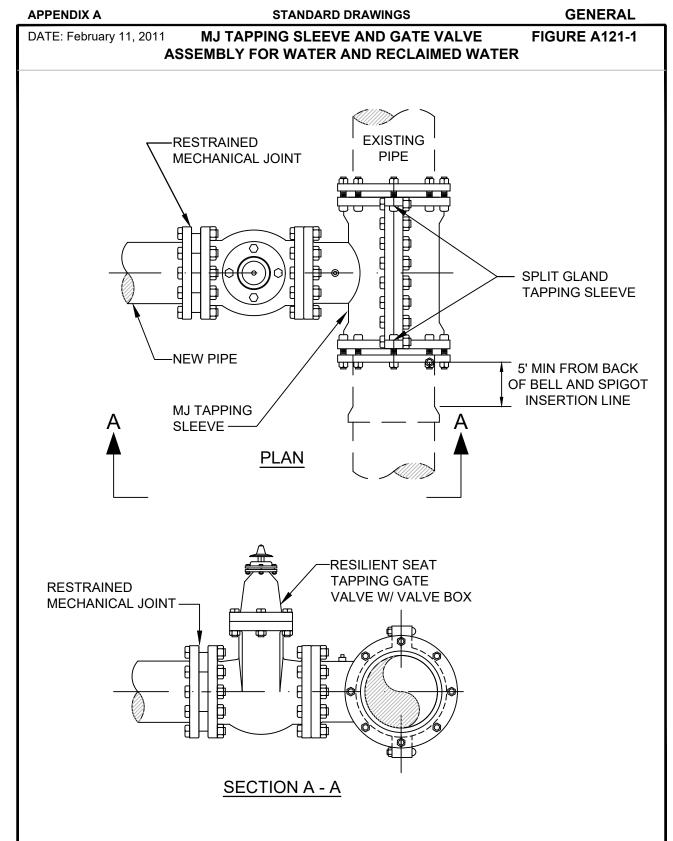


ORANGE COUNTY UTILITIES STANDARDS AND CONSTRUCTION SPECIFICATIONS MANUAL

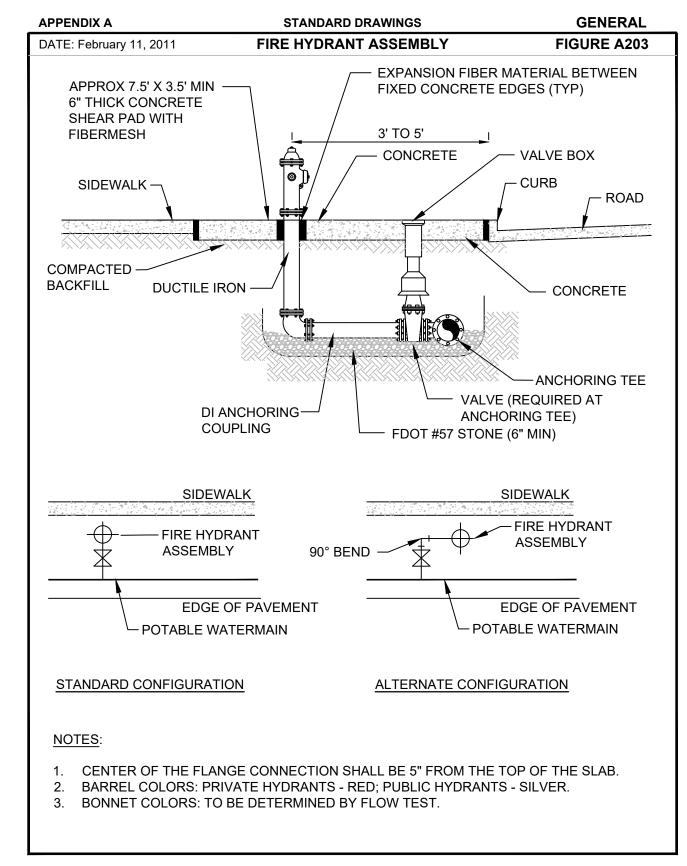




ORANGE COUNTY UTILITIES STANDARDS AND CONSTRUCTION SPECIFICATIONS MANUAL

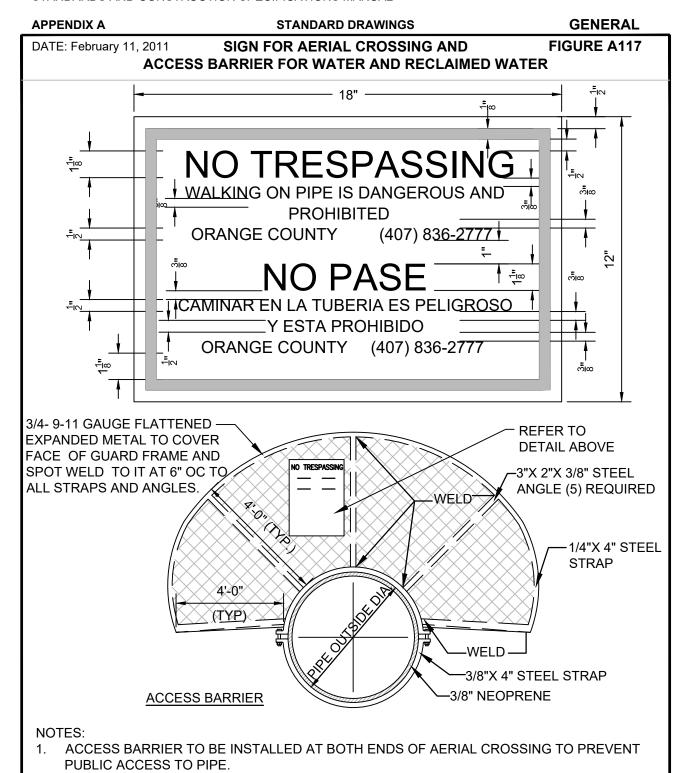


ENTIRE ACCESS BARRIER TO BE DIPPED GALVANIZED AFTER FABRICATION, PAINTING IS

REFER TO ENGINEERS APPROVED DESIGN FOR AERIAL CROSSING CONSTRUCTION

CENTER ACCESS BARRIER ANGLES ON 4" STEEL STRAP.

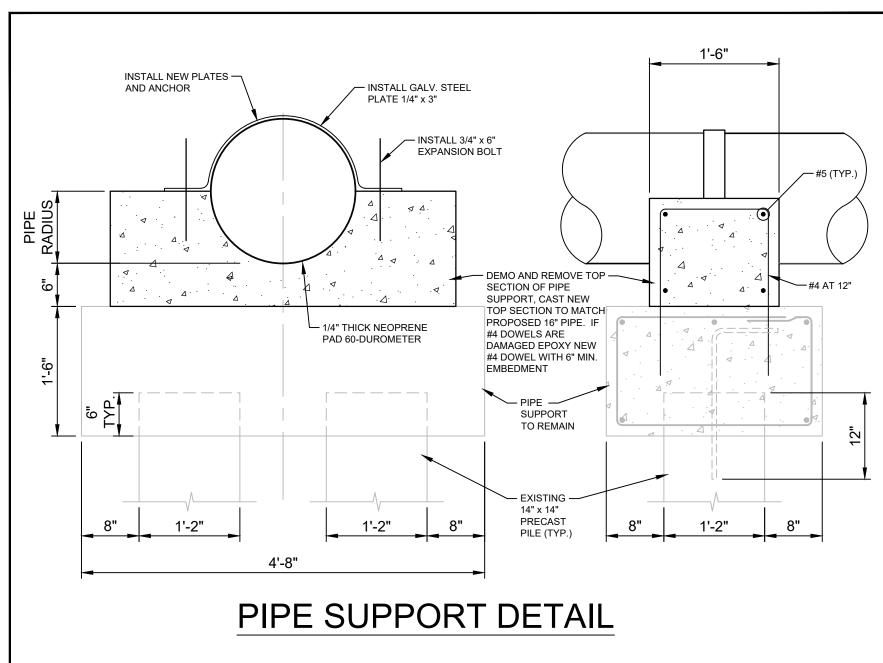

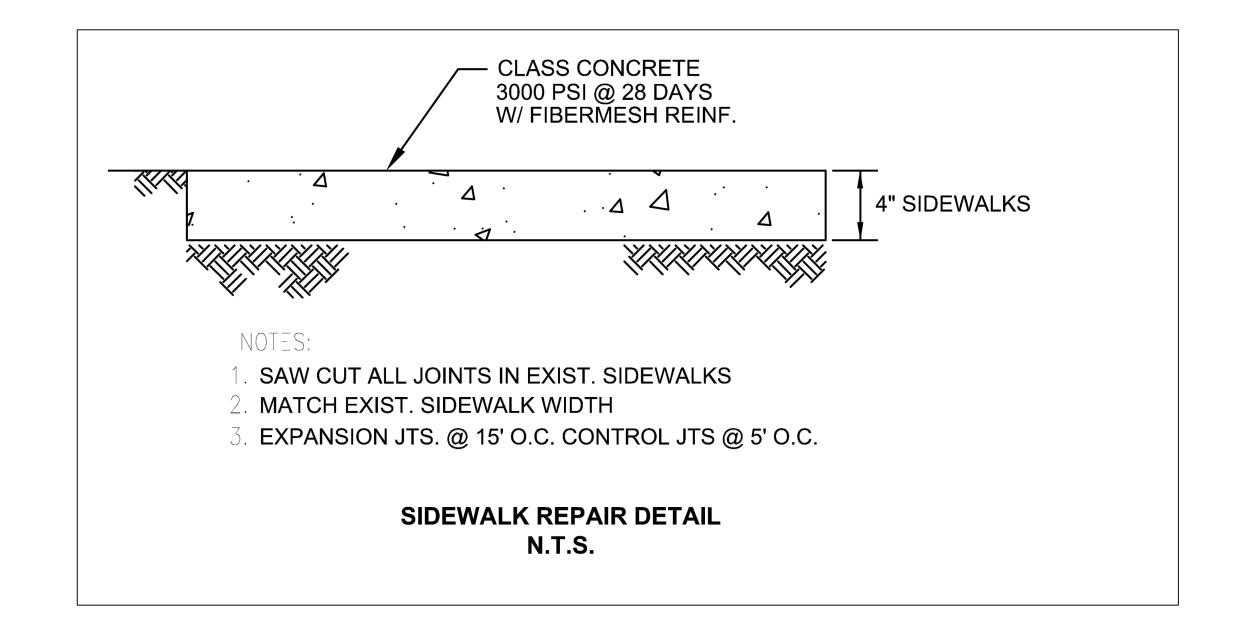

11	REV	DATE	DESCRIPTION	ORANGE	ORANGE COUNTY	A Full Service A & E Firm Licenses:	CONSTRUCTION DETAILS		OCU FILE NO.: 85506	SCALE: N.T.S.
				LINE IS 2 INCHES	URANGE COUNTY UTILITIES DEPARTMENT	Architects M / E / P Survey L.B. No. 7143	BERRY DEASE ROAD		DESIGNED BY: DEM	DRAWING NO. :
				AT FULL SIZE		Environmental Surveyors Arch. Lic. No. AA2600926	WATER MAIN EXTENSION AND		DRAWN BY: GNP	D-130
\	+			(IF NOT SCALE ACCORDINGLY)	ENGINEERING DIVISION	www.cphcorp.com Landscape Architects Traffic/Transportation Lndscp. Lic. No. LC0000298	FORCE MAIN REPLACEMENT PROJECT	DAVID E. MAHLER PROFESSIONAL ENGINEER	CHECKED BY: DEM	D 100
('				F L G R I D A	9150 CURRY FORD ROAD ORLANDO, FL. 32825	1117 East Robinson Street ~ Orlando, FL 32801 ~ Phone: 407.425.0452	FORCE MAIN REPLACEMENT PROJECT	FLORIDA LICENSE #50041	CADD FILE: O28509 Cover	SHEET: 20 OF 21


	FITTINGS										
ID Number	Plan Sheet #	Easting	Northing	Elevation	Main Type	Fitting Type	Comments				
WM-1											
FM-1											

			HYDRA	NTS				
ID Number	ID Number Plan Sheet # Easting Northing Elevation Manufacturer Model # Comments							
FH-1								

						PIPES					
ID Number	Plan Sheet #	Easting	Northing	Elevation	Main Type	Type of Shot	Construction Method	Material	Pressure Class	Manufacturer	Comments
WM-1											
FM-1											

	VALVES									
ID Number	Plan Sheet#	Easting	Northing	Elevation	Valve Type	Main Type	Size	Comments		
TSV-1										
PV-1										
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ARV-1										

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ORANGE COUNTY
UTILITIES DEPARTMENT
ENGINEERING DIVISION

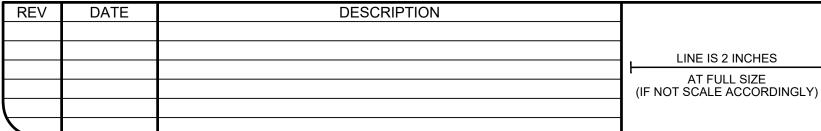9150 CURRY FORD ROAD ORLANDO EL 2022



Eng. C.O.A. No. 3215 Survey L.B. No. 7143 Arch. Lic. No. AA2600926

1117 East Robinson Street ~ Orlando, FL 32801 ~ Phone: 407.425.0452

ASSET TABLES BERRY DEASE ROAD WATER MAIN EXTENSION AND FORCE MAIN REPLACEMENT PROJECT

	OCU FILE NO.: 85506	SCALE: N.T.S.
	DESIGNED BY: DEM	DRAWING NO.
	DRAWN BY: GNP	X-100
DAVID E. MAHLER	CHECKED BY: DEM	N-100
PROFESSIONAL ENGINEER FLORIDA LICENSE #50041	CADD FILE: O28509 Cover	SHEET: 21 OF