

PUMP STATION R/R PACKAGE No. 4

PS 3990 Arning Drive,
PS 3092/3439 Winfree Drive/Secluded Oaks Drive
and PS 3259 Allwood Place
Improvements

BOARD OF COUNTY COMMISSIONERS

TERESA JACOBS
ORANGE COUNTY MAYOR

S. SCOTT BOYD
DISTRICT 1

BRYAN NELSON
DISTRICT 2

PETE CLARKE
DISTRICT 3

JENNIFER THOMPSON
DISTRICT 4

TED B. EDWARDS
DISTRICT 5

VICTORIA P. SIPLIN
DISTRICT 6



AJIT LALCHANDANI
COUNTY ADMINISTRATOR

RAYMOND E. HANSON, P.E.
DIRECTOR ORANGE COUNTY UTILITIES DEPARTMENT

PLANS PREPARED BY:



ATTENTION IS DIRECTED TO THE FACT THAT THESE PLANS MAY HAVE BEEN REDUCED IN SIZE BY REPRODUCTION. THIS MUST BE CONSIDERED WHEN OBTAINING SCALED DATA. DIMENSION INFORMATION SHOULD NOT BE OBTAINED BY SCALING THE PLANS.

*ORANGE COUNTY UTILITIES DEPARTMENT
ENGINEERING DIVISION
ORANGE COUNTY, FLORIDA*

July 2015

BID SET

OCU FILE NO.: 74325


CIP FUNDING CODE:

- 1503-23 (PS 3990)
- 1503-22 (PS 3092)
- 1503-29 (PS 3259)
- 1503-49 (PS 3439)

DRAWING INDEX


SHEET NO.	DWG. NO.	TITLE
1 OF 40	G100	COVER SHEET
2 OF 40	G200	LOCATION MAP & DRAWING INDEX
3 OF 40	G300	GENERAL NOTES, ABBREVIATIONS AND LEGEND
4 OF 40	V100	P.S. # 3990 ARNING DRIVE - BOUNDARY & TOPOGRAPHIC SURVEY
5 OF 40	V200	P.S. # 3259 ALLWOOD PLACE - BOUNDARY & TOPOGRAPHIC SURVEY
6 OF 40	V300	P.S. # 3092 / P.S. # 3439 SURVEY BOUNDARY AND TOPOGRAPHIC NOTES AND LEGENDS
7 OF 40	V400	P.S. # 3092 / P.S. # 3439 WINFREE DRIVE / SECLUDED OAKS DRIVE - TOPOGRAPHIC SURVEY
8 OF 40	C100	P.S. # 3990 ARNING DRIVE - DEMOLITION SITE PLAN
9 OF 40	C101	P.S. # 3990 ARNING DRIVE - SITE PLAN
10 OF 40	C102	P.S. # 3990 ARNING DRIVE - SITE GRADING PLAN
11 OF 40	C200	P.S. # 3259 ALLWOOD PLACE - DEMOLITION SITE PLAN
12 OF 40	C201	P.S. # 3259 ALLWOOD PLACE - SITE PLAN
13 OF 40	C202	P.S. # 3259 ALLWOOD PLACE - SITE GRADING PLAN
14 OF 40	C300	P.S. # 3439 SECLUDED OAKS DRIVE - DEMOLITION SITE PLAN
15 OF 40	C301	P.S. # 3439 SECLUDED OAKS DRIVE - SITE PLAN
16 OF 40	C302	P.S. # 3439 SECLUDED OAKS DRIVE - GRADING PLAN
17 OF 40	C303	P.S. # 3439 SECLUDED OAKS DRIVE - GRAVITY MAIN IMPROVEMENTS PLAN AND PROFILE
18 OF 40	C304	P.S. # 3439 SECLUDED OAKS DRIVE - GRAVITY MAIN IMPROVEMENTS PLAN AND PROFILE
19 OF 40	C400	P.S. # 3092 WINFREE DRIVE - DEMOLITION SITE PLAN
20 OF 40	P100	P.S. # 3990 ARNING DRIVE - PUMP PLAN, SECTION AND DETAIL
21 OF 40	P200	P.S. # 3259 ALLWOOD PLACE - PUMP PLAN, SECTION AND DETAIL
22 OF 40	P300	P.S. # 3439 SECLUDED OAKS DRIVE - PUMP PLAN, SECTION AND DETAIL
23 OF 40	D100	CONSTRUCTION DETAILS - MANHOLE AND PIPE INSTALLATION
24 OF 40	D110	CONSTRUCTION DETAILS - MANHOLE AND PIPE INSTALLATION
25 OF 40	D120	CONSTRUCTION DETAILS - MANHOLE AND PIPE INSTALLATION
26 OF 40	D130	CONSTRUCTION DETAILS - WET WELL INSTALLATION
27 OF 40	D140	CONSTRUCTION DETAILS - WET WELL INSTALLATION
28 OF 40	D150	CONSTRUCTION DETAILS - MANHOLE AND PIPE INSTALLATION
29 OF 40	D160	CONSTRUCTION DETAILS - MANHOLE AND PIPE INSTALLATION
30 OF 40	D170	CONSTRUCTIONS DETAILS
31 OF 40	E001	ELECTRICAL NOTES, SYMBOLS AND ABBREVIATIONS
32 OF 40	E100	P.S. # 3990 ARNING DRIVE - DUPLEX PUMP CONTROL PANEL SINGLE LINE DIAGRAM
33 OF 40	E101	P.S. # 3990 ARNING DRIVE - ELECTRICAL DEMOLITION AND ELECTRICAL SITE PLAN
34 OF 40	E200	P.S. # 3259 ALLWOOD PLACE - DUPLEX PUMP CONTROL PANEL SINGLE LINE DIAGRAM
35 OF 40	E201	P.S. # 3259 ALLWOOD PLACE - ELECTRICAL DEMOLITION AND ELECTRICAL SITE PLAN
36 OF 40	E300	P.S. # 3439 SECLUDED OAKS DRIVE - DUPLEX PUMP CONTROL PANEL SINGLE LINE DIAGRAM
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38 OF 40	ED-100	ELECTRICAL DETAILS SHEET 1
39 OF 40	ED-101	ELECTRICAL DETAILS SHEET 2
40 OF 40	X100	ASSET TABLE

LOCATION MAP

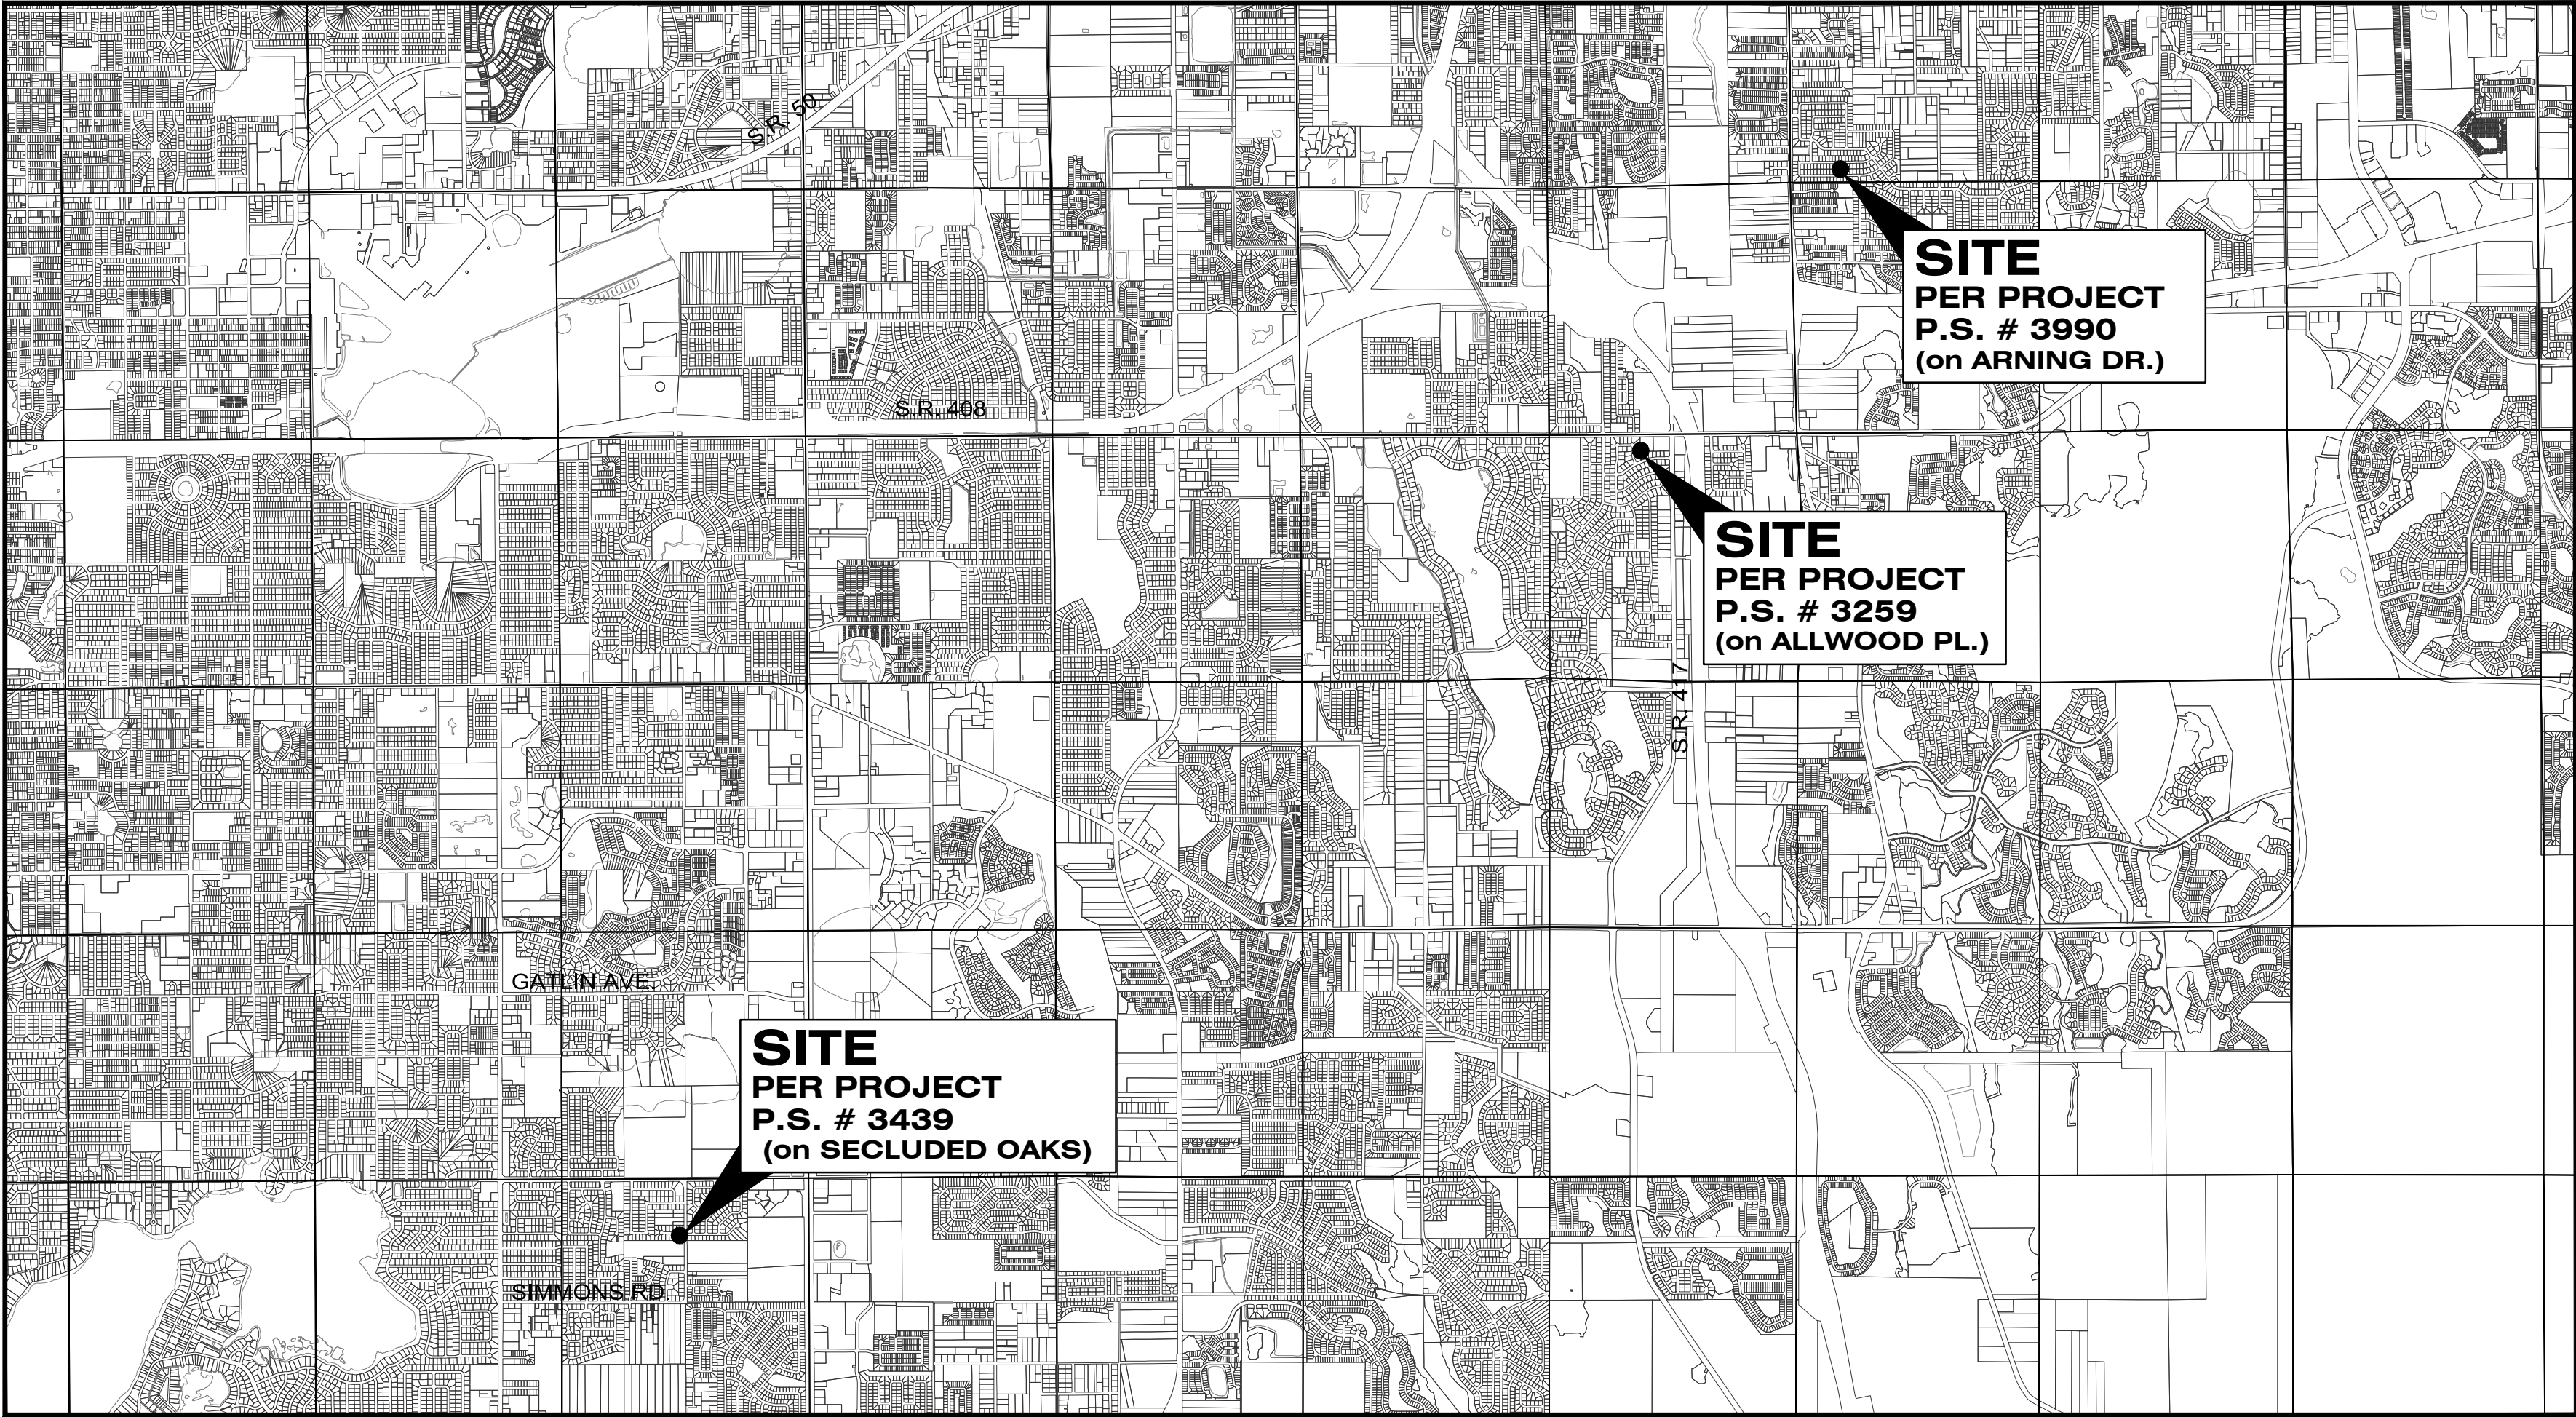

ORANGE COUNTY, FLORIDA
SCALE: 1" = 3,000'

NOTE:
SEE SURVEYS FOR SPECIFIC LOCATIONS

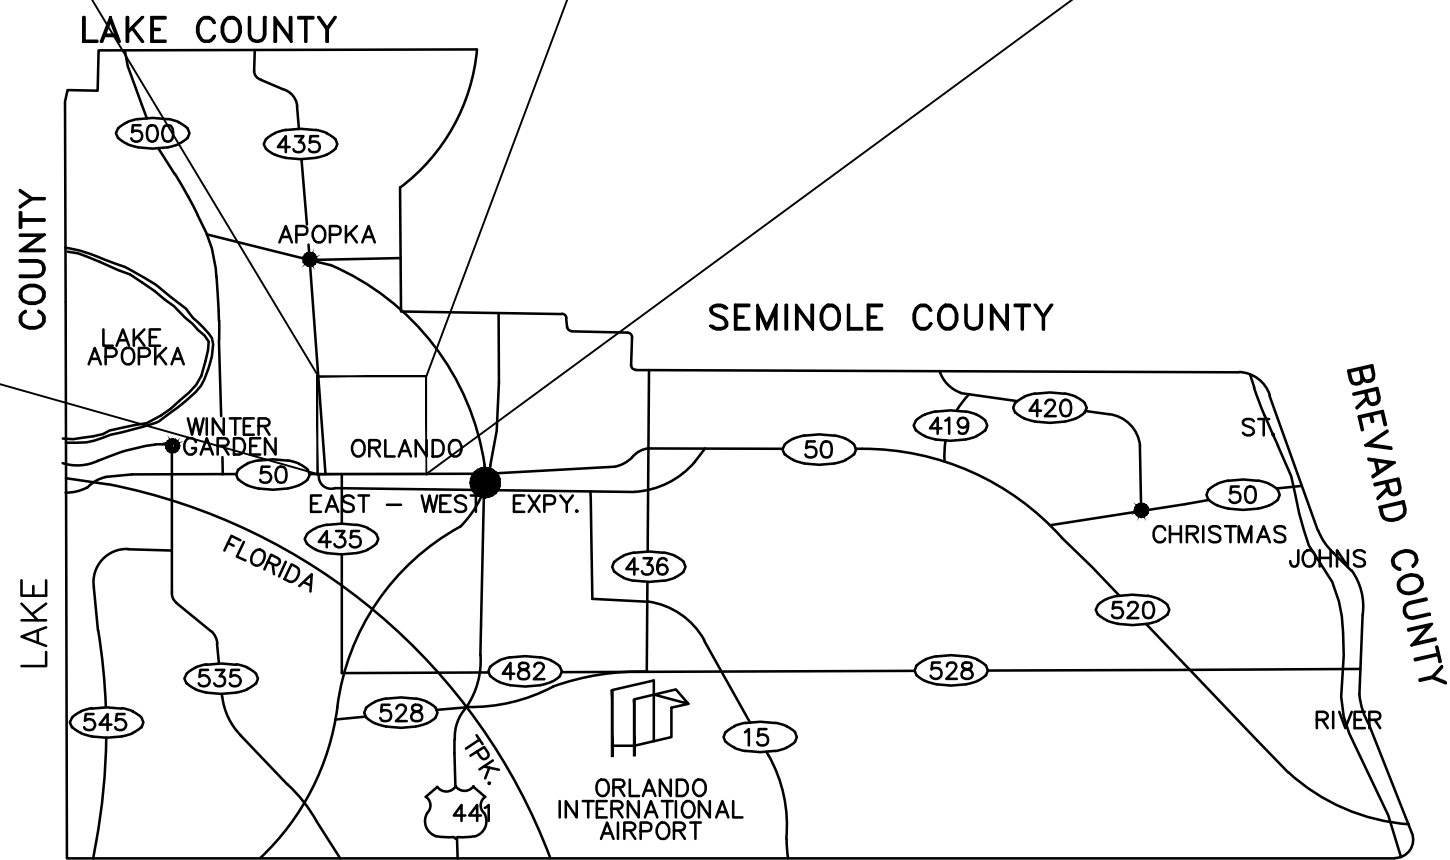

ORANGE COUNTY, FLORIDA
SCALE: 1" = 50,000'

REV	DATE	DESCRIPTION

LINE IS 2 INCHES
AT FULL SIZE
(IF NOT SCALE ACCORDINGLY)



ORANGE COUNTY
UTILITIES DEPARTMENT
ENGINEERING DIVISION
9150 CURRY FORD ROAD ORLANDO, FL. 32825



A Full Service A & E Firm
Architects M / E / P
Engineers Planners
Environmental Surveyors
Landscape Architects Traffic/Transportation

Licenses:
Eng. C.O.A. No. 3215
Survey L.B. No. 7143
Arch. Lic. No. AA2600926
Lndscp. Lic. No. LC0000298

LOCATION MAP AND
DRAWING INDEX

SCOTT A. BREITENSTEIN
PROFESSIONAL ENGINEER
FLORIDA LICENSE #57402

OCU FILE NO.: 74325
DESIGNED BY: SAB
DRAWN BY: DGH/GCM
CHECKED BY: SAB/DEM
CADD FILE: Location-Sheet Index.dwg

SCALE: AS SHOWN
DRAWING NO. :
G200
SHEET: 2 OF 40

GENERAL NOTES

1. **EXCAVATE CAUTIOUSLY** LOCATIONS OF EXISTING UTILITIES INDICATED HERE IN ARE BASED ON BEST AVAILABLE INFORMATION AND ARE NOT TO BE CONSIDERED ALL INCLUSIVE. CONTRACTOR SHALL VERIFY EXACT LOCATION, CHARACTER AND NATURE OF ALL EXISTING AND PROPOSED UTILITIES PRIOR TO BEGINNING CONSTRUCTION AND PRIOR TO FABRICATION OF PIPING AND EQUIPMENT TO ENSURE PROPER ASSEMBLY OF ALL ITEMS.
2. LOCATIONS AND DIMENSION OF EXISTING RIGHTS-OF-WAY AND EASEMENTS ARE BASED ON BEST AVAILABLE INFORMATION. CONTRACTOR SHALL VERIFY THE LIMITS OF THE RIGHTS-OF-WAY AND EASEMENTS IN ORDER TO AVOID ENCROACHMENTS.
3. COVER OVER ALL PIPES SHALL BE THREE (3) FEET MINIMUM, OR AS SHOWN.
4. PIPES SHALL NOT BE DEFLECTED.
5. ALL EXCAVATIONS SHALL BE BACK FILLED AT THE END OF EACH WORK DAY. ALL FINAL BACK FILL IS TO BE COMPACTED TO 98% OF MAXIMUM MODIFIED PROCTOR.
6. ALL SITE WORK SHALL BE COORDINATED WITH THE COUNTY RESIDENT PROJECT REPRESENTATIVE (RPR).
7. THE ELEVATIONS SHOWN ARE BASED ON NAVD **1988 DATUM**.
8. NEW OR RELOCATED, UNDERGROUND WATER MAINS SHALL BE LAID TO PROVIDE A HORIZONTAL DISTANCE OF AT LEAST SIX FEET, AND PREFERABLY TEN FEET, BETWEEN THE OUTSIDE OF THE WATER MAIN AND THE OUTSIDE OF ANY EXISTING OR PROPOSED GRAVITY- OR PRESSURE-TYPE SANITARY SEWER, WASTEWATER FORCE MAIN, OR PIPELINE CONVEYING RECLAIMED WATER NOT REGULATED UNDER PART III OF CHAPTER 62-610, F.A.C. THE MINIMUM HORIZONTAL SEPARATION DISTANCE BETWEEN WATER MAINS AND GRAVITY-TYPE SANITARY SEWERS SHALL BE REDUCED TO THREE FEET WHERE THE BOTTOM OF THE WATER MAIN IS LAID AT LEAST SIX INCHES ABOVE THE TOP OF THE SEWER. NEW OR RELOCATED, UNDERGROUND WATER MAINS CROSSING ANY EXISTING OR PROPOSED GRAVITY-OR VACUUM-TYPE SANITARY SEWER SHALL BE LAID SO THE OUTSIDE OF THE WATER MAIN IS AT LEAST SIX INCHES, AND PREFERABLY 12 INCHES, ABOVE3 OR AT LEAST 12 INCHES BELOW THE OUTSIDE OF THE OTHER PIPELINE. HOWEVER, IT IS PREFERABLE TO LAY THE WATER MAIN ABOVE THE OTHER PIPELINE. NEW OR RELOCATED, UNDERGROUND WATER MAINS CROSSING ANY EXISTING OR PROPOSED PRESSURE TYPE SANITARY SEWER, WASTEWATER OR STORMWATER FORCE MAIN, OR PIPELINE CONVEYING RECLAIMED WATER SHALL BE LAID SO THE OUTSIDE OF THE WATER MAIN IS AT LEAST 12 INCHES ABOVE OR BELOW THE OUTSIDE OF THE OTHER PIPELINE. HOWEVER, IT IS PREFERABLE TO LAY THE WATER MAIN ABOVE THE OTHER PIPELINE.

AT THE UTILITY CROSSINGS DESCRIBED ABOVE, ONE FULL LENGTH OF WATER MAIN PIPE SHALL BE CENTERED ABOVE OR BELOW THE OTHER PIPELINE SO THE WATER MAIN JOINTS WILL BE AS FAR AS POSSIBLE FROM THE OTHER PIPELINE. ALTERNATIVELY, AT SUCH CROSSINGS, THE PIPES SHALL BE ARRANGED SO THE ALL WATER MAIN JOINTS ARE AT LEAST THREE FEET FROM ALL JOINTS IN VACUUM-TYPE SANITARY SEWERS, OR PIPELINES CONVEYING RECLAIMED WATER REGULATED UNDER PART III OF CHAPTER 62-610, F.A.C., AND AT LEAST SIX FEET FROM ALL JOINTS IN GRAVITY-OR PRESSURE-TYPE SANITARY SEWERS, WASTEWATER FORCE MAINS, OR PIPELINES CONVEYING RECLAIMED WATER NOT REGULATED UNDER PART III OF CHAPTER 62-610, F.A.C.

9. ALL PROPOSED DUCTILE IRON M.J. FITTINGS, PIPES, OR RESTRAINTS WITHIN FORTY (40) FEET OF EXISTING GAS MAINS SHALL BE POLYETHYLENE ENCASED.
10. ALL EXISTING AND PROPOSED WATER, WASTEWATER AND REUSE VALVES SHALL BE OPERATED BY ORANGE COUNTY UTILITIES AUTHORIZED REPRESENTATIVES. EXISTING VALVE BOXES AND MANHOLES, WHICH ARE TO REMAIN, SHALL BE ADJUSTED TO THE FINISHED GRADE. ALL VALVES UNDER CONSTRUCTION SHALL REMAIN CLOSED DURING CONSTRUCTION.
11. THE CONTRACTOR SHALL PROVIDE TANKERS AND SIGNED DOCUMENT ACKNOWLEDGING THE UNDERSTANDING OF THE ORANGE COUNTY UTILITY **"EMERGENCY WASTEWATER SPILL AND WATER MAIN BREAK PROCEDURES"**, IN THE PRE-CONSTRUCTION PACKET FOR THE MEETING.
12. THE CONTRACTOR SHALL PROVIDE AND MAINTAIN ON-SITE DURING THE LIFE OF THE PROJECT, A WEATHERPROOF ENCLOSURE CONTAINING A READILY ACCESSIBLE LIST OF EMERGENCY CONTACTS AND PHONE NUMBERS.
13. THE CONTRACTOR SHALL BE RESPONSIBLE FOR THE SATISFACTION OF ALL REQUIREMENTS OF REGULATORY AGENCY PERMITS WITH REGARD TO CONSTRUCTION ACTIVITIES AND RELATED CONDITIONS.
14. THE CONTRACTOR SHALL CALL SUNSHINE STATE ONE CALL NO LESS THAN FOURTY- EIGHT (48) HOURS PRIOR TO THE START OF CONSTRUCTION. - PHONE - 800-432-4777.
15. **ADVANCE NOTIFICATION of CONSTRUCTION**
THE ORANGE COUNTY UTILITY CONSTRUCTION SECTION (407) 254-9798, SHALL BE NOTIFIED AT LEAST SEVEN (7) DAYS PRIOR TO ANY CONSTRUCTION ACTIVITY.
16. THE CONTRACTOR SHALL MAKE EXPLORATORY EXCAVATIONS AT ALL INTERSECTIONS OF PROPOSED WORK AND EXISTING UTILITIES. THE EXPLORATORY EXCAVATIONS SHALL BE MADE FORTY-EIGHT (48) HOURS IN ADVANCE OF THE WORK. IF THERE IS A POTENTIAL CONFLICT, THE CONTRACTOR SHALL NOTIFY THE COUNTY RESIDENT PROJECT REPRESENTATIVE IMMEDIATELY WITH INFORMATION WHICH SHALL INCLUDE LOCATION, ELEVATION, UTILITY TYPE, MATERIAL AND SIZE.
17. IN AREAS WHERE CONSTRUCTION ACTIVITIES RESTRICT NORMAL ACCESS TO PROPERTIES, THE CONTRACTOR SHALL PROVIDE AND MAINTAIN ALTERNATE ACCESS ROUTES WHICH ARE SUBJECT TO APPROVAL BY THE ENGINEER, AS PART OF THE M.O.T. PLAN.
18. THE DISPOSAL OF ANY EXCESS EARTH WORK MATERIAL SHALL BE THE RESPONSIBILITY OF THE CONTRACTOR.
19. THE CONTRACTOR SHALL REPLACE WITH EQUAL MATERIAL, OR AS DIRECTED BY THE RPR, ALL PAVING, GRASSED AREAS, STABILIZED EARTH, DRIVEWAYS, ETC., DISTURBED OR DAMAGED BY THE CONSTRUCTION OR RELATED ACTIVITIES. ALL DISTURBED AREAS SHALL BE SODDED, EXCEPT DIRT DRIVES AND WHERE INDICATED IN THE DRAWINGS.
20. SALVAGE AND/OR DISPOSAL OF ALL EXISTING EQUIPMENT SHALL BE AT THE DIRECTION OF THE RPR.
21. THE CONTRACTOR SHALL BE RESPONSIBLE FOR PROPER DISPOSAL OF ALL STRUCTURES, PIPE, CONDUIT, WIRE, FITTINGS, PANELS, ETC. THAT ARE DEMOLISHED, DISASSEMBLED, OR REMOVED, PER SECTION 02080 OF THE SPECIFICATION MANUAL OF THIS PROJECT.

22. **OPERATION OF ORANGE COUNTY PUMP STATIONS** THE CONTRACTOR SHALL COORDINATE ALL PUMP STATION OPERATIONS AND SHUT DOWN CONTROL WITH THE ORANGE COUNTY RPR.
23. THE CONTRACTOR SHALL PROVIDE TEMPORARY BY-PASS PUMPING AS NEEDED FOR EACH PUMP STATION AND/OR MANHOLE TO BE REHABILITATED AND/OR REPLACED PRIOR TO THE START OF ANY WORK. BOTH THE PRIMARY AND THE BACKUP BY-PASS PUMPING SYSTEMS SHALL BE OF ADEQUATE CAPACITIES AND SIZES TO HANDLE THE FLOW AND SHALL MAINTAIN CONTINUOUS SERVICE DURING THE ENTIRE CONSTRUCTION PROCESS UNTIL THE NEW OR REHABILITATED PUMP STATION OR MANHOLE HAS BEEN ACCEPTED BY THE COUNTY. THE BY-PASS PUMPING SYSTEMS SHALL BE APPROVED AND ACCEPTED BY THE COUNTY PRIOR TO INSTALLATION. THE CONTRACTOR SHALL NOT MAINTAIN MORE THAN TWO (2) PUMP STATION BY-PASS OPERATIONS AT THE SAME TIME DURING THE CONSTRUCTION PROCESS.
24. BY-PASS PUMPING SHALL BE LOW NOISE SUITABLE FOR RESIDENTIAL NEIGHBORHOODS (SEE SECTION 01001.1.05B OF THE TECHNICAL SPECIFICATIONS).
25. THE CONTRACTOR SHALL BE RESPONSIBLE FOR ANY DE-WATERING REQUIRED DURING CONSTRUCTION AND TO OBTAIN AND PAY FOR ALL PERMITS REQUIRED FOR THE TEMPORARY DEWATERING OF DRAINAGE STRUCTURES.
26. THE CONTRACTOR SHALL FURNISH AND INSTALL ALL TEMPORARY PLUGS, BLOCKING, TAPS, AND TESTING EQUIPMENT REQUIRED TO COMPLETE PRESSURE TESTING, AS SPECIFIED.
27. THE CONTRACTOR SHALL PREPARE AND SUBMIT FOR APPROVAL BY THE COUNTY, A COMPREHENSIVE WRITTEN PROCEDURE THAT DESCRIBES THE INTENDED CONSTRUCTION SEQUENCE FOR MAINTAINING AND TRANSFERRING SERVICE FROM THE EXISTING PUMP STATION TO THE NEW PUMP STATION. ITEMS TO ADDRESS SHALL INCLUDE THE FOLLOWING AS A MINIMUM:
- A. LOCATION AND METHOD OF BY-PASS PUMPING.
- B. STATION START-UP AND DRAW-DOWN PROCEDURES.
- C. TIE IN OF THE NEW PUMP STATION.
- D. DISMANTLING OF EQUIPMENT AND CONVERSION OR REMOVAL OF OLD WET WELL.

- THIS PROCEDURE SHALL BE SUBMITTED WITH THE PROJECT SCHEDULE.
28. THE CONTRACTOR SHALL NOTIFY THE COUNTY SEVEN (7) WORKING DAYS IN ADVANCE OF ANY SANITARY FORCE MAIN SHUT-DOWN.
29. ALL CONNECTIONS TO EXISTING FORCE MAINS SHALL BE MADE BY THE CONTRACTOR ONLY AFTER THE CONNECTION PROCEDURE AND THE WORK SCHEDULING HAS BEEN REVIEWED AND APPROVED BY THE COUNTY. THE CONTRACTOR SHALL SUBMIT A WRITTEN REQUEST TO THE COUNTY A MINIMUM OF SEVEN (7) WORKING DAYS PRIOR TO SCHEDULING SAID CONNECTIONS. THE REQUEST SHALL OUTLINE THE FOLLOWING:
- A. POINTS OF CONNECTION, FITTINGS TO BE USED, AND METHOD OF FLUSHING.
- B. ESTIMATED CONSTRUCTION TIME FOR SAID CONNECTIONS.
30. THE COUNTY SHALL REVIEW THE SUBMITTAL WITHIN SEVEN (7) WORKING DAYS AFTER RECEIPT AND INFORM THE CONTRACTOR REGARDING APPROVAL OR DENIAL OF THE REQUEST. IF THE REQUEST IS REJECTED BY THE COUNTY, THE CONTRACTOR SHALL RESUBMIT THE WRITTEN REQUEST, WHICH HAS BEEN MODIFIED IN A MANNER ACCEPTABLE TO THE COUNTY. ALL CONNECTIONS SHALL BE MADE ONLY ON THE AGREED UPON DATE AND TIME. IF THE CONTRACTOR DOES NOT INITIATE AND COMPLETE THE CONNECTION WORK IN THE AGREED UPON MANNER, HE SHALL BE REQUIRED TO RESCHEDULE THE SAID CONNECTIONS BY FOLLOWING THE PROCEDURE OUTLINED IN NOTE 29.
31. **ADVANCE NOTIFICATION OF PENDING CONNECTION**
THE ORANGE COUNTY UTILITY WATER DIVISION AND THE ORANGE COUNTY UTILITY WATER RECLAMATION DIVISION SHALL BE NOTIFIED AT LEAST SEVEN (7) DAYS IN ADVANCE TO SCHEDULE MAIN TIE-INS AND VALVE OPERATIONS.
32. ANY WORK PROPOSED FOR THE POTABLE WATER SYSTEM SHALL BE PERFORMED IN ACCORDANCE WITH THE STANDARDS AND DETAILS OF THE APPROPRIATE UTILITY PROVIDER.
33. **REPAIR IMMEDIATELY**
ALL DAMAGE TO ORANGE COUNTY MAINS SHALL BE REPAIRED IMMEDIATELY BY THE CONTRACTOR AT THE CONTRACTOR'S EXPENSE. IF THE REPAIR IS NOT DONE IN A TIMELY MANER, AS DETERMINED BY THE ORANGE COUNTY UTILITY INSPECTOR, ORANGE COUNTY MAY PERFORM REPAIRS AND THE CONTRACTOR WILL BE CHARGED FOR SAID REPAIRS.
34. **TELEPHONE NOTIFICATIONS**
THE ORANGE COUNTY DISPATCH OPERATOR SHALL BE NOTIFIED IMMEDIATELY IN THE EVENT OF A FORCEMAIN, GRAVITY SEWER, OR WATER MAIN BREAK OR DAMAGE AT (407)836-2777 (24-HOURS ASSISTANCE).
35. ALL WORK AND MATERIAL SHALL CONFORM TO THE ORANGE COUNTY UTILITIES STANDARDS AND CONSTRUCTION SPECIFICATIONS MANUAL, LATEST EDITION OR AS INDICATED IN THE PROJECT SPECIFICATIONS OR DRAWINGS.

EMERGENCY NUMBER

CABLE	ADELPHIA LEVEL 3	321-308-0250
CABLE	BRIGHT HOUSE NETWORKS	407-532-8511
ELECTRIC	DUKE ENERGY FLORIDA	407-850-2785
GAS	TECO PEOPLES GAS	407-420-2678
LOCATES	SUNSHINE ONE CALL	800-432-4770
TELEPHONE	AT&T NETWORK OPERATIONS	407-273-2803
UTILITIES	ORANGE COUNTY DISPATCH	407-836-2777 (24-HR ASSISTANCE)
WASTEWATER	ORANGE COUNTY UTILITIES (O. C. U.)	407-254-9680
WATER	ORANGE COUNTY UTILITIES (O. C. U.)	407-254-9850
WATER/ELE.	ORLANDO UTILITIES COMMISSION (O. U. C.)	407-423-9100

LEGEND			
	GUY WIRE AND ANCHOR		EXISTING STORM PIPE
	CAP		EXISTING BURIED TELEPHONE
	PLUG		EXISTING FIBER OPTIC CABLE
	BENCHMARK		EXISTING BURIED ELECTRIC
	TREE (TYPE & SIZE NOTED)		EXISTING OVERHEAD ELECTRIC
	SHRUB		EXISTING CABLE TV (BURIED)
	PROPOSED ELEVATION		EXISTING ELEVATION
	PROPOSED FORCE MAIN		EXISTING FORCE MAIN
	PROPOSED GRAVITY MAIN		EXISTING GRAVITY MAIN
	PROPOSED WATER SERVICE		EXISTING WATER MAIN
	PROPOSED CHAIN-LINK FENCE		EXISTING CHAN-LINK FENCE
	PROPOSED WOOD FENCE		EXISTING WOOD FENCE
	PROPOSED POWER POLE		EXISTING POWER POLE
	PROPOSED MANHOLE (SPECIFY)		EXISTING MANHOLE (SPECIFY)
	PROPOSED VALVE (SPECIFY)		EXISTING VALVE (SPECIFY)
	PROPOSED WATER METER		EXISTING WATER METER
	PROPOSED BACK-FLOW PREVENTER		EXISTING BACK-FLOW PREVENTER
	PROPOSED SILT FENCE		

PRECAST STRUCTURAL NOTES

1. PRECAST STRUCTURES SHALL BE ENGINEERED PRODUCTS OF A PRECAST MANUFACTURER AND SHALL BE SPECIFICALLY DESIGNED FOR THE SERVICE AND APPLICATION AS SHOWN ON THESE DRAWINGS. THE PRECAST MANUFACTURER IS SOLELY RESPONSIBLE FOR DESIGN AND MANUFACTURE OF EACH STRUCTURE. THE CONTRACTOR SHALL BE SOLELY RESPONSIBLE FOR INSTALLATION OF THESE PRODUCTS AND CONFORMANCE OF SAME WITH ALL PROJECT DOCUMENTS. THE CONTRACTOR SHALL SUBMIT COMPLETE SHOP DRAWINGS FOR ALL SUCH PRECAST STRUCTURES ON THE PROJECT FOR REVIEW AND APPROVAL, PRIOR TO THE ORDERING OF ANY STRUCTURES OR MATERIALS.
2. THE CONTRACTOR SHALL SUBMIT SHOP DRAWINGS OF THE CAST-IN-PLACE REINFORCEMENT AND CONCRETE PLACEMENT USED IN THE INSTALLATION OF SADDLE MANHOLES FOR REVIEW AND APPROVAL BY THE COUNTY, PRIOR TO THE ORDERING OF ANY MATERIALS.
3. STRUCTURAL DESIGN STANDARDS - ACI STANDARD 318-89 BUILDING CODE REQUIREMENTS FOR REINFORCED CONCRETE AND ACI 350R-83, "CONCRETE SANITARY ENGINEERING STRUCTURES". PRECAST WALL SECTIONS ASTM C478.
4. ALL CONCRETE SHALL HAVE A SPECIFIED MINIMUM COMPRESSIVE STRENGTH OF $f_c' = 4000$ P.S.I. AT 28 DAYS, UNLESS NOTED ON DRAWINGS.
5. ALL REINFORCING BARS SHALL CONFORM TO ASTM A615 GRADE 60. MINIMUM YIELD STRENGTH SHALL BE 60,000 P.S.I..
6. CONTRACTOR SHALL COORDINATE WET WELL HATCH OPENING SIZE AND LOCATION AS REQUIRED BY PUMP MANUFACTURER/SUPPLIER WITH THE PRECAST CONCRETE SUPPLIER PRIOR TO CASTING. SHOP DRAWINGS OF THE PRECAST SHALL BE PROVIDED TO THE COUNTY FOR REVIEW.
7. THE FLOOR GROUT (FILLET) SHALL BE FULL CIRCUMFERENCE OF THE STRUCTURE.

POWER AND WATER SUPPLY NOTES:

1. THE CONTRACTOR SHALL CONTACT THE APPROPRIATE UTILITY PROVIDER FOR POWER AND WATER SERVICE, AND SHALL INCLUDE IN HIS BID ALL PROVIDER CHARGES FOR MATERIALS, LABOR, ONE-TIME NONRECURRING CONSTRUCTION COSTS AND OTHER COSTS, INCLUDING WATER METER, ASSESSED BY THE PROVIDER, WHETHER OR NOT INDICATED ON THE DRAWINGS, OR SPECIFIED.
2. THE CONTRACTOR SHALL COORDINATE THE INSTALLATION OF THE POWER SUPPLY AND THE WATER SYSTEM RELOCATION AND INSTALLATION WITH THE SUPPLIER.
3. THE POWER PROVIDER SHALL MAKE ALL SECONDARY TERMINATIONS AT POWER TRANSFORMERS.
4. THE WATER SUPPLIER WILL PERFORM THE REQUIRED RELOCATIONS AND MAKE ALL CONNECTIONS TO THE EXISTING WATER SYSTEM, INCLUDING WATER METER INSTALLATION.
5. POWER SUPPLIER: DUKE ENERGY (P.S. # 3259) (P.S. # 3439) (P.S. # 3990)
6. WATER SUPPLIER: O. C. U. (P.S. # 3259) (P.S. # 3439) (P.S. # 3990)

ABBREVIATIONS			
AKA	ALSO KNOWN AS	L.S.	LIFT STATION
AC	ASBESTOS CEMENT	LT	LEFT
ALUM.	ALUMINUM	L.W.L.	LOW WATER LEVEL
APPROX.	APPROXIMATELY	MAX.	MAXIMUM
ASPH.	ASPHALT	MATL	MATERIAL
ASSEM.	ASSEMBLY	M.H.	MANHOLE
BE	BURIED ELECTRIC	MIN.	MINIMUM
BL	BASELINE	MOD	MODIFIED
B.M.	BENCHMARK	M.O.T.	MAINTENANCE OF TRAFFIC
B.O.	BLOWOFF	M.J.	MECHANICAL JOINT
BCL	BURIED CABLE LINE	N.G.	NATURAL GROUND
BT	BURIED TELEPHONE	NO.	NUMBER
B.F.V.	BUTTERFLY VALVE	NPW	NON-POTABLE WATER
CATV	CABLE TELEVISION	N.T.S.	NOT TO SCALE
C.B.	CATCH BASIN	O.C.U.	ORANGE COUNTY UTILITIES
C.F.S.	CUBIC FEET PER SECOND	O.D.	OUTSIDE DIAMETER
CIP	CAST IRON PIPE	O.H.E.	OVERHEAD ELECTRIC
CL	CENTERINE	O.U.C.	ORLANDO UTILITY COMMISSION
C.M.	CONCRETE MONUMENT	PAVT.	PAVEMENT
C.M.P.	CORRUGATED METAL PIPE	P.B.	PULL BOX
CONC.	CONCRETE	PG.	PAGE
CONN.	CONNECTION	P.I.	POINT OF INTERSECTION
CONST.	CONSTRUCT	PL	PROPERTY LINE
CONT.	CONTINUOUS	POLY.	POLYETHYLENE
CORP.	CORPORATION	PP	POWER POLE
C.V.	CHECK VALVE	PROP.	PROPOSED
C.Y.	CUBIC YARD	PS	PUMP STATION
DBL.	DOUBLE	P.S.I.	POUNDS PER SQUARE INCH
DHW	DESIGN HIGH WATER	P.U.E.	PERMANENT UTILITY EASEMENT
DIA.	DIAMETER	PV	PLUG VALVE
DIP	DUCTILE IRON PIPE	RAD. PT.	RADIUS POINT
DWLS.	DOWELS	R	RADIUS
DWG.	DRAWING	RCP	REINFORCED CONCRETE PIPE
ELEC	ELECTRIC	REINF.	REINFORCED
EA.	EACH	REQ.	REQUIRED
EFF	EFFLUENT	RPZ	REDUCED PRESSURE ZONE
ELEV.	ELEVATION		BACKFLOW PREVENTER
EMB.	EMBED OR EMBEDDED	RT.	RIGHT
E/P	EDGE OF PAVEMENT	RW	RECLAIMED WATER
ESMT.	EASEMENT	R/W	RIGHT OF WAY
E.W.	EACH WAY	SAN.	SANITARY SEWER
EXIST.	EXISTING	SCH.	SCHEDULE
EXP. JT.	EXPANSION JOINT	S.D.	STORM DRAIN
F.D.	FLOOR DRAIN	S.F.	SQUARE FEET
F.D.E.P.	FLORIDA DEPT. OF ENVIRONMENTAL PROTECTION	SHT.	ENVIRONMENTAL PROTECTION SHEET
F.D.O.T.	FLORIDA DEPT. OF TRANSPORTATION		TRANSPORTATION
F.F.	FINISHED FLOOR	SPECS.	SPECIFICATIONS
F.H.	FIRE HYDRANT	SQ.	SQUARE
FKA	FORMALLY KNOWN AS	SS	STAINLESS STEEL
FLG.	FLANGE	STA.	STATION
FL.	FLOW LINE	STD.	STANDARD
FM	FORCEMAIN	STL.	STEEL
FT.	FEET	S.Y.	SQUARE YARDS
FTG.	FOOTING	TEL	TELEPHONE
GA	GAUGE	T&B	TOP AND BOTTOM
GAL.	GALLONS	TBM	TEMPORARY BENCH MARK
GEN.	GENERATOR	TCE	TEMPORARY CONSTRUCTION
GRD.	GROUND		EASEMENT
G.S.P.	GALVANIZED STEEL PIPE	TEMP.	TEMPORARY
GM	GAS MAIN	THD.	THREADED
GPM	GALLONS PER MINUTE	THK.	THICK
GV	GATE VALVE	TYP.	TYPICAL
HB	HOSE BIBB	U.G.	UNDERGROUND
HDWL.	HEADWALL	VAC	VOLTAGE ALTERNATING CURRENT
HT.	HEIGHT	VCP	VITRIFIED CLAY PIPE
HP	HIGH POINT	VDC	VOLTAGE DIRECT CURRENT
HORIZ.	HORIZONTAL	VERT.	VERTICAL
H.W.L.	HIGH WATER LEVEL	V.V.H.	VERIFIED VERTICALLY & HORIZONTALLY
I.E.	INVERT ELEVATION	W/	WITH
I.D.	INSIDE DIAMETER	WM	WATERMAIN
IN.	INCHES	WM	WATER METER
INV.	INVERT	WP	WALL PIPE
I.P.	IRON PIPE	WS	WATER SERVICE
I.R.	IRON ROD	W.S.	WATER SURFACE
J.B.	JUNCTION BOX	WWF	WELDED WIRE FABRIC
JUNC.	JUNCTION	"X"	SPOT ELEVATION
LAT.	LATERAL		
LF	LINEAR FEET		

REF:NNNNN REFERENCE MADE TO AN APPLICABLE SECTION(S) OF THE TECHNICAL SPECIFICATIONS FOR THIS PROJECT.

ADDRESSES FOR THE PUMP STATIONS:

PS # 3259 - 9237 ALLWOOD PLACE, ORLANDO, FL. 32825

PS # 3439 - 5260 SECLUDED OAKS DRIVE, ORLANDO, FL. 32812

PS # 3990 750 - ARNING DRIVE, ORLANDO, FL. 32825

REV	DATE	DESCRIPTION	LINE IS 2 INCHES AT FULL SIZE (IF NOT SCALE ACCORDINGLY)				ORANGE COUNTY UTILITIES DEPARTMENT <i>ENGINEERING DIVISION</i> 9150 CURRY FORD ROAD ORLANDO, FL. 32825		 www.cphcorp.com		A Full Service A & E Firm Architects M/E/P Engineers Planners Environmental Surveyors Landscape Architects Traffic/Transportation Landscape Architects Traffic/Transportation	Licenses: Eng. C.O.A. No. 3215 Survey L.B. No. 7143 Arch. Lic. No. AA2600926 Landscape Architects Traffic/Transportation Lndscp. Lic. No. LC0000298	GENERAL NOTES ABBREVIATIONS AND LEGEND		SCOTT A. BREITENSTEIN PROFESSIONAL ENGINEER FLORIDA LICENSE #57402		OCU FILE NO.: 74325 DESIGNED BY: SAB DRAWN BY: DGH/GCM CHECKED BY: SAB/DEM CADD FILE: General Notes.dwg	SCALE: NONE DRAWING NO. : G300 SHEET: 3 OF 40
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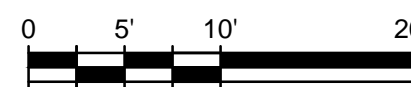
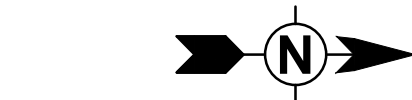
BRIDLEWOOD DRIVE

(50' RIGHT-OF-WAY)
ASPHALT ROAD

LOT 370

BROWNWOOD DRIVE

(50' RIGHT-OF-WAY)
ASPHALT ROAD



CONTROL POINT NAIL & DISC #4
N 1534432.93
E 578755.36
ELEV 70.38

SANITARY SEWER MANHOLES											
Manhole	Top(FT)	DIR	DIST*	Inv.(FT)	DIR	DIST*	Inv.(FT)	DIR	DIST*	Inv.(FT)	DIR
SS-1	72.35	S (2) 6" PVC	20.50	51.85	BOTTOM	21.00	51.35				
SS-2	71.17	E	14.40	56.77	BOTTOM	18.75	52.42	(2) 6" PVC PIPES COME INTO STRUCTURE FROM NORTH AND TURN DOWN INTO THE GROUND INSIDE			
SS-3	70.96	W	13.50	57.46	S	13.35	57.61				

* DISTANCE FROM TOP OF STRUCTURE TO INVERT OF PIPE

LEGEND

BM BENCHMARK	CO CLEANOUT	MB MAIL BOX	UTILITY MARKER (AS SHOWN)
ND NAIL & DISK	DECIDUOUS TREE	PALM TREE	UTILITY MANHOLE (AS SHOWN)
TP TRAVERSE POINT	ELECTRIC TRANSFORMER	POST	UTILITY METER (AS SHOWN)
F FOUND IRON (TYPE)	EVERGREEN TREE	SATELITE DISH	UTILITY RISER (AS SHOWN)
S SET IRON (TYPE)	FIRE HYDRANT	SPIGOT	UTILITY VALVE (AS SHOWN)
F FOUND MONUMENT (TYPE)	FLAG (AS SHOWN)	SPRINKLER HEAD	UTILITY POLE (AS SHOWN)
S SET MONUMENT (TYPE)	GUY ANCHOR	TRAFFIC SIGN	WELL
SC SECTION CORNER	LIGHT POLE		

ANT ANTENNA	EM ELECTRIC METER	JBL JURISDICTIONAL BOUNDARY	PG PAGE	TEL TELEPHONE
BM BENCHMARK	ET ELECTRIC TRANSFORMER	LINE	PK PK NAIL	TP TRAVERSE POINT
(C) CALCULATED	F FOUND	(M) MEASURED	RCP REINFORCED CONC PIPE	TSC TRAFFIC SIGNAL CONTROL
CO CLEANOUT	FF FINISHED FLOOR	MB MAILBOX	RR RAILROAD	TSP TRAFFIC SIGNAL POLE
CONC CONCRETE	FH FIRE HYDRANT	MH MANHOLE	RW RECLAIMED WATER	TV CABLE TVISION
CM CONCRETE MONUMENT	FO FIBER OPTIC	MW MONITORING WELL	S SET	UE UNDERGROUND UTILITY LINES
CMP CORRUGATED METAL PIPE	G GAS	ND NAIL & DISK	SC SECTION CORNER	W WATER
CPP CORRUGATED PLASTIC PIPE	GM GAS METER	NL NAIL	SH SPRINKLER HEAD	WH WOODEN HUB
(D) AS DESCRIBED	GV GAS VALVE	OE OVERHEAD UTILITY LINES	SPIG WATER SPIGOT	WM WATER METER
DIP DUCTILE IRON PIPE	INV INVERT	OR OFFICIAL RECORDS	SS SANITARY SEWER	WV WATER VALVE
DH DRILL HOLE	IP IRON PIPE	P POST	SD STORM DRAIN	XC X CUT
EB ELECTRIC RISER	IR IRON ROD	(P) PER PLAT	SV SANITARY SEWER VALVE	
ELEC ELECTRIC	IRRV IRRIGATION VALVE	PB PLAT BOOK	TB TELEPHONE RISER	

ABBREVIATIONS

TEL TELEPHONE	TP TRAVERSE POINT
TSC TRAFFIC SIGNAL CONTROL	TSP TRAFFIC SIGNAL POLE
TV CABLE TVISION	UE UNDERGROUND UTILITY LINES
W WATER	WH WOODEN HUB
WM WATER METER	WV WATER VALVE
XC X CUT	

REV	DATE	DESCRIPTION

LINE IS 2 INCHES
AT FULL SIZE
(IF NOT SCALE ACCORDINGLY)



ORANGE COUNTY
UTILITIES DEPARTMENT
ENGINEERING DIVISION
9150 CURRY FORD ROAD ORLANDO, FL. 32825



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1117 East Robinson Street ~ Orlando, FL 32801 ~ Phone: 407.425.0452

Licenses:
Eng. C.O.A. No. 3215
Survey L.B. No. 7143
Arch. Lic. No. AA2600926
Lndscp. Lic. No. LC0000298

P.S. # 3990 ARNING
BOUNDARY AND TOPOGRAPHIC SURVEY
SURVEY PROVIDED BY TETRA TECH
PROJECT NO.: 200-09074-11001

OCU FILE NO.: 74325
DESIGNED BY:
DRAWN BY:
CHECKED BY:
CADD FILE: Arning Blvd Survey.dwg


SCALE: AS SHOWN
DRAWING NO.:
V100
SHEET: 4 OF 40

LEGAL DESCRIPTION

THAT 25' X 25' UTILITY EASEMENT FOR LIFT STATION LYING WITHIN LOT 348 AND LOT 371, PARK MANOR ESTATES UNIT ELEVEN "A", ACCORDING TO THE PLAT THEREOF, AS RECORDED IN PLAT BOOK 6, PAGES 23 AND 24, OF THE PUBLIC RECORDS OF ORANGE COUNTY, FLORIDA

NOTES

- BEARINGS AND COORDINATES SHOWN HEREON ARE BASED ON FLORIDA STATE PLANE COORDINATE SYSTEM, EAST ZONE, NORTH AMERICAN VERTICAL DATUM OF 1983/1990 ADJUSTMENT (NAD83).
- ELEVATIONS SHOWN HEREON ARE BASED ON ORANGE COUNTY SURVEY BENCHMARK #L-809-018, BEING AN ALUMINUM DISC IN CURB INLET, HAVING A PUBLISHED ELEVATION OF 69.92 (NAVD 1988).
- THERE MAY BE EASEMENTS AND RESTRICTIONS OF RECORDS AND/OR PRIVATE AGREEMENTS NOT FURNISHED TO THIS SURVEYOR THAT MAY AFFECT PROPERTY RIGHTS AND/OR LAND USE RIGHTS OF THE LANDS SHOWN HEREON.
- NO UNDERGROUND INSTALLATIONS, FOUNDATION FOOTINGS OR IMPROVEMENTS HAVE BEEN LOCATED EXCEPT AS NOTED.
- THIS SURVEY WAS PERFORMED IN ACCORDANCE WITH THE MINIMUM TECHNICAL STANDARDS FOR SURVEYS AS SET FORTH BY THE FLORIDA BOARD OF PROFESSIONAL SURVEYORS AND MAPPERS, CHAPTER 5J-17, FLORIDA ADMINISTRATIVE CODE.
- BASED ON THE NATIONAL FLOOD INSURANCE PROGRAM "FIRM" MAP COMMUNITY - PANEL NUMBER 120179 0290 E DATED 9/25/2009 THE ABOVE DESCRIBED PROPERTY IS LOCATED IN ZONE "X".
- THIS FIELD SURVEY WAS PERFORMED ON NOVEMBER 11, 2010.

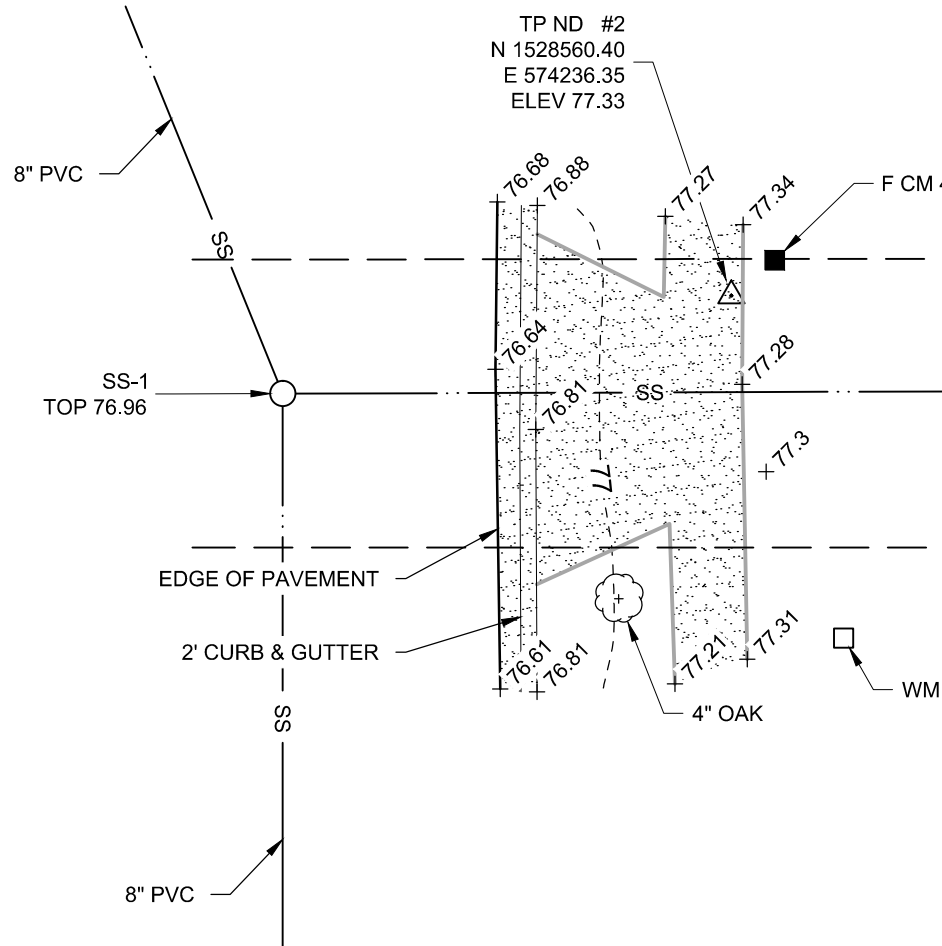

ALLWOOD PLACE
(50' RIGHT-OF-WAY)
ASPHALT ROAD

DESCRIPTION

TRACT "B" - LIFT STATION SITE, DEERWOOD UNIT 2, ACCORDING TO THE PLAT THEREOF AS RECORDED IN PLAT BOOK 8, PAGE 150 OF THE PUBLIC RECORDS OF ORANGE COUNTY, FLORIDA

DESCRIPTION

- ELEVATIONS SHOWN HEREON ARE BASED ON ORANGE COUNTY BENCHMARK # H721002, BEING A CHISELED SQUARE IN SIDEWALK, HAVING A PUBLISHED ELEVATION OF 77.408. (NAVD 1988)
- THERE MAY BE EASEMENTS AND RESTRICTIONS OF RECORDS AND/OR PRIVATE AGREEMENTS NOT FURNISHED TO THIS SURVEYOR THAT MAY AFFECT PROPERTY RIGHTS AND/OR LAND USE RIGHTS OF THE LANDS SHOWN HEREON.
- NO UNDERGROUND INSTALLATIONS, FOUNDATION FOOTINGS OR IMPROVEMENTS HAVE BEEN LOCATED EXCEPT AS NOTED.
- THIS SURVEY WAS PERFORMED IN ACCORDANCE WITH THE MINIMUM TECHNICAL STANDARDS FOR SURVEYS AS SET FORTH BY THE FLORIDA BOARD OF PROFESSIONAL SURVEYORS AND MAPPERS, CHAPTER 5J-17, FLORIDA ADMINISTRATIVE CODE.
- BASED ON THE NATIONAL FLOOD INSURANCE PROGRAM "FIRM" MAP COMMUNITY - PANEL NUMBER 120179 0270 F DATED 09/25/2009 THE ABOVE DESCRIBED PROPERTY IS LOCATED IN ZONE "X".
- THIS FIELD SURVEY WAS PERFORMED ON JULY 21, 2011.

SANITARY SEWER MANHOLES

Manhole	Top(FT)	DIR	DIST*	Inv.(FT)	DIR	DIST*	Inv.(FT)	DIR	DIST*	Inv.(FT)	DIR	DIST*	Inv.(FT)
SS-1	76.96	NW	14.25	62.71	E	14.65	62.31	S	14.55	62.41			
SS-2	79.09	S	17.25	61.84	W	17.15	61.94						
VALVE VAULT	79.97	E & W (2 DISCHARGE PIPES MEASURED TO TOP)	4.25	75.72							BOTTOM	6.50	73.47
WET WELL	79.99	E (2 DISCHARGE PIPES MEASURED TO TOP)	4.15	75.84	W	5.50	74.49	N	18.20	61.79	BOTTOM	23.00	56.99
* DISTANCE FROM TOP OF STRUCTURE TO INVERT OF PIPE													

LEGEND

BM BENCHMARK	CO CLEANOUT	MB MAIL BOX	UTILITY MARKER (AS SHOWN)
ND NAIL & DISK	DECIDUOUS TREE	PALM TREE	UTILITY MANHOLE (AS SHOWN)
TP TRAVERSE POINT	ELECTRIC TRANSFORMER	POST	UTILITY METER (AS SHOWN)
F FOUND IRON (TYPE)	EVERGREEN TREE	SATELITE DISH	UTILITY RISER (AS SHOWN)
S SET IRON (TYPE)	FIRE HYDRANT	SPIGOT	UTILITY VALVE (AS SHOWN)
F FOUND MONUMENT (TYPE)	FLAG (AS SHOWN)	SPRINKLER HEAD	UTILITY POLE (AS SHOWN)
S SET MONUMENT (TYPE)	GUY ANCHOR	TRAFFIC SIGN	WELL
SC SECTION CORNER	LIGHT POLE		

ABBREVIATIONS

ANT ANTENNA	EM ELECTRIC METER	IRRV IRRIGATION VALVE	(P) PER PLAT	SV SANITARY SEWER VALVE
BM BENCHMARK	ET ELECTRIC TRANSFORMER	JBL JURISDICTIONAL BOUNDARY	PB PLAT BOOK	TB TELEPHONE RISER
(C) CALCULATED	F FOUND	LINE	PG PAGE	TEL TELEPHONE
CO CLEANOUT	FDC FIRE DEPT CONNECTION	(M) MEASURED	PK PK NAIL	TP TRAVERSE POINT
CONC CONCRETE	FF FINISHED FLOOR	MB MAILBOX	RCP REINFORCED CONC PIPE	TSC TRAFFIC SIGNAL CONTROL
CM CONCRETE MONUMENT	FH FIRE HYDRANT	MH MANHOLE	RR RAILROAD	TSP TRAFFIC SIGNAL POLE
OMP CORRUGATED METAL PIPE	FO FIBER OPTIC	RW RECLAIMED WATER	TV CABLE TELEVISION	TV CABLE TELEVISION
CPP CORRUGATED PLASTIC PIPE	G GAS	S SET	UE UNDERGROUND UTILITY LINES	UE UNDERGROUND UTILITY LINES
(D) AS DESCRIBED	GM GAS METER	NL NAIL	SC SECTION CORNER	W WATER
DIP DUCTILE IRON PIPE	GV GAS VALVE	OE OVERHEAD UTILITY LINES	SH SPRINKLER HEAD	WM WATER METER
DH DRILL HOLE	INV INVERT	OR OFFICIAL RECORDS	SPIG WATER SPIGOT	WV WATER VALVE
EB ELECTRIC RISER	IP IRON PIPE	P POST	SS SANITARY SEWER	XC X CUT
ELEC ELECTRIC	IR IRON ROD		SD STORM DRAIN	

REV	DATE	DESCRIPTION

LINE IS 2 INCHES
AT FULL SIZE
(IF NOT SCALE ACCORDINGLY)



ORANGE COUNTY
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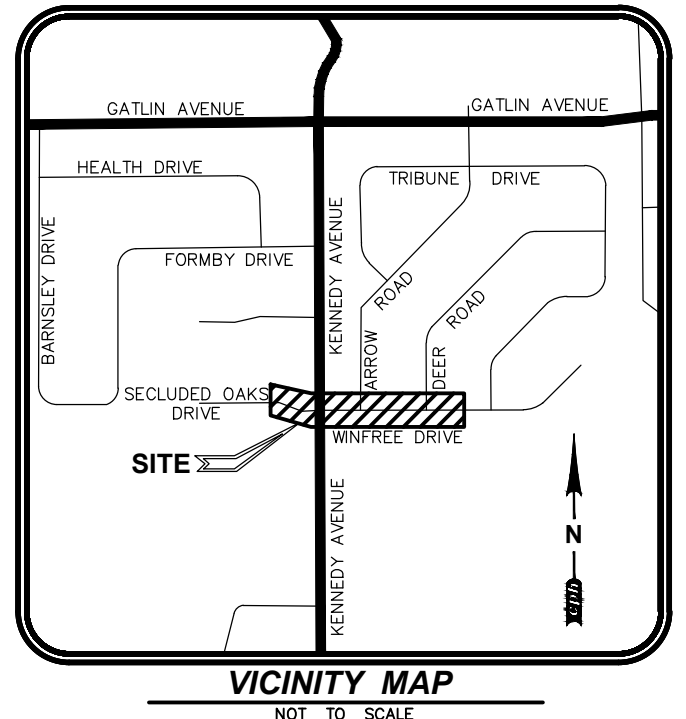
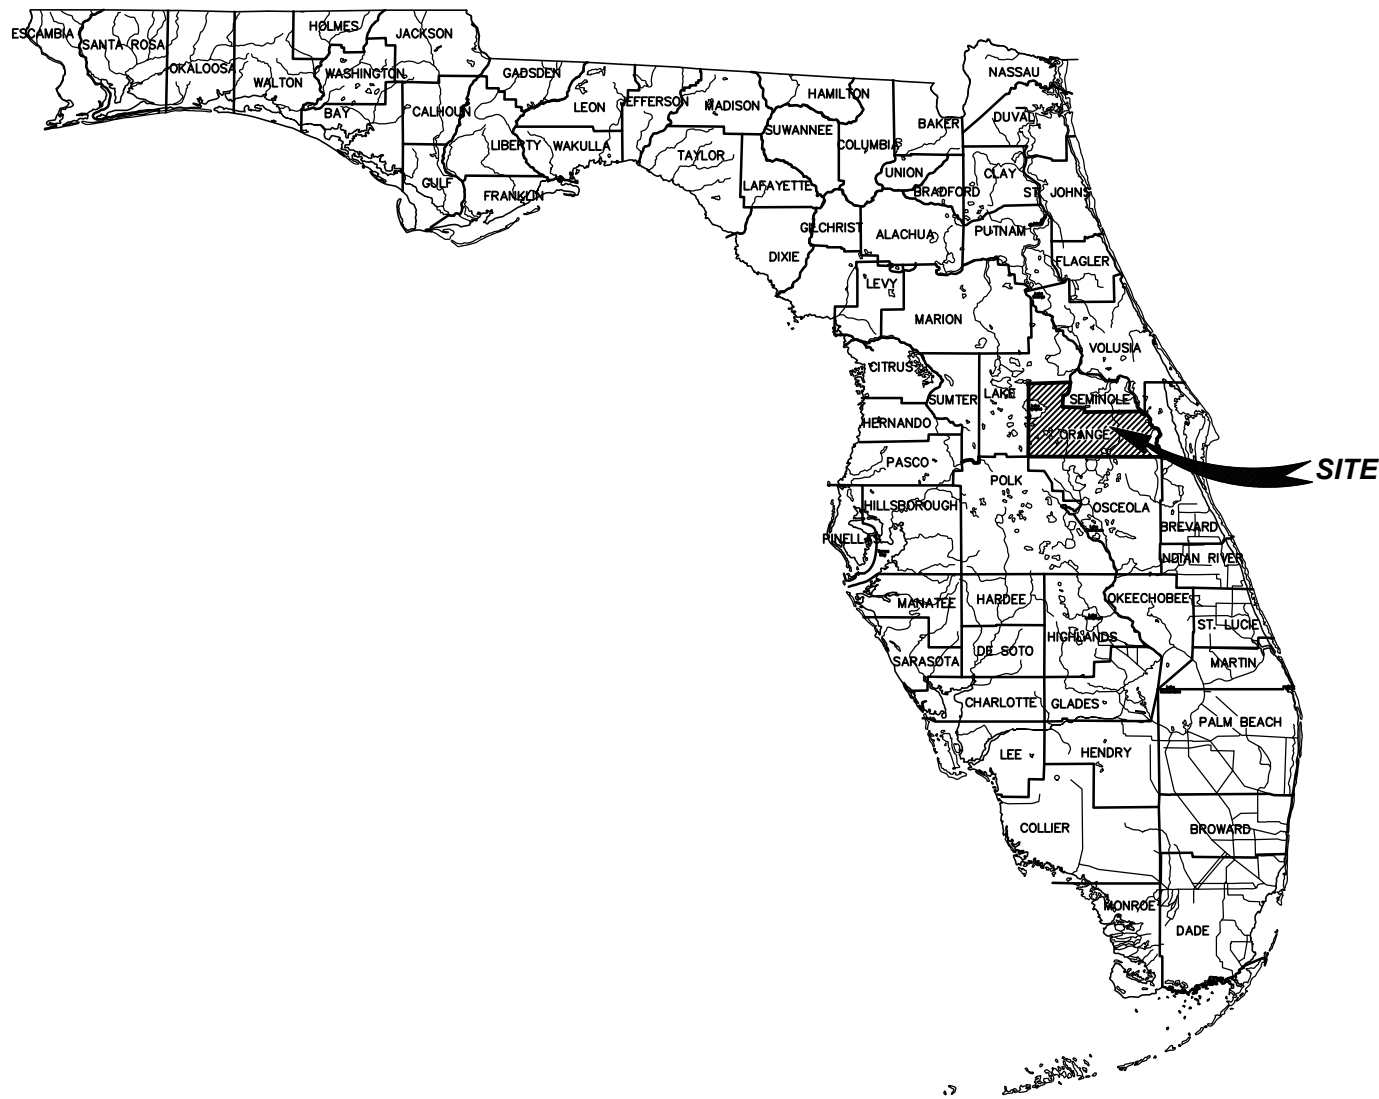
Licenses:
Eng. C.O.A. No. 3215
Survey L.B. No. 7143
Arch. Lic. No. AA2600926
Lndscp. Lic. No. LC0000298

P.S. # 3259 ALLWOOD
BOUNDARY AND TOPOGRAPHIC SURVEY
SURVEY PROVIDED BY TETRA TECH
PROJECT NO.: 200-09074-11002

OCU FILE NO.: 74325
DESIGNED BY:
DRAWN BY:
CHECKED BY:
CADD FILE: Allwood Survey.dwg

SCALE: AS SHOWN
DRAWING NO.:
V200
SHEET: 5 OF 40

TOPOGRAPHIC SURVEY
FOR
ORANGE COUNTY UTILITIES
AT
WINFREE DRIVE
LYING IN
SECTION 16-TOWNSHIP 23 SOUTH-RANGE 30 EAST
ORANGE COUNTY, FLORIDA



Topographic Site Limits:

THAT PORTION OF WINFREE DRIVE BEGINNING 290' WESTERLY OF THE CENTER LINE OF KENNEDY AVENUE AND EXTENDING EASTERLY 190' EAST OF DEER ROAD AND THE NORTH 150' FROM THE CENTERLINE OF WINFREE DRIVE ALONG KENNEDY AVENUE, ARROW ROAD AND DEER ROAD ALL LYING IN GATLIN HEIGHTS SUBDIVISION PER PLAT BOOK 4, PAGE 126 AND SECLUDED OAKS PER PLAT BOOK 21, PAGE 128 PUBLIC RECORDS ORANGE COUNTY FLORIDA.

Survey Notes:

- "SURVEY MAP AND REPORT OR THE COPIES THEREOF ARE NOT VALID WITHOUT THE SIGNATURE AND THE ORIGINAL RAISED SEAL OF A FLORIDA LICENSED SURVEYOR AND MAPPER."
- "ADDITIONS OR DELETIONS TO SURVEY MAPS OR REPORTS BY OTHER THAN THE SIGNING PARTY OR PARTIES IS PROHIBITED WITHOUT WRITTEN CONSENT OF THE SIGNING PARTY OR PARTIES."
- THE SITE BENCHMARKS FOR THIS TOPOGRAPHIC SURVEY ARE DISPLAYED ON THE RESPECTIVE SURVEY FILE. THESE BENCHMARKS ARE BASED ON A CLOSED VERTICAL CONTROL LOOP HAVING AN ACTUAL ERROR OF CLOSURE OF 0.005' WHICH MEETS THE ALLOWABLE CLOSURE OF 0.027". THIS FIELDWORK WAS PERFORMED USING A TOPCON LEVEL MODEL # DL-1010C AND REFERENCES THE FOLLOWING PUBLISHED BENCHMARKS AS ESTABLISHED BY THE NORTH AMERICAN VERTICAL DATUM OF 1988 (NAVD '88) AND SAID ELEVATIONS ARE MATCHED TO THE VERTICAL CONTROL BENCHMARKS PER TETRA TECH SURVEY PROJECT NO. 200-09074-11001 (LIFT STATION #3092 WINFREE DRIVE) AS FOLLOWS:
a) CONTROL POINT NAIL & DISC #2
ELEVATION = 102.58 (NAVD) '88
b) CONTROL POINT NAIL & DISC #3
ELEVATION = 103.02 (NAVD) '88
SITE BENCHMARKS ARE AS SHOWN ON SHEET 2 OF 2.
- THIS SURVEY IS NOT VALID WITHOUT SHEETS 1 THROUGH 2 OF 2.
- THE LAST DAY FIELD WORK WAS PERFORMED WAS APRIL 17, 2014; ALL BOUNDARY CORNERS WERE RECOVERED OR SET AS NOTED HEREON.
- THE APPARENT USE OF THE LAND, AS CLASSIFIED BY THE MINIMUM TECHNICAL STANDARDS RULE CHAPTER 5J-17, FLORIDA ADMINISTRATIVE CODE ESTABLISHES THAT THE MINIMUM RELATIVE ACCURACY FOR THIS TYPE OF BOUNDARY SURVEY MEET THE HORIZONTAL CONTROL ACCURACY OF 1/7,500 FEET FOR A SUBURBAN SURVEY. THE MEASUREMENTS AND CALCULATIONS OF THE CLOSED GEOMETRIC FIGURES WERE FOUND TO MEET THIS ACCURACY REQUIREMENT. THE EQUIPMENT USED TO VERIFY THE HORIZONTAL CONTROL ON THE SUBJECT SURVEY WAS A TOPCON GPT 2005.
- HORIZONTAL WELL-IDENTIFIED FEATURES IN THIS SURVEY AND MAP HAVE BEEN MEASURED TO AN ESTIMATED HORIZONTAL POSITIONAL ACCURACY OF 0.05 (FT). THE EQUIPMENT USED TO LOCATE THE FEATURES WAS A TOPCON GPT 2005 AND LEICA SCANSTATION C10.
- THIS SURVEY WAS PREPARED WITHOUT THE BENEFIT OF AN ABSTRACT OR OPINION OF TITLE. NO INSTRUMENTS OF RECORD REFLECTING EASEMENTS, RIGHTS-OF-WAY, AND/OR OWNERSHIP WERE FURNISHED TO THIS SURVEYOR EXCEPT AS NOTED.
- THIS SURVEY DOES NOT IDENTIFY THE LIMITS OR EXTENT OF POTENTIAL JURISDICTIONAL WETLAND BOUNDARIES.
- FENCES EXISTING ON, OVER OR ADJACENT TO SUBJECT PROPERTY, ARE DISPLAYED HEREON; OWNERSHIP WHETHER SINGULAR OR JOINT WAS NOT DETERMINED BY THIS SURVEY.
- VERTICAL FEATURE ACCURACY: "ELEVATIONS OF WELL-IDENTIFIED FEATURES CONTAINED IN THIS SURVEY AND MAP HAVE BEEN MEASURED TO AN ESTIMATED VERTICAL POSITIONAL ACCURACY OF 0.05 (FT)."
- STATE PLANE INFORMATION SHOWN HEREON IS BASED ON THE NORTH AMERICAN DATUM OF 1983 (2007) USING CONTROL POINTS FROM TETRA TECH SURVEY PROJECT NO. 200-09074-11001 (LIFT STATION #3092 WINFREE DRIVE) WHICH ARE AS FOLLOWS:
a) CONTROL POINT NAIL & DISC #2
N 1511672.55 FEET, E 554324.75 FEET
b) CONTROL POINT NAIL & DISC #3
N 1511693.35 FEET, E 554225.18 FEET
THE EQUIPMENT USED TO TRANSFER THE STATE PLANE INFORMATION FROM THE ABOVE REFERENCED CONTROL POINTS TO THE SUBJECT SURVEY WAS A TOPCON GPS HIPER PRO.
- DIMENSIONS ARE SHOWN RELATIVE TO UNITED STATES STANDARD FEET AND DECIMALS THEREOF, UNLESS THE OBJECT SHOWN IS COMMONLY IDENTIFIED IN INCHES, I.E. TREE DIAMETER, PIPE DIAMETER, ETC.
- THE UNDERGROUND UTILITIES LABELED UE, FM, AND UW DISPLAYED ON SHEET 2 OF 2 ARE A RESULT OF THE FIELD LOCATION OF THE FLAGS AND MARKINGS ESTABLISHED BY ORANGE COUNTY UTILITIES DEPARTMENT.
- THE UNDERGROUND UTILITIES DEPICTED BY PIPE LINE TYPES ARE APPROXIMATE IN NATURE BASED UPON AN INSPECTION OF THE MANHOLE, GRATE, ETC. OF EACH FACILITY. EXISTING PIPES WERE NOT LAMPED OR REMOTELY VIEWED FOR OBSTRUCTIONS OR CONNECTIVITY.
- BEARINGS SHOWN HEREON ARE RELATIVE TO A LINE BETWEEN TWO NGS PUBLISHED BENCHMARKS WITH PID NUMBERS AK7130 AND AK7287, LINE BEARING N 69°34'33" W.
- THE PURPOSE OF THIS TOPOGRAPHIC SURVEY IS TO PROVIDE TOPOGRAPHIC INFORMATION OF EXISTING IMPROVEMENTS FROM TRACT "B" EAST TO DEER ROAD AS PERFORMED WITHIN THE PLATTED RIGHTS OF WAY.
- TREE SYMBOLS ARE NOT TO SCALE.

Index of Sheets

- COVER SHEET
- TOPOGRAPHIC SURVEY

Surveyor's Certification:

I hereby certify that the attached "Topographic Survey" of the hereon-described property is true and correct to the best of my knowledge, information and belief as surveyed in the field on April 17, 2014. I further certify that this "Topographic Survey" meets the minimum technical standards set forth in Rule Chapter 5J-17 of the Florida Administrative Code.

For the Firm By: _____
Thomas J. Galloway
Professional Surveyor and Mapper
Florida Registration No. 6549

TITLE BLOCK ABBREVIATIONS
Eng. = ENGINEERING L.R. = LICENSED BUSINESS
C.O.A. = CERTIFICATE OF AUTHORIZATION Arch. = ARCHITECTURAL
Landscape = LANDSCAPE N/A = NOT APPLICABLE LG. = LICENSED
No. = NUMBER P.O. = POST OFFICE © = COPYRIGHT

Survey Prepared By:
CPH, Inc.
500 West Fulton St.
Sanford, FL 32771
Ph: 407.322.6841
Licenses:
Eng. C.O.A. No. 3215
Survey L.B. No. 7143
Arch. Lic. No. AA2600926
Landscape Lic. No. LC0000298

OCU FILE NO.: 74325
APPROVED BY: TJG
DRAWN BY: JAB/JYR
CHECKED BY: RLR
CADD FILE: PS 3439 Survey.dwg

SCALE: N/A
DRAWING NO.:
V300
SHEET: 6 OF 40

Abbreviation Legend:

(A)	- ACTUAL	MH	- MANHOLE
A/C	- AIR CONDITIONER	MLP	- METAL LIGHT POLE
ACSM	- AMERICAN CONGRESS ON SURVEYING & MAPPING	MPH	- MILES PER HOUR
ADA	- AMERICANS WITH DISABILITIES ACT	MPP	- METAL POWER POLE
ALTA	- AMERICAN LAND TITLE ASSOCIATION	N/A	- NOT APPLICABLE
APPROX	- APPROXIMATE	NAVD	- NORTH AMERICAN VERTICAL DATUM
ARV	- AIR RELEASE VALVE	NAV	- NORTH AMERICAN DATUM
AVE	- AVENUE	NG	- NATURAL GROUND
AVG	- AVERAGE	NGS	- NATIONAL GEODETIC SURVEY
(BB)	- BEARING BASIS	NGVD	- NATIONAL GEODETIC VERTICAL DATUM
BFP	- BACK FLOW PREVENTER	N & D	- NAIL AND DISK
BLK	- BLOCK	NO.	- NUMBER
BLDG	- BUILDING	NR	- NON-RADIAL
BLVD	- BOULEVARD	NSPS	- NATIONAL SOCIETY OF PROFESSIONAL SURVEYORS
BM	- BENCH MARK	NT	- NON-TANGENT
BOC	- BACK OF CURB	NTS	- NOT TO SCALE
BOW	- BACK OF WALK	OD	- OUTSIDE DIAMETER
BSL	- BUILDING SETBACK LINE	ORB	- OFFICIAL RECORDS BOOK
BWF	- BARBED WIRE FENCE	OR	- OFFICIAL RECORDS
C-X	- DENOTES SHEET NUMBERING FOR ENGINEERING PLANS	OUL	- OVERHEAD UTILITY LINES
(C)	- CALCULATED	OTL	- OVERHEAD TRAFFIC LINES
CATV	- CABLE TELEVISION RISER	(P)	- PLAT
CB	- CHORD BEARING	PB	- PLAT BOOK
CBS	- CONCRETE BLOCK STRUCTURE	PC	- POINT OF CURVATURE
C & G	- CURB & GUTTER	PCC	- POINT OF COMPOUND CURVATURE
CI	- CATCH INLET	PCP	- PERMANENT CONTROL POINT
C/L	- CENTERLINE	PFF	- PROPOSED FINISHED FLOOR
CLF	- CHAIN LINK FENCE	PG	- PAGES
CMP	- CONCRETE MONUMENT	PGS	- PAGES
CO	- CORRUGATED METAL PIPE	PI	- POINT OF INTERSECTION
CONC	- CLEANOUT	PK	- PARKER KAYLON
COR	- CORNER	PGB	- POINT OF BEGINNING
CUE	- CORRUGATED PLASTIC PIPE	POC	- POINT OF COMMENCEMENT
CWS	- CROSSWALK SIGNAL	POL	- POINT ON LINE
(D)	- DELTA	PP	- POWER POLE
DB	- DEED BOOK	PRC	- POINT OF REVERSE CURVATURE
DBH	- DIAMETER AT BREAST HEIGHT IN INCHES	PRM	- PERMANENT REFERENCE MONUMENT
DE	- DRAINAGE EASEMENT	PSM	- PROFESSIONAL SURVEYOR & MAPPER
DEPT	- DEPARTMENT	PT	- POINT OF TANGENCY
DI	- DUCTILE IRON PIPE	PVC	- POLYVINYL CHLORIDE PIPE
DR	- DRIVE	PVMT	- PAVEMENT
D/U	- DRAINAGE AND UTILITY EASEMENT	R30E	- RANGE 30 EAST
(E)	- ENGINEERING PLAN	R	- RADIUS
EJB	- ELECTRIC JUNCTION BOX	RAD	- RADIAL
EL	- UNDERGROUND ELECTRICAL LINES	RCF	- REINFORCED CONCRETE PIPE
ELEC	- ELECTRIC	REC	- RECOVERED
ELEV	- ELEVATION	REV	- REVISION
ELUP	- ELLIPTICAL	RP	- RADIUS POINT
EOI	- END OF INFORMATION	R/W	- RIGHT-OF-WAY
EOP	- EDGE OF PAVEMENT	RLS	- REGISTERED LAND SURVEYOR
FB	- FIELD BOOK	RP	- RADIUS POINT
FDOT	- FLORIDA DEPARTMENT OF TRANSPORTATION	RWL	- UNDERGROUND RECLAIM WATER LINE
FF	- FINISH FLOOR	SE	- SPECIAL EASEMENT
FGI	- FLAT GRATE INLET	SEC 16	- SECTION 16
FGLP	- FIBERGLASS LIGHT POLE	SQ	- SQUARE
FHYD	- FIRE HYDRANT	SQ FT	- SQUARE FEET
FM	- FORCE MAIN	STMH	- STORM DRAINAGE MANHOLE
FND	- FOUND	S/W	- SIDEWALK
FP&L	- FLORIDA POWER AND LIGHT	TB	- TANGENT BEARING
(G)	- GRID (STATE PLANE)	T23S	- TOWNSHIP 23 SOUTH
GL	- UNDERGROUND GAS LINES	TELE	- TELEPHONE
GOVT	- GOVERNMENT	TL	- TOWNSHIP 23 SOUTH
GPR	- GROUND PENETRATING RADAR	TOB	- TOP OF BANK
GMH	- GREASE TRAP MANHOLE	TOE	- TOE OF SLOPE
HDPE	- HIGH DENSITY POLYETHYLENE PIPE	TR	- TELEPHONE RISER
HWF	- HOOD WIRE FENCE	TRANS	- TRANSFORMER PAD
ID	- IDENTIFICATION	TSSP	- TRAFFIC SIGNAL SUPPORT POLE
ICV	- IRRIGATION CONTROL VALVE	TVL	- UNDERGROUND CABLE TV LINES
INFO	- INFORMATION	(TYP)	- TYPICAL
INV	- INVERT	U.E.	- UTILITY EASEMENT
IP	- IRON PIPE	UNK	- UNKNOWN
IP&C	- IRON PIPE & CAP	UTL	- UNDERGROUND TELEPHONE LINES
IR	- IRON ROD	W/	- WITH
IR&C	- IRON REBAR & CAP	WL	- UNDERGROUND WATER LINE
L	- ARC LENGTH	WLP	- WOOD LIGHT POLE
LB#	- LICENSED BUSINESS NUMBER	WM	- WATER METER
LP	- LIGHT POLE	WP	- WORK PROGRAM
(M)	- MEASURED	WPF	- WOOD POST FENCE
MB	- MAILBOX	WPP	- WOOD POWER POLE
MES	- MITERED END SECTION	WV	- WATER VALVE

Line Legend:

NOT TO SCALE

1	= 1 FOOT CONTOURS
5	= 5 FOOT CONTOURS
---	= ADJOINER PROPERTY LINES
-X-X-	= BARBED WIRE FENCE
---	= BROKEN LINE
---	= BURIED CABLE
---	= BURIED CABLE TELEVISION
---	= BURIED ELECTRIC
---	= BURIED FIBER OPTICS CABLE
---	= BURIED GAS
---	= BURIED RECLAIMED MAIN/LINE
---	= BURIED SANITARY SEWER LINES
---	= BURIED SANITARY SEWER FORCE MAIN LINE
---	= BURIED TRAFFIC CONTROL
---	= BURIED TELEPHONE LINE
---	= BURIED WATER MAIN/LINES
---	= CENTER LINE R/W
---	= CHAIN LINK FENCE
---	= EASEMENT LINES (EXISTING)
---	= EASEMENT LINES (PROPOSED)
---	= EXISTING DRAINAGE PIPES
---	= EXISTING DRAINAGE PIPES (OUTFALL NOT LOCATED)
---	= HOT WATER SUPPLY LINES
---	= IRRIGATION LINES
---	= OVERHEAD TRAFFIC LINES
---	= OVERHEAD UTILITY LINES
---	= RAILROAD TRACK LINES
---	= RIGHT-OF-WAY LINES
---	= SECTION LINES
---	= LANDSCAPE AREA
---	= TOP OF BANK LINES
---	= TOE OF SLOPE LINES
---	= TREE LINES
---	= TRAVERSE LINES
---	= UNKNOWN BURIED LINES
---	= VINYL FENCE
---	= WOOD FENCE
---	= WETLAND LINE

Symbol Legend:

NOT TO SCALE

---	- AIR RELEASE VALVE
---	- BORING HOLE LOCATION
---	- CABLE TV RISER
---	- CENTRAL ANGLE
---	- CONCRETE
---	- CLEAN OUT
---	- CONCRETE MITERED END SECTION
---	- CONCRETE RIP RAP
---	- CONCRETE UTILITY POLE
---	- COUNTY ROAD SYMBOL
---	- DUAL SUPPORT SIGN
---	- ELECTRICAL MANHOLE
---	- ELECTRIC OUTLET
---	- ELECTRIC RISER
---	- FIRE HYDRANT
---	- FLOOD LIGHT
---	- SITE BENCH MARK
---	- STORM SEWER MANHOLE
---	- STRIPING (DIRECTIONAL)
---	- TELEPHONE CABLE RISER
---	- TELEPHONE MANHOLE
---	- TEST HOLE
---	- TRANSFORMER PAD
---	- UTILITY RISER
---	- GUY ANCHOR
---	- HANDICAP PARKING SPACE
---	- INTERSTATE SYMBOL
---	- IRRIGATION CONTROL VALVE
---	- CONCRETE LIGHT POLE
---	- LIGHT POLE
---	- LIGHT POLE (DUAL)
---	- LIGHT POLE (TRIPLE)
---	- LIGHT POLE (QUAD)
---	- MAILBOX
---	- MONITOR WELLS
---	- BRICK PAVERS
---	- GARBAGE CAN
---	- PULL BOX AS NOTED
---	- TRAFFIC SIGNAL SUPPORT POLE
---	- NAIL & DISC (AS NOTED)
---	- PARKING SPACES (2)
---	- REVISION NUMBER (3)
---	- RECLAIMED WATER METER
---	- RECLAIMED WATER VALVE
---	- ROOF DRAIN
---	- SANITARY SEWER MANHOLE
---	- SANITARY SEWER VALVE
---	- SCHEDULE B ITEM NUMBER (8)
---	- GROUND LIGHT
---	- SECTION CORNER
---	- 4" X 4" CM LB #7143
---	- 5/8" IR&C LB #7143
---	- SIGN
---	- AISLE SIGN
---	- BUS STOP SIGN
---	- DO NOT ENTER SIGN (R5-1)
---	- HANDICAP SIGN
---	- KEEP RIGHT SIGN
---	- MEDIAN SIGN
---	- NO DUMPING SIGN
---	- NO LEFT TURN SIGN (R3-2)
---	- NO LITTERING SIGN
---	- NO PARKING FIRE LANE SIGN
---	- NO RIGHT TURN SIGN (R3-1)
---	- NO TRUCKS (R5-2)
---	- NO PARKING SIGN
---	- ONE WAY SIGN (R6-2)
---	- PEDESTRIAN CROSSING SIGN
---	- RIGHT TURN ONLY
---	- SPEED LIMIT SIGN
---	- STOP SIGN (R1-1)
---	- STREET SIGN
---	- TOW AWAY ZONE SIGN
---	- TRUCK ENTRANCE SIGN
---	- UNKNOWN SIGN
---	- WEIGHT LIMIT SIGN
---	- WRONG WAY SIGN
---	- YIELD SIGN
---	- UNKNOWN RISER

Sign Legend:

NOT TO SCALE

---	- AISLE SIGN
---	- BUS STOP SIGN
---	- DO NOT ENTER SIGN (R5-1)
---	- HANDICAP SIGN
---	- KEEP RIGHT SIGN
---	- MEDIAN SIGN
---	- NO DUMPING SIGN
---	- NO LEFT TURN SIGN (R3-2)
---	- NO LITTERING SIGN
---	- NO PARKING FIRE LANE SIGN
---	- NO RIGHT TURN SIGN (R3-1)
---	- NO TRUCKS (R5-2)
---	- NO PARKING SIGN
---	- ONE WAY SIGN (R6-2)
---	- PEDESTRIAN CROSSING SIGN
---	- RIGHT TURN ONLY
---	- SPEED LIMIT SIGN
---	- STOP SIGN (R1-1)
---	- STREET SIGN
---	- TOW AWAY ZONE SIGN
---	- TRUCK ENTRANCE SIGN
---	- UNKNOWN SIGN
---	- WEIGHT LIMIT SIGN
---	- WRONG WAY SIGN
---	- YIELD SIGN
---	- UNKNOWN RISER

NOTE:

THIS SURVEY IS NOT VALID WITHOUT SHEETS 1 THROUGH 2 OF 2.

REV	DATE	DESCRIPTION

LINE IS 2 INCHES
AT FULL SIZE
(IF NOT SCALE ACCORDINGLY)



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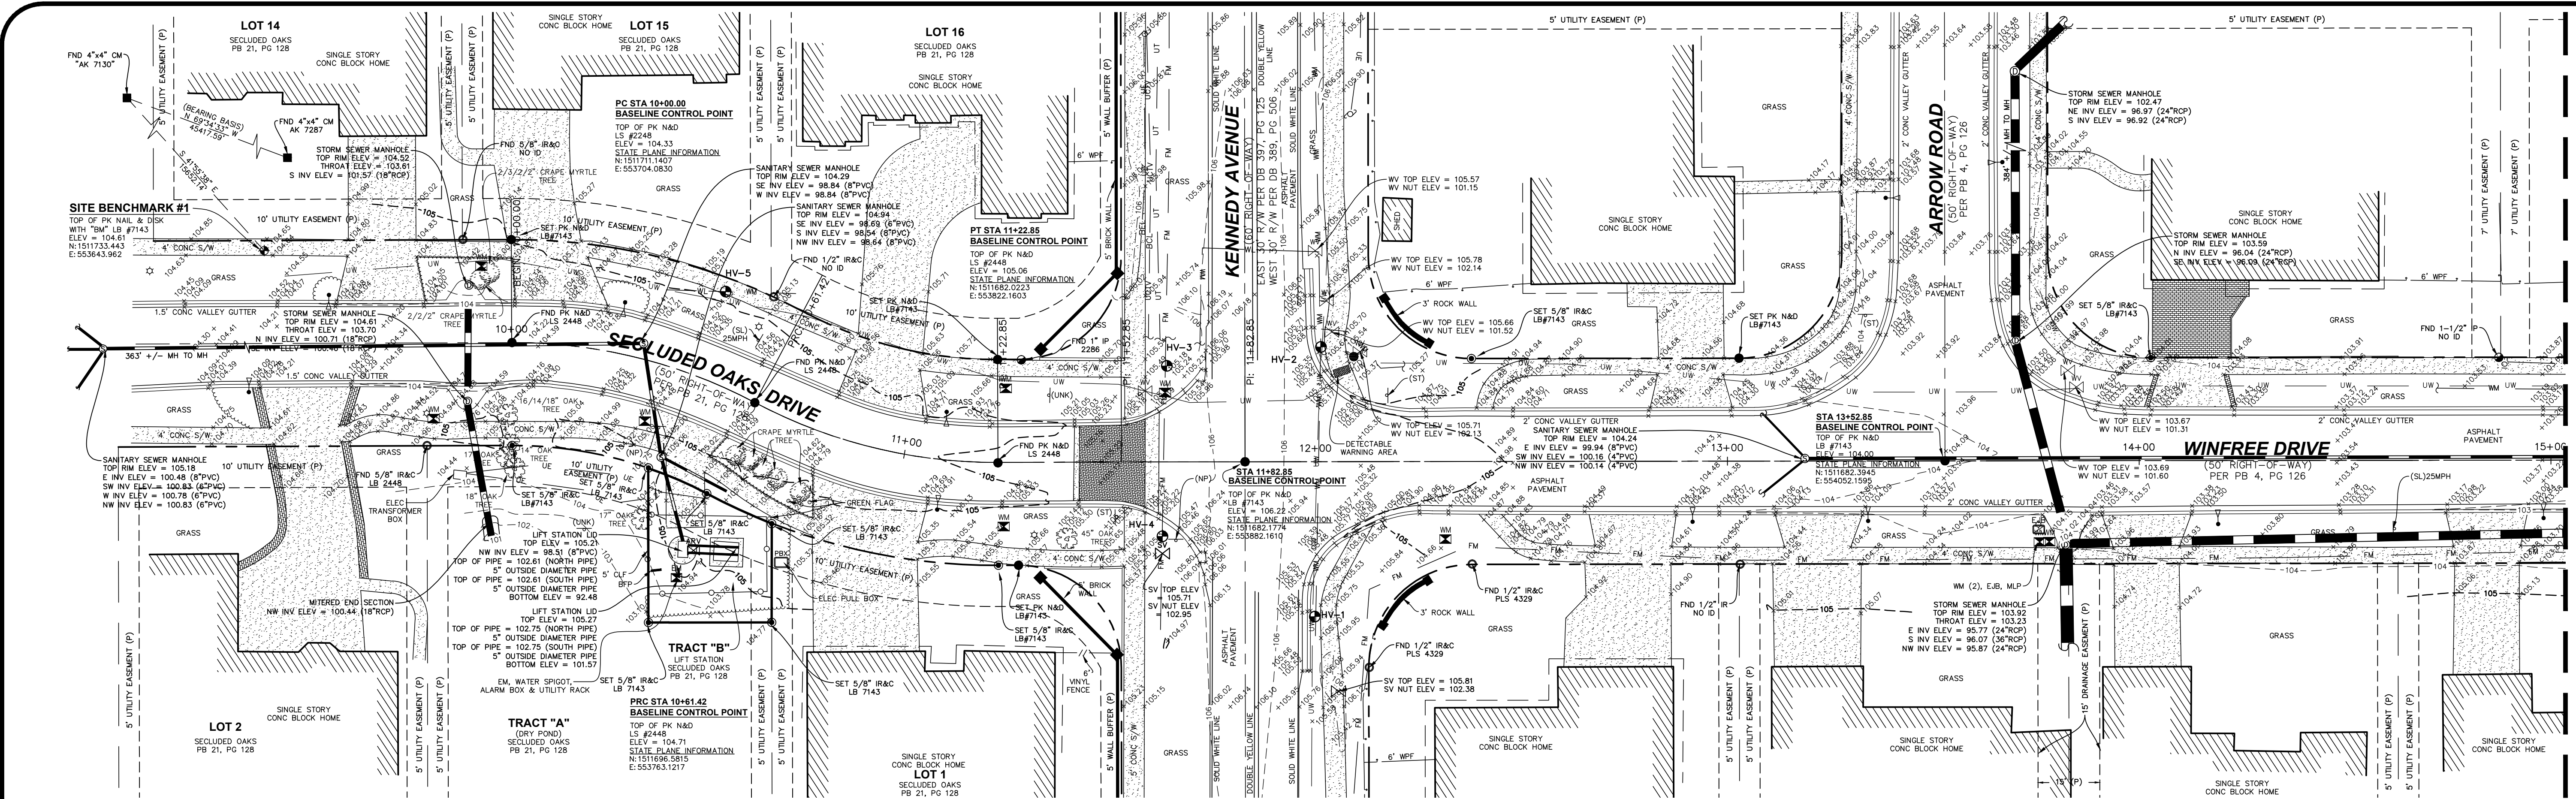
Licenses:
Eng. C.O.A. No. 3215
Survey L.B. No. 7143
Arch. Lic. No. AA2600926
Landscape Lic. No. LC0000298

P.S. # 3092 / P.S. # 3439 SURVEY
NOTES AND LEGENDS

Survey Prepared By:
CPH, Inc.
500 West Fulton St.
Sanford, FL 32771
Ph: 407.322.6841
Licenses:
Eng. C.O.A. No. 3215
Survey L.B. No. 7143
Arch. Lic. No. AA2600926
Landscape Lic. No. LC0000298

OCU FILE NO.: 74325
APPROVED BY: TJG
DRAWN BY: JAB/JYR
CHECKED BY: RLR
CADD FILE: PS 3439 Survey.dwg

SCALE: N/A
DRAWING NO.:
V300
SHEET: 6 OF 40




MATCHLINE SEE BELOW

TEST HOLE DATA:


LOCATION ID	HORIZONTAL COORDINATES	ELEVATION		UTILITY OWNER	SIZE & MATERIAL
		GROUND	TOP OF UTILITY		
HV-1	N 1511645 E 553899	105.8	101.4	ORANGE COUNTY	16-1/2" (OD) METAL
HV-2	N 1511710 E 553901	105.2	99.4	ORANGE COUNTY	16-1/2" (OD) METAL
HV-3	N 1511705 E 553863	105.7	101.7	ORANGE COUNTY	4-1/2" (OD) PVC
HV-4	N 1511664 E 553862	105.6	102.2	ORANGE COUNTY	4-1/2" (OD) PVC
HV-5	N 1511724 E 553756	105.0	100.9	ORANGE COUNTY	8-1/2" (OD) PVC

NOTE:

TEST HOLE INFORMATION WAS PROVIDED BY A SUBCONSULTANT
SEE THIS SHEET FOR LOCATIONS OF VH#-TEST HOLE NUMBER

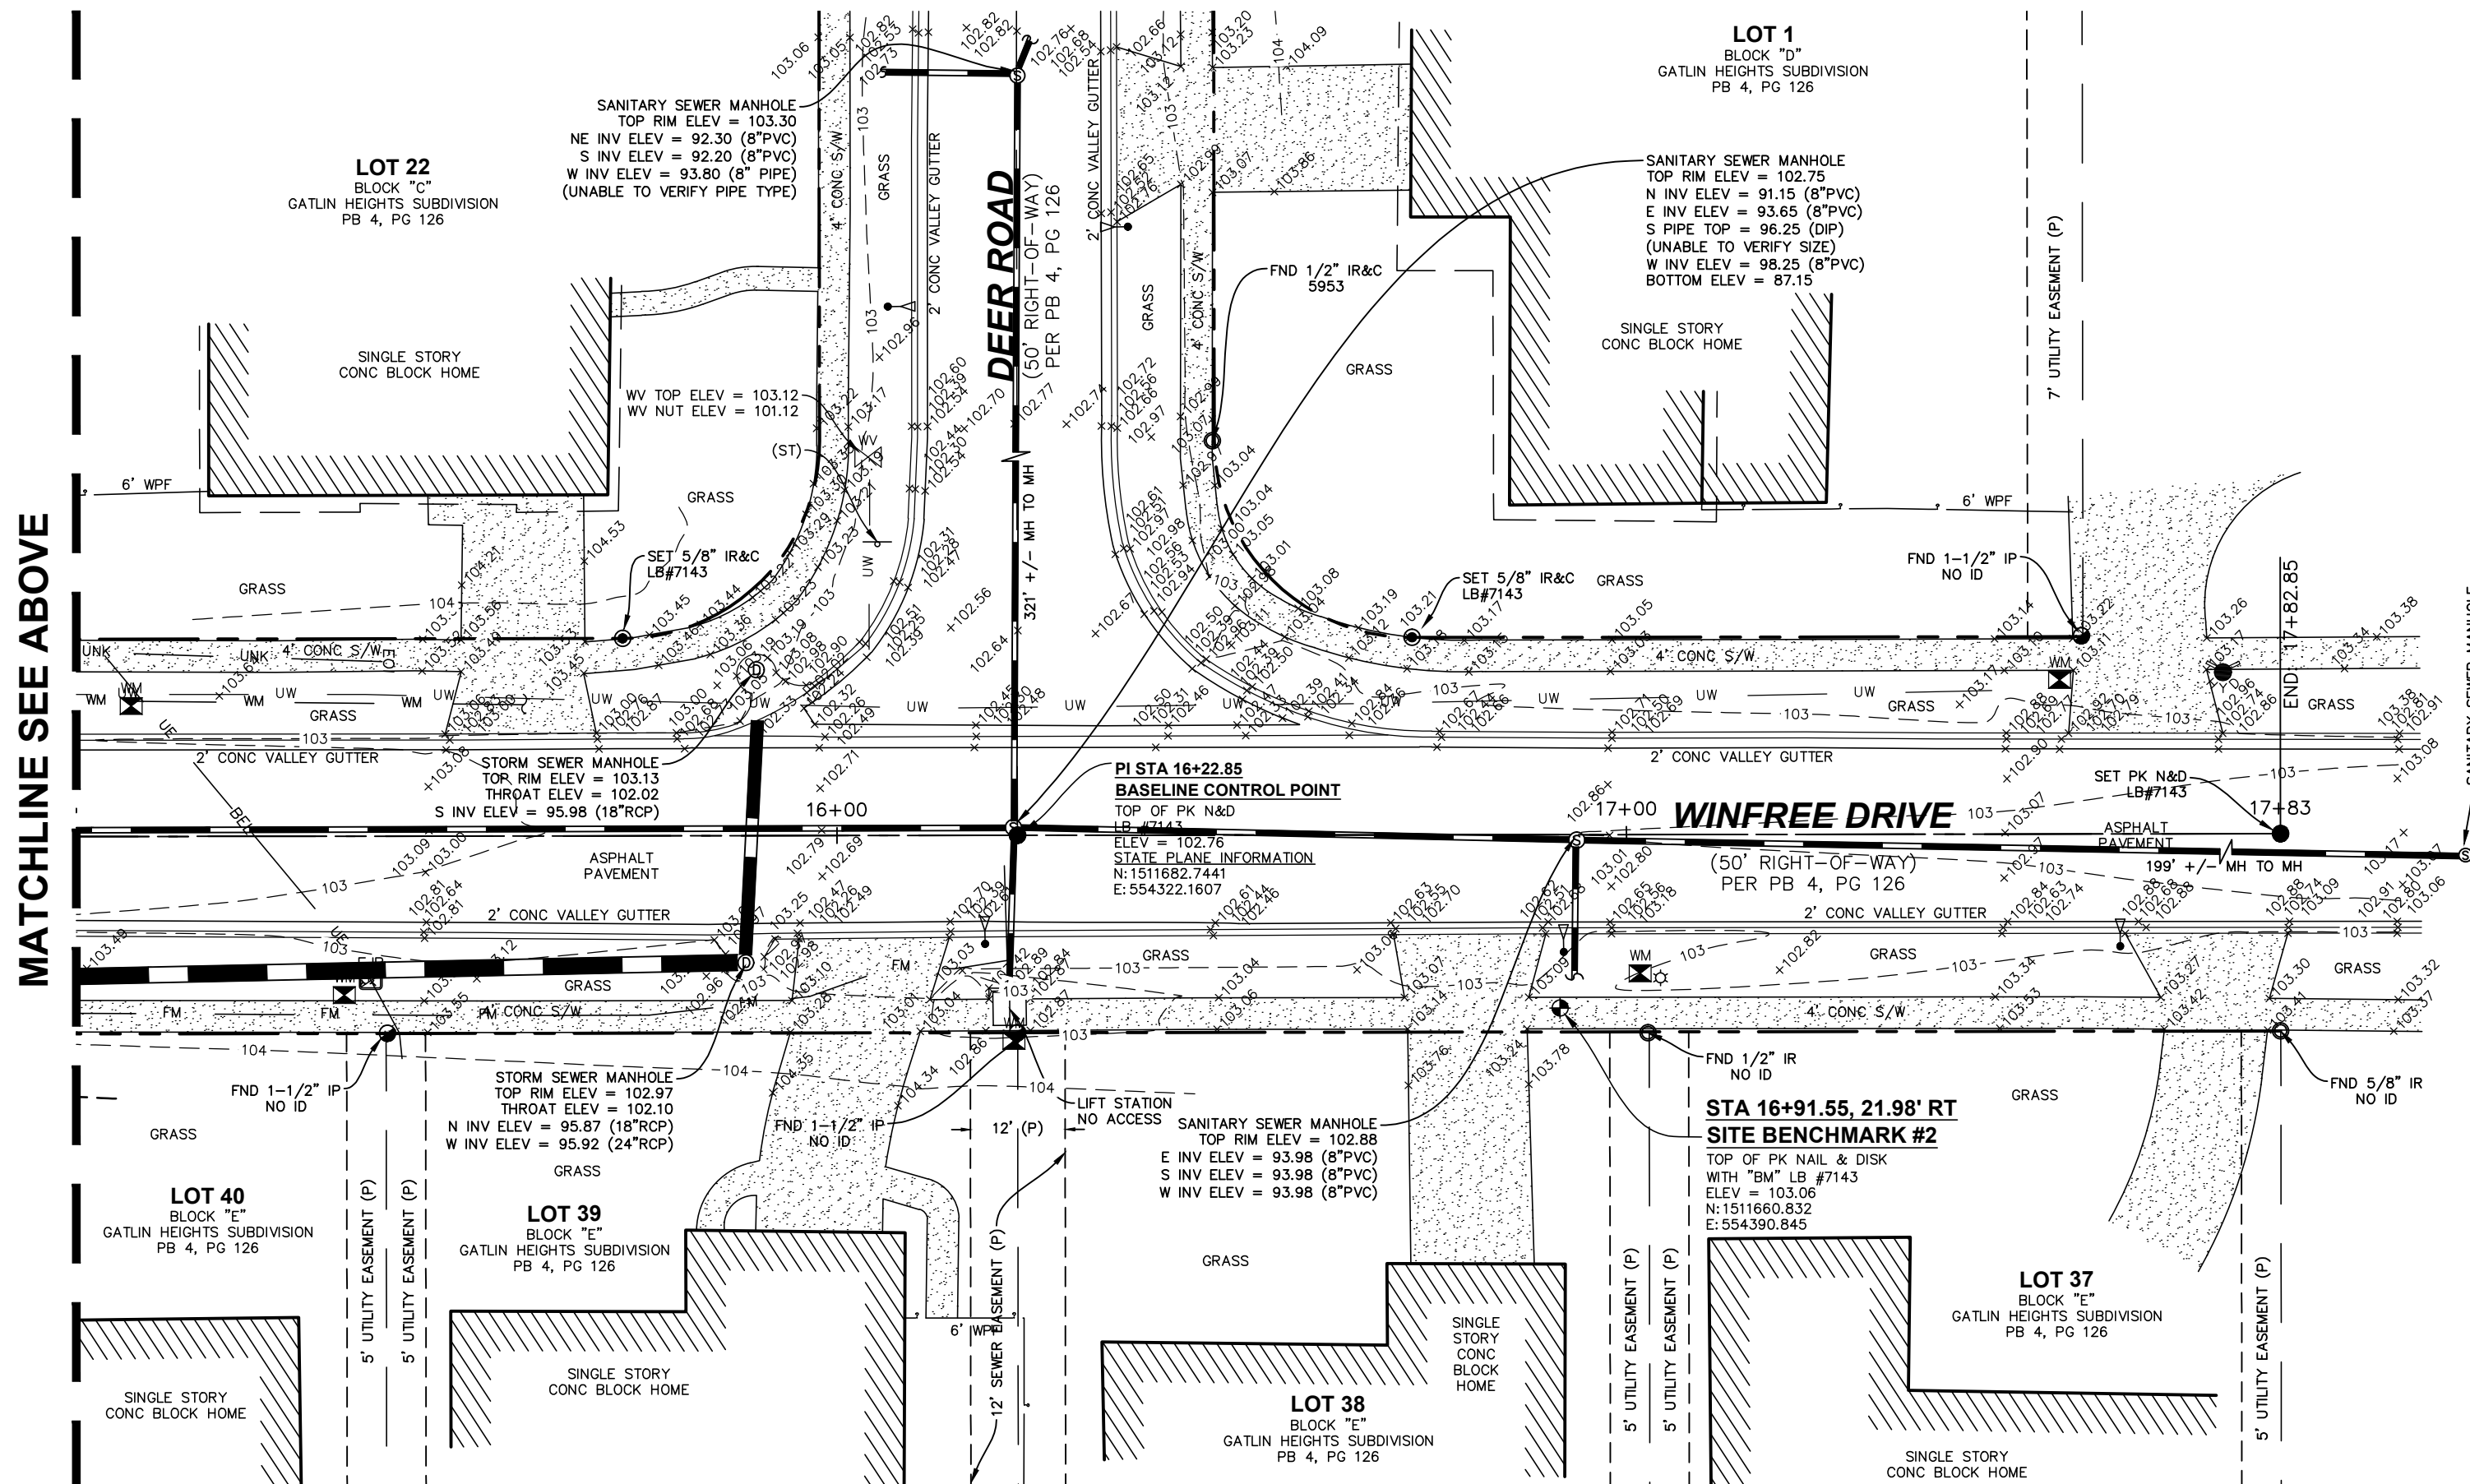

GRAPHIC SCALE

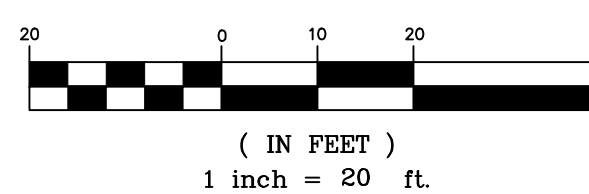

NOTE:

THIS SURVEY IS NOT VALID WITHOUT SHEETS 1 THROUGH 2 OF 2.

Eng = ENGINEERING	L.B. = LICENSED BUSINESS
C.O.A. = CERTIFICATE OF AUTHORIZATION	Arch = ARCHITECTURAL
Landscp = LANDSCAPE	NA = NOT APPLICABLE
No. = NUMBER	P.O. = POST OFFICE
	© = COPYRIGHT

REV	DATE	DESCRIPTION

LINE IS 2 INCHES
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Survey L.B. No. 7143
Arch. Lic. No. AA2600926
Lndscp. Lic. No. LC0000298


P.S. # 3092 / P.S. # 3439
WINFREE DRIVE / SECLUDED OAKS DRIVE
BOUNDARY AND TOPOGRAPHIC SURVEY

Survey Prepared By:
CPH, Inc.
500 West Fulton St.
Sanford, FL 32771
Ph: 407.322.6841
Licenses:
Eng. C.O.A. No. 3215
Survey L.B. No. 7143
Arch. Lic. No. AA2600926
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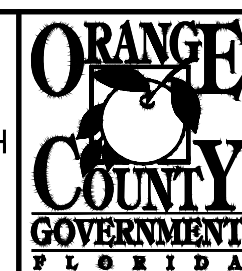
OCU FILE NO.: 74325
APPROVED BY: TJG
DRAWN BY: JAB/JYR
CHECKED BY: RLR
CADD FILE: PS 3439 Survey.dwg

SCALE: 1" = 20'
DRAWING NO.:
V400
SHEET: 7 OF 40

 DENOTES ITEMS TO BE REMOVED
AND / OR DEMOLISHED

[illegible]

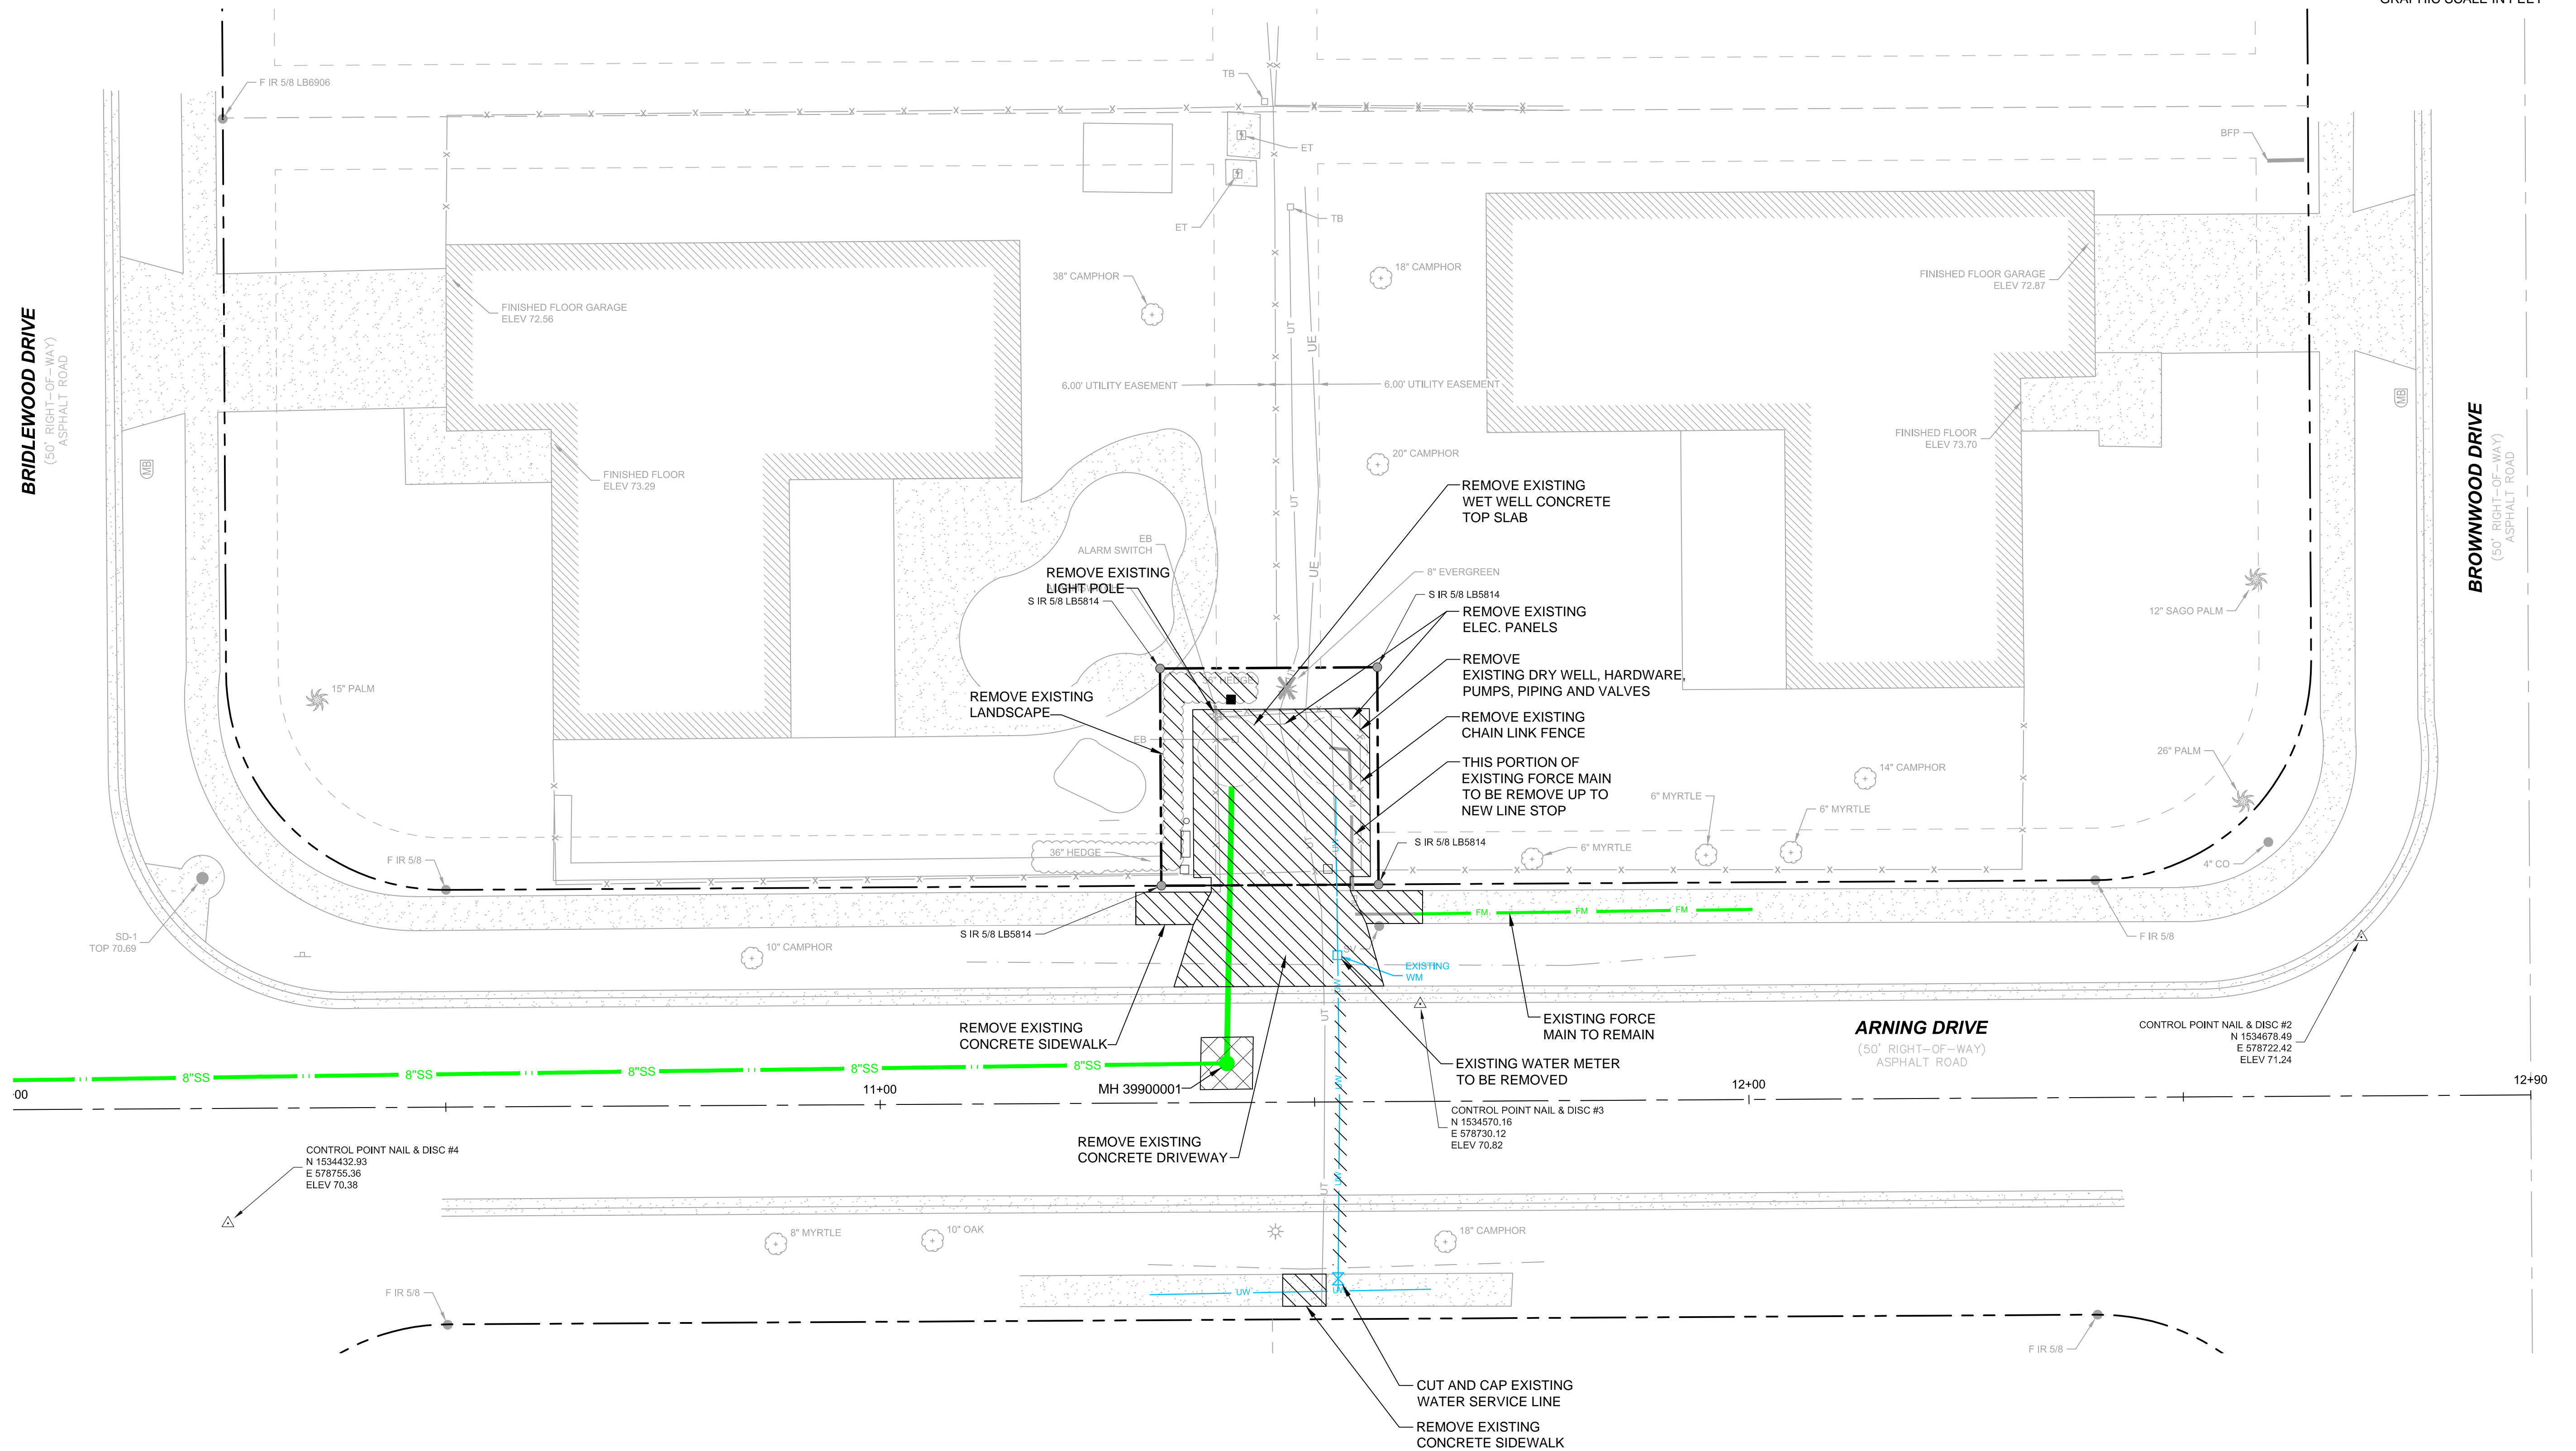LINE IS 2 INCHES
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(IF NOT SCALE ACCORDINGLY)



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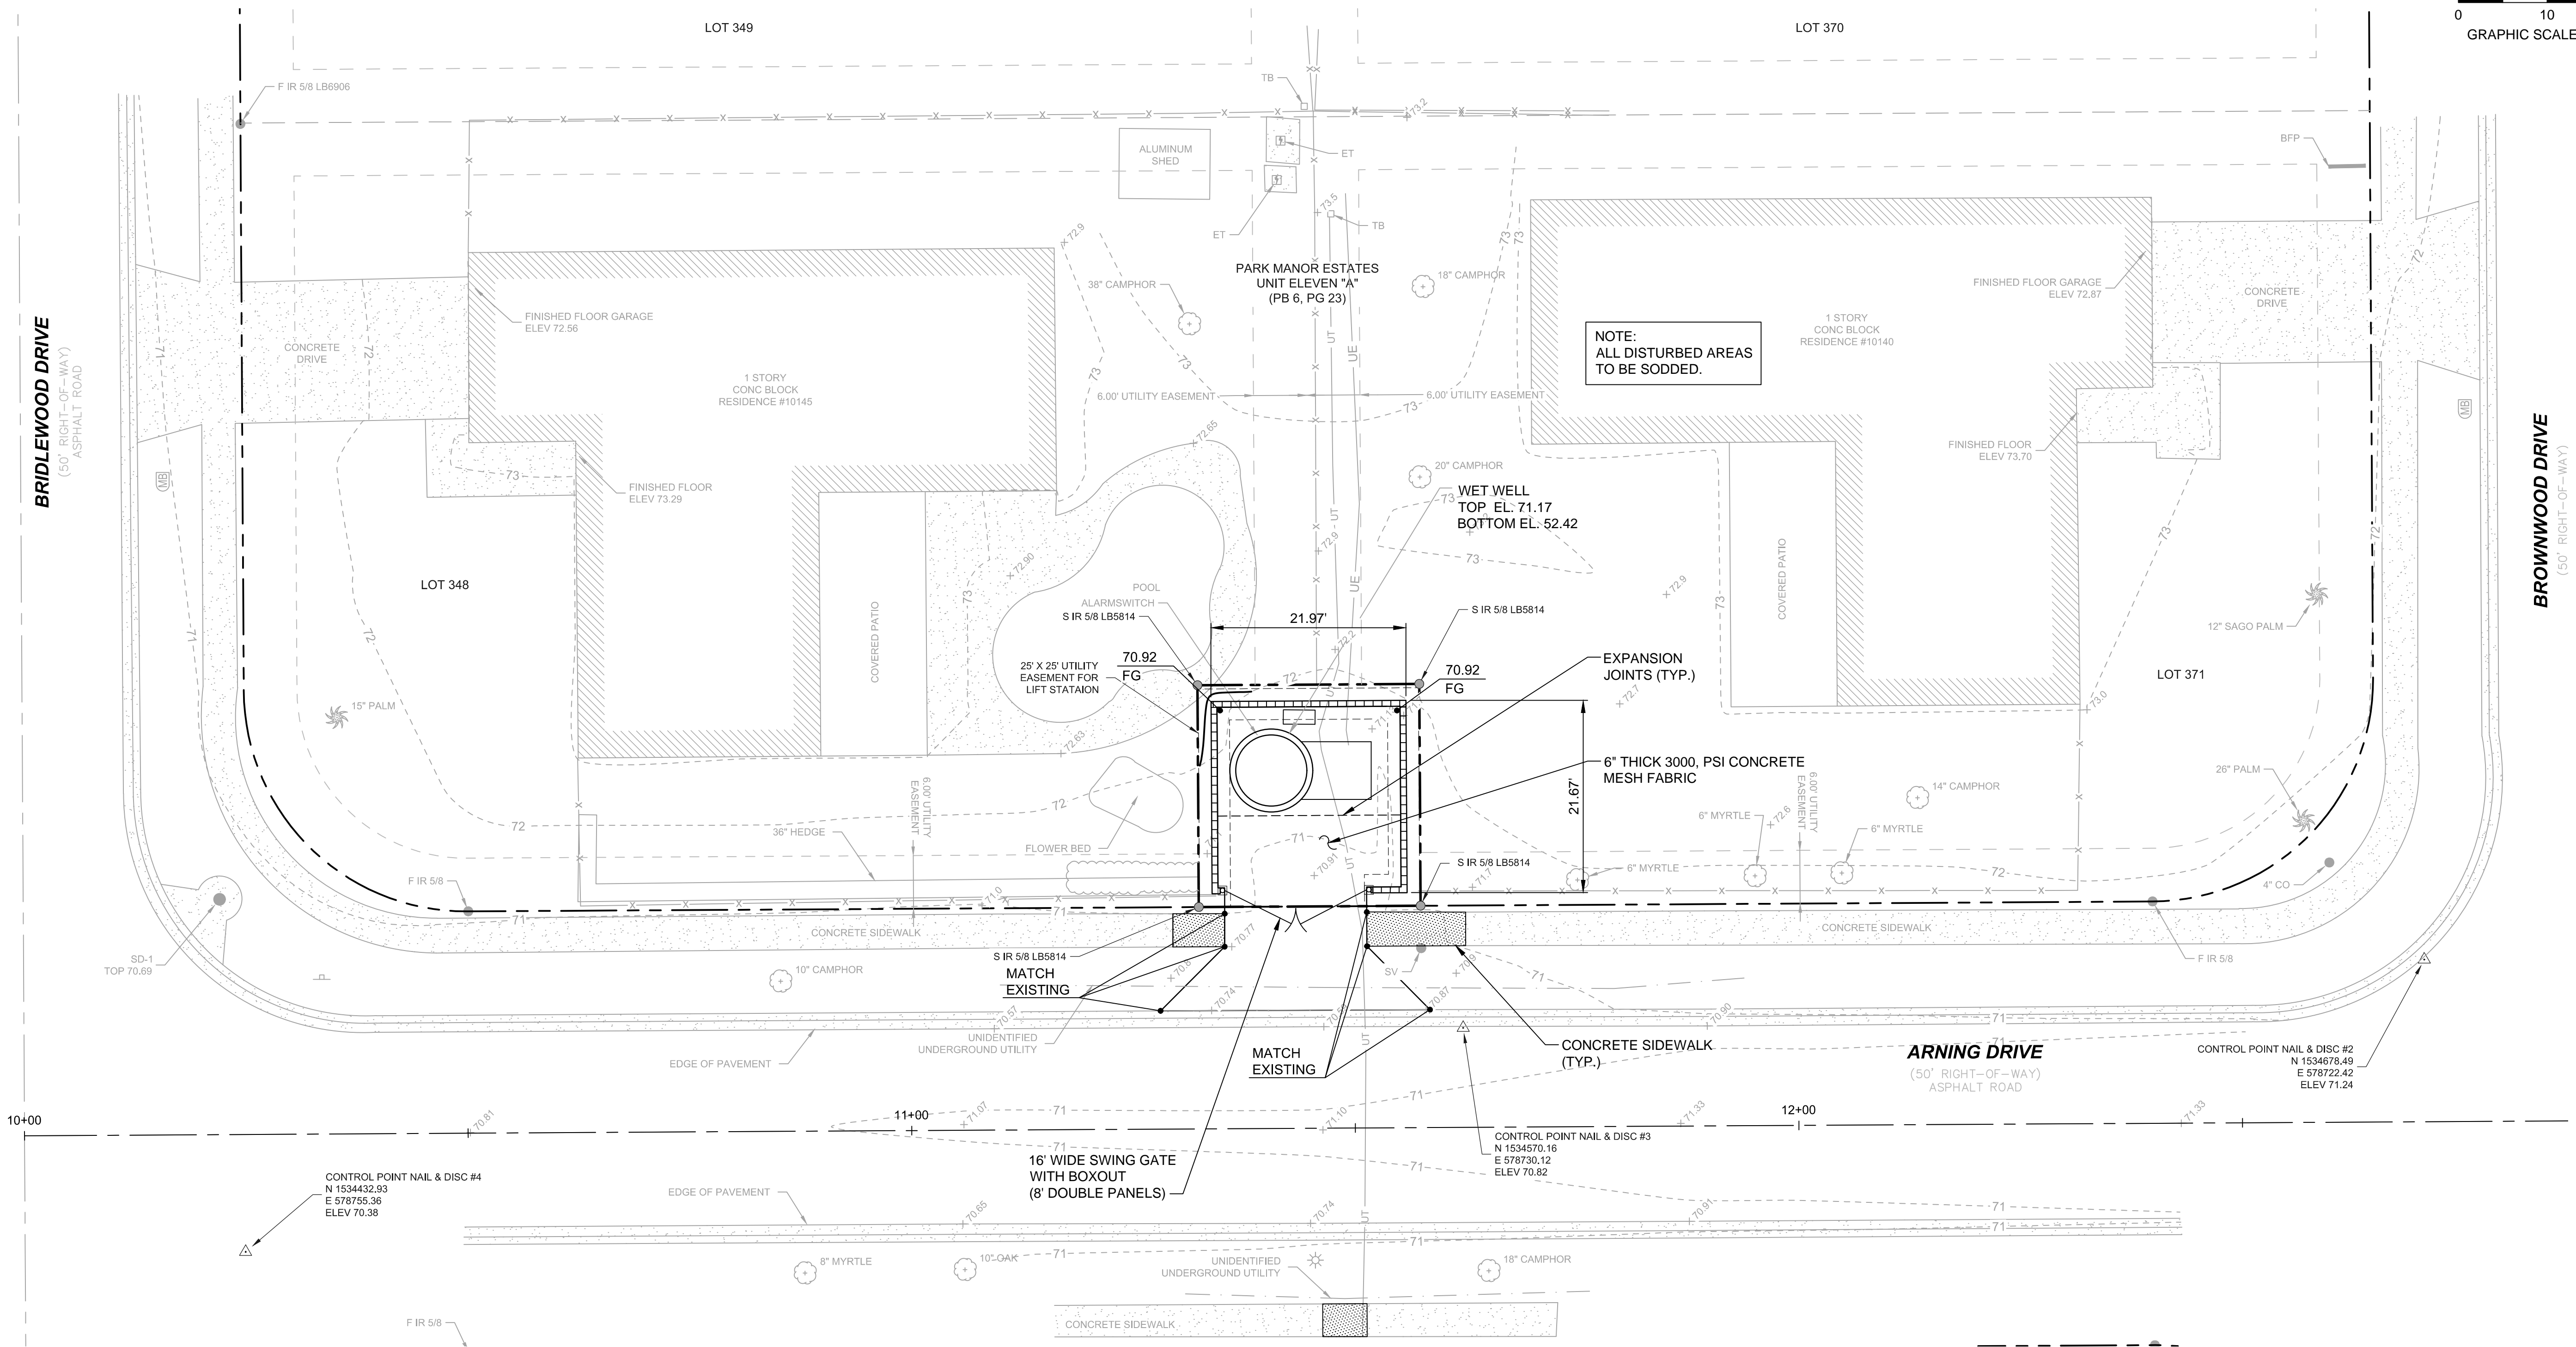
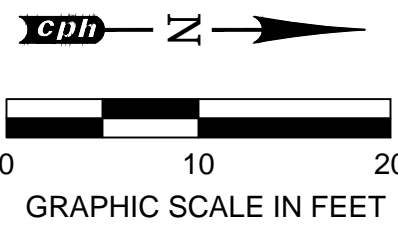
Eng. C.O.A. No. 3215
Survey L.B. No. 7143
Arch. Lic. No. AA2600926
Lndscp. Lic. No. LC0000298

SCOTT A. BREITENSTEIN
PROFESSIONAL ENGINEER
FLORIDA LICENSE #57402

CADD FILE: PS 3990 Site Plan.dwg

SHEET: 8 OF 40

BID DRAWING



REV	DATE	DESCRIPTION

LINE IS 2 INCHES
AT FULL SIZE
(IF NOT SCALE ACCORDINGLY)



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Arch. Lic. No. AA2609926
Lndscp. Lic. No. LC0000298


P.S. # 3990 ARNING DRIVE
SITE GRADING PLAN

SCOTT A. BREITENSTEIN
PROFESSIONAL ENGINEER
FLORIDA LICENSE #57402

OCU FILE NO.: 74325
DESIGNED BY: SAB
DRAWN BY: DGH/GCM
CHECKED BY: SAB/DEM
CADD FILE: PS 3990 Site Plan.dwg

SCALE: 1" = 10'
DRAWING NO. :
C102
SHEET: 10 OF 40

BID DRAWING

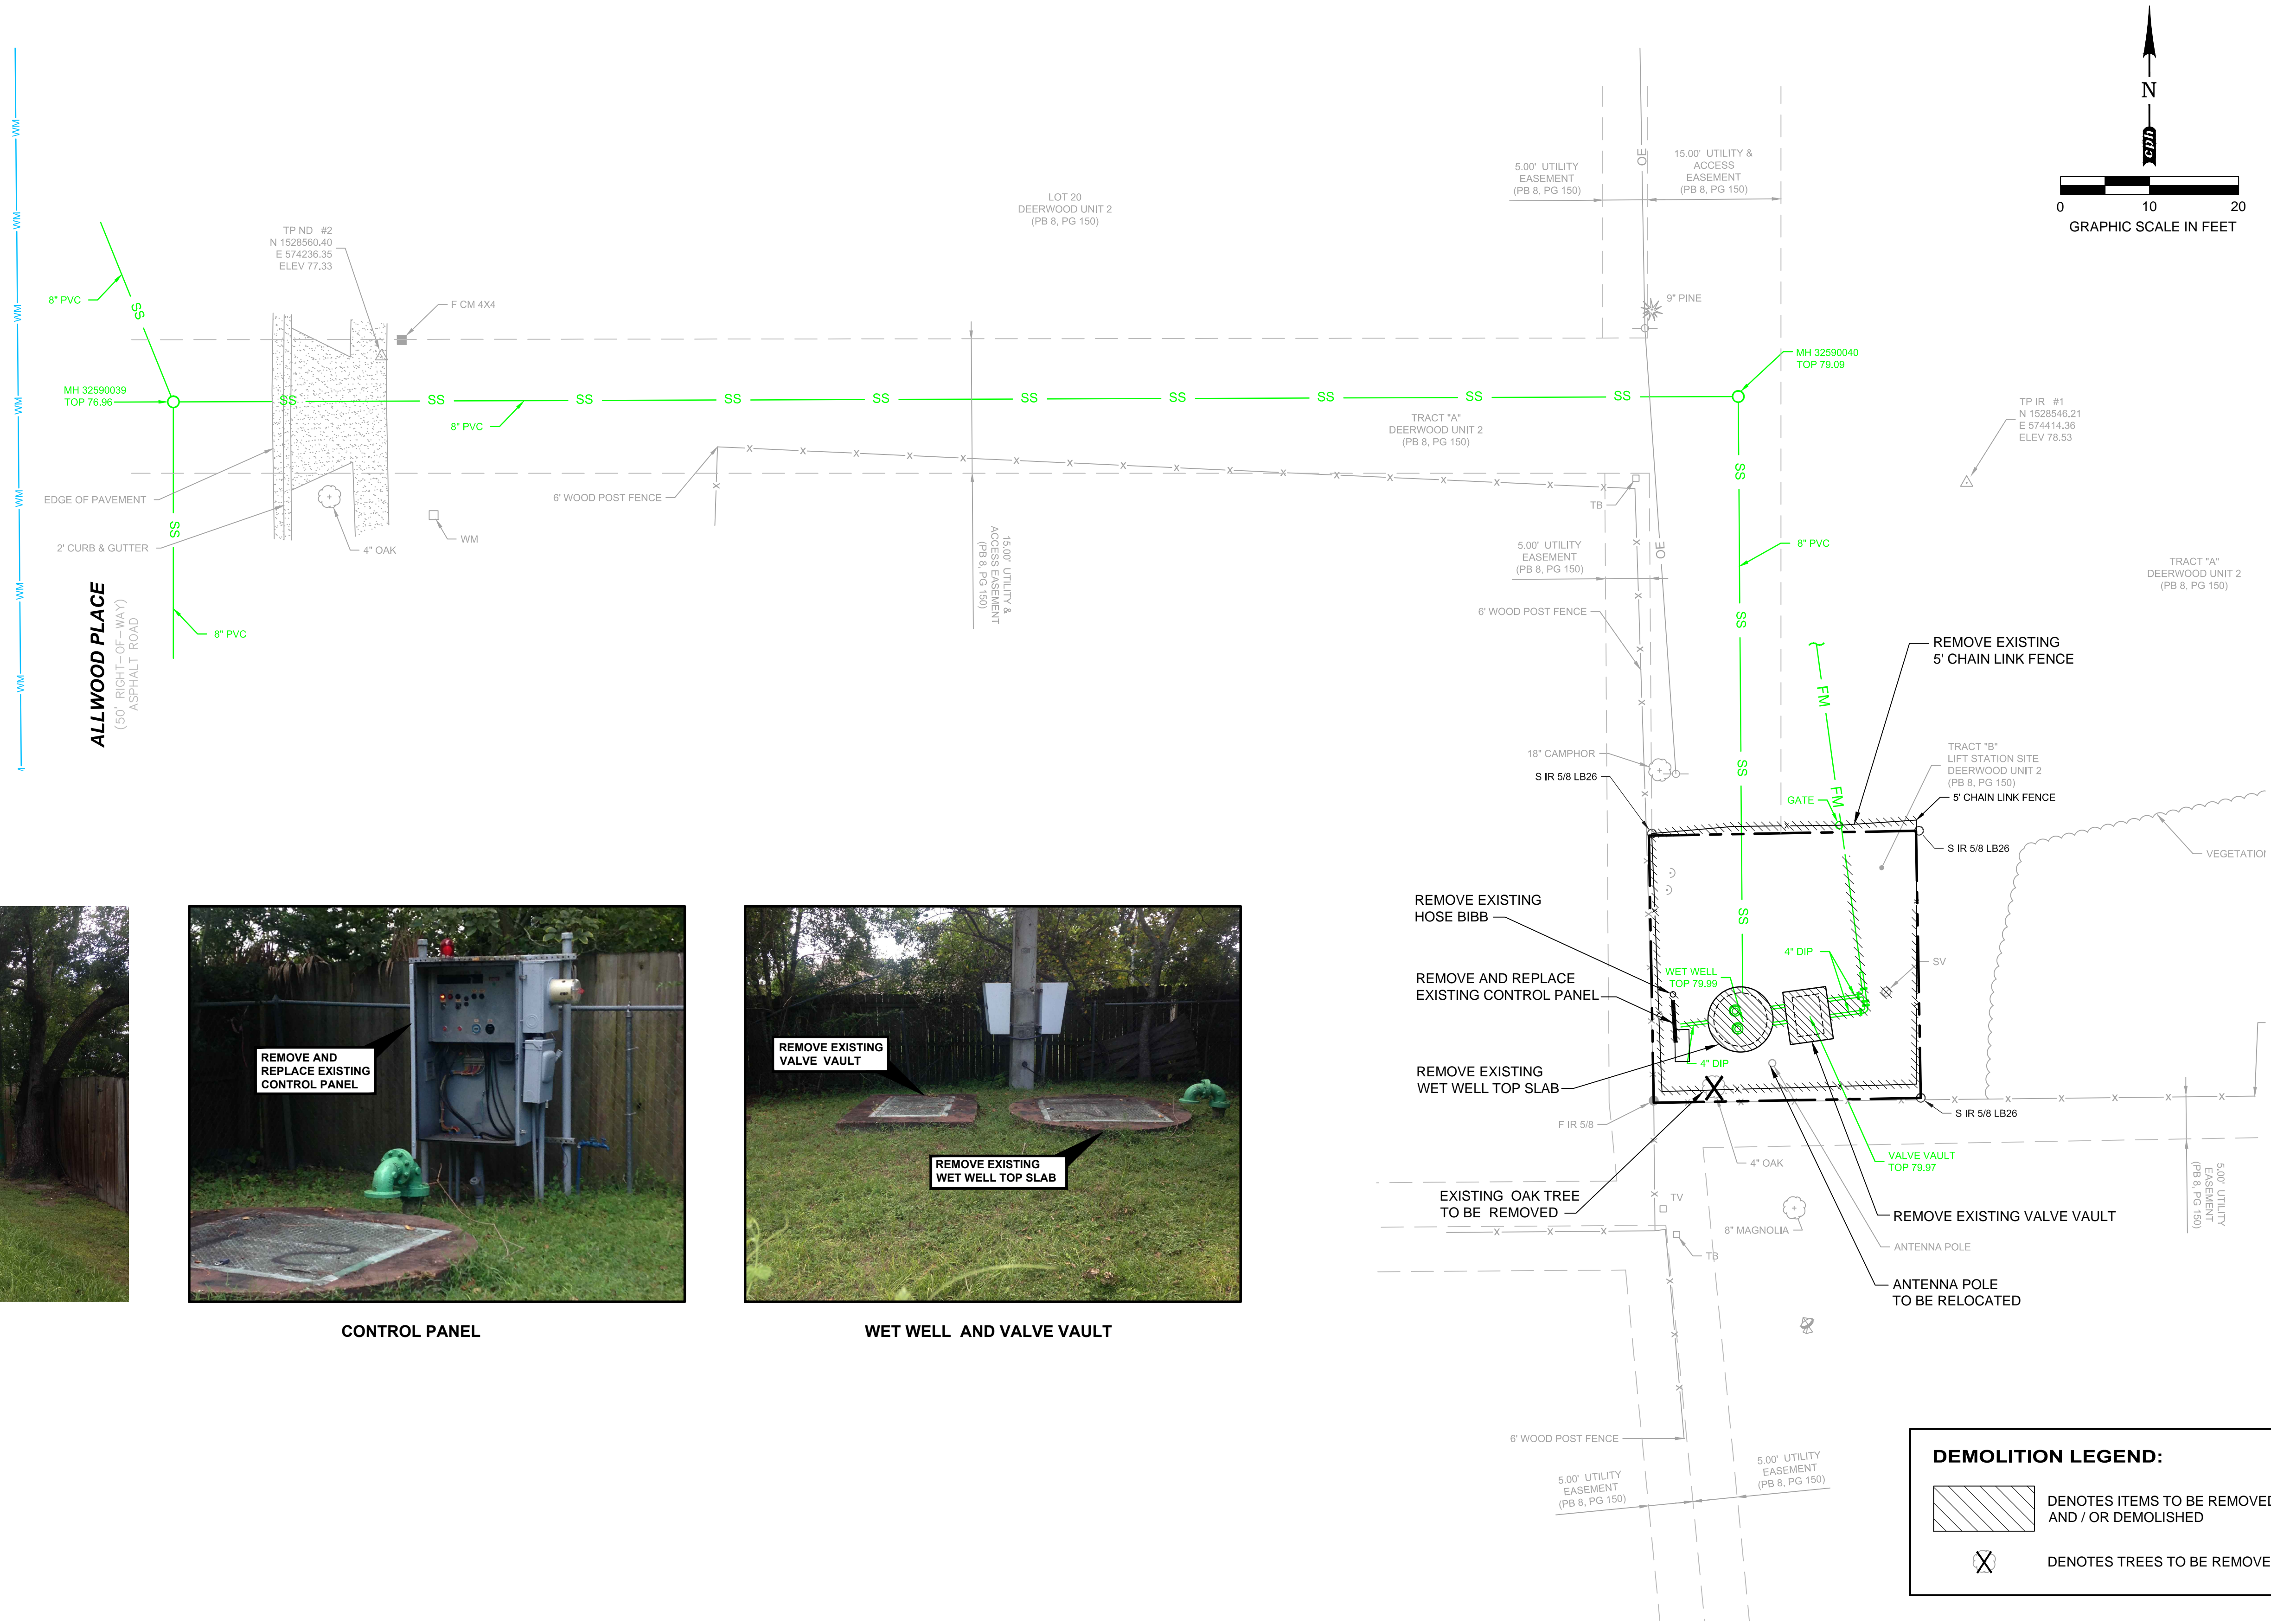

PUMP STATION FENCE SITE



CONTROL PANEL



WET WELL AND VALVE VAULT

REV	DATE	DESCRIPTION

LINE IS 2 INCHES
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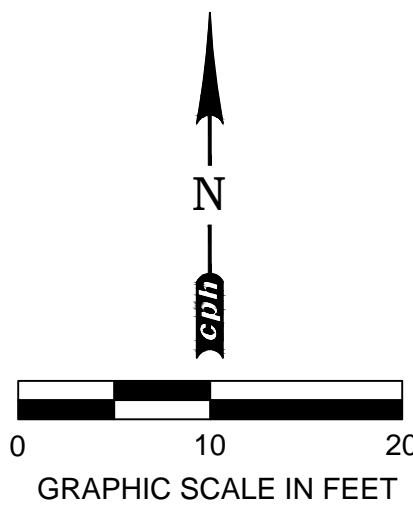
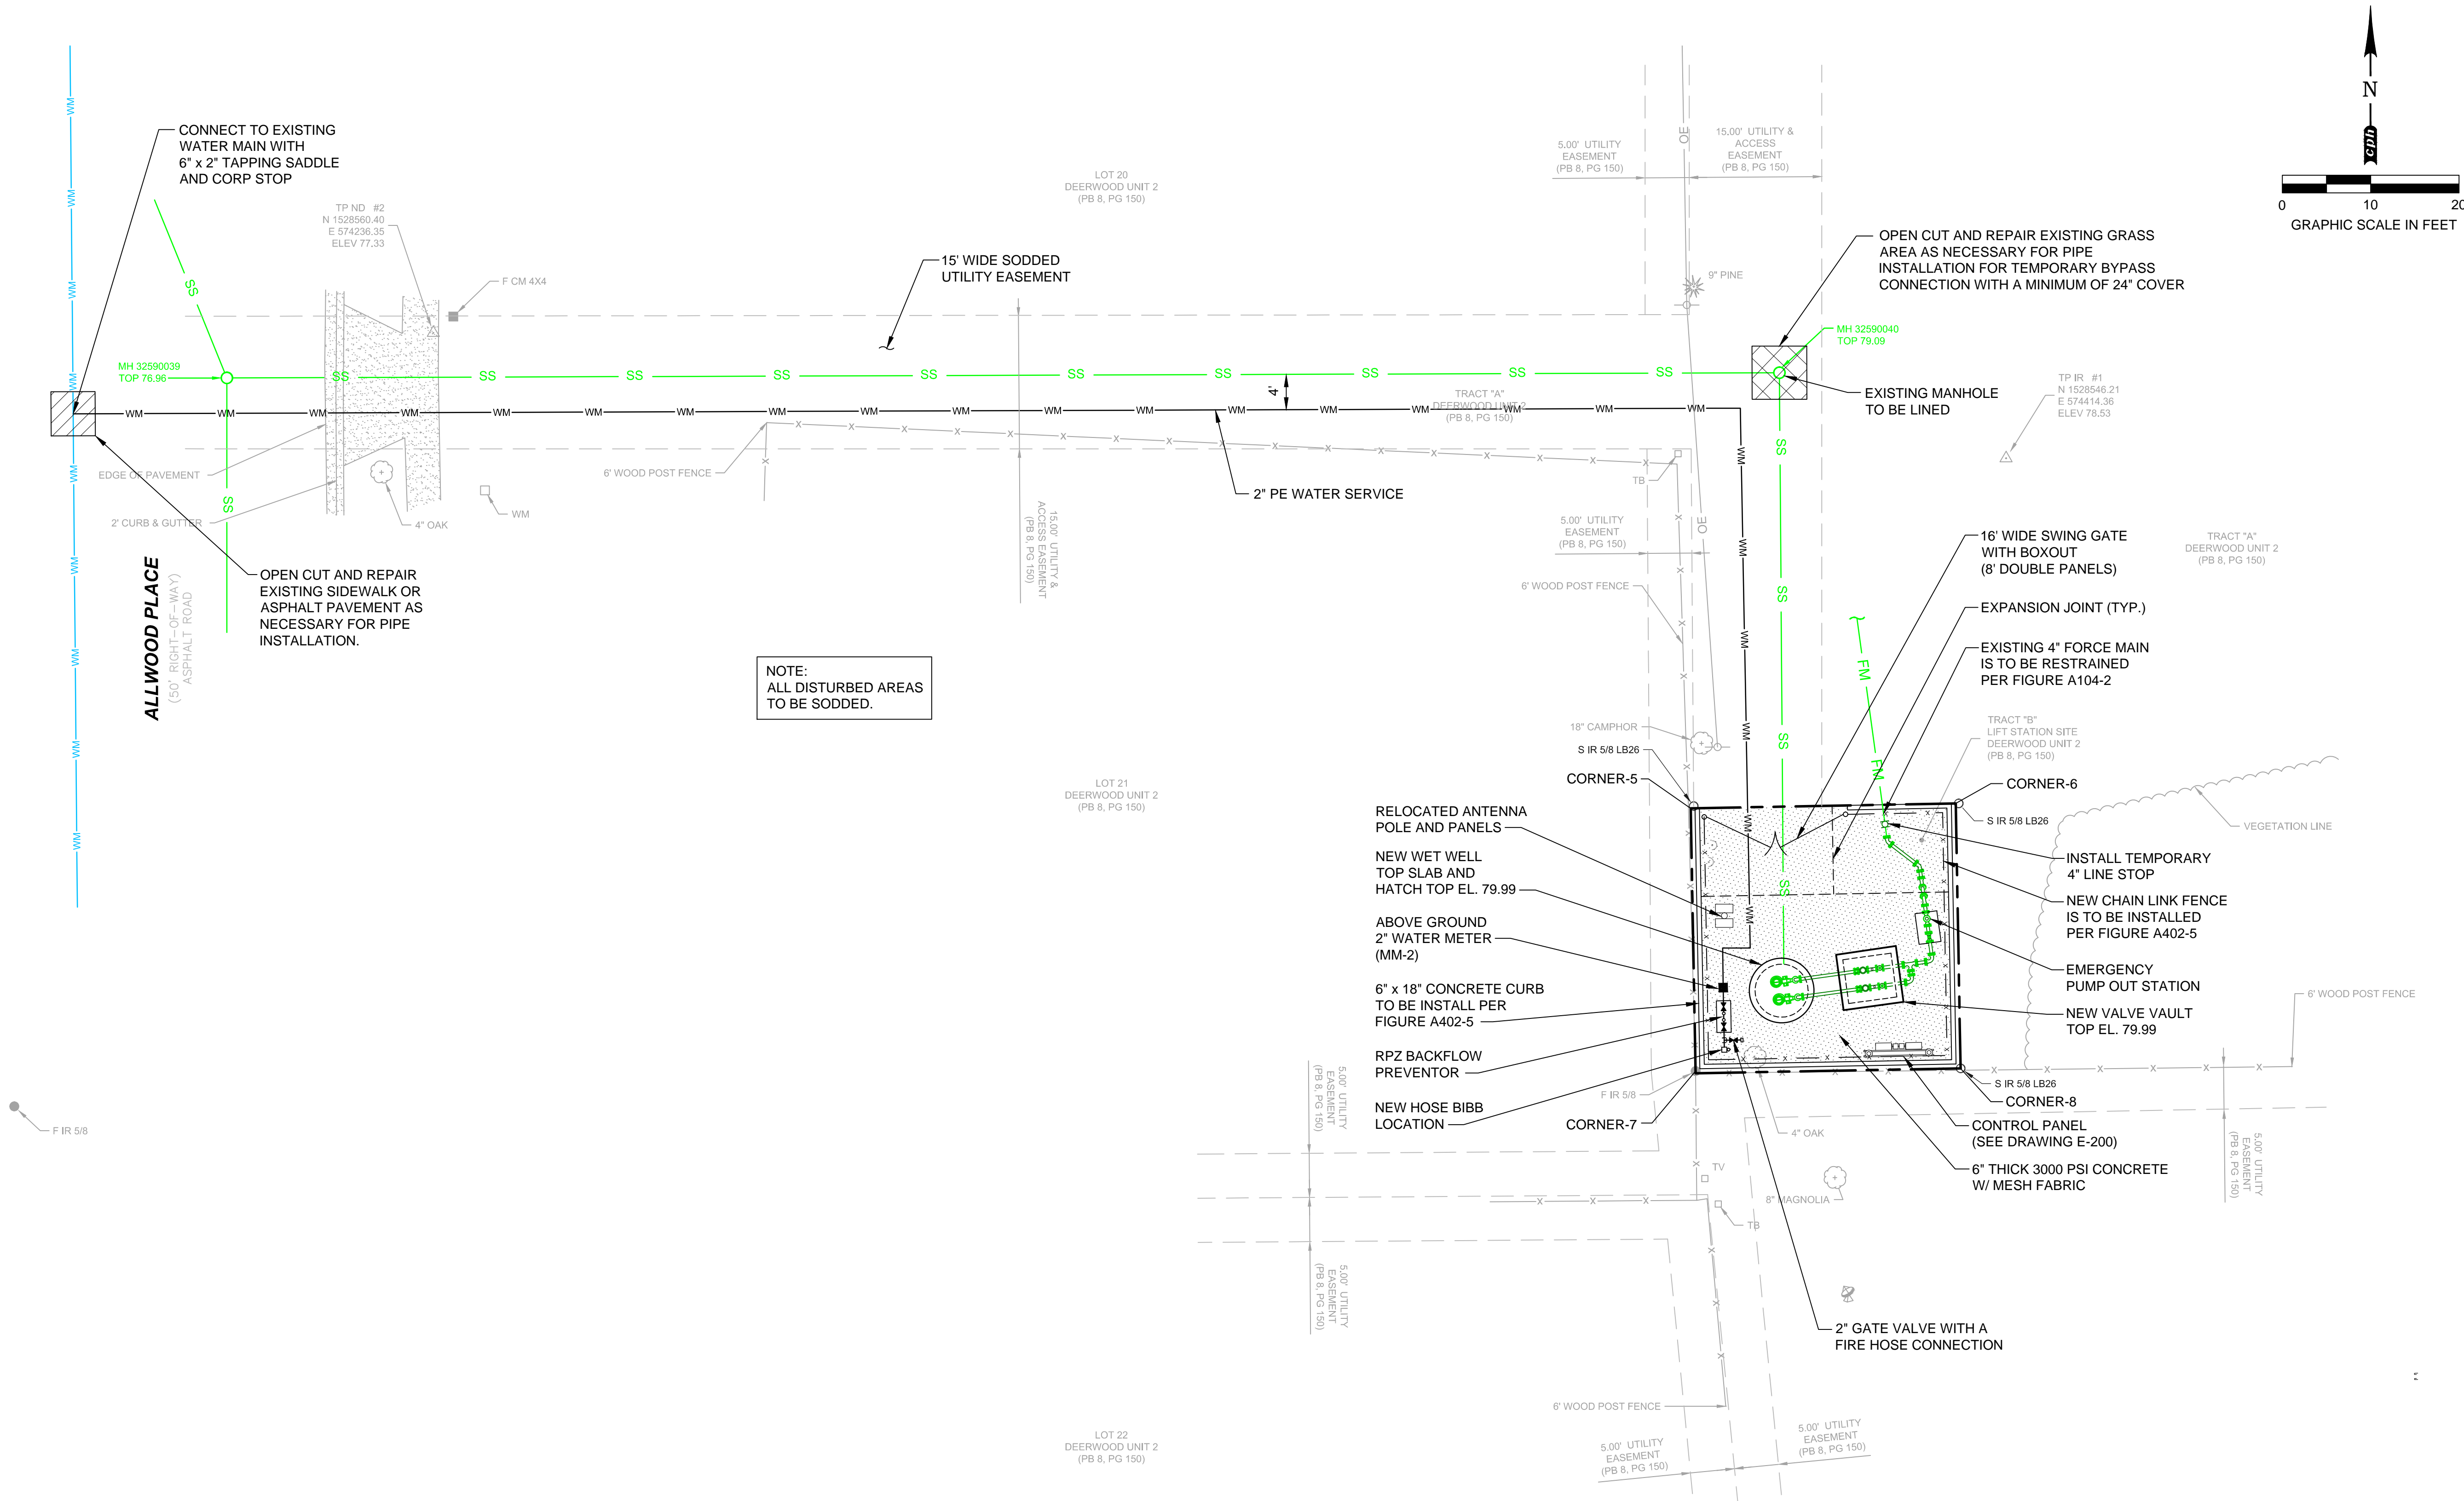
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Survey L.B. No. 7143
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Lndscp. Lic. No. LC0000298

P.S. # 3259 ALLWOOD PLACE
DEMOLITION SITE PLAN

SCOTT A. BREITENSTEIN
PROFESSIONAL ENGINEER
FLORIDA LICENSE #57402

OCU FILE NO.: 74325
DESIGNED BY: SAB
DRAWN BY: DGH/GCM
CHECKED BY: SAB/DEM
CADD FILE: PS 3259 Site Plan.dwg

SCALE: 1" = 10'
DRAWING NO. :
C200
SHEET: 11 OF 40



REV	DATE	DESCRIPTION

LINE IS 2 INCHES
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Arch. Lic. No. AA2600926
Lndscp. Lic. No. LC0000298


P.S. # 3259 ALLWOOD PLACE
SITE PLAN

SCOTT A. BREITENSTEIN
PROFESSIONAL ENGINEER
FLORIDA LICENSE #57402

OCU FILE NO.: 74325
DESIGNED BY: SAB
DRAWN BY: DGH/GCM
CHECKED BY: SAB/DEM
CADD FILE: PS 3259 Site Plan.dwg

SCALE: 1" = 10'
DRAWING NO. :
C201
SHEET: 12 OF 40

BID DRAWING

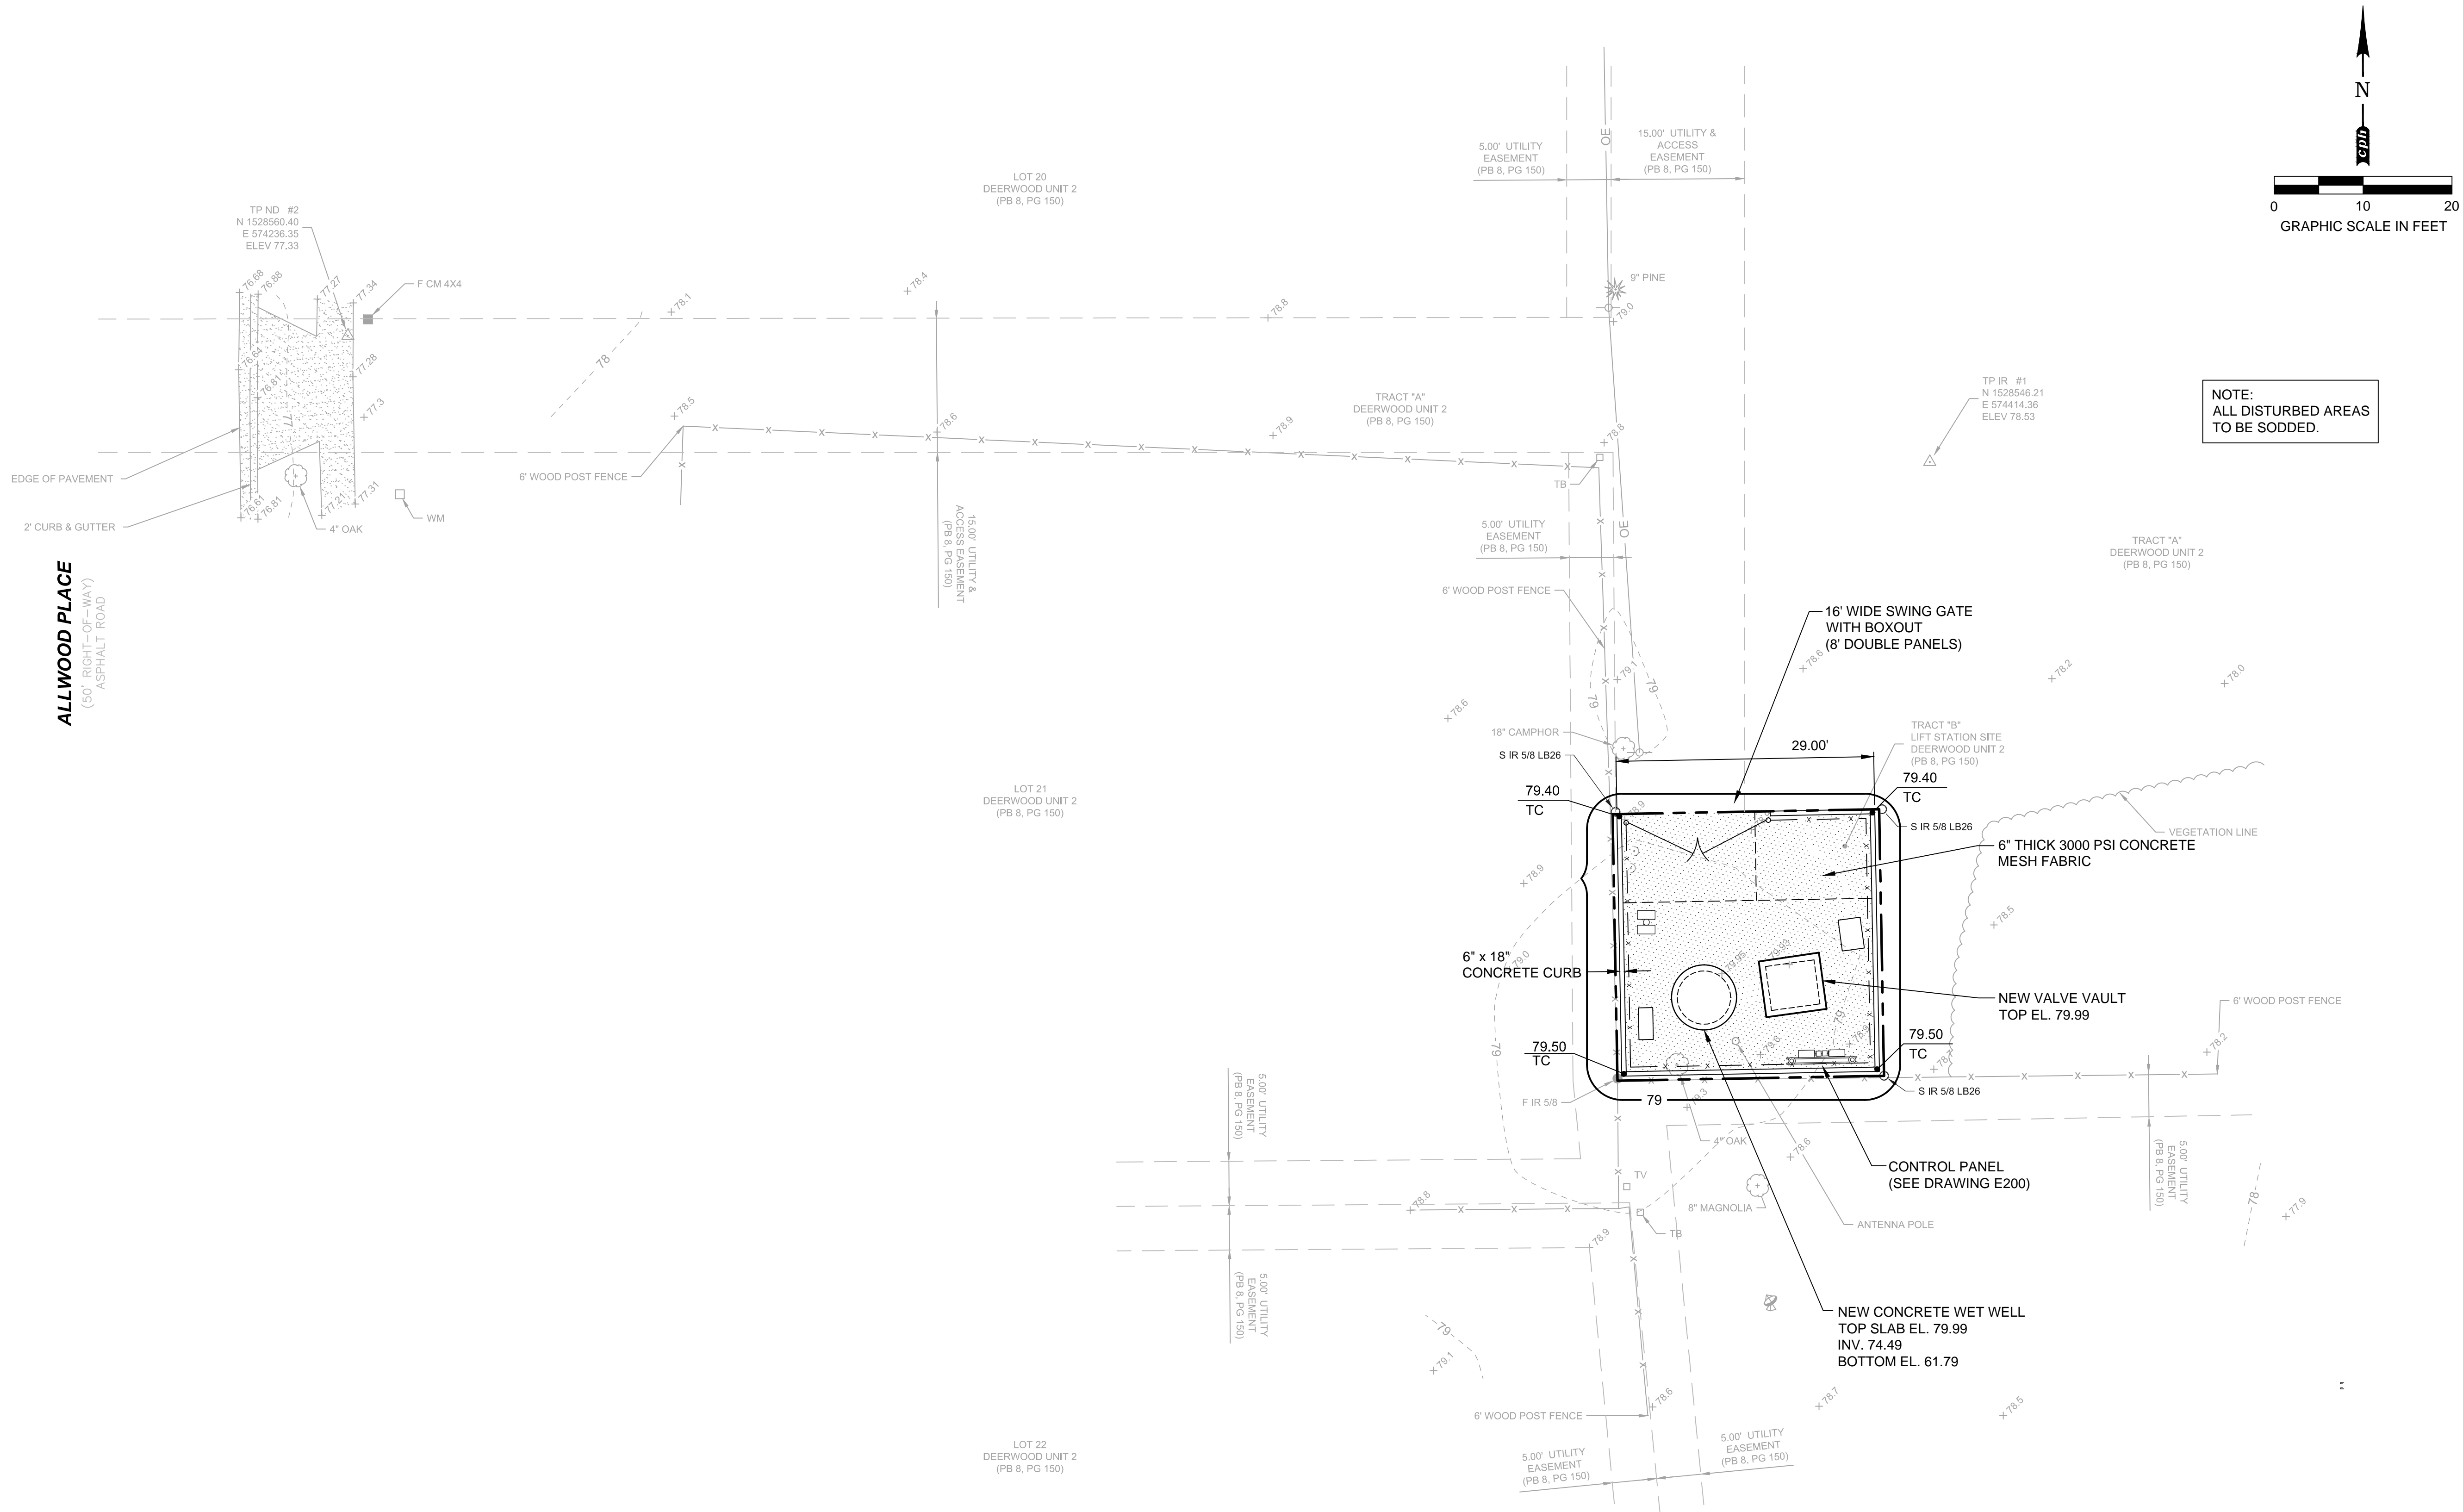

NOTE:
ALL DISTURBED AREAS
TO BE SODDED.

REV	DATE	DESCRIPTION

LINE IS 2 INCHES
AT FULL SIZE
(IF NOT SCALE ACCORDINGLY)

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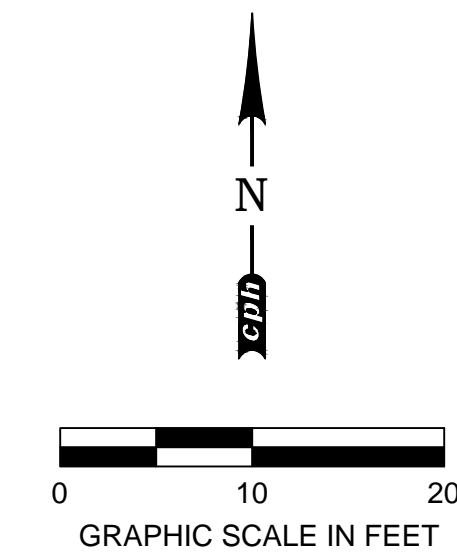
P.S. # 3259 ALLWOOD PLACE
SITE GRADING PLAN

OCU FILE NO.: 74325
DESIGNED BY: SAB
DRAWN BY: DGH/GCM
CHECKED BY: SAB/DEM
CADD FILE: PS 3259 Site Plan.dwg

SCOTT A. BREITENSTEIN
PROFESSIONAL ENGINEER
FLORIDA LICENSE #57402


SCALE: 1" = 10'
DRAWING NO. :
C202
SHEET: 13 OF 40

BID DRAWING



 DENOTES ITEMS TO BE REMOVED
AND / OR DEMOLISHED

 DENOTES TREES TO BE REMOVED

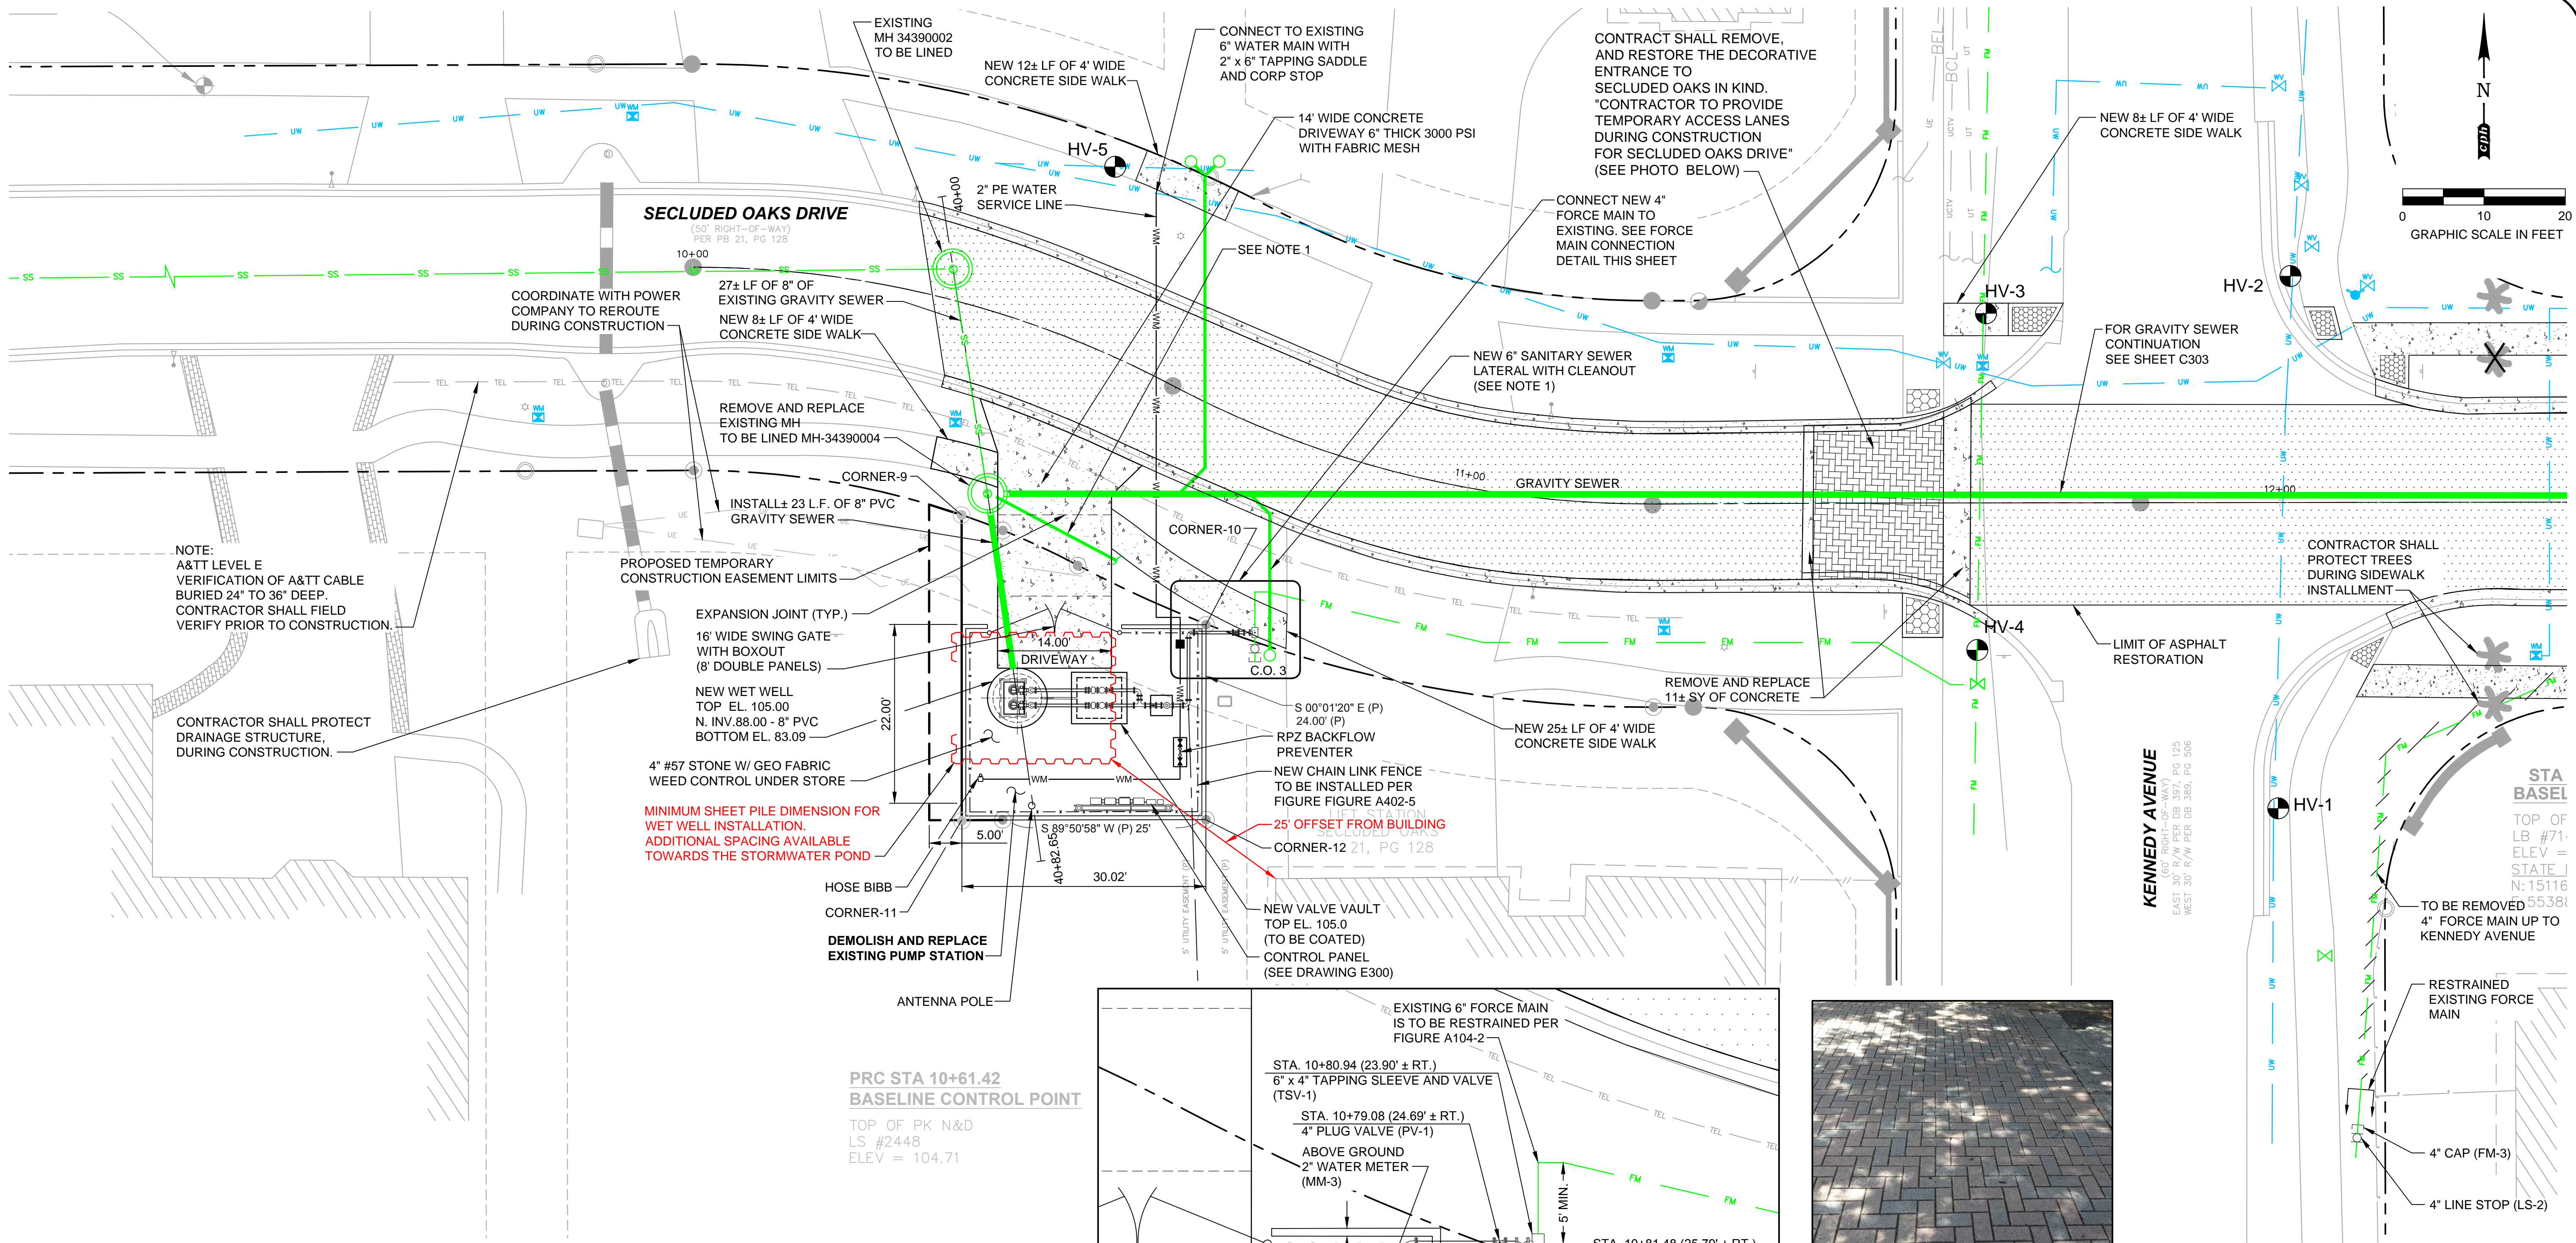

TEST HOLE DATA:

LOCATION ID	HORIZONTAL COORDINATES	ELEVATION	UTILITY	SIZE & MATERIAL
		GROUND	TOP OF UTILITY	
HV-1	N 1511645 E 553899	105.8	101.4	ORANGE COUNTY 16-1/2" (OD) METAL
HV-2	N 1511710 E 553901	105.2	99.4	ORANGE COUNTY 16-1/2" (OD) METAL
HV-3	N 1511705 E 553863	105.7	101.7	ORANGE COUNTY 4-1/2" (OD) PVC
HV-4	N 1511654 E 553862	105.6	102.2	ORANGE COUNTY 4-1/2" (OD) PVC
HV-5	N 1511724 E 553756	105.0	100.9	ORANGE COUNTY 8-1/2" (OD) PVC

NOTE: TEST HOLE INFORMATION WAS PROVIDED BY A SUBCONSULTANT
SEE THIS SHEET FOR LOCATIONS OF VHM-TEST HOLE NUMBER

NOTES:

1. ESTIMATED LOCATION OF 6" SERVICE LATERAL AND CLEANOUT. CONTRACTOR TO PROVIDE TEMPORARY BY-PASS PUMPING TO EXISTING PUMP STATION DURING CONSTRUCTION AND CONNECT NEW CLEANOUT AND LATERAL TO NEW 8-INCH GRAVITY MAIN.
2. DEMOLISH AND REPLACE EXISTING PUMP STATION.
3. CONTRACTOR TO KEEP THE SITE CLEAN AND ANY DEBRIS FROM CONSTRUCTION ACTIVITIES SHALL BE KEPT AWAY FROM THE POND AND INLETS.
4. AT&T PROVIDED LEVEL E VERIFICATION OF BURIED CABLE LINE APPROXIMATE 24" - 36" DEEP.

FORCE MAIN CONNECTION DETAIL - PS # 3439

SCALE: 1" = 5'

REV	DATE	DESCRIPTION

LINE IS 2 INCHES
AT FULL SIZE
(IF NOT SCALE ACCORDINGLY)



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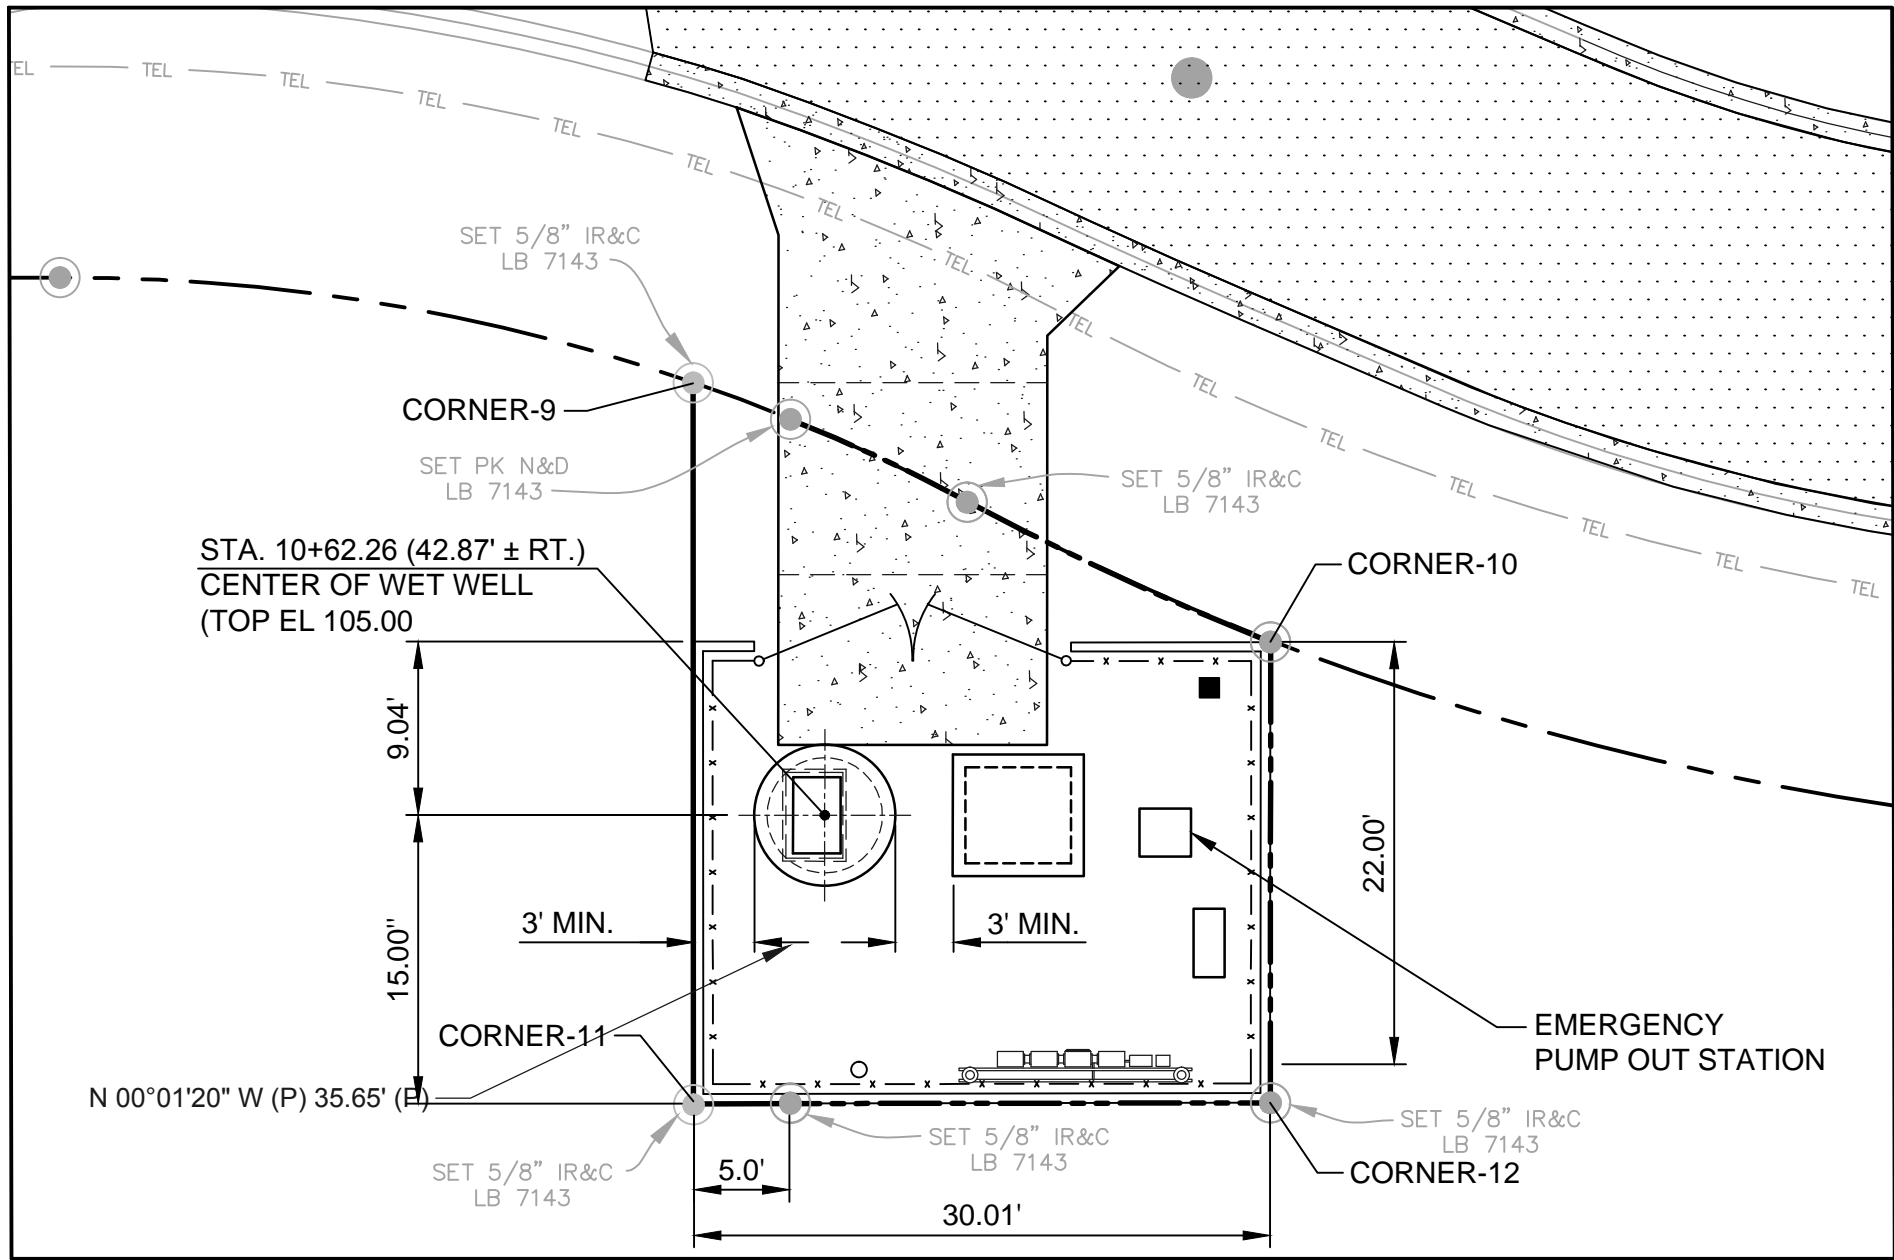
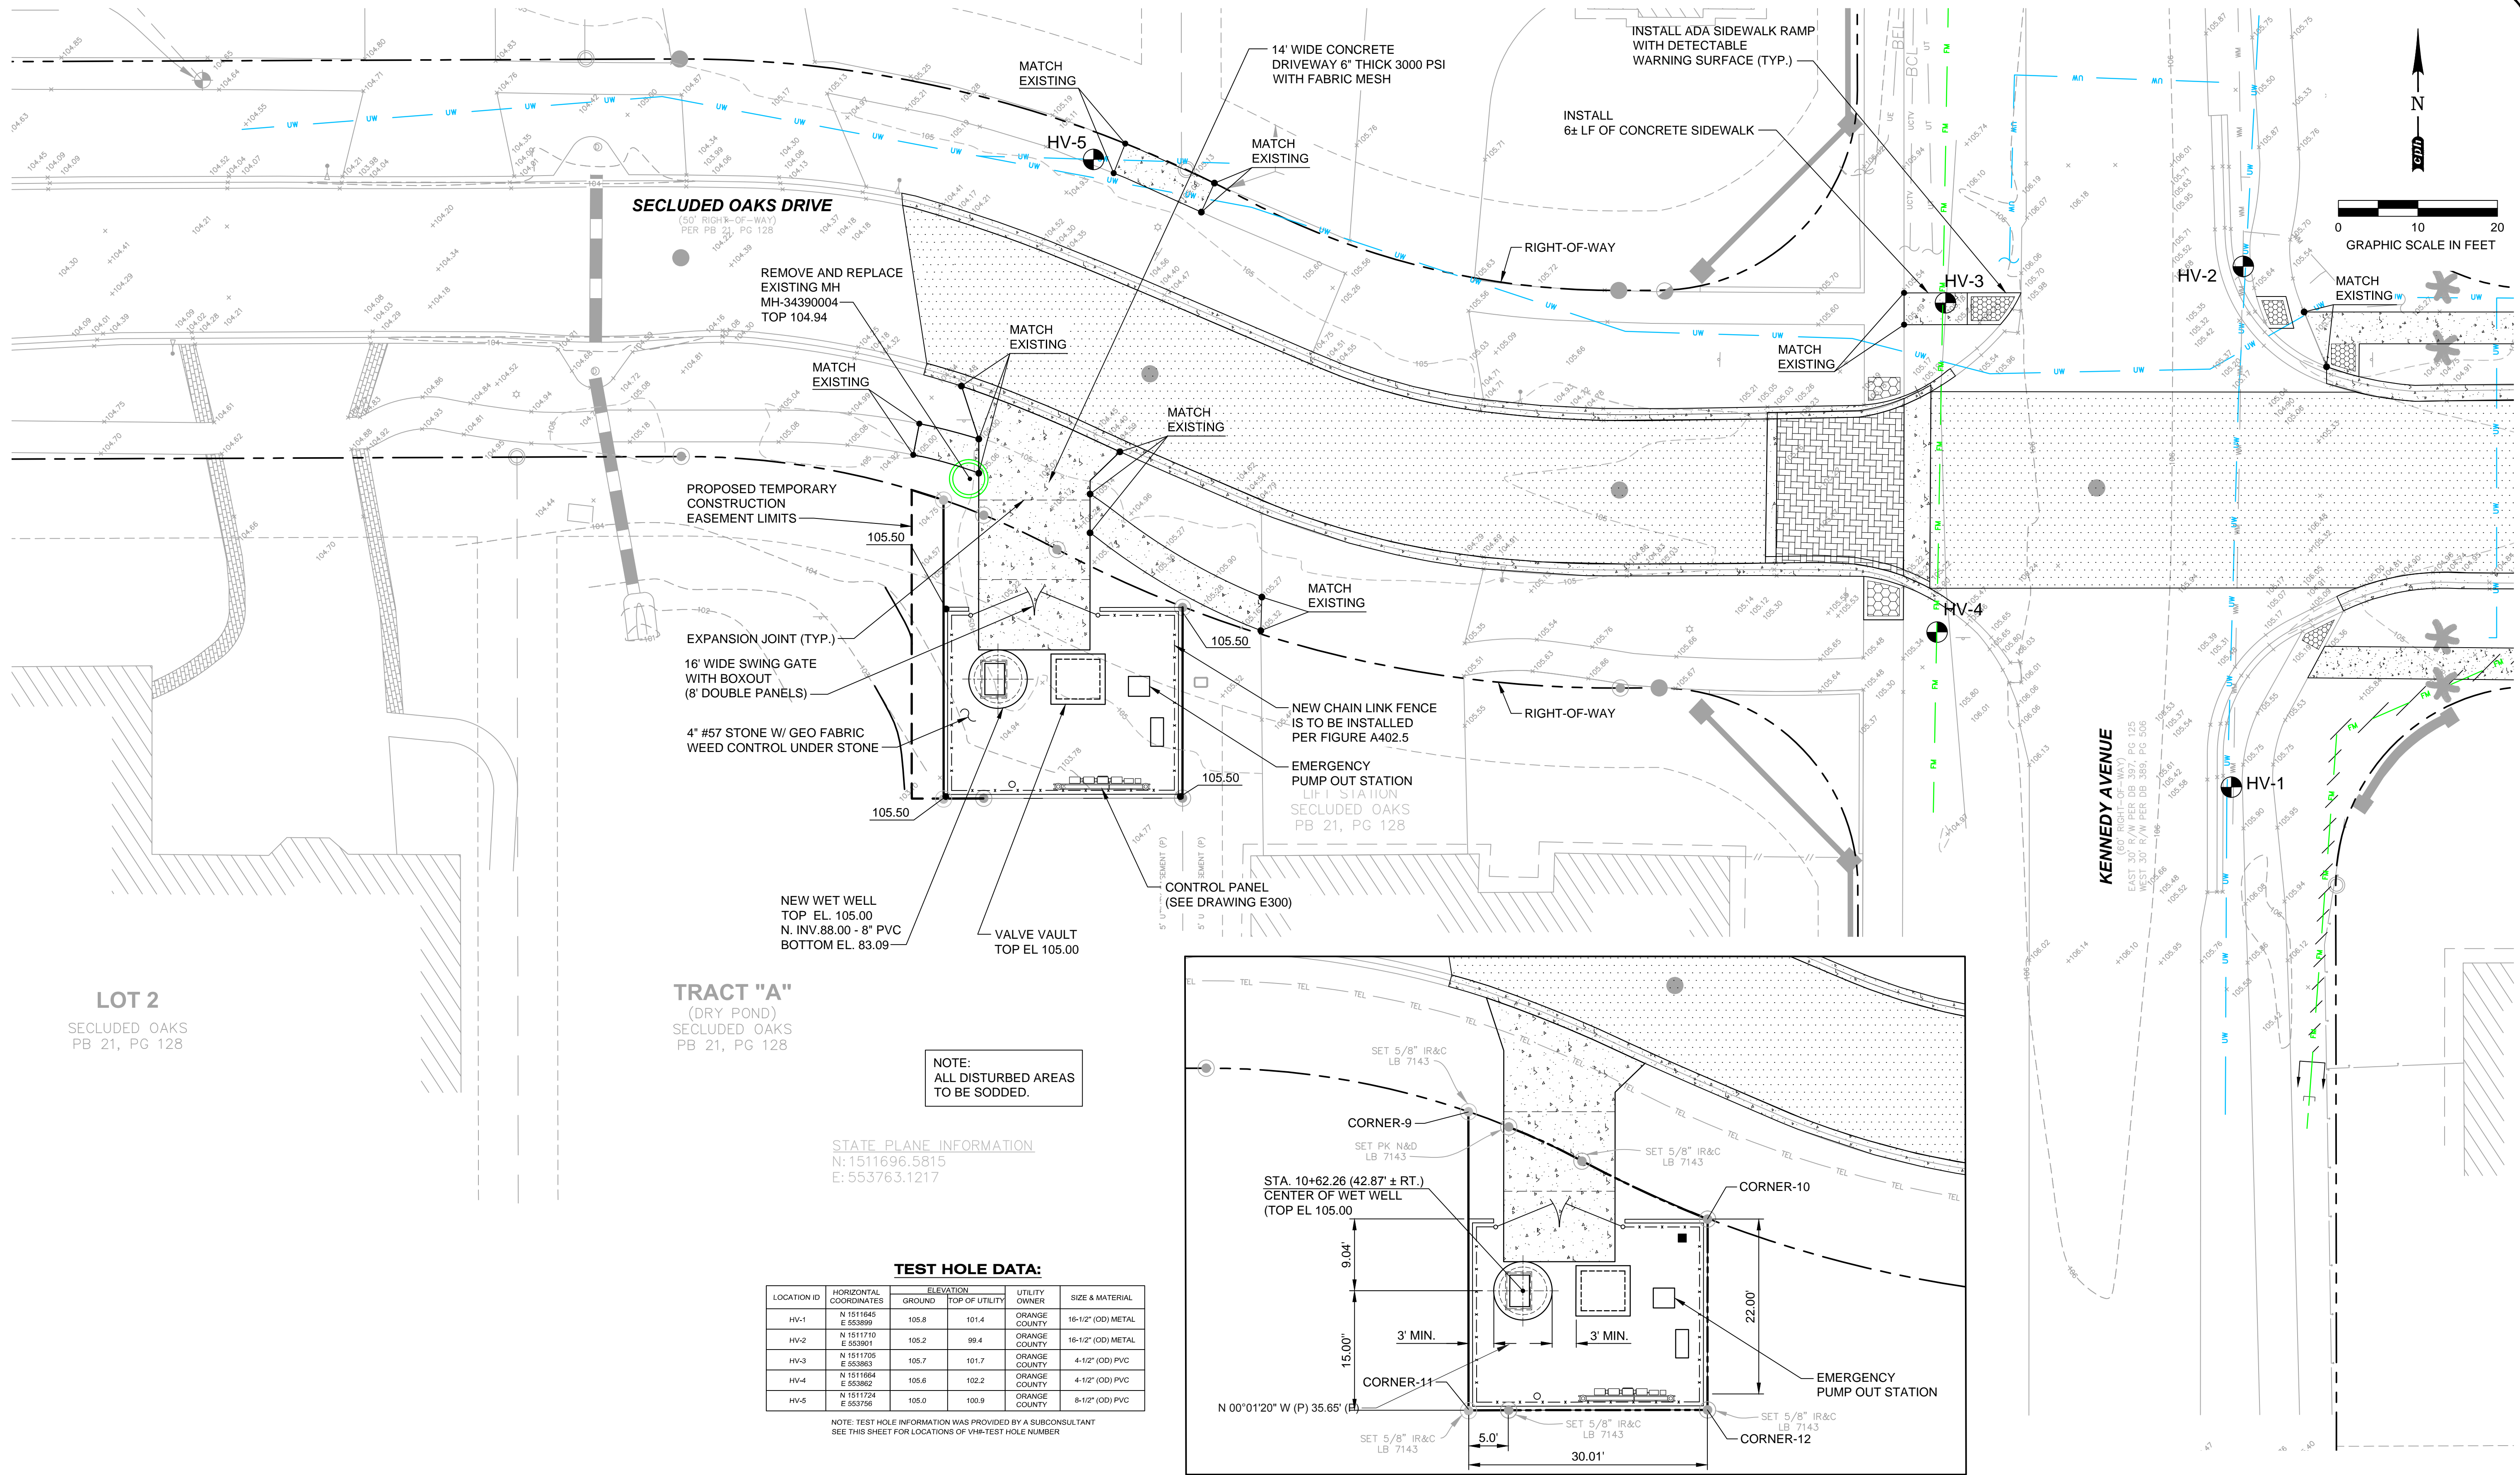
Licenses:
Eng. C.O.A. No. 3215
Survey L.B. No. 7143
Arch. Lic. No. AA2600926
Landscape Lic. No. LC0000298

P.S. 3439 SECLUDED OAKS DRIVE
SITE PLAN

SCOTT A. BREITENSTEIN
PROFESSIONAL ENGINEER
FLORIDA LICENSE #57402

OCU FILE NO.: 74325
DESIGNED BY: SAB
DRAWN BY: DGH/GCM
CHECKED BY: SAB/DEM
CADD FILE: PS 3439 Site Plan.dwg

SCALE: 1" = 10'
DRAWING NO.:
C301
SHEET: 15 OF 40




TEST HOLE DATA:

LOCATION ID	HORIZONTAL COORDINATES	ELEVATION		UTILITY OWNER	SIZE & MATERIAL
		GROUND	TOP OF UTILITY		
HV-1	N 1511645 E 553899	105.8	101.4	ORANGE COUNTY	16-1/2\" (OD) METAL
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HV-3	N 1511705 E 553863	105.7	101.7	ORANGE COUNTY	4-1/2\" (OD) PVC
HV-4	N 1511664 E 553862	105.8	102.2	ORANGE COUNTY	4-1/2\" (OD) PVC
HV-5	N 1511724 E 553756	105.0	100.9	ORANGE COUNTY	8-1/2\" (OD) PVC

NOTE: TEST HOLE INFORMATION WAS PROVIDED BY A SUBCONSULTANT
SEE THIS SHEET FOR LOCATIONS OF VHM-TEST HOLE NUMBER

REV	DATE	DESCRIPTION

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(IF NOT SCALE ACCORDINGLY)



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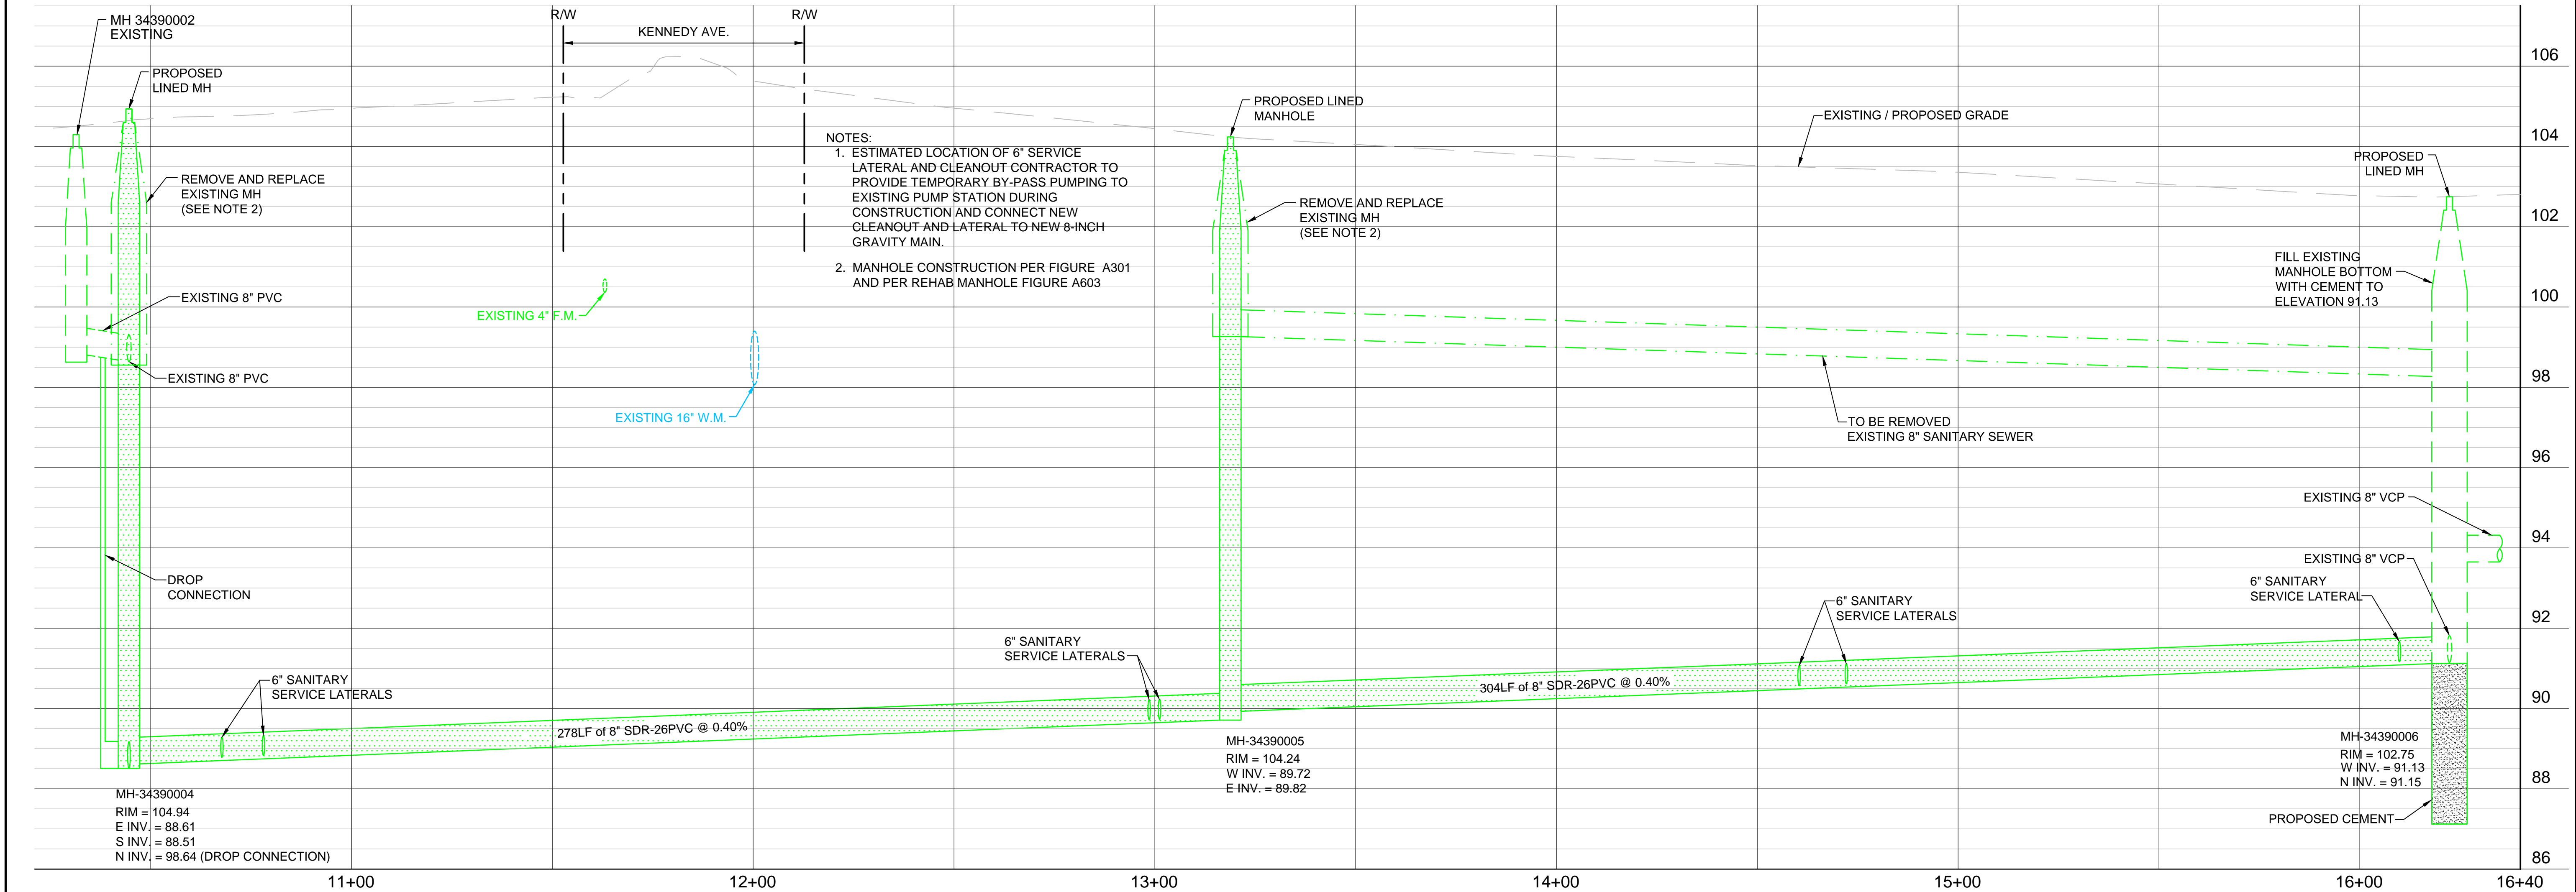
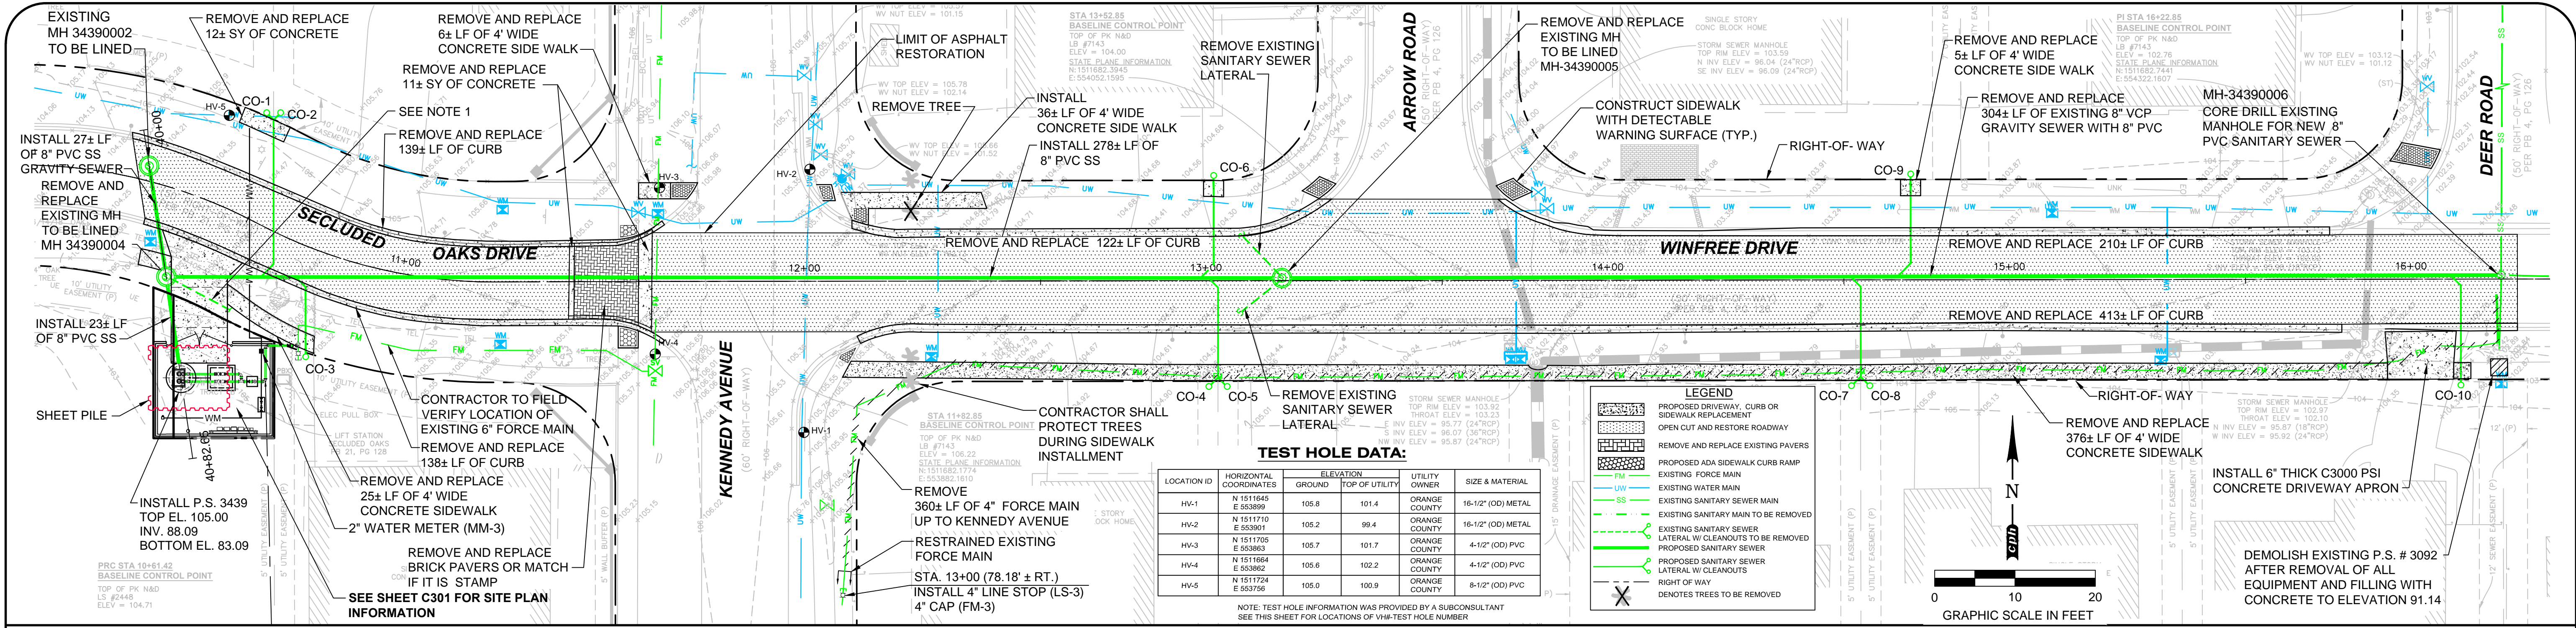
P.S. 3439 SECLUDED OAKS DRIVE
SITE GRADING PLAN

OCU FILE NO.: 74325
DESIGNED BY: SAB
DRAWN BY: DGH/GCM
CHECKED BY: SAB/DEM
CADD FILE: PS 3439 Site Plan.dwg

SCOTT A. BREITENSTEIN
PROFESSIONAL ENGINEER
FLORIDA LICENSE #57402

SCALE: 1" = 10'
DRAWING NO.:
C302
SHEET: 16 OF 40

BID DRAWING



REV	DATE	DESCRIPTION

LINE IS 2 INCHES AT FULL SIZE (IF NOT SCALE ACCORDINGLY)

ORANGE COUNTY UTILITIES DEPARTMENT ENGINEERING DIVISION

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Licenses: Eng. C.O.A. No. 3215 Survey L.B. No. 7143 Arch. Lic. No. AA2600926 Lndscp. Lic. No. LC0000298



P.S. # 3439 SECLUDED OAKS DRIVE GRAVITY MAIN IMPROVEMENTS PLAN AND PROFILE

OCU FILE NO.: 74325 DESIGNED BY: SAB DRAWN BY: DGH/GCM CHECKED BY: SAB/DEM CADD FILE: PS 3439 Site Plan.dwg


SCOTT A. BREITENSTEIN PROFESSIONAL ENGINEER FLORIDA LICENSE #57402

SCALE: 1" = 20' DRAWING NO.: C303 SHEET: 17 OF 40

BID DRAWING

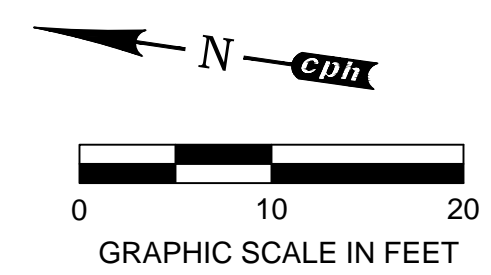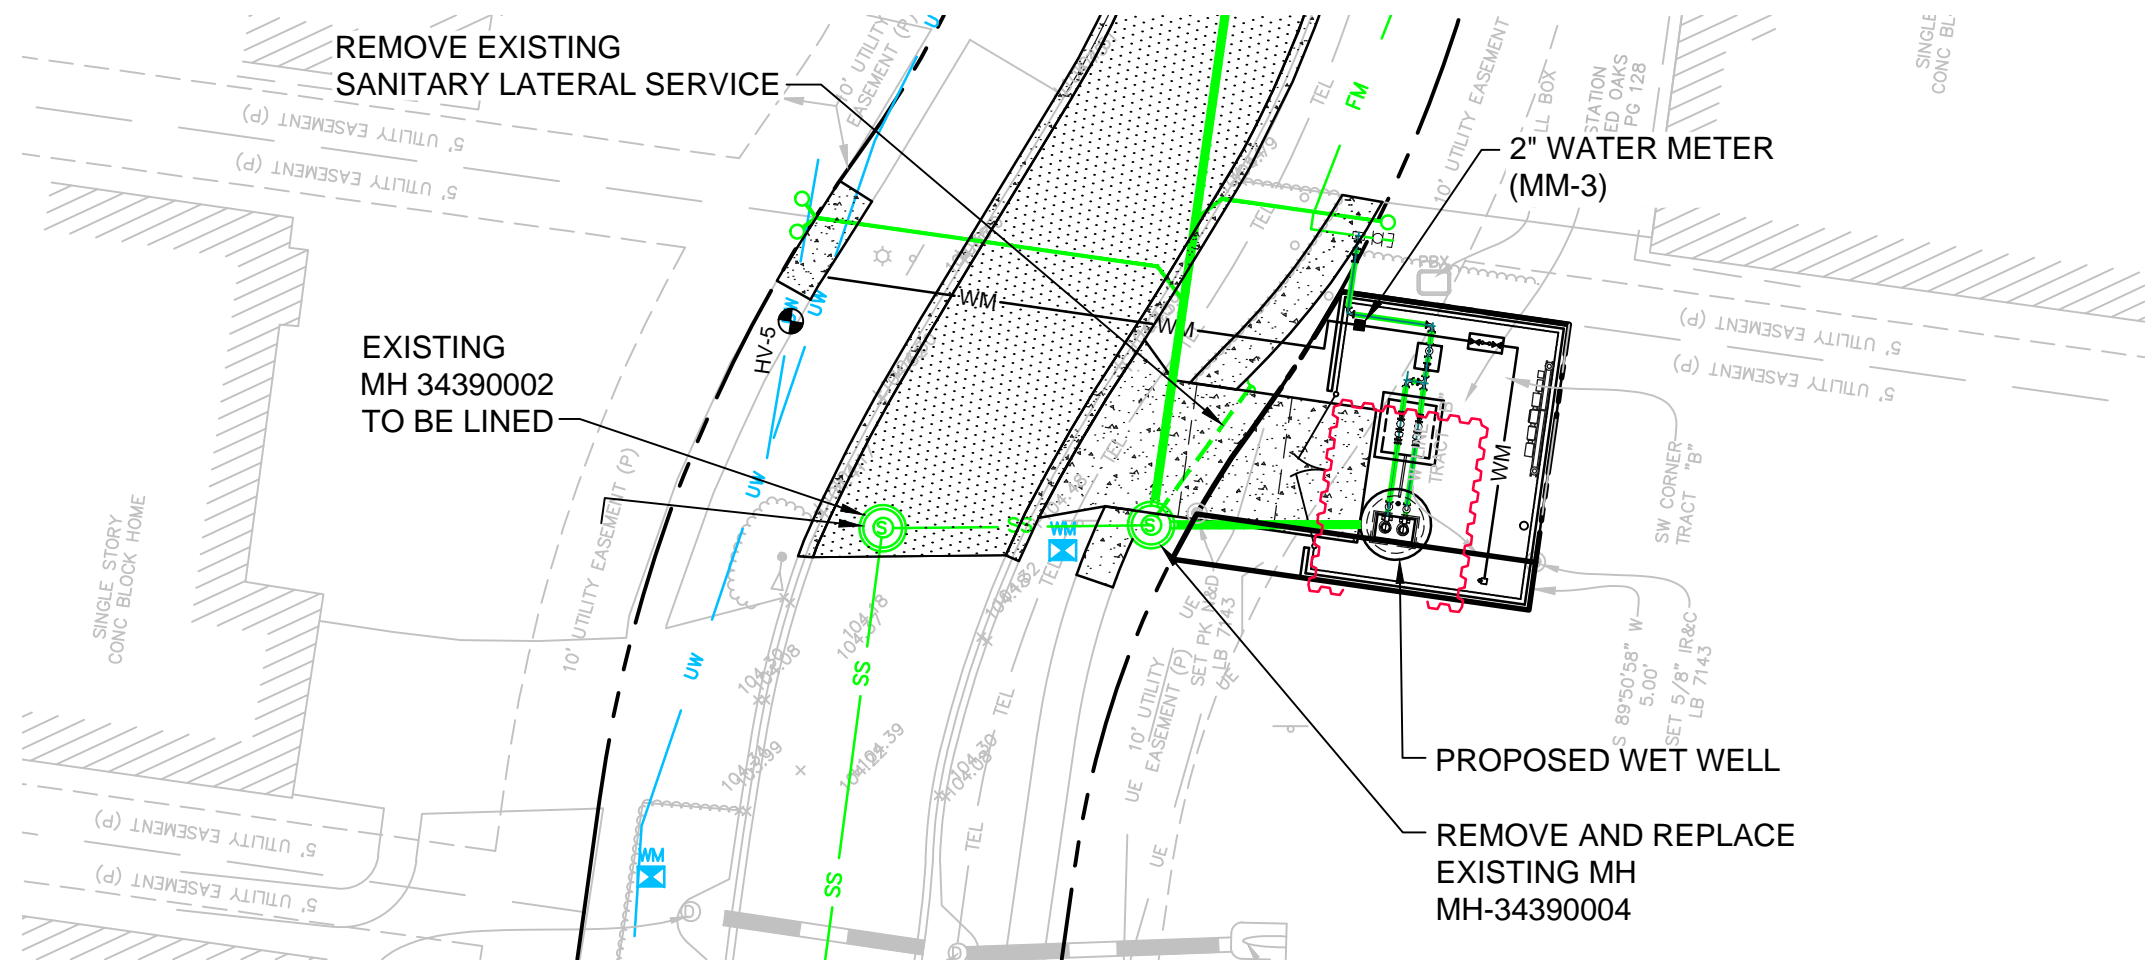

LEGEND	
	PROPOSED DRIVEWAY, CURB OR SIDEWALK REPLACEMENT
	OPEN CUT AND RESTORE ROADWAY
	REMOVE AND REPLACE EXISTING PAVERS
	PROPOSED ADA SIDEWALK CURB RAMP
	EXISTING FORCE MAIN
	EXISTING WATER MAIN
	EXISTING SANITARY SEWER MAIN
	EXISTING SANITARY MAIN TO BE REMOVED
	EXISTING SANITARY SEWER LATERAL W/ CLEANOUTS TO BE REMOVED
	PROPOSED SANITARY SEWER
	PROPOSED SANITARY SEWER LATERAL W/ CLEANOUTS
	RIGHT OF WAY
	DENOTES TREES TO BE REMOVED

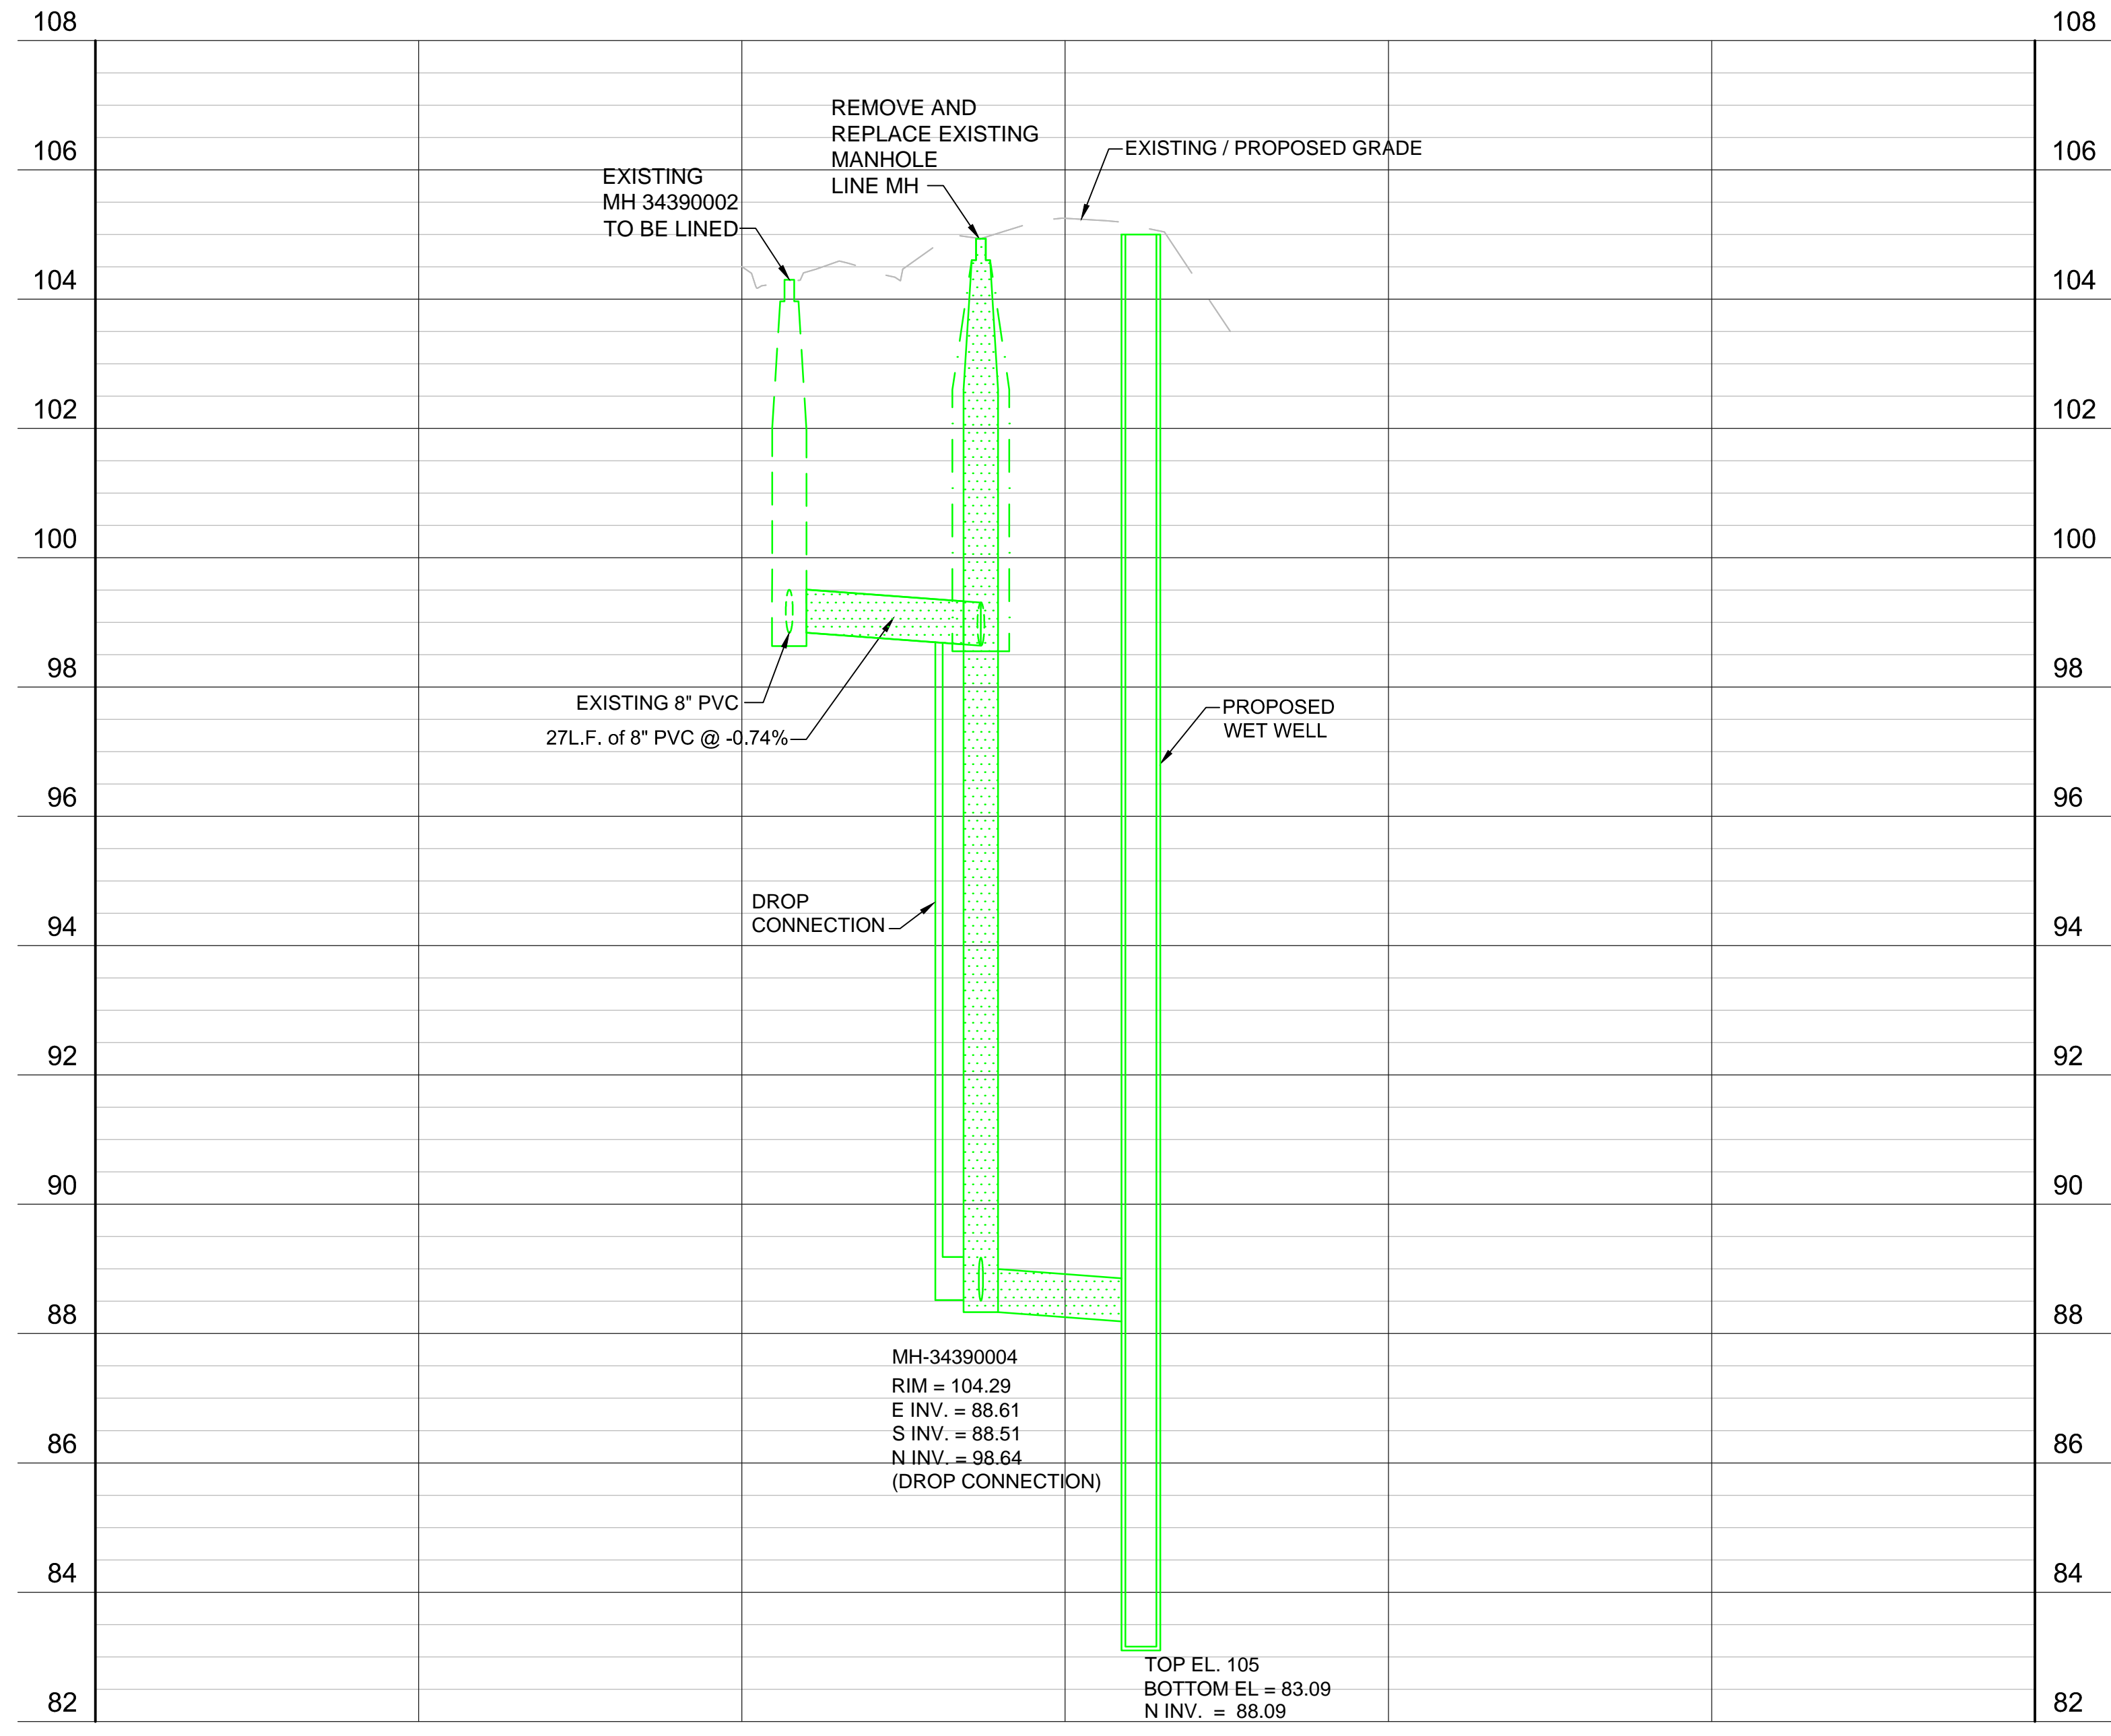

REV	DATE	DESCRIPTION

LINE IS 2 INCHES
AT FULL SIZE
(IF NOT SCALE ACCORDINGLY)

ORANGE COUNTY UTILITIES DEPARTMENT ENGINEERING DIVISION
9150 CURRY FORD ROAD ORLANDO, FL. 32825

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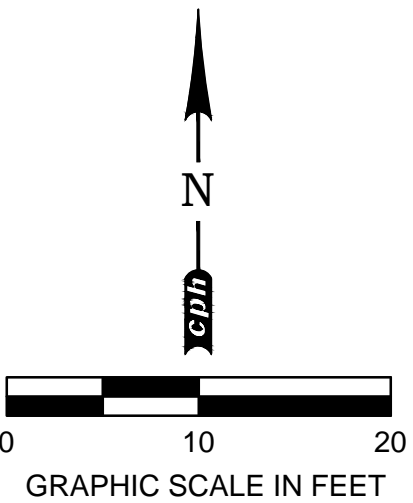
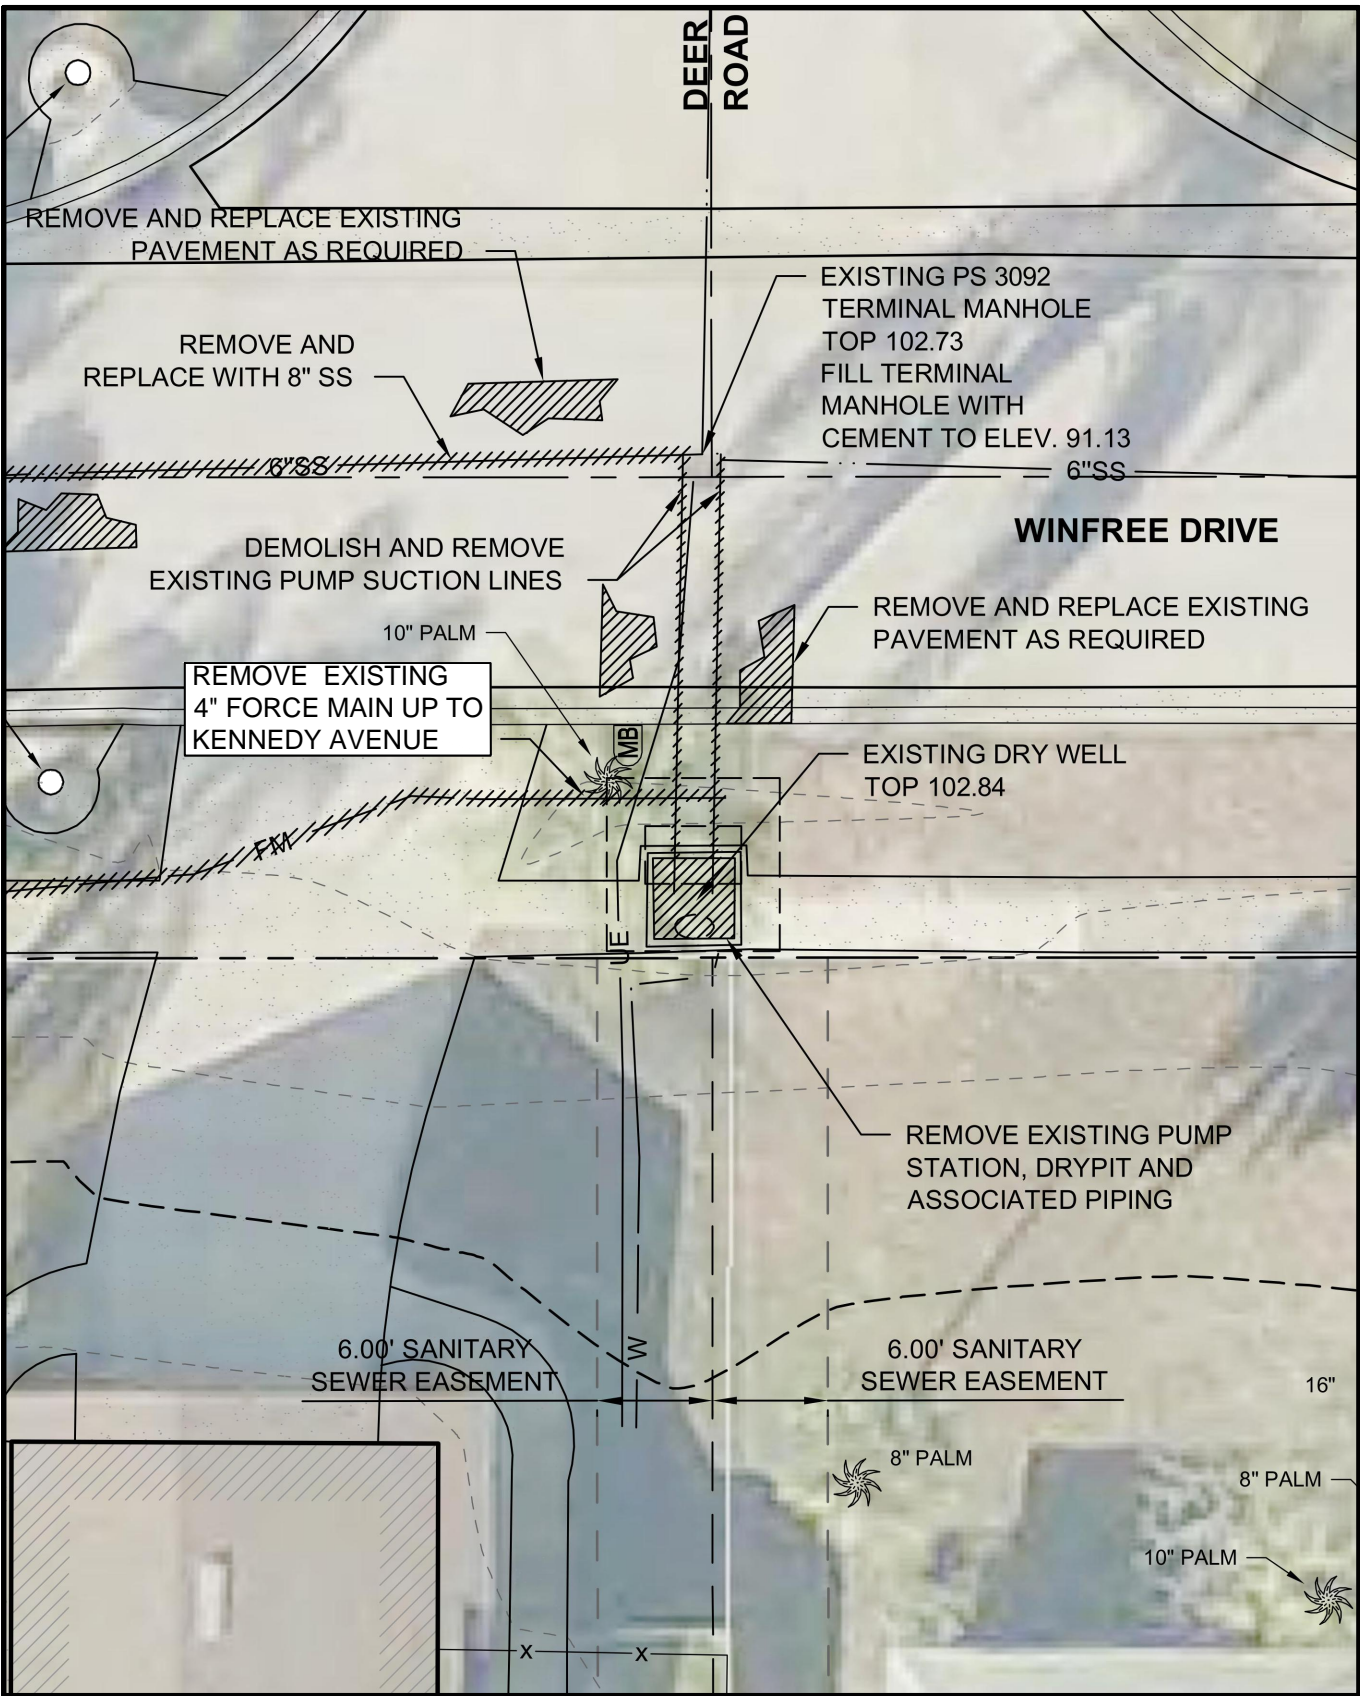
Licenses:
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Survey L.B. No. 7143
Arch. Lic. No. AA2600926
Landscape Lic. No. LC0000298

P.S. # 3439 SECLUDED OAKS DRIVE GRAVITY MAIN IMPROVEMENTS PLAN AND PROFILE

OCU FILE NO.: 74325	SCALE: 1" = 20'
DESIGNED BY: SAB	DRAWING NO. : C304
DRAWN BY: DGH/GCM	SHEET: 18 OF 40
CHECKED BY: SAB/DEM	
CADD FILE: PS 3439 Site Plan.dwg	

SCOTT A. BREITENSTEIN
PROFESSIONAL ENGINEER
FLORIDA LICENSE #57402

BID DRAWING



EXISTING SITE PIPING PLAN



DRY WELL AND TERMINAL MANHOLE



EXISTING PUMPS AND PIPING

REV	DATE	DESCRIPTION

LINE IS 2 INCHES
AT FULL SIZE
(IF NOT SCALE ACCORDINGLY)



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9150 CURRY FORD ROAD ORLANDO, FL. 32825



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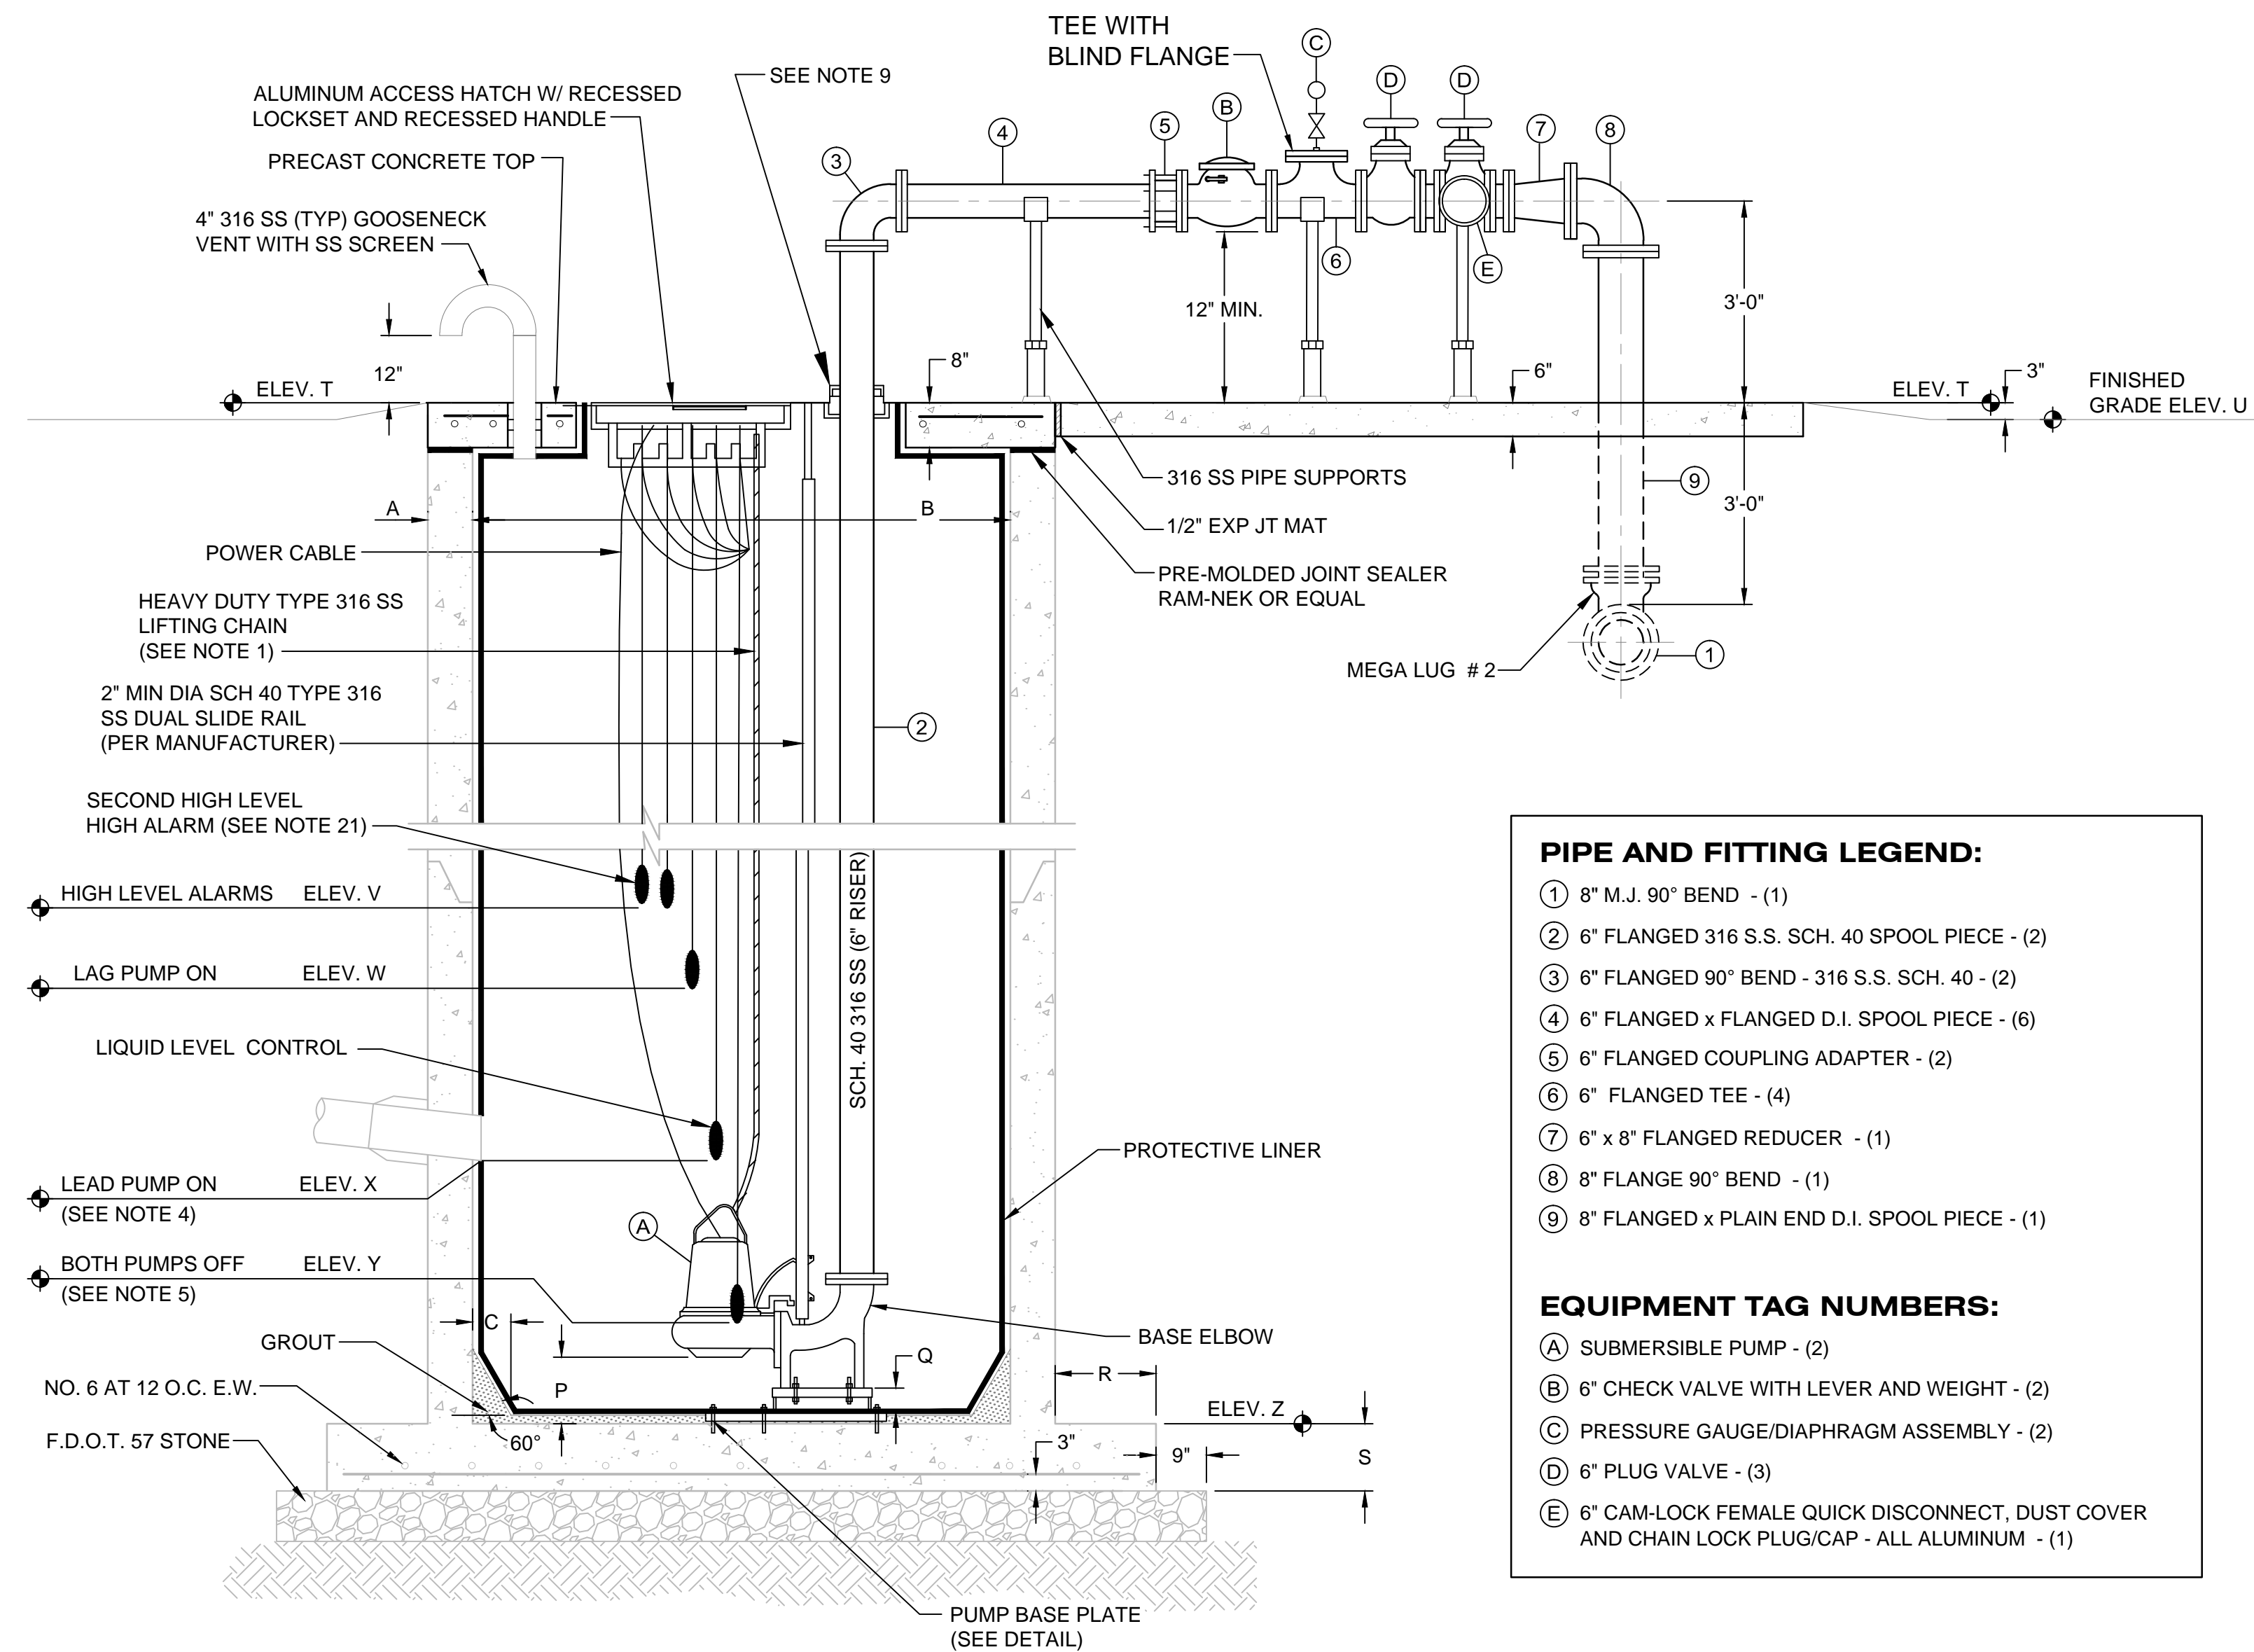
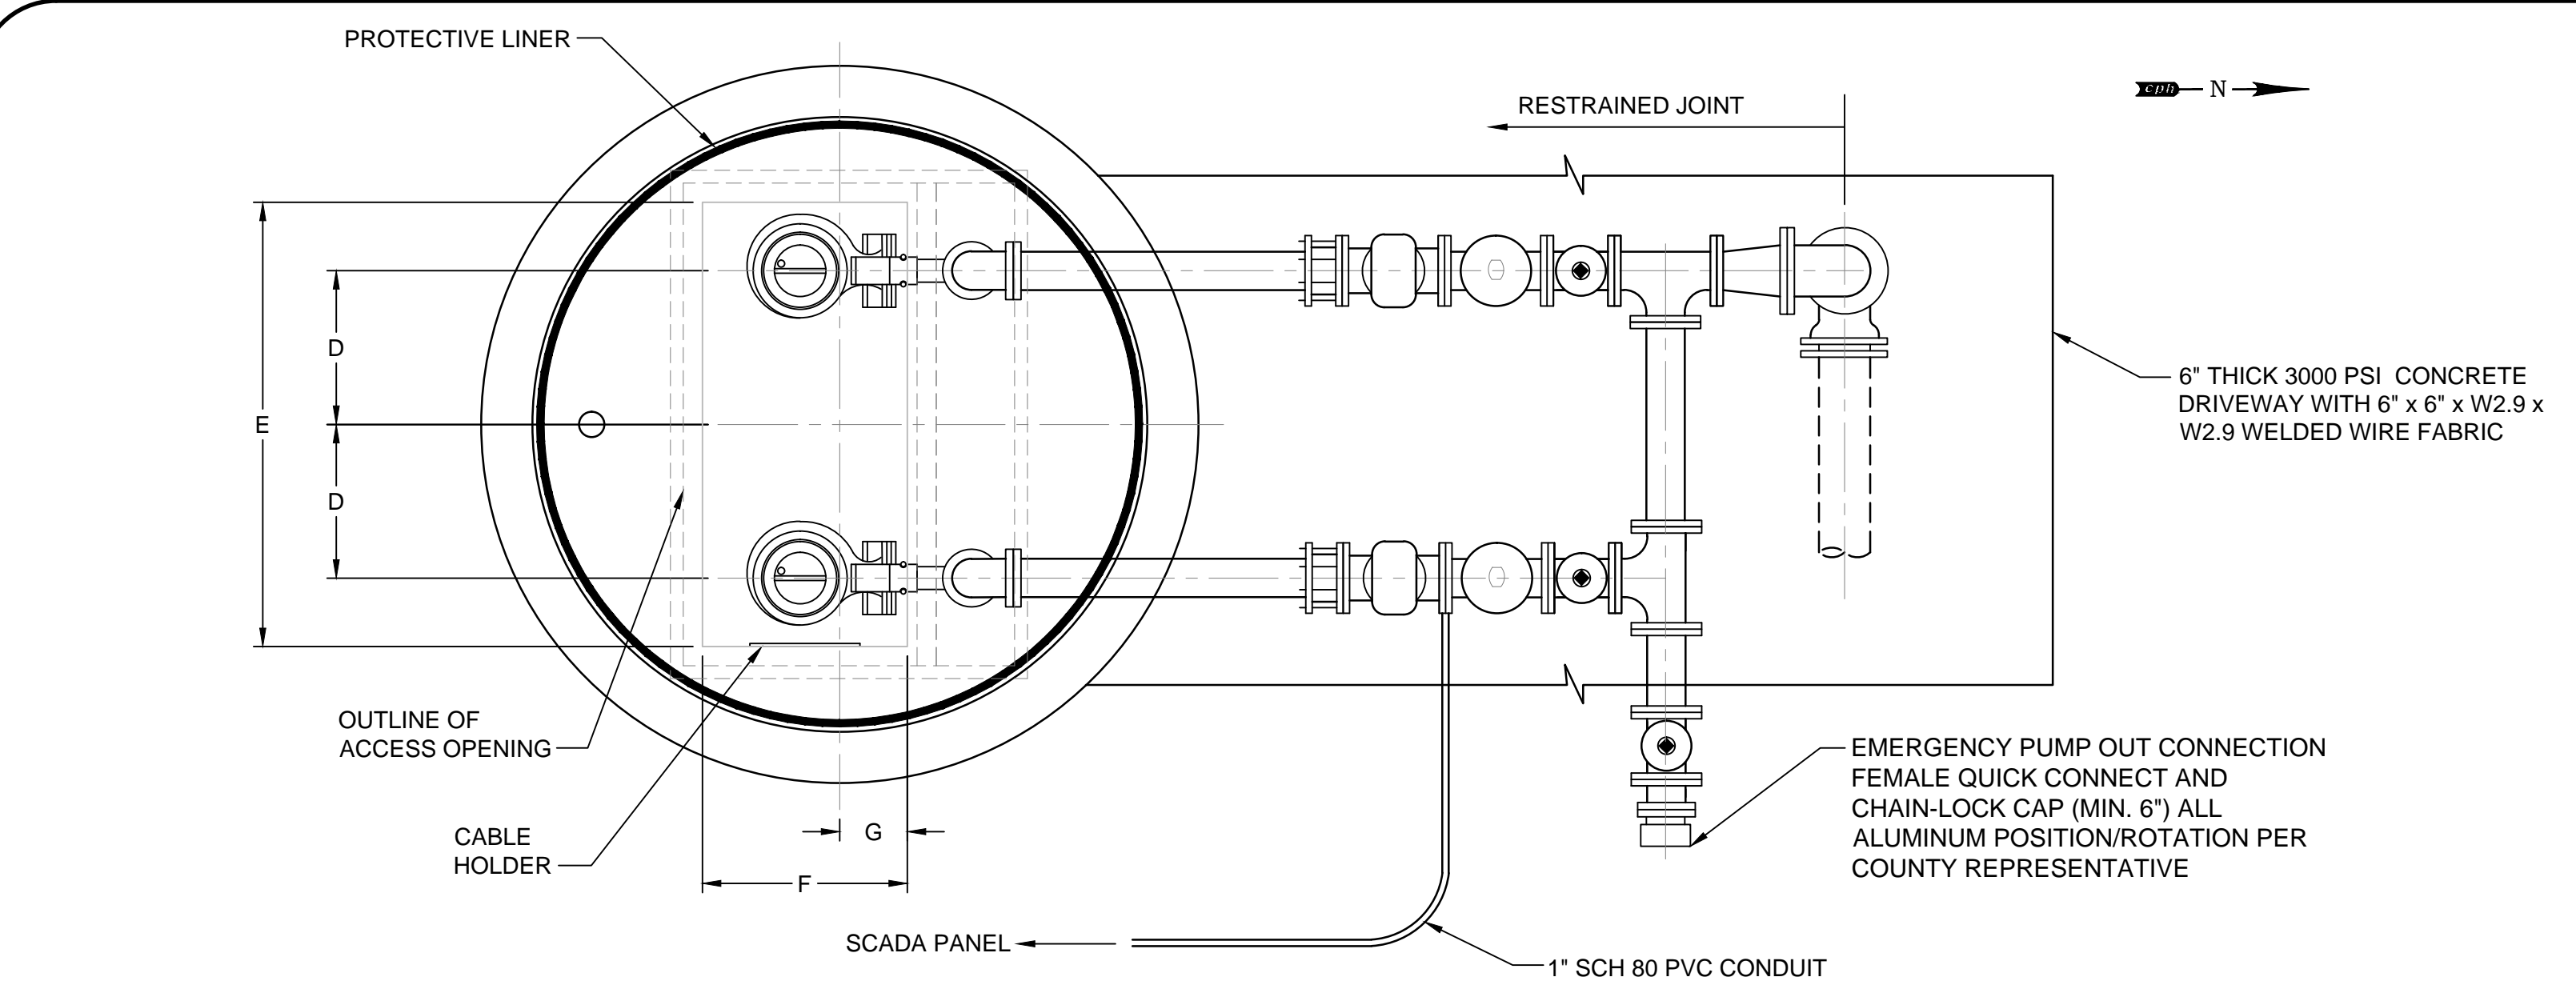
Licenses:
Eng. C.O.A. No. 3215
Survey L.B. No. 7143
Arch. Lic. No. AA260926
Lndscp. Lic. No. LC0000298

P.S. # 3092 WINFREE DRIVE
DEMOLITION SITE PLAN

SCOTT A. BREITENSTEIN
PROFESSIONAL ENGINEER
FLORIDA LICENSE #57402

OCU FILE NO.: 74325
DESIGNED BY: SAB
DRAWN BY: DGH/GCM
CHECKED BY: SAB/DEM
CADD FILE: PS 3092 Site Plan.dwg

SCALE: 1" = 10'
DRAWING NO. :
C400
SHEET: 19 OF 40



- PIPE AND FITTING LEGEND:**
- ① 8" M.J. 90° BEND - (1)
 - ② 6" FLANGED 316 S.S. SCH. 40 SPOOL PIECE - (2)
 - ③ 6" FLANGED 90° BEND - 316 S.S. SCH. 40 - (2)
 - ④ 6" FLANGED x FLANGED D.I. SPOOL PIECE - (6)
 - ⑤ 6" FLANGED COUPLING ADAPTER - (2)
 - ⑥ 6" FLANGED TEE - (4)
 - ⑦ 6" x 8" FLANGED REDUCER - (1)
 - ⑧ 8" FLANGE 90° BEND - (1)
 - ⑨ 8" FLANGED x PLAIN END D.I. SPOOL PIECE - (1)
- EQUIPMENT TAG NUMBERS:**
- (A) SUBMERSIBLE PUMP - (2)
 - (B) 6" CHECK VALVE WITH LEVER AND WEIGHT - (2)
 - (C) PRESSURE GAUGE/DIAPHRAGM ASSEMBLY - (2)
 - (D) 6" PLUG VALVE - (3)
 - (E) 6" CAM-LOCK FEMALE QUICK DISCONNECT, DUST COVER AND CHAIN LOCK PLUG/CAP - ALL ALUMINUM - (1)

- GENERAL NOTES:**
- ALL MATERIALS AND CONSTRUCTION SHALL BE IN ACCORDANCE WITH THE ORANGE COUNTY UTILITIES STANDARDS AND SPECIFICATIONS MANUAL (LATEST EDITION), AND/OR AS SPECIFIED HEREIN.
 - ALL EXPOSED METAL OUTSIDE OF THE WET WELL SHALL BE IN ACCORDANCE WITH THE ORANGE COUNTY UTILITIES STANDARDS AND SPECIFICATIONS MANUAL.
 - A CRYSTALLINE WATER PROOFING ADMIXTURE SHALL BE ADDED TO THE CONCRETE DURING THE MIXING CYCLE FOR THE WET WELL AND VALVE VAULT PRECAST STRUCTURES. THE CRYSTALLINE WATER PROOFING ADMIXTURE SHALL BE APPROVED PRODUCT AS LISTED IN OCU APPENDIX D.
 - THE INSIDE OF THE WET WELL AND VALVE VAULT SHALL BE LINED WITH AN FRP LINER AS LISTED IN APPENDIX D.
 - WET WELL ACCESS OPENING SHALL BE COVERED ON ALL FOUR VERTICAL SIDES WITH A PROTECTIVE LINER.
 - WET WELL ACCESS HATCH AND COVER SHALL BE ALUMINUM, WITH 316 STAINLESS STEEL HARDWARE AND LOCK BRACKET PLATE WITH THE WORDS 'CONFINED SPACE' STAMPED (ETCHED) ON THE TOP SIDE.
 - ALL HARDWARE IN THE WET WELL SHALL BE 316 STAINLESS STEEL.
 - THERE SHALL BE NO VALVES OR ELECTRICAL JUNCTION BOXES IN THE WET WELL.
 - ALL PIPING AND CONDUIT PENETRATIONS THROUGH CONCRETE SHALL BE WATERTIGHT. CAST-IN-PLACE SLEEVES SHALL BE PLACED IN ALL OPENINGS WHERE PRESSURE PIPE ENTER OR LEAVE THE WET WELL. PENETRATIONS THROUGH WET WELL SHALL BE A COMPRESSION TYPE SEAL, SUCH AS "LINK-SEAL", OR AN ACCEPTABLE EQUAL AS LISTED IN OCU APPENDIX D.
 - ALL CONNECTIONS WITHIN THE WET WELL SHALL BE FLANGED JOINTS. ALL REMAINING JOINTS BETWEEN THE WET WELL AND THE CONNECTION TO THE EXISTING FORCE MAIN SHALL BE RESTRAINED MECHANICAL JOINTS. (SEE TABLE ON DETAIL SHEET D100).
 - ALL PIPING WITHIN THE WET WELL SHALL BE STAINLESS STEEL 316 SCHEDULE 40.
 - PIPE SUPPORTS SHALL BE 316 STAINLESS STEEL, PROVIDED AND INSTALLED TO SUPPORT AND ANCHOR THE PIPING SECURELY IN THE VALVE VAULT.
 - CONTRACTOR SHALL, AS DIRECTED BY THE COUNTY REPRESENTATIVE, REMOVE AND SALVAGE TO THE COUNTY, ALL EXISTING PUMP STATION EQUIPMENT, INCLUDING PUMPS, CHECK VALVES, SHUTOFF VALVES, AND CONTROL PANEL.
 - CONTRACTOR SHALL DEMOLISH AND REMOVE FROM SITE ALL DEBRIS RESULTING FROM THE REMOVAL OF THE EXISTING STRUCTURES.
 - CONTRACTOR SHALL VERIFY ALL DIMENSIONS AND ELEVATIONS PRIOR TO ORDERING ANY MATERIALS OR EQUIPMENT.
 - CONTRACTOR SHALL GROUT FLOOR OF WET WELL, AS REQUIRED BY MANUFACTURER'S SPECIFICATIONS, TO ACCOMMODATE INSTALLATION OF THE NEW PUMPS.
 - STRUCTURAL DESIGN OF THE PRECAST WET WELL, TOP, AND VALVE VAULT SHALL BE THE RESPONSIBILITY OF THE PRECAST MANUFACTURER. CONTRACTOR SHALL SUBMIT SHOP DRAWINGS FOR THE PRECAST WET WELL, THE PRECAST WET WELL TOP AND HATCH COVER, RISERS AND THE VALVE VAULT, TO THE ENGINEER.
 - 100-YEAR FLOOD ELEVATION: OUT OF THE 100-YEAR FLOOD ZONE.
 - ALL EXTERNAL JOINTS SHALL BE COVERED WITH A HIGH STRENGTH, WATER TIGHT, PRESS-TO-SEAL TYPE TAPE/AS LISTED IN OCU APPENDIX D.
 - A SECOND HIGH LEVEL ALARM LIQUID FLOAT SHALL BE INSTALLED TO PROVIDE DRY CONTACT FOR SCADA. REFER TO PUMP CONTROL SCHEMATIC.
 - ALL SPOOLS SHALL BE MINIMUM OF SIX INCHES WHERE SPACE ALLOWS.
 - CONTRACTOR SHALL BE RESPONSIBLE FOR ALIGNMENT FROM THE BASE PLATE TO THE RISER PLATE AT NO EXTRA COST TO OCU.

DESIGN SPECIFICATIONS			
MANUFACTURER: ABS		VOLTAGE: 240 V	
MODEL: XFP150E CB1		PHASE: 3	
IMP: 8.46 IN		H.P.: 12	
DIA: 215 MM.		MAX. SOLID SIZE (3 IN MIN): 3 7/8 IN	
SPEED: 1760 RPM		CURVE NUMBER: XFP150E CB1	
DISCHARGE SIZE: 6 IN			
SHUT OFF HEAD: 75 FEET TDH			
HIGH HEAD CONDITION: 440 GPM AT 50 FEET TDH			
MINIMUM HEAD CONDITION: 1480 GPM AT 12 FEET TDH			
DESCRIPTION	SYMBOL	DIMENSION	ELEVATION
THICKNESS OF WALL	A	8"	—
DIAMETER OF WET WELL	B	8'	—
WIDTH OF BOTTOM FILLET	C	SEE NOTE 1	—
C/L OF WET WELL TO C/L OF PIPES	D	SEE NOTE 1	—
LENGTH OF PUMP ACCESS OPENING	E	SEE NOTE 1	—
WIDTH OF PUMP ACCESS OPENING	F	SEE NOTE 1	—
CENTER OF WET WELL TO EDGE OF HATCH	G	SEE NOTE 1	—
VALVE BOX HATCH OPENING	H	N/A	—
VALVE BOX HATCH OPENING	I	N/A	—
LIP WIDTH OF WETWELL BASE	R	18"	—
THICKNESS OF WETWELL BASE	S	12"	—
TOP OF WET WELL	T	—	71.17
FINISHED GRADE	U	—	70.92
HIGH LEVEL ALARMS	V	—	59.42
LAG PUMP ON	W	—	58.92
LEAD PUMP ON / INFLUENT PIPE INVERT	X	—	58.42
PUMPS OFF (TOP OF PUMP VOLUTE)	Y	—	53.92
BOTTOM OF PUMP TO FLOOR OF WET WELL	P	4 1/4"	51.84
STEP HEIGHT (IF REQUIRED)	Q		-
FLOOR OF WET WELL	Z	—	52.42
NOTES:			
1. PER PUMP MANUFACTURER'S REQUIREMENTS			
2. DIMENSION P AND ELEVATIONS Y AND Z MUST MEET ABS REQUIREMENTS.			
3. ELEVATION X - ELEVATION Z ≥ 5 FEET			
4. TOP ELEVATION OF WET WELL SHALL BE A MINIMUM OF 1' ABOVE THE 100 YEAR FLOOD ELEVATION AND THE ELEVATION OF THE CROWN OF THE ROAD.			
5. SYMBOLS SHOWN IN TABLE ARE USED IN PLAN AND SECTION VIEW THIS SHEET.			

FLYGT PUMPS DO NOT MEET PUMP STATION CONDITIONS PER OCU STANDARD DESIGN REQUIREMENTS

REV	DATE	DESCRIPTION

LINE IS 2 INCHES
AT FULL SIZE
(IF NOT SCALE ACCORDINGLY)

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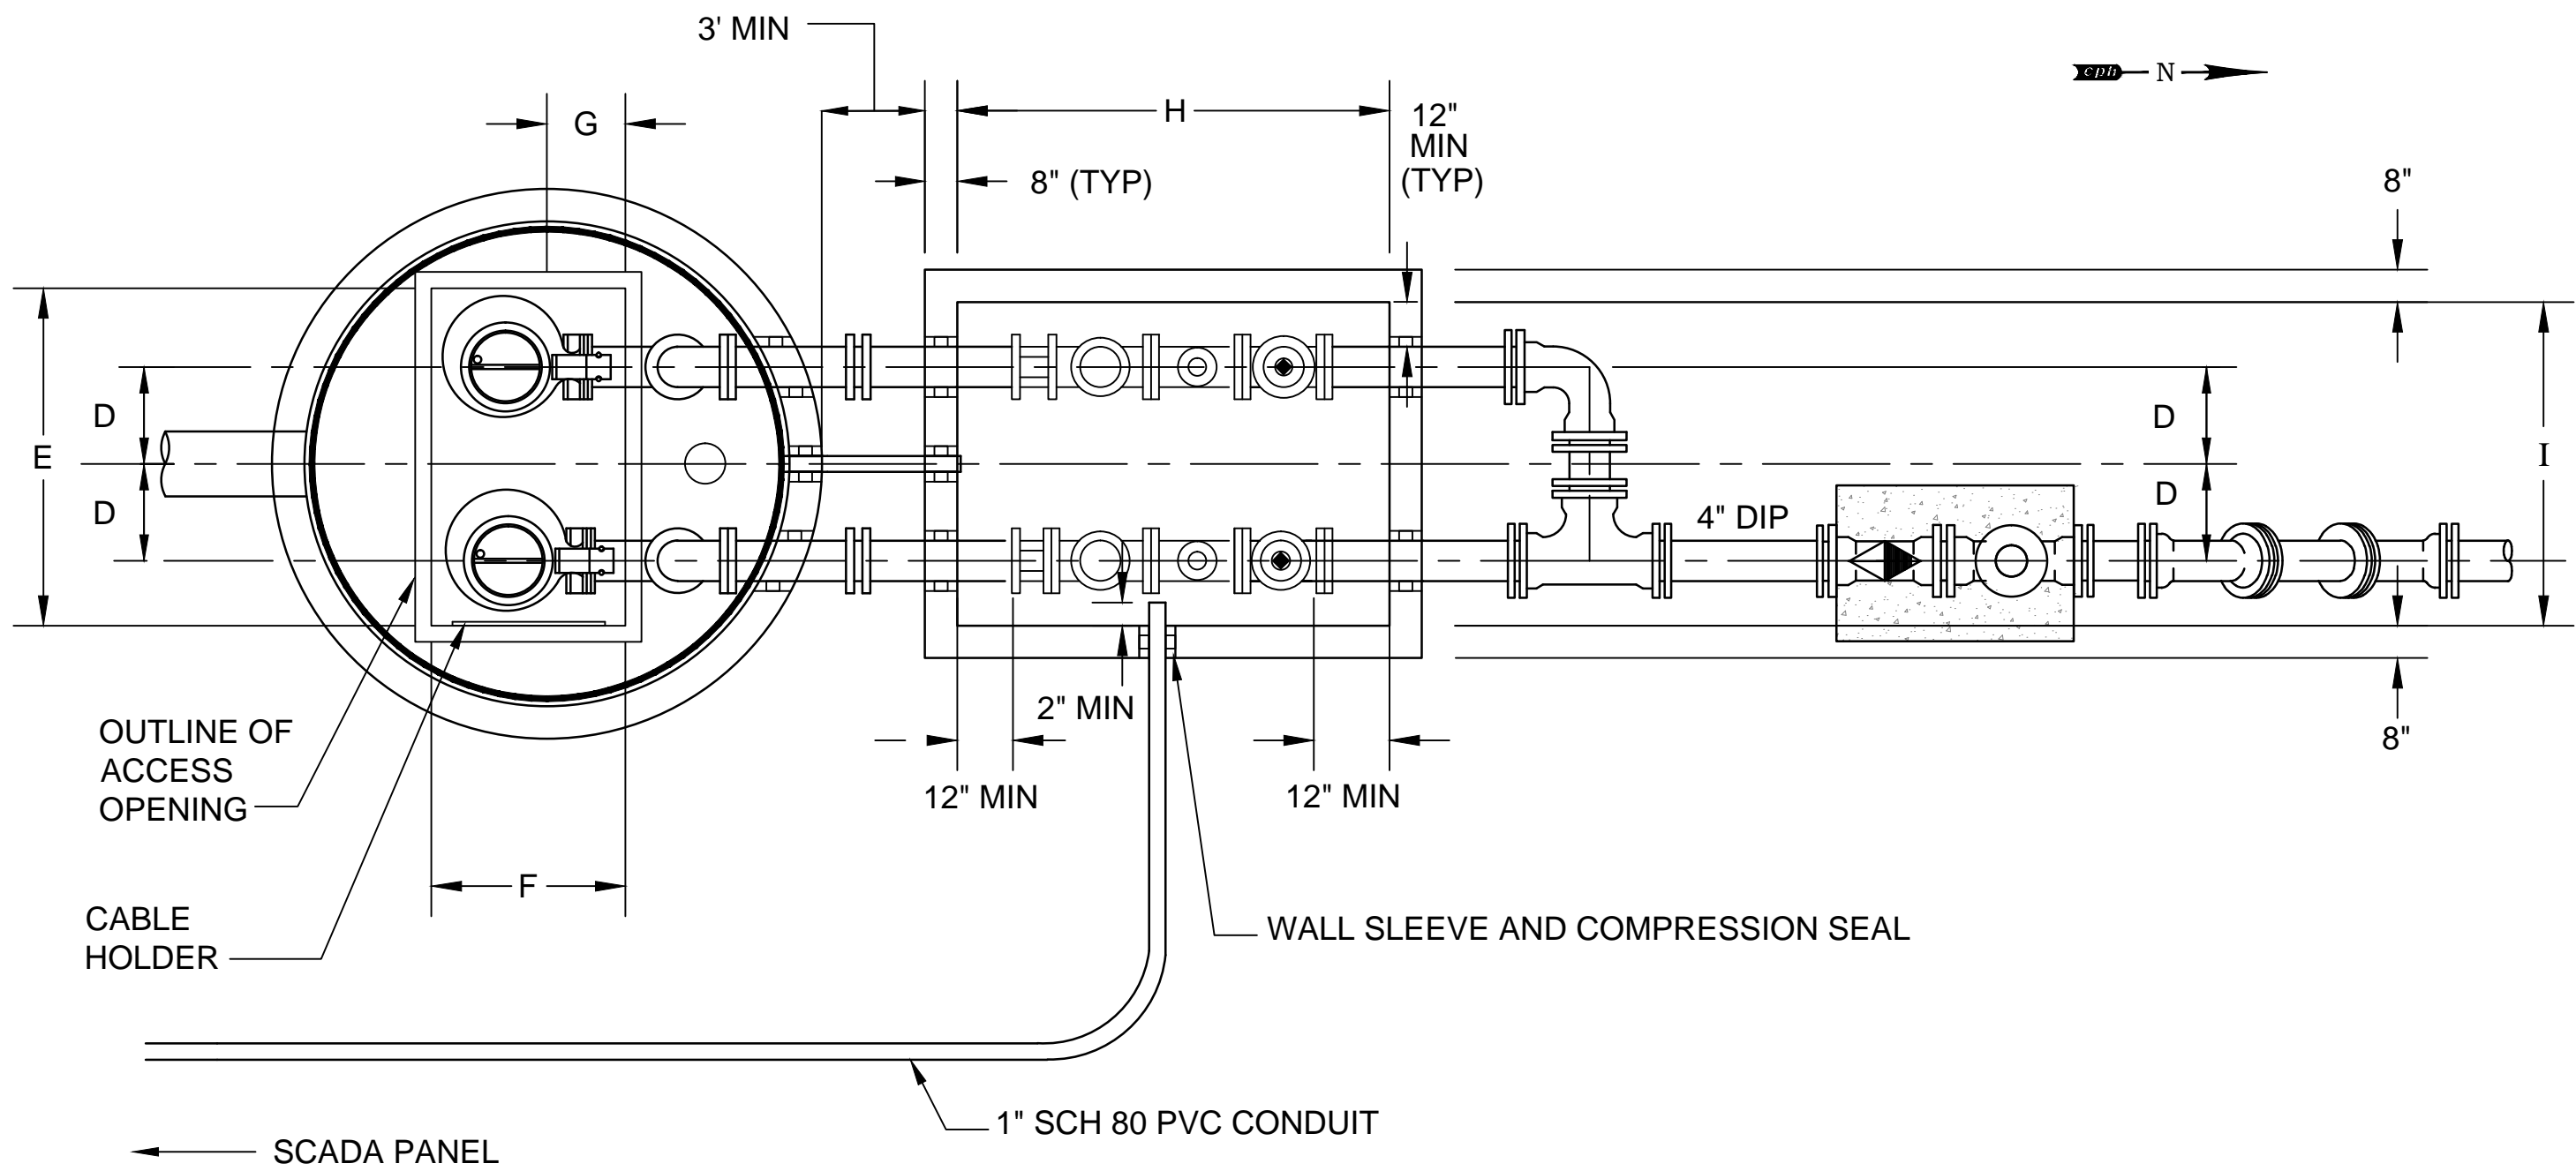
P.S. # 3990 ARNING DRIVE
PUMP PLAN, SECTION AND DETAIL

OCU FILE NO.: 74325
DESIGNED BY: SAB
DRAWN BY: DGH/GCM

SCOTT A. BREITENSTEIN
PROFESSIONAL ENGINEER
FLORIDA LICENSE #57402

SCALE: N.T.S.
DRAWING NO.:
P100
SHEET: 20 OF 40

BID DRAWING



GENERAL NOTES:

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- THE INSIDE OF THE WET WELL AND VALVE VAULT SHALL BE LINED WITH AN FRP LINER AS LISTED IN APPENDIX D.
- WET WELL ACCESS OPENING SHALL BE COVERED ON ALL FOUR VERTICAL SIDES WITH A PROTECTIVE LINER.
- WET WELL ACCESS HATCH AND COVER SHALL BE ALUMINUM, WITH 316 STAINLESS STEEL HARDWARE AND LOCK BRACKET PLATE WITH THE WORDS "CONFINED SPACE" STAMPED (ETCHED) ON THE TOP SIDE.
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- THERE SHALL BE NO VALVES OR ELECTRICAL JUNCTION BOXES IN THE WET WELL.
- ALL PIPING AND CONDUIT PENETRATIONS THROUGH CONCRETE SHALL BE WATERTIGHT. CAST-IN-PLACE SLEEVES SHALL BE PLACED IN ALL OPENINGS WHERE PRESSURE PIPE ENTER OR LEAVE THE WET WELL AND/OR VALVE VAULT. PENETRATIONS THROUGH WET WELL AND VALVE VAULT SHALL BE A COMPRESSION TYPE SEAL, SUCH AS "LINK-SEAL", OR AN ACCEPTABLE EQUAL AS LISTED IN OCU APPENDIX D.
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- ALL PIPING WITHIN THE WET WELL AND VALVE VAULT SHALL BE STAINLESS STEEL 316 SCHEDULE 40.
- VALVE VAULT SHALL BE SIZED TO PERMIT EASY REMOVAL OF CHECK VALVE SPINDLES, WITH MINIMUM CLEARANCE, AS SHOWN FOR 6" DIAMETER PIPE, OR SMALLER.
- PIPE SUPPORTS SHALL BE 316 STAINLESS STEEL, PROVIDED AND INSTALLED TO SUPPORT AND ANCHOR THE PIPING SECURELY IN THE VALVE VAULT.
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- ALL SPOOLS SHALL BE MINIMUM OF SIX INCHES WHERE SPACE ALLOWS.
- CONTRACTOR SHALL BE RESPONSIBLE FOR ALIGNMENT FROM THE BASE PLATE TO THE RISER PLATE AT NO EXTRA COST TO OCU.

DESIGN SPECIFICATIONS

MANUFACTURER: ABS
MODEL: XFP100E.CB1
IMP: 7.28 IN
DIA: 185 MM.
SPEED: 1770 RPM
DISCHARGE SIZE: 4 IN
VOLTAGE: 240 V
PHASE: 3
H.P.: 10
MAX. SOLID SIZE (3 IN MIN): 80 MM
CURVE NUMBER: XFP100E.CB1
SHUT OFF HEAD: 48 FEET TDH
HIGH HEAD CONDITION: 158 GPM AT 40 FEET TDH
MINIMUM HEAD CONDITION: 681 GPM AT 11 FEET TDH

DESCRIPTION	SYMBOL	DIMENSION	ELEVATION
THICKNESS OF WALL	A	8"	—
DIAMETER OF WET WELL	B	6'	—
WIDTH OF BOTTOM FILLET	C	SEE NOTE 1	—
C/L OF WET WELL TO C/L OF PIPES	D	SEE NOTE 1	—
LENGTH OF PUMP ACCESS OPENING	E	SEE NOTE 1	—
WIDTH OF PUMP ACCESS OPENING	F	SEE NOTE 1	—
CENTER OF WET WELL TO EDGE OF HATCH	G	SEE NOTE 1	—
VALVE BOX HATCH OPENING	H	66"	—
VALVE BOX HATCH OPENING	I	60"	—
LIP WIDTH OF WETWELL BASE	R	18"	—
THICKNESS OF WETWELL BASE	S	12"	—
TOP OF WET WELL	T	—	79.90
FINISHED GRADE	U	—	79.65
HIGH LEVEL ALARMS	V	—	66.42
LAG PUMP ON	W	—	65.92
LEAD PUMP ON / INFLUENT PIPE INVERT	X	—	74.50
PUMPS OFF (TOP OF PUMP VOLUTE)	Y	—	63.29
BOTTOM OF PUMP TO FLOOR OF WET WELL	P	4.6"	61.42
STEP HEIGHT (IF REQUIRED)	Q	—	-
FLOOR OF WET WELL	Z	—	61.80

- NOTES:
- PER PUMP MANUFACTURER'S REQUIREMENTS
 - DIMENSION P AND ELEVATIONS Y AND Z MUST MEET ABS REQUIREMENTS.
 - ELEVATION X - ELEVATION Z ≥ 5 FEET
 - TOP ELEVATION OF WET WELL SHALL BE A MINIMUM OF 1' ABOVE THE 100 YEAR FLOOD ELEVATION AND THE ELEVATION OF THE CROWN OF THE ROAD.
 - SYMBOLS SHOWN IN TABLE ARE USED IN PLAN AND SECTION VIEW THIS SHEET.

FLYGT PUMPS DO NOT MEET
PUMP STATION CONDITIONS PER
OCU STANDARD DESIGN REQUIREMENTS

REV	DATE	DESCRIPTION

LINE IS 2" INCHES
AT FULL SIZE
(IF NOT SCALE ACCORDINGLY)



ORANGE COUNTY
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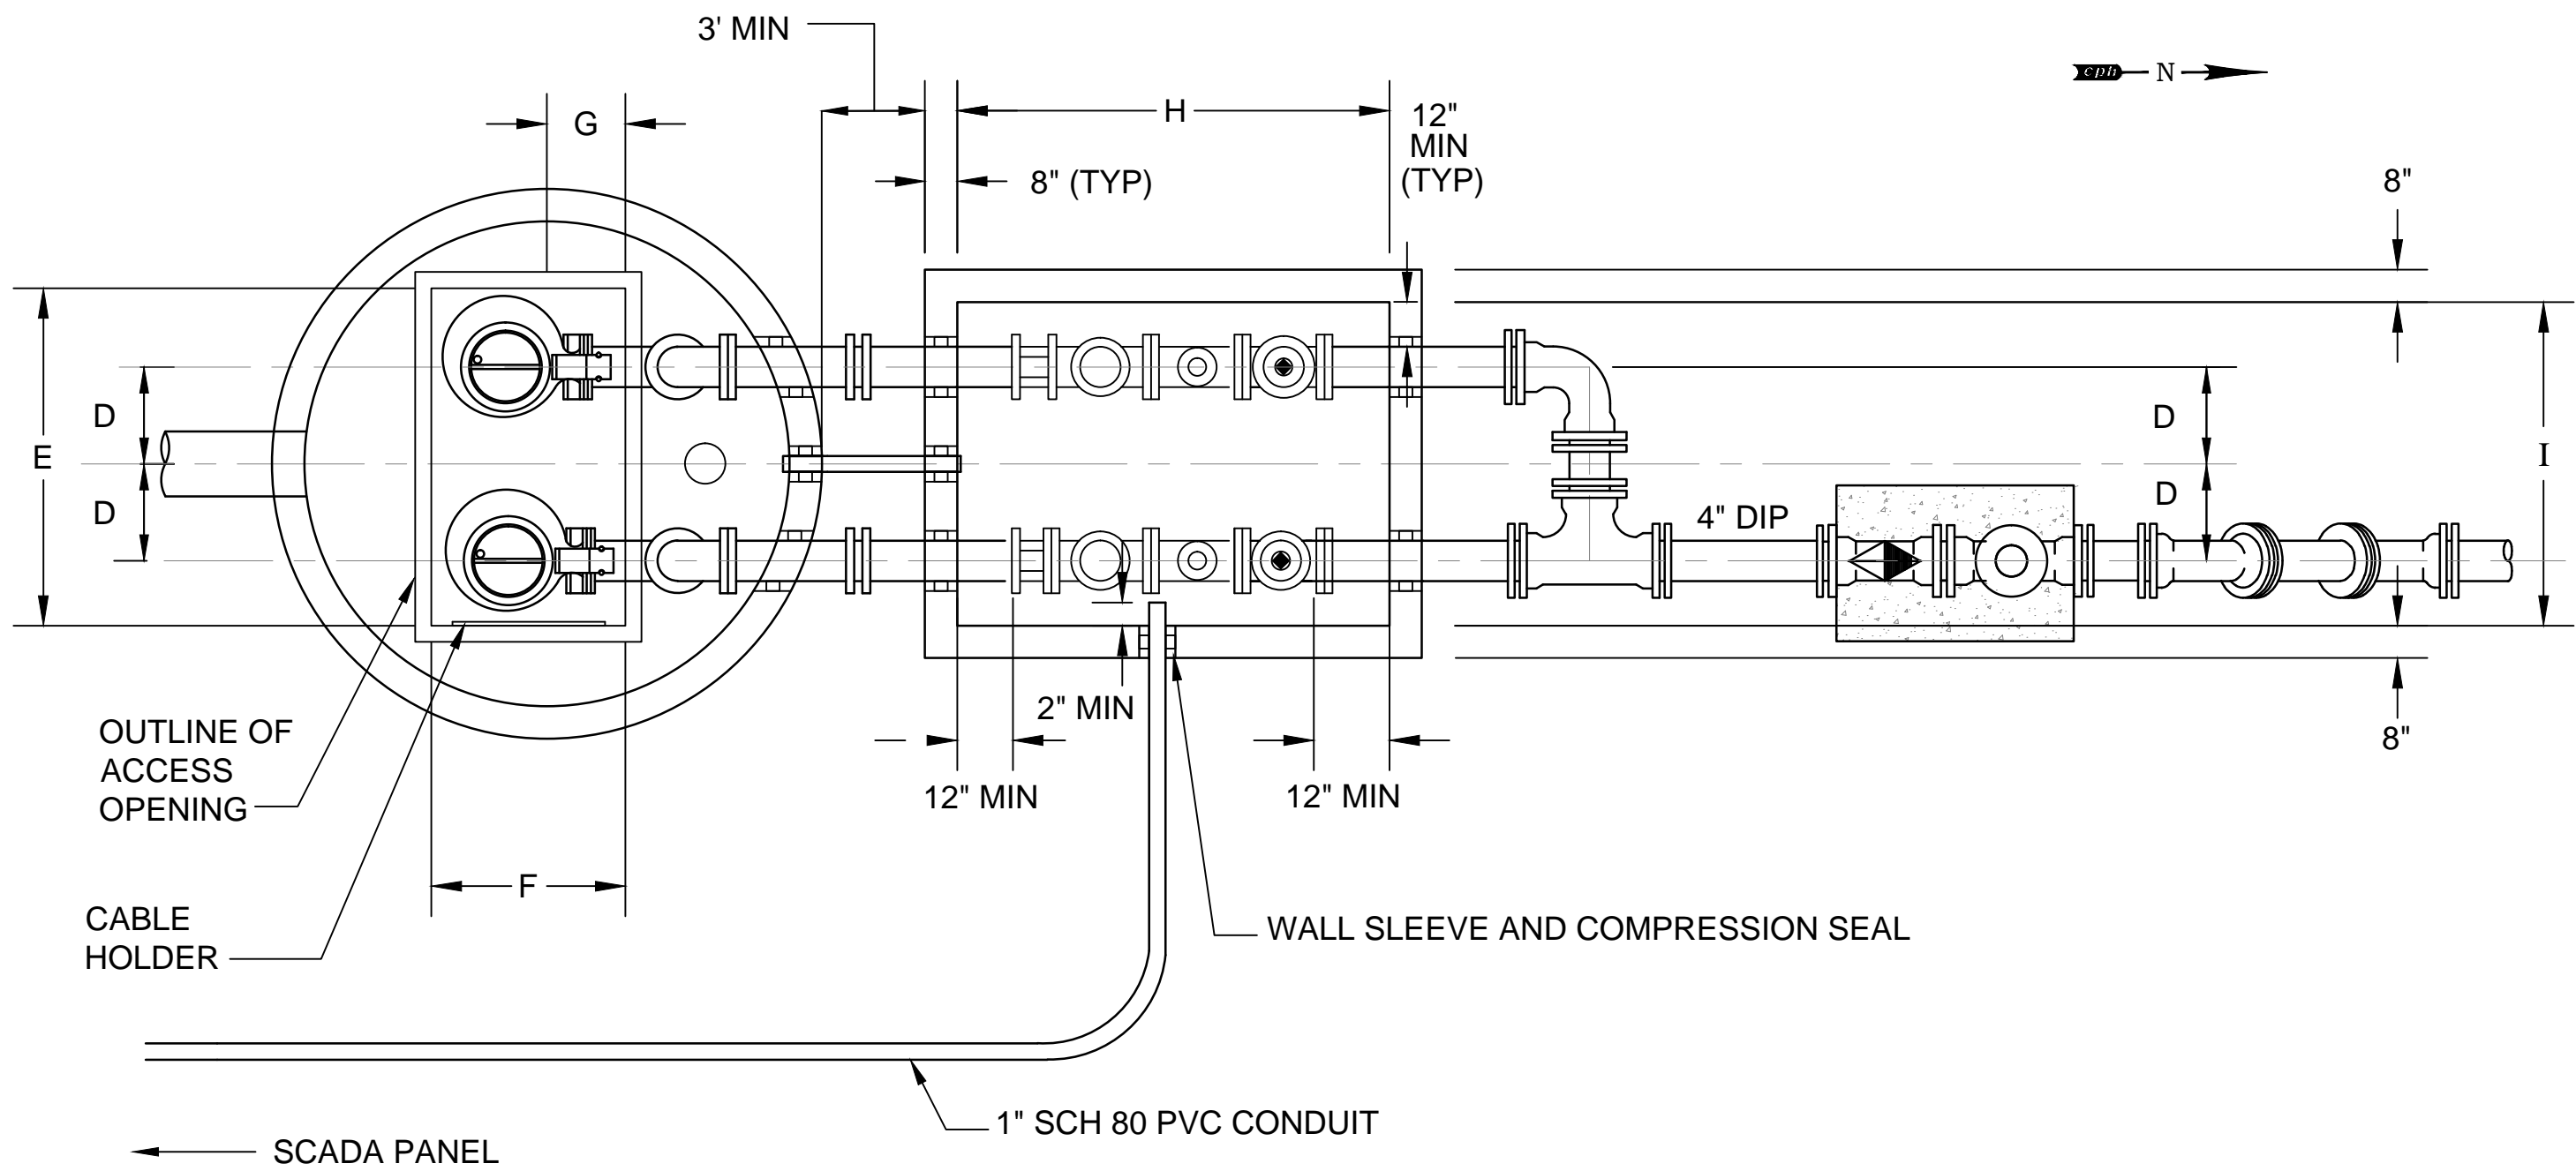
Eng. C.O.A. No. 3215
Survey L.B. No. 7143
Arch. Lic. No. AA2600926
Lndscp. Lic. No. LC0000298

P.S. # 3259 ALLWOOD PLACE
PUMP PLAN, SECTION AND DETAIL

SCOTT A. BREITENSTEIN
PROFESSIONAL ENGINEER
FLORIDA LICENSE #57402

OCU FILE NO.: 74325
DESIGNED BY: SAB
DRAWN BY: DGH/GCM
CHECKED BY: SAB/DEM
CADD FILE: Pump Station Details.dwg

SCALE: N.T.S.
DRAWING NO.:
P200
SHEET: 21 OF 40



GENERAL NOTES:

- ALL MATERIALS AND CONSTRUCTION SHALL BE IN ACCORDANCE WITH THE ORANGE COUNTY UTILITIES STANDARDS AND SPECIFICATIONS MANUAL (LATEST EDITION), AND/OR AS SPECIFIED HEREIN.
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- THE INSIDE OF THE WET WELL AND VALVE VAULT SHALL BE LINED WITH AN FRP LINER AS LISTED IN APPENDIX D.
- WET WELL ACCESS OPENING SHALL BE COVERED ON ALL FOUR VERTICAL SIDES WITH A PROTECTIVE LINER.
- WET WELL ACCESS HATCH AND COVER SHALL BE ALUMINUM, WITH 316 STAINLESS STEEL HARDWARE AND LOCK BRACKET PLATE WITH THE WORDS "CONFINED SPACE" STAMPED (ETCHED) ON THE TOP SIDE.
- ALL HARDWARE IN THE WET WELL SHALL BE 316 STAINLESS STEEL.
- THERE SHALL BE NO VALVES OR ELECTRICAL JUNCTION BOXES IN THE WET WELL.
- ALL PIPING AND CONDUIT PENETRATIONS THROUGH CONCRETE SHALL BE WATERTIGHT. CAST-IN-PLACE SLEEVES SHALL BE PLACED IN ALL OPENINGS WHERE PRESSURE PIPE ENTER OR LEAVE THE WET WELL AND/OR VALVE VAULT. PENETRATIONS THROUGH WET WELL AND VALVE VAULT SHALL BE A COMPRESSION TYPE SEAL, SUCH AS "LINK-SEAL", OR AN ACCEPTABLE EQUAL AS LISTED IN OCU APPENDIX D.
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- 100-YEAR FLOOD ELEVATION: OUT OF THE 100-YEAR FLOOD ZONE.
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- ALL SPOOLS SHALL BE MINIMUM OF SIX INCHES WHERE SPACE ALLOWS.
- CONTRACTOR SHALL BE RESPONSIBLE FOR ALIGNMENT FROM THE BASE PLATE TO THE RISER PLATE AT NO EXTRA COST TO OCU.

DESIGN SPECIFICATIONS

MANUFACTURER: ABS
MODEL: XFP100E CB1
IMP: 7.68 IN
DIA: 195 MM.
SPEED: 1170 RPM
DISCHARGE SIZE: 4 IN
VOLTAGE: 240 V
PHASE: 3
H.P.: 5
MAX. SOLID SIZE (3 IN MIN): 3 1/8 IN
CURVE NUMBER: XFP100E CB1
SHUT OFF HEAD: 29.3 FEET TDH
HIGH HEAD CONDITION: 145 GPM AT 18 FEET TDH
MINIMUM HEAD CONDITION: 480 GPM AT 10 FEET TDH

DESCRIPTION	SYMBOL	DIMENSION	ELEVATION
THICKNESS OF WALL	A	8"	—
DIAMETER OF WET WELL	B	6'	—
WIDTH OF BOTTOM FILLET	C	SEE NOTE 1	—
C/L OF WET WELL TO C/L OF PIPES	D	SEE NOTE 1	—
LENGTH OF PUMP ACCESS OPENING	E	SEE NOTE 1	—
WIDTH OF PUMP ACCESS OPENING	F	SEE NOTE 1	—
CENTER OF WET WELL TO EDGE OF HATCH	G	SEE NOTE 1	—
VALVE BOX HATCH OPENING	H	66"	—
VALVE BOX HATCH OPENING	I	60"	—
LIP WIDTH OF WETWELL BASE	R	18"	—
THICKNESS OF WETWELL BASE	S	12"	—
TOP OF WET WELL	T	—	105.00
FINISHED GRADE	U	—	104.75
HIGH LEVEL ALARMS	V	—	90.59
LAG PUMP ON	W	—	90.09
LEAD PUMP ON / INFLUENT PIPE INVERT	X	—	88.09
PUMPS OFF (TOP OF PUMP VOLUTE)	Y	—	84.59
BOTTOM OF PUMP TO FLOOR OF WET WELL	P	4.6"	82.71
STEP HEIGHT (IF REQUIRED)	Q	—	—
FLOOR OF WET WELL	Z	—	83.09

- NOTES:
- PER PUMP MANUFACTURER'S REQUIREMENTS
 - DIMENSION P AND ELEVATIONS Y AND Z MUST MEET ABS REQUIREMENTS.
 - ELEVATION X - ELEVATION Z ≥ 5 FEET
 - TOP ELEVATION OF WET WELL SHALL BE A MINIMUM OF 1' ABOVE THE 100 YEAR FLOOD ELEVATION AND THE ELEVATION OF THE CROWN OF THE ROAD.
 - SYMBOLS SHOWN IN TABLE ARE USED IN PLAN AND SECTION VIEW THIS SHEET.

FLYGT PUMPS DO NOT MEET
PUMP STATION CONDITIONS PER
OCU STANDARD DESIGN REQUIREMENTS

REV	DATE	DESCRIPTION

LINE IS 2" INCHES
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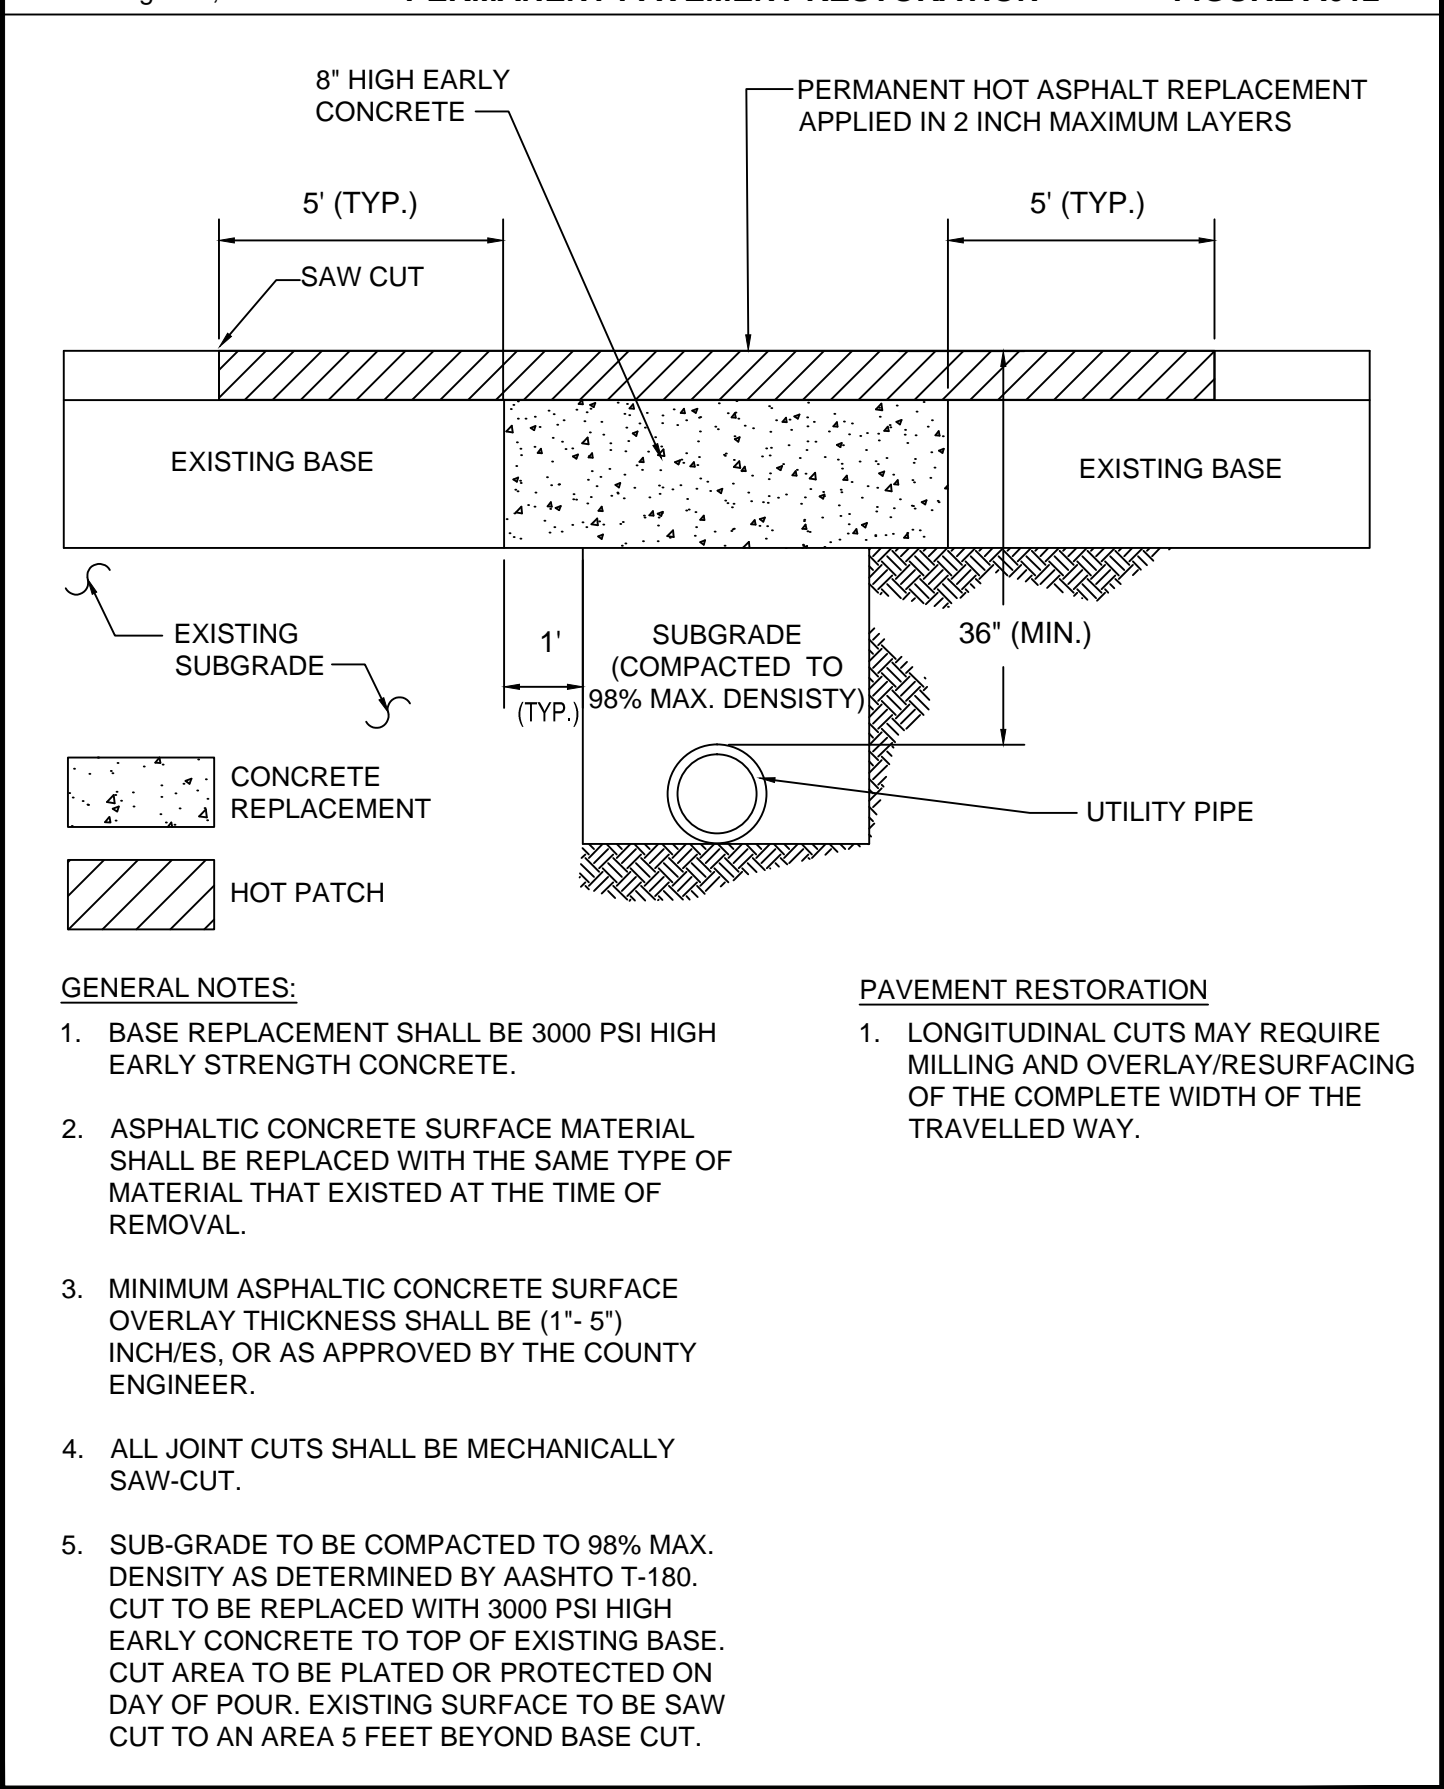
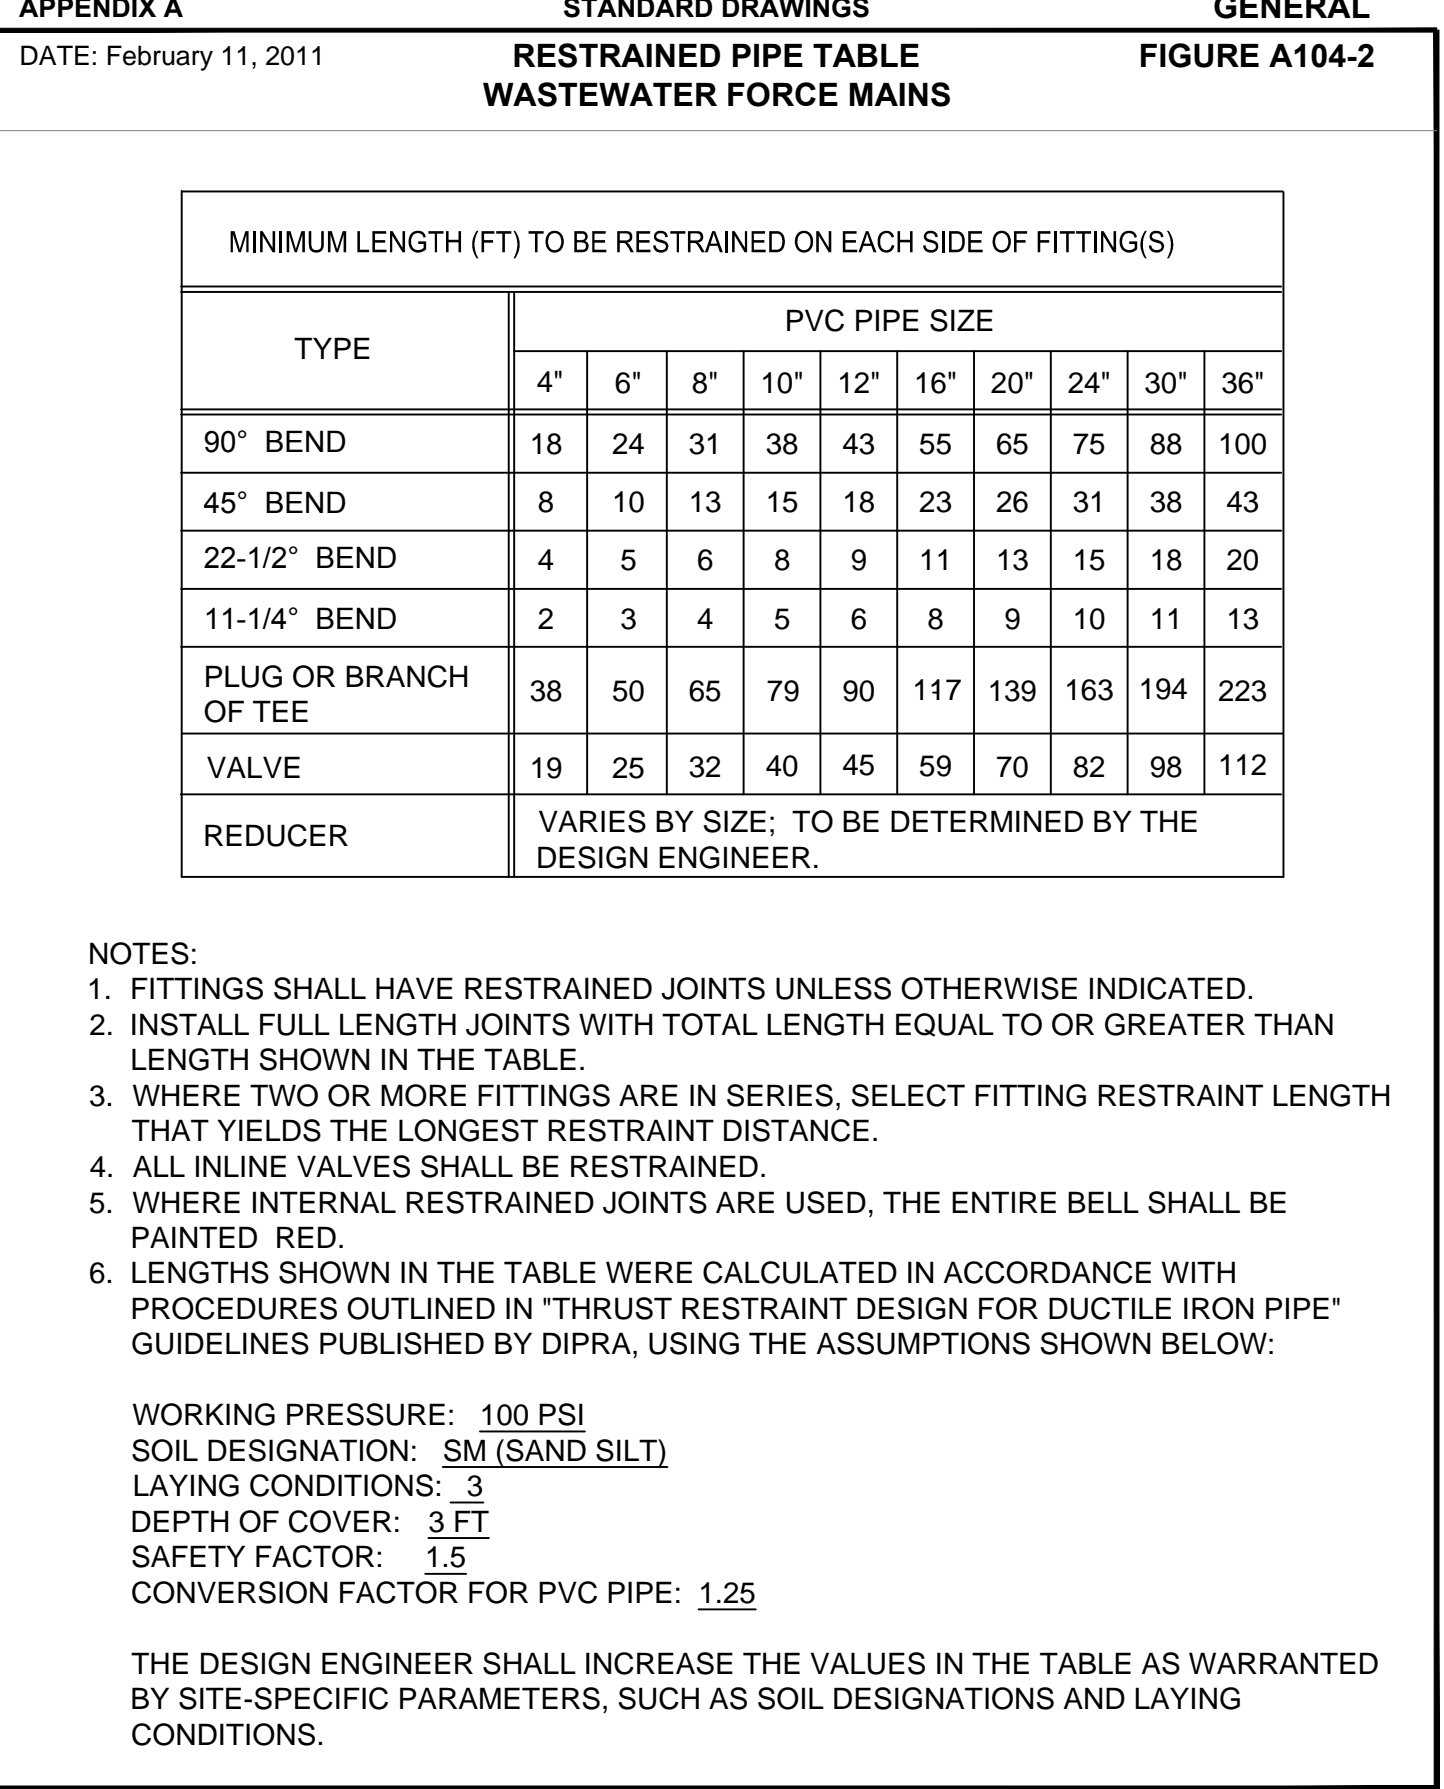
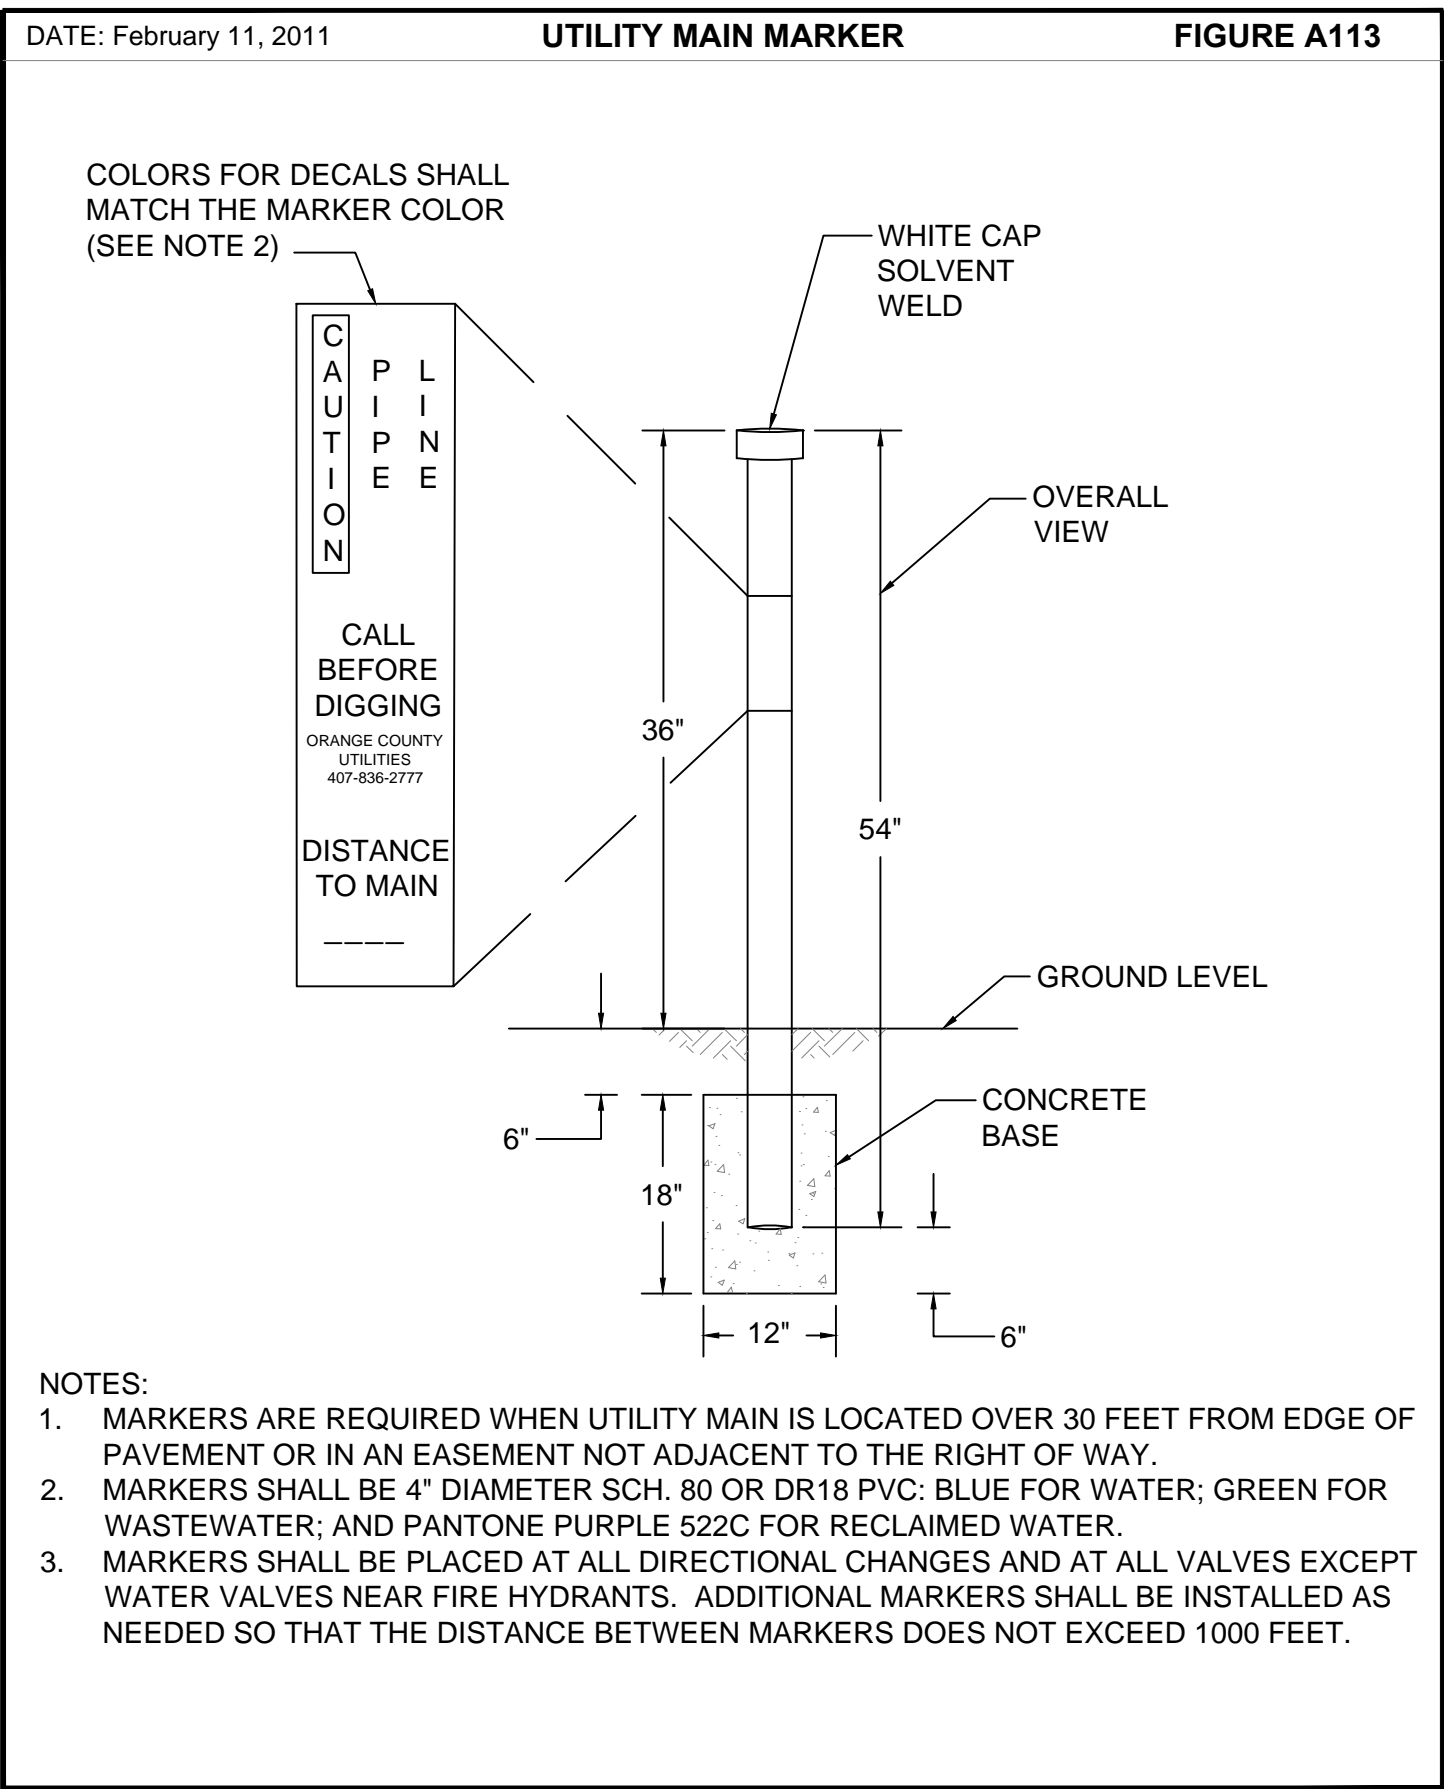
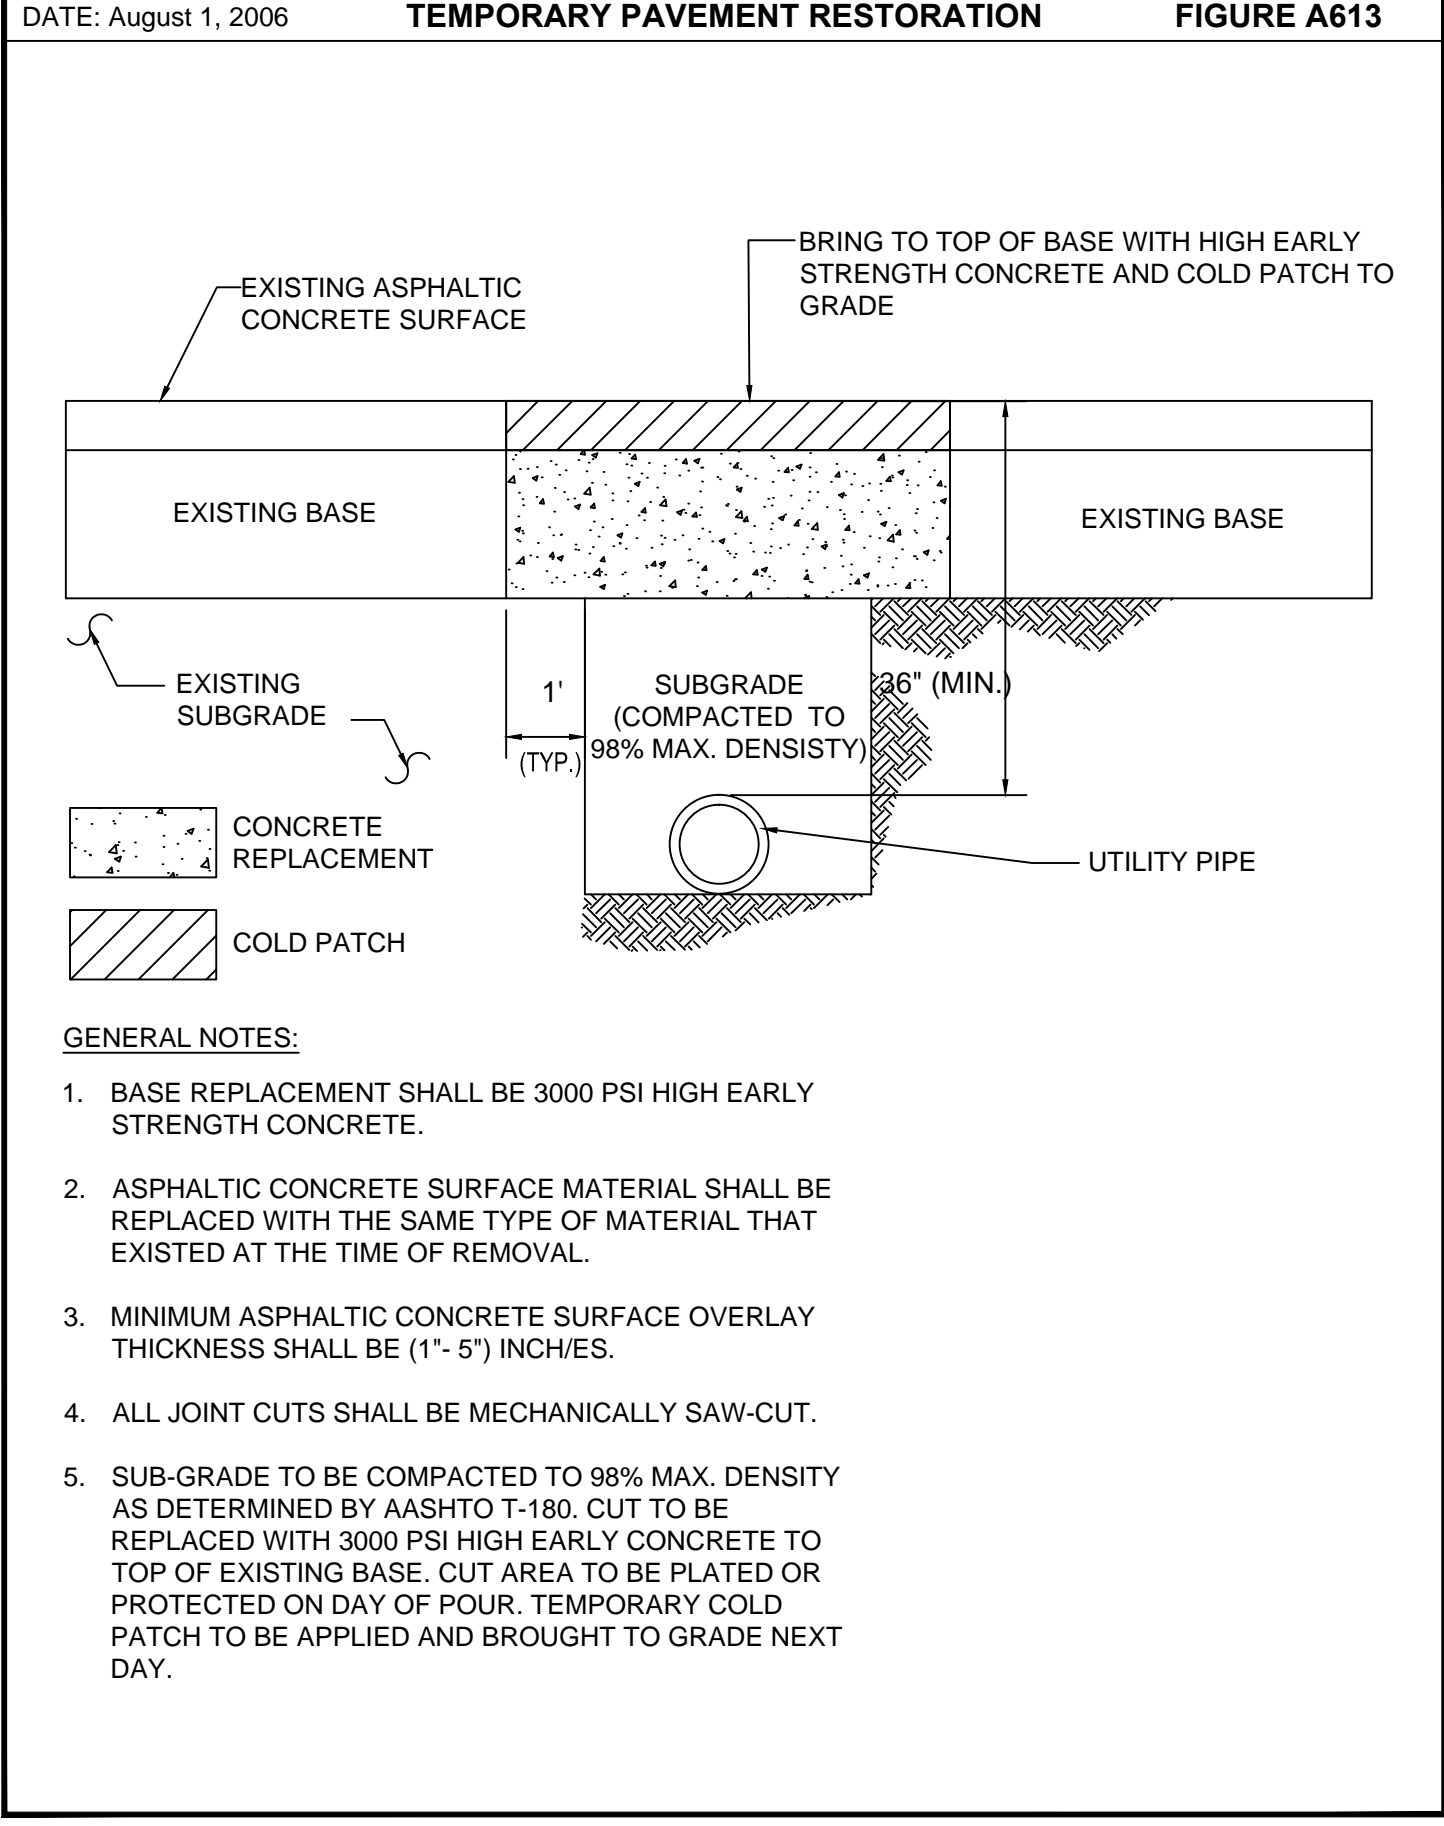
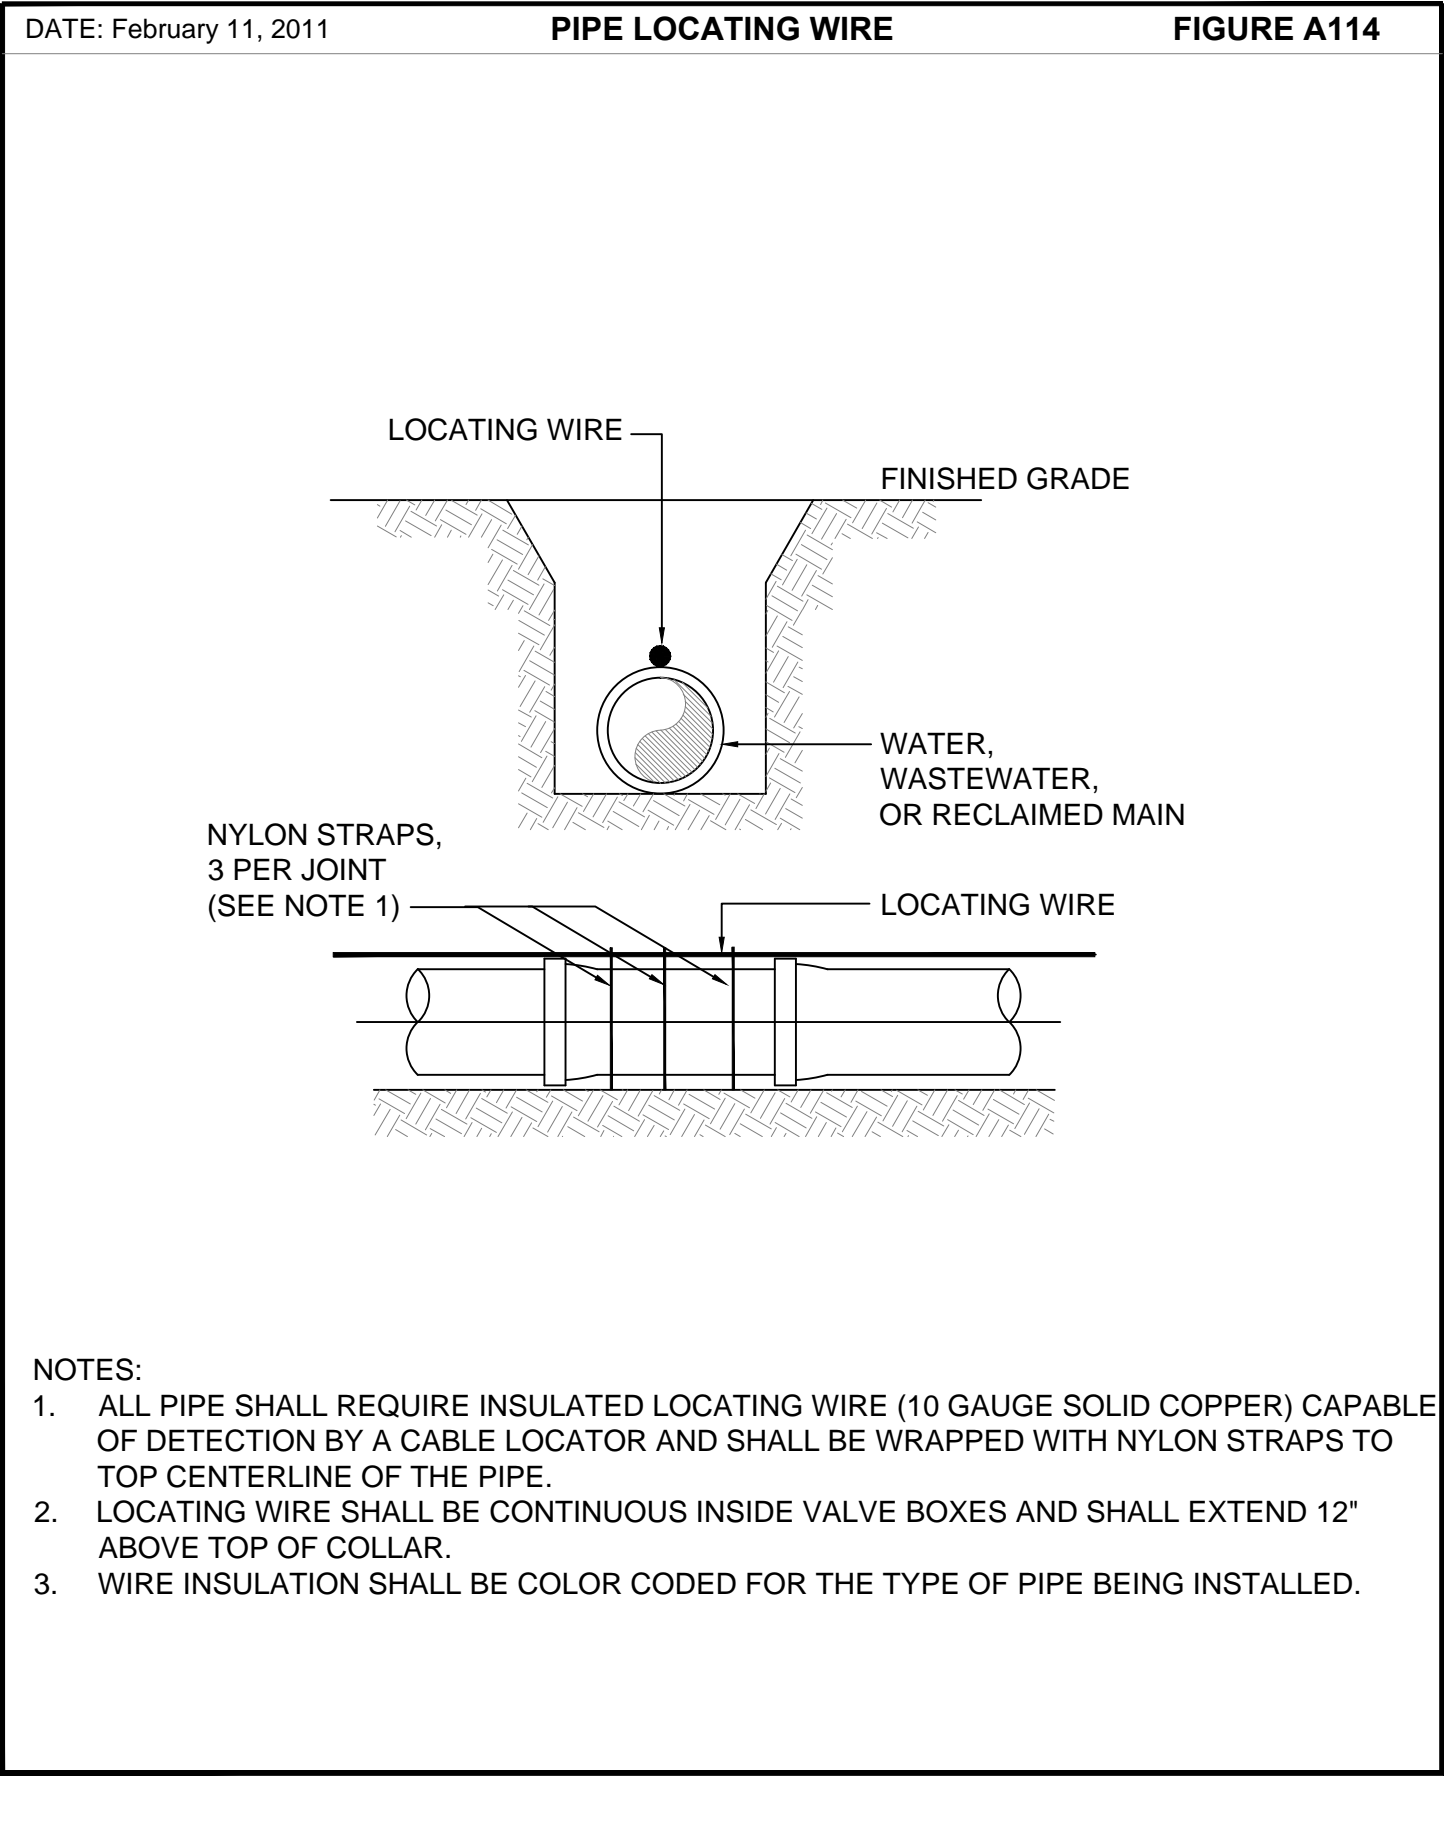
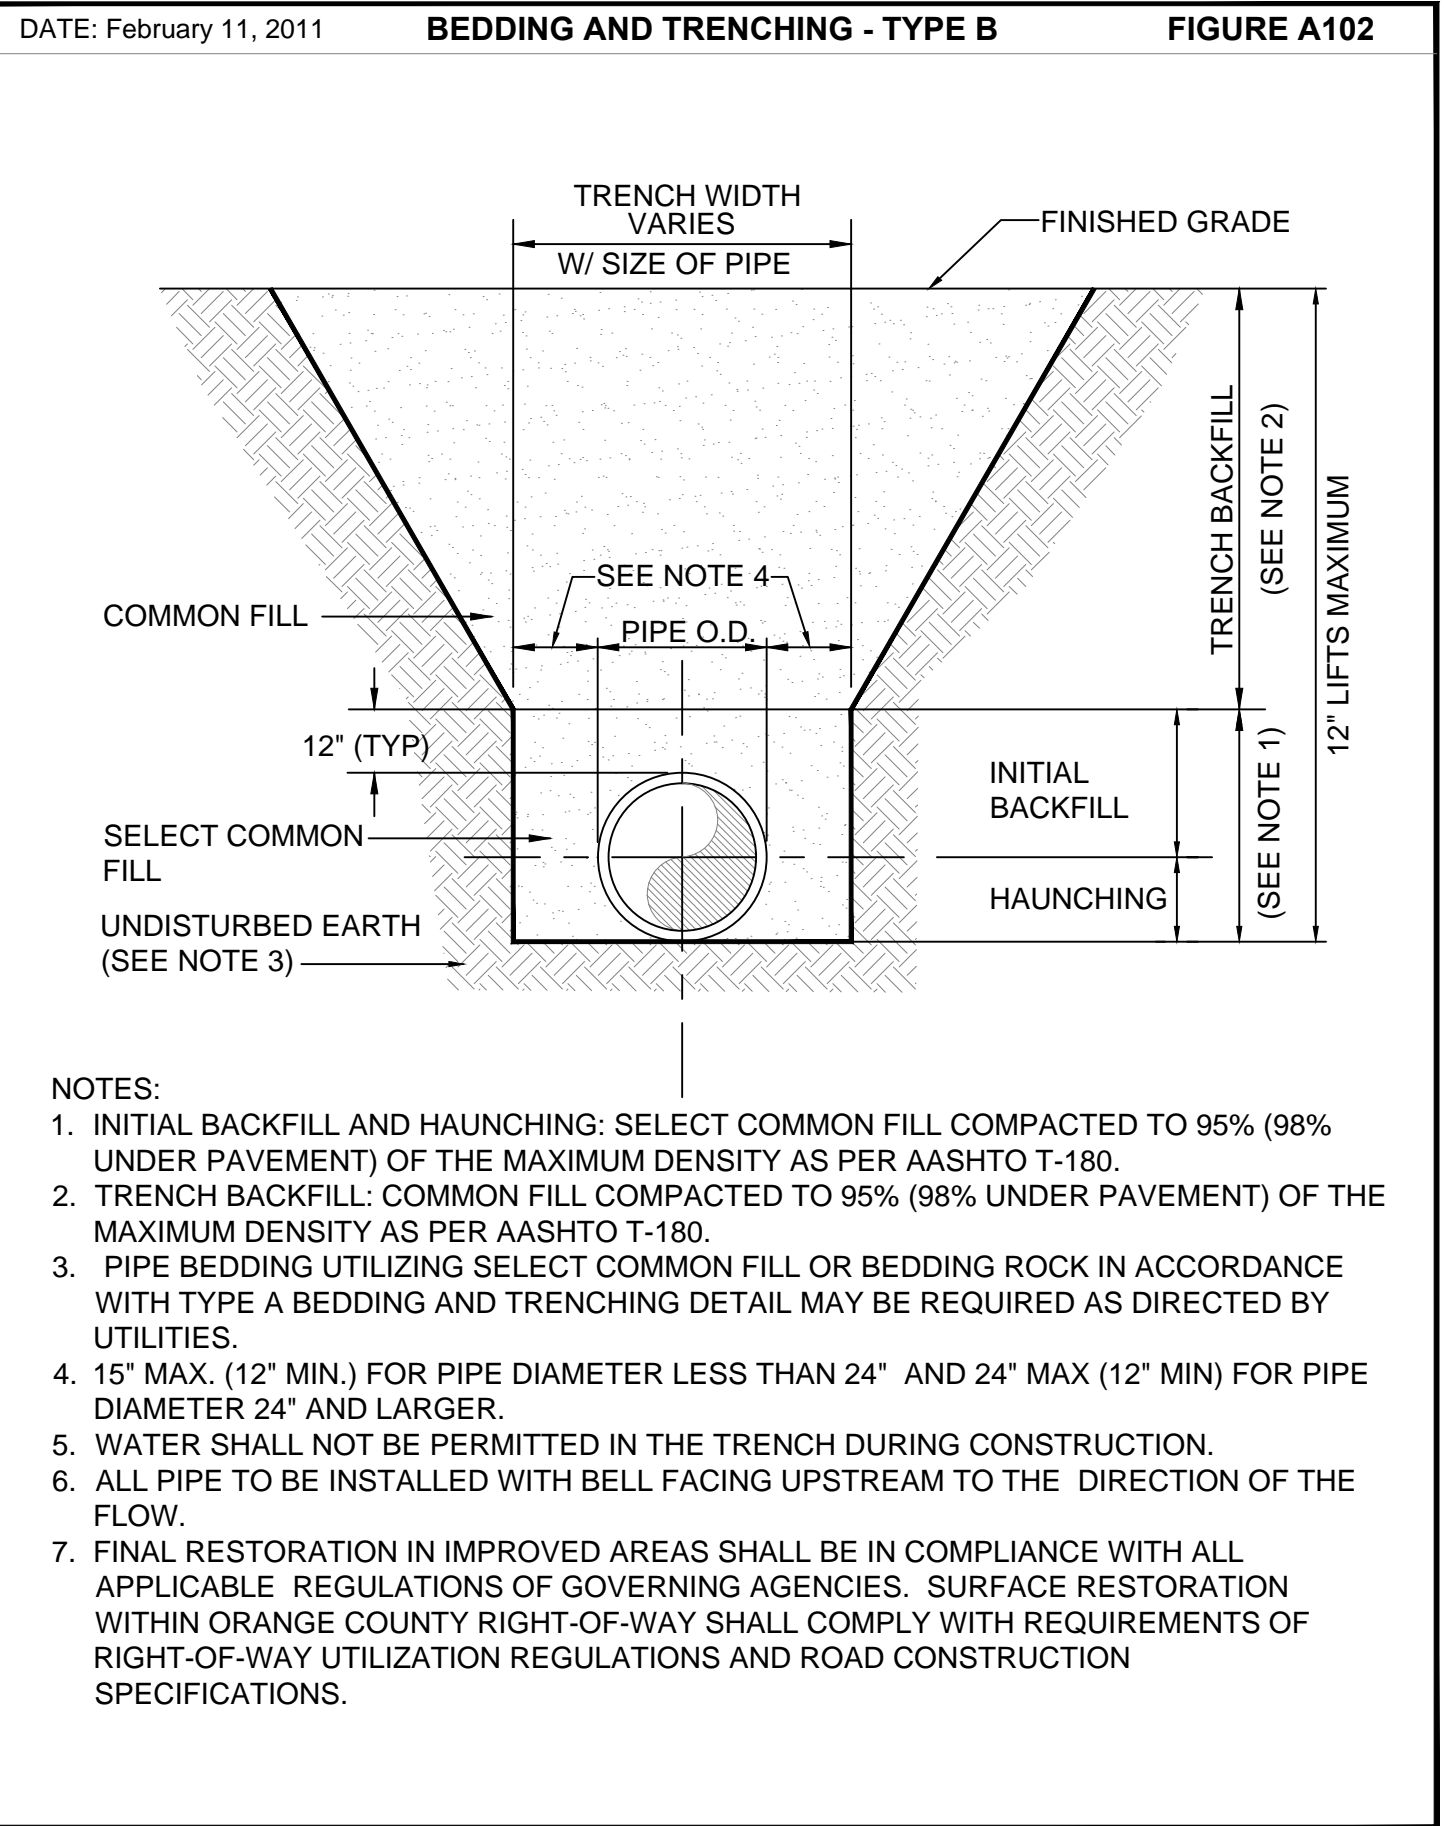
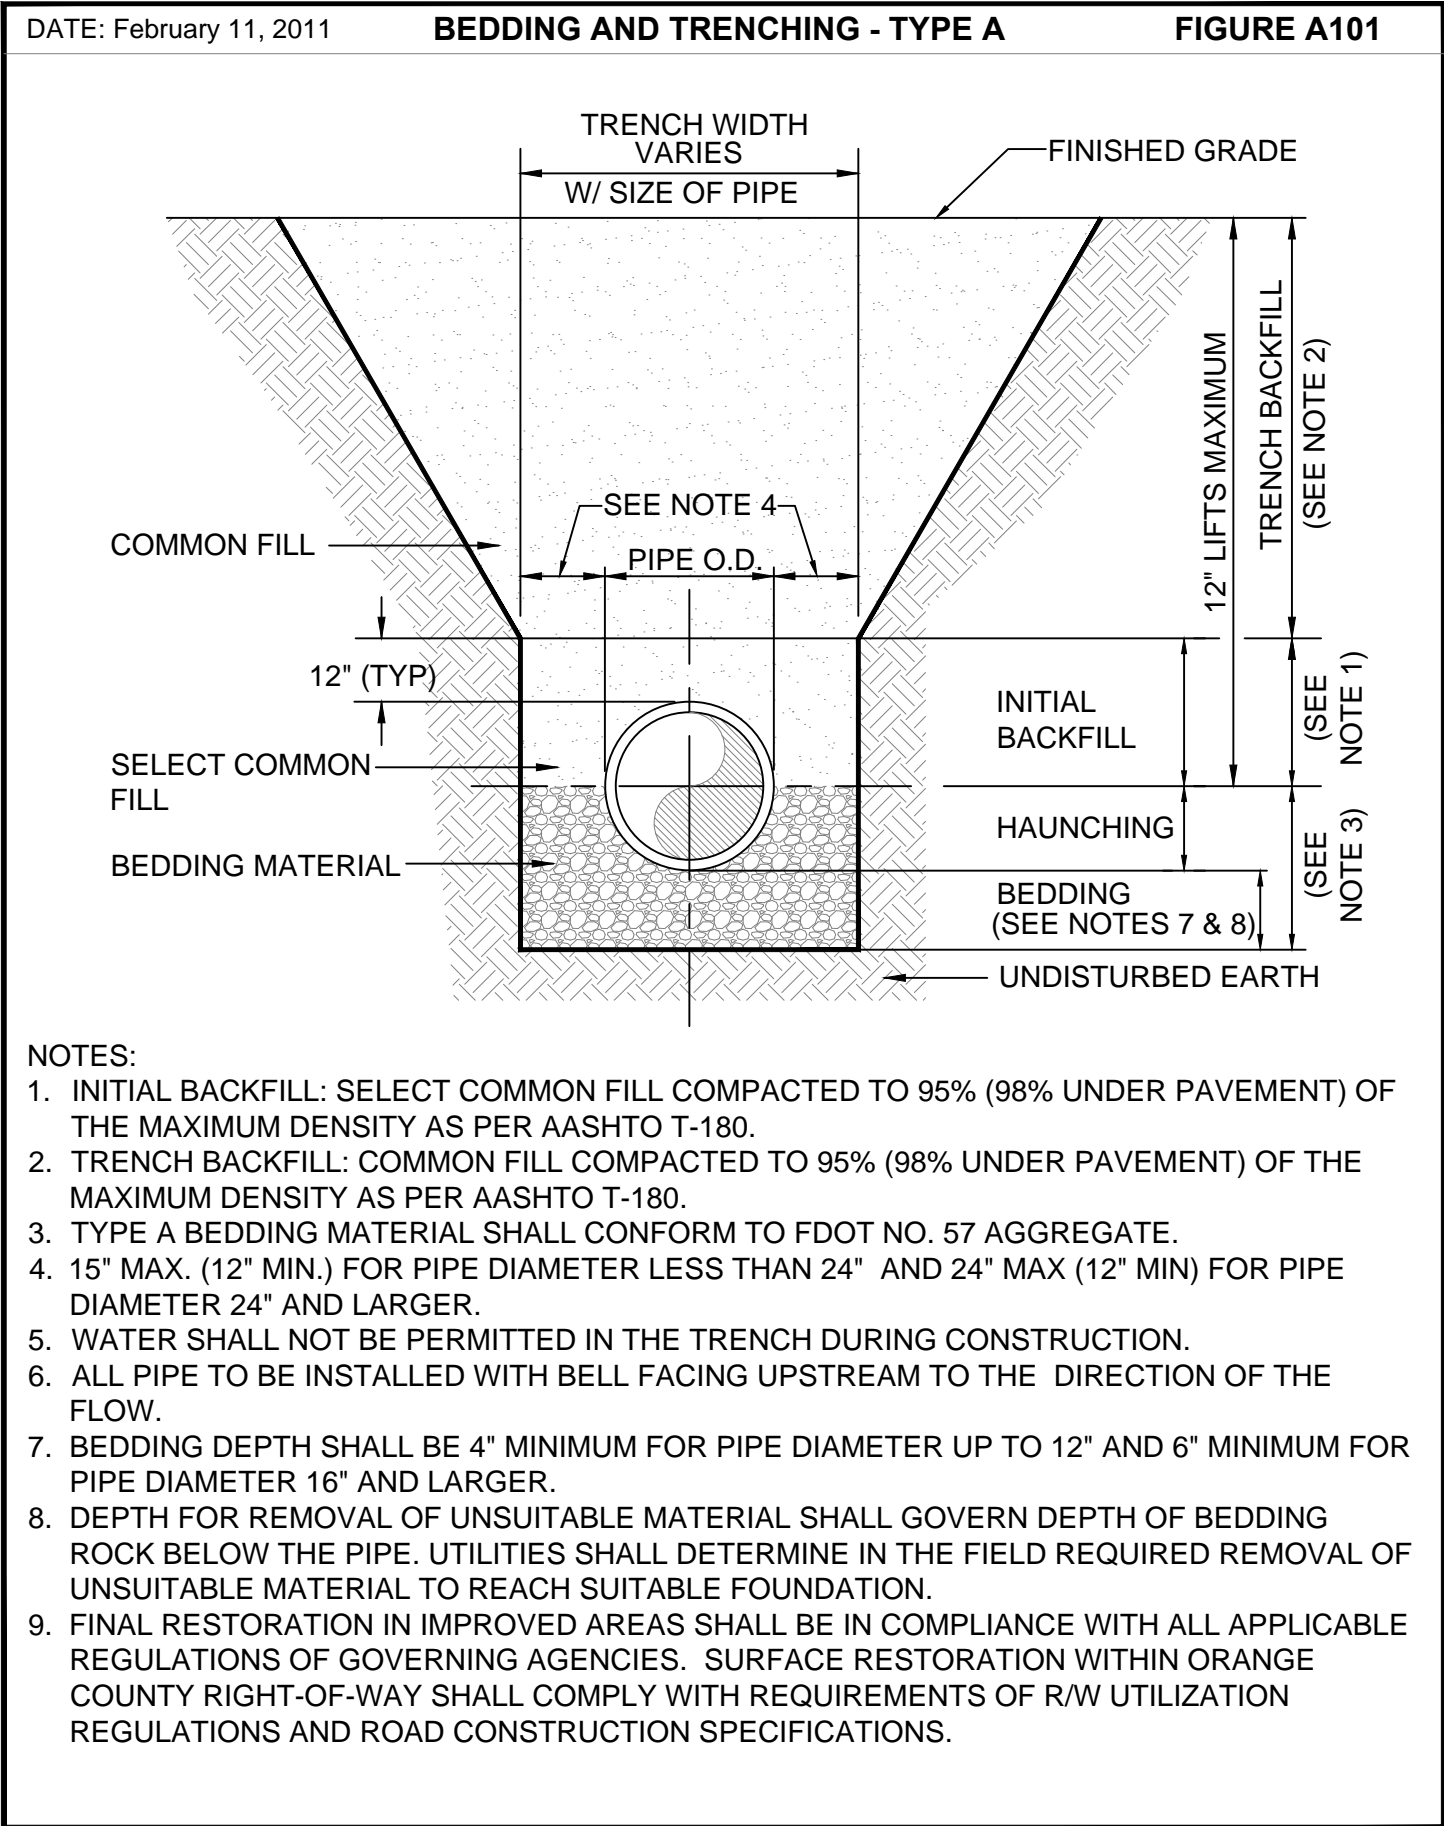
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Survey L.B. No. 7143
Arch. Lic. No. AA2600926
Lndscp. Lic. No. LC0000298

P.S. # 3439 SECLUDED OAKS DRIVE
PUMP PLAN, SECTION AND DETAIL

SCOTT A. BREITENSTEIN
PROFESSIONAL ENGINEER
FLORIDA LICENSE #57402

OCU FILE NO.: 74325
DESIGNED BY: SAB
DRAWN BY: DGH/GCM
CHECKED BY: SAB/DEM
CADD FILE: Pump Station Details.dwg

SCALE: N.T.S.
DRAWING NO.:
P300
SHEET: 22 OF 40



REV	DATE	DESCRIPTION

LINE IS 2 INCHES
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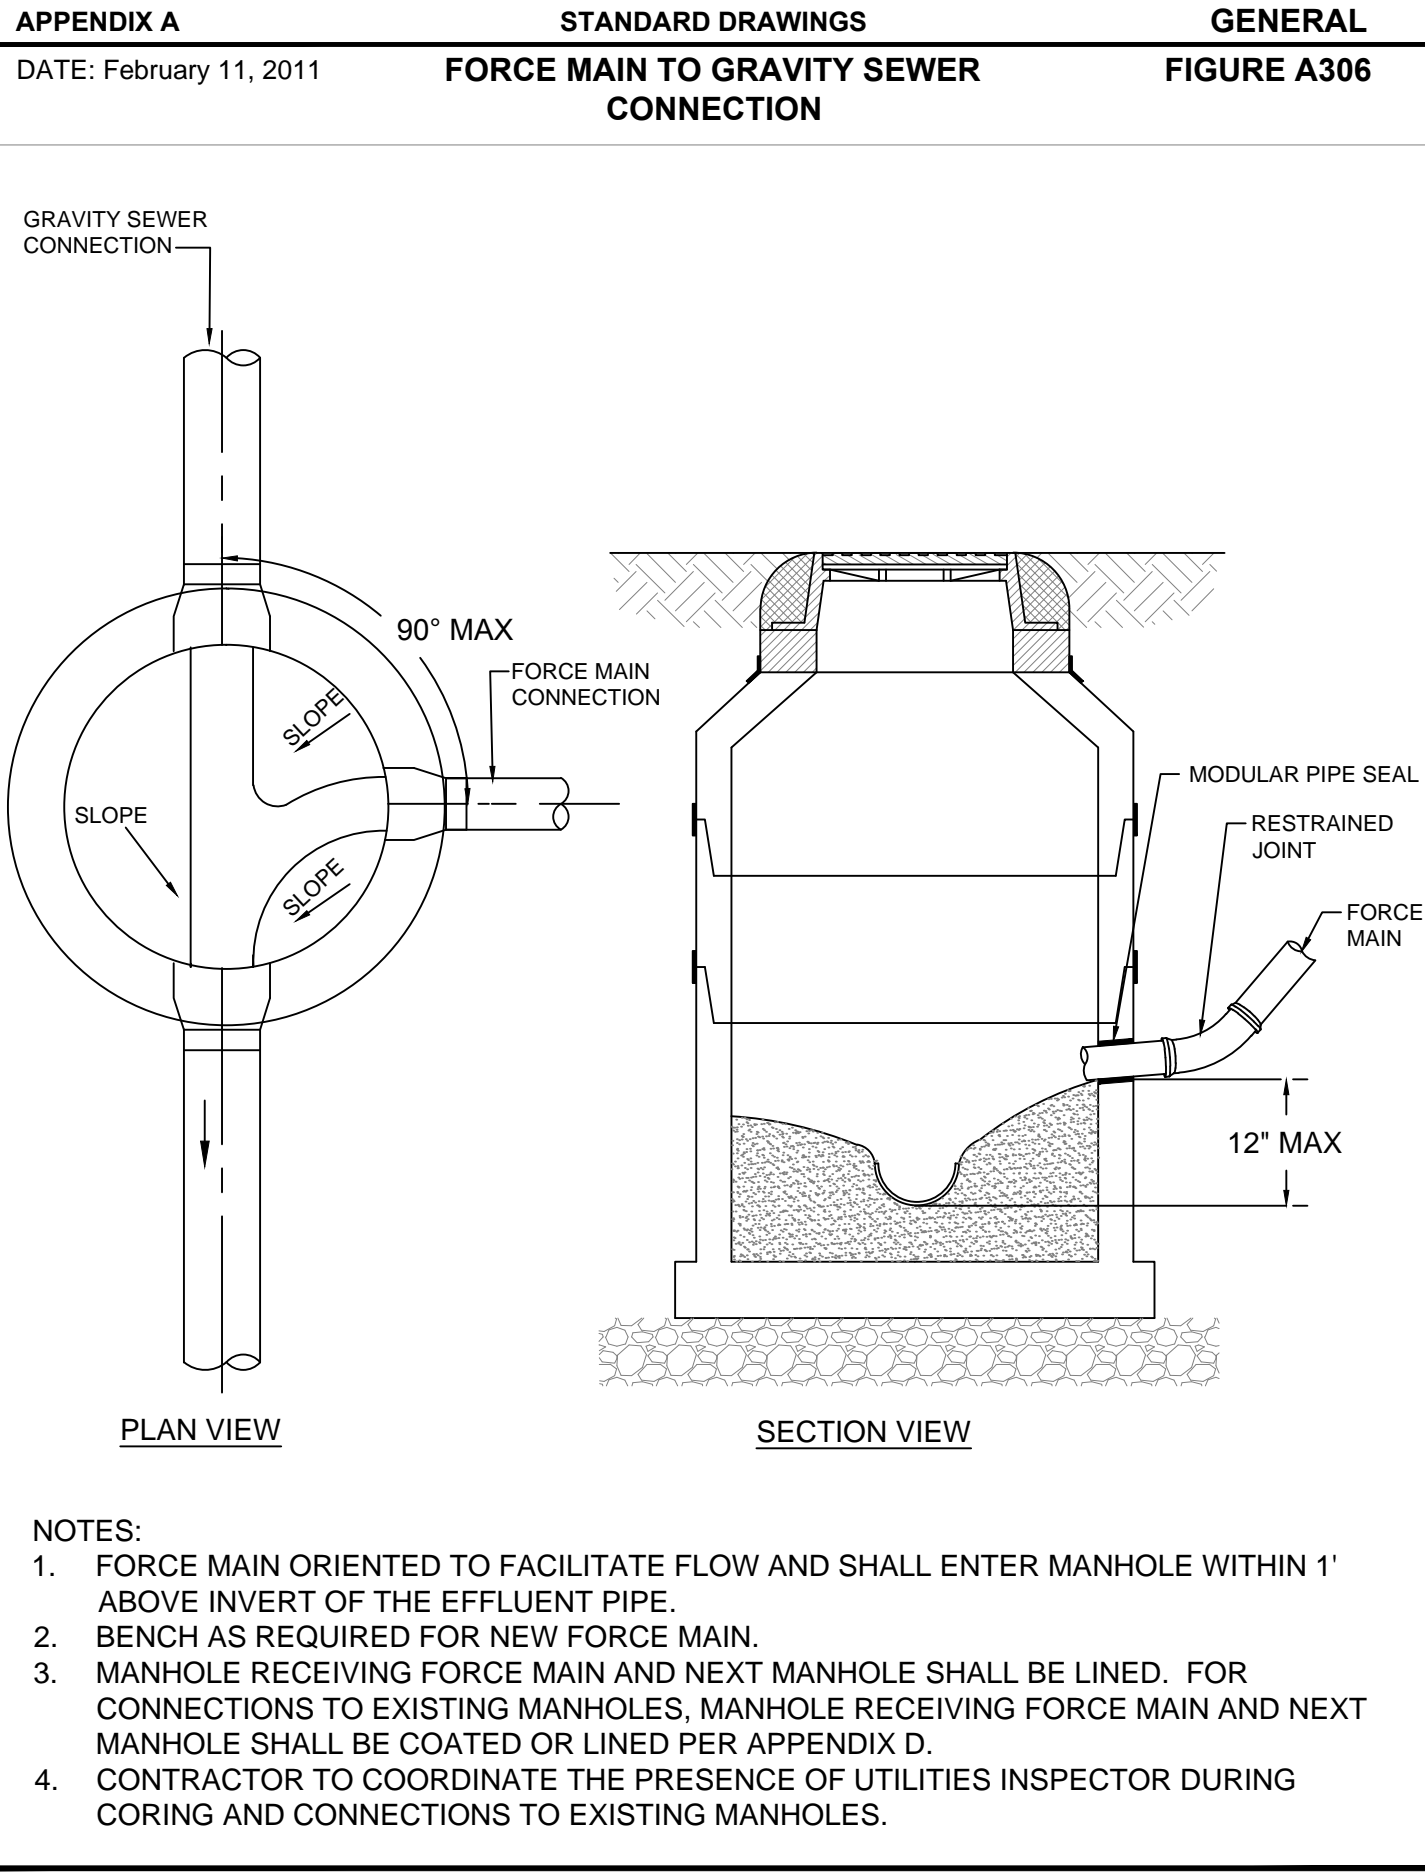
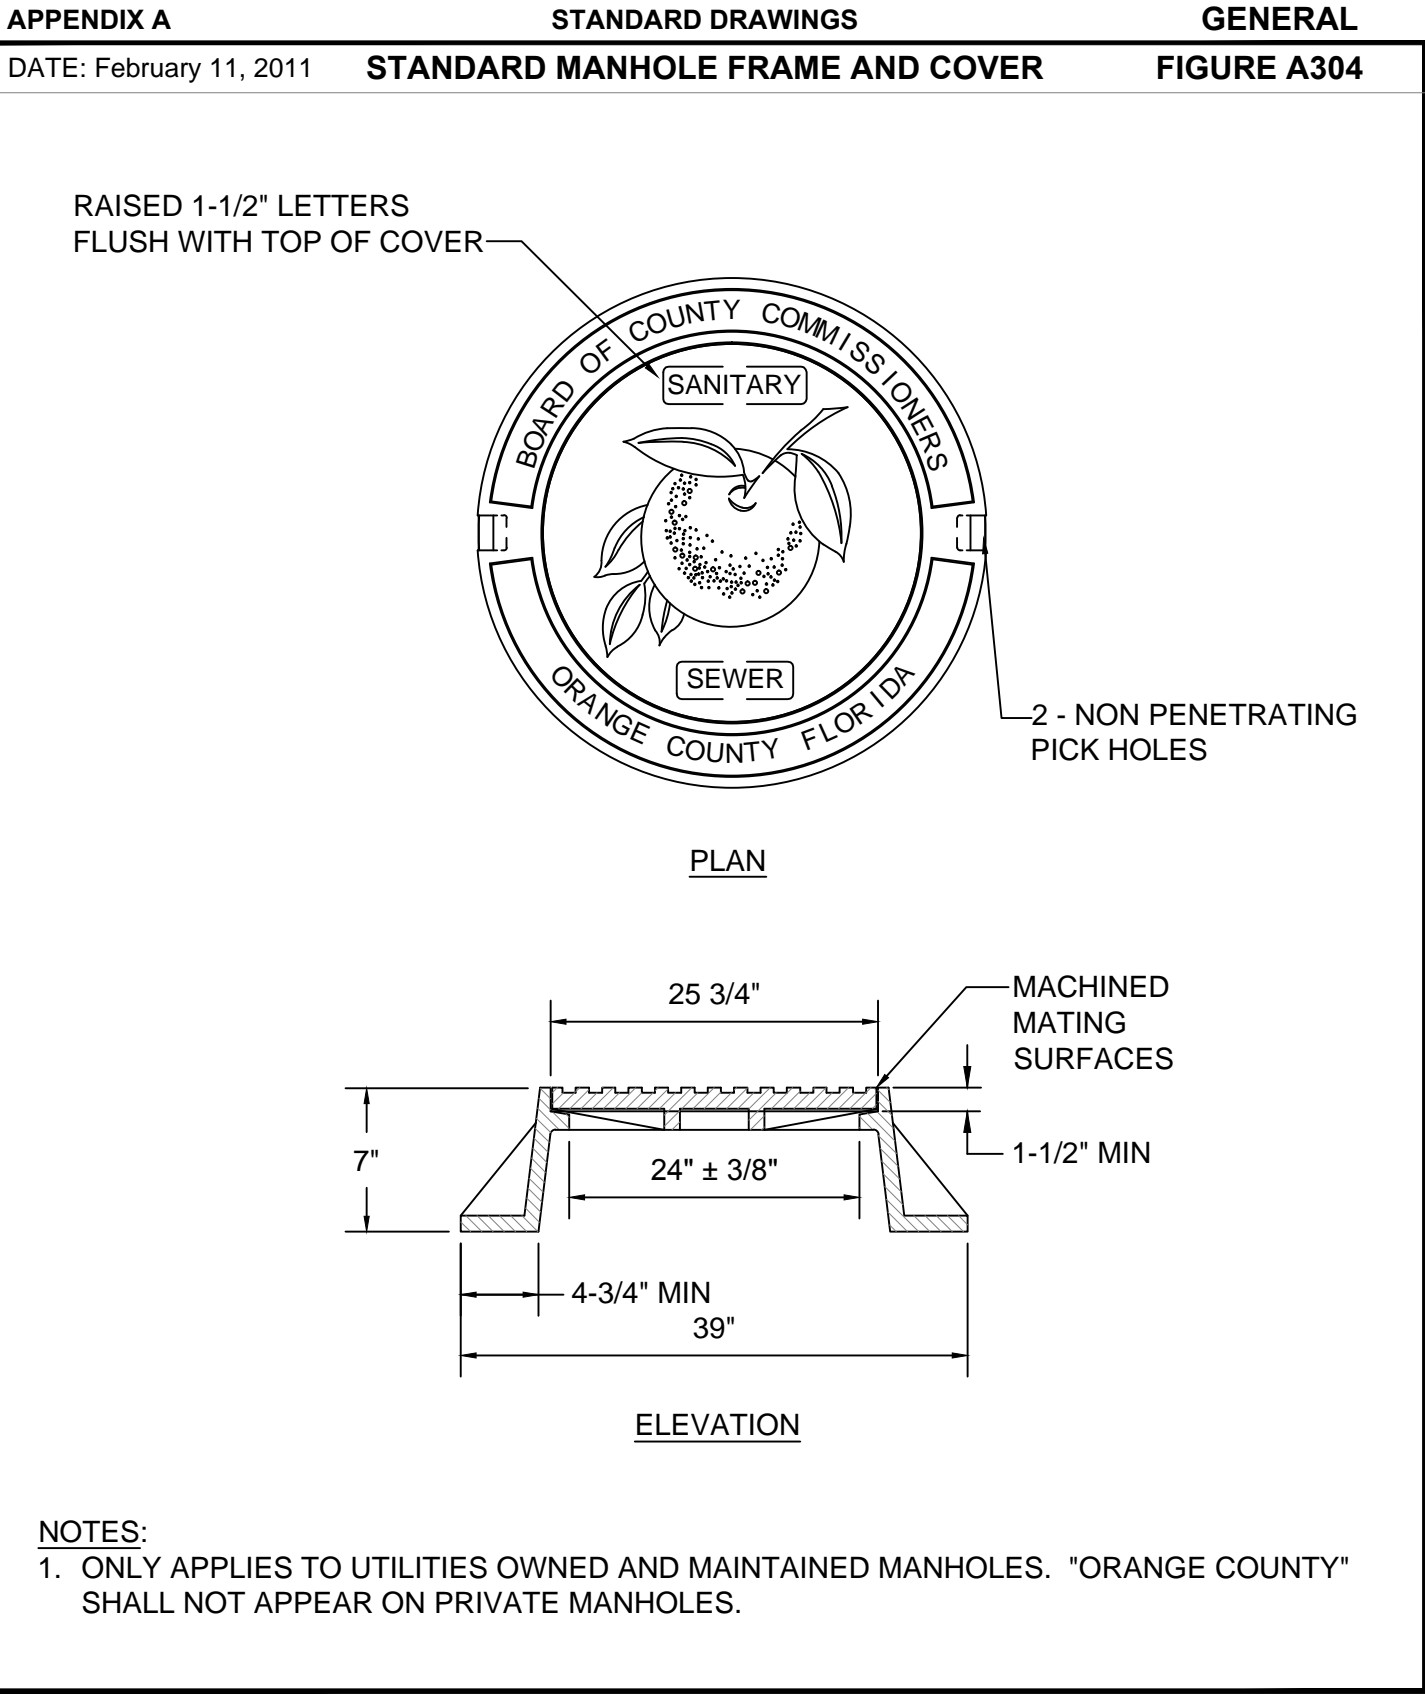
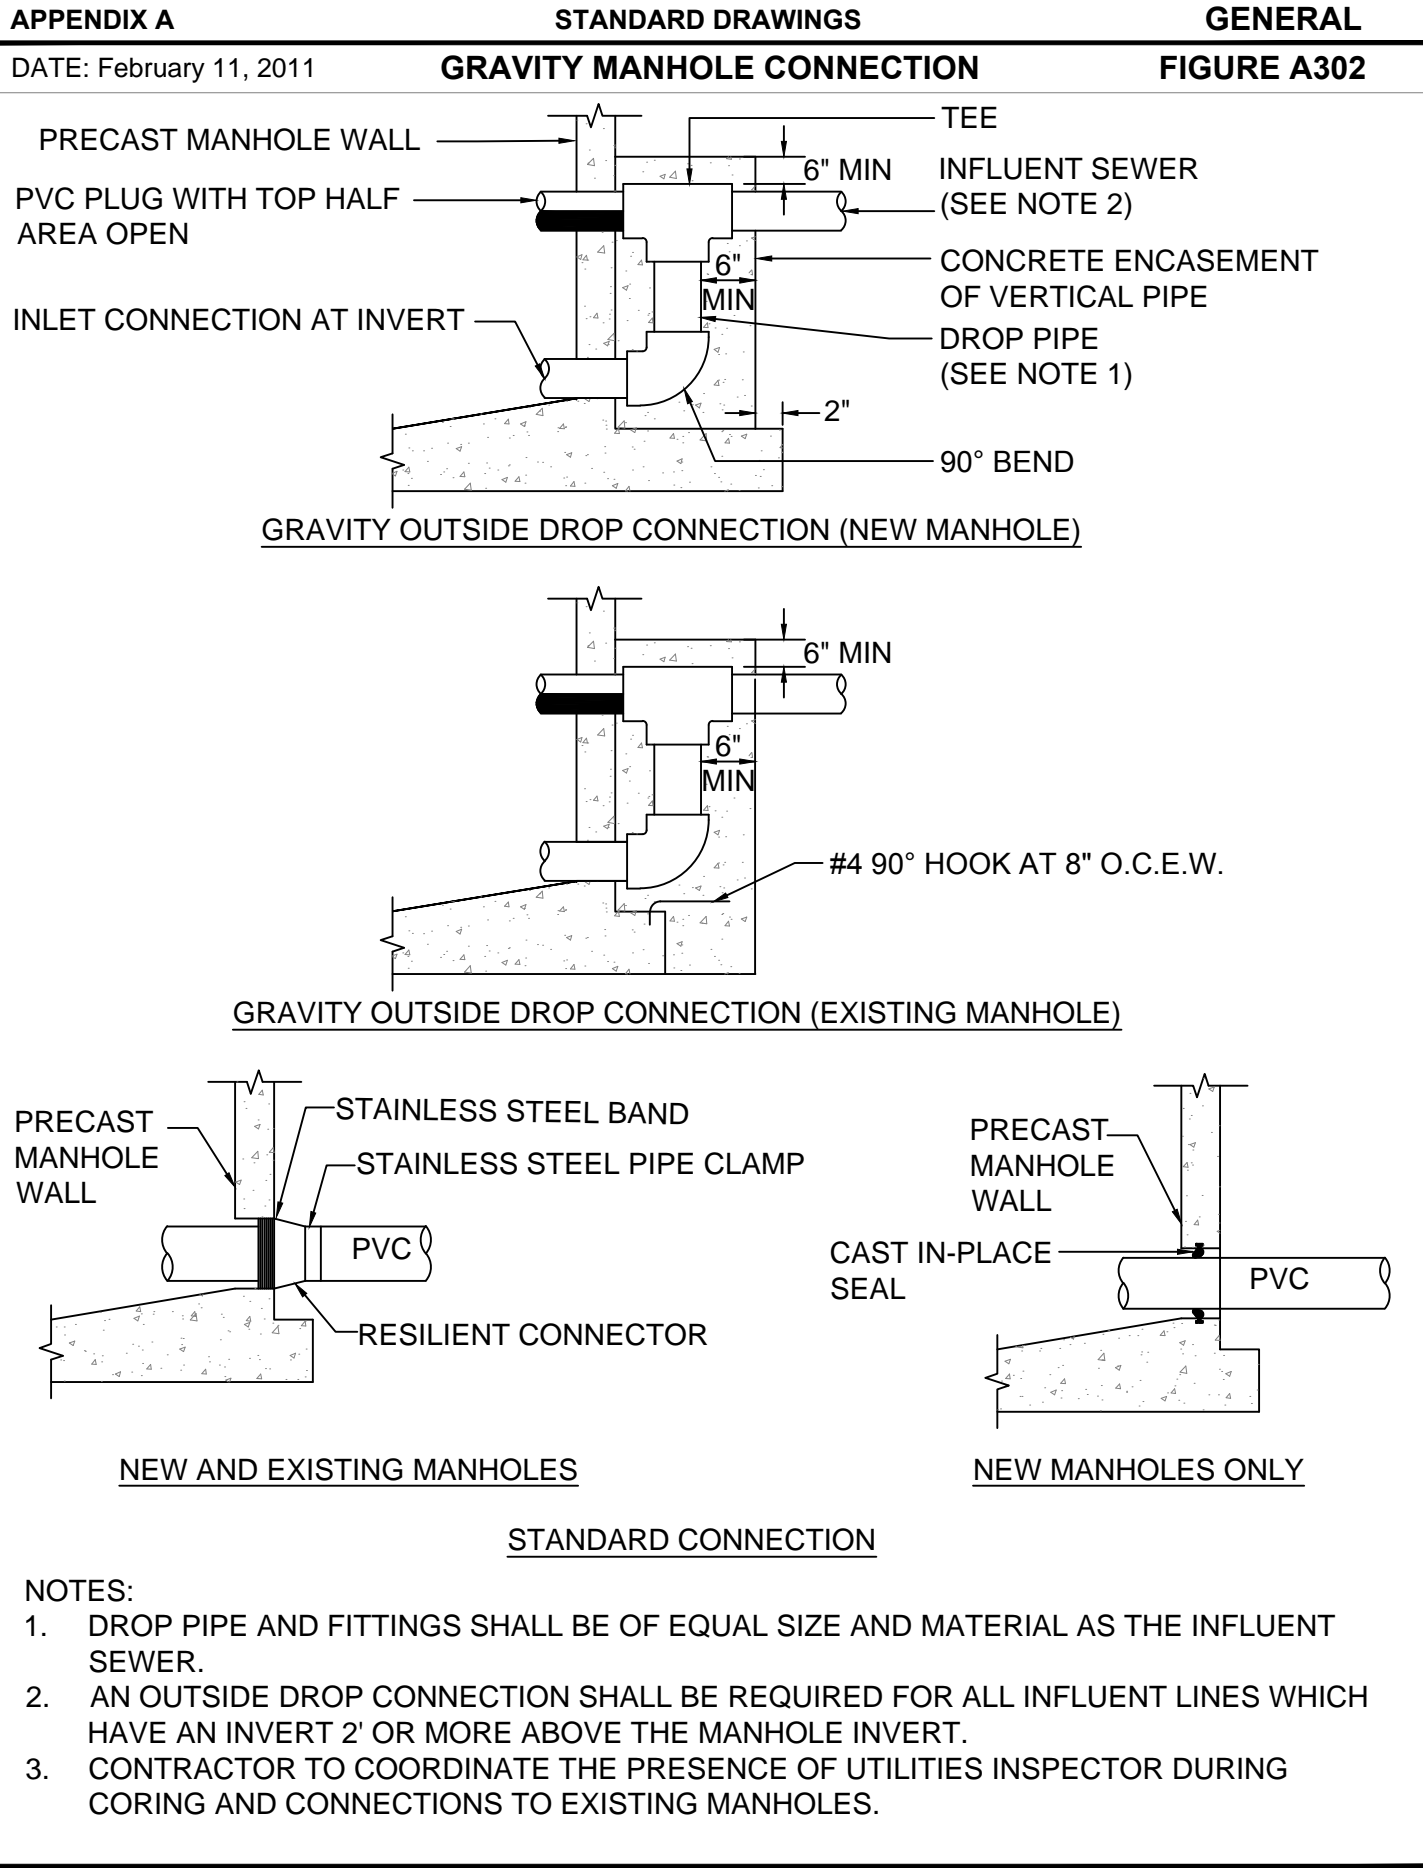
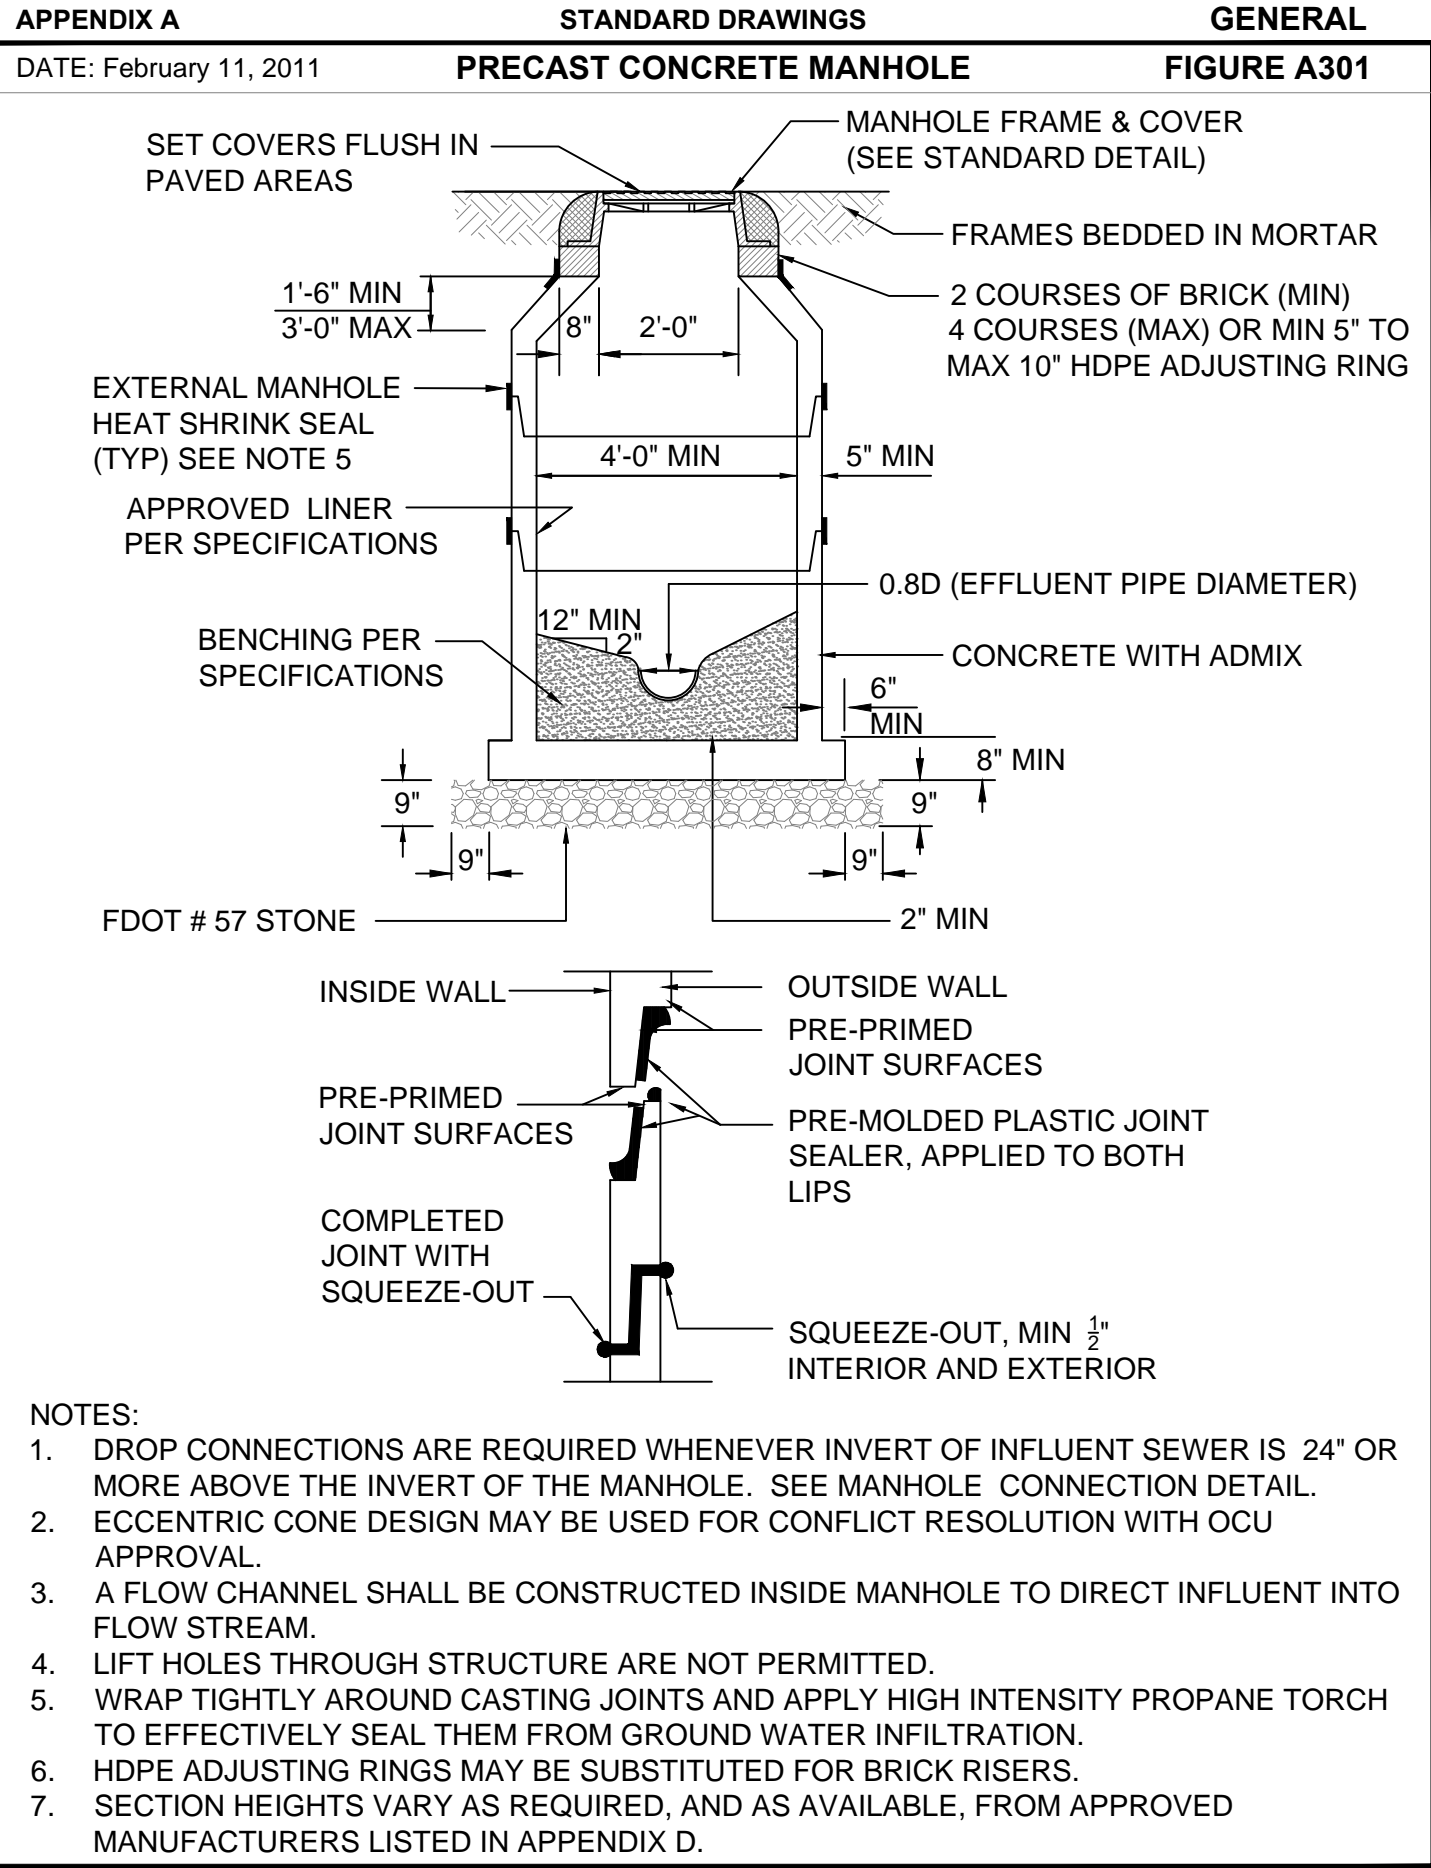
Licenses:
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Survey L.B. No. 7143
Arch. Lic. No. AA2609926
Lndscp. Lic. No. LC0000296

CONSTRUCTION DETAILS
MANHOLE AND PIPE INSTALLATION

SCOTT A. BREITENSTEIN
PROFESSIONAL ENGINEER
FLORIDA LICENSE #57402

OCU FILE NO.: 74325
DESIGNED BY: SAB
DRAWN BY: DGH/GCM
CHECKED BY: SAB/DEM
CADD FILE: Construction Details.dwg

SCALE: NONE
DRAWING NO.:
D100
SHEET: 23 OF 40



REV	DATE	DESCRIPTION

LINE IS 2 INCHES
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Landscape Lic. No. LC0000298





1117 East Robinson Street - Orlando, FL 32801 - Phone: 407.425.0452

CONSTRUCTION DETAILS
MANHOLE AND PIPE INSTALLATION

SCOTT A. BREITENSTEIN
PROFESSIONAL ENGINEER
FLORIDA LICENSE #57402

OCU FILE NO.: 74325
DESIGNED BY: SAB
DRAWN BY: DGH/GCM
CHECKED BY: SAB/DEM
CADD FILE: Construction Details.dwg

SCALE: NONE
DRAWING NO.:
D110
SHEET: 24 OF 40

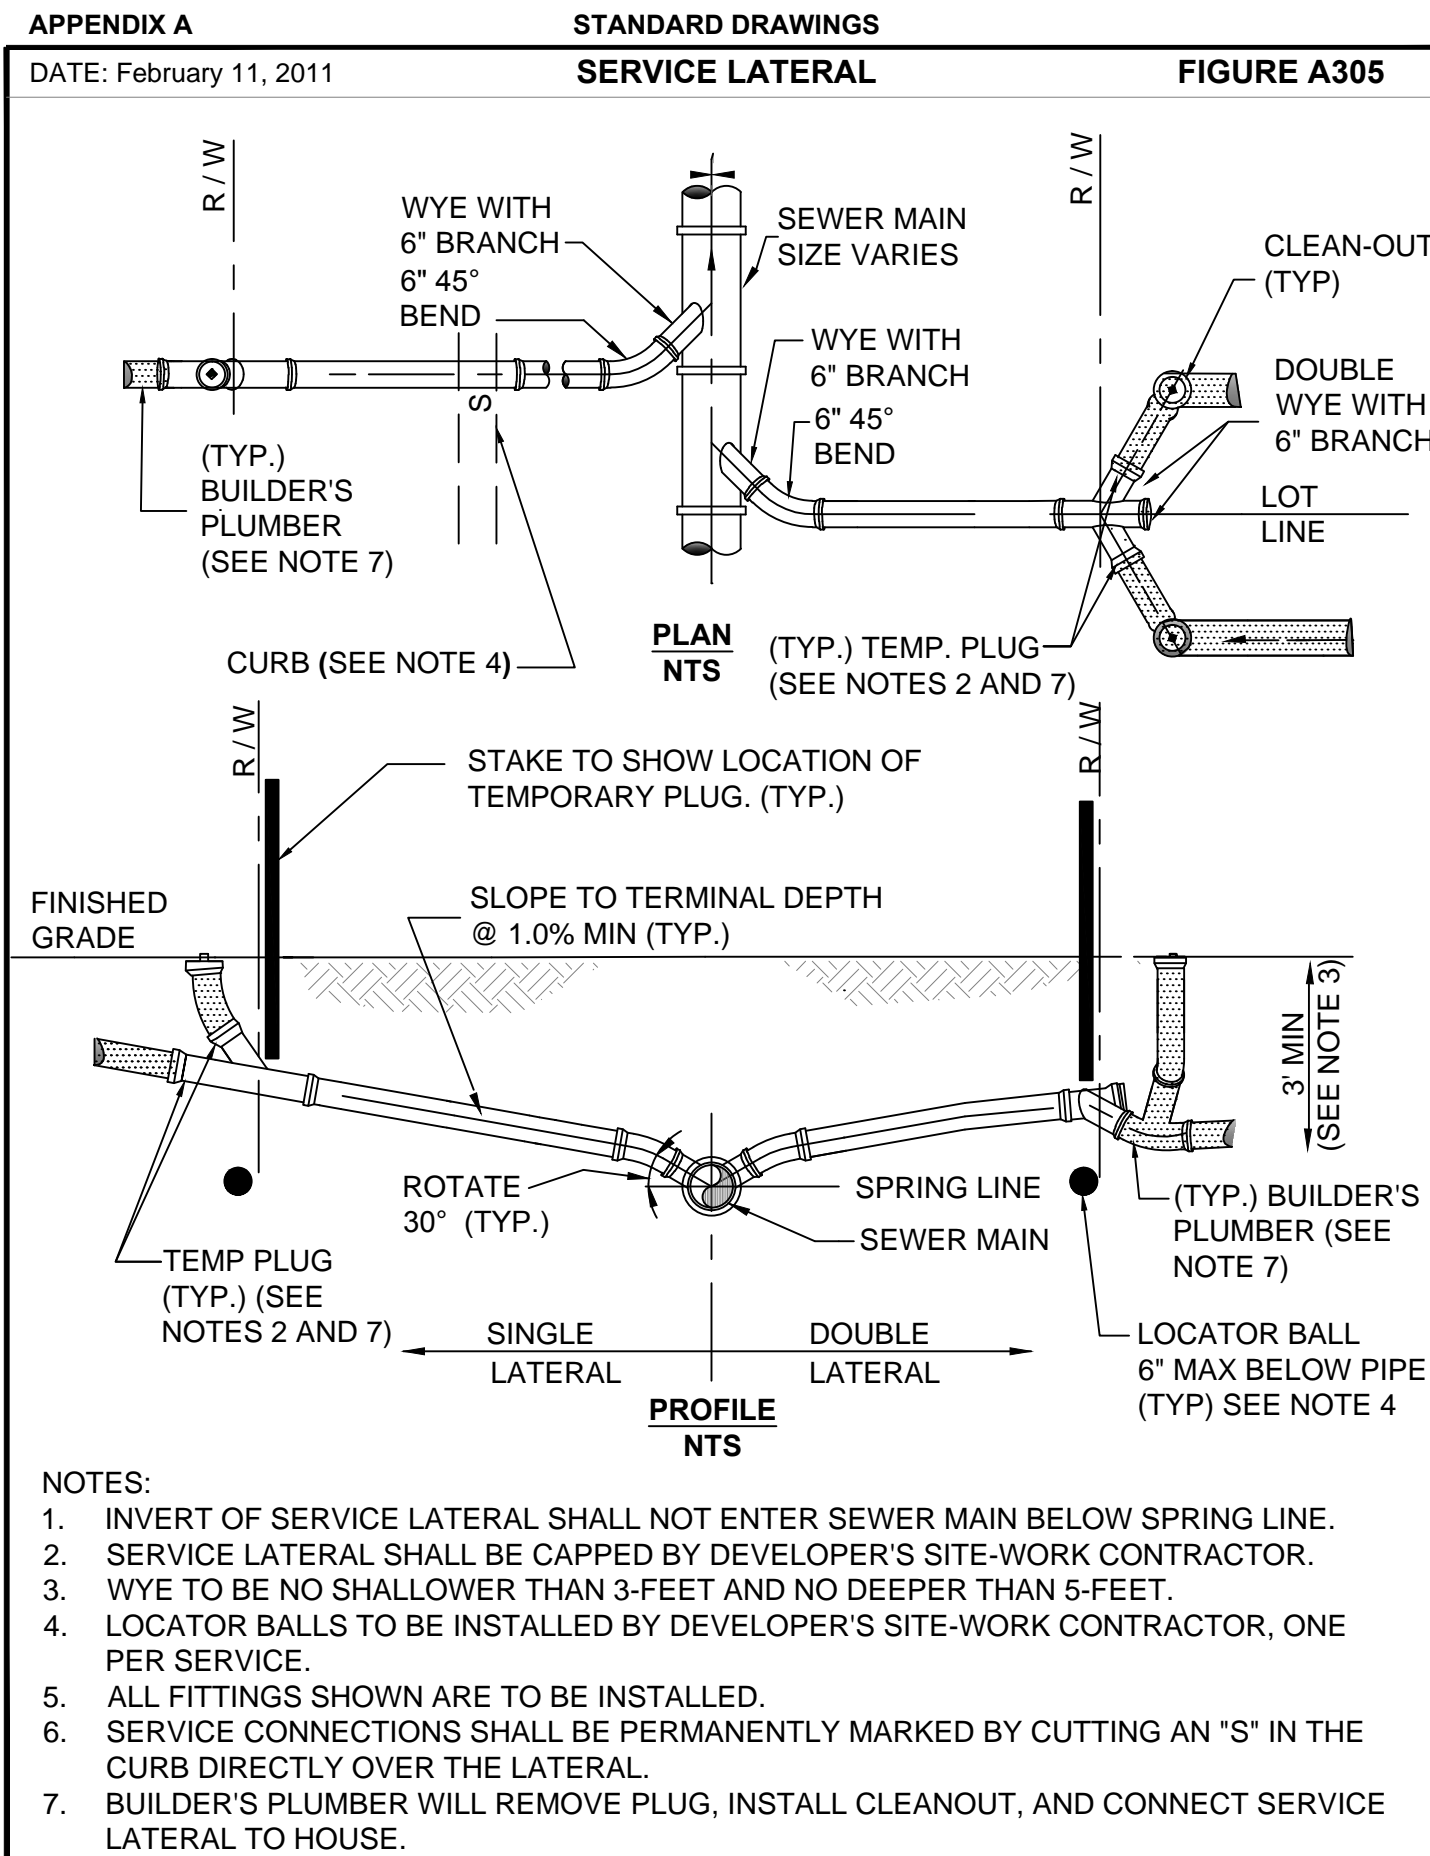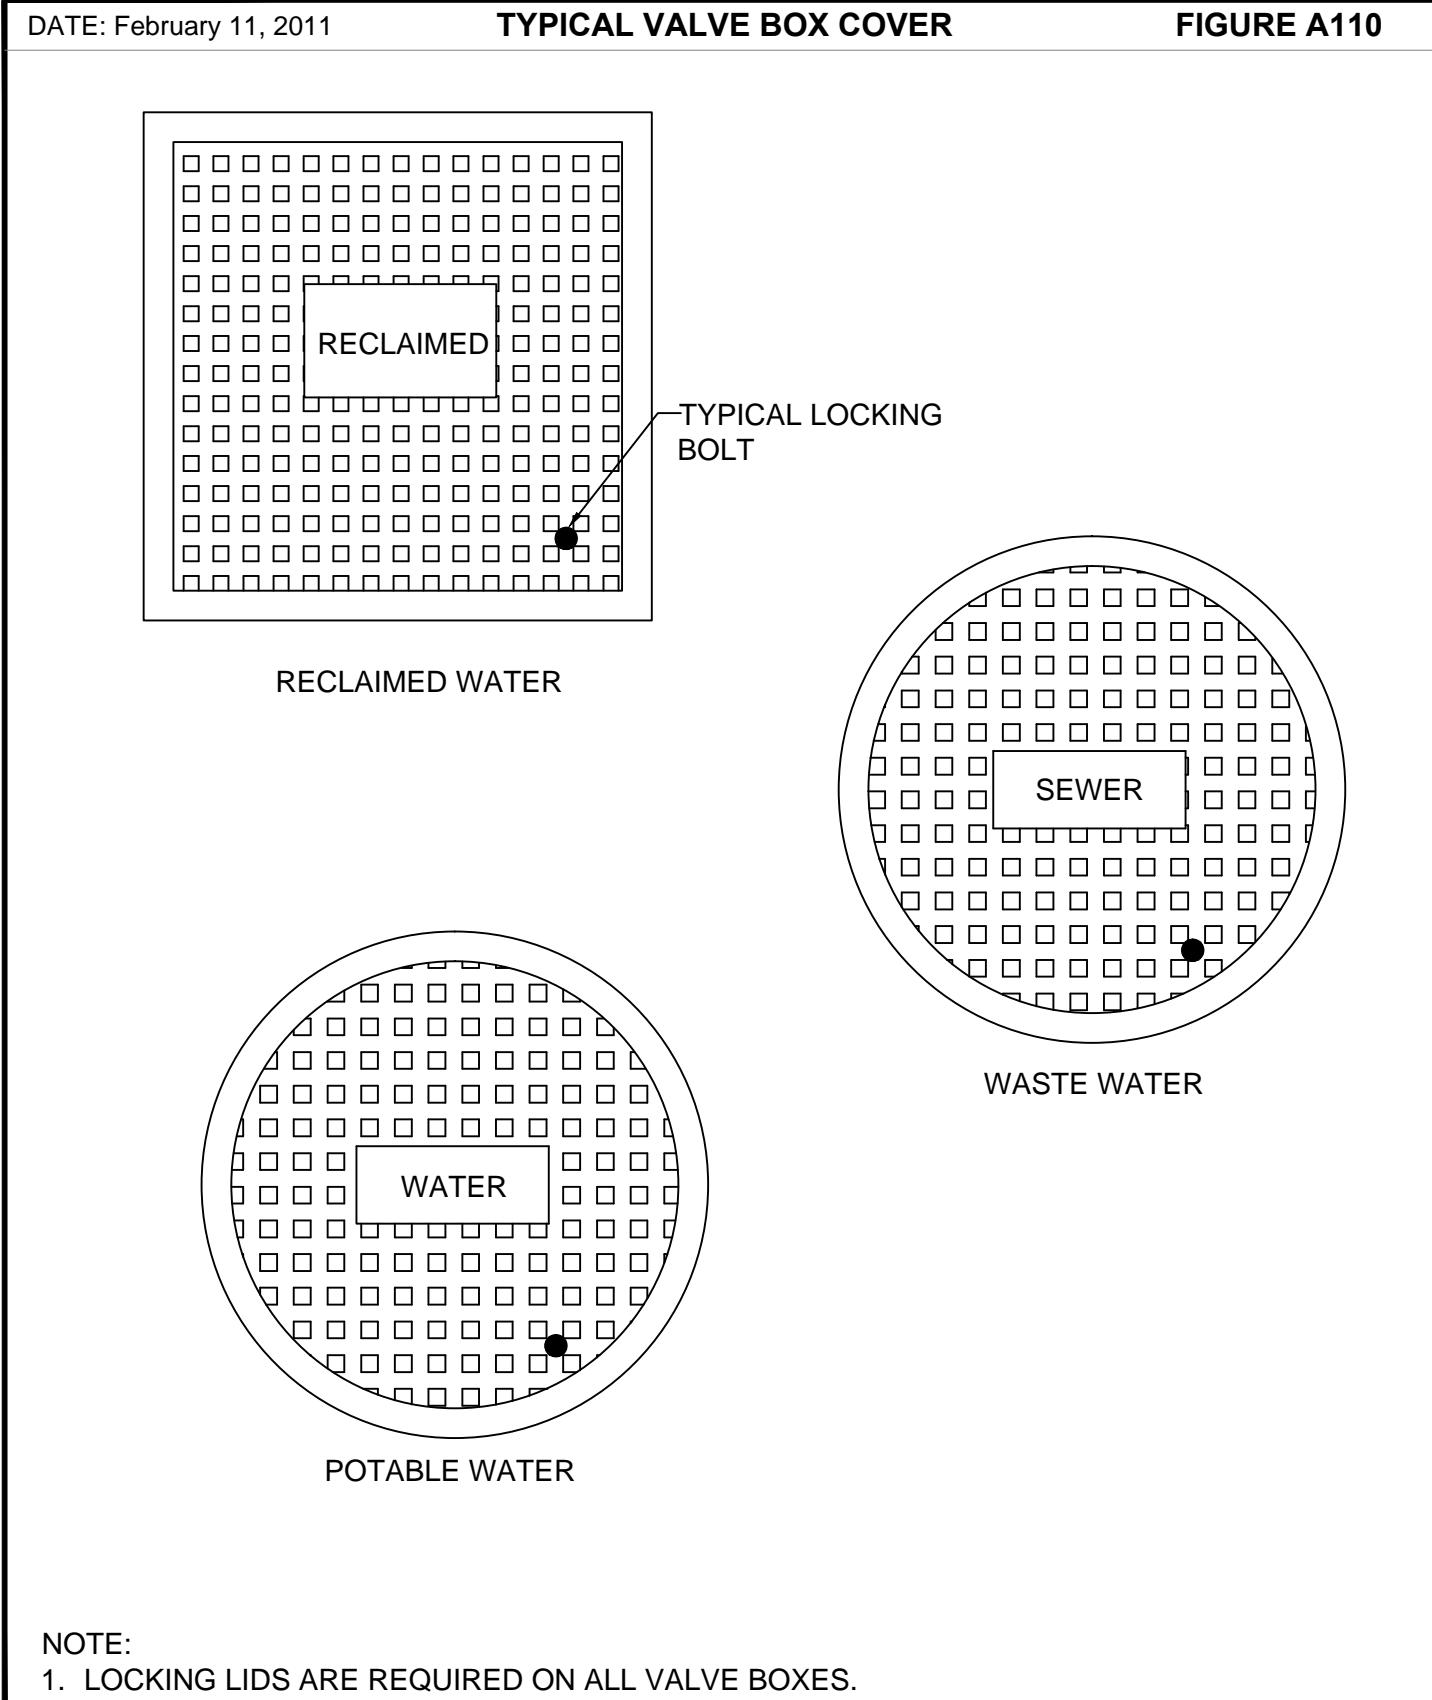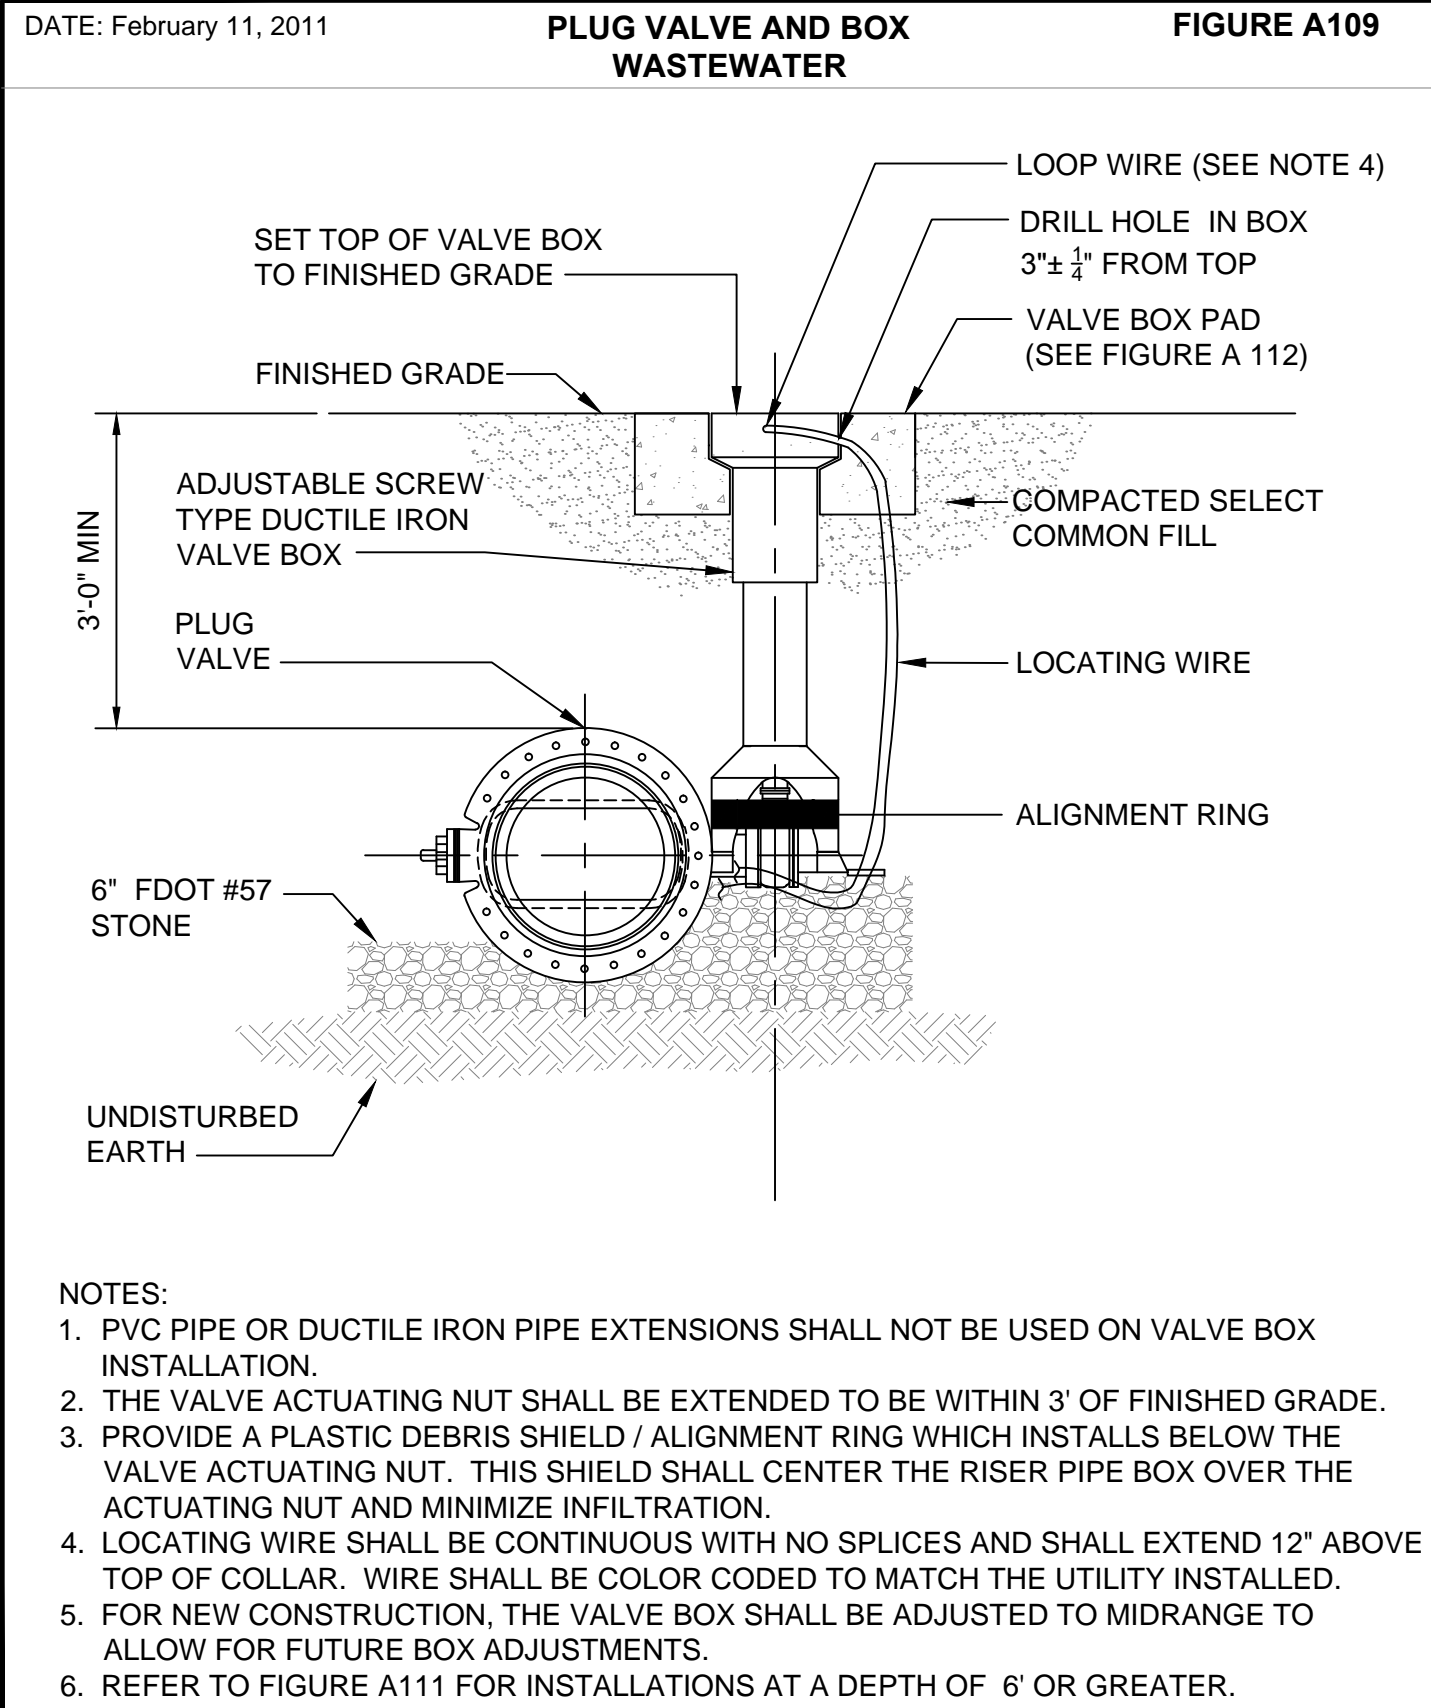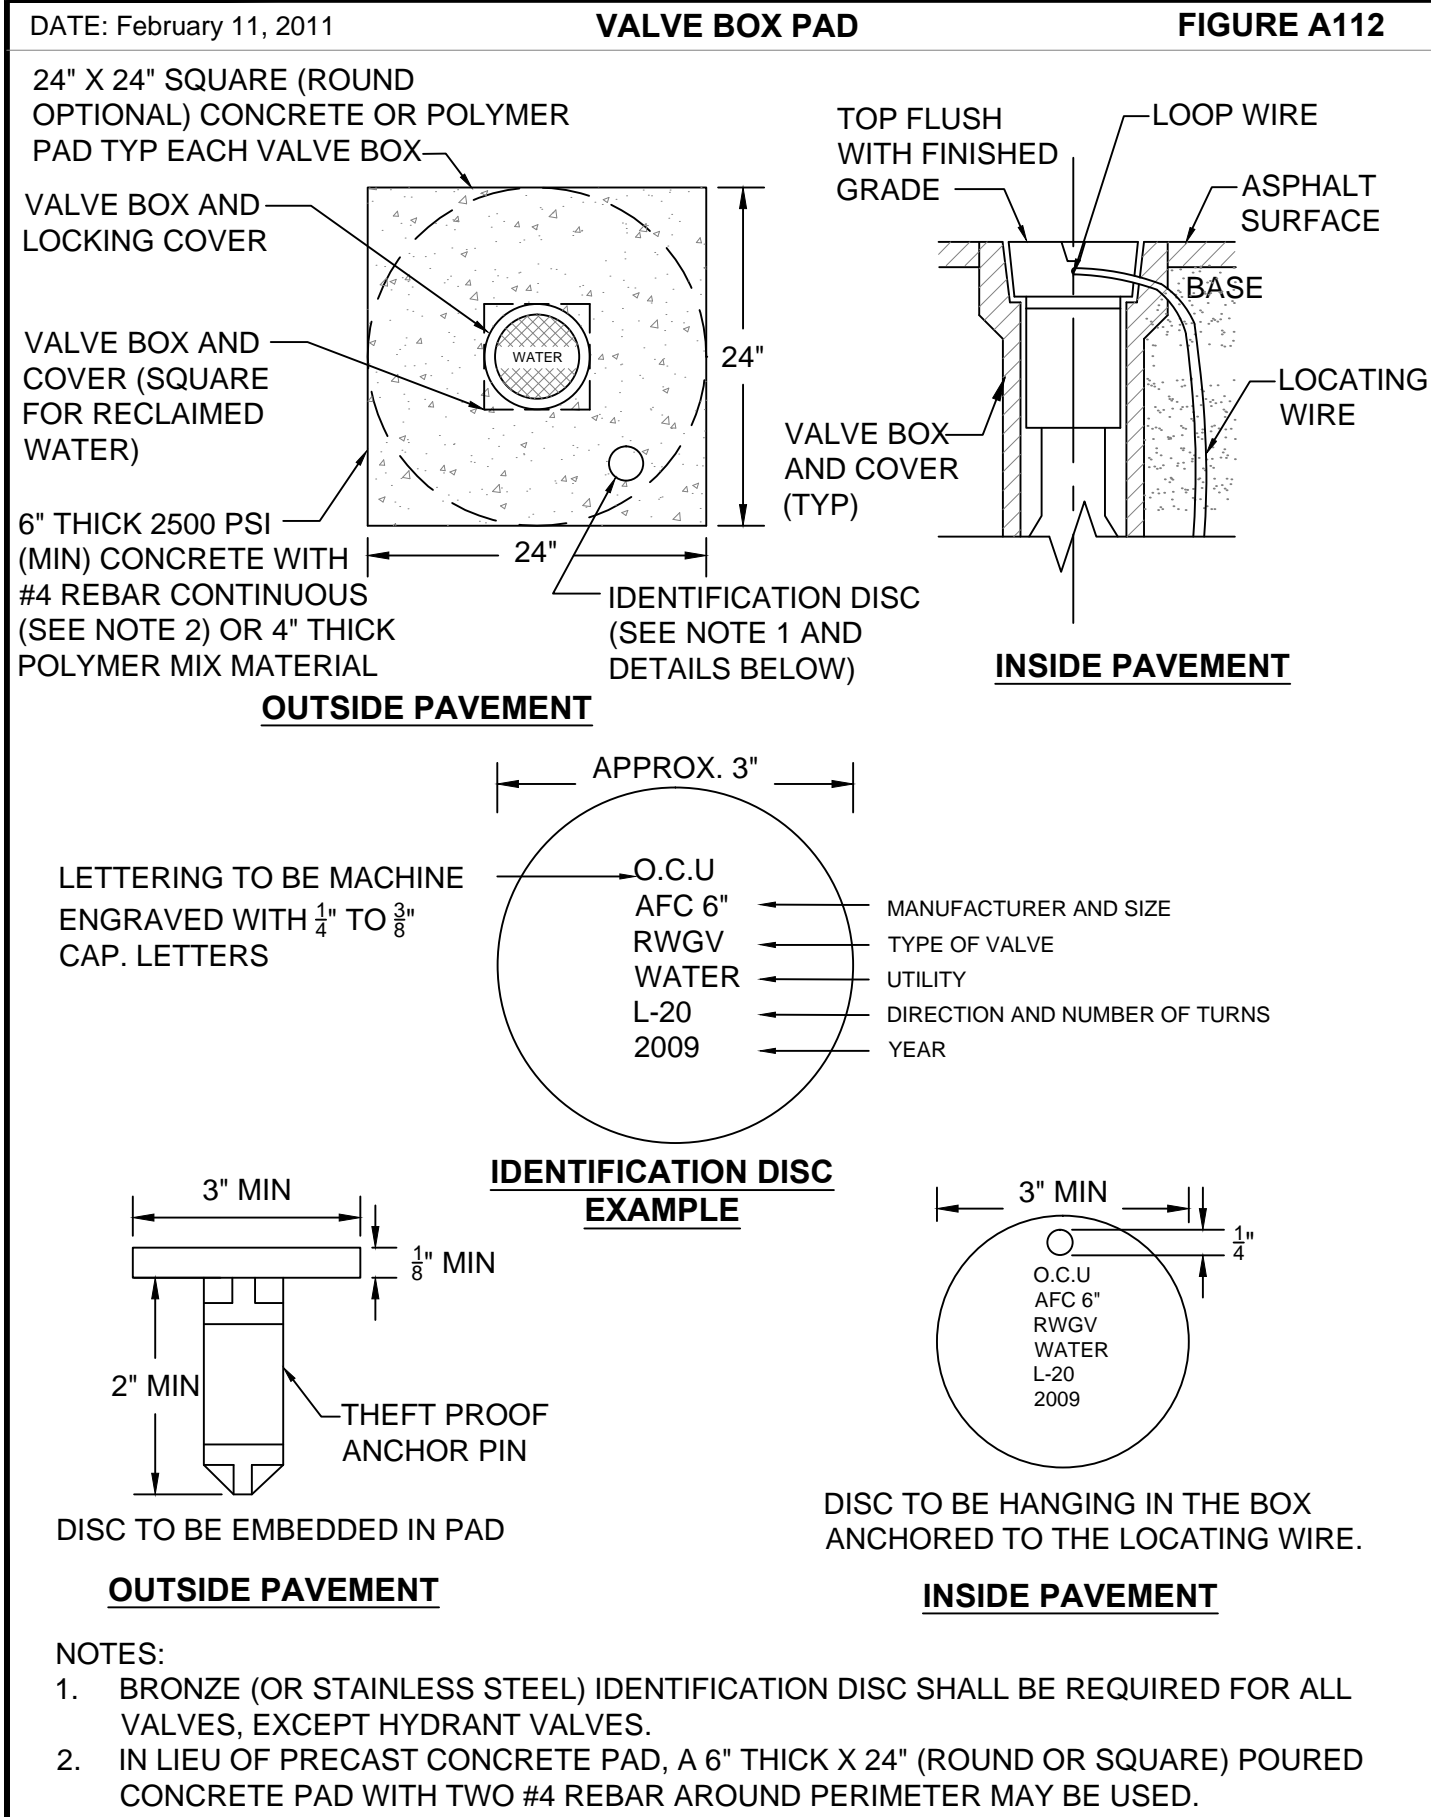

REV	DATE	DESCRIPTION

LINE IS 2 INCHES
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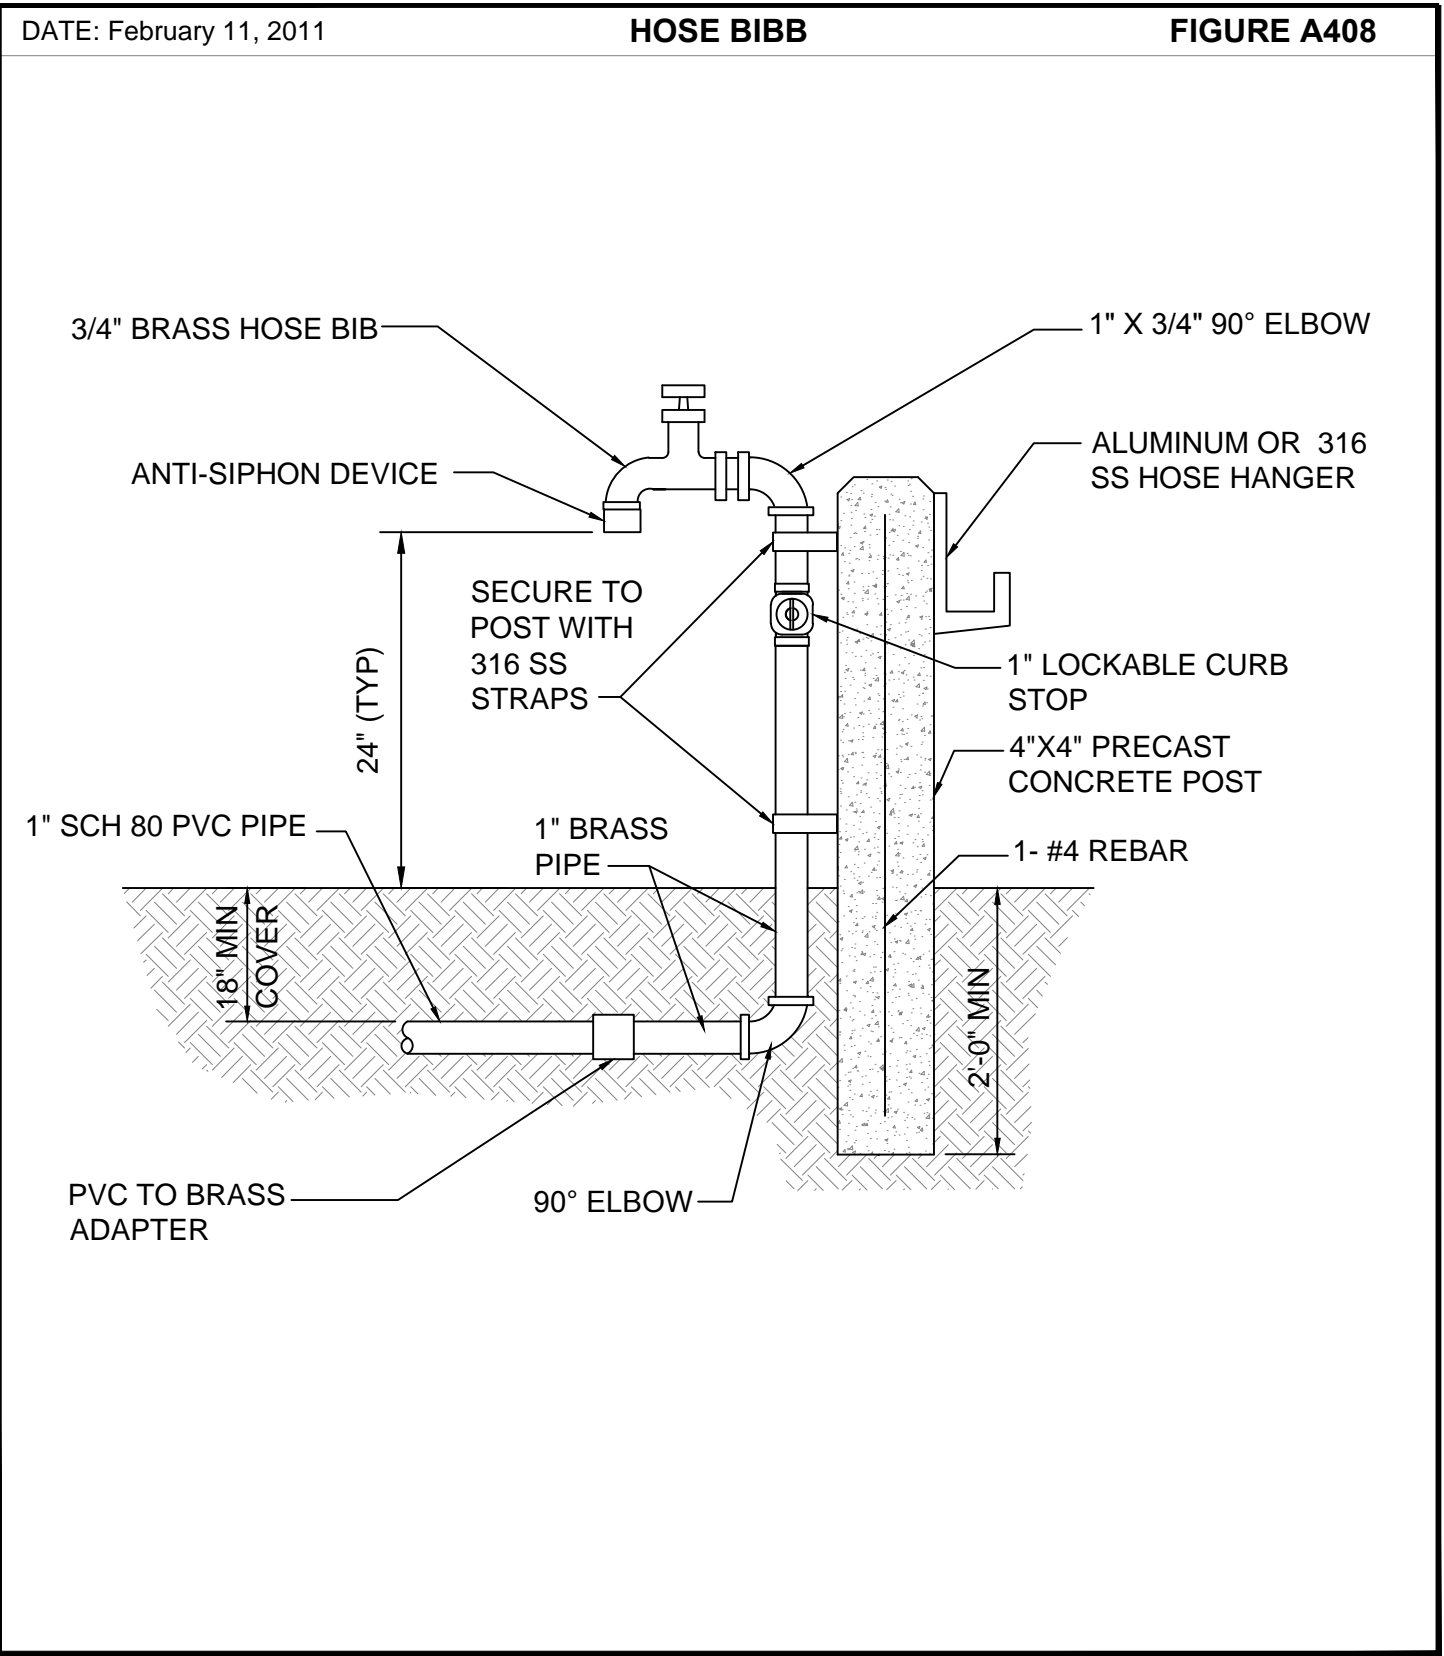
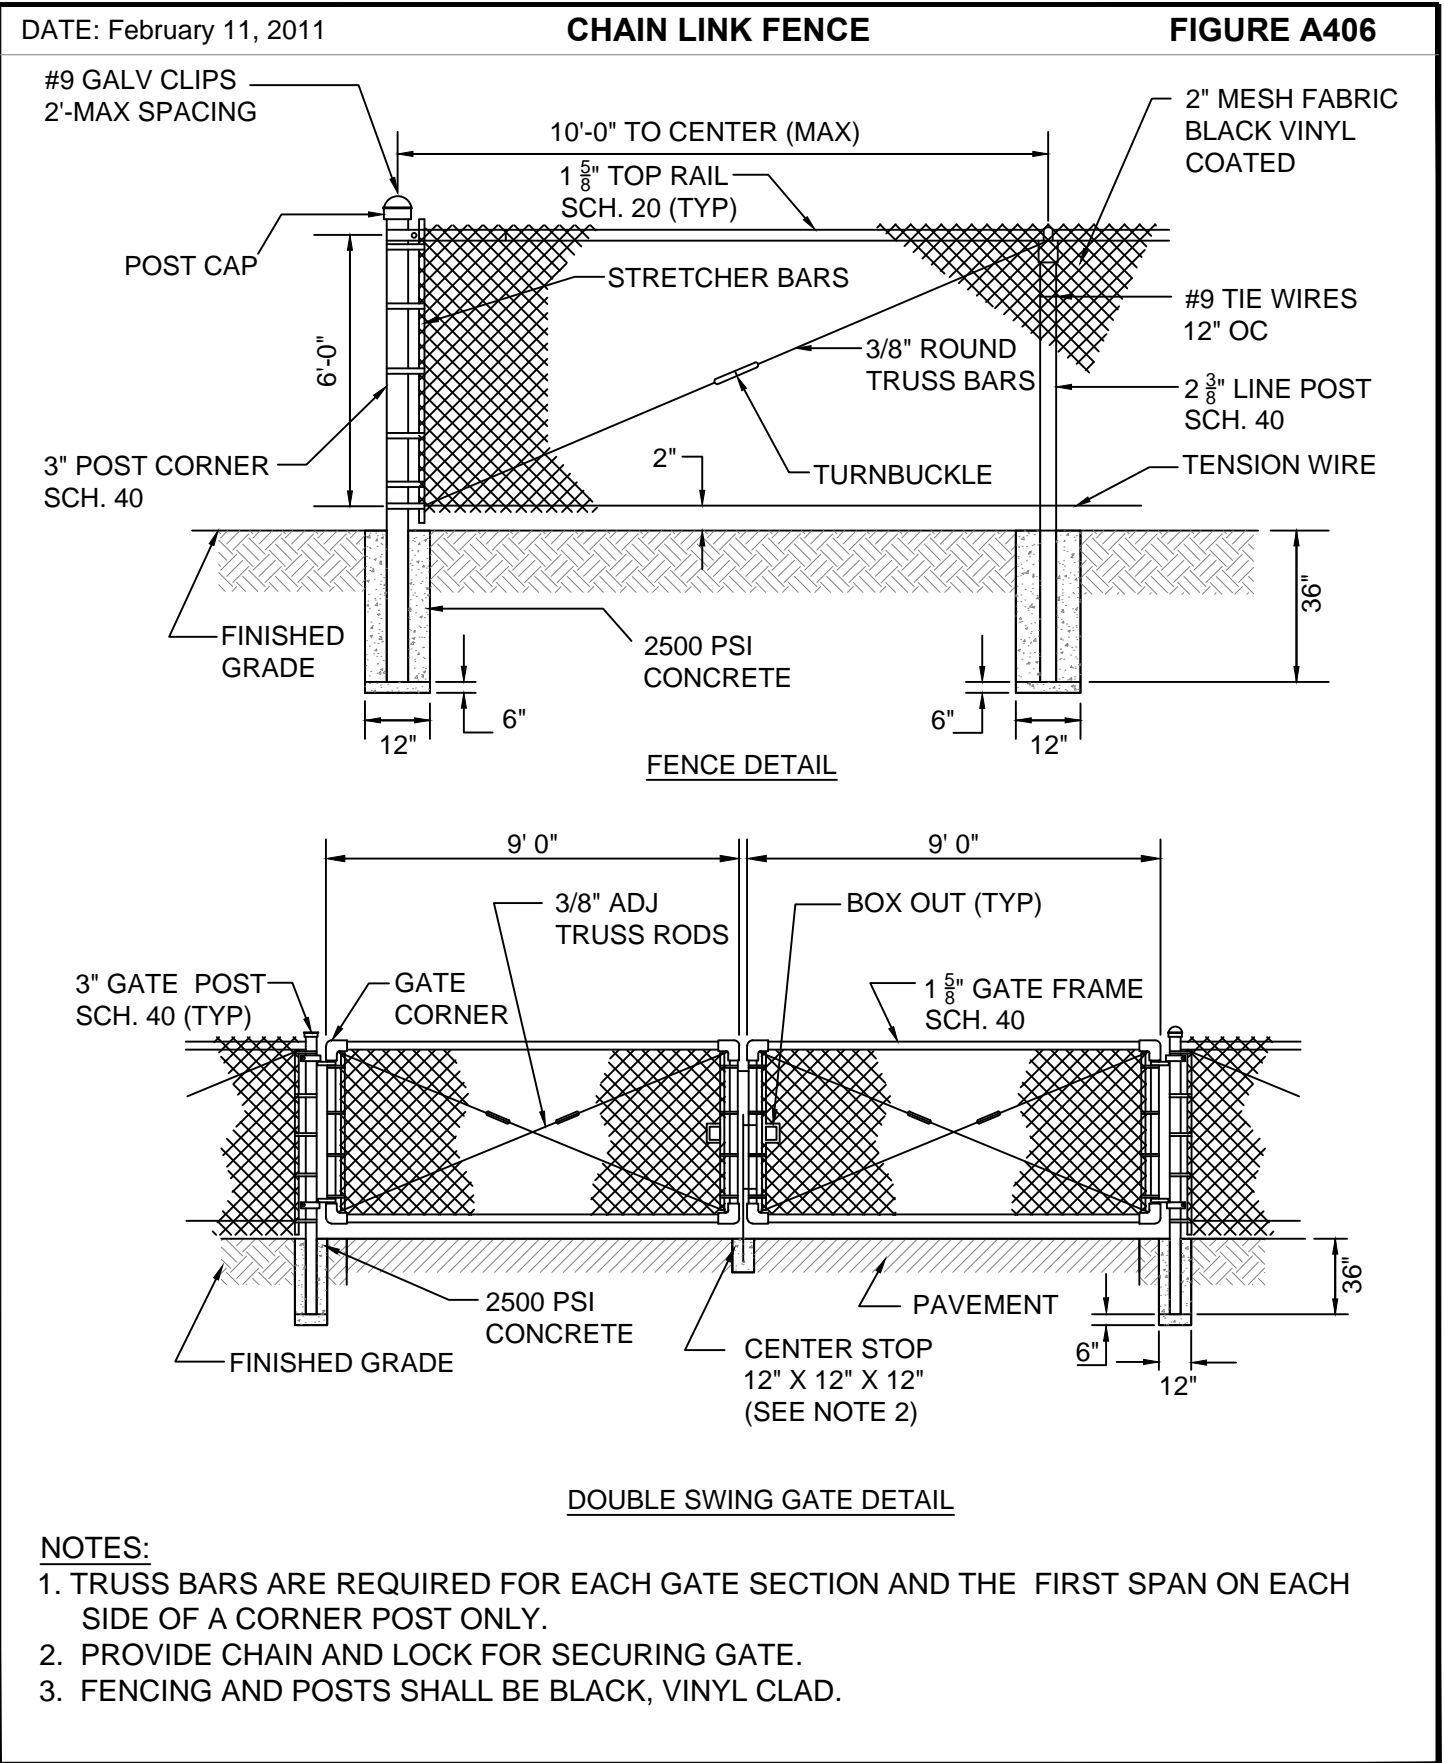
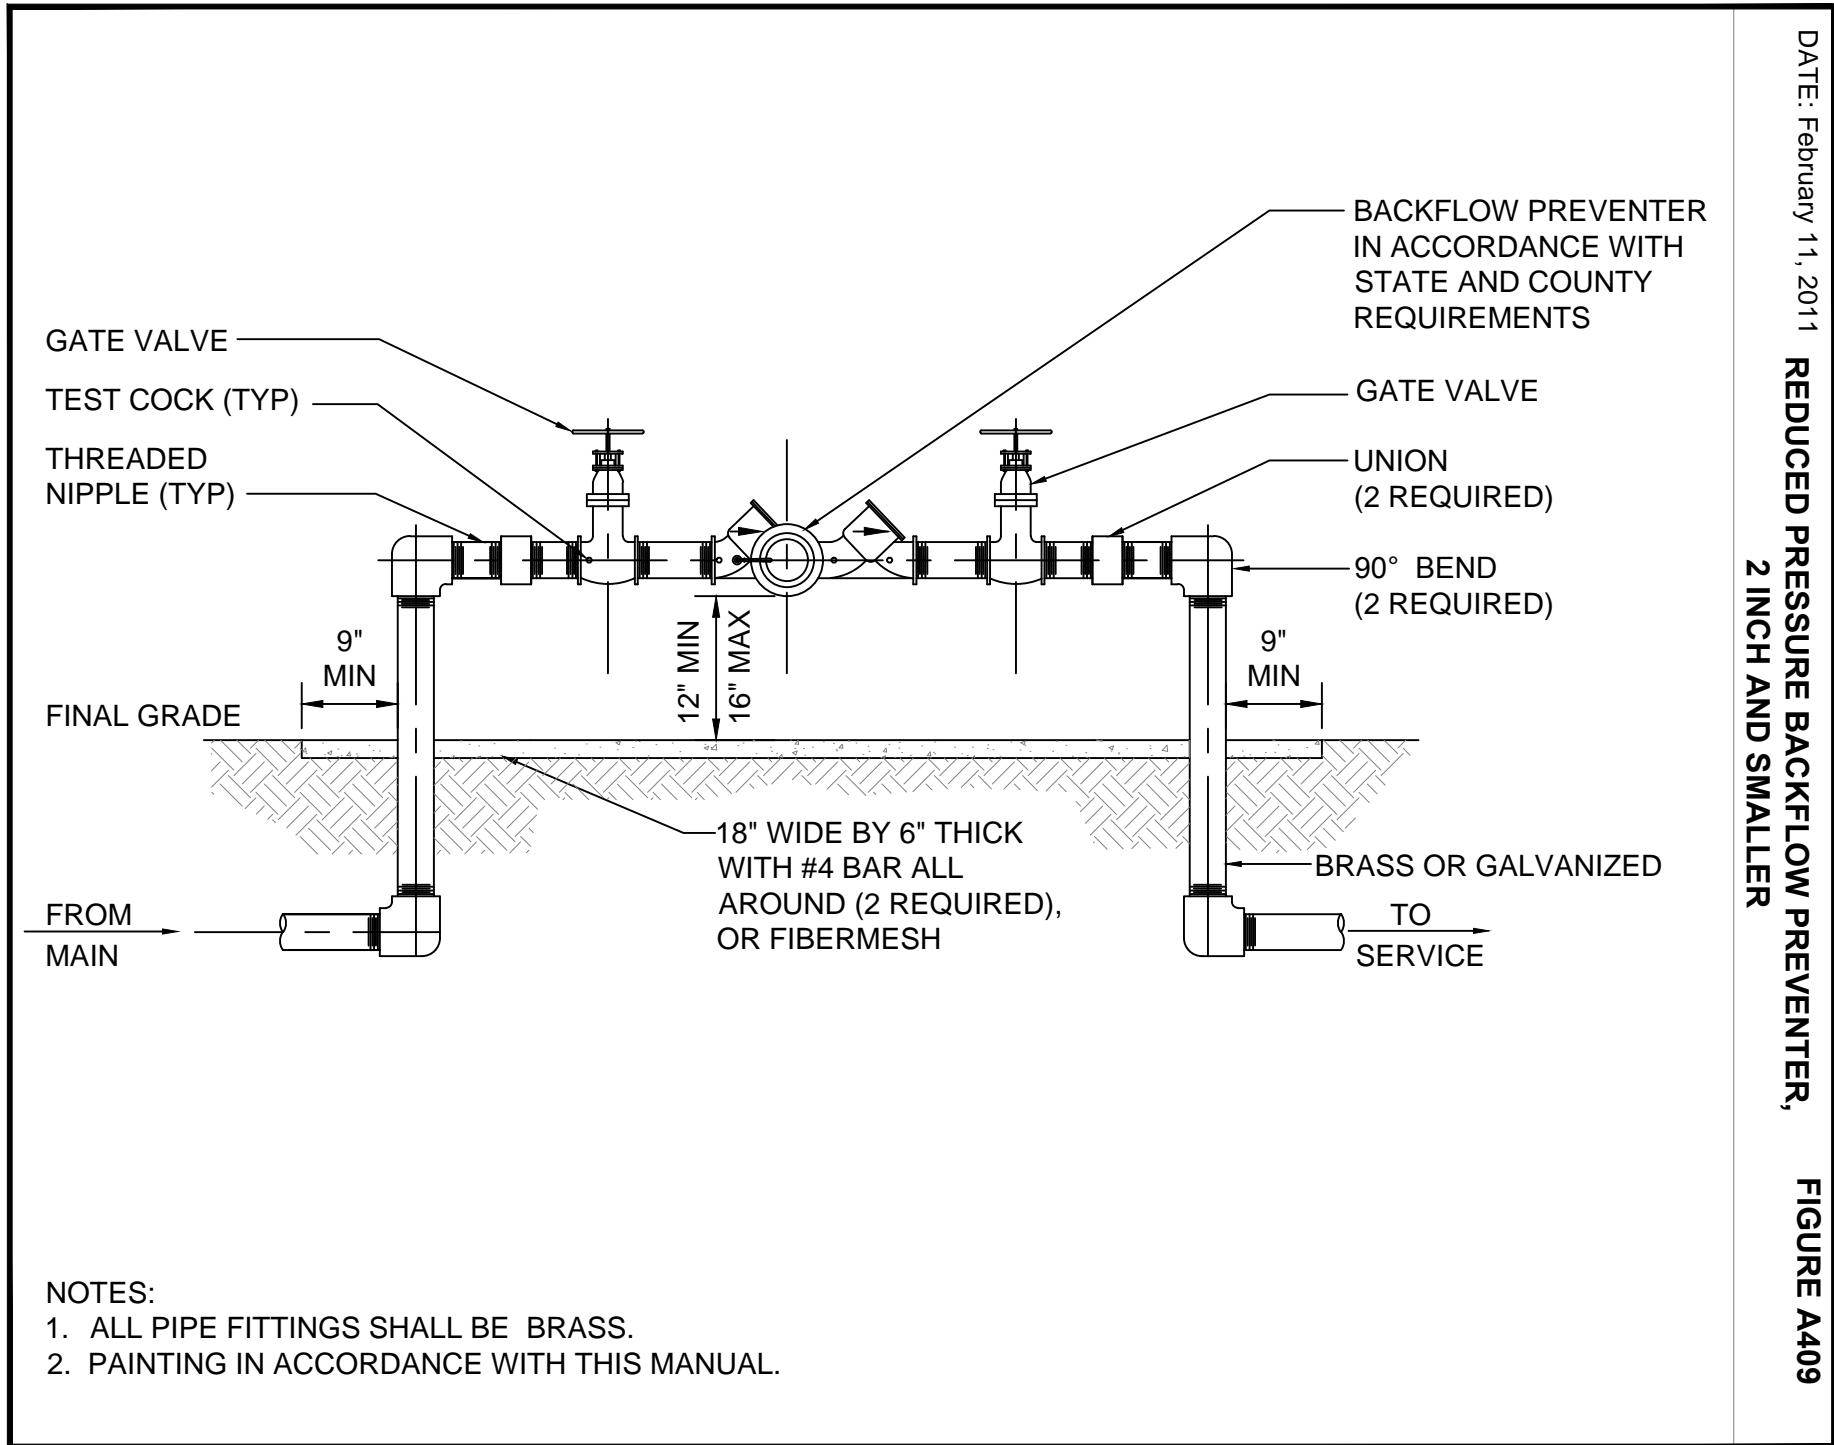
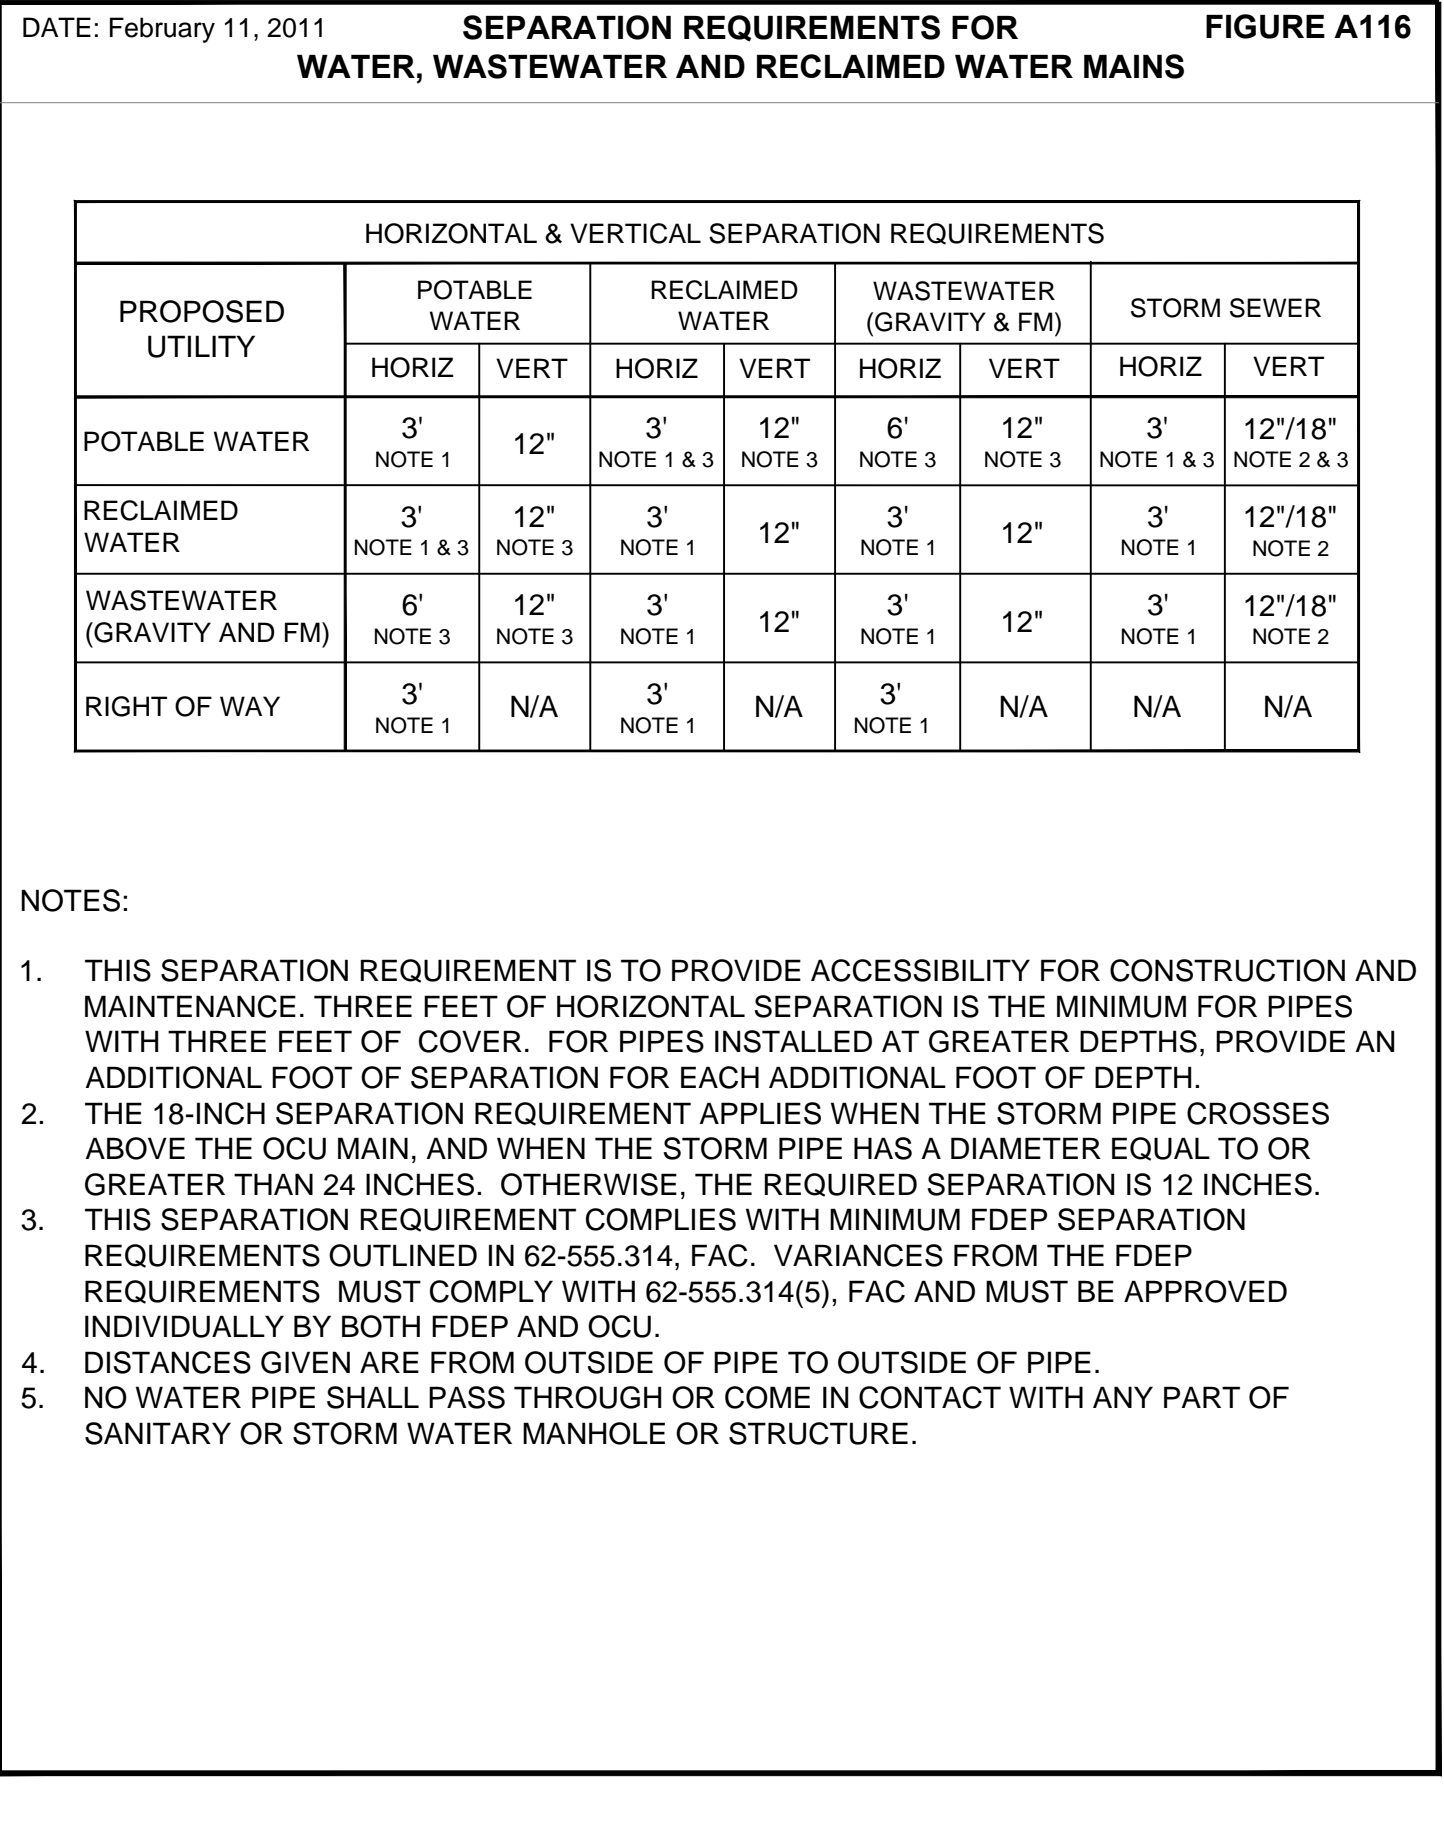
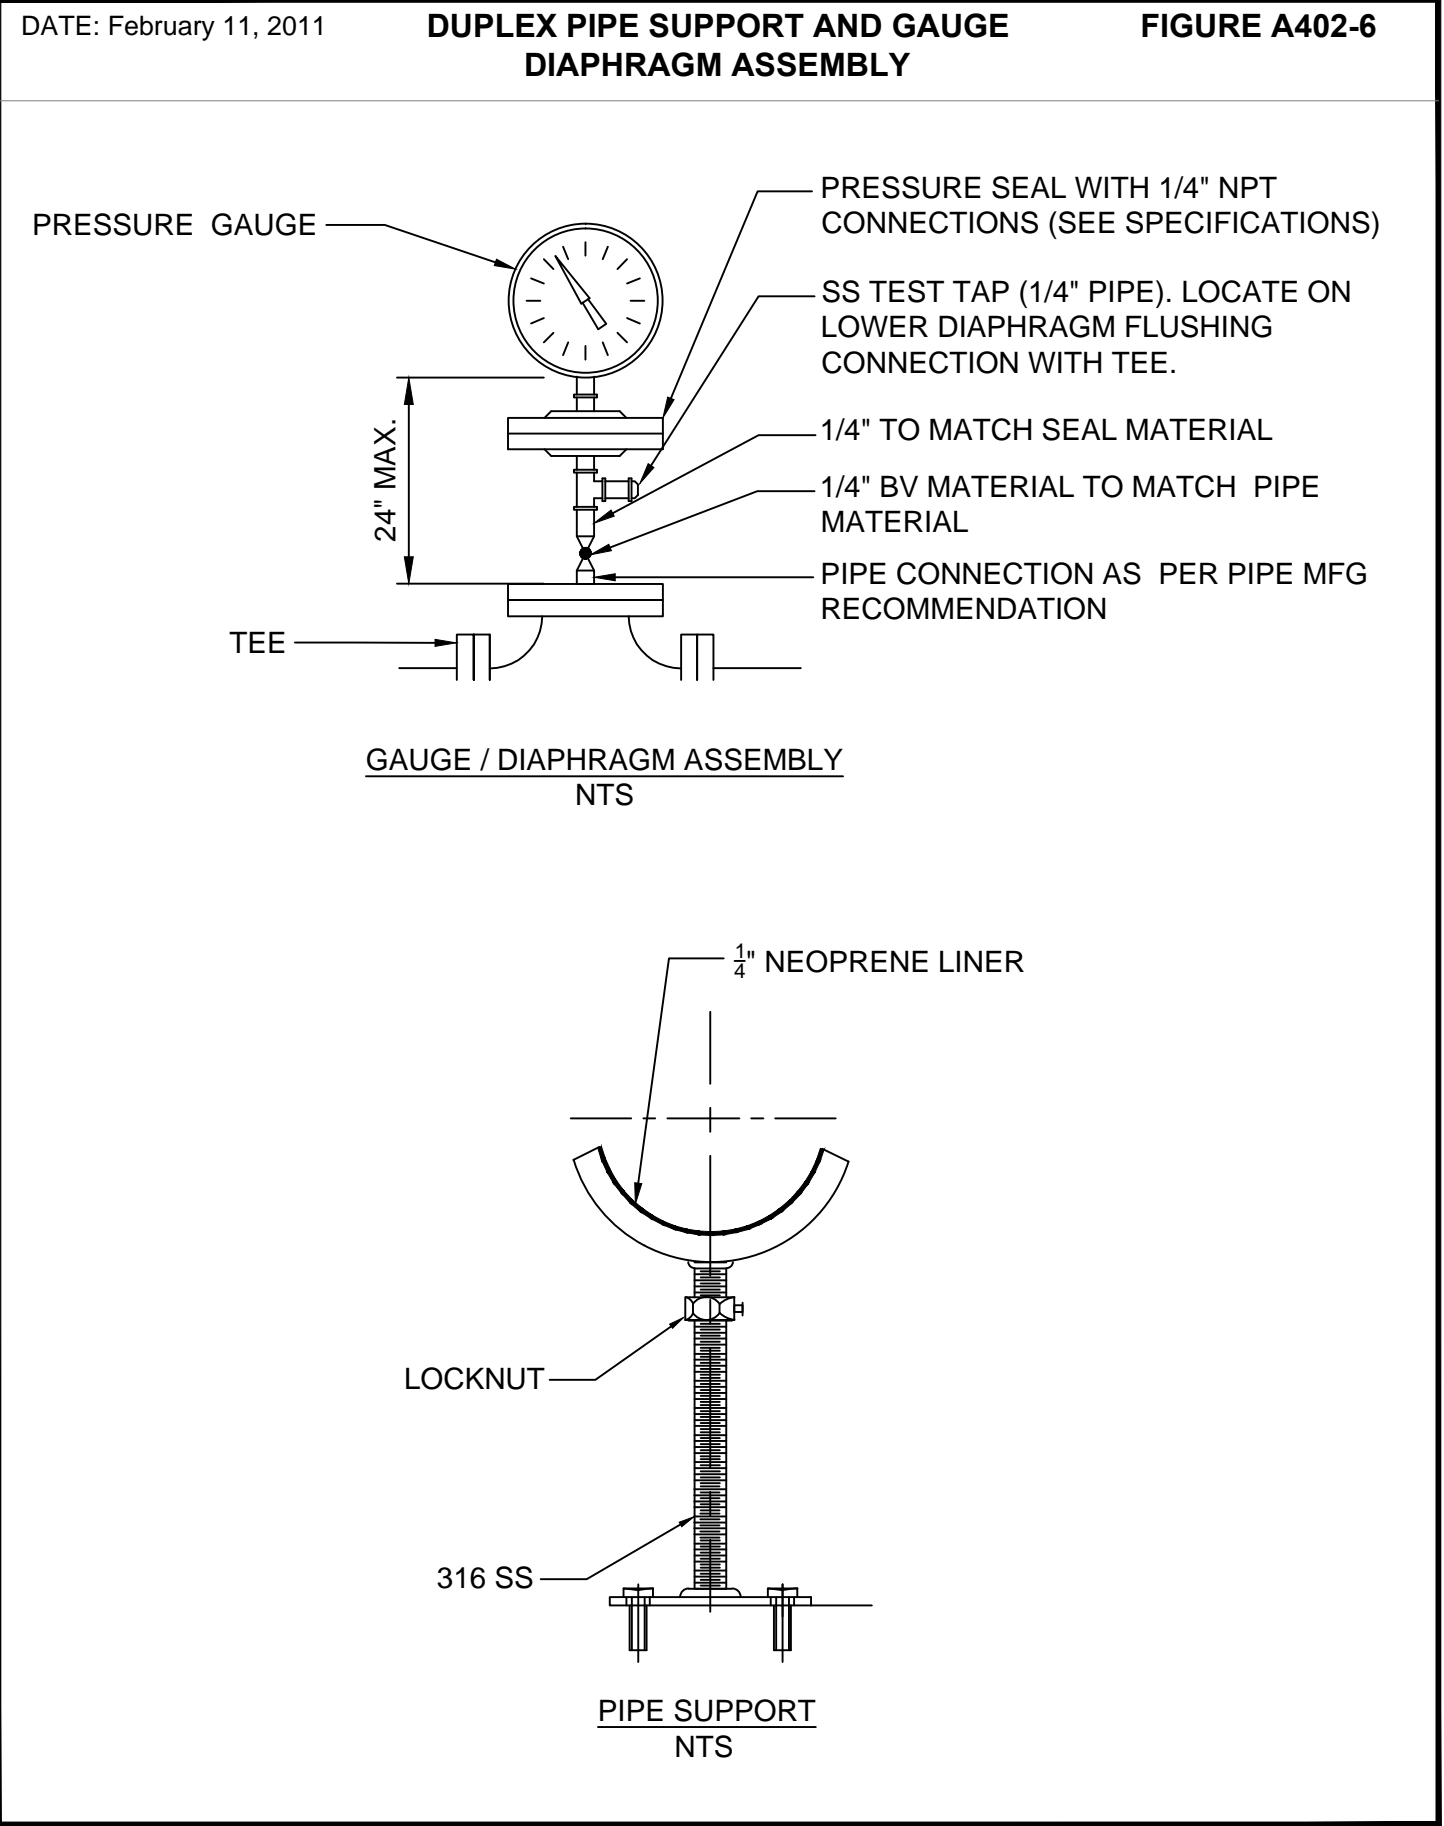
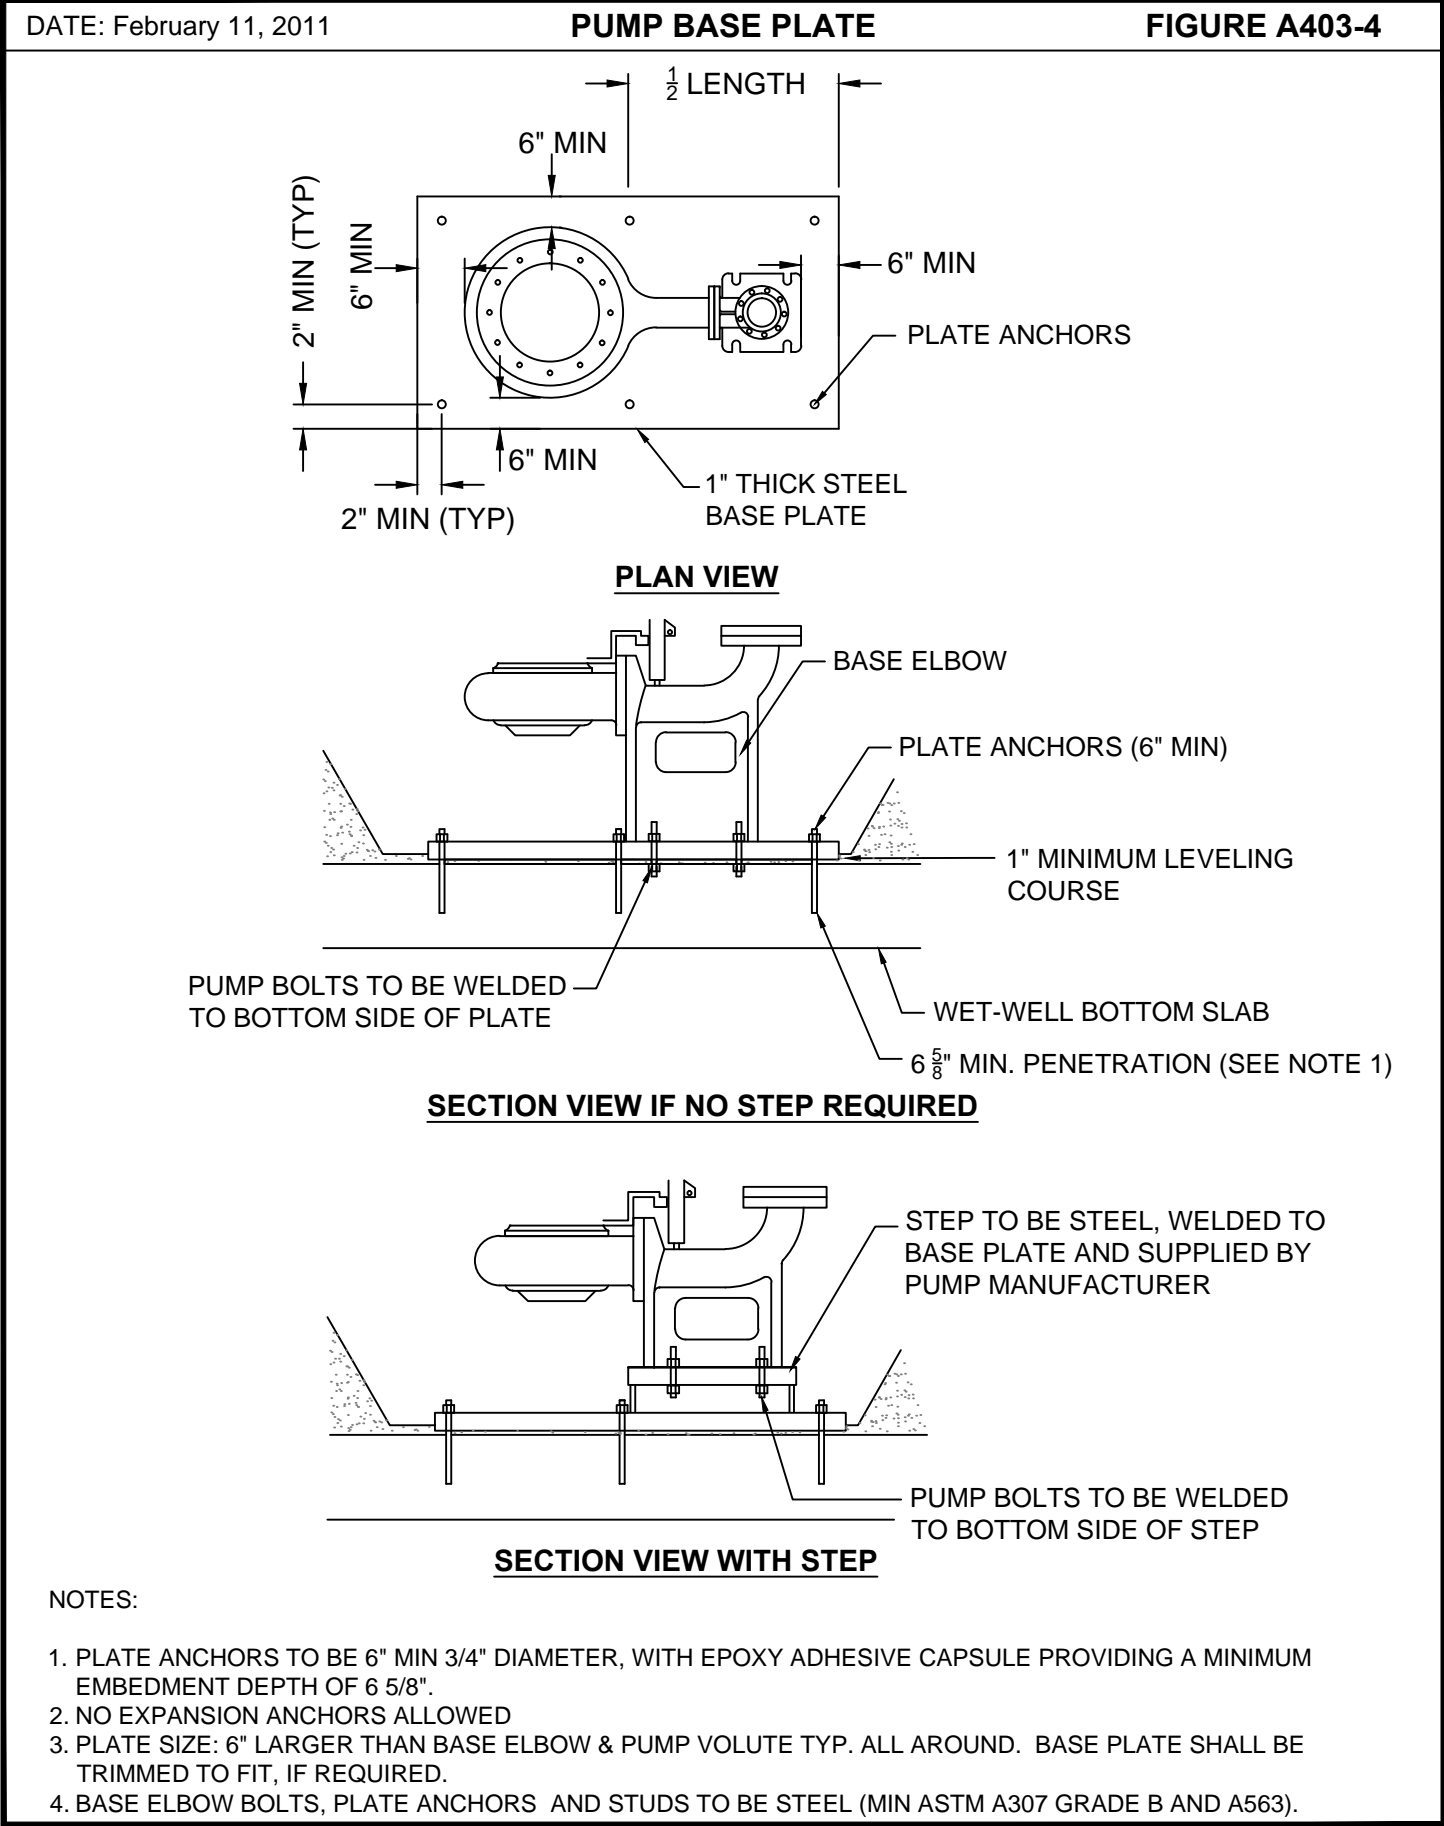
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CONSTRUCTION DETAILS
MANHOLE AND PIPE INSTALLATION


SCOTT A. BREITENSTEIN
PROFESSIONAL ENGINEER
FLORIDA LICENSE #57402

OCU FILE NO.: 74325
DESIGNED BY: SAB
DRAWN BY: DGH/GCM
CHECKED BY: SAB/DEM
CADD FILE: Construction Details.dwg

SCALE: NONE
DRAWING NO.:
D120
SHEET: 25 OF 40



REV	DATE	DESCRIPTION

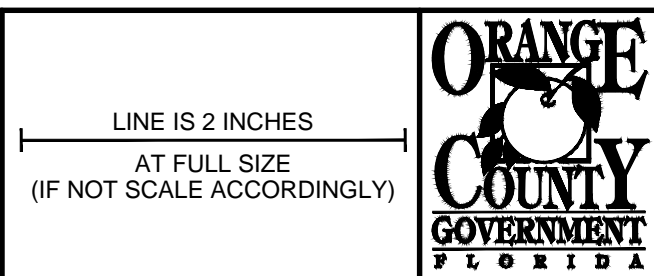

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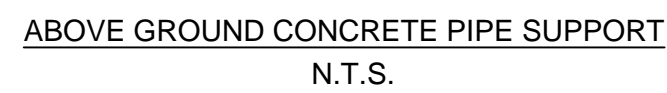
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CONSTRUCTION DETAILS
WET WELL INSTALLATION

OCU FILE NO.: 74325	SCALE: NONE
DESIGNED BY: SAB	DRAWING NO.: D130
DRAWN BY: DGH/GCM	SHEET: 26 OF 40
CHECKED BY: SAB/DEM	
CADD FILE: Construction Details.dwg	




SCOTT A. BREITENSTEIN PROFESSIONAL ENGINEER FLORIDA LICENSE #57402
--



PIPE SIZE	DIM. "A"	DIM. "B"
3/4"	2"	2"
1"	2-1/2"	2-1/2"
1-1/2"	4"	4"
2"	4"	4"
2-1/2"	4"	4"
3"	5"	5"
4"	6"	2-1/2"
6"	10"	2-1/2"
8"	12"	2-3/4"
10"	14"	3"
12"	16"	3-1/2"
14"	18"	3-1/2"
16"	20"	3-3/4"
18"	24"	3-3/4"
20"	24"	3-3/4"
24"	30"	4"
30"	36"	4-1/2"
36"	42"	5"
42"	48"	5-1/2"
48"	54"	5-3/4"
54"	60"	6"








LINE IS 2 INCHES
AT FULL SIZE
(IF NOT SCALE ACCORDINGLY)

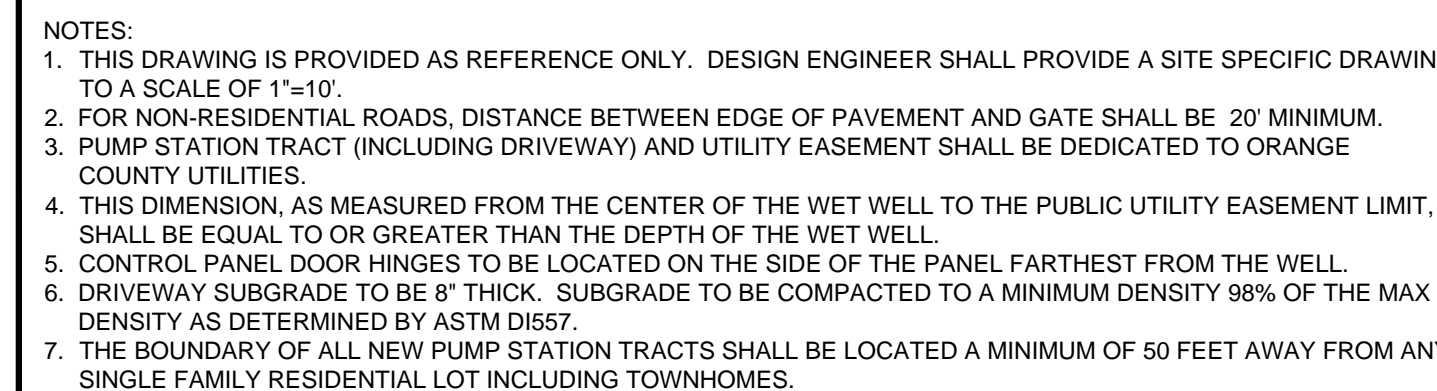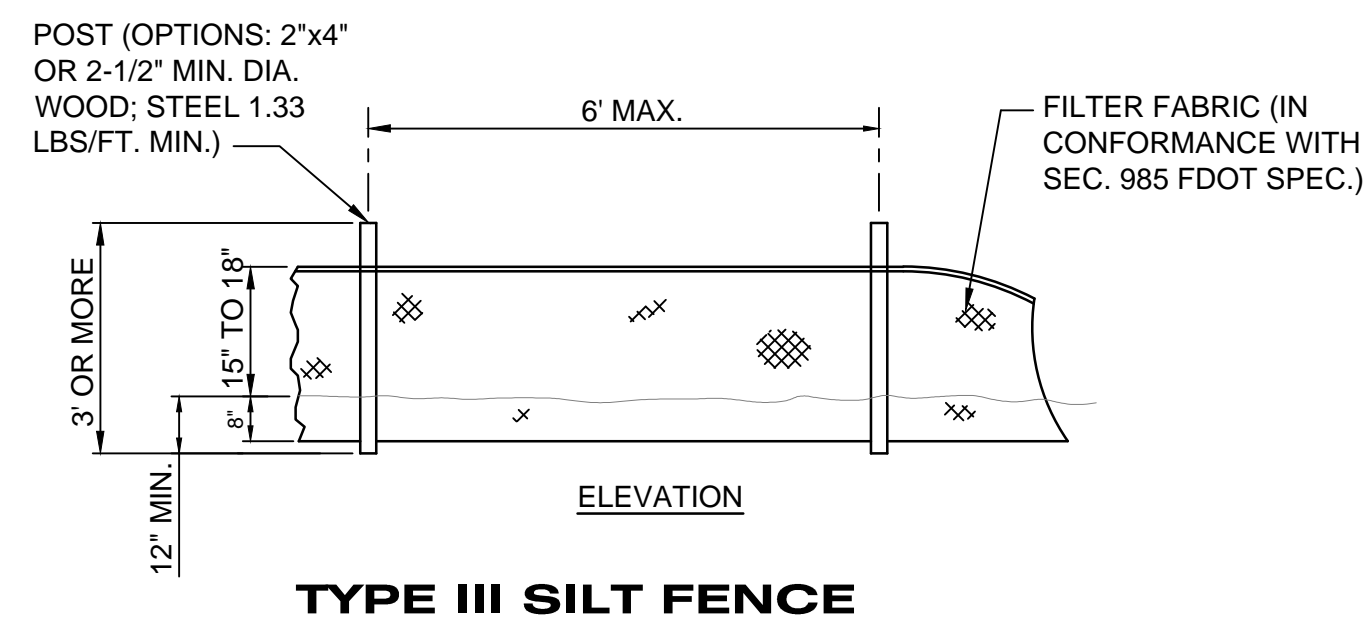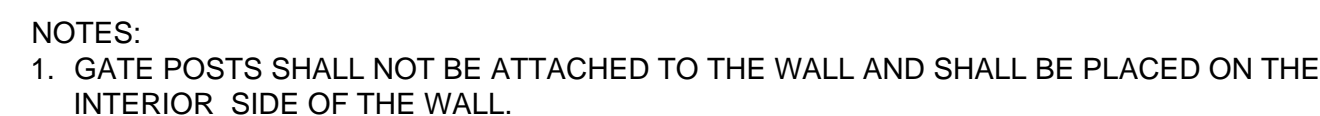

GENERAL

FIGURE A121-2

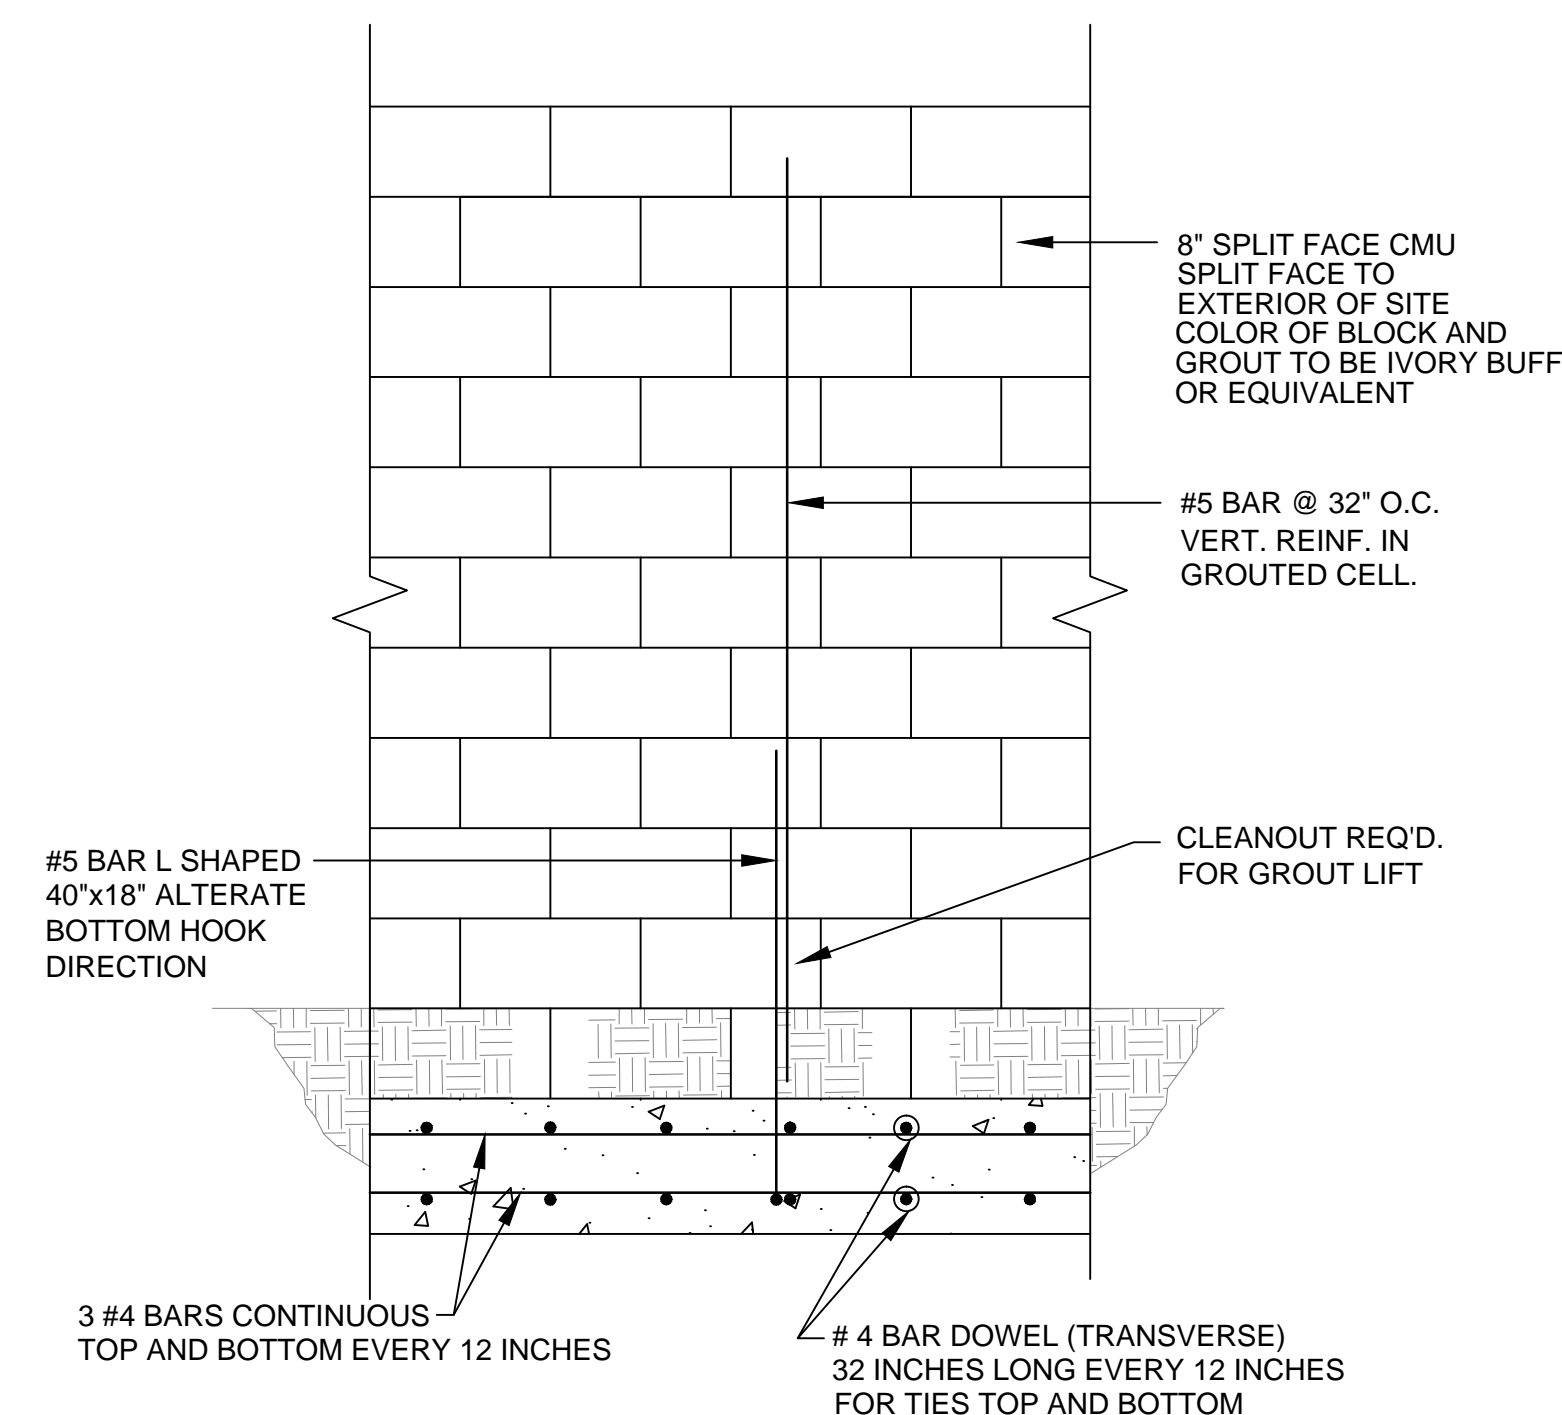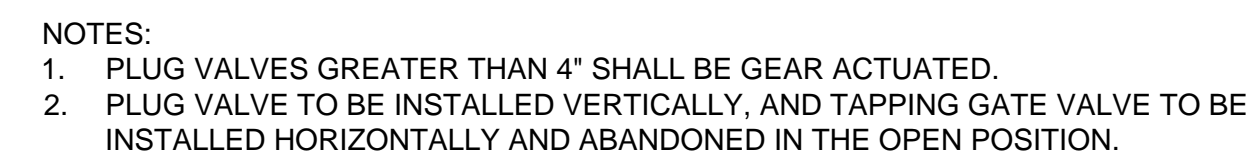

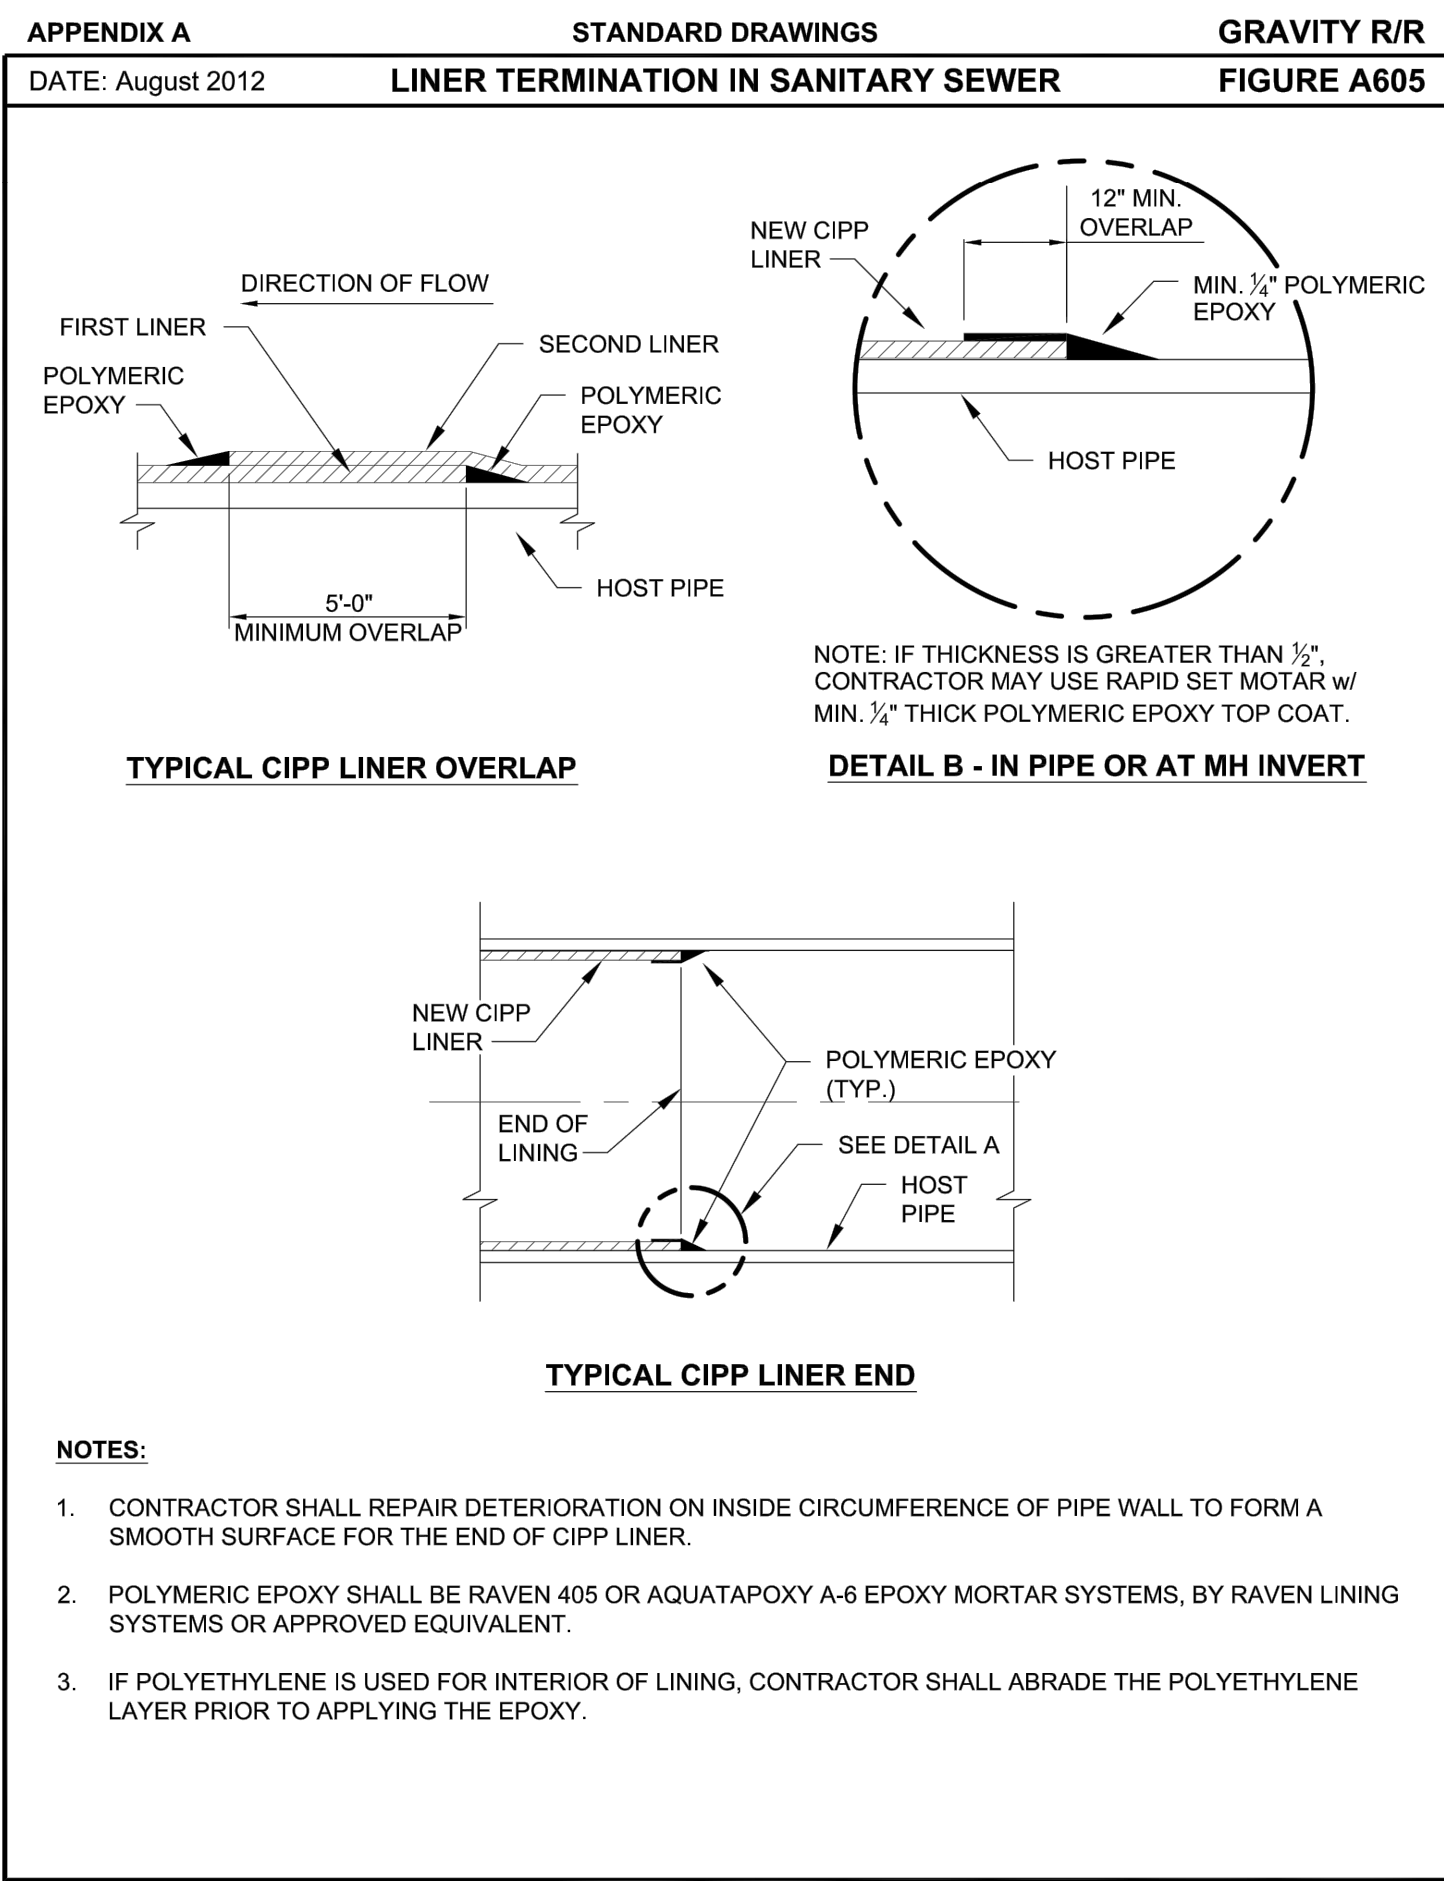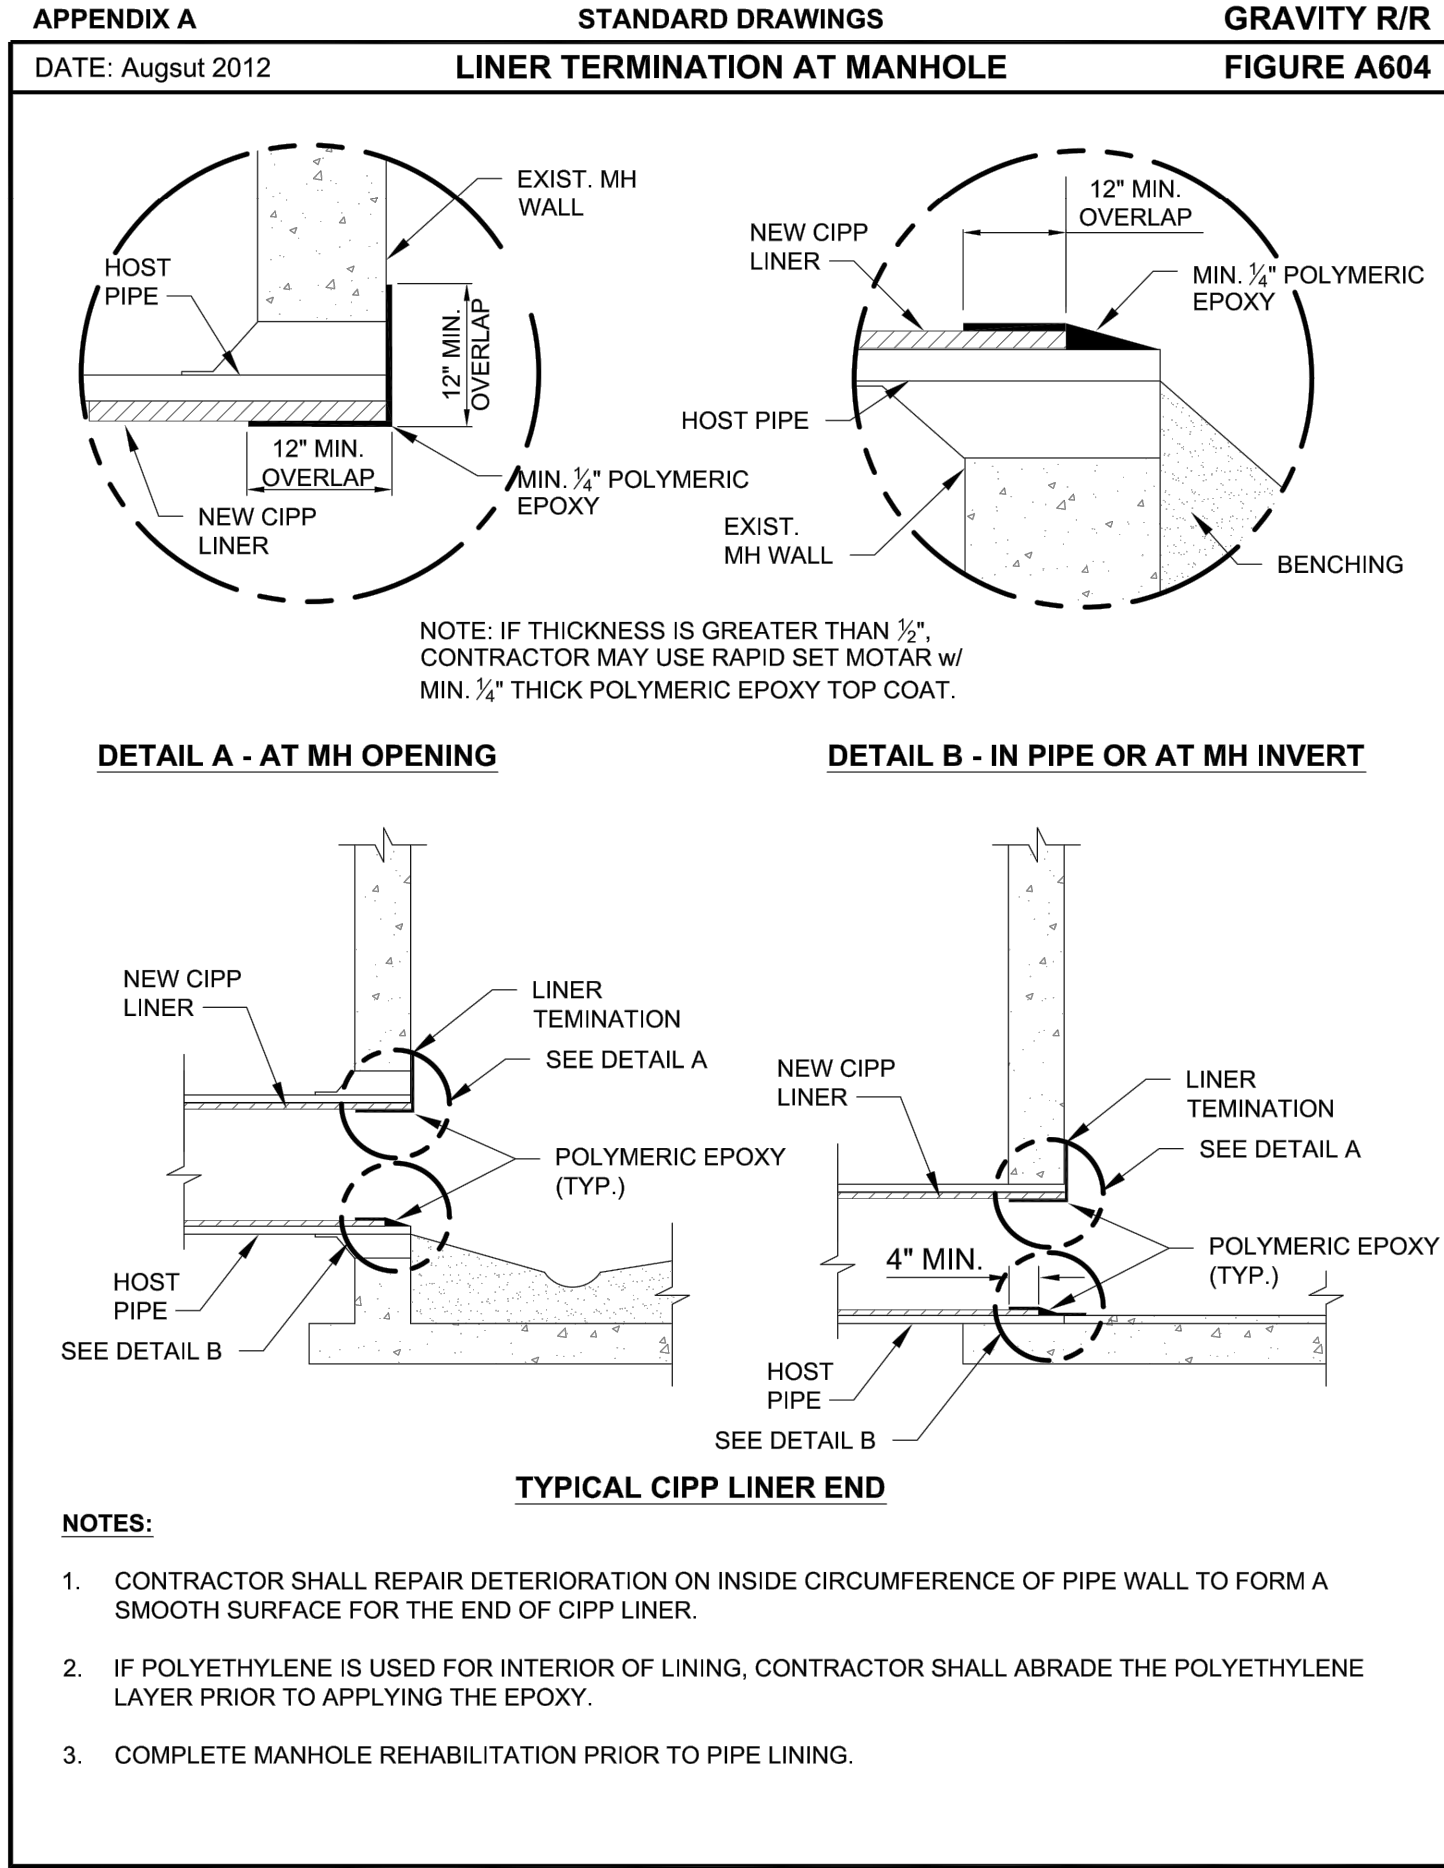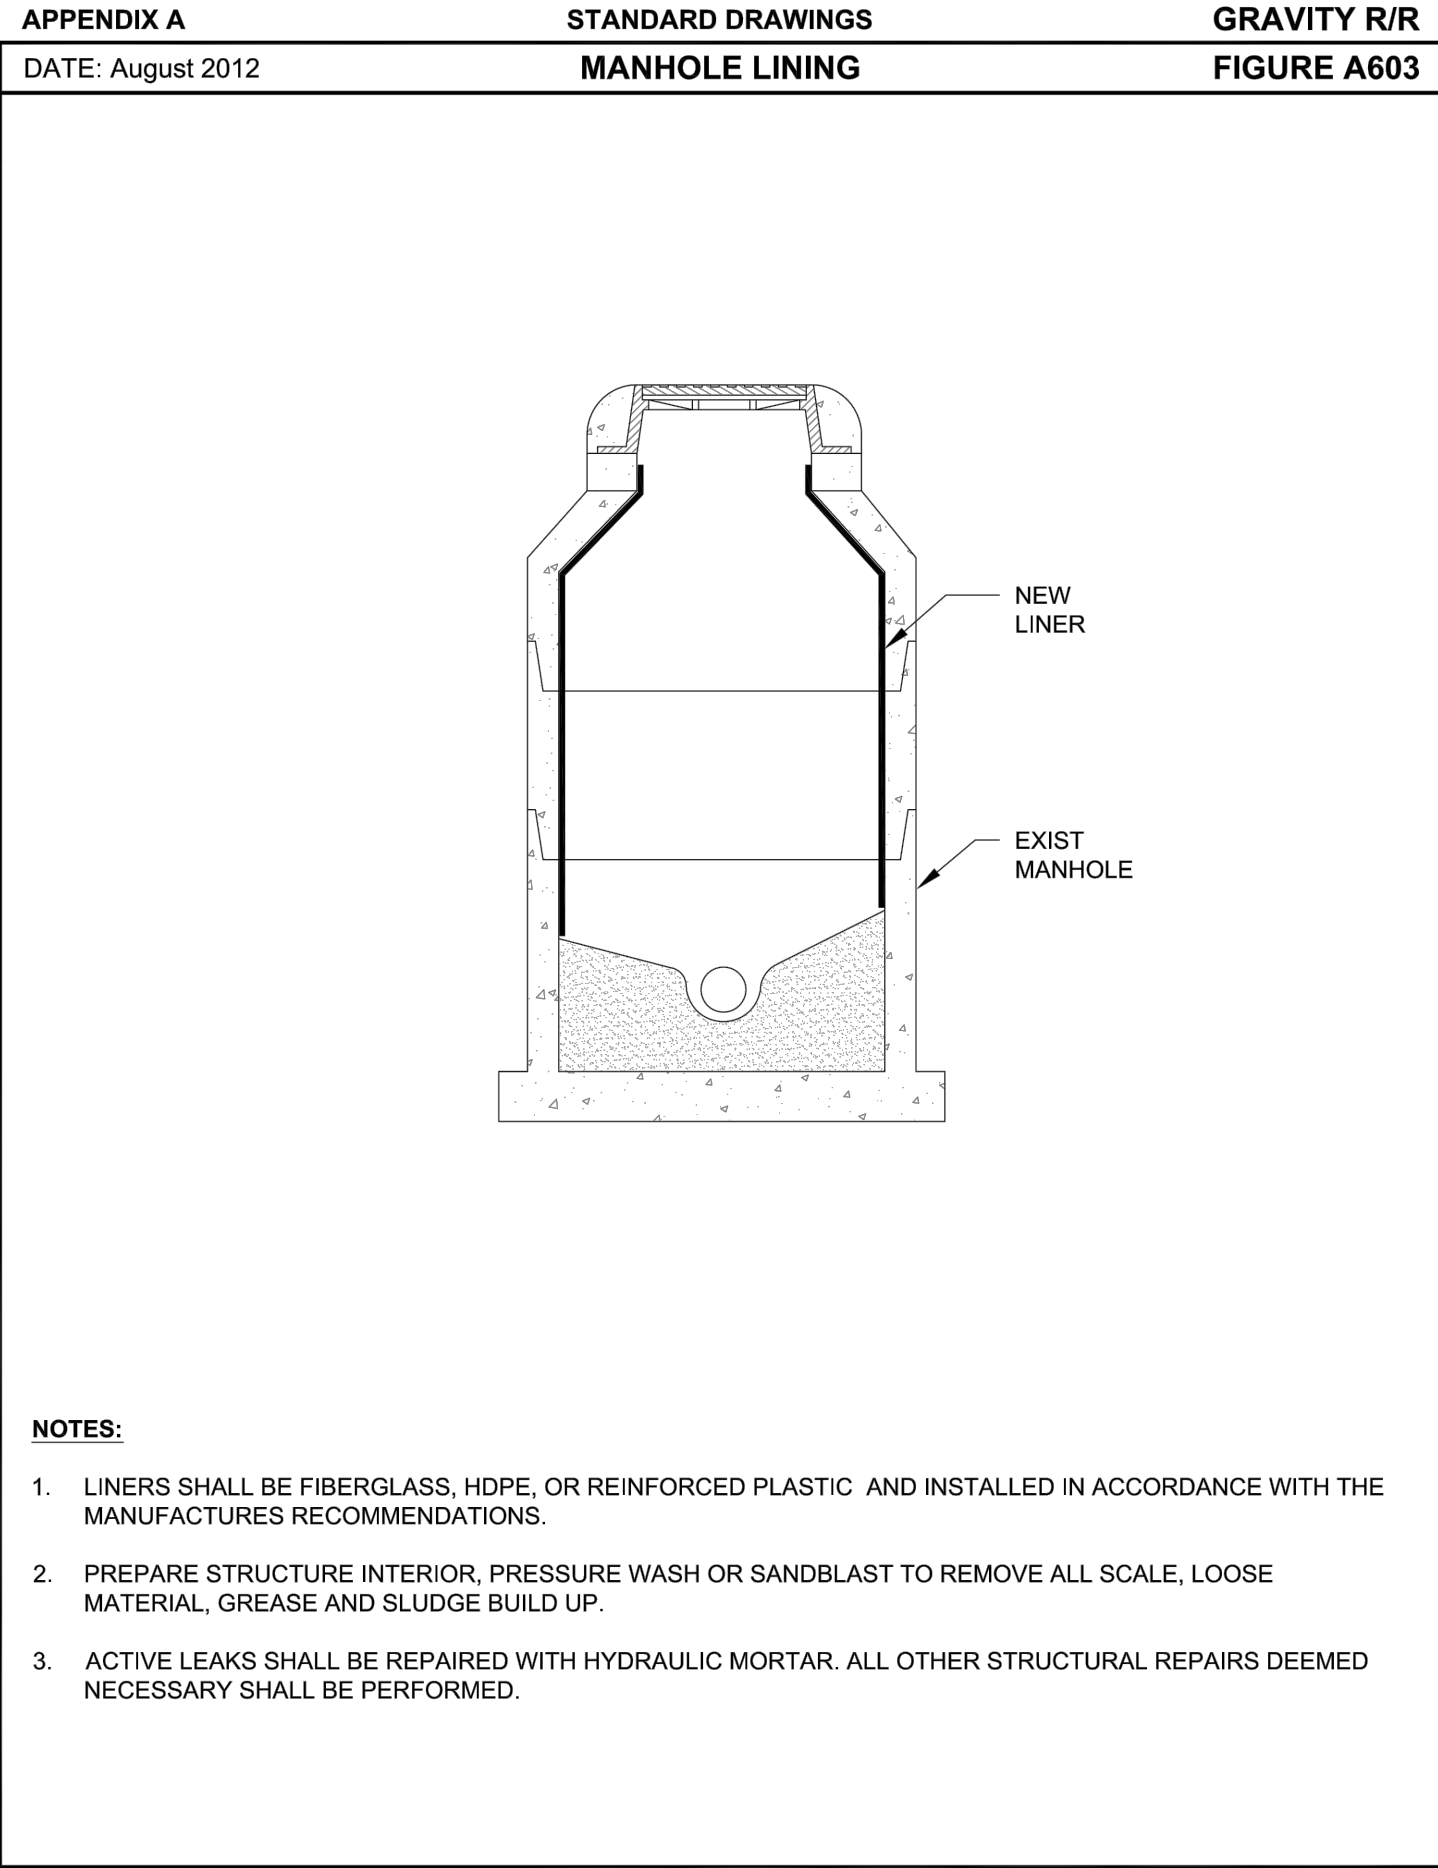

REV	DATE	DESCRIPTION

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Lndscp. Lic. No. LC0000298

CONSTRUCTION DETAILS
MANHOLE AND PIPE INSTALLATION

SCOTT A. BREITENSTEIN
PROFESSIONAL ENGINEER
FLORIDA LICENSE #57402

OCU FILE NO.: 74325

DESIGNED BY: SAB

DRAWN BY: DGH/GCM

CHECKED BY: SAB/DEM



CADD FILE: .Construction Details.dwg

SCALE: NONE

DRAWING NO. :

D150

SHEET: 28 OF 40

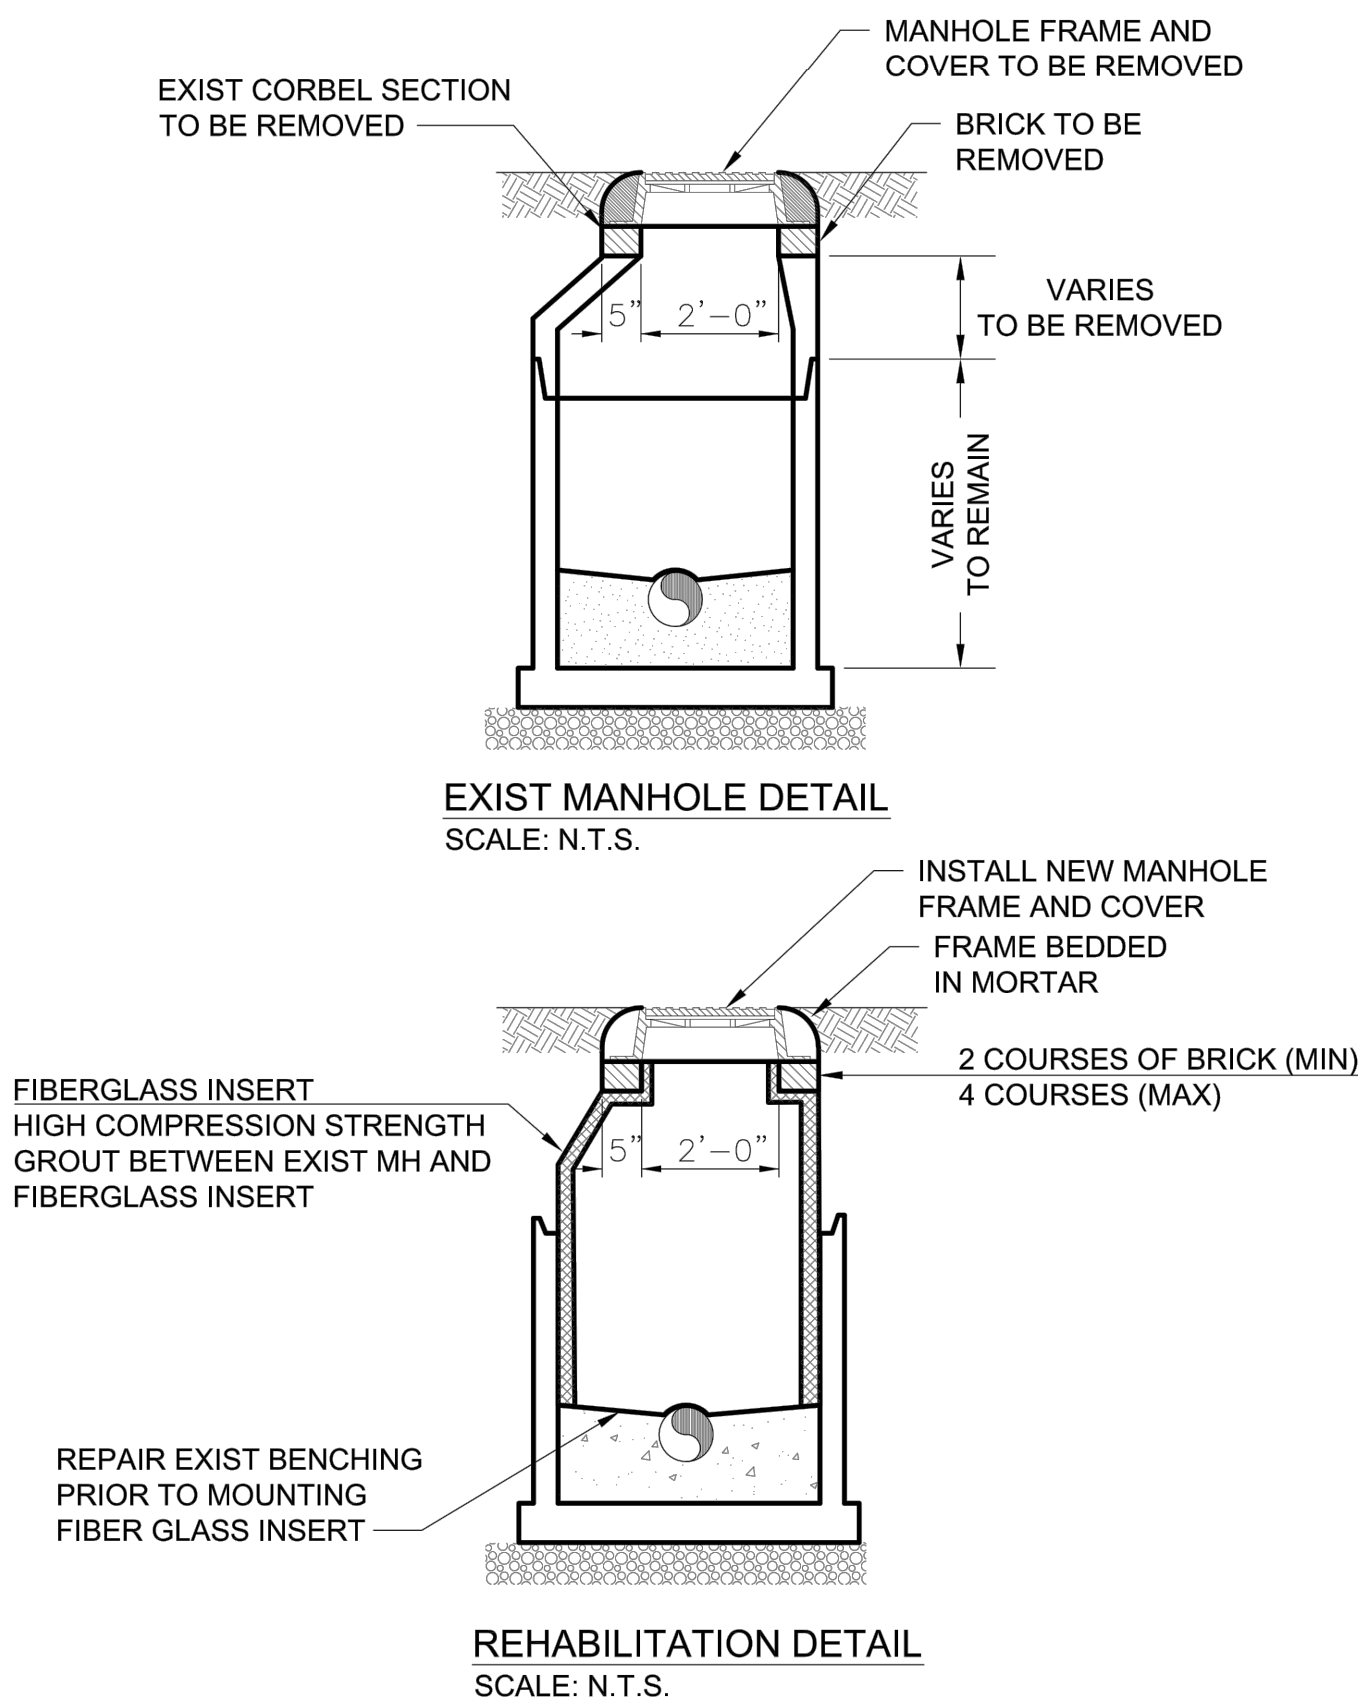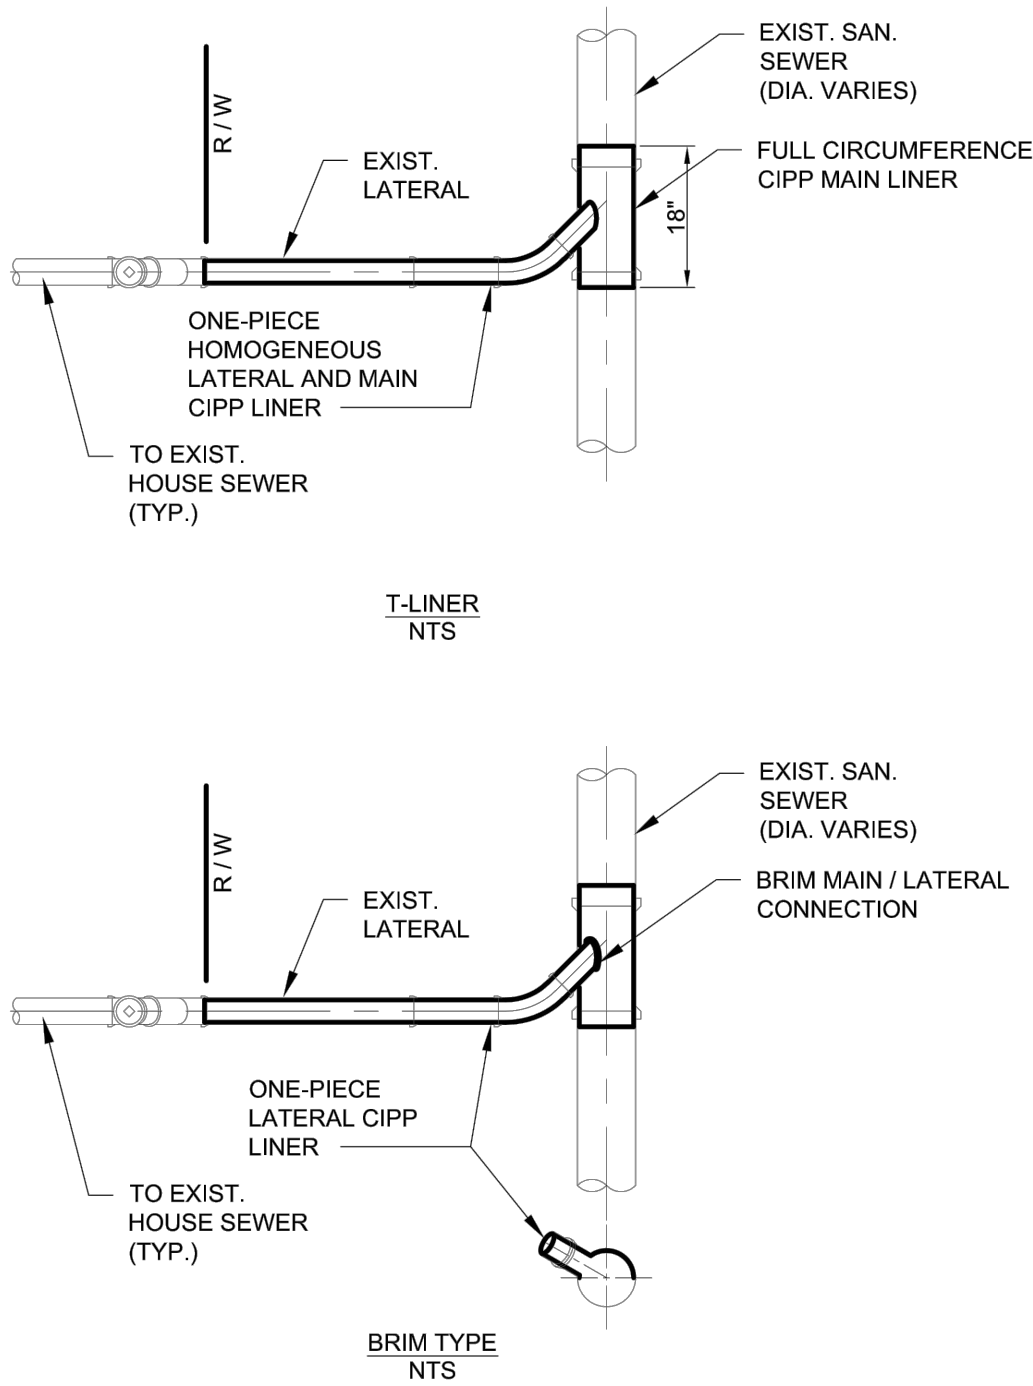

REV	DATE	DESCRIPTION

LINE IS 2 INCHES
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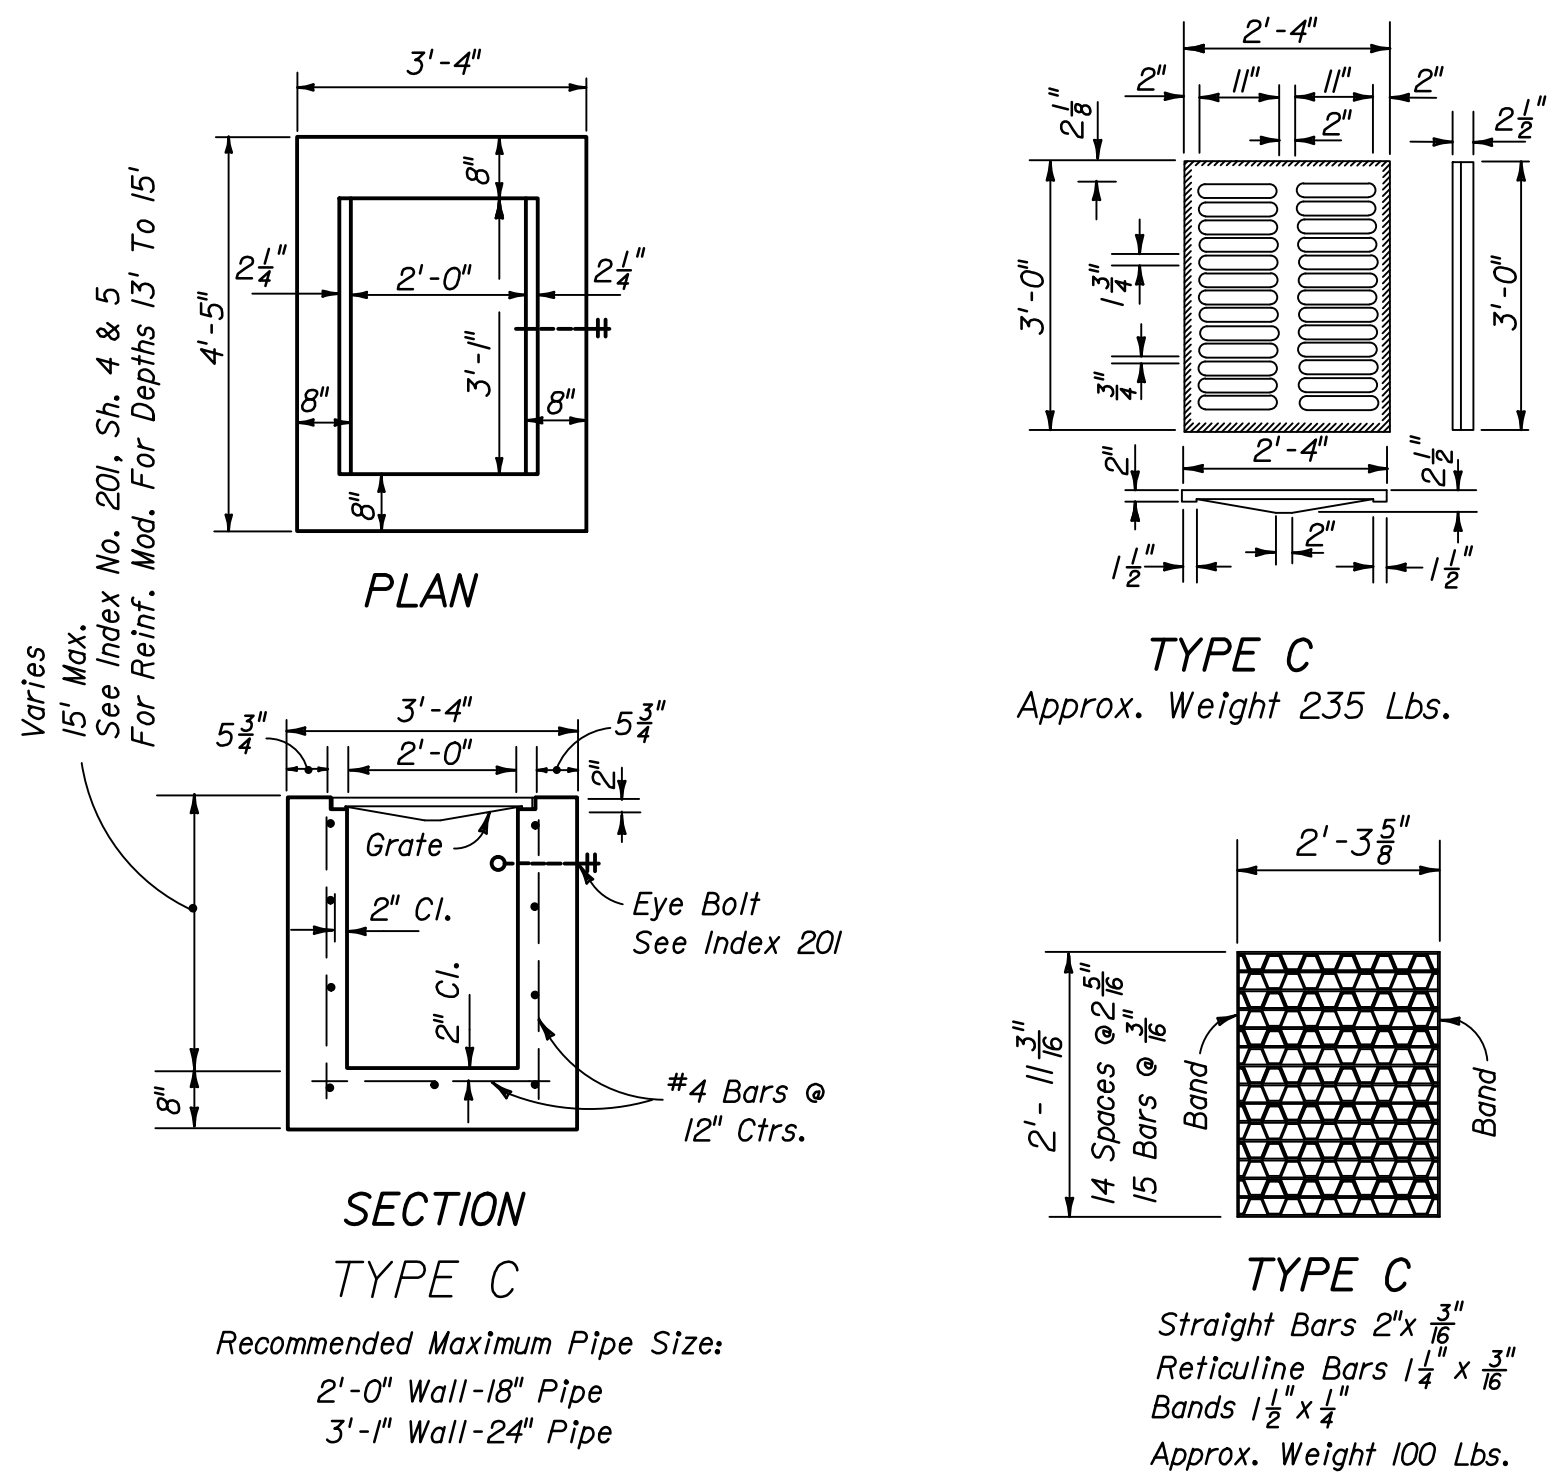
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CONSTRUCTION DETAILS
MANHOLE AND PIPE INSTALLATION

SCOTT A. BREITENSTEIN
PROFESSIONAL ENGINEER
FLORIDA LICENSE #57402


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DESIGNED BY: SAB
DRAWN BY: DGH/GCM
CHECKED BY: SAB/DEM
CADD FILE: .Construction Details.dwg

SCALE: NONE
DRAWING NO. :
D160
SHEET: 29 OF 40



FDOT TYPE 'C' INLET

NOT TO SCALE

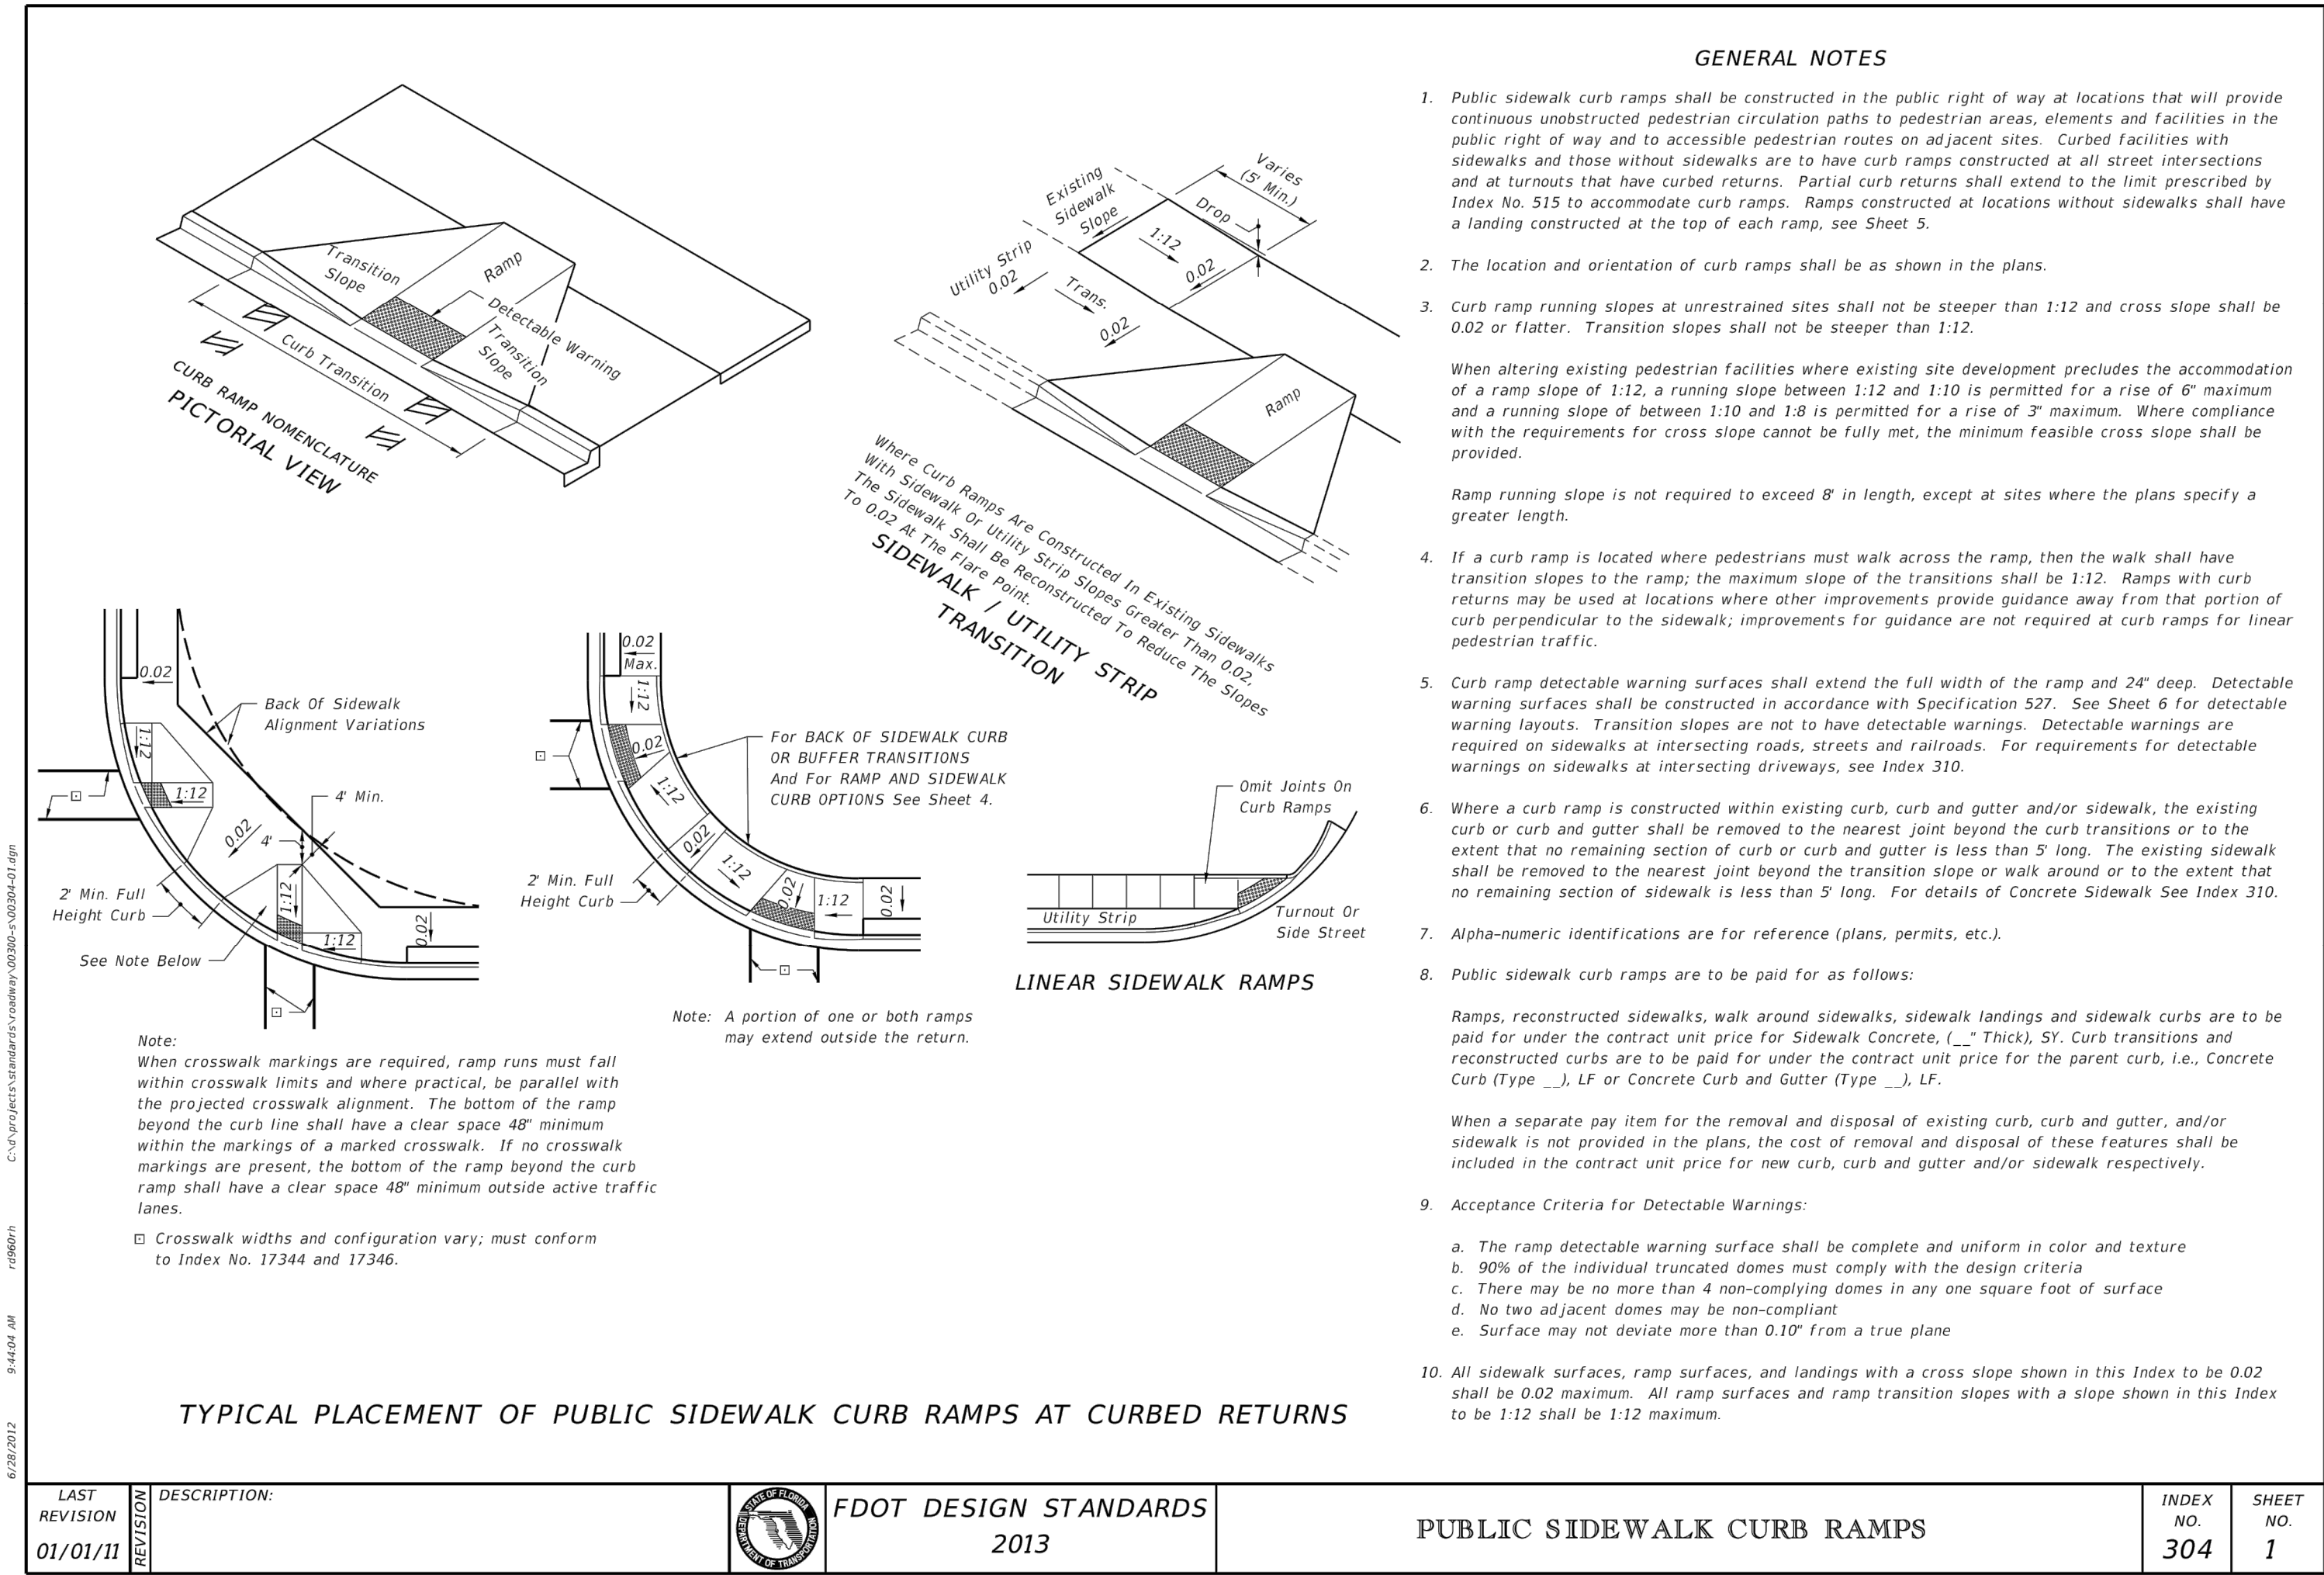


LAST REVISION	DESCRIPTION:	FDOT DESIGN STANDARDS 2013	PUBLIC SIDEWALK CURB RAMPS	INDEX NO. 304	SHEET NO. 1
01/01/11					

[illegible]

PUMP STATION #3990
750 ARNING DRIVE

LEGEND

AH	ALARM HORN	MB	MOTOR BREAKER
AL	ALARM LIGHT	MCB	MAIN CIRCUIT BREAKER
ALT	ALTERNATOR	MS	MOTOR STARTER
ASB	ALARM SILENCE BUTTON	OL	OVERLOAD
ATS	ALTERNATOR TEST SWITCH	PL	PILOT LIGHT
CB	CIRCUIT BREAKER	PM	PHASE MONITOR
CCB	CONTROL CIRCUIT BREAKER	R	RELAY
DPDT	DOUBLE POLE DOUBLE THROW	RL	RUNNING LIGHT
DRB	DUPLEX RECEPTACLE BREAKER	SCB	SCADA CIRCUIT BREAKER
ECB	EMERGENCY CIRCUIT BREAKER	SLB	SITE LIGHT BREAKER
ETM	ELAPSED TIME METER	TB	TERMINAL BLOCK
F	FUSE	TTS	THERMAL TERMINAL STRIP
FB	FUSE BLOCK	TVSS	TRANSIENT VOLTAGE SURGE SUPPRESSOR
FL	FLASHER	VA	VOLT AMPERE
FR	FLOAT REGULATOR	XFMR	TRANSFORMER
GFDR	GROUND FAULT DUPLEX RECEPTACLE		
GR	GENERATOR RECEPTACLE		
HOA	HAND-OFF-AUTO SELECTOR SWITCH		

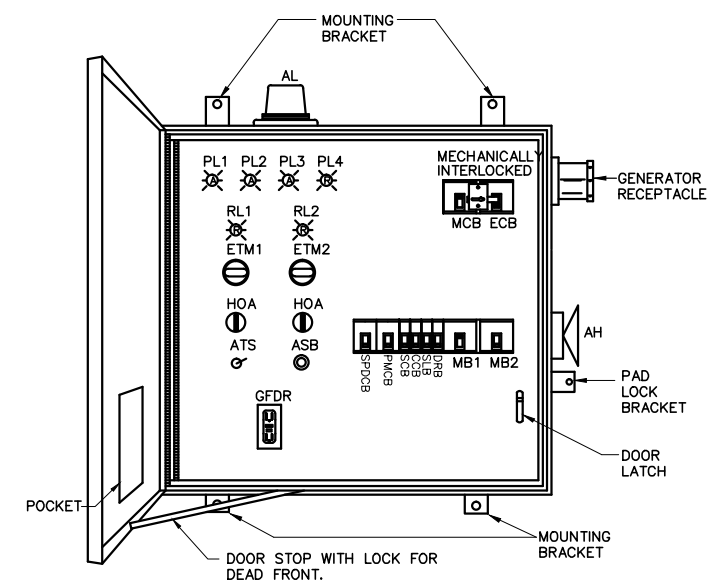


NOTES:

- ① DEADFRONT LAYOUT NEMA TYPE 3R S.S. ENCLOSURE W/CONTINUOUS HINGE. ALL HARDWARE TYPE 316 S.S. TYPICAL, ACTUAL LAYOUT MAY VARY WITH HORSEPOWER
- ② THIS CONTROL PANEL, INCLUDING THE GENERATOR RECEPTACLE, SHALL COMPLY WITH THE STANDARD LIST OF COMPONENTS REQUIRED BY ORANGE COUNTY UTILITIES.
- ③ ALL CONTROL WIRE TO BE #14 AWG MINIMUM.
- ④ CONTROL PANEL SHALL BE U.L. LISTED AND LABELED.
- ⑤ CONTROL PANEL SHALL INCLUDE 30 SPARE TERMINALS (TB2).
- ⑥ PHASE MONITOR CIRCUIT BREAKER TO BE SIEMENS P/N: MSP10G, OR SQ-D P/N: MQ24532.
- ⑦ PROVIDE AUXILIARY FORM "C" CONTACT ON MAIN AND EMERGENCY CIRCUIT BREAKERS IN PUMP CONTROL PANEL.
- ⑧ ALL 240V CIRCUIT BREAKERS SHALL BE TYPE "HGL"

DUPLEX CONTROL PANEL ENCLOSURE DEAD FRONT LAYOUT

SCALE: N.T.S.

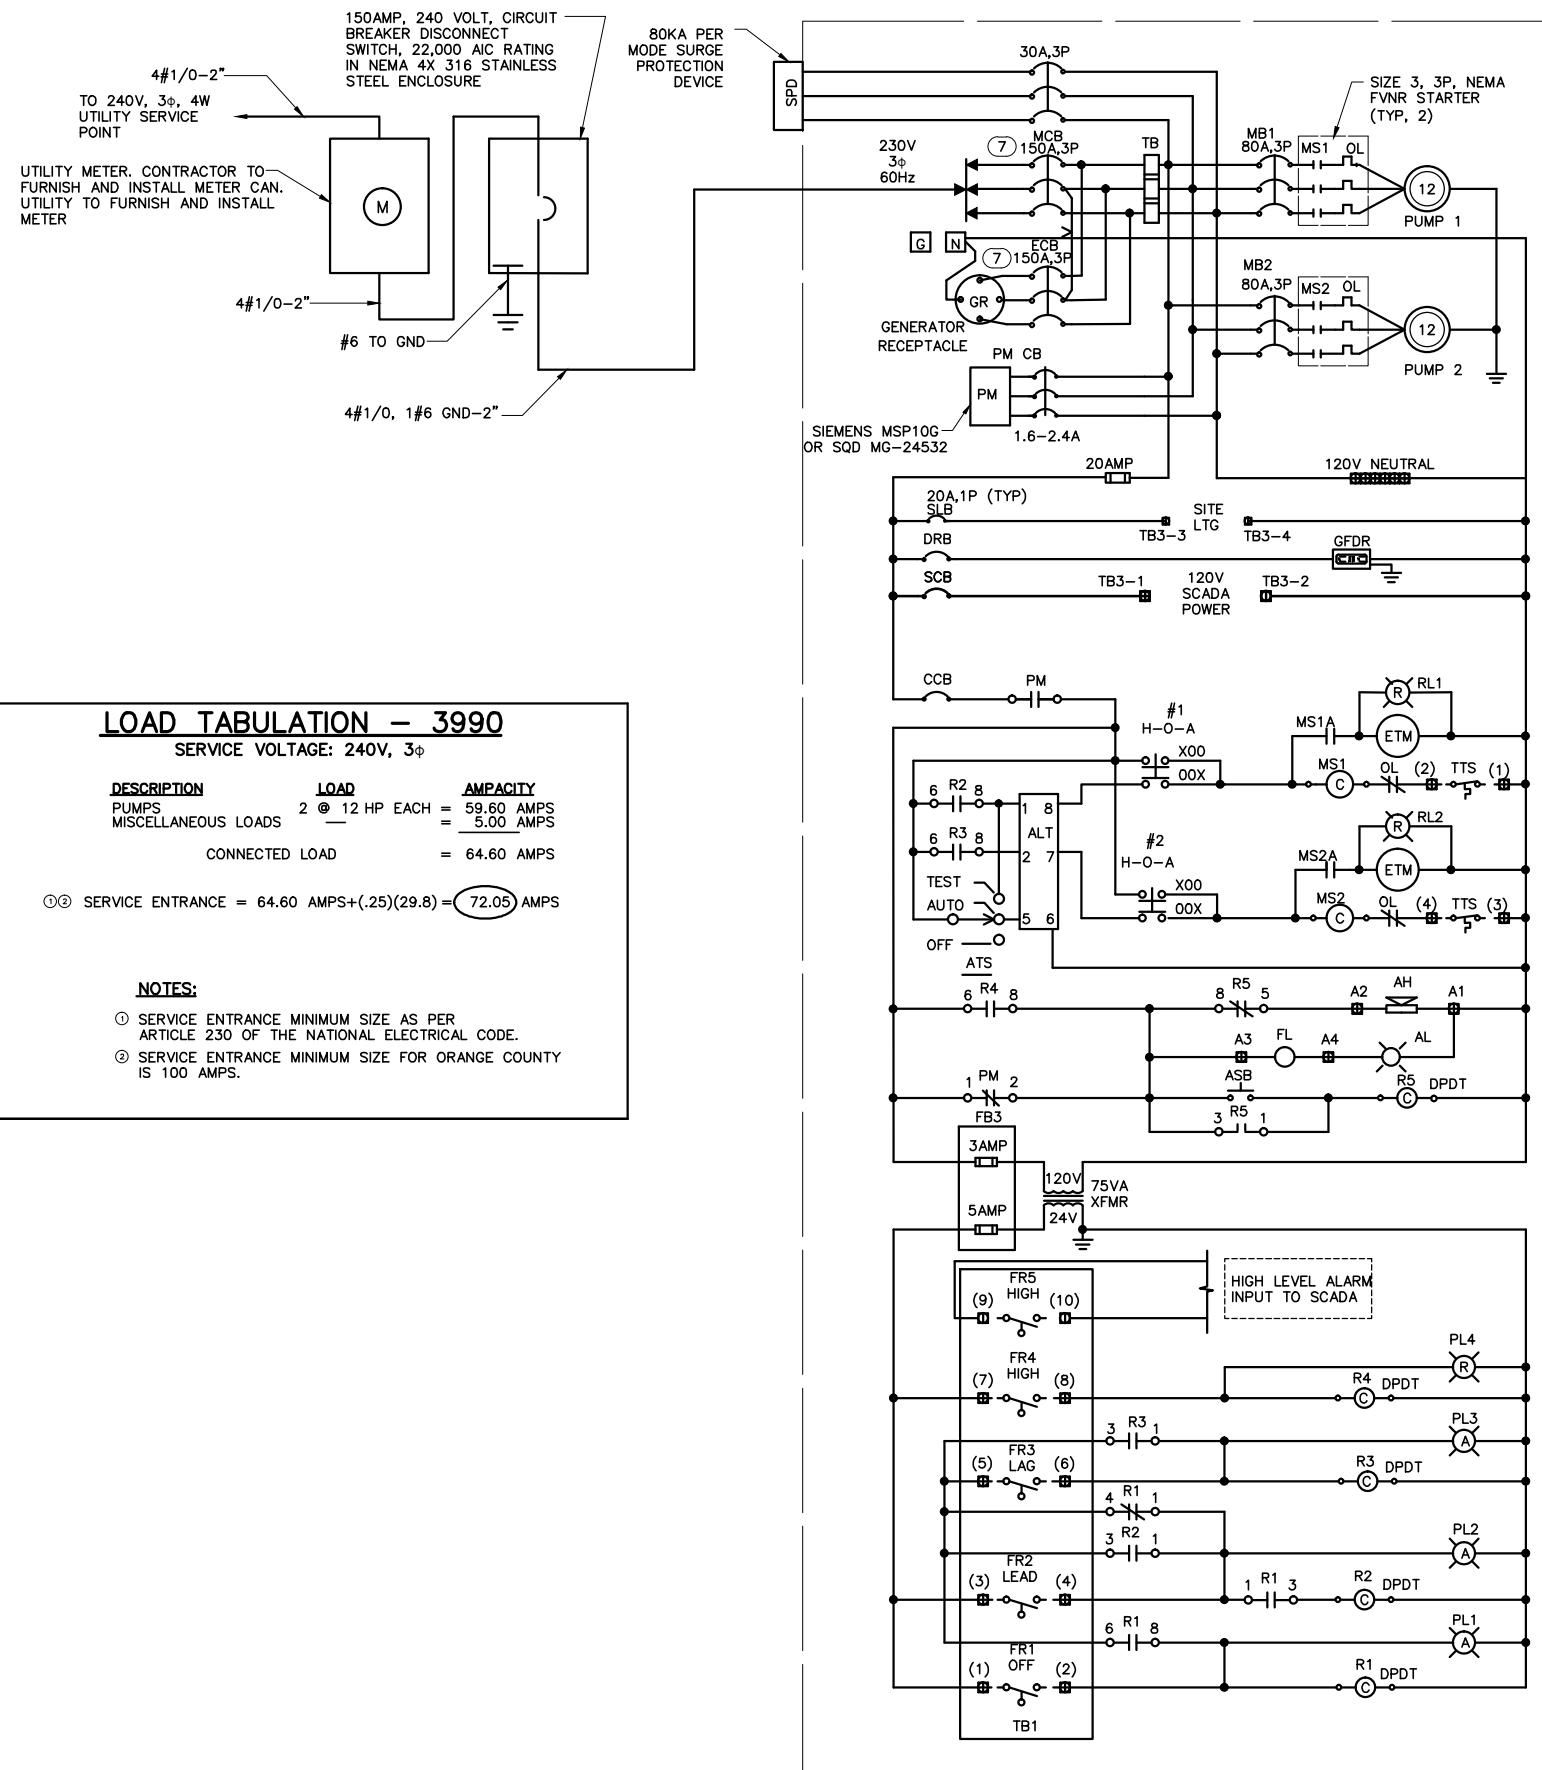

240V DUPLEX PUMP CONTROL SCHEMATIC

[illegible]

LINE IS 2 INCHES
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Lndscp. Lic. No. LC0000298

one: 407.425.0452

PUMP STATION 3990
 DUPLEX PUMP CONTROL PANEL
 SINGLE LINE DIAGRAM

OCU FILE NO.: 74325

DESIGNED BY: LMP

DESIGNED BY: EMR
DRAWN BY: BSM

DRAWN BY: RRM _____

CHECKED BY: LMR


CADD FILE: E-100 PS 3990 SLD

SCALE: AS NOTED:

DRAWING NO. :
E-100

SHEET: 32 OF 40

BID DRAWING

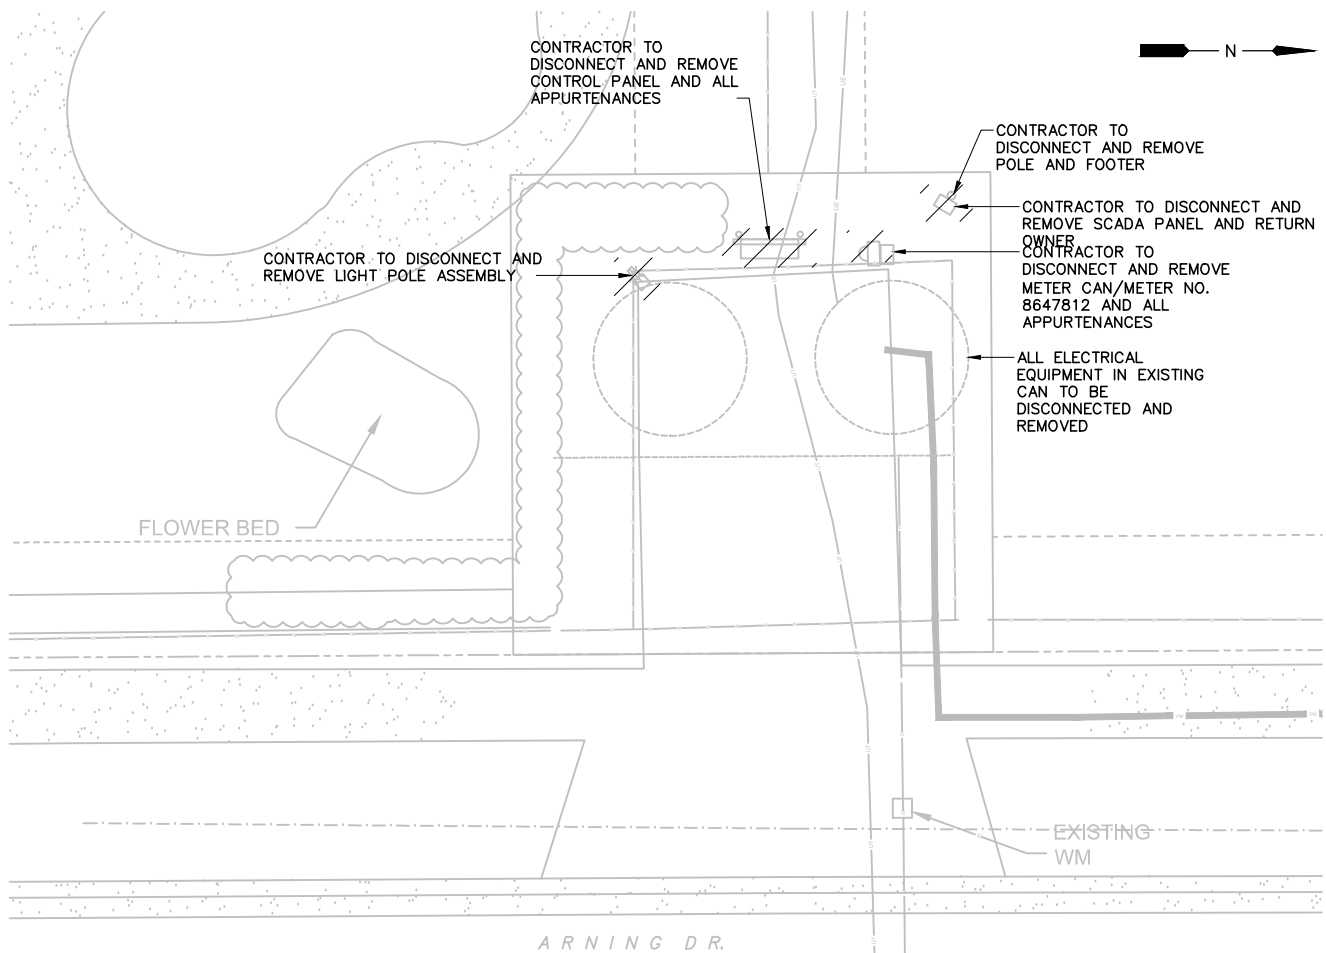

PS3990 ELECTRICAL DEMOLITION PLAN

SCALE: 1"=5'-0"
5 2.5 0 5'




PS3990 FIGURE NO. 1

SCALE: N.T.S.



PS3990 FIGURE NO. 2

SCALE: N.T.S.

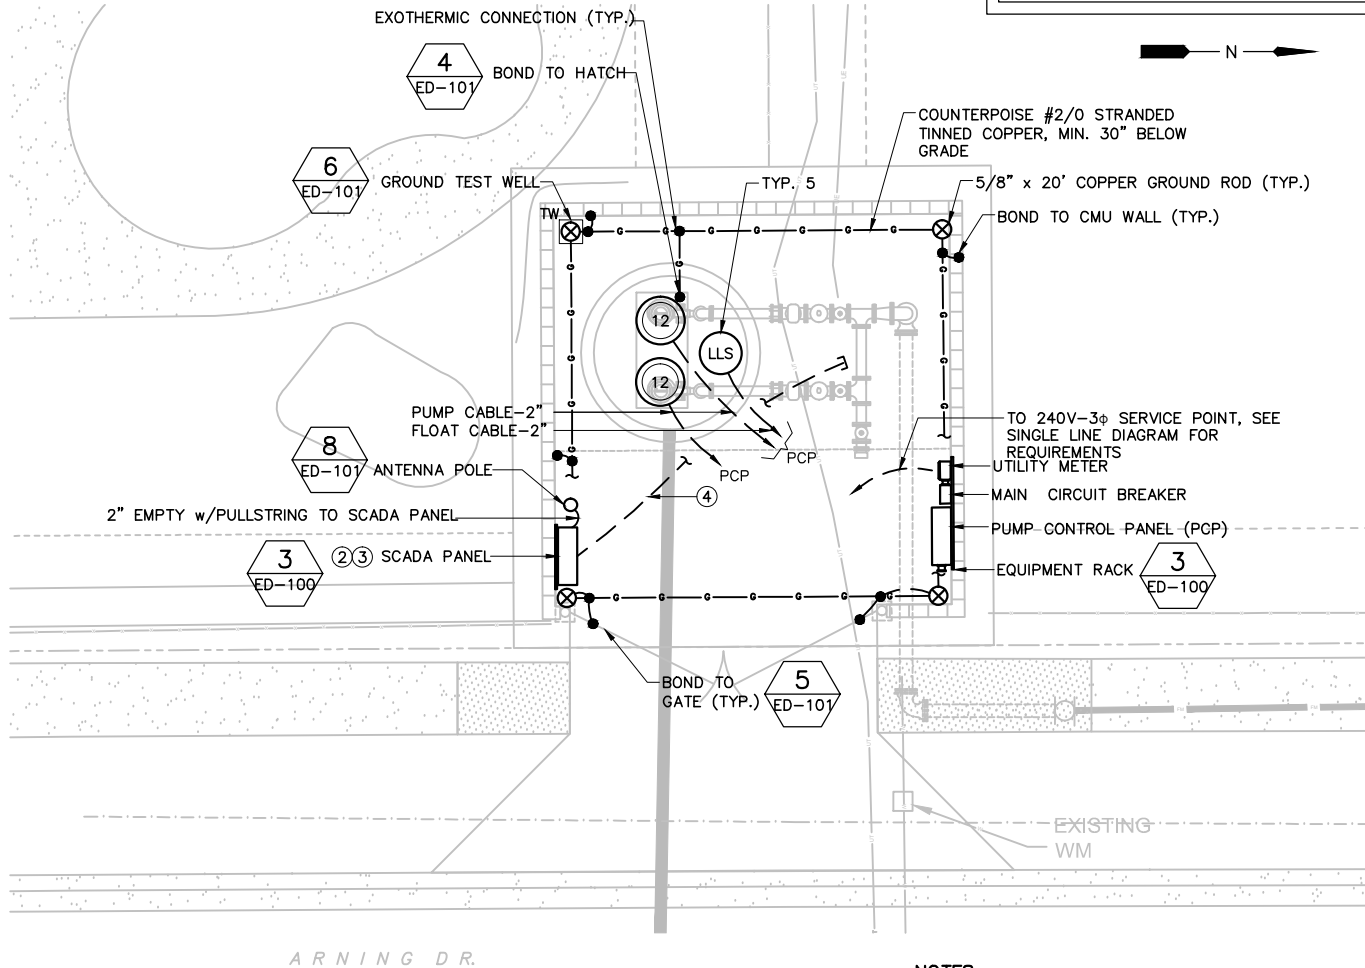

PS3990 ELECTRICAL PLAN

SCALE: 1"=5'-0"
5 2.5 0 5'

NOTES:

- ① REFER TO SHEET E-001 FOR ELECTRICAL NOTES, SYMBOLS AND ABBREVIATIONS.
- ② CONTRACTOR TO FURNISH AND INSTALL ANTENNA MAST. OCU TO INSTALL RELOCATED SCADA PANEL, ANTENNA, AND ANTENNA CABLE. ORANGE COUNTY SCADA TO PROVIDE THE INTERCONNECTION BETWEEN THE PCP AND THE SCADA PANEL, INCLUDING ANTENNA CABLE FROM SCADA PANEL TO ANTENNA. CONTRACTOR TO FURNISH AND INSTALL CONDUIT.
- ③ CONTRACTOR TO FURNISH AND INSTALL THREE (3) 1" CONDUITS WITH PULLSTRING FROM THE SCADA PANEL TO THE PCP.
- ④ 1" EMPTY WITH PULLSTRING.



4763 SOUTH CONWAY ROAD, STE. E
ORLANDO, FLORIDA 32812
PHONE: (407) 745-5604
FAX: (407) 745-5603
C.O.A. No. 8079
LILLIAN M. REYES, P.E.
Florida P.E. No. 50780

REV	DATE	DESCRIPTION

LINE IS 2 INCHES
AT FULL SIZE
(IF NOT SCALE ACCORDINGLY)



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Landscape Lic. No. LC0000298

**PUMP STATION 3990
ELECTRICAL DEMOLITION
AND ELECTRICAL PLAN**

LILLIAN M. REYES
PROFESSIONAL ENGINEER
FLORIDA LICENSE #50780

OCU FILE NO.: 74325
DESIGNED BY: LMR
DRAWN BY: RRM
CHECKED BY: LMR
CADD FILE: E-101 PS 3990

SCALE: AS NOTED:
DRAWING NO.:
E-101
SHEET: 33 OF 40

BID DRAWING

LEGEND

AH	-	ALARM HORN	MB	-	MOTOR BREAKER
AL	-	ALARM LIGHT	MCB	-	MAIN CIRCUIT BREAKER
ALT	-	ALTERNATOR	MS	-	MOTOR STARTER
ASB	-	ALARM SILENCE BUTTON	OL	-	OVERLOAD
ATS	-	ALTERNATOR TEST SWITCH	PL	-	PILOT LIGHT
CB	-	CIRCUIT BREAKER	PM	-	PHASE MONITOR
CCB	-	CONTROL CIRCUIT BREAKER	R	-	RELAY
DPDT	-	DOUBLE POLE DOUBLE THROW	RL	-	RUNNING LIGHT
DRB	-	DUPLEX RECEPTACLE BREAKER	SCB	-	SCADA CIRCUIT BREAKER
ECB	-	EMERGENCY CIRCUIT BREAKER	SLB	-	SITE LIGHT BREAKER
ETM	-	ELAPSED TIME METER	TB	-	TERMINAL BLOCK
F	-	FUSE	TTS	-	THERMAL TERMINAL STRIP
FB	-	FUSE BLOCK	TVSS	-	TRANSIENT VOLTAGE SURGE SUPPRESSOR
FL	-	FLASHER	VA	-	VOLT AMPERE
FR	-	FLOAT REGULATOR	XFMR	-	TRANSFORMER
GFDR	-	GROUND FAULT DUPLEX RECEPTACLE			
GR	-	GENERATOR RECEPTACLE			
HOA	-	HAND-OFF-AUTO SELECTOR SWITCH			

LOAD TABULATION - PS 3259


SERVICE VOLTAGE: 240V,
3 ϕ

DESCRIPTION	LOAD	AMPACITY
PUMPS	2 @ 10 HP EACH	= 56.00 AMPS
MISCELLANEOUS LOADS	—	= 5.00 AMPS
CONNECTED LOAD		= 61.00 AMPS


①② SERVICE ENTRANCE = 61.00 AMPS + (.25)(28.0) = 68.00 AMPS

NOTES:

- SERVICE ENTRANCE MINIMUM SIZE AS PER ARTICLE 230 OF THE NATIONAL ELECTRICAL CODE.
- SERVICE ENTRANCE MINIMUM SIZE FOR ORANGE COUNTY IS 100 AMPS.

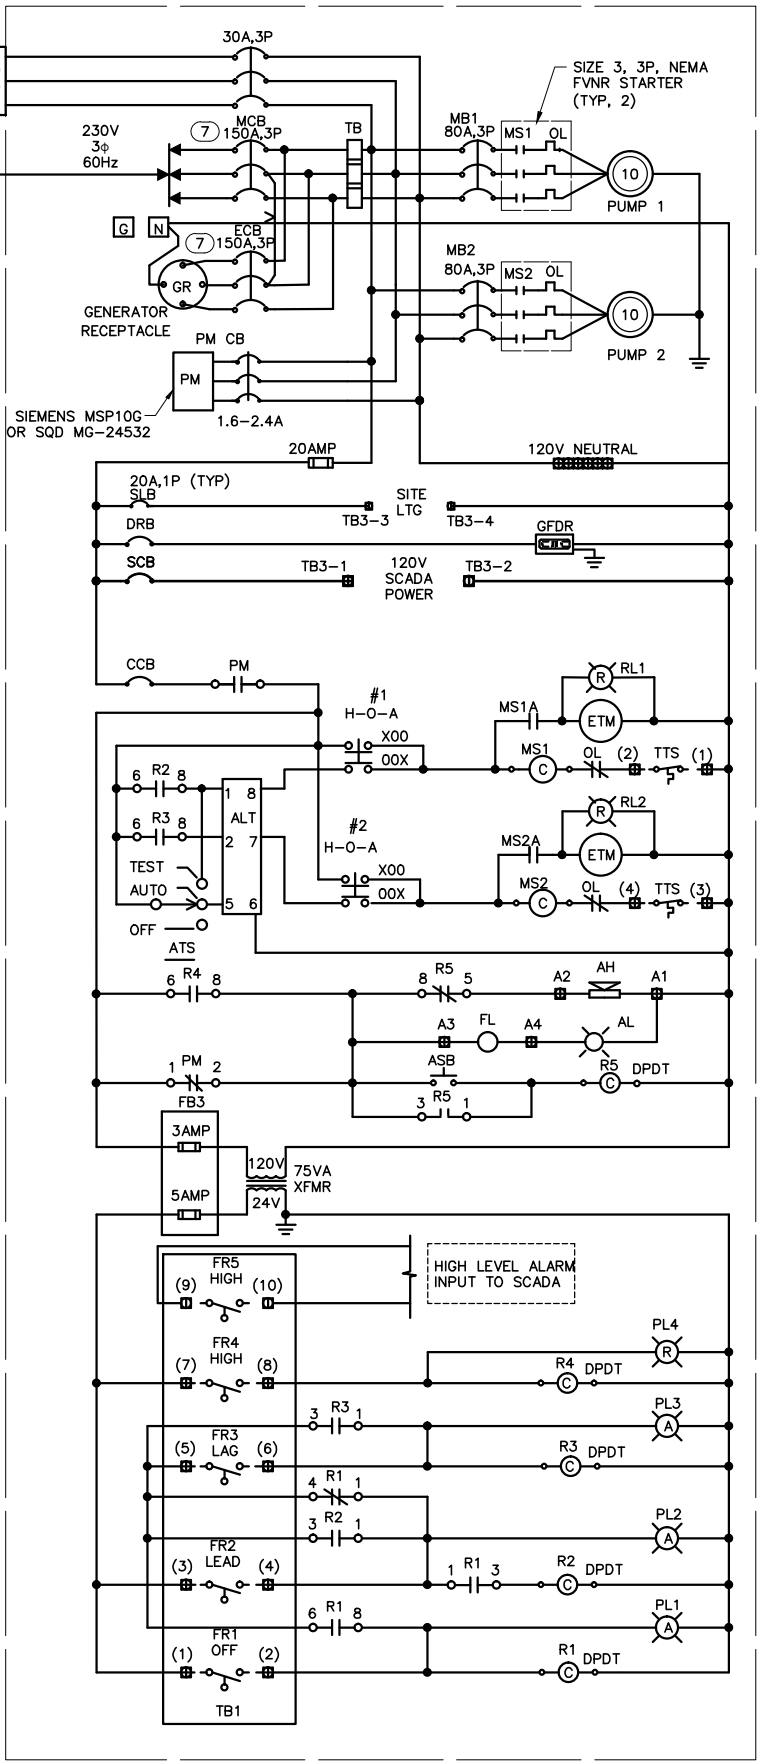

240V DUPLEX PUMP CONTROL SCHEMATIC

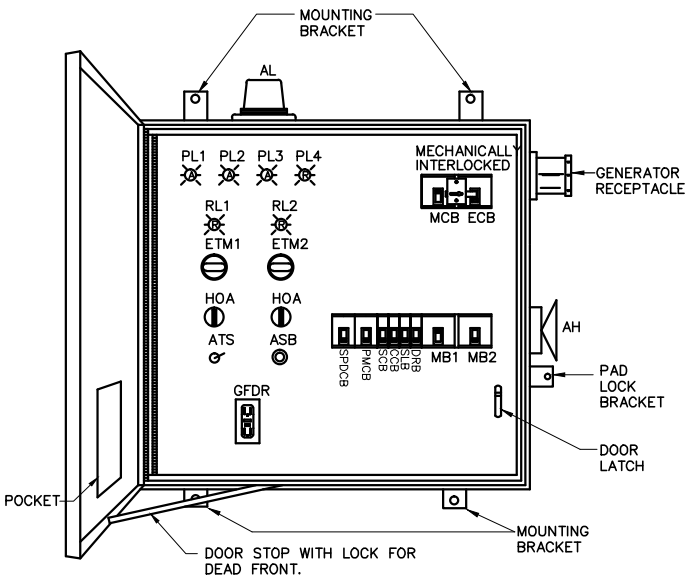

NOTES:

- DEADFRONT LAYOUT NEMA TYPE 3R S.S. ENCLOSURE W/CONTINUOUS HINGE. ALL HARDWARE TYPE 316 S.S. TYPICAL, ACTUAL LAYOUT MAY VARY WITH HORSEPOWER
- THIS CONTROL PANEL, INCLUDING THE GENERATOR RECEPTACLE, SHALL COMPLY WITH THE STANDARD LIST OF COMPONENTS REQUIRED BY ORANGE COUNTY UTILITIES.
- ALL CONTROL WIRE TO BE #14 AWG MINIMUM.
- CONTROL PANEL SHALL BE U.L. LISTED AND LABELED.
- CONTROL PANEL SHALL INCLUDE 30 SPARE TERMINALS (TB2).
- PHASE MONITOR CIRCUIT BREAKER TO BE SIEMENS P/N: MSP10G, OR SQ-D P/N: MG24532.
- PROVIDE AUXILIARY FORM "C" CONTACT ON MAIN AND EMERGENCY CIRCUIT BREAKERS IN PUMP CONTROL PANEL.
- ALL 240V CIRCUIT BREAKERS SHALL BE TYPE "HGL"

DUPLEX CONTROL PANEL
ENCLOSURE DEAD FRONT LAYOUT

SCALE: N.T.S.

REV	DATE	DESCRIPTION

LINE IS 2 INCHES
AT FULL SIZE
(IF NOT SCALE ACCORDINGLY)



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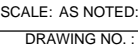
Licenses:

Eng. C.O.A. No. 3215
Survey L.B. No. 7143
Arch. Lic. No. AA2600926
Landscape Lic. No. LC0000298

PUMP STATION 3259
DUPLEX PUMP CONTROL PANEL
SINGLE LINE DIAGRAM

LILLIAN M. REYES
PROFESSIONAL ENGINEER
FLORIDA LICENSE #50780


OCU FILE NO.: 74325
DESIGNED BY: LMR
DRAWN BY: RRM
CHECKED BY: LMR
CADD FILE: E-200 PS 3259 SLD



4763 SOUTH CONWAY ROAD, STE. E
ORLANDO, FLORIDA 32812
PHONE: (407) 745-5604
FAX: (407) 745-5603
C.O.A. No. 8079
LILLIAN M. REYES, P.E.
Florida P.E. No. 50780

SCALE: AS NOTED:
DRAWING NO.:
E-200

SHEET: 34 OF 40

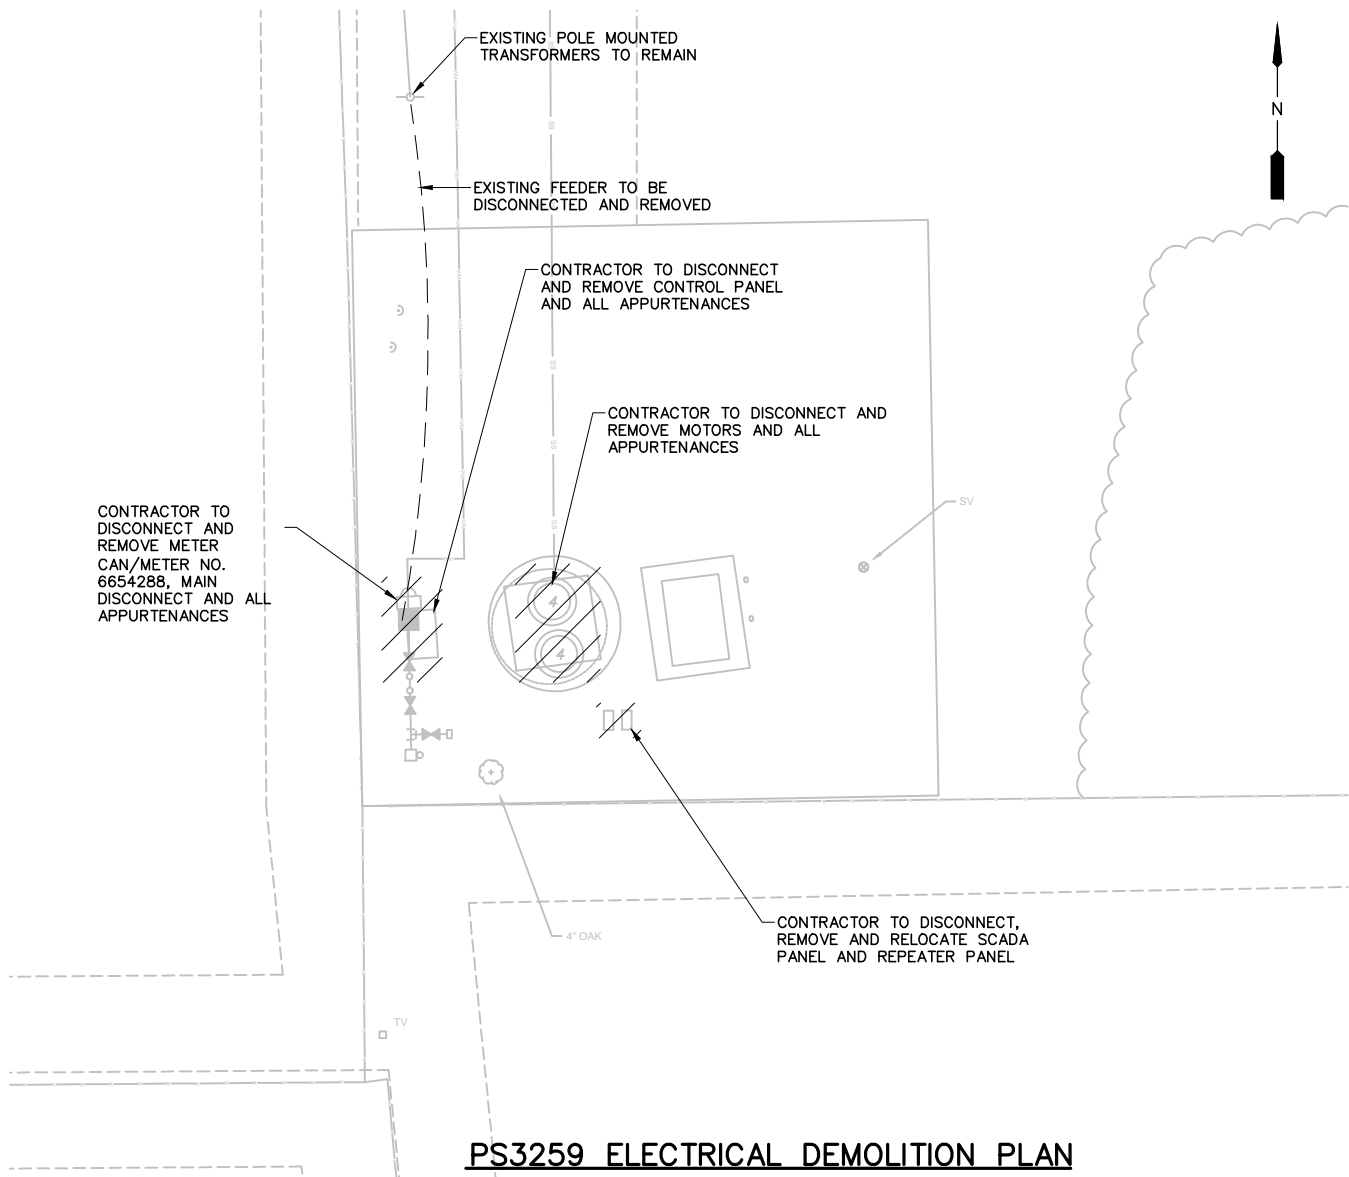

PS3259 ELECTRICAL DEMOLITION PLAN

SCALE: 1"=5'-0"
5 2.5 0 5'




PS3259 FIGURE NO. 1

SCALE: N.T.S.



PS3259 FIGURE NO. 2

SCALE: N.T.S.

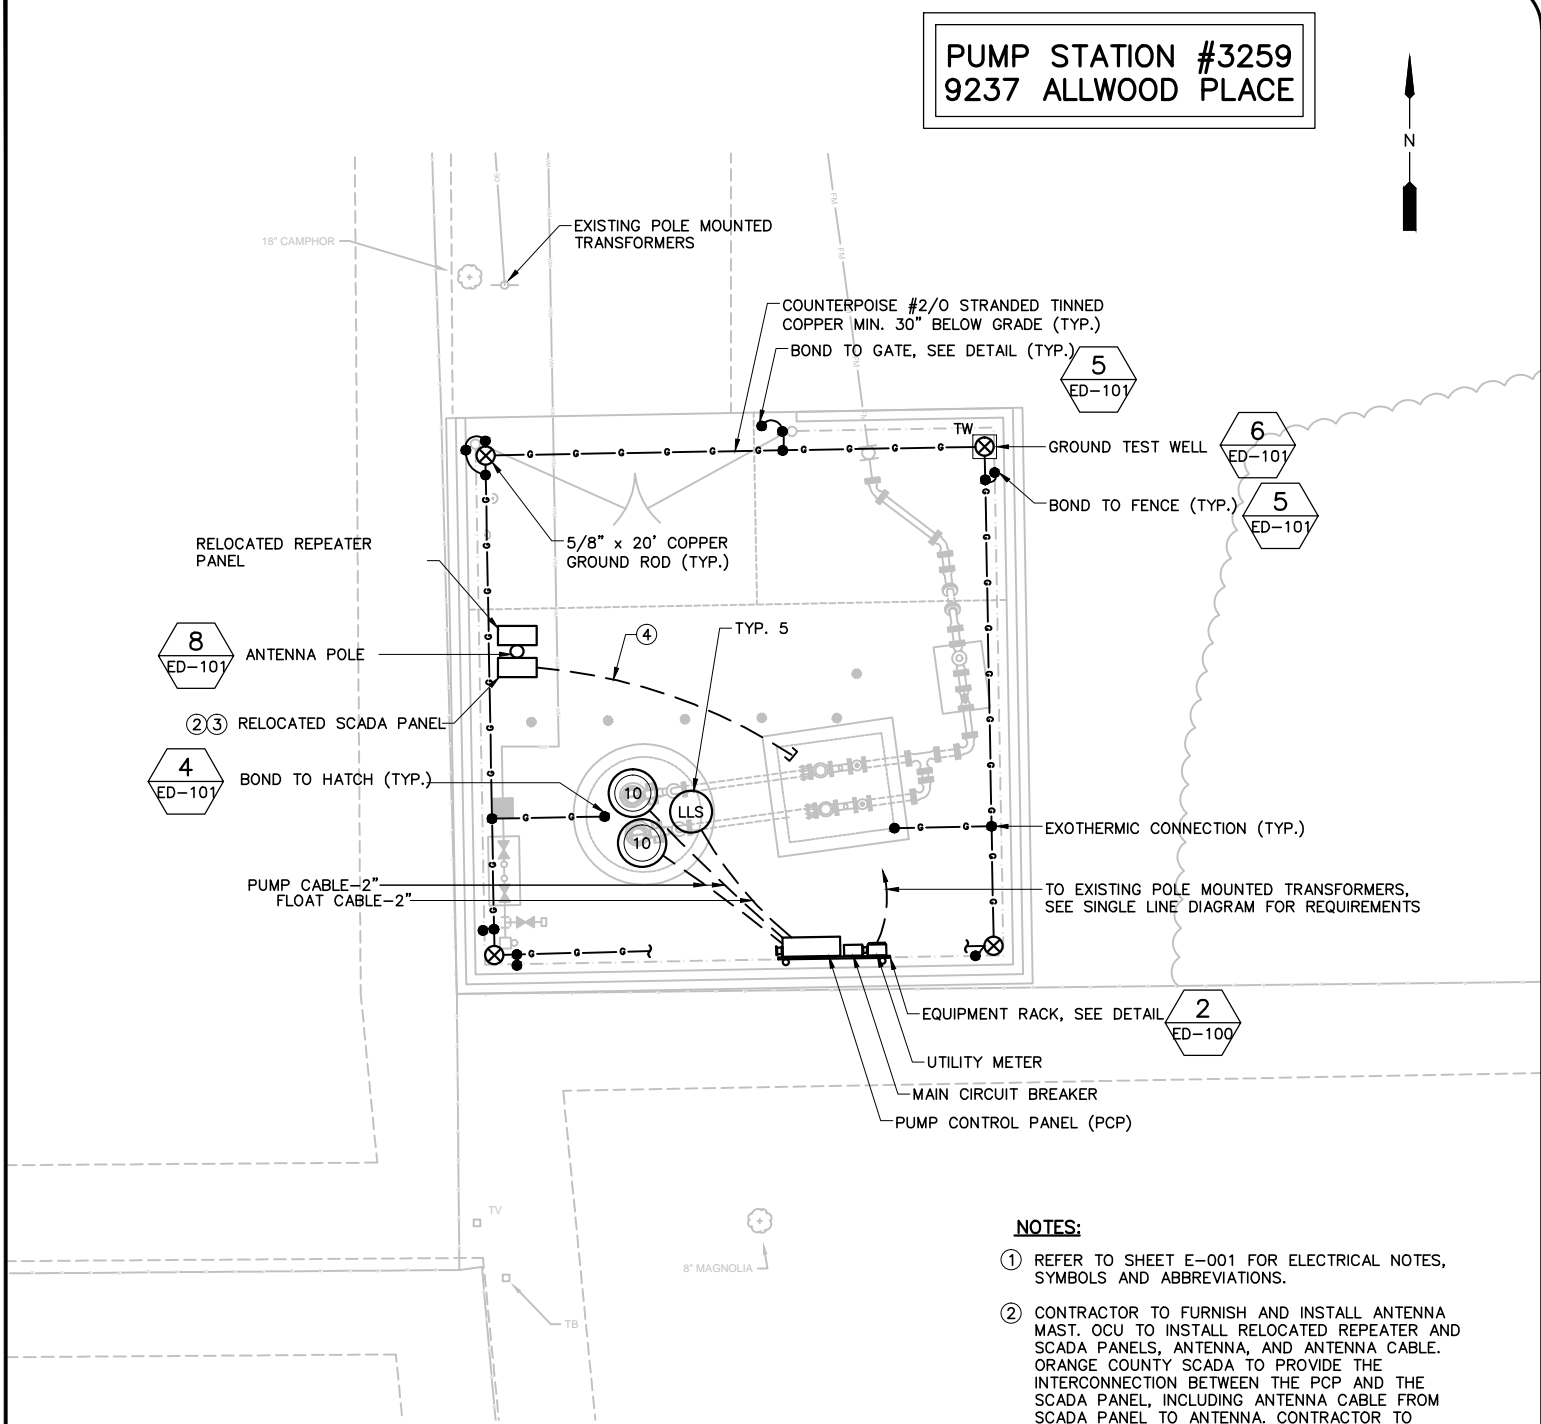

PS 3259 ELECTRICAL PLAN

SCALE: 1"=5'-0"
5 2.5 0 5'

NOTES:

- ① REFER TO SHEET E-001 FOR ELECTRICAL NOTES, SYMBOLS AND ABBREVIATIONS.
- ② CONTRACTOR TO FURNISH AND INSTALL ANTENNA MAST, OCU TO INSTALL RELOCATED REPEATER AND SCADA PANELS, ANTENNA, AND ANTENNA CABLE. ORANGE COUNTY SCADA TO PROVIDE THE INTERCONNECTION BETWEEN THE PCP AND THE SCADA PANEL, INCLUDING ANTENNA CABLE FROM SCADA PANEL TO ANTENNA. CONTRACTOR TO FURNISH AND INSTALL CONDUIT.
- ③ CONTRACTOR TO FURNISH AND INSTALL THREE (3) 1" CONDUITS WITH PULLSTRING FROM THE SCADA PANEL TO THE PCP.
- ④ 1" EMPTY WITH PULLSTRING.

REV	DATE	DESCRIPTION

LINE IS 2 INCHES
AT FULL SIZE
(IF NOT SCALE ACCORDINGLY)



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Survey L.B. No. 7143
Arch. Lic. No. AA2600926
Landscape Lic. No. LC0000298

**PUMP STATION 3259
ELECTRICAL DEMOLITION
AND ELECTRICAL PLAN**

LILLIAN M. REYES
PROFESSIONAL ENGINEER
FLORIDA LICENSE #50780


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DESIGNED BY: LMR
DRAWN BY: RRM
CHECKED BY: LMR
CADD FILE: E-201 PS 3259

SCALE: AS NOTED:
DRAWING NO.:
E-201
SHEET: 35 OF 40




BID DRAWING

PUMP STATION #3439
5267 SECLUDED OAKS DR.

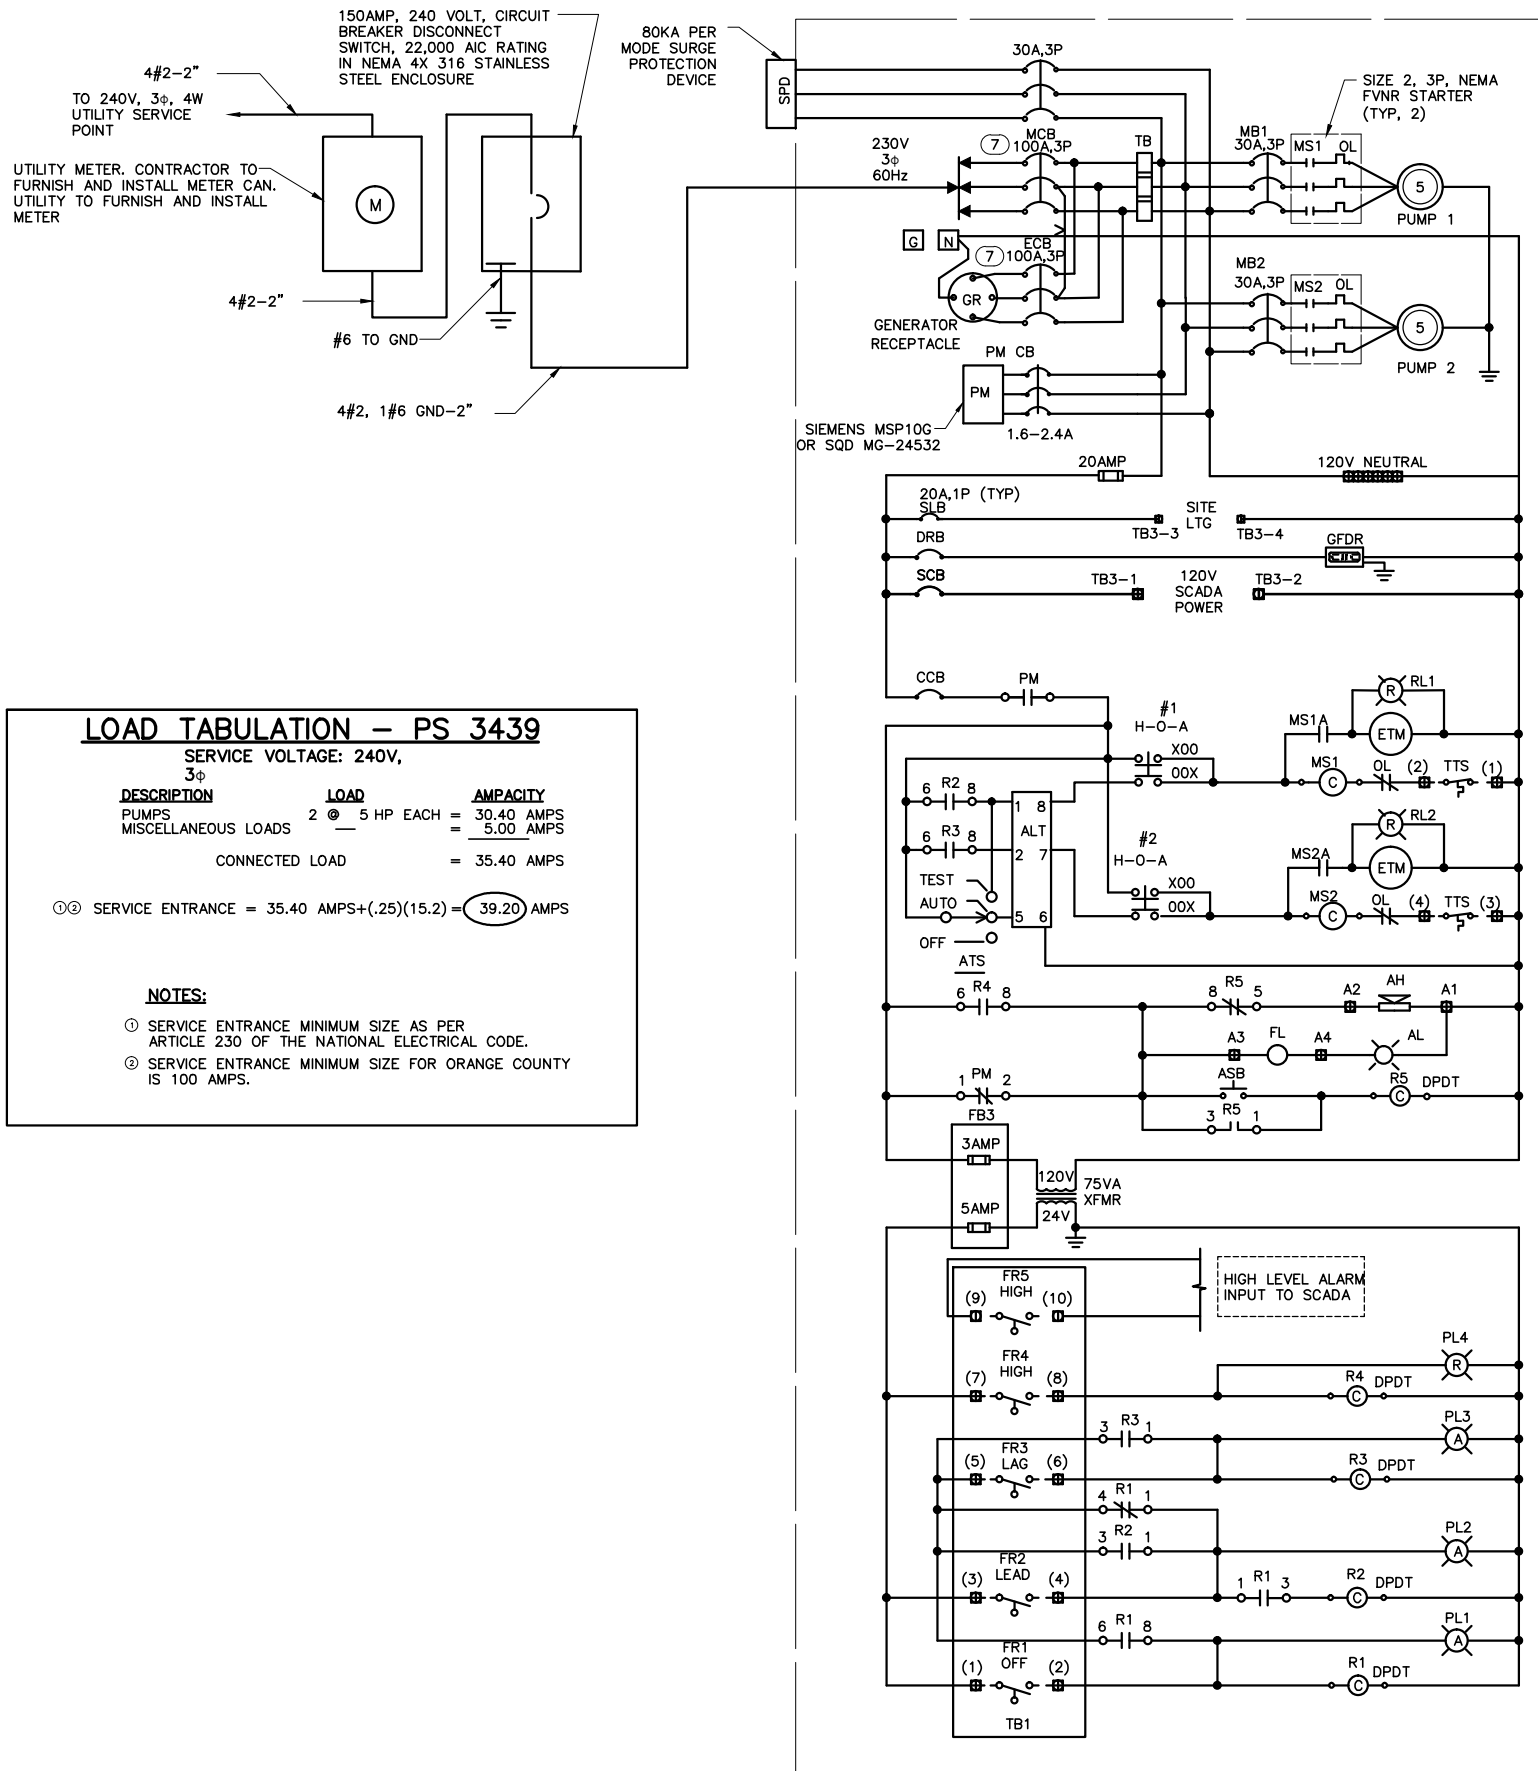

LEGEND

AH	ALARM HORN	MB	MOTOR BREAKER
AL	ALARM LIGHT	MCB	MAIN CIRCUIT BREAKER
ALT	ALTERNATOR	MS	MOTOR STARTER
ASB	ALARM SILENCE BUTTON	OL	OVERLOAD
ATS	ALTERNATOR TEST SWITCH	PL	PILOT LIGHT
CB	CIRCUIT BREAKER	PM	PHASE MONITOR
CCB	CONTROL CIRCUIT BREAKER	R	RELAY
DPDT	DOUBLE POLE DOUBLE THROW	RL	RUNNING LIGHT
DRB	DUPLEX RECEPTACLE BREAKER	SCB	SCADA CIRCUIT BREAKER
ECB	EMERGENCY CIRCUIT BREAKER	SLB	SITE LIGHT BREAKER
ETM	ELAPSED TIME METER	TB	TERMINAL BLOCK
F	FUSE	TTS	THERMAL TERMINAL STRIP
FB	FUSE BLOCK	TVSS	TRANSIENT VOLTAGE SURGE SUPPRESSOR
FL	FLASHER	VA	VOLT AMPERE
FR	FLOAT REGULATOR	XFMR	TRANSFORMER
GFDR	GROUND FAULT DUPLEX RECEPTACLE		
GR	GENERATOR RECEPTACLE		
HOA	HAND-OFF-AUTO SELECTOR SWITCH		

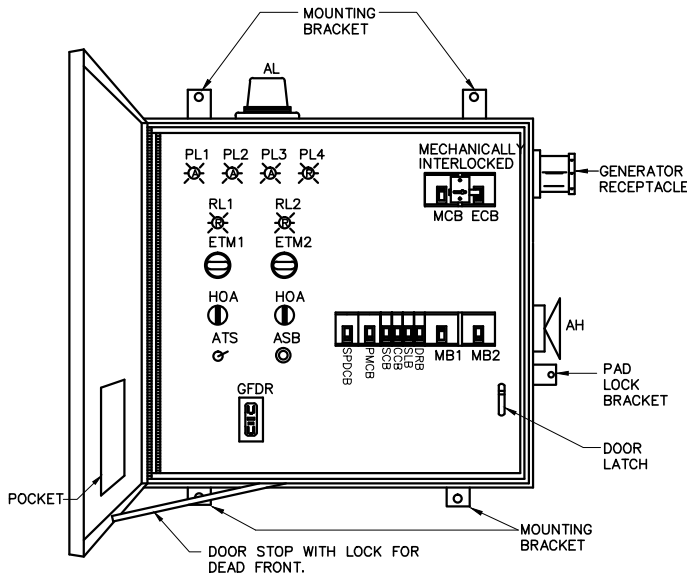

NOTES:

- (1) DEADFRONT LAYOUT NEMA TYPE 3R S.S. ENCLOSURE W/CONTINUOUS HINGE. ALL HARDWARE TYPE 316 S.S. TYPICAL, ACTUAL LAYOUT MAY VARY WITH HORSEPOWER
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- (4) CONTROL PANEL SHALL BE U.L. LISTED AND LABELED.
- (5) CONTROL PANEL SHALL INCLUDE 30 SPARE TERMINALS (TB2).
- (6) PHASE MONITOR CIRCUIT BREAKER TO BE SIEMENS P/N: MSP10G, OR SQ-D P/N: MQ24532.
- (7) PROVIDE AUXILIARY FORM "C" CONTACT ON MAIN AND EMERGENCY CIRCUIT BREAKERS IN PUMP CONTROL PANEL.
- (8) ALL 240V CIRCUIT BREAKERS SHALL BE TYPE "HGL"

DUPLEX CONTROL PANEL ENCLOSURE DEAD FRONT LAYOUT

SCALE: N.T.S



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C.O.A. No. 8079
LILLIAN M. REYES, P.E.
Florida P.E. No. 50780

[illegible]

LINE IS 2 INCHES
AT FULL SIZE
(IF NOT SCALE ACCORDINGLY)



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by L.B. No. 7143
Lic. No. AA2600926
Lic. No. LC0000291



PUMP STATION 3439
 DUPLEX PUMP CONTROL PANEL
 SINGLE LINE DIAGRAM

LILLIAN M. REYES
PROFESSIONAL ENGINEER
FLORIDA LICENSE #50780

OCU FILE NO.: 74325
DESIGNED BY: LMR
DRAWN BY: RRM
CHECKED BY: LMR
CADD FILE: E-300 300 PS 3439 SLD

SCALE: AS NOTED:
DRAWING NO. :
E-300
SHEET: 36 OF 40

BID DRAWING

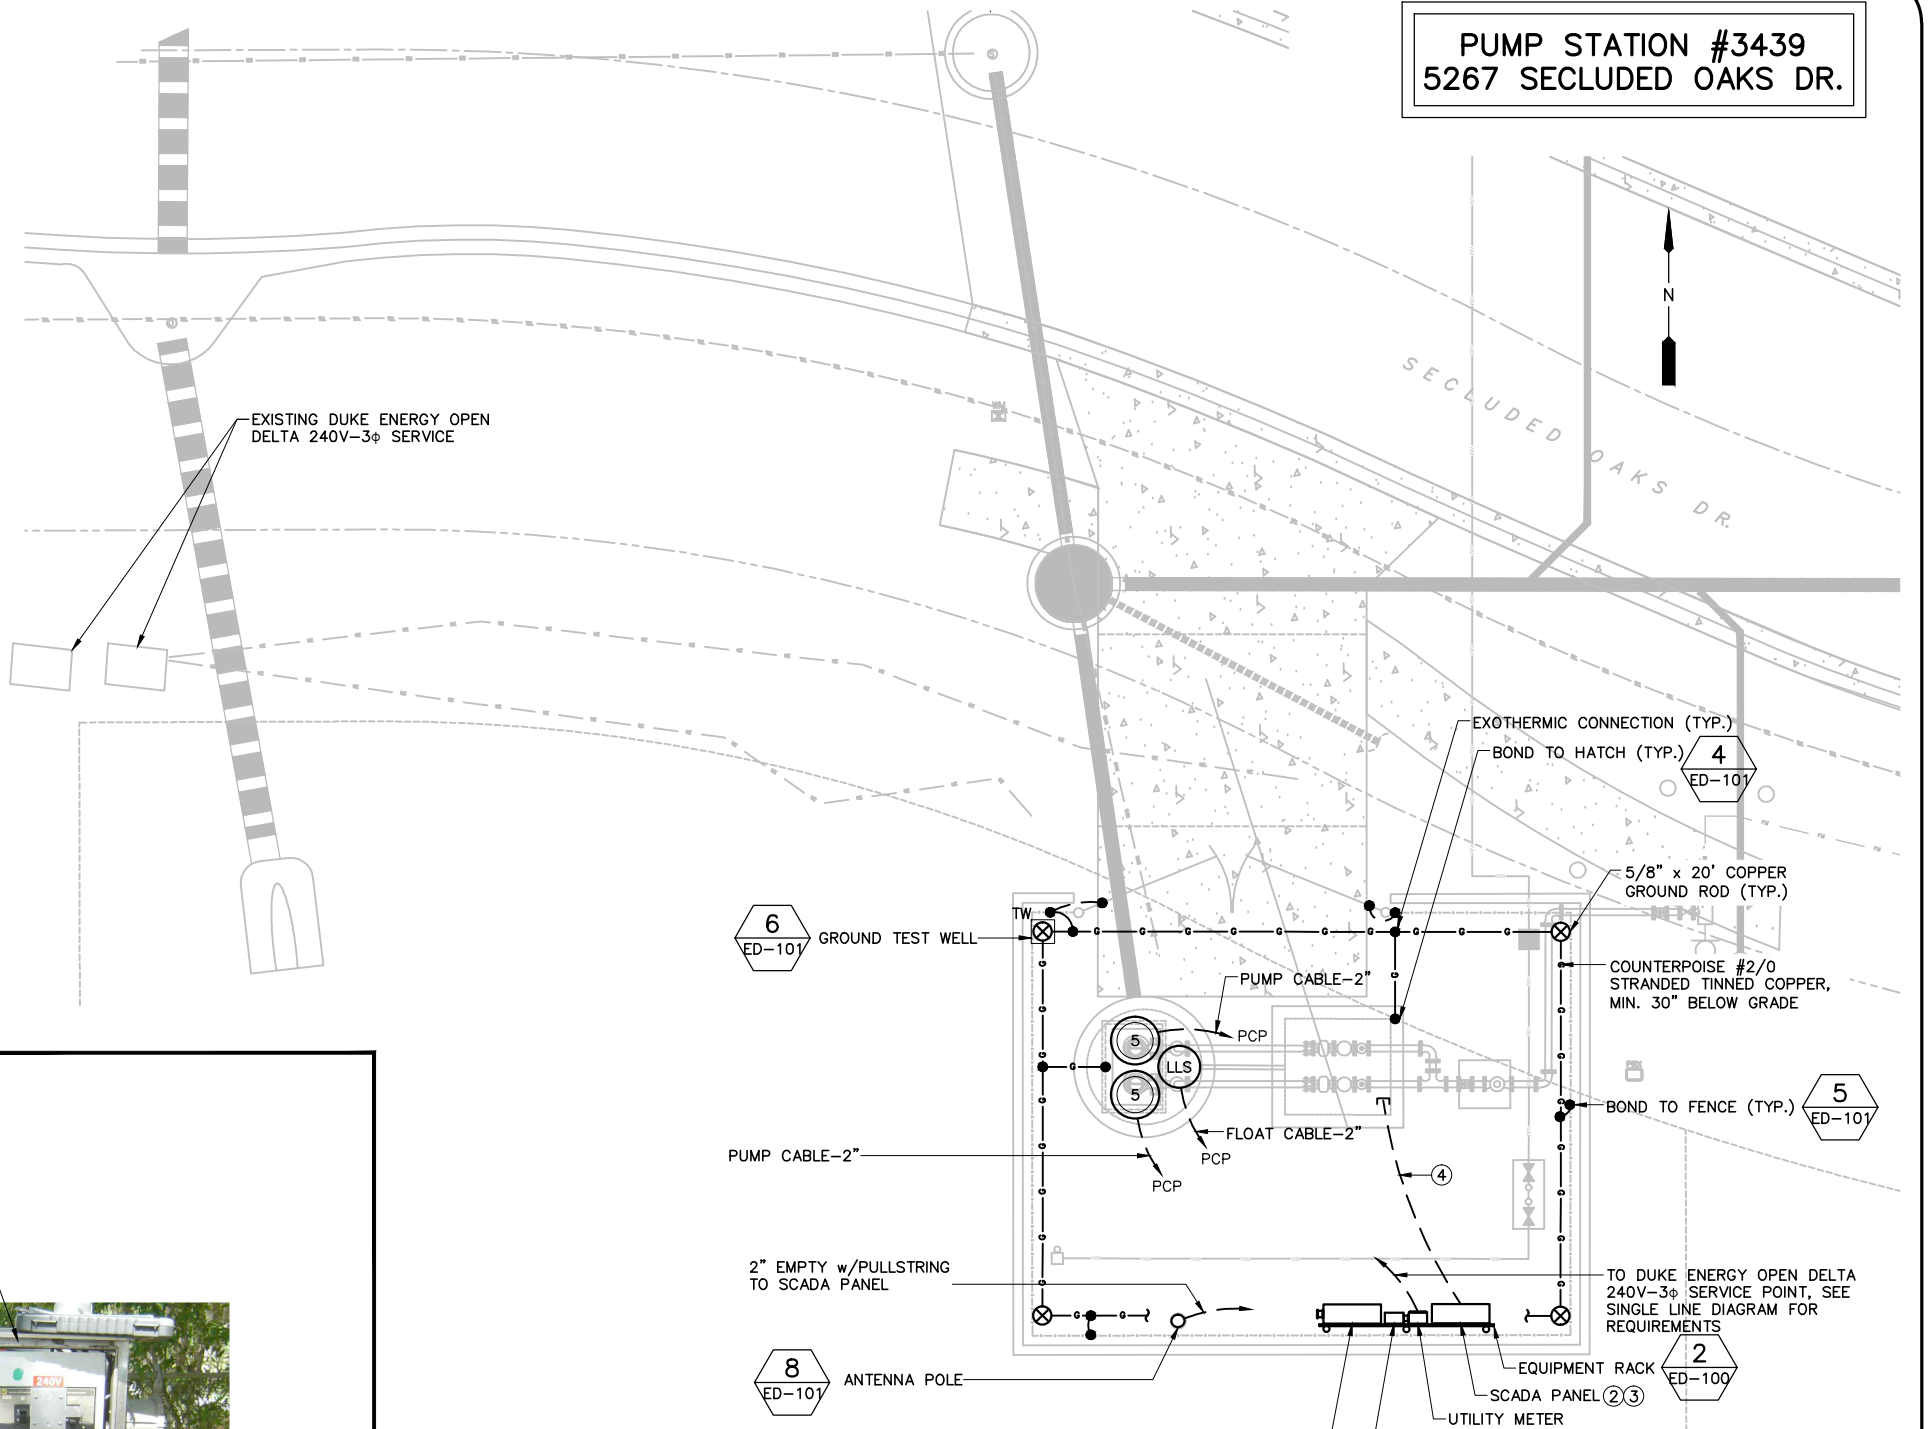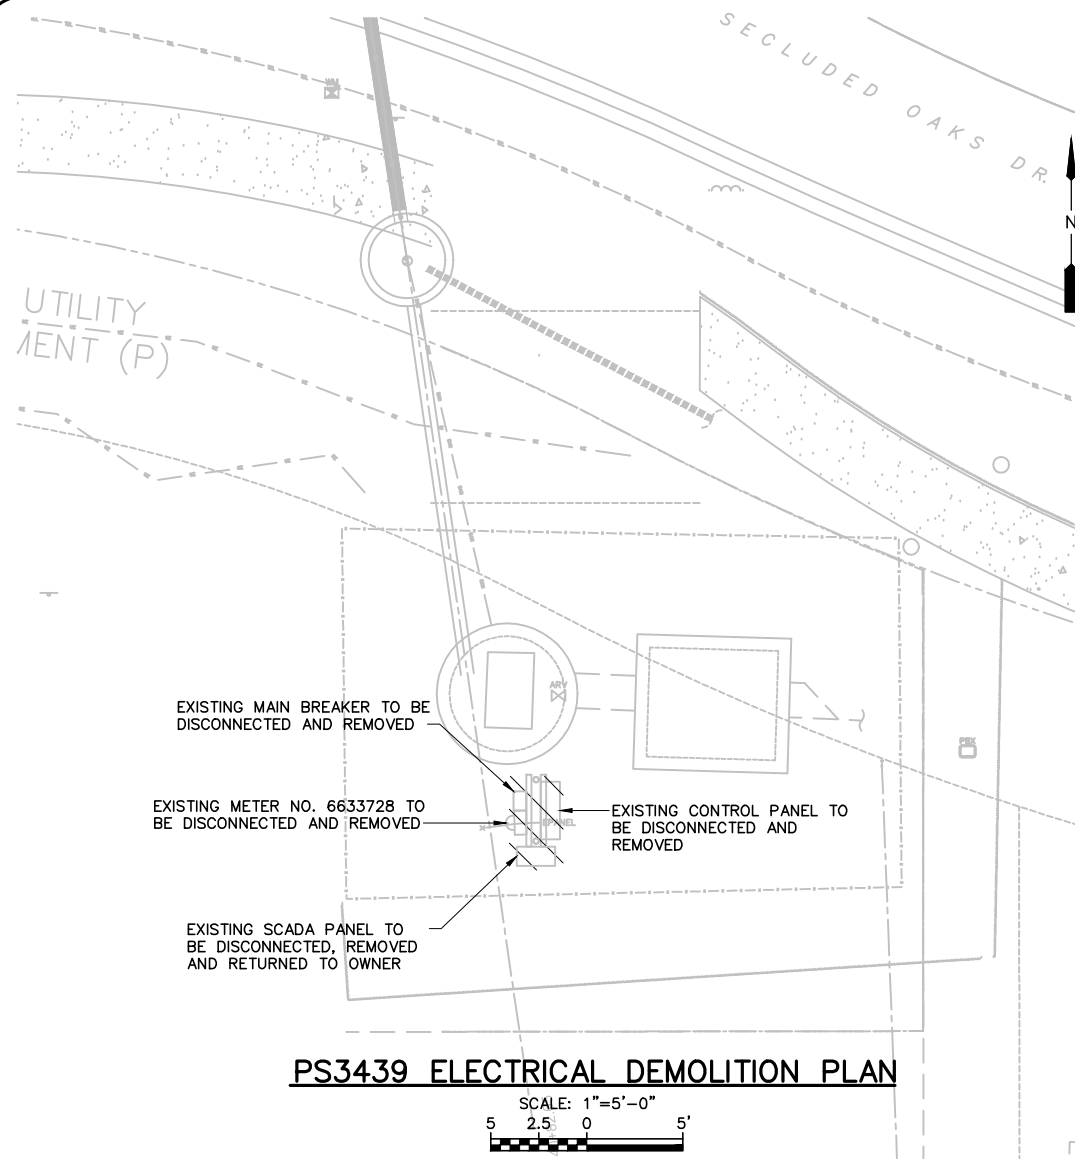

NOTES:

- REFER TO SHEET E-001 FOR ELECTRICAL NOTES, SYMBOLS AND ABBREVIATIONS.
- CONTRACTOR TO FURNISH AND INSTALL ANTENNA MAST, OCU TO INSTALL RELOCATED SCADA PANEL, ANTENNA, AND ANTENNA CABLE. ORANGE COUNTY SCADA TO PROVIDE THE INTERCONNECTION BETWEEN THE PCP AND THE SCADA PANEL, INCLUDING ANTENNA CABLE FROM SCADA PANEL TO ANTENNA. CONTRACTOR TO FURNISH AND INSTALL CONDUIT.
- CONTRACTOR TO FURNISH AND INSTALL THREE (3) 1" CONDUITS WITH PULLSTRING FROM THE SCADA PANEL TO THE PCP.
- 1" EMPTY WITH PULLSTRING.

REV	DATE	DESCRIPTION

LINE IS 2 INCHES
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Survey L.B. No. 7143
Arch. Lic. No. AA2600926
Landscape Lic. No. LC0000298

**PUMP STATION 3439
ELECTRICAL PLAN**


LILLIAN M. REYES
PROFESSIONAL ENGINEER
FLORIDA LICENSE #50780

OCU FILE NO.: 74325
DESIGNED BY: LMR
DRAWN BY: RRM
CHECKED BY: LMR
CADD FILE: E-301 PS 3439



SCALE: AS NOTED:
DRAWING NO.:
E-301
SHEET: 37 OF 40

BID DRAWING

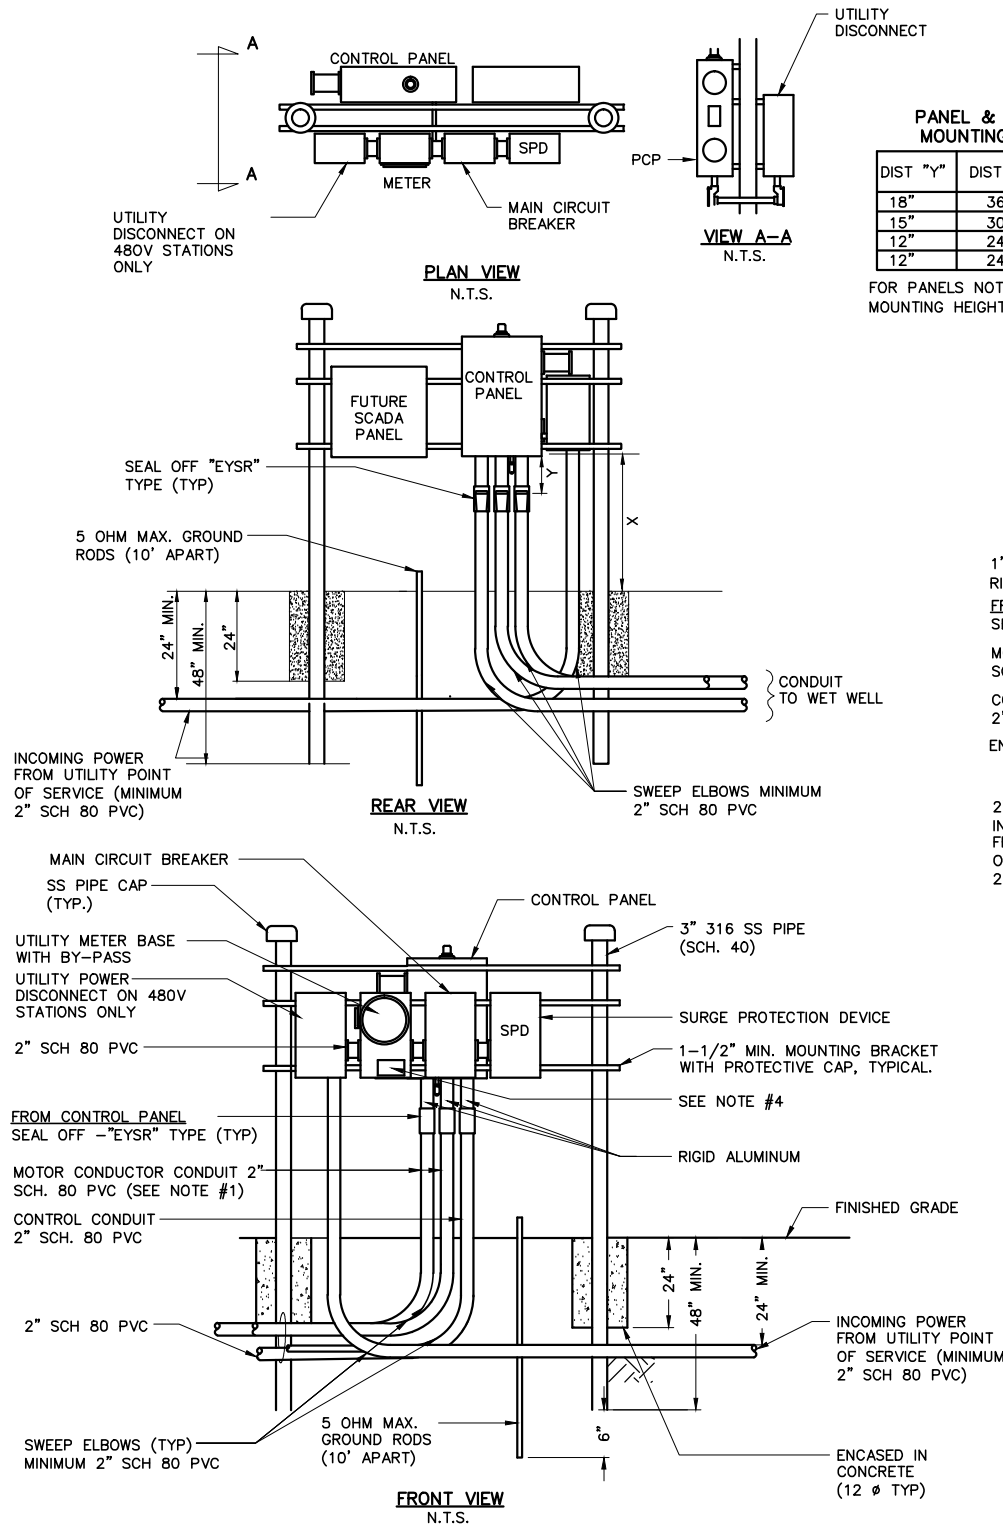


**1 A413-1 & A413-2
BACK TO BACK EQUIPMENT RACK**
N.T.S.

PANEL & SEAL-OFF MOUNTING HEIGHTS

DIST "Y"	DIST "X"	PANEL HEIGHT
18"	36"	36"
15"	30"	42"
12"	24"	48"
12"	24"	60"



FOR PANELS NOT LISTED ADJUST MOUNTING HEIGHTS ACCORDINGLY

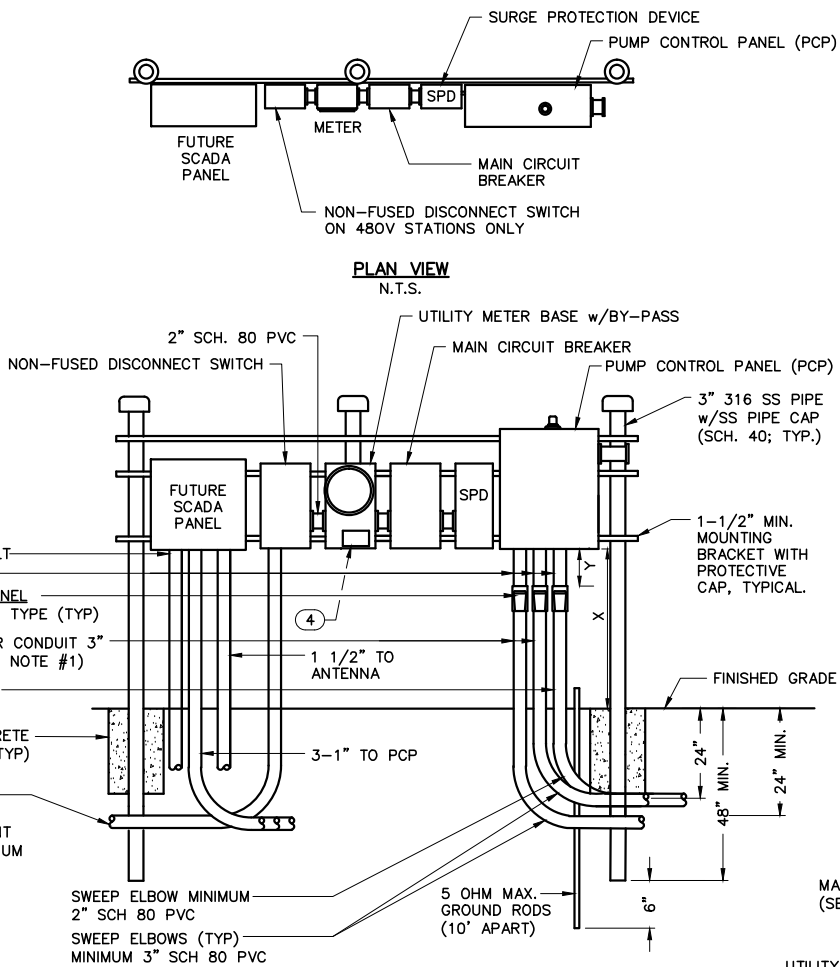

2 SIDE BY SIDE EQUIPMENT RACK
N.T.S.

PANEL INSTALLATION NOTES:

- PUMP MOTOR CONDUIT SHALL BE SIZED TO ACCOMMODATE 40% CONDUIT FILL. MINIMUM CONDUIT SIZE TO BE 2" SCH 80 PVC.
- POWER SUPPLY SHALL BE UNDERGROUND ON THE LIFT STATION SITE AND SHALL BE 3-PHASE, FROM A 3-PHASE SOURCE ONLY.
- AN ELECTRICAL GROUNDING SYSTEM SHALL BE INSTALLED AS PER THE NATIONAL ELECTRICAL CODE, LOCAL CODES AND ORDINANCES, AN UNDERGROUND PERIMETER CABLE GROUNDING SYSTEM SHALL BE INSTALLED WITH CONNECTIONS TO AT LEAST WET WELL COVER, VALVE VAULT COVER, CONTROL PANELS, UTILITY COMPANY TRANSFORMER, MANUAL DISCONNECT SWITCH AND METAL FENCE. REFER TO GROUNDING DETAILS.
- THE STATION NAME, ORANGE COUNTY I.D. NUMBER, AND ADDRESS SHALL BE AFFIXED TO THE FRONT OF THE METER CABINET.
- ALL MOUNTING HARDWARE, BRACKETS AND ELECTRICAL ENCLOSURES SHALL BE 316 STAINLESS STEEL.
- THE SCADA PANEL IS SHOWN FOR INFORMATION ONLY AND WILL BE INSTALLED IN THE FUTURE (BY OTHERS).

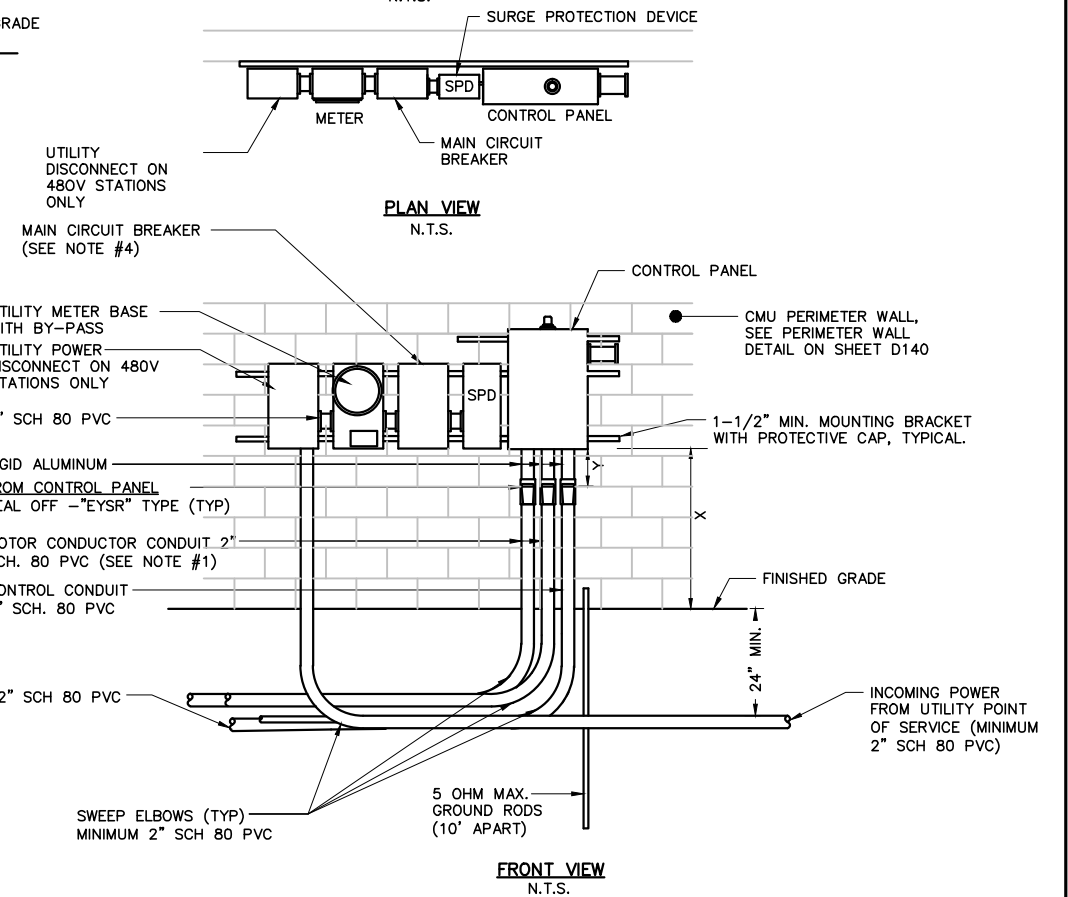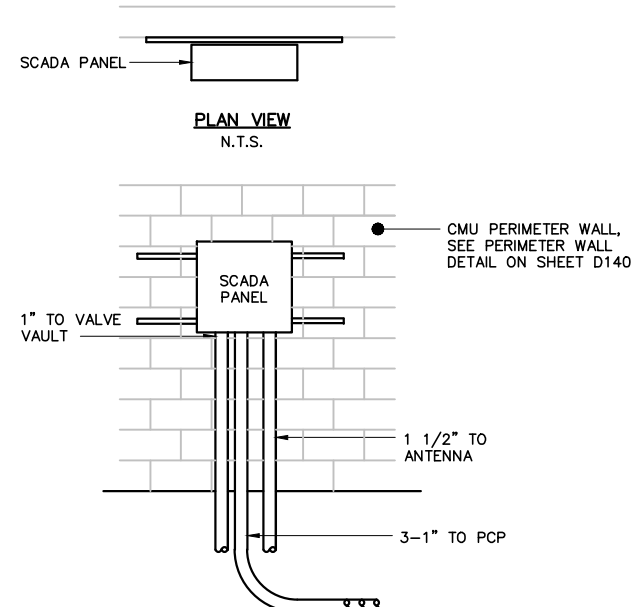

3 SPLIT EQUIPMENT RACK
N.T.S.

REV	DATE	DESCRIPTION

LINE IS 2 INCHES
AT FULL SIZE
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**ELECTRICAL DETAILS
SHEET 1**


LILLIAN M. REYES
PROFESSIONAL ENGINEER
FLORIDA LICENSE #50780

OCU FILE NO.: 74325
DESIGNED BY: LMR
DRAWN BY: RRM
CHECKED BY: LMR
CADD FILE: ED-100 DTLS

SCALE: AS NOTED:
DRAWING NO.:
ED-100
SHEET: 38 OF 40


EDA
Electrical Design Associates
4763 SOUTH CONWAY ROAD, STE. E
ORLANDO, FLORIDA 32812
PHONE: (407) 745-5604
FAX: (407) 745-5603
C.O.A. No. 8079
LILLIAN M. REYES, P.E.
Florida P.E. No. 50780

BID DRAWING

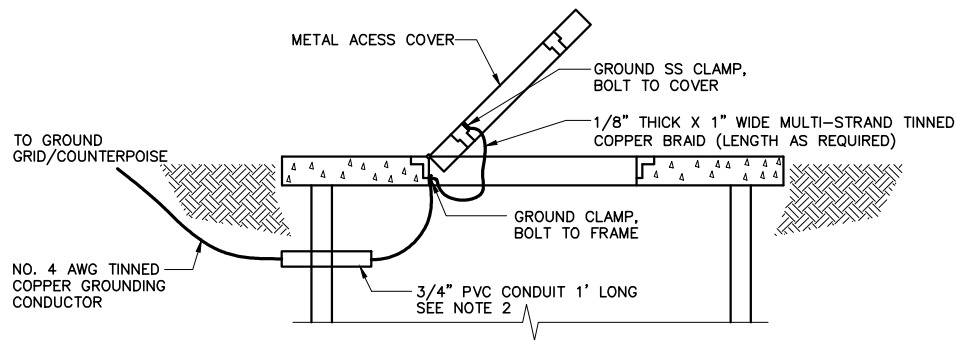


1. ON COVERS WITH MULTIPLE DOORS, PROVIDE BRAID FROM FRAME TO DOOR ON EACH DOOR
2. PROVIDE WATERPROOF CAULKING WHERE GROUND CABLE AND CONDUIT PENETRATES WETWELL TO PREVENT INTRUSION OF GROUND WATER AND ESCAPE OF VAPORS FROM WETWELL.
3. INSTALL GROUND WIRE SO THAT IT WILL NOT CROSS CLEAR OPENING OR PREVENT OR IMPEDE NORMAL METHOD OF REMOVING FLOATS OR PUMPS.

4
ED-101
COVER & DOOR GROUNDING DETAIL
N.T.S.

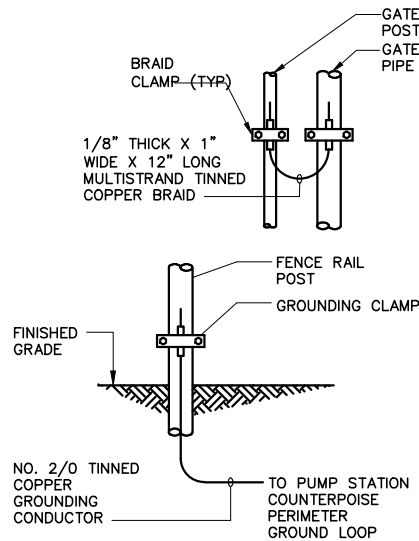


5
ED-101
FENCE POST GROUNDING
N.T.S.

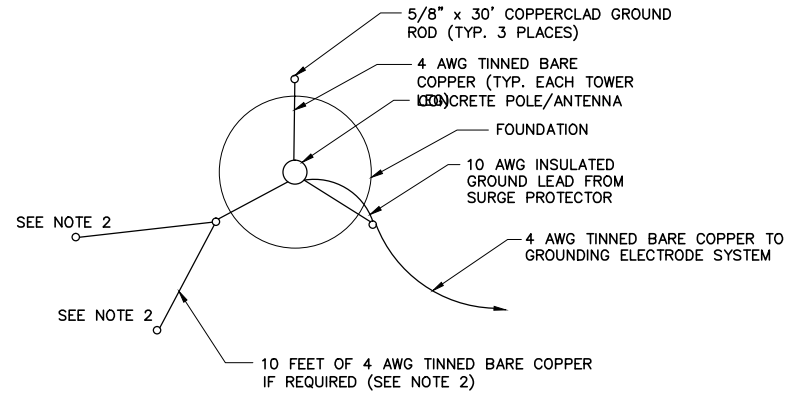


1. MEGGER GROUND SYSTEM FOLLOWING INSTALLATION.
2. IF READING IS GREATER THAN 5 OHMS, INSTALL TWO ADDITIONAL GROUND RODS RADIALLY FROM EACH LEG AS SHOWN UNTIL A VALUE OF 5 OHMS OR LESS IS ATTAINED.
3. IF READING IS STILL ABOVE 5 OHMS, INCREASE THE LENGTH OF EACH ROD IN 10 FEET INCREMENTS UNTIL THE REQUIRED VALUE IS OBTAINED
4. ALL ELECTRODE SYSTEM CONNECTIONS TO BE EXOTHERMALLY BONDED.
5. USE MOST STRINGENT REQUIREMENT OF THESE DETAILS OR APPLICABLE CODES.

7
ED-101
MAST GROUNDING PLAN
N.T.S.

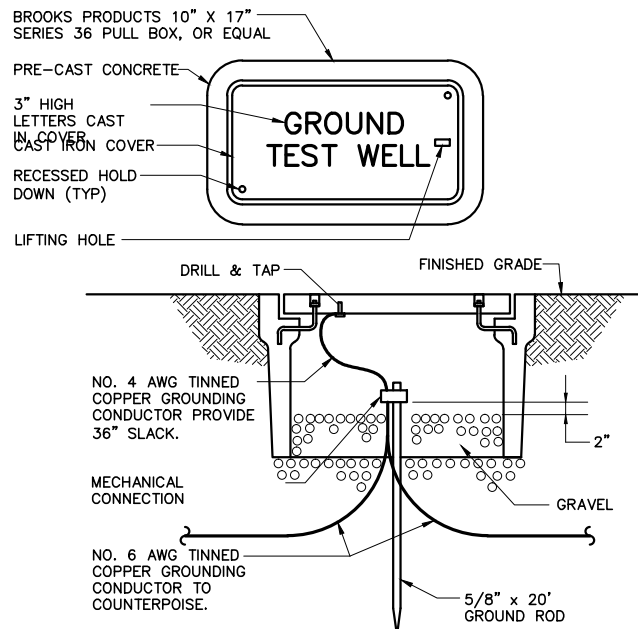

6
ED-101
GROUND TEST WELL
N.T.S.

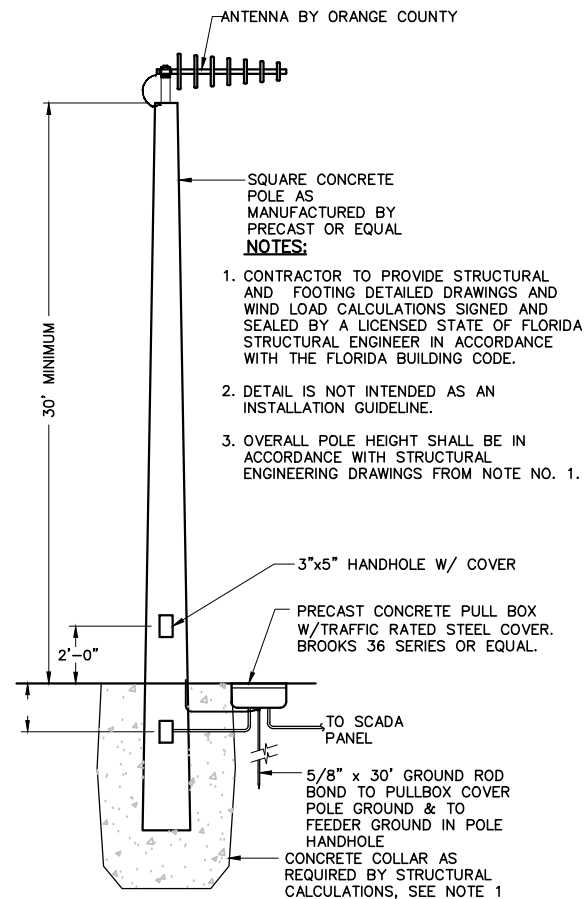

8
ED-101
ANTENNA POLE DETAIL
N.T.S.

REV	DATE	DESCRIPTION

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Survey L.B. No. 7143
Arch. Lic. No. AA2600926
Lndscp. Lic. No. LC0000298

**ELECTRICAL DETAILS
SHEET 2**

LILLIAN M. REYES
PROFESSIONAL ENGINEER
FLORIDA LICENSE #50780

OCU FILE NO.: 74325
DESIGNED BY: LMR
DRAWN BY: RRM
CHECKED BY: LMR
CADD FILE: ED-101 DTLs

SCALE: AS NOTED:
DRAWING NO.:
ED-101
SHEET: 39 OF 40

EDA
Electrical Design Associates
4763 SOUTH CONWAY ROAD, STE. E
ORLANDO, FLORIDA 32812
PHONE: (407) 745-5604
FAX: (407) 745-5603
C.O.A. No. 8079
LILLIAN M. REYES, P.E.
Florida P.E. No. 50780

BID DRAWING

VALVES															
ID Number	Plan Sheet #	Easting	Northing	Elevation	Valve Type	Main Type	Size	Valve Manufacturer	Valve Model #	# of Turns to Close	Gear Actuator	Gear Ratio	Side Actuator	Actuator Manufacturer	Comments
LS-1	C301				Line Stop	Force Main	6"								PS 3439
LS-2	C301				Line Stop	Force Main	4"								PS3439
TSV-1	C301				Tapping Sleeve & Valve	Force Main	6"x 4"								PS3439
PV-1	C301				Plug	Force Main	4"								PS 3439

SANITARY MANHOLES														
ID Number	Plan Sheet #	Easting	Northing	Rim Elevation	Invert Elv N	Invert Elv NE	Invert Elv E	Invert Elv SE	Invert Elv S	Invert Elv SW	Invert Elv W	Invert Elv NW	Manufacturer	Comments
ID Number	Plan Sheet #	Easting	Northing	Rim Elevation	Invert Elv N	Invert Elv NE	Invert Elv E	Invert Elv SE	Invert Elv S	Invert Elv SW	Invert Elv W	Invert Elv NW	Manufacturer	Comments
MH 34390002	C303			104.29				98.84			98.84			Lined Existing
MH 34390004	C303			104.94	98.64		88.61		88.51					Replace Existing MH 34392001
MH-34390005	C303			104.24			89.92				89.72			Replace Existing MH 30920001
MH-34390006	C303			102.75	91.15						91.13			Replaces demolished PS 3092

FITTINGS							
ID Number	Plan Sheet #	Easting	Northing	Elevation	Main Type	Fitting Type	Comments
FM-1	C101				Force Main	Bend 90°	8"
FM-2	C301				Force Main	Cap	6"
FM-3	C301				Force Main	Cap	4"

PUMP STATION						
ID Number	Plan Sheet #	Easting	Northing	Elevation	Manufacturer	Comments
PS 3990	C101			71.17		Existing Pump Station to be Rehab
PS 3259	C201			105.00		Existing Pump Station to be Rehab
PS 3439	C302			79.99		Existing Pump Station to be Rehab

CLEANOUTS					
ID Number	Plan Sheet #	Easting	Northing	Elevation	Comments
CO-1	C303				
CO-2	C303				
CO-3	C303				
CO-4	C303				
CO-5	C303				
CO-6	C303				
CO-7	C303				
CO-8	C303				
CO-9	C303				
CO-10	C303				

PUMP STATION TRACT CORNERS						
ID Number	Plan Sheet #	Easting	Northing	Elevation	Boundary Corner Type	Comments
Corner-1	C102				Pump Station Tract	N.W. Corner of PS 3990
Corner-2	C102				Pump Station Tract	N.E. Corner of PS 3390
Corner-3	C102				Pump Station Tract	S.W. Corner of PS 3390
Corner-4	C102				Pump Station Tract	S.E. Corner of PS 3390
Corner-5	C201				Pump Station Tract	N.W. Corner of PS 3259
Corner-6	C201				Pump Station Tract	N.E. Corner of PS 3259
Corner-7	C201				Pump Station Tract	S.W. Corner of PS 3259
Corner-8	C201				Pump Station Tract	S.E. Corner of PS 3259
Corner-9	C302				Pump Station Tract	N.W. Corner of PS 3439
Corner-10	C302				Pump Station Tract	N.E. Corner of PS 3439
Corner-11	C302				Pump Station Tract	S.W. Corner of PS 3439
Corner-12	C302				Pump Station Tract	S.E. Corner of PS 3439

METERS						
ID Number	Plan Sheet #	Easting	Northing	Elevation	Main Type	Comments
MM-1	C101				Water Main	Above Ground at PS 3990
MM-2	C201				Water Main	Above Ground at PS 3259
MM-3	C301				Water Main	Above Ground at PS 3439