April 18, 2017

BOARD OF COUNTY COMMISSIONERS ORANGE COUNTY, FLORIDA ADDENDUM NO. 1 / IFB NO. Y17-751-PH

OLD CHENEY HIGHWAY, ROBINSWOOD HILLS, SYLVAN HEIGHTS AND SHELDON TERRACE WASTEWATER IMPROVEMENTS PACKAGE 10

BID OPENING DATE: April 25, 2017

This addendum is hereby incorporated into the bid documents of the project referenced above. The following items are clarifications, corrections, additions, deletions and/or revisions to and shall take precedence over the original documents. Additions are indicated by **underlining**, deletions are indicated by strikethrough.

A. CLARIFICATIONS

B. PROJECT DRAWINGS

Please see the attached Electrical Drawings to replace E-001 through ED-101 (total of eight sheets).

C. On Invitation for Bid Documents - BID SCHEDULE

No changes

D. ACKNOWLEDGEMENT OF ADDENDA

a. The Proposer shall acknowledge receipt of this addendum by completing the applicable section in the solicitation or by completion of the acknowledgement information on the addendum. Either form of acknowledgement must be completed and returned not later than the date and time for receipt of proposal.

All other terms, conditions and specifications remain the same.

Receipt acknowledged by:

Authorized Signature

Date Signed

Title

Name of Firm

PLAN SYMBOLS	RISER	& CONTROL DIAGRAM SYMBOLS	5	ABBREVIATIONS	
PLAN SYMBOLS HOME RUN TO PARELEDARD. NO. OF ARROWS INDICATE NO. OF CRUTTS, HARKS INDICATE 2, #12 CONDUCTORS. NO HASH MARKS INDICATE 2, #12 CONDUCTORS. NO HASH MARKS INDICATE 2, #12 CONDUCTORCEALED IN WALL IN SLAB ABOVE, OR ABOVE CELLING CONDUIT CONCEALED IN WALL IN SLAB ABOVE, OR ABOVE CELLING CONDUIT RUN EXPOSED. RUN PARALLEL OR PERPENDICULAR TO STRUCTURE OR WALL. OW POLE MOUNTED LIGHTING FIXTURE. Image: Provide and the provide the provide connection. Image: Provide and the provide the prov	X X X	 CONTROL DIAGRAM SYMBOLS NORMALLY OPEN, TIMED TO CLOSE CONTACT NORMALLY CLOSED, TIMED TO OPEN CONTACT NORMALLY OPEN, TIMED TO OPEN CONTACT LIMIT SWITCH TORQUE SWITCH SPEED SWITCH SOLENOID VALVE LIQUID LEVEL SWITCH VIBRATION SWITCH ALARM RELAY ALARM TIMER CONTROL RELAY ALARM INDICATING LIGHT RUN INDICATING LIGHT MOMENTARY CONTACT PUSHBUTTON MOMENTARY BREAK PUSHBUTTON OR RESET KEYED SWITCH START/STOP(S/S) CONTROL SWITCH MAINTAINED CONTACT THREE POSITION MAINTAINED CONTACT SELECTOR SWITCH TORTOL POWER TRANSFORMER REMOTE TERMINAL BLOCK POINT MINI-POWER ZONE 	A AFF AH AIC ALS BENT ALS BETTER AT AND ALS	AMPERES ABOVE FINISHED FLOOR ALARM HORN AMPS INTERRUPTING CURRENT ALARM LIGHT AUTOMATIC TRANSFER SWITCH ALTERNATOR TEST SWITCH BREAKER CONTROL CIRCUIT BREAKER CONTROL CIRCUIT BREAKER CONTROL PANEL CONTROL POWER TRANSFORMER CONTROL POWER TRANSFORMER COMTROL POWER TRANSFORMER CONTROL POWER TRANSFORMER CONTROL POWER TRANSFORMER CONTROL POWER TRANSFORMER CONTOL POWER TRANSFORMER CONTOL POWER TRANSFORMER CONTOL POWER TRANSFORMER EXHAUST EXISTING FUSE FLASHER FLOAT REGULATOR FULL VOLTAGE NON-REVERSING GENERATOR GROUND FAULT INTERRUPTER GROUND FAULT RECEPTACLE HIGHWAY KILO VOLT-AMPERES KILOWATT LIGHTING ARRESTOR LINEAR FEET LIGHTING MAXIMUM MOTOR BREAKER MAIN LUGS ONLY MOUNTED MOTOR STARTER MOISTURE AND TEMPERATURE FAIL LIGHT NATIONAL ELECTRIC CODE MINIMUM MAIN LUGS ONLY MOUNTED MOTOR STARTER MOISTURE AND TEMPERATURE FAIL LIGHT NATIONAL ELECTRIC CODE MINIMUM MAIN LUGS ONLY MOUNTED MOTOR STARTER MOISTURE AND TEMPERATURE FAIL LIGHT NATIONAL ELECTRIC CODE MINIMUM MAIN LUGS ONLY MOUNTED FUNCT CHAR SECONDA FAILABLE LIGHT PREMER SOR SWITCH TO COLOR FRELAP POLYNINTL CHLORIDE RELAP SUPPRESSOR SWITCH TERMINAL STRIP THERMAL TERMINAL STRIP THERMAL STRIP THERMAL STRIP THERMAL STRIP	 ELECTRICAL CONTRACTO AFFECTING ELECTRICAL CONDITIONS OF ELECTR SYSTEM SHALL BE USE 3. ALL WORK SHALL BE USE SYSTEM AND SHALL MINIMUM WIRE SIZE SHOUTED. ALL CONDUCT IT IS NOT THE INTENT CONTRACTOR IS EXPECT SYSTEM AND PROVIDE PROPER WORKING ORD ELECTRICAL SYSTEM SH LATEST EDITION OF THIS SIZED PER TABLE 250 ALL WORK SHALL BE F WORKMANLIKE MANNER. ENGINEER/OWNER. CONTRACTOR SHALL GL PERIOD OF NOT LESS CORRECTION OF ANY D INCLUDE REPLACEMENT HAVE BEEN DAMAGED. THE ELECTRICAL INSTAI ELECTRICAL CONTRACTOR SHADED TEXT DEMOTES EQUIPMENT, STRUCTUR SHADED TEXT DEMOTES EQUIPMENT, STRUCTUR
REV DATE DESCRIPTION	0	ORANGE COUNTY UTILITIES DEPARTMENT		UNDERGROUND VOLT WATT WITH WEATHERPROOF PHASE UII Service A & E Firm Licenses: Eng. C.O.A. No. 3215	ELECTRICAL NOTES,

NOTES

CTOR SHALL SUPPLY AND INSTALL ALL NEW ELECTRICAL WORK INDICATED.

CTOR SHALL VISIT JOB SITE AND FAMILIARIZE HIMSELF WITH ALL CONDITIONS AL INSTALLATION AND MAKE PROVISIONS AS TO THE COST THEREOF. EXISTING CTRICAL EQUIPMENT, LIGHT FIXTURES, ETC... THAT ARE PART OF THE FINAL VERIFIED BY THE CONTRACTOR PRIOR TO SUBMITTING HIS BID.

DONE IN ACCORDANCE WITH NATIONAL ELECTRICAL CODE, ORANGE COUNTY ALL COMPLY WITH ALL LOCAL RULES AND ORDINANCES.

SHALL BE #12 A.W.G. EXCLUDING CONTROL WIRING, UNLESS OTHERWISE JCTORS SHALL BE COPPER.

NT OF THESE PLANS TO SHOW EVERY MINOR DETAIL OF CONSTRUCTION. THE PECTED TO FURNISH AND INSTALL ALL ITEMS FOR A COMPLETE ELECTRICAL DE ALL REQUIREMENTS NECESSARY FOR THE EQUIPMENT TO BE PLACED IN RDER.

SHALL BE COMPLETE AND EFFECTIVELY GROUNDED AS REQUIRED BY THE THE N.E.C. OR LOCAL CODES. ALL CONDUITS SHALL HAVE A BOND WIRE 50 OF THE NATIONAL ELECTRIC CODE.

L BE NEW AND BEAR UNDERWRITERS' LABELS WHERE APPLICABLE. PERFORMED BY A LICENSED ELECTRICAL CONTRACTOR IN A FIRST CLASS IER. THE COMPLETED SYSTEM SHALL BE FULLY OPERATIVE AND ACCEPTED BY

GUARANTEE ALL MATERIALS AND WORKMANSHIP FREE FROM DEFECTS FOR A SS THAN TWO YEARS FROM DATE OF ACCEPTANCE.

DEFECTS SHALL BE COMPLETED WITHOUT ADDITIONAL CHARGE AND SHALL ENT OR REPAIR OF ANY OTHER PHASE OF THE INSTALLATION WHICH MAY

TALLATION SHALL MEET ALL STANDARD REQUIREMENTS OF THE NATIONAL THE FLORIDA BUILDING CODE.

BE RESPONSIBLE FOR ALL CUTTING AND PATCHING REQUIRED OF HIS WORK. CTOR SHALL LABEL ALL PANELS W/ TYPEWRITTEN DIRECTORIES (NEW & EXISTING). RING SHALL BE THE RESPONSIBILITY OF THE ELECTRICAL CONTRACTOR.

ELECTRICAL DRAWINGS. REFER TO THE MECHANICAL DRAWINGS & THE TURER'S SHOP DRAWINGS FOR THE EXACT LOCATION OF ALL EQUIPMENT. TES EXISTING EQUIPMENT OR STRUCTURES. NON-SHADED TEXT DENOTES NEW


URES AND WORK. SLANTED TEXT (NOT SHADED) DENOTES FUTURE URES AND WORK.



Electrical Design Associates 6965 PIAZZA GRANDE AVE., STE. 412 ORLANDO, FLORIDA 32835 PHONE: (407) 745-5604 FAX: (407) 745-5603 C.O.A. No. 8079 LILLIAN M. REYES, P.E. Florida P.E. No. 50780

BID	SET

	OCU FILE NO.: 71925	SCALE: AS NOTED:
	DESIGNED BY: LMR	DRAWING NO. :
	DRAWN BY: RRM	E-001
LILLIAN M. REYES	CHECKED BY: LMR	
PROFESSIONAL ENGINEER FLORIDA LICENSE #50780	CADD FILE: E-001 NOTES	SHEET: 51 OF 60

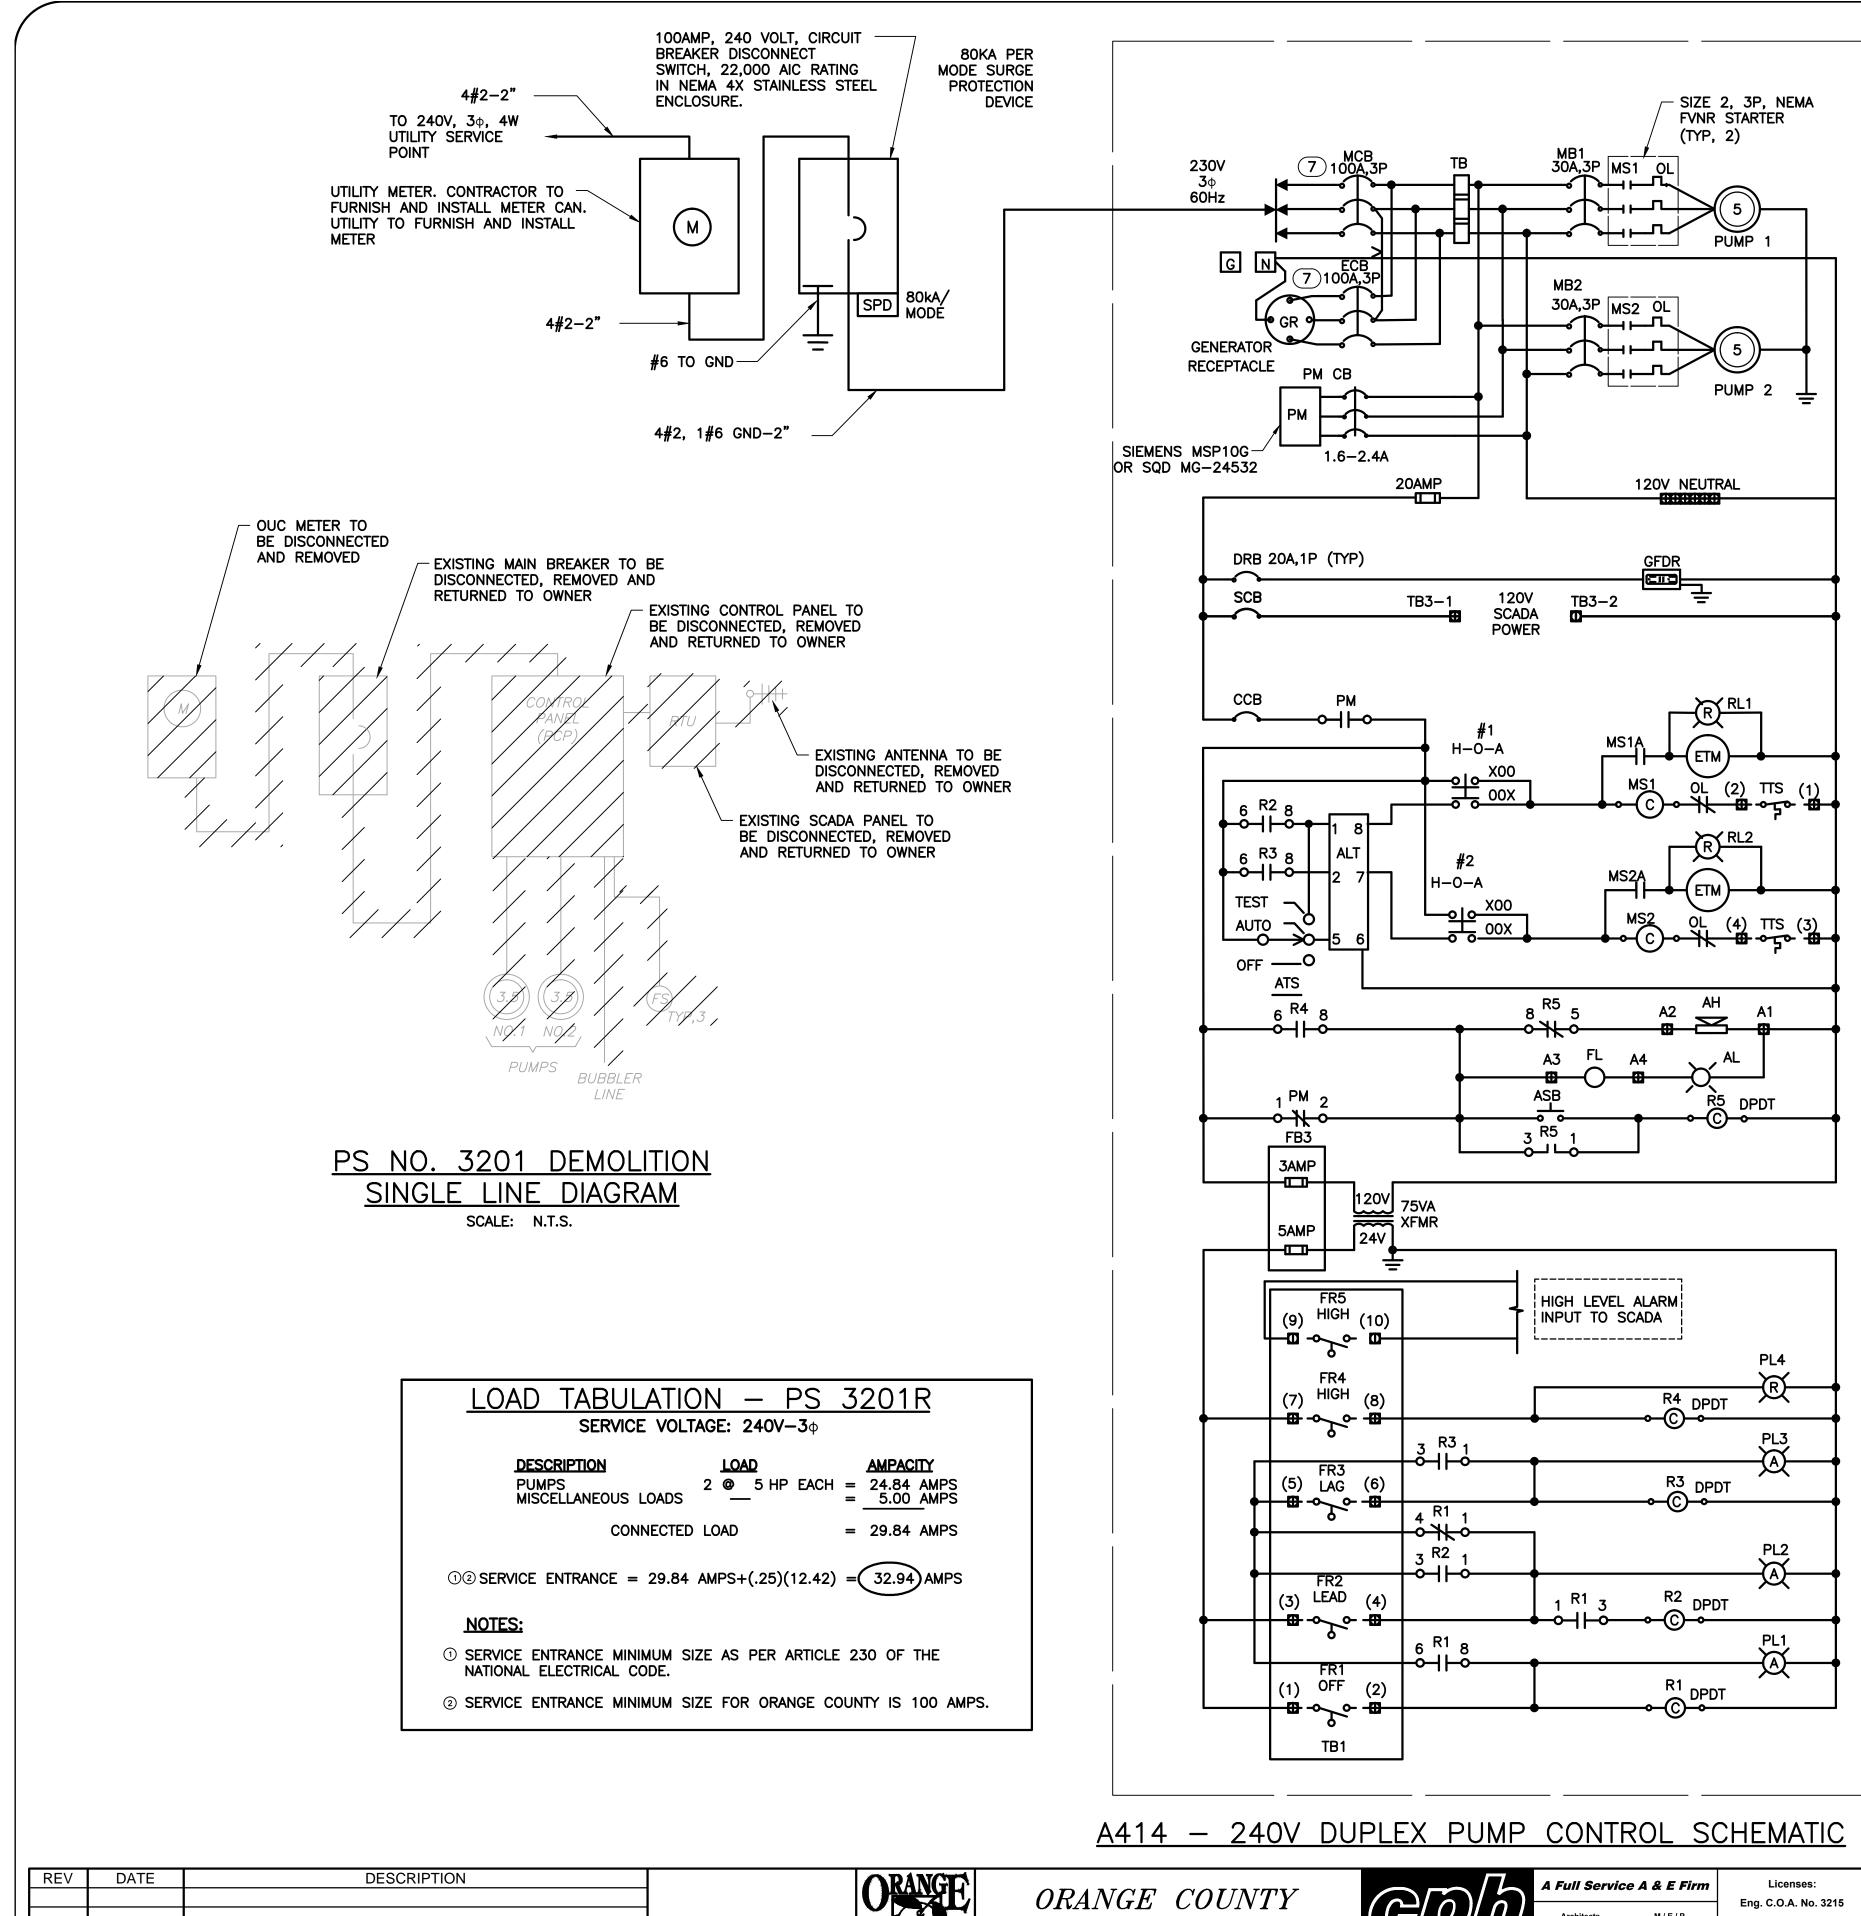

LINE IS 2 INCHES

AT FULL SIZE

(IF NOT SCALE ACCORDINGL

LOUNT !

GOVERNMENT FLORIDA






PUMP STATION 3201R DUPLEX PUMP CONTROL PANE SINGLE LINE DIAGRAM


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-				

AH	_	ALARM HORN	MB	_	MOTOR BREAKER
AL	_	ALARM LIGHT	MCB	_	MAIN CIRCUIT BREAKER
ALT	_	ALTERNATOR	MS	_	MOTOR STARTER
ASB	_	ALARM SILENCE BUTTON	OL	_	OVERLOAD
ATS	_	ALTERNATOR TEST SWITCH	PL	_	PILOT LIGHT
СВ	_	CIRCUIT BREAKER	PM	_	PHASE MONITOR
CCB	_	CONTROL CIRCUIT BREAKER	R	_	RELAY
DPDT	_	DOUBLE POLE DOUBLE THROW	RL	_	RUNNING LIGHT
DRB	_	DUPLEX RECEPTACLE BREAKER	SCB	_	SCADA CIRCUIT BREAKER
ECB	_	EMERGENCY CIRCUIT BREAKER	SLB	_	SITE LIGHT BREAKER
ETM	_	ELAPSED TIME METER	TB	_	TERMINAL BLOCK
F	_	FUSE	TTS	_	THERMAL TERMINAL STRIP
FB	_	FUSE BLOCK	TVSS	_	TRANSIENT VOLTAGE SURGE
FL	_	FLASHER			SUPPRESOR
FR	_	FLOAT REGULATOR	VA	_	VOLT AMPERE
GFDR	-	GROUND FAULT DUPLEX RECEPTACLE	XFMR	-	TRANSFORMER
GR	-	GENERATOR RECEPTACLE			

SWITCH

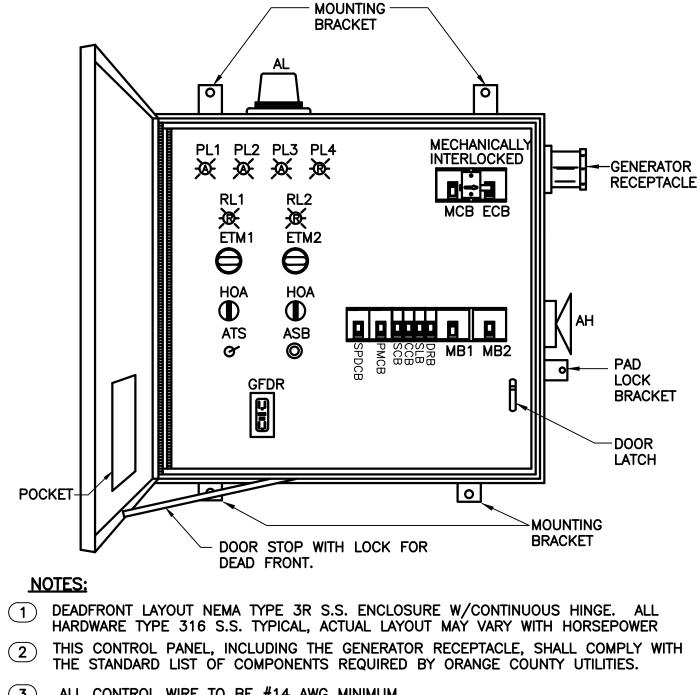

- (2) (3) ALL CONTROL WIRE TO BE #14 AWG MINIMUM. (4) CONTROL PANEL SHALL BE U.L. LISTED AND LABELED. (5) CONTROL PANEL SHALL INCLUDE 30 SPARE TERMINALS (TB2). (6) PHASE MONITOR CIRCUIT BREAKER TO BE SIEMENS P/N: MSP10G, OR SQ-D P/N: MG24532. 7 PROVIDE AUXILLARY FORM "C" CONTACT ON MAIN AND EMERGENCY CIRCUIT BREAKERS IN PUMP CONTROL PANEL.
- (8) ALL 240V CIRCUIT BREAKERS SHALL BE TYPE "HGL"

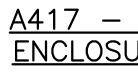

PUMP STATION #3201R 5747 OLD CHENEY HWY.

<u>ND</u>

HOA _ HAND-OFF-AUTO SELECTOR

A417 - DUPLEX CONTROL PANEL ENCLOSURE DEAD FRONT LAYOUT


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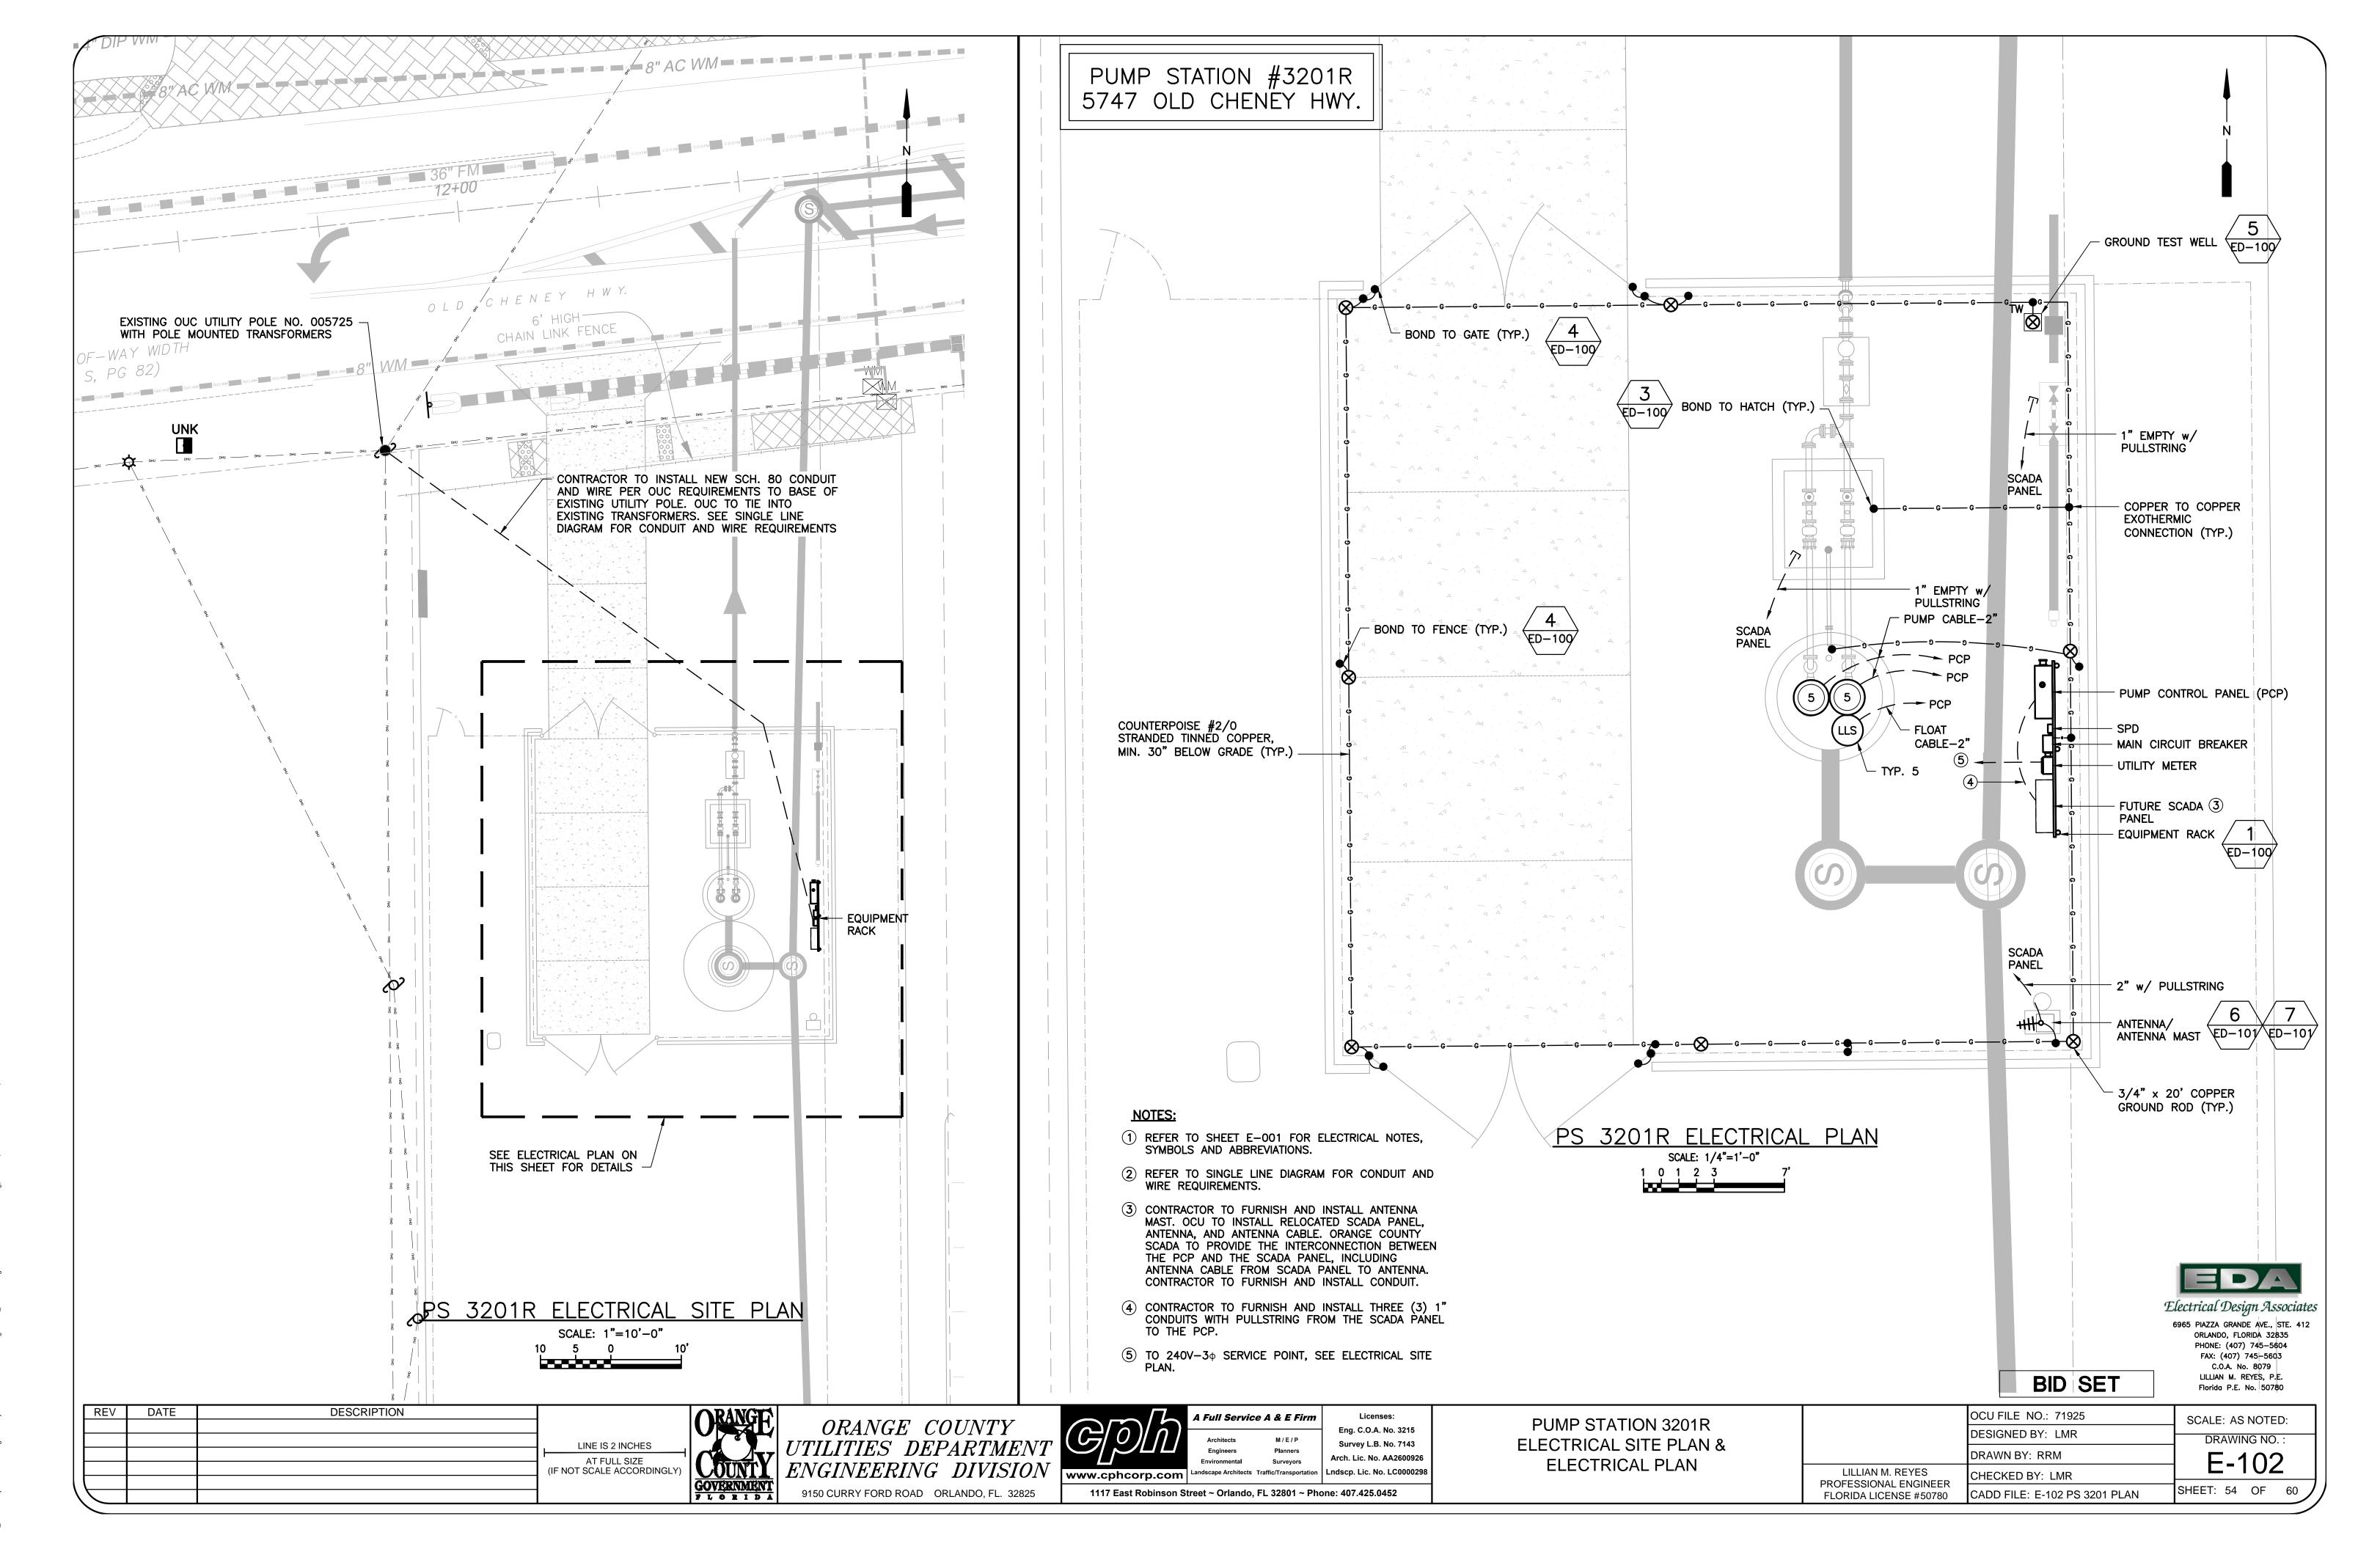



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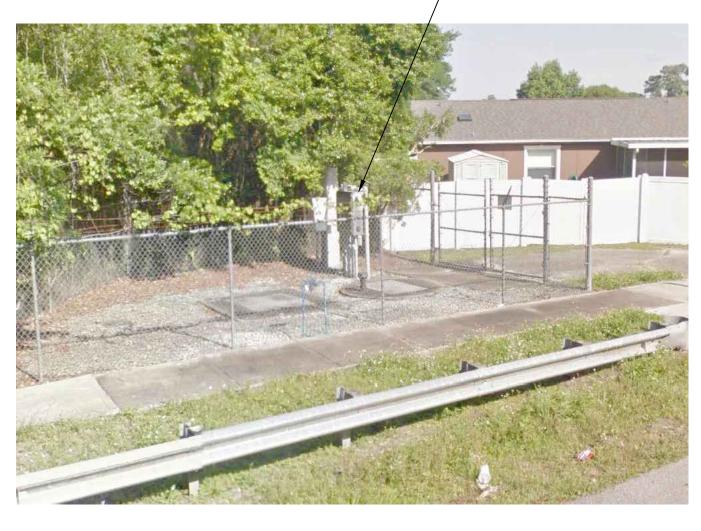
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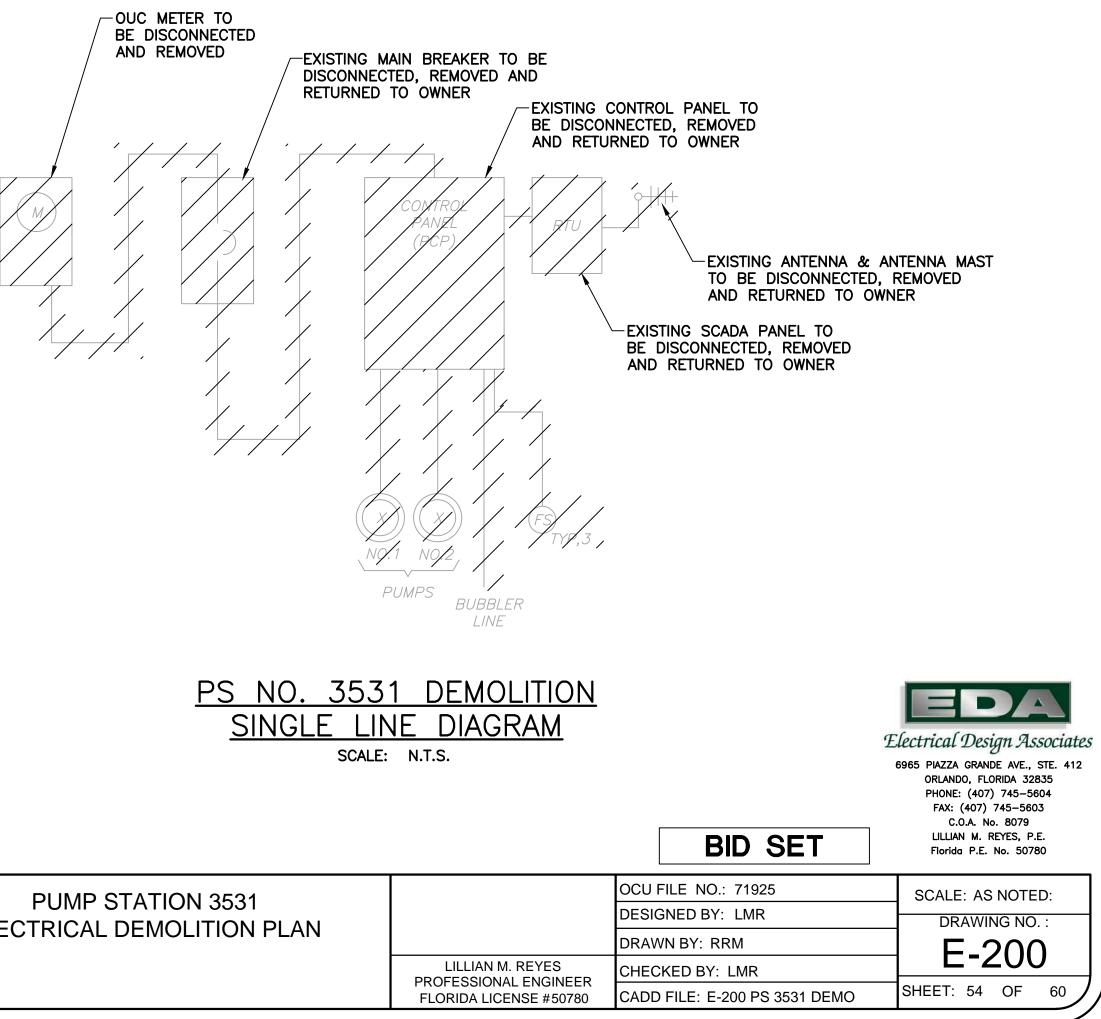
EL		OCU FILE NO.: 71925 DESIGNED BY: LMR	SCALE: AS NOTED: DRAWING NO. :
		DRAWN BY: RRM	E-100
	LILLIAN M. REYES PROFESSIONAL ENGINEER	CHECKED BY: LMR	
		CADD FILE: E-100 PS 3201 SLD	SHEET: 52 OF 60








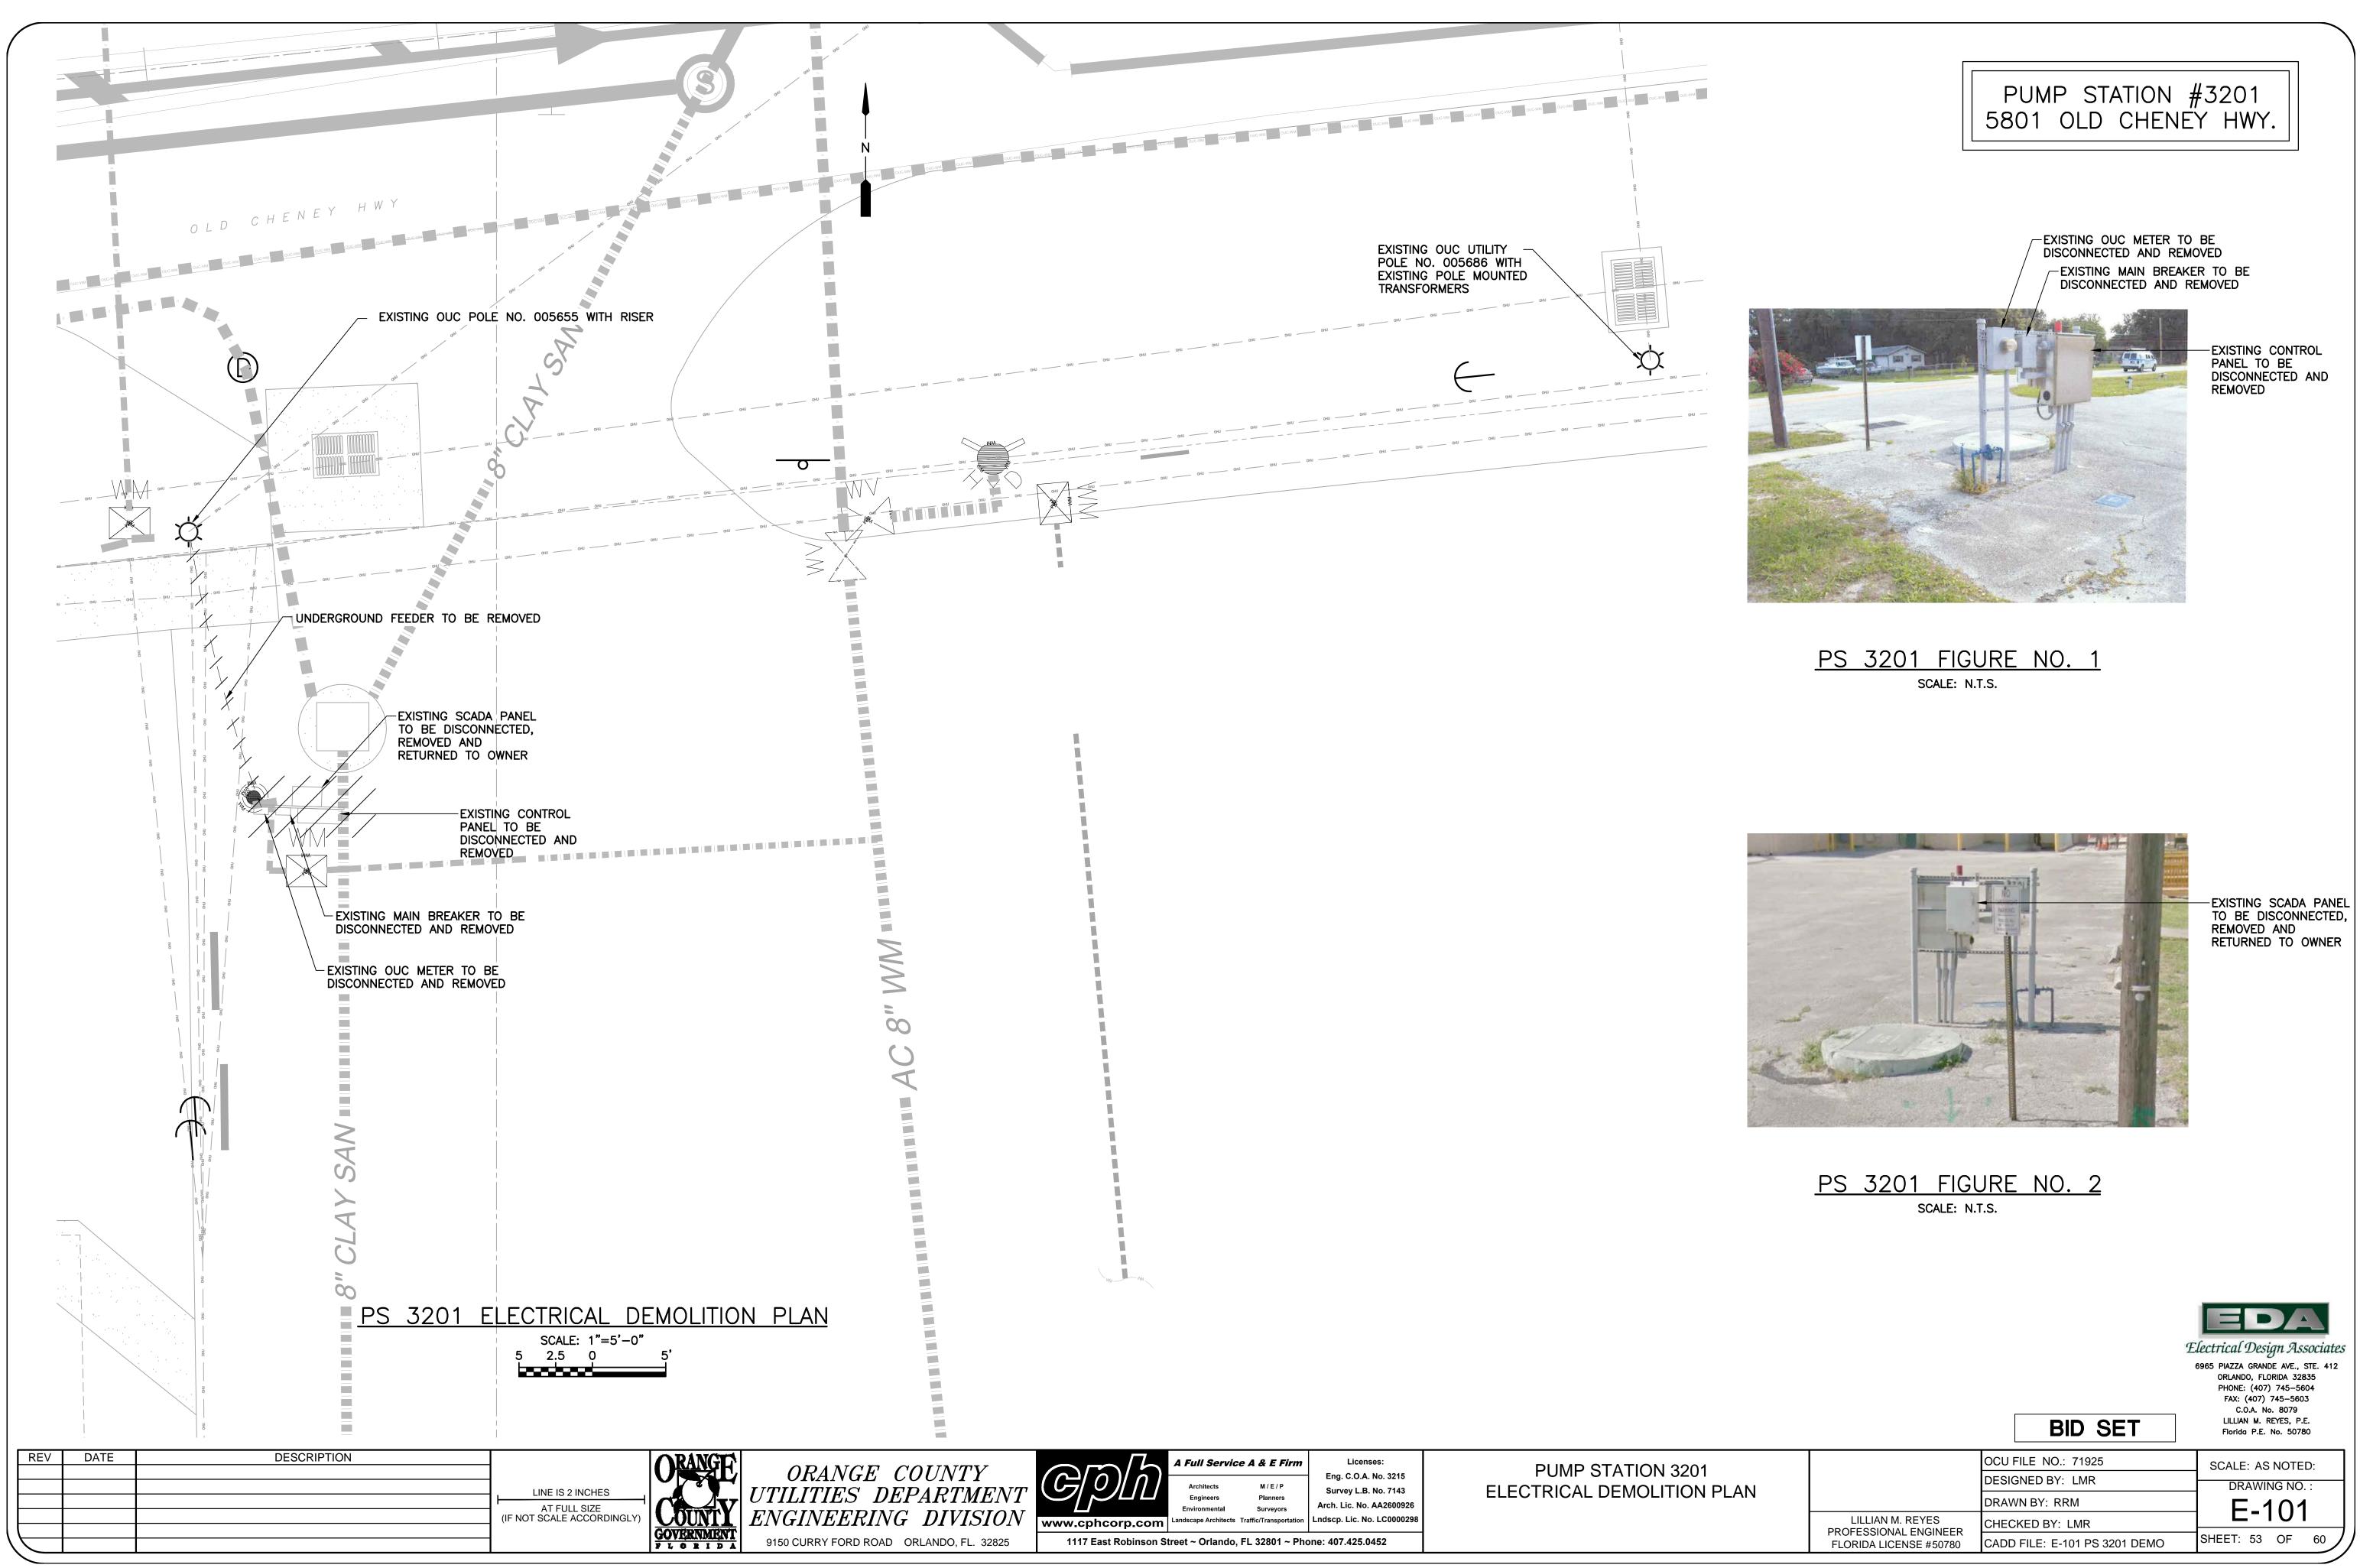

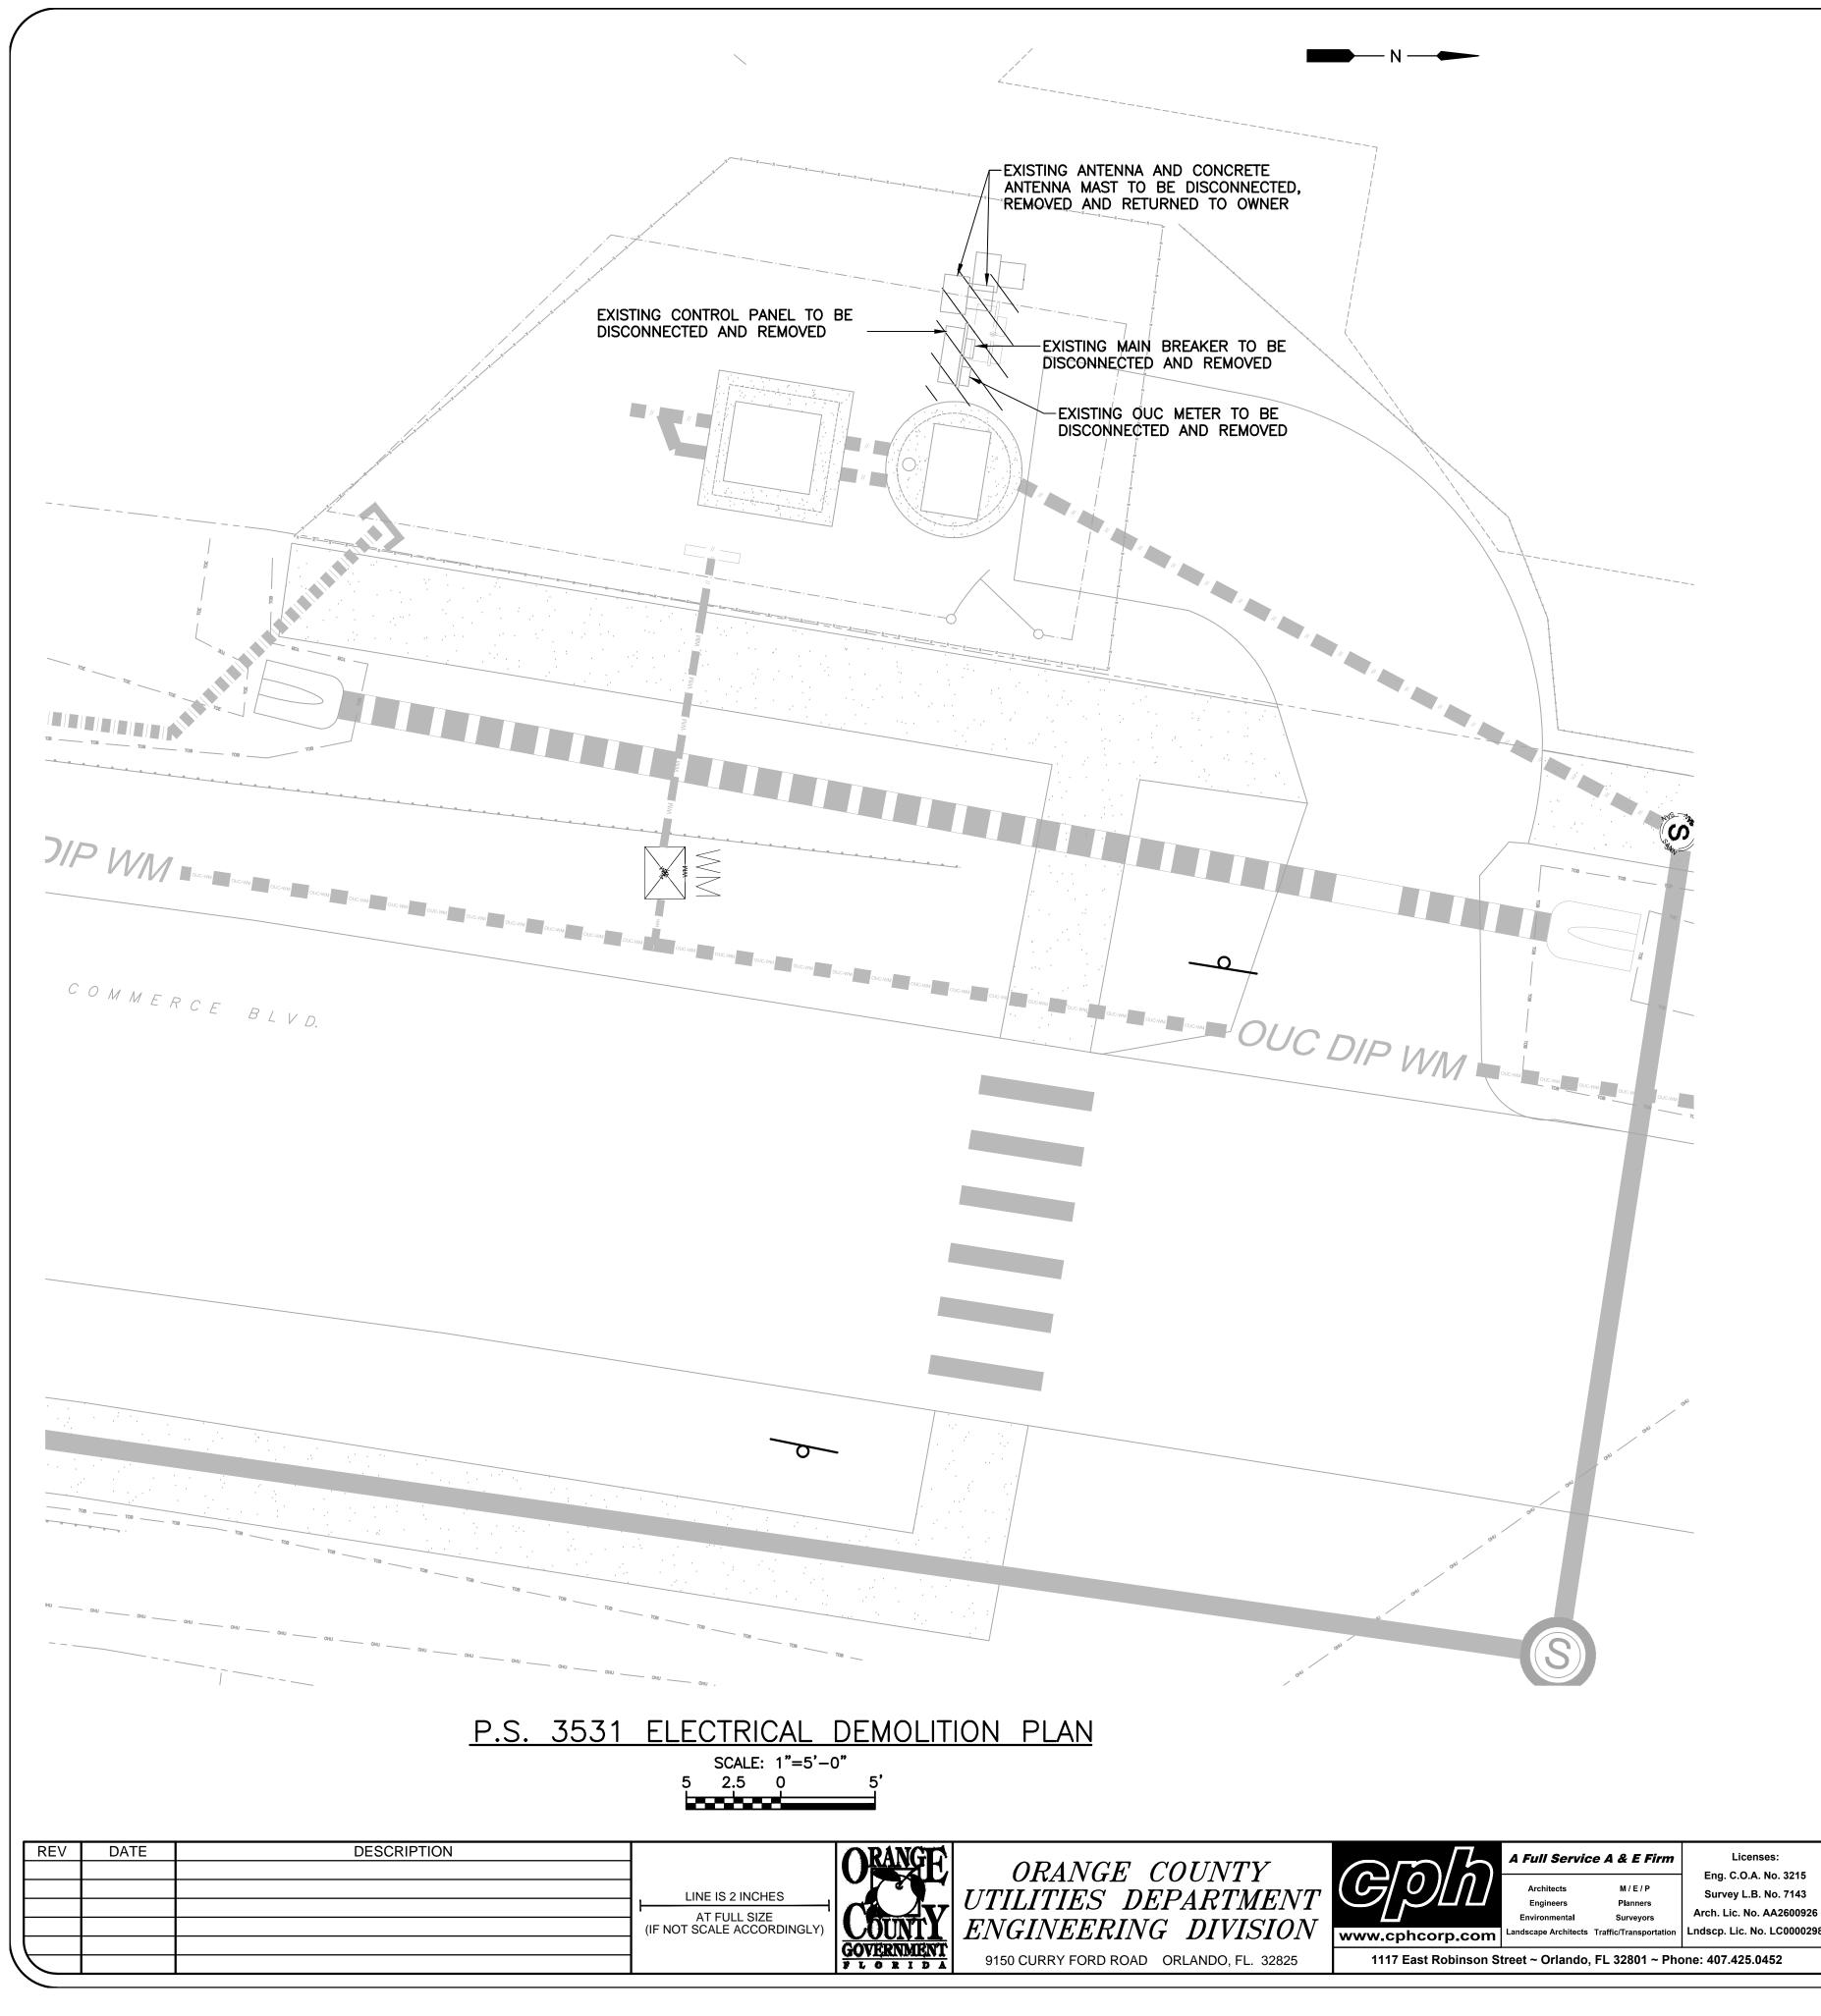

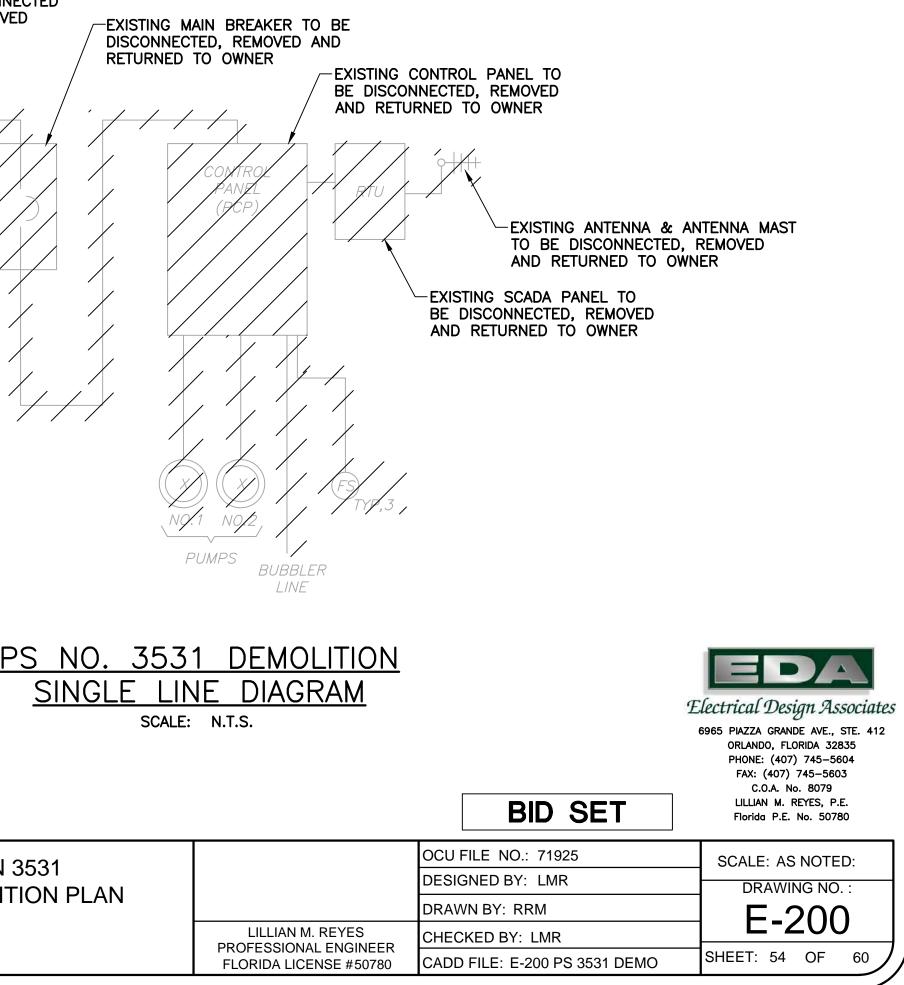


ELECTRICAL DEMOLITION PLAN


PUMP STATION #3531 1577 COMMERCE BLVD.

- CONTRACTOR TO DISCONNECT AND REMOVE EXISTING ELECTRICAL EQUIPMENT, INCLUDING BUT NOT LIMITED TO METER, DISCONNECT, CONTROL PANEL, SCADA PANEL, ETC.

<u>PS 3531 FIGURE NO. 1</u> SCALE: N.T.S.

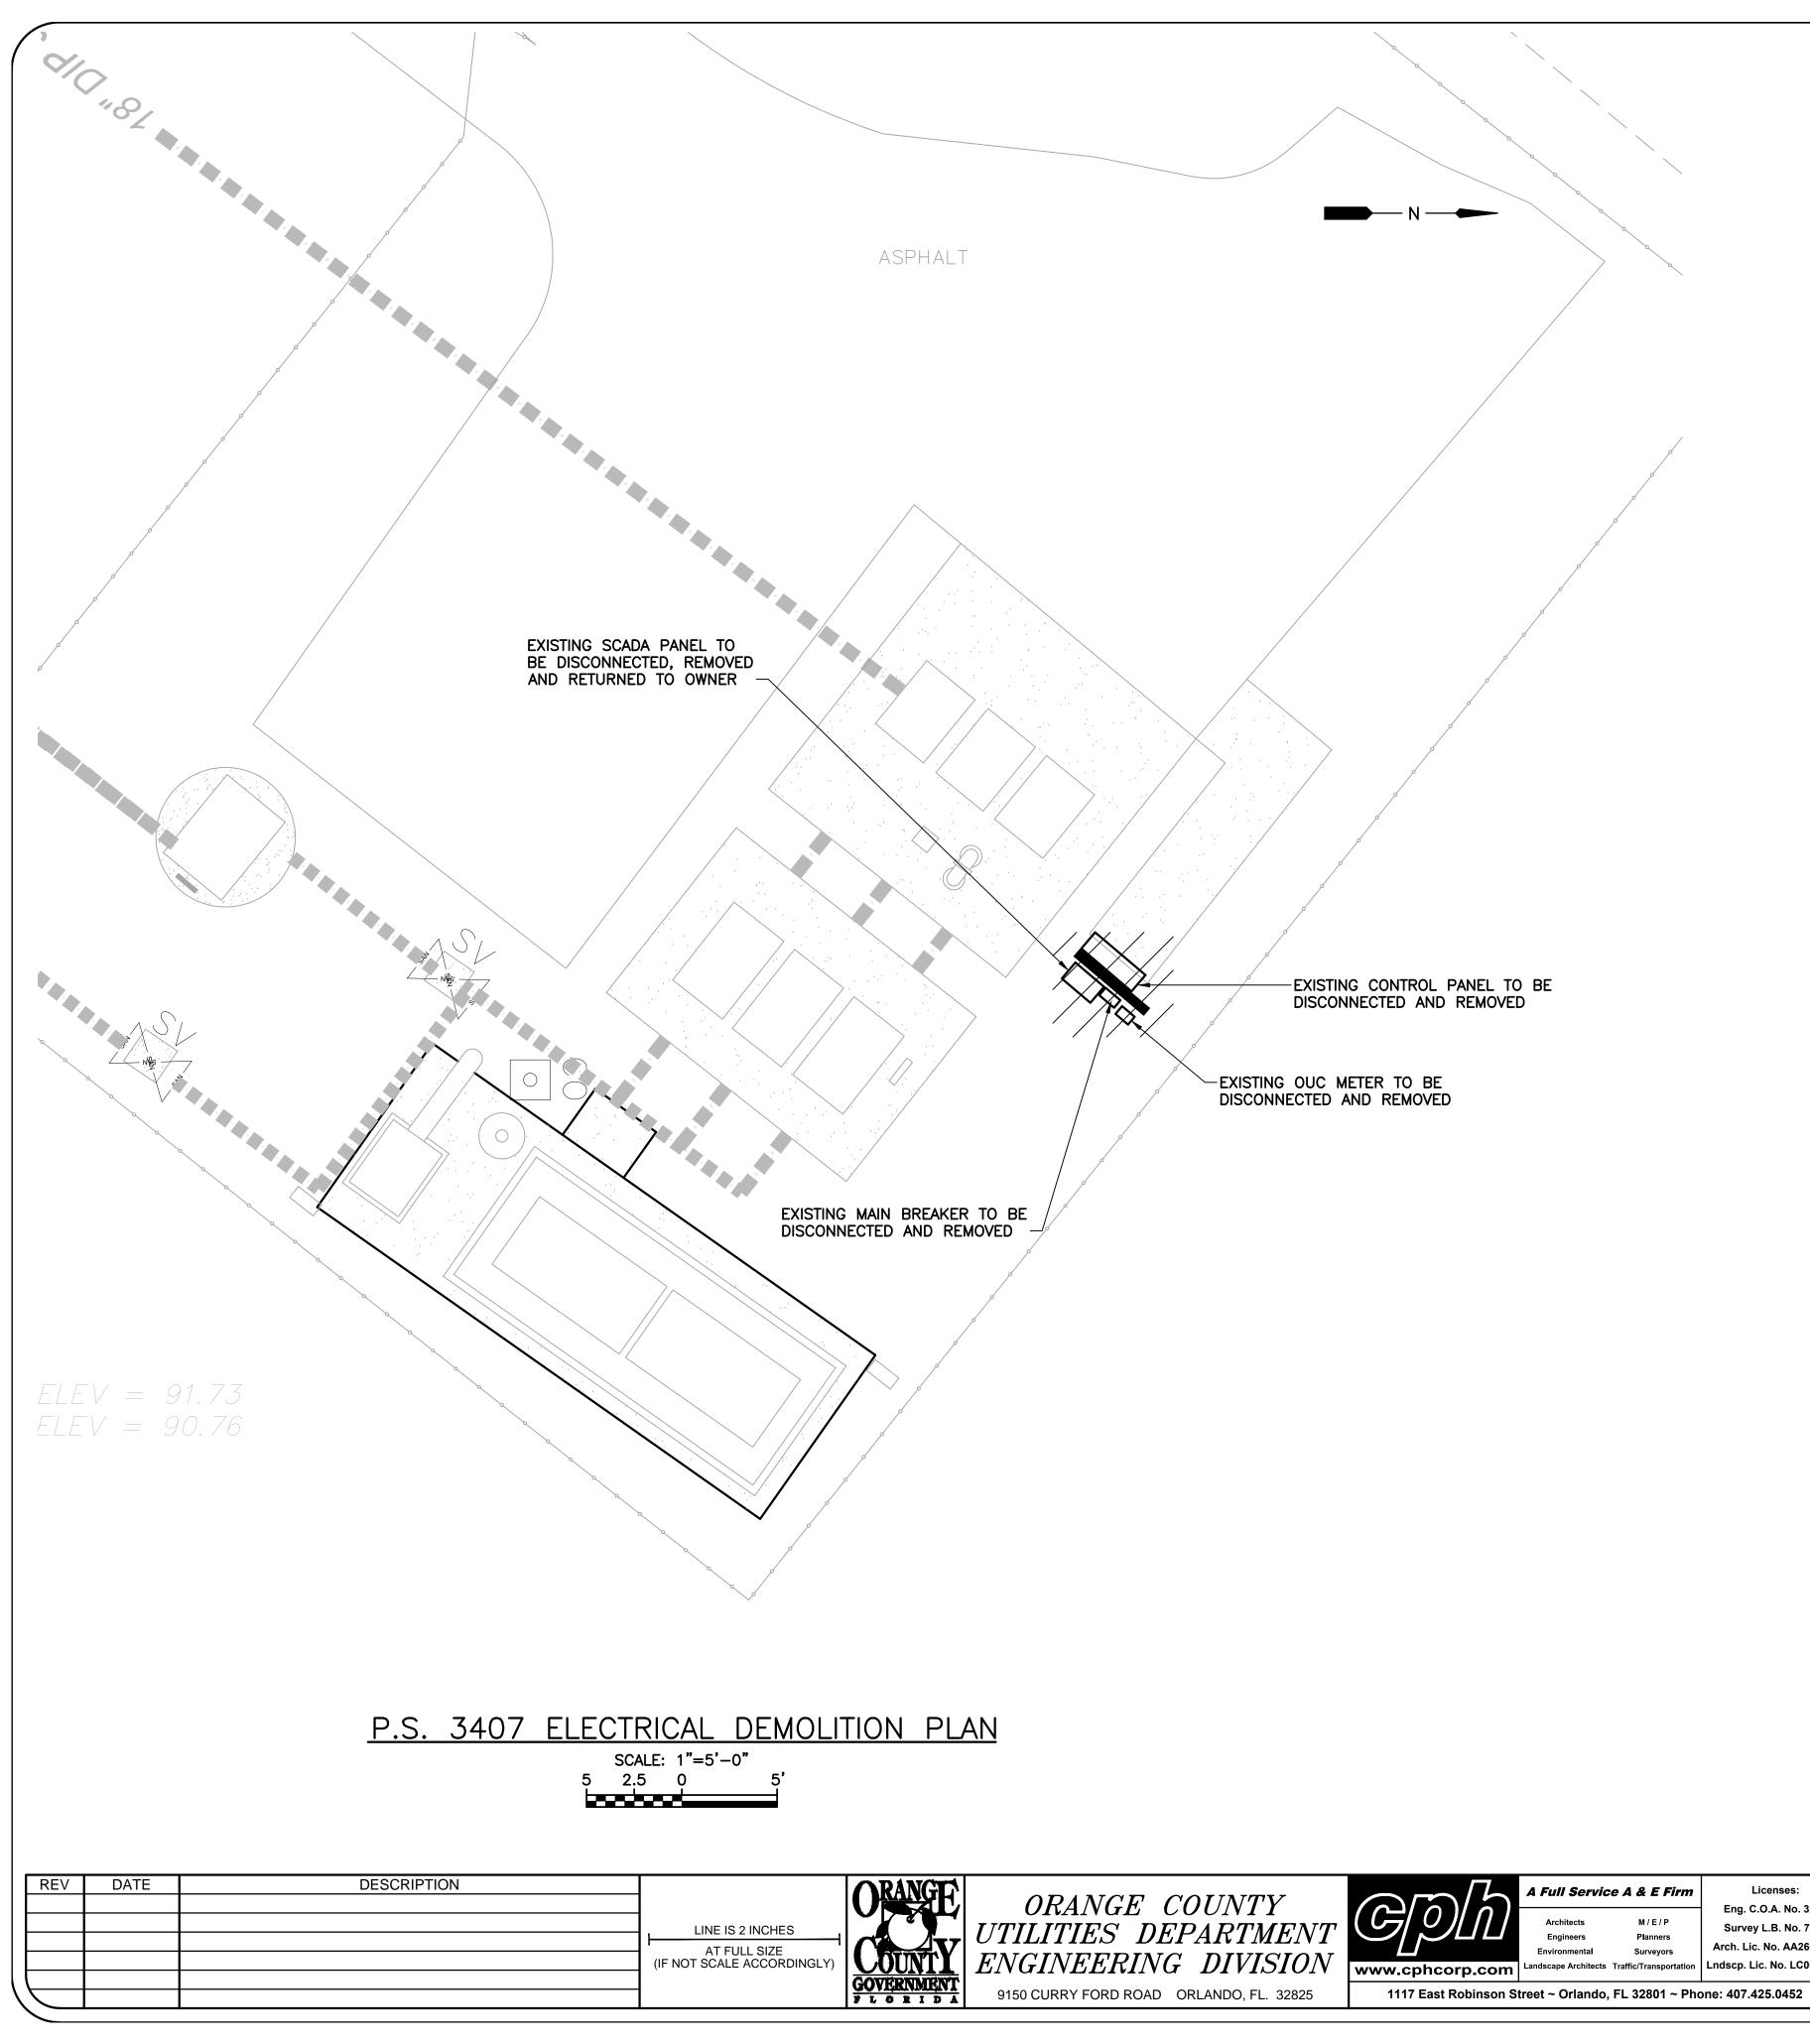



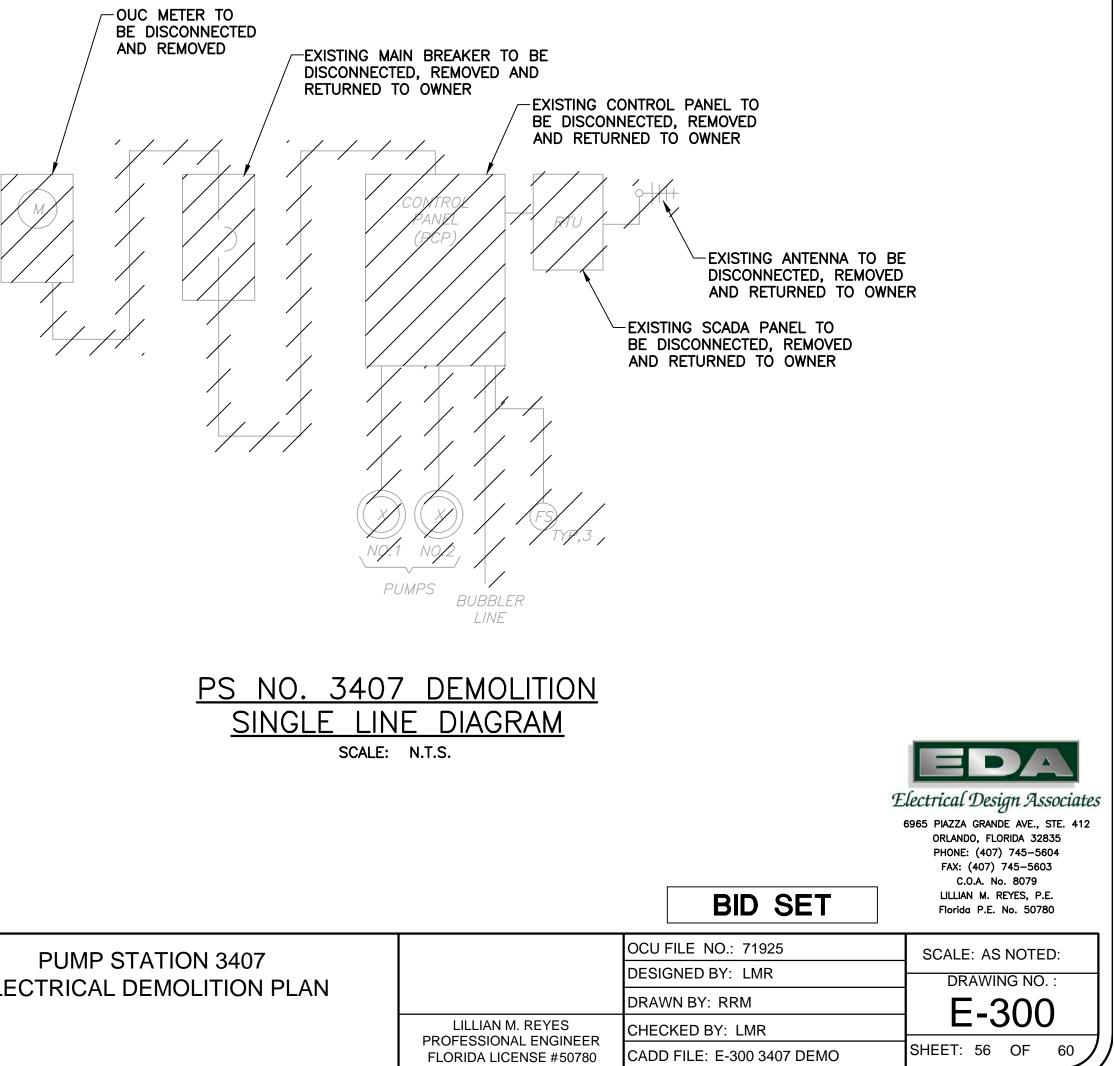

A Full Service A & E Firm M/E/P Architects Engineers Planners Surveyors Environmental Landscape Architects Traffic/Transportation

Licenses: Eng. C.O.A. No. 3215 Survey L.B. No. 7143 Arch. Lic. No. AA2600926 Lndscp. Lic. No. LC0000298


ELECTRICAL DEMOLITION PLAN

PUMP STATION #3407 6137 CORNELIA AVE.

CONTRACTOR TO DISCONNECT AND REMOVE EXISTING ELECTRICAL EQUIPMENT, INCLUDING BUT NOT LIMITED TO METER, DISCONNECT, CONTROL PANEL, SCADA PANEL, ETC.

<u>PS 3407 FIGURE NO. 1</u>


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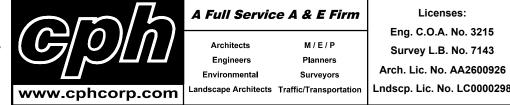
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nners	•
/eyors	Arch. Lic. No. AA2600926
insportation	Lndscp. Lic. No. LC000029

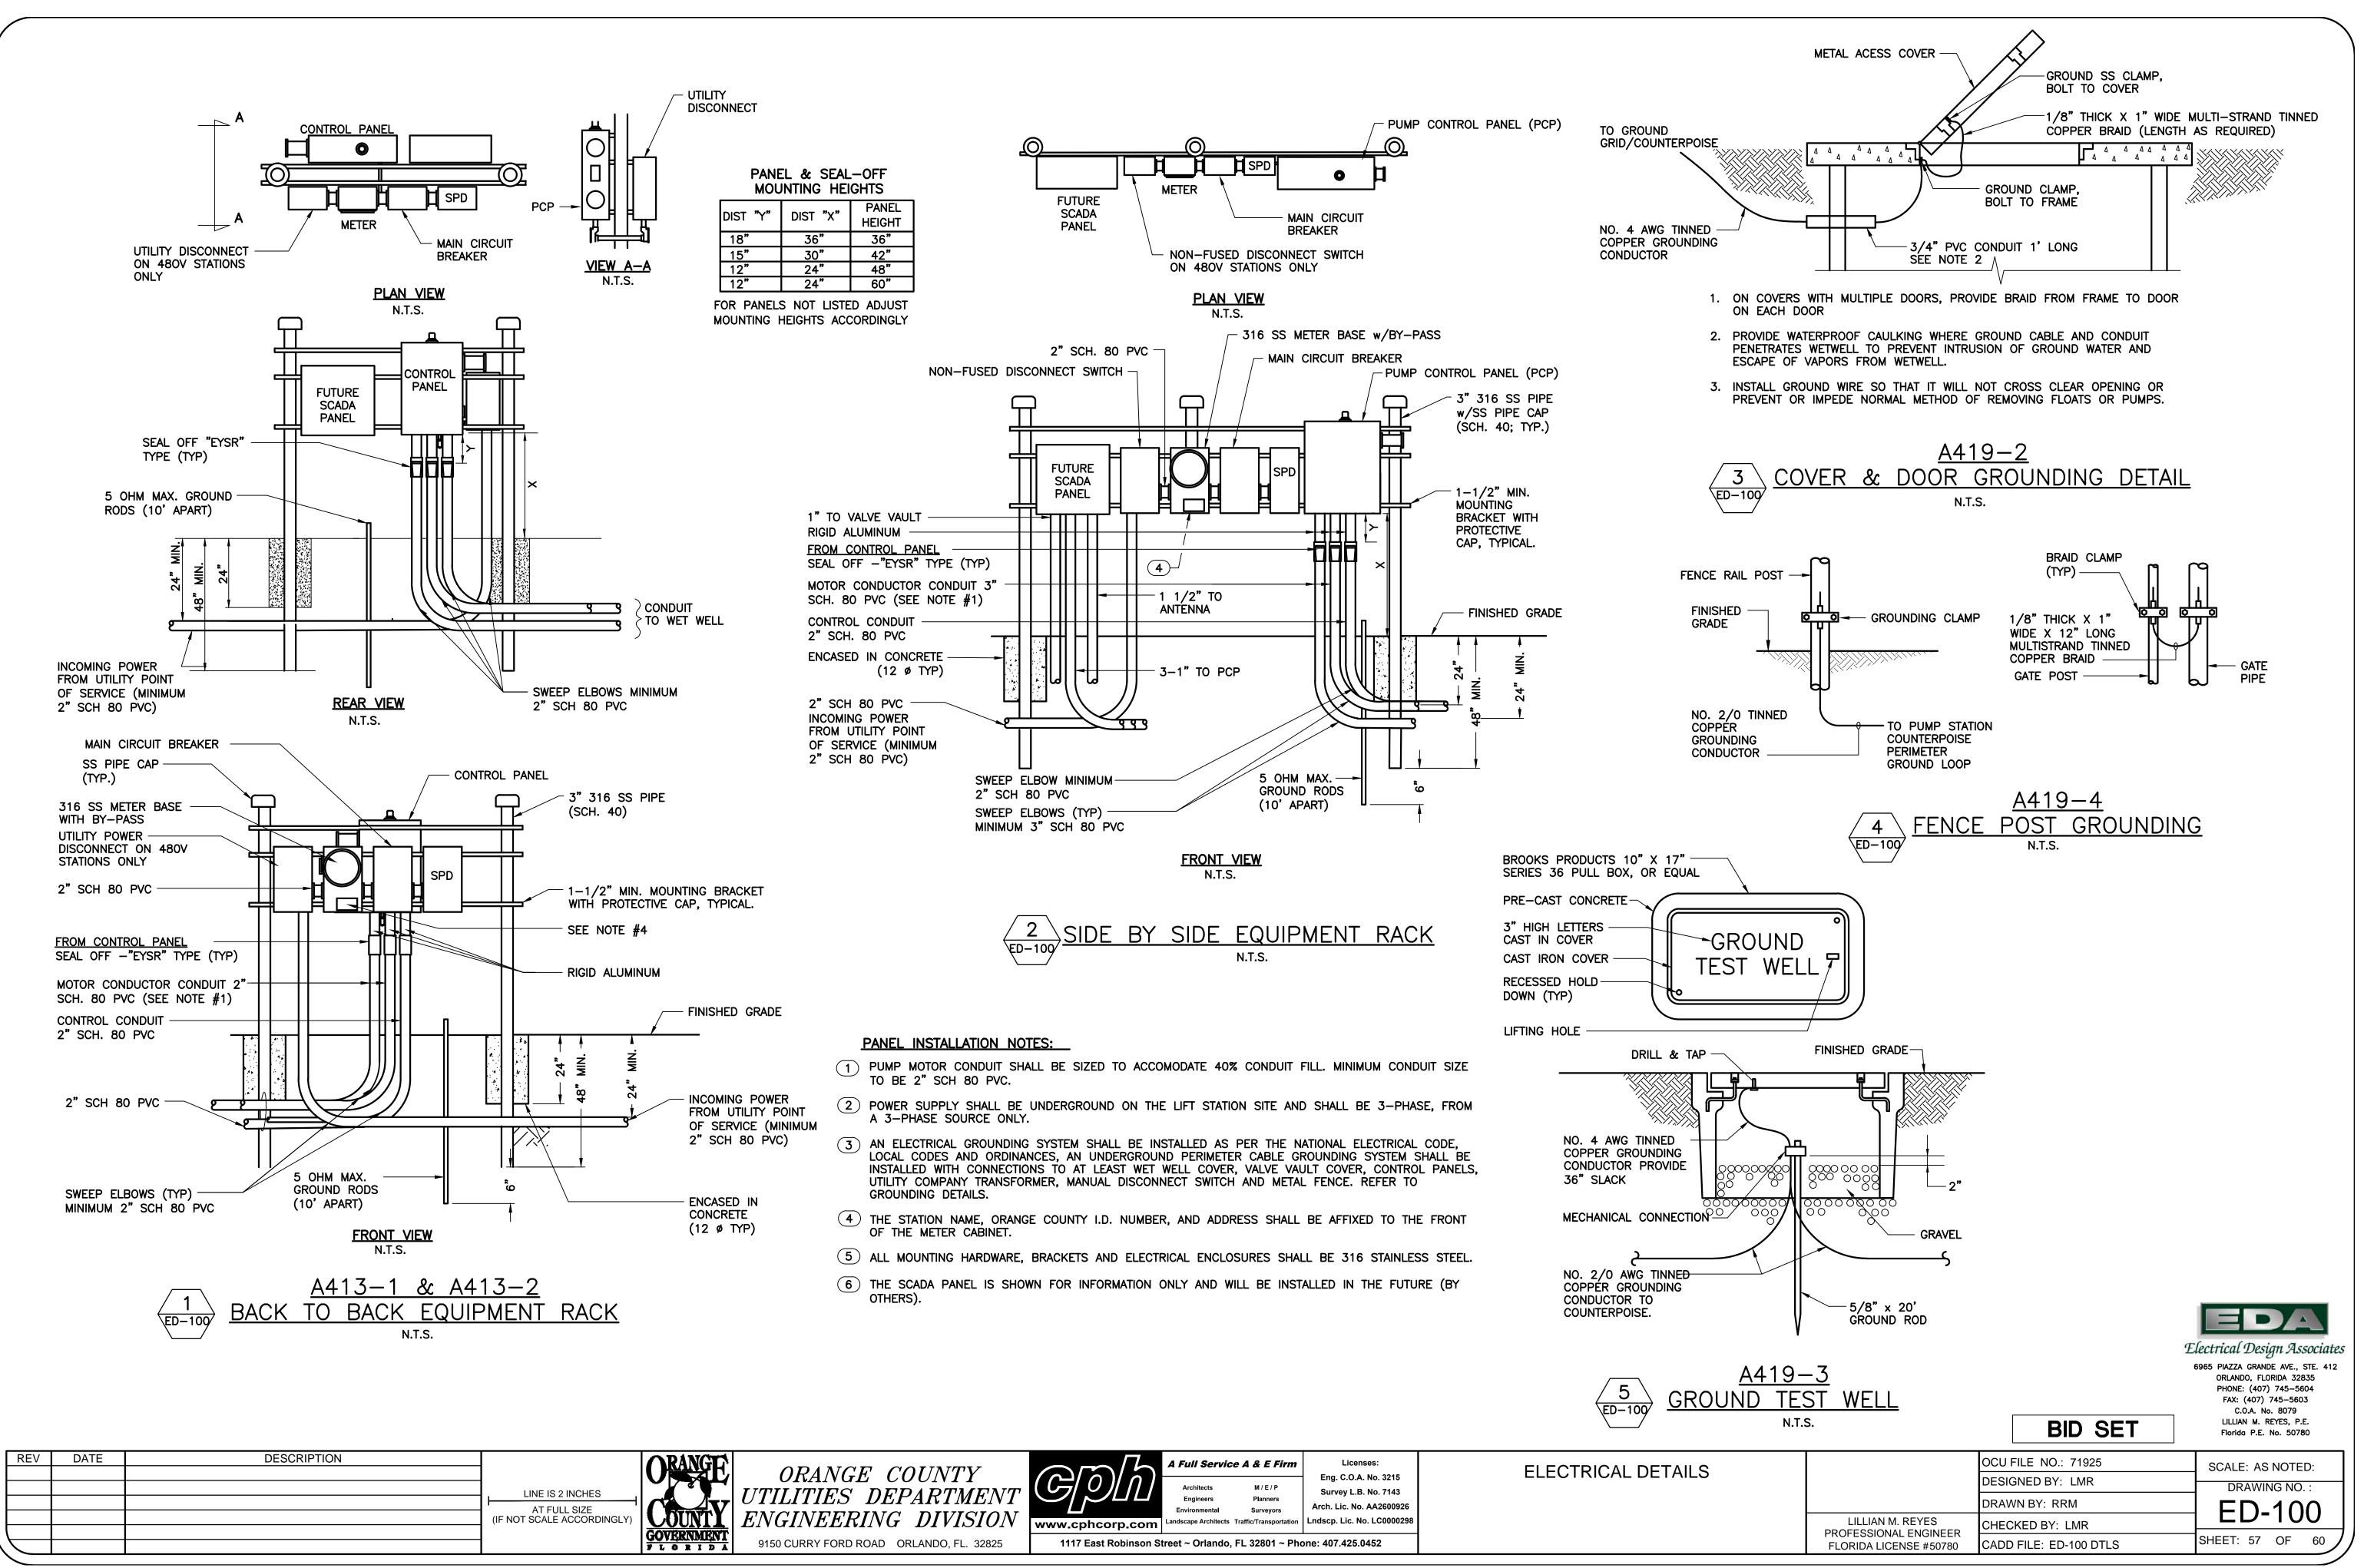

FLORIDA 3130 C

	50'			35'		
	14 5/8"			12"		
	8	B'-6"		5'-8"		
		3'-8"		3'-6"		
	6	1/2"		6"		
	10'			7'		
	40'			28'		
	5840			3110		
IPH)	160	170	180	170	175	180
Q. FT.)	19.9	15.8	11.5	4.9	3.5	2.2
	•	-		•	-	



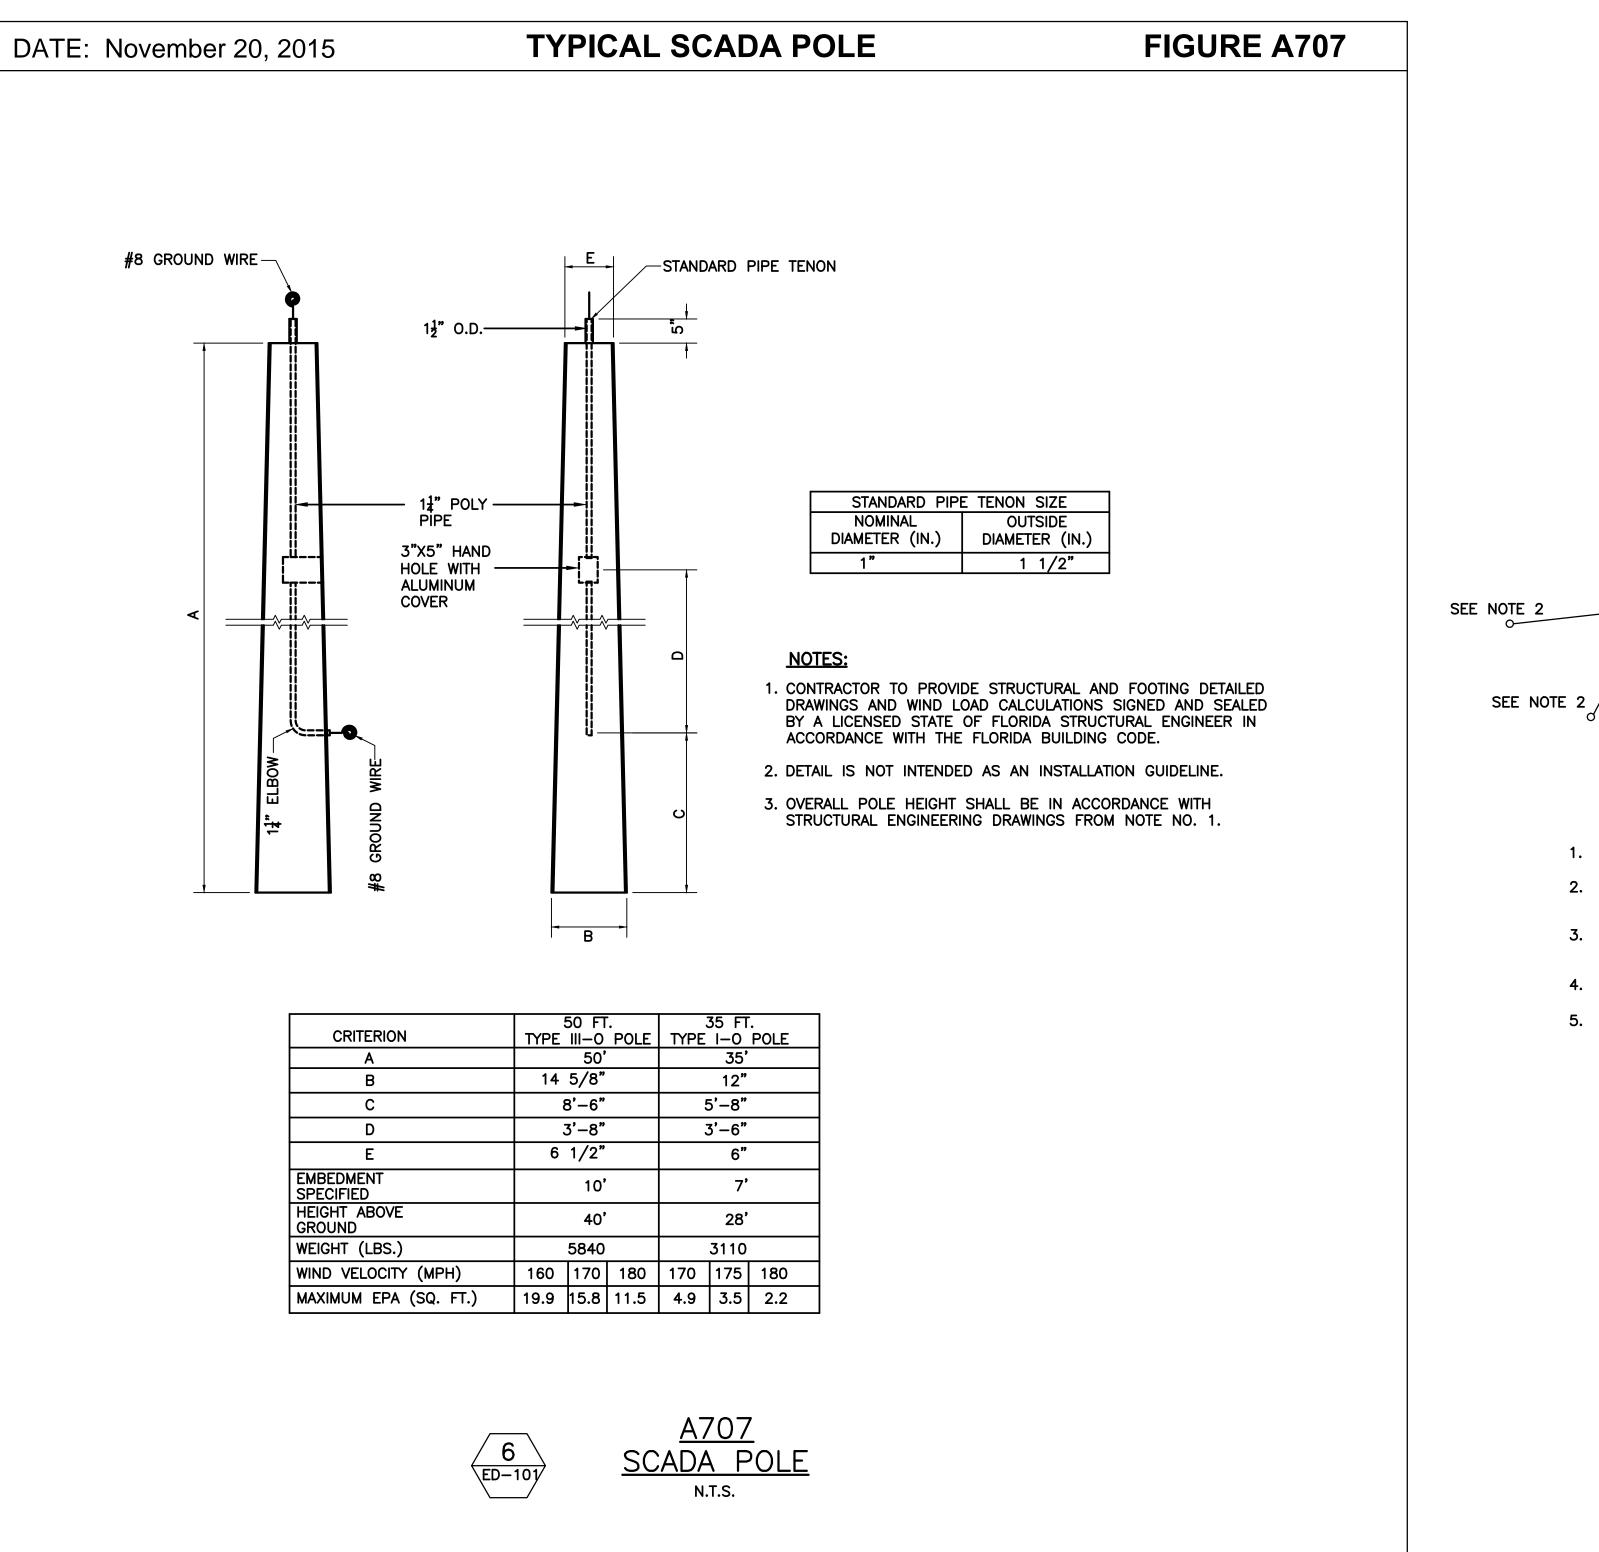


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ELECTRICAL DETAILS

0-



1. MEGGER GROUND SYSTEM FOLLOWING INSTALLATION.

2. IF READING IS GREATER THAN 5 OHMS, INSTALL TWO ADDITIONAL GROUND RODS RADIALLY FROM EACH LEG AS SHOWN UNTIL A VALUE OF 5 OHMS OR LESS IS ATTAINED. 3. IF READING IS STILL ABOVE 5 OHMS, INCREASE THE LENGTH OF EACH ROD IN 10 FEET INCREMENTS UNTIL THE REQUIRED VALUE IS OBTAINED 4. ALL ELECTRODE SYSTEM CONNECTIONS TO BE EXOTHERMALLY BONDED. 5. USE MOST STRINGENT REQUIREMENT OF THESE DETAILS OR APPLICABLE CODES.

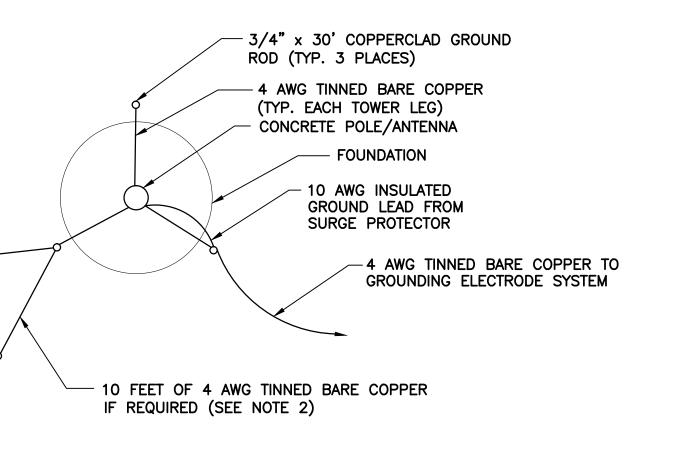



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		CADD FILE: ED-101 DTLS	SHEET: 58 OF 60