February 28, 2017 BOARD OF COUNTY COMMISSIONERS ORANGE COUNTY, FLORIDA Y17-731-CC / ADDENDUM # 3 WITTENSTEIN COTTAGE ADA UPGRADES AND RENOVATIONS Bid Opening Date: March 7, 2017

This addendum is hereby incorporated into the bid documents of the project referenced above. The following items are clarifications, corrections, additions, deletions and/or revisions to and shall take precedence over the original documents. <u>Underlining</u> indicates additions, deletions are indicated by <u>strikethrough</u>.

- A. The Bid Opening Date remains March 7, 2017 at 2:00 P.M.
- B. Questions/Answers/Clarifications:
 - **1. Question:** Does Note 4 on Sheet MD 1.01 refer just to the diffusers that it is pointing to or is it meant to be a general note?

Answer: Note #4 pertains to the diffuser it is associated with. Refer to Sheet M1.01.

2. Question: Can the County provide a list of the furniture/equipment to be deep cleaned as indicated on A 6.01?

Answer: A list of furniture/equipment for deep cleaning is not available. Provide cleaning as needed once construction is complete. See attached revised sheet note C on revised plan sheet A06.01.

3. Question: Window treatments are labelled "TBD" on drawings, spec section calls for horizontal blinds – do these apply to all windows?

Answer: Window treatment shall be horizontal 1" cordless plastic blinds - no cords for safety reason, rods are acceptable.

4. Question: Note 2 on A02.01 Calls out to repair damage to concrete flooring. Does this refer to the thin textured coating that is chipped where the porch meets the sidewalk? No other concrete damage was evident at the walk thru.

Answer: Yes, that is correct.

5. Question: Note 7 on Construction plan A02.01 calls for a cased entrance to the kitchen. Specs do not detail shape or style of casing.

Answer: Existing trim to remain. Remove door and hinges, patch and repair frame where hinges were removed. Note: changes have been made to sheet A01.01 and A02.01, see attachment.

6. Question: At the walk thru, it was noted that there were light bulbs behind grilles on the interior walls of each bedroom (1 each). These lights do not appear on the drawings. Are they to be demolished and the holes closed with drywall?

Answer: Per attached Drawing ED1.01 Plan Note #1 the light fixture is to be removed. GC to patch and repair as needed.

7. Question: On A04.01, a key note 11 is referenced on the drawing in several places. Should this be key note 10?

Answer: Corrections have been made sheet A04.01A, see attachment.

8. Question: Please clarify the disposition of the furniture throughout the building. Will the furniture be gone prior to construction start, or are the various furniture notes on the drawings correct?

Answer: Most of the office furniture will be removed by facilities, any remaining items GC is to protect during construction.

9. Question: Does the additive painting item include the exterior of the building?

Answer: Full exterior painting is not included in the additive pricing.

10.Question: For past performance verification, can Federal projects (which do not involve commercial permitting) be submitted? Typically, Federal projects do not require obtaining a commercial building permit; however, the added complexity of start-up requirements for those projects often outweighs the requirements of a commercial permit.

Answer: Past performance verification of Federal Projects can be substituted in lieu of obtaining a commercial building permit, provided the scope of work performed meets the requirements of the similar projects description mentioned in Part C, No.28 References and Attachment E of the IFB.

11.Question: For past performance verification, will the County accept a CCASS/CPARS review from the Federal SAM database in lieu of a live reference contact? For instance, if the owner point of contact has retired and is no longer available.

Answer: Only live reference contacts will be accepted. These references however can refer to historical data for verification.

12.Question: Regarding the handrail details on A08.04, can FRP handrail be bolt-down in lieu of pocketed?

Answer: No.

13. Question: Taking into consideration the General Notes D on sheet E1.01, it is an assumption that the lights placed outside in the back of the building will be Type A fixtures. I would like to confirm, considering that they are similarly presented as the Type F Fixtures in the hallways, that the outdoor lights will be Type A Fixtures.

Answer: Per attached Revised Sheet E101, Plan Note #5 the outdoor fixtures shall be equal to Hubbell #LNC2 5L 120 4K 3 PC.

14.Question: The drawings call for tubular steel handrails on page A08.04 but the specifications contain only sections for Aluminum and FRP handrails. Which of these three options will be used?

Answer: Aluminum or FRP handrails will be accepted, per specification manual.

15.Question: All of the canopy manufacturers we have contacted have informed us that they do not fabricate handrails (this includes Dittmer Architectural Aluminum, from the basis of design). Can the handrails be affixed to the canopy with mechanical connections?

Answer: GC may submit awning and rails from separate manufacturers but must coordinate installation. All manufactures to provide shop drawings, signed and sealed by an engineer licensed in state of Florida per performance requirements in spec section 05 5202 article 1.2. Clear anodized finish is preferred for all components for a maintenance free awning and hand rail system.

16.Question: I did not see what kind of finish for the countertops for both the kitchen and the laundry room?

Answer: The drawings call for plastic laminate to match existing. The Additive Bid Pricing should be for solid surface material, as shown on finish tag CT-2, on attached sheet A05.01.

17. Question: Opening #100: Key note #4 on plan sheet A02.01 says to replace closer if a maximum door force of 8.5 lbs, or less, cannot be met. Please advise if a new closer is required at this opening.

Answer: The Contractor shall test ALL doors with closers on site to determine if the existing closers need replacing. A new closer is required at this opening if a maximum door force of 8.5 lbs. or less cannot be met.

18. Question: Opening #101: Key note #10 on plan sheet A02.01 says to adjust closer to a door force of 5.5 lbs and furnish a lever handle to replace a knob, as needed. This door has a non-functioning closer already, and is currently a push/pull function. This door is not prepped to receive a lockset. Please advise correct hardware required at this opening.

Answer: Please refer to revised Hardware Set and Sheet Notes on attached Revised Sheet A00.30.

19. Question: Note #10 on plan sheet A02.01 says to adjust closers and furnish lever handles to replace knobs, as needed. Please note that the doors currently at this facility are cylindrical locksets. The hardware sets are all specifying mortise locksets. Mortise locksets will not be compatible with the current doors to remain which will require new locksets. Please advise if cylindrical locksets are to be furnished everywhere, in lieu of mortise locksets, or only at existing doors to remain

Answer: Please refer to revised Hardware Set and Sheet Notes on attached Revised Sheet A00.30.

20.Question: Openings #102, 104a, 107 and 109b: Please advise if these openings currently have knobs that will require new lever locksets.

Answer: Please refer to revised Hardware Set and Sheet Notes on attached Revised Sheet A00.30.

21.Question: Opening #104b: Door has both a lockset and a deadbolt, which violates life safety code. Please advise if a new door will be required at this opening, or if the deadbolt hole will be filled in and a new cylindrical lockset furnished.

Answer: Please refer to revised Hardware Set and Sheet Notes on attached Revised Sheet A00.30 and Keynote 40 on Sheet A02.01.

22. Question Opening #106d: Shown as a new door, frame and hardware per the demo plans, but is shown as existing per the door schedule. Please provide door, frame and hardware information on the door schedule.

Answer: Please refer to revised Hardware Set and Sheet Notes on attached Revised Sheet A00.30 and Keynote 8 on Sheet A02.01.

23.Question: Opening #110a: Please advise if two separate door panels are required at this opening with the inactive leaf to be fixed in place by the millwork wood frame manufacturer, or if one door is to be furnished to go into a sidelite wood frame built and furnished by the millwork subcontractor.

Answer: Please refer to revised Hardware Set and Sheet Notes on attached Revised Sheet A00.30 and Keynote 15 on Sheet A01.01.

24. Question: Openings #111b, 112a, 113b, 114a: We do not include rough buck hollow metal frames at these openings as shown in frame details 01 & 02/a00.30. Rough buck frames are not approved for Florida building code for windstorm. We include hollow metal frames in existing cmu partitions that are pierced and dimpled with existing masonry anchors for compliance with building code. Please confirm this application will be acceptable to the architect.

Answer: The hollow metal frames are acceptable as stated on attached Sheet A00.30, door types A,C, and D.

25. Question: Openings 111a & 113a: Please confirm that a privacy lockset with an occupancy indicator is the desired function at these rooms. One is a storage closet and the other a fire riser room.

Answer: Please refer to revised Hardware Set and Sheet Notes on attached Revised Sheet A00.30.

26.Question: Opening 112a: Please confirm that a wood door is required at this boys restroom to match the other interior doors, in lieu of a metal door as shown on the door schedule.

Answer: Both locker room doors for boys and girls require a metal door with louver due to heavy duty wear and tear. Door Type D on attached Sheet A00.30 shall be used.

27.Question: Hardware Sets #2 and #4: Both sets are specified as 'lockset passage' Schlage I9080. The Schlage I9080 lockset is a storeroom function lockset (continuously locked). Please confirm correct function and lockset.

Answer: Please refer to revised Hardware Set and Sheet Notes on attached Revised Sheet A00.30.

- C. CHANGES TO SPECIFICATIONS: 1. N/A
- D. CHANGES TO DRAWINGS: This addendum includes clarifications, corrections, additions, deletions, and revisions that take precedence over the original bid documents. Below is a list of the information contained herein.
 - 1. Revised Construction Issue Plan Set 02.27.17

- E. All other term and conditions of the IFB remain the same.
- F. The Proposer shall acknowledge receipt of this addendum by completing the applicable section in the solicitation or by completion of the acknowledgement information on the addendum. Either form of acknowledgement must be completed and returned not later than the date and time for receipt of the proposal.

Receipt acknowledged by:

Authorized Signature

Date Signed

Title

Name of Firm

ORANGE COUNTY CAPITAL PROJECT DIVISION **INTERNAL OPERATIONS CENTER II** 400 E. SOUTH STREET, 5th FLOOR ORLANDO, FL 32801

ORANGE COUNTY MAYOR HONORABLE TERESA JACOBS


COMMISSIONER DISTRICT 1 **BETSY VANDERLEY**

COMMISSIONER DISTRICT 2 **BRYAN NELSON**



ARCHITECTURAL DESIGN COLLABORATIVE

ARCHITECT 945 N. PENNSYLVANIA AVENUE WINTER PARK, FLORIDA 32789 (407) 629-1188 CONTACT: KAREN ANDERSON

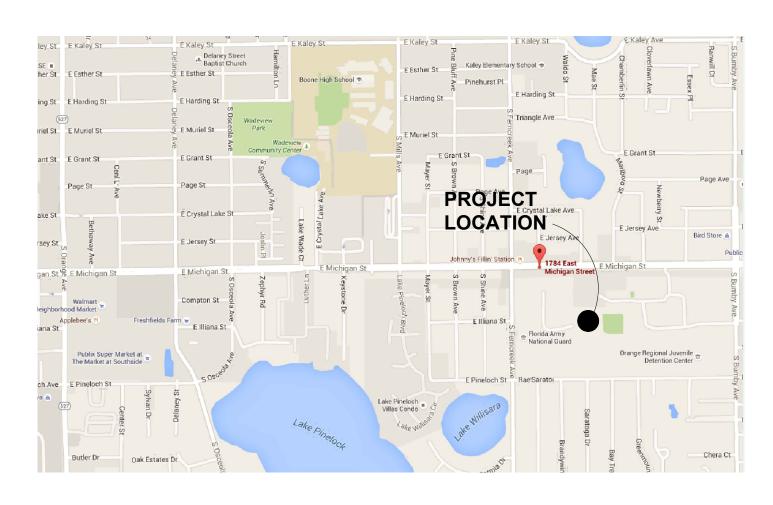



VICINITY MAP N.T.S.



COMMISSIONER DISTRICT 6 VICTORIA P. SIPLIN

GREAT OAKS VILLAGE WITTENSTEIN COTTAGE **1784 E. MICHIGAN STREET** ORLANDO, FL 32806 ORANGE COUNTY PROJECT MANAGER: RANDY NIXON



SGM ENGINEERING

MEP ENGINEER 935 LAKE BALDWIN LANE ORLANDO, FL 32814 (407)767-5188 CONTACT: JOHN J BONOTTO





N LOCATION MAP N.T.S.

COMMISSIONER DISTRICT 3 PETE CLARKE COMMISSIONER DISTRICT 4 JENNIFER THOMPSON **COMMISSIONER DISTRICT 5** EMILY BONILLA



BASE CONSULTANTS

STRUCTURAL ENGINEER 1214 EAST CONCORD STREET ORLANDO, FL 32803 (407)337-7227 CONTACT: LAURA BARBERO-BUFFA



CONSTRUCTION ISSUE SET

ARCHITECTURAL ABBREVIATIONS

PLAS

PLSTC

PLASTER

PLASTIC

PLYWD PLYWOOD

PRTECN PROTECTION

.

A		G
ACCES ACOUS AFF	ACCESSORY ACOUSTIC(AL) ABOVE FINISHED FLOOR	GA GFR(
AHJ AL	AUTHORITY HAVING JURISDICTION ALUMINUM	GFR(
ALT ANNUNC ANOD	ALTERNATE ANNUNCIATOR ANODIZED	GFRF GL
APPL ARCH	APPLIANCE ARCHITECT(URAL)	GR GYP
AUTO AVG &	AUTOMATIC AVERAGE AND	Н
В		HD HDW
BLDG BOLLD	BUILDING BOLLARD	HDW HM
BD BLKG BDD M	BOARD BLOCKING BROADLOOM	HOR HVA
BRDLM BU	BROADLOOM BUILT UP	
		INFO INST INSU
CAB CPT CEM	CABINET CARPET CEMENT(ITIOUS)	INTL INT
CER CLG	CERAMIC CEILING	INFIL J
COATG COILG CONC	COATING COILING CONCRETE	JAN
CONSTR CONT	CONSTRUCTION CONTINUOUS(ATION)	K
CONTR COV CMU	CONTRACT(OR) COVER CONCRETE MASONRY UNIT	KIT
D		L
DBL DEPT	DOUBLE DEPARTMENT	LAV LB £
DES DET	DESIGN(ED) DETAIL	L L LVLC
DF DIA DIFF	DRINKING FOUNTAIN DIAMETER DIFFUSER	lvr M
DIM DISP DIV	DIMENSION DISPENSER DIVISION	MAX MFD
DN \$	DOWN DOLLAR (US CURRENCY)	MFR MEC
DR DSCON	DOOR DISCONNECT	MET MEM MEZ
dwr E	DRAWER	MIN MISC
 Elast	ELASTOMERIC	MLW MOIS
ELEC EMBED ENGR	ELECTRICAL EMBEDD(ED)(ING) ENGINEER(ED)	MOT MTD
ENTR EQ EQUIP	ENTRANCE EQUAL EQUIPMENT	N NIC
EXIST EXP JT	EXISTING EXPANSION JOINT	NO NTS
EXPS EXT	EXPOSE(D) EXTERIOR	0
F		ORN OVFL
FAB FD FE	FABRICATION FLOOR DRAIN FIRE EXTINGUISHER	OVHI OPN OPR
FE&C	FIRE EXTINGUISHER AND CABINET	P
FHC FIN FLDG	FIRE HOSE CABINET FINISH FOLDING	PTN PED
FPLC FR	FIREPLACE FIRE RAT(ING)(ED)	PBD PjM PNL
FRMG FXD FXTR	FRAMING FIXED FIXTURE	POL` POR
FLR FURN	FLOOR(ING) FURNITURE	PREF PREF PLAN
FUT FWC FUT	FUTURE FABRIC WALL COVERING	PLAS PLST
FUT	FUTURE	PLY\ PRTF

G		R	
GA GFRC GFRP GL GR GYP H	GAUGE GLASS FIBER REINFORCED CONCRETE GLASS FIBER REINFORCED GYPSUM GLASS FIBER REINFORCED PLASTER GLASS GRAD(E)(ING) GYPSUM	RDR RECES RECPT REF REFL REFR REQD RESIS REINF RESIL RFG RM RO	READER RECESSED RECEPTACLE REFER(ENCE) REFLECTED REFRIGERATOR REQUIRED RESIST(ANT)(IVE) REINFORCE(D)(IN RESILIENT ROOFING ROOM
HD HDWD HDWE HM HORIZ HVAC	HEAD HARDWOOD HARDWARE HOLLOW METAL HORIZONTAL HEATING, VENTILATING, AND AIR CONDITIONING	S SCR SECUR SF SGL SHORG SIM SST	SCRIBE SECURITY SQUARE FEET SINGLE SHORING SIMILAR STAINLESS STEE
INFO INSTRUM INSUL INTLK INT INFILTR	INFORMATION INSTRUMENT(ATION) INSULATION INTERLOCK(ING) INTERIOR INFILTRATION	STD STL STRFR STRUCT SURF SUSP SYS	STANDARD STEEL STOREFRONT STRUCTURAL SURFACE SUSPENDED SYSTEM(S)
JAN	JANITOR	- Т	THICK
К кіт L	KITCHEN	TLT TRAF TRANS TRTD T&G TYP	TOILET TRAFFIC TRANSPARENT TREATED TONGUE AND GR TYPICAL
LAV LB LT LVLG LVR	LAVATORY POUND BRITISH POUND (CURRENCY) LIGHT LEVELING LOUVER	U TIL UNO	UNDERLAYMENT UTILITY UNLESS NOTED
MAX MFD MFR MECH MET MEMB MEZZ MIN MISC MLWK MOIST MOT	MAXIMUM MANUFACTURED MANUFACTURER MECHANICAL METAL MEMBRANE MEZZANINE MINIMUM MISCELLANEOUS MILLWORK MOISTURE MOTOR(IZED)	VEH VERT VIF W/ WC WD WD WDW WDW W/O WT	VEHICLE VERTICAL VERIFY IN FIELD WITH WATER CLOSET WOOD WINDOW WITHOUT WEIGHT
MTD	MOUNTED	WTRPRF	WATERPROOFING
NIC NO NTS	NOT IN CONTRACT NUMBER NOT TO SCALE	-	
0		-	
ORNA OVFL OVHD OPNG OPR	ORNAMENTAL OVERFLOW OVERHEAD OPENING(S) OPERABLE		
Ρ			
PTN PEDTR PBD PJM PNL POLYST PORT PREFIN PREFAB PLAM	PARTITION PEDESTRIAN PARTICLE BOARD PROJECT MANAGER PANEL POLYSTYRENE PORTABLE PREFINISHED PREFABRICATED PLASTIC LAMINATE		

READER RECES RECESSED RECPT RECEPTACLE REF REFER(ENCE) REFL REFLECTED REFRIGERATOR REFR reqd required RESIS RESIST(ANT)(IVE) REINFORCE(D)(ING)(MENT) REINF RESIL RESILIENT RFG roofing ROOM SCR SCRIBE SECUR SECURITY SQUARE FEET SINGLE SGL SHORING SHORG SIMILAR STAINLESS STEEL STD STANDARD STL STEEL STRFR STOREFRONT STRUCT STRUCTURAL SURF SURFACE SUSP SUSPENDED SYS SYSTEM(S) THK THICK TOILET TRAFFIC TRAF TRANS TRANSPARENT TRTD TREATED T&G TONGUE AND GROOVE TYP TYPICAL UNDRLAY UNDERLAYMENT UTIL UTILITY UNLESS NOTED OTHERWISE UNO VEH VEHICLE VERT VERTICAL VERIFY IN FIELD WITH WATER CLOSET WOOD WDW WINDOW W/O WITHOUT WEIGHT

SCOPE

PROJECT NARRATIVE/SCOPE OF WORK

THIS PROJECT IS AN ALTERATION TO AN EXISTING RESIDENCE TO BUILD OUT THREE BEDROOMS IN EACH WING OF THE BUILDING TO ACCOMMODATE A BOYS AND GIRLS AREA. THE EXISTING RESTROOM IN EACH OF THE TWO WINGS WILL BE ALTERED TO PROVIDE AN ACCESSIBLE FIXTURE SET. THE SHOWER IN THE RESTROOM OFF THE COMMON GATHERING AREA WILL BE ALTERED FOR GREATER ACCESSIBILITY.

THE EXISTING CERAMIC TILE FLOOR WILL BE REPLACED WITH NEW FLOORING THROUGHOUT AND GENERAL MAINTENANCE MAY BE PERFORMED AS RELATED TO ALTERATION CONSTRUCTION.

THE KITCHEN WILL BE ALTERED TO PROVIDE FOR AN ACCESSIBLE PATH AROUND THE KITCHEN, AN ACCESSIBLE SINK, AND AN ACCESSIBLE MICROWAVE.

A NEW FIRE SPRINKLER SYSTEM WILL BE INSTALLED AS DIRECTED BY THE FIRE MARSHAL

THE EXISTING STAIRS AT THE REAR OF THE BUILDING WILL BE REPAIRED OR REPLACED AND COMPLIANT HANDRAILS WILL BE INSTALLED. NO EXPANSION OF THE EXISTING FOOTPRINT IS PLANNED.

SCOPE OF WORK NOTES:

1. WORK THAT IS NOT STATED HEREIN NOR SHOWN IN THESE PLANS IS NOT PART OF THE SCOPE OF WORK FOR THIS PROJECT.

2. ADDITIONAL WORK REQUIRED THAT WOULD ALTER THE PRESENTED SCOPE OF WORK SHALL BE SUBJECT TO A REVISION OF THESE DOCUMENTS AND MAY BE REQUIRED TO BE REVIEWED BY THE BUILDING DEPARTMENT HAVING JURISDICTION.

GENERAL DEMOLITION NOTES:

REMOVE EXISTING RECEPTACLES, TELEPHONES, SWITCHES, AND ANY ELECTRICAL DEVICES IN WALLS TO BE DEMOLISHED. RELOCATE THESE DEVICES AS INDICATED OR REQUIRED BY THE DRAWINGS, ARCHITECT, OR OWNER REPRESENTATIVE. PROVIDE ARCHITECT WITH AS-BUILT DRAWINGS OF FINAL INSTALLATION FOR RECORD PURPOSES. CONTRACTOR IS NOTIFIED THAT NOT ALL EXISTING DEVICES MAY HAVE BEEN INDICATED ON THE DRAWINGS AND THAT SOME EXISTING ELECTRICAL DEVICES MAY NOT HAVE BEEN SHOWN IN THEIR ACTUAL LOCATION. CONTRACTOR IS REQUIRED TO VISIT SITE AND BECOME FAMILIAR WITH THE EXISTING CONDITIONS PRIOR TO DETERMINING THE WORK THAT NEEDS TO BE ACCOMPLISHED AS PART OF HIS/HER BID.

- THE WORK SHALL INCLUDE THE FURNISHING OF ALL MATERIALS. CUTTING. EXTENDING. CONNECTING, REPAIRING, ADAPTING, AND OTHER COINCIDENTAL WORK TOGETHER WITH SUCH TEMPORARY INSTALLATIONS AS MAY BE NECESSARY TO SATISFY THE DEMOLITION PROGRAM. APPROVAL SHALL BE SECURED FROM THE OWNER/PROJECT MANAGER PRIOR TO CUTTING/DRILLING ANY STRUCTURAL SUPPORT.
- 3 ALL BUILDING CONSTRUCTION AFFECTED BY THE REMOVAL. RELOCATION, INSTALLATION OF ANY PIECE OF EQUIPMENT SHALL BE REPAIRED AND FINISHED AS REQUIRED TO MATCH EXISTING CONDITION OR AS DIRECTED BY THE ARCHITECTURAL DRAWINGS, SPECIFICATIONS, OR PROJECT MANAGER.
- WHEN ELECTRICAL DEVICES ARE PRESENT IN PARTITIONS OR CEILINGS TO BE REMOVED. THE ELECTRICAL CONTRACTOR SHALL DISCONNECT THEM UP TO THE NEXT OUTLET TO REMAIN OR BACK TO PANEL THE BOARD. IF EXISTING TO REMAIN OUTLETS ARE FED THROUGH DEMOLISHED PARTITIONS OR CEILINGS, THE CIRCUIT SHALL BE REARRANGED TO MAINTAIN CIRCUIT CONTINUITY. WIRE SHALL BE REMOVED BACK TO SOURCE FROM INACCESSIBLE RACEWAYS NOT REUSED. INSTALL BLANK PLATES ON FLUSH OUTLETS NOT REUSED. PLATE COLOR SHALL MATCH ADJACENT SURFACE AS NEAR AS POSSIBLE IN FINISHED AREAS.
- REFER TO ELECTRICAL ENGINEERING FOR WORK TO BE REMOVED FROM STRUCTURE. OTHER ELECTRICAL ITEMS ASSOCIATED WITH THIS WORK SHALL BE REMOVED IF NOT REQUIRED FOR NEW EQUIPMENT TO CONTINUE IN SERVICE.
- CONTRACTOR SHALL DEMOLISH ANY INTERIOR FINISHES TO COMPLETE THE NECESSARY AND PROPOSED WORK AS DIRECTED BY THE ARCHITECTURAL DRAWINGS, INTERIOR DESIGN DRAWINGS, SPECIFICATIONS, OR BY PROJECT MANAGER. EXISTING FIXTURES, EQUIPMENT, AND ALL DEBRIS WHICH ARE REQUIRED TO BE REMOVED SHALL
- BE REMOVED BY THE CONTRACTOR. CONTRACTOR TO COORDINATE WITH PROJECT MANAGER PRIOR TO REMOVAL OF SUCH. ALL ELECTRICAL AND PLUMBING LINES WHICH REQUIRE REMOVAL OR ALTERATION ARE TO BE
- DONE SO BY THE CONTRACTOR. LINES TO BE CAPPED AND PREPARED FOR REMOVAL OR RE-ROUTING AS SPECIFIED.
- REMOVE ALL UTILITIES IN DEMOLITION AREAS AND CONSTRUCTION AREAS IN A MANNER, AND IN THE TIME, SATISFACTORY TO THE UTILITY COMPANY. IF UTILITY COMPANY DESIRES TO EFFECT THE REMOVAL OF THE MATERIALS, THEY SHALL BE PERMITTED TO DO SO.
- 10 COVER ITEMS AS SPECIFIED BY OWNER/PROJECT MANAGER TO PROTECT FROM DUST AND DEBRIS. 11 SALVAGED MATERIALS SHALL BE REMOVED, CLEANED, AND PREPARED FOR RE-INSTALLATION. OWNER MAINTAINS OWNERSHIP OF ALL MATERIALS UNLESS OTHERWISE SPECIFIED.
- 2 WHERE EXISTING WALLS, CEILINGS, AND FIXTURES HAVE BEEN REMOVED, AREAS SHALL BE PATCHED TO MATCH EXISTING FINISHES, OR FINISHES TO BE ADDED AS PER PLANS, INTERIOR DESIGNER, OR AS PER OWNER.
- 13 WHERE EXISTING WORK IS DAMAGED IN THE EXECUTION OF THIS CONTRACT, OR WHERE OPENINGS ARE LEFT DUE TO THE REMOVAL OF PIPES, EQUIPMENT OR APPARATUS, THE SAME SHALL BE REPAIRED OR CLOSED TO CORRESPOND IN MATERIAL, QUALITY, SHAPE AND FINISH WITH THAT OF SIMILAR AND ADJOINING WORK, UNLESS OTHERWISE CALLED FOR. WHERE DAMAGE IS IRREPARABLE, NEW ITEMS OR EQUIPMENT SHALL BE PROVIDED. CONTRACTOR SHALL PROVIDE ALL NECESSARY WATERPROOFING, FIRE STOPPING AND SEALING OF PENETRATIONS LEFT FROM REMOVED EQUIPMENT OR PRODUCED BY THIS WORK.
- 14 INTERRUPTION OF EXISTING SERVICES AND/OR OPERATION OF FACILITIES SHALL BE KEPT TO A MINIMUM. CONTRACTOR SHALL FURNISH ALL MATERIALS REQUIRED WHENEVER TEMPORARY CONNECTIONS ARE NECESSARY TO MAINTAIN CONTINUITY OF SERVICE. INTERRUPTION OF EXISTING SERVICES, THE INSTALLATION OF TEMPORARY FACILITIES, AND THE WORK OF MAKING FINAL CONNECTIONS TO THE NEW WORK SHALL BE DONE ONLY AT SUCH TIMES PERMITTED AND SCHEDULED IN ADVANCE BY THE ARCHITECT/OWNER WITHOUT ADDITIONAL COST. CARE MUST BE USED IN REMOVING SERVICES TO AREAS BEING DEMOLISHED SO THAT SERVICES TO OTHER AREAS WHICH MIGHT BE SERVED THROUGH THESE AREAS WILL NOT BE INTERRUPTED.
- 5 WHERE DEMOLITION WORK REQUIRES TEMPORARY INTERRUPTION OF ELECTRICAL, TELEPHONE, TV ALARM OR COMMUNICATION SERVICES, RESPECTIVE UTILITIES AND/OR COMPANY REPRESENTATIVES SHALL BE NOTIFIED AS NECESSARY, AND ALL WORK DONE SHALL BE UNDER SUPERVISION AND THEIR ESTABLISHED STANDARDS.
- 16 ALL LIGHTING FIXTURES, RECEPTACLES, SWITCHES, WIRING DEVICES, SPECIAL OUTLETS, TELEPHONE CABLES, TV CABLES, MISCELLANEOUS SYSTEM WIRING, POWER CONDUCTORS, CONDUITS, ELECTRICAL BOXES, RACEWAYS AND ANY OTHER ELECTRICAL SYSTEM COMPONENTS LOCATED IN THE AREAS SHOWN AS BEING DEMOLISHED OR NOT USED AFTER WORK IS COMPLETED SHALL BE REMOVED UNLESS OTHERWISE NOTED AS EXISTING TO REMAIN OR BE RELOCATED. CONDUITS RUNNING IN SLAB AT FINISHED AREAS SHALL BE CUT FLUSH, PLUGGED AND ABANDONED AFTER CONDUCTORS ARE REMOVED. NO WIRING SHALL BE LEFT ABANDONED AFTER WORK IS COMPLETED.
- 17 ALL DEMOLITION, RENOVATION, AND CONSTRUCTION TO COMPLY WITH CURRENT NFPA REQUIREMENTS.
- 18 DEBRIS SHALL BE REMOVED FROM THE SITE DAILY. 19 THE GC SHALL THOROUGHLY INVESTIGATE EXISTING CONDITIONS INCLUDING GENERAL PLAN LAYOUT/CONFIGURATION AND EXISTING STRUCTURAL COMPONENTS VISIBLE OR CONCEALED (IN WALL AND/OR ABOVE CEILING), THAT COULD IMPACT THE WORK. THE GC SHALL FIELD VERIFY EXISTING DIMENSIONS, MATERIALS AND METHODS OF CONSTRUCTION, AND STRUCTURE, AND COORDINATE EACH WITH THE CONTRACT DOCUMENTS. THE GC SHALL NOTIFY THE ARCHITECT OF DISCREPANCIES BETWEEN EXISTING CONDITIONS AND THE CONTRACT DOCUMENTS PRIOR TO

AS BUILT DRAWINGS:

COMMENCING WORK.

- GC TO PROVIDE ARCHITECT WITH FULL SIZED RED-LINED AND CLOUDED MARKED-UP/AS BUILT DRAWINGS AT EVERY SITE VISIT. DRAWINGS SHOULD SHOW ANY FIELD MODIFICATIONS THAT DIFFER FROM CONSTRUCTION DOCUMENTS.
- THE ABOVE REFERENCED RUNNING SET OF AS-BUILTS WILL BE USED AT COMPLETION OF PROJECT TO PROVIDE THE CLIENT WITH AN ACCURATE SET OF RECORD DRAWINGS.

PROJECT INFORMATION

APPLICABLE CODES

FLORIDA BUILDING CODE - (5th EDITION 2014) FLORIDA BUILDING CODE ACCESSIBILITY (5th EDITION 2014) FLORIDA BUILDING CODE - EXISTING BUILDING- (5th EDITION 2014) FLORIDA FIRE PREVENTION CODE - (5th EDITION) NFPA 101 - LIFE SAFETY CODE 2012 WITH FLORIDA AMENDMENTS NFPA 1- UNIFORM FIRE CODE 2012 WITH FLORIDA AMENDMENTS NFPA 70 - NATIONAL ELECTRICAL CODE - 2011 FLORIDA MECHANICAL CODE - 2014

CITY OF ORLANDO JURISDICTION

OCCUPANCY

GROUP CLASSIFICATION: MAX. PROJECTED RESIDENTS:

RESIDENTIAL:

RESIDENTIAL R4 - GROUP HOME 12 OCC. TOTAL IN BEDROOMS PLUS (4) MAX SUPPORT STAFF TOTAL OF (16) OCCUPANTS OR LESS OFFICES PROVIDED FOR 24 HOUR STAFF WHICH ARE AN ACCESSORY USE TO THE R-4 OCCUPANCY

EXITS

SEE LIFE SAFETY SUMMARY AND I	DIAGRAM ON A00.53
MAX. TRAVEL DISTANCE:	250 FT. (SPRINKLERED)
PROVIDED:	99 FT.
MAX. COMMON PATH OF TRAVEL:	75 FT (SPRINKLERED)
PROVIDED:	35 FT.
MAX. DEAD END CORRIDOR:	50FT. (SPRINKLERED)
PROVIDED:	0 FT.
EGRESS CAPACITY:	137 x .2 = 27.4"
PROVIDED:	170" (3 doors @ 34" ONE AT 68")
	· · · · · · · · · · · · · · · · · · ·

CONSTRUCTION

TYPE:	EXISTING
SPRINKLERED or NONSPRINKLERED:	SPRINKLERED BUILDING
HEIGHT:	EXISTING
CLASSIFICATION OF WORK:	ALTERATION / RENOVATION

PLUMBING REQUIREMENTS: 16 TOTAL / 2 = 8 EACH SEX (PER TABLE 403.1)

MINIMUM REQUIRED PLUMBING FIXTURES

	FEMALE	MALE	UNISEX
WATER CLOSETS	(1) REQUIRED	(1) REQUIRED	(1) REQUIRED
1 PER (10 PEOPLE)	(2) PROVIDED	(2) PROVIDED	(1) PROVIDED
LAVATORIES	(1) REQUIRED	(1) REQUIRED	(1) REQUIRED
1 PER (10 PEOPLE)	(2) PROVIDED	(2) PROVIDED	(1) PROVIDED
DRINKING FOUNTAINS	-	-	(1) REQUIRED
1 PER (100)	-	-	(2) PROVIDED
UTILITY SINK	-	-	(1) REQUIRED
1 PER (100)	-	-	(2) PROVIDED

DRAWING INDEX

ARCHITECTURAL

	COVER SHEET
A00.00	INDEX
A00.01	GRAPHIC SYMBOLS
A00.30	DOOR, FRAME AND HARDWARE SCHEDULE
A00.31	TYPICAL STANDARDS
A00.40	ACCESSIBILITY INFORMATION
A00.50	SITE PLAN
A00.51	LIFE SAFETY PLAN
A01.01	DEMOLITION PLAN
A02.01	CONSTRUCTION PLAN
A04.01A	DEMO REFLECTED CEILING PLAN
A04.01B	REFLECTED CEILING PLAN
A05.01	FLOOR FINISH PLAN
A06.01	FURNITURE AND EQUIPMENT LAYOUT
A08.01	ENLARGED RESTROOMS
A08.02	ENLARGED RESTROOMS
A08.03	ENLARGED KITCHEN
A08.04	STAIR DETAILS AND ELEVATIONS
A12.01	MILLWORK DETAILS
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FIRE PROTECTION

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F100	FIRE PROTECTION SITE PLAN
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PLUMBING SYMBOLS, LEGEND AND GENERAL NOTES
PLUMBING PLAN
PLUMBING SCHEDULES
PLUMBING DETAILS

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M0.01	MECHANICAL SYMBOLS, LEGEND AND
	GENERAL NOTES
MD1.01	MECHANICAL DEMOLITION PLAN
M1.01	MECHANICAL PLAN
M5.01	MECHANICAL DETAILS

ELECTRICAL

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E0.02	ELECTRICAL SPECIFICATIONS
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ED1.02	POWER DEMO PLAN
E1.01	LIGHTING RENOVATION PLAN
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E4.01	ELECTRICAL PANEL SCHEDULES

STRUCTURAL

S0.01	GENERAL NOTES
S0.02	SYMBOLS AND ABBREVIATIONS
S02.03	FOUNDATION AND SLAB PLAN
S05.01	SECTIONS AND DETAILS

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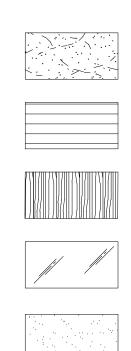
INDEX

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GRAPHIC SYMBOLS (CONT.)

STONE

ELEVATION INDICATIONS




BRICK/CONCRETE BLOCK
FINISHED WOOD

GLASS	

QUARTZ

RESIN

SECTION INDICATIONS

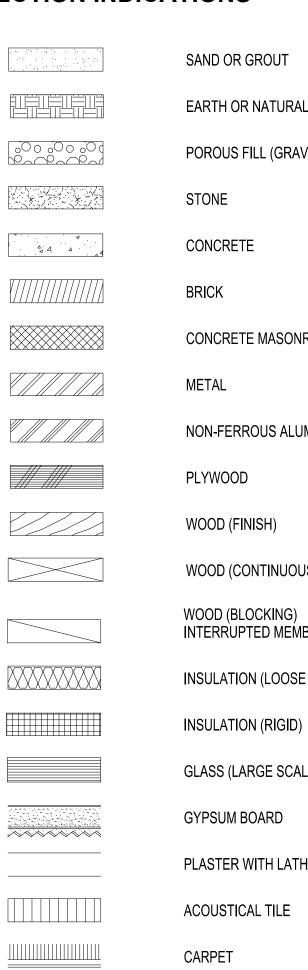

SAND OR GROUT EARTH OR NATURAL GROUND POROUS FILL (GRAVEL) STONE CONCRETE BRICK CONCRETE MASONRY UNIT METAL NON-FERROUS ALUMINUM PLYWOOD WOOD (FINISH) WOOD (CONTINUOUS)

INTERRUPTED MEMBER

INSULATION (LOOSE OR BATT)

GLASS (LARGE SCALE)

GYPSUM BOARD

PLASTER WITH LATH

ACOUSTICAL TILE

CARPET


FABRIC WRAPPED PANEL




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GRAPHIC SYMBOLS (CONT.)

REFLECTED CEILING

ACOUSTICAL CEILING AND GRID
 - MAIN RUNNER
GYPSUM BOARD SOFFIT
EXISTING TO BE REMOVED
SURFACE MOUNTED FLUORESCENT LIGHT FIXTURE
FLUORESCENT STRIP FIXTURE
FLUORESCENT PENDANT FIXTURE
CEILING HEIGHT CHANGE
DIMENSION OF CEILING ABOVE FINISH FLOOR
CEILING FINISH
CEILING MOUNTED EXIT SIGN, SHOWS QUANTITY OF FACE(S) AND DIRECTION OF ARROW(S)
SMOKE DETECTOR
STROBE
FIRE SPRINKLER
SPEAKER
ACCESS DOOR
SECURITY CAMERA
THERMOSTAT
LIGHT SWITCH
DIMMER SWITCH
RETURN AIR
SUPPLY AIR
LINEAR DIFFUSER
DENOTES EXISTING TO REMAIN
DENOTES EXISTING, RELOCATED FIXTURE

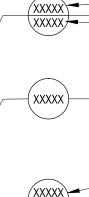 WALL FINISH
BASE FINISH
 EXTENT OF FINISH

WALL FINISH - EXTENT OF FINISH

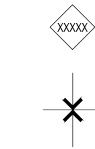- WALL FINISH WAINSCOT FINISH - BASE FINISH - EXTENT OF FINISH
- SPECIAL FINISH
- FLOOR FINISH

CHANGE IN FLOOR FINISH


GRAPHIC SYMBOLS (CONT.)

POWER & COMMUNICATION WALL MOUNTED DUPLEX WALL MOUNTED FOURPLEX QUADRAPLEX ISOLATED WALL MOUNTED SEPARATE DUPLEX WALL MOUNTED DEDICATED DUPLEX ₽ WALL MOUNTED DEDICATED FOURPLEX WALL MOUNTED HALF DEDICATED FOURPLEX WALL MOUNTED SPECIAL OUTLET WALL MOUNTED TELEPHONE RECEPTACLE WALL MOUNTED TELE/DATA RECEPTACLE WALL MOUNTED 1 TELE/2 DATA RECEPTACLE - QUAD FACEPLATE TERMINAL IN SINGLE-GANG, DUPLEX J-BOX. \triangle WALL MOUNTED DATA RECEPTACLE AV WALL MOUNTED A/V RECEPTACLE TV WALL MOUNTED TV/CAMERA RECEPTACLE - 3" SQUARE. FLUSH FLOOR MOUNTED TELEPHONE RECEPTACLE FLUSH FLOOR MOUNTED TELE/DATA RECEPTACLE FLUSH FLOOR MOUNTED 1 TELE/2 DATA RECEPTACLE 2 (A \bigcirc FLUSH FLOOR MOUNTED DATA RECEPTACLE \bullet FLUSH FLOOR MOUNTED DUPLEX $(\mathbf{\Phi})$ FLUSHFLOOR MOUNTED FOURPLEX \mathbf{O} FLUSH FLOOR MOUNTED DEDICATED DUPLEX FLUSH FLOOR MOUNTED DEDICATED FOURPLEX FLUSH FLOOR MOUNTED SEPARATE DUPLEX FLUSH FLOOR MOUNTED SEPARATE FOURPLEX FLUSH FLOOR MOUNTED DUPLEX WITH TELE/DATA RECEPTACLE FLUSH FLOOR MOUNTED DEDICATED DUPLEX WITH TELE/DATA RECEPTACLE FLUSH FLOOR MOUNTED SEPARATE DUPLEX WITH TELE/DATA RECEPTACLE FLUSH FLOOR MOUNTED A/V RECEPTACLE (TV) FLUSH FLOOR MOUNTED TV RECEPTACLE POKE-THRU TEL. MONUMENT POKE-THRU TELE/DATA MONUMENT \square POKE-THRU DATA POWER MONUMENT POKE-THRU DUPLEX POWER MONUMENT - | POKE-THRU FOURPLEX POWER MONUMENT POKE-THRU DEDICATED DUPLEX POWER MONUMENT 0 POKE-THRU DEDICATED FOURPLEX POWER MONUMENT Ð \bigcirc POKE-THRU SEPARATE DUPLEX POWER MONUMENT POKE-THRU SEPARATE FOURPLEX POWER MONUMENT AV POKE-THRU A/V MONUMENT TV POKE-THRU TV MONUMENT FLUSH WALL MOUNTED POWER JUNCTION BOX WITH HARDWIRE CONNECTION FLOOR POKE-THRU JUNCTION BOX WITH HARDWIRE CONNECTION COMBINATION FLOOR POKE-THRU JUNCTION BOX

CR CARD READER ID INTERCOM DEVICE DR DOOR RELEASE BUTTON PΒ DOOR BELL PUSH BUTTON TO READ "PUSH TO EXIT" PER NFPA 7.2.1.6.2 (4) Μ MONITOR PD PHONE DIRECTORY Η ELECTROMAGNETIC DOOR HOLD OPEN ELECTRIC LOCKSET (SEE HARDWARE SCHEDULE) ML MAGNETIC LOCK (SEE HARDWARE SCHEDULE) SECURITY SYSTEM DOOR MONITOR CONTACT (SEE HARDWARE SCHEDULE) INTRUSION ALARM (SEE SECURITY DRAWINGS) KS KEY SWITCH (SEE SECURITY DRAWINGS) CONTROL PANEL CP BG 491 EMERGENCY BREAK GLASS STATION; SECURITY DOOR CONTROLS SB WALL MOUNTED SIMON BOARD, POWER & DATA TO BE COORDINATED WITH VENDOR $\langle X \rangle$ **EQUIPMENT ITEM - SEE SCHEDULE** FIRE WARDEN STATION FS FP FIRE ALARM PULL BOX SECURITY MONITOR (AV) A/V FOR PROJECTION SYSTEM CAMERA REFER TO REFLECTED CEILING PLAN FOR LOCATION RECESSED POWER. DATA & COAX OUTLET, SEE PLAN FOR HT GF **GROUND FAULT INTERCEPTOR** 0

WITH HARDWIRE CONNECTION

GRAPHIC SYMBOLS

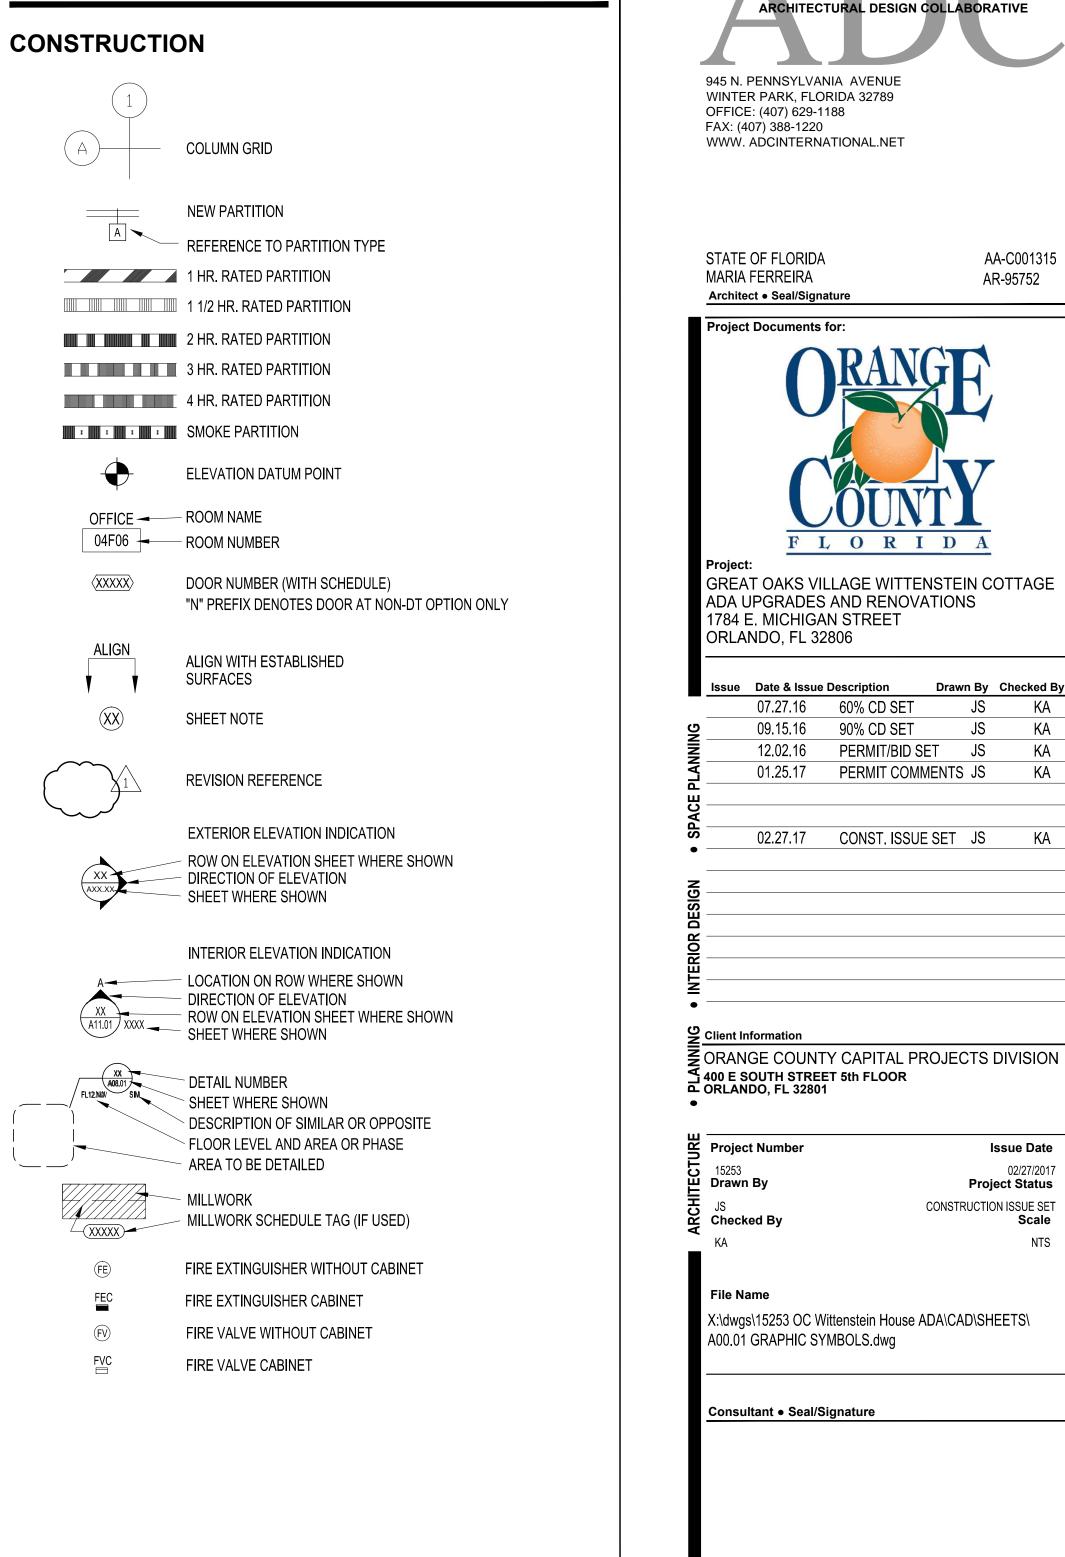

Sheet Title:

GRAPHIC SYMBOLS

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Issue Date

02/27/2017

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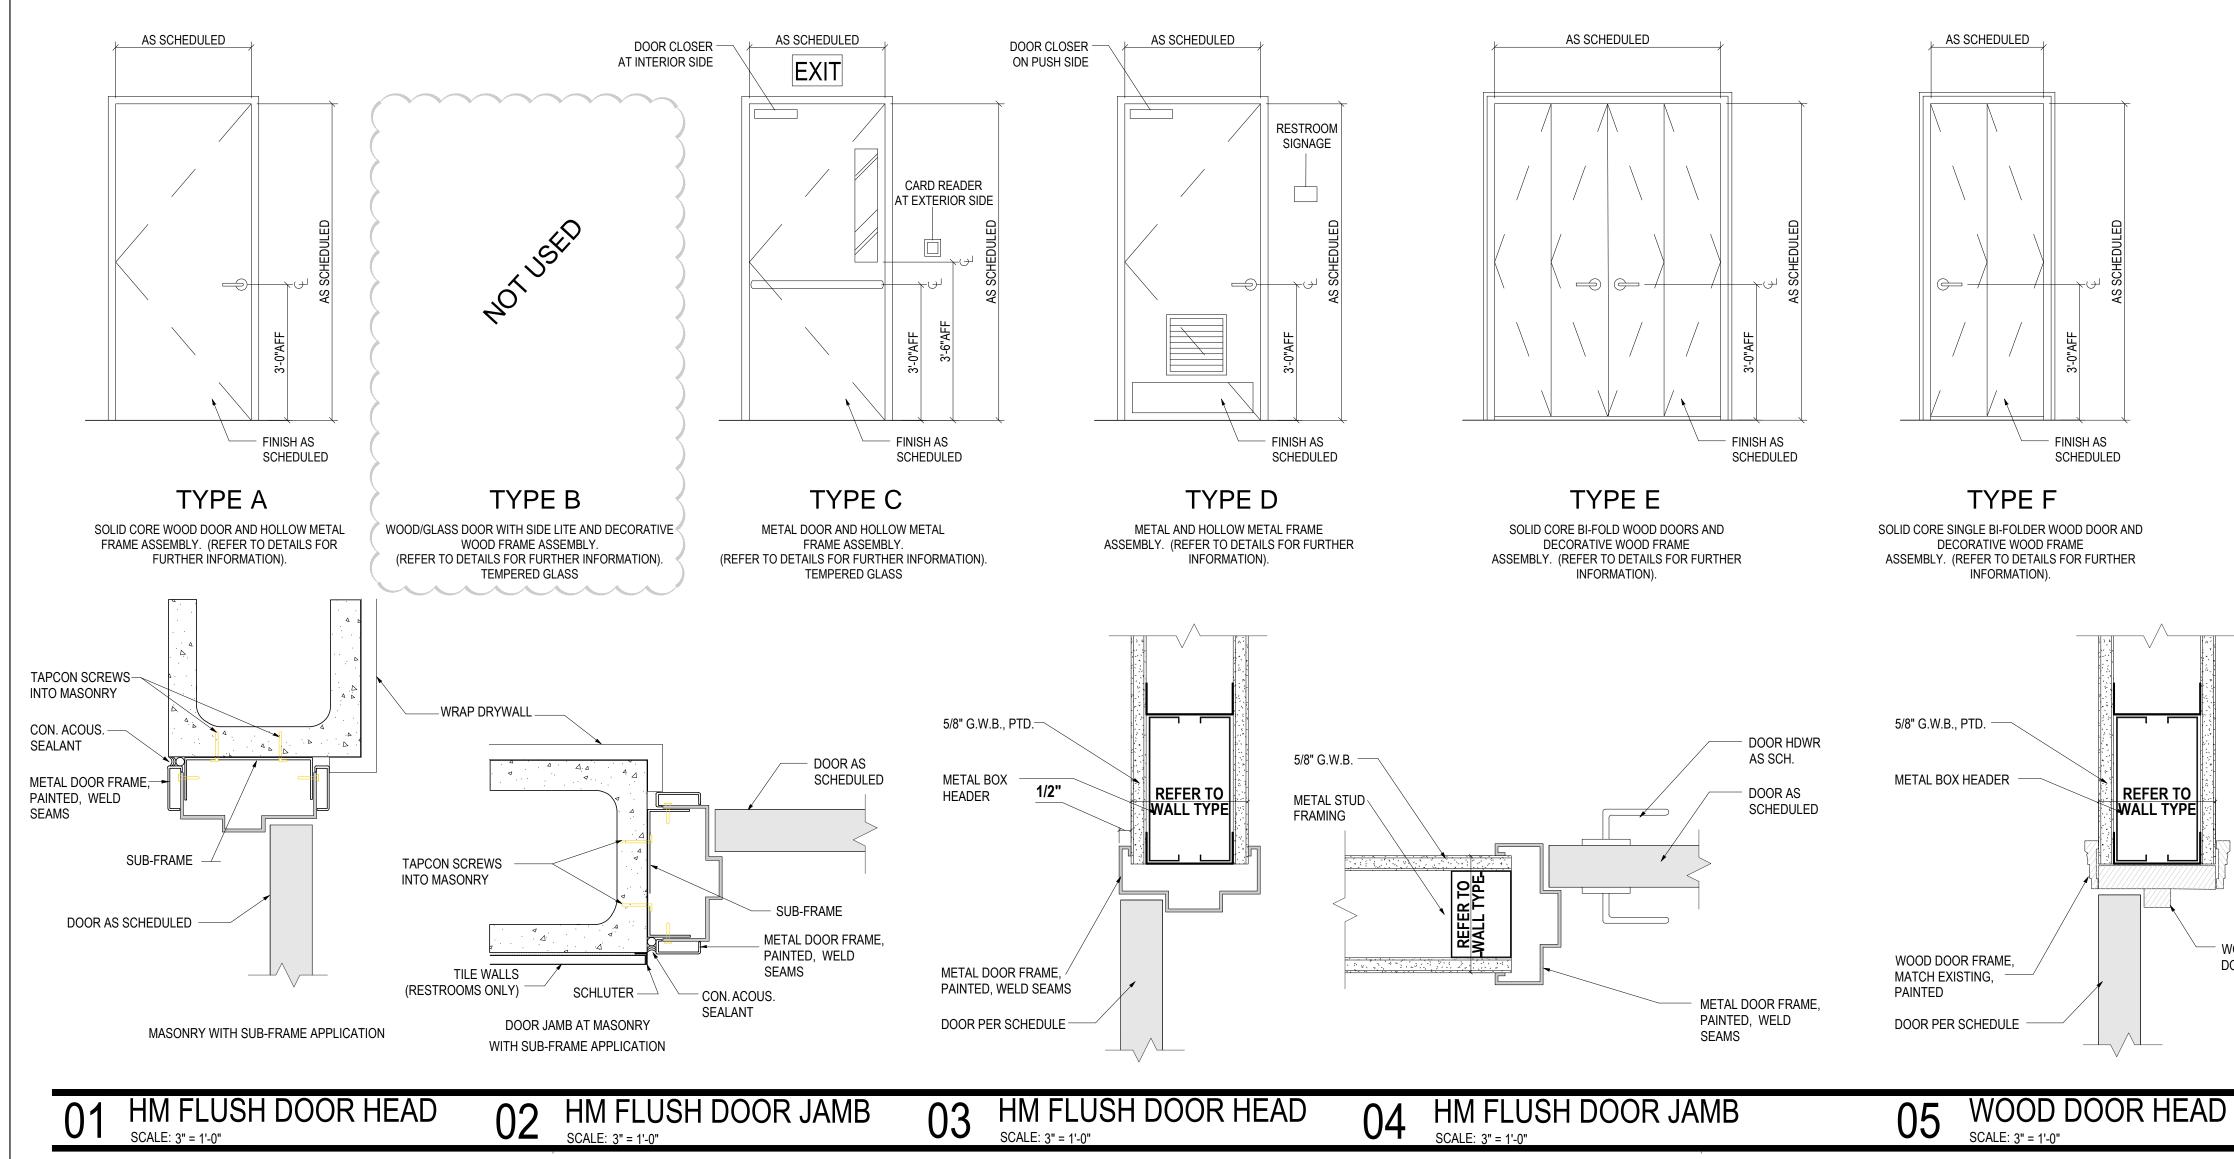
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DOOR, FRAME AND HARDWARE GROUP SCHEDULE

								SCHI	EDULE - DOOR AN	ID FRAME						
			DOOR A	SSEMBLY						FRAME ASSEM	MBLY		FIRE	HARDWARE	HARDWARE	
NO.	LOCATION	TYPE	WIDTH	HEIGHT	THICKNESS	MATERIAL	FINISH	MATERIAL	FINISH	HEAD DETAIL	JAMB DETAIL	SILL DETAIL	RATING	GROUP	FUNCTION	REMARKS
100	ENTRY DOOR						PAINT		PAINT					3		2, 3. 6 3
	LOBBY						PAINT		PAINT					6		2, 3, 8, 9
<u> </u>	OFFICE						PAINT		PAINT		teee			Cit of		2, 3, 8
	STORAGE CLOSET	-					PAINT		PAINT	_	_	-	_		(2, 3, 8
	CORRIDOR	-					PAINT		PAINT	_	_	-	_	6	i	2, 3, 8
	LIVING ROOM / DINING ROOM	_					PAINT		PAINT	_	-	-	_	6		2, 3, 8
106A	UNISEX RESTROOM	-					PAINT		PAINT	-	-	_	_			2, 3, 8
106B	JANITOR CLOSET	-					PAINT		PAINT	-	-	-	_	_	(2, 3, 8
	HALLWAY #1						PAINT		PAINT	-	-		-	-	(2, 3, 8
	HALLWAY #2	A	3'-0"	6'-8"	1 3/4"	S.C. WOOD	PAINT	HOLLOW MTL	PAINT	03/A00.30	04/A00.30			1	P7	2, 5
107	MECHANICAL ROOM			$\overline{}$			PAINT	Y	PAINT	<u></u>	$\frac{1}{2}$		<u>h</u>			2, 3, 8
108	OFFICE	-					PAINT		PAINT	-	-	-	-	-		2, 3, 8
109A	LAUNDRY ROOM	Α	3'-0"	6'-8"	1 3/4"	S.C. WOOD	PAINT	-	PAINT	-	-	-	-	-	(2, 3, 8
109B	LAUNDRY ROOM						PAINT		PAINT							2, 3, 8
110A	STUDY AREA	-		-		-	PAINT	-	PAINT	-	-	-				2, 3, 9 -BOTH DOORS
110B	BACK ENTRY						PAINT		PAINT							2, 3, 6, 8
111A	STORAGE CLOSET	A	2'-8"	6'-8"	1 3/4"	S.C. WOOD	STAIN	HOLLOW MTL	PAINT	03/A00.30	04/A00.30	-	-	1		2, 4, 8
111B	BACK DOOR	C	3'-0"	6'-8"	1 3/4"	METAL/GLASS	PAINT	HOLLOW MTL	PAINT	01/A00.30	02/A00.30			3		2, 6, 8
112A	BOY'S RESTROOM	D	3'-0"	6'-8"	1 3/4"	METAL	STAIN	HOLLOW MTL	PAINT	01/A00.30	02/A00.30			4		2,5
113A	FIRE RISER ROOM	Α	2'-8"	6'-8"	1 3/4"	S.C. WOOD	STAIN	HOLLÓW MTL	PAINT	03/A00.30	04/A00.30	-	-	1		2, 4
113B	BACK DOOR	C	3'-0"	6'-8"	1 3/4"	METAL/GLASS	PAINT	HOLLOW MTL	PAINT	01/A00.30	02/A00.30		<u> </u>	3	\sum	2, 6
114A	GIRL'S RESTROOM	D	3'-0"	6'-8"	1 3/4"	METAL	STAIN	HOLLOW MTL	PAINT	01/A00.30	02/A00.30	-	-	4		2, 5
116A	GIRL'S SLEEPING QUARTERS #1	Α	3'-0"	6'-8"	1 3/4"	S.C. WOOD	STAIN	HOLLOW MTL	PAINT	03/A00.30	04/A00.30	-	-	2		2, 4
116B	CLOSET	F	2'-8"	6'-8"	1 3/4"	S.C. WOOD	STAIN	WOOD	PAINT	05/A00.30	06/A00.30	-	-	5		1, 4, 7
117A	GIRL'S SLEEPING QUARTERS #2	Α	3'-0"	6'-8"	1 3/4"	S.C. WOOD	STAIN	HOLLOW MTL	PAINT	03/A00.30	04/A00.30	-	-	2		2, 4
117B	CLOSET	E	5'-0"	6'-8"	1 3/4"	S.C. WOOD	STAIN	WOOD	PAINT	05/A00.30	06/A00.30	-	-	5		1, 4
118A	GIRL'S SLEEPING QUARTERS #3	Α	3'-0"	6'-8"	1 3/4"	S.C. WOOD	STAIN	HOLLOW MTL	PAINT	03/A00.30	04/A00.30	-	-	2		2, 4
118B	CLOSET	E	5'-0"	6'-8"	1 3/4"	S.C. WOOD	STAIN	WOOD	PAINT	05/A00.30	06/A00.30	-	-	5		1, 4, 7
119A	BOY'S SLEEPING QUARTERS #1	Α	3'-0"	6'-8"	1 3/4"	S.C. WOOD	STAIN	HOLLOW MTL	PAINT	03/A00.30	04/A00.30	-	-	2		2, 4
119B	CLOSET	F	2'-8"	6'-8"	1 3/4"	S.C. WOOD	STAIN	WOOD	PAINT	05/A00.30	06/A00.30	-	-	5		1, 4, 7
120A	BOY'S SLEEPING QUARTERS #2	Α	3'-0"	6'-8"	1 3/4"	S.C. WOOD	STAIN	HOLLOW MTL	PAINT	03/A00.30	04/A00.30	-	-	2		2, 4
120B	CLOSET	E	5'-0"	6'-8"	1 3/4"	S.C. WOOD	STAIN	WOOD	PAINT	05/A00.30	06/A00.30	-	-	5		1, 4, 7
121A	BOY'S SLEEPING QUARTERS #3	Α	3'-0"	6'-8"	1 3/4"	S.C. WOOD	STAIN	HOLLOW MTL	PAINT	03/A00.30	04/A00.30	-	-	2		2, 4
121B	CLOSET	E	5'-0"	6'-8"	1 3/4"	S.C. WOOD	STAIN	WOOD	PAINT	05/A00.30	06/A00.30	-	_	5		1, 4, 7

DOOR TYPES



HARDWARE GROUPS

SET 01

- LOCKSET PRIVACY- MARKS 195 SERIES WITH I/C CORE PREP CYLINDRICAL LOCKSET, LEVER, 26D FINISH
- FULL MORTISE BUTT STAINLESS HINGES, STANLEY CB1900 4 1/2"X4 1/2" (3)
- DOOR STOP- FLOOR MOUNTED-DOME; ROCKWOOD 440, 626 FINISH **SET 02**

- LOCKSET PASSAGE- MARKS 195 SERIES, LEVER, 26D FINISH - FULL MORTISE BUTT STAINLESS HINGES, STANLEY CB1900 4 1/2"X4 1/2" (3) - DOOR STOP- FLOOR MOUNTED-DOME; ROCKWOOD 440, 626 FINISH

SET 03

- CARD READER @ EXTERIOR ONLY
- EXIT DEVICE PANIC HARDWARE SARGENT 8888 WITH 8ETL, 26 FINISH
- SHALL BE PUSH-PAD TYPE TO EGRESS DIRECTION AND NOT REQUIRED MORE THAN ONE OPERATION
- TO UNLATCH
- WEATHER STRIPPING - SURFACE CLOSER- LCN 4040XP, 689 FINISH @ PUSH SIDE
- DOOR SWEEP, ZERO 539AA, W1 - DOOR STOP, ZERO 475AA, Y1
- DOOR STOP- FLOOR MOUNTED-DOME; ROCKWOOD 440, 626 FINISH @ EXTERIOR
- THRESHOLD, ZERO 566A SERIES METAL, TYPE 1 - (1) 12" KICKPLATE - IVES 8400, US26D FINISH @ PUSH SIDE
- KEYED CYLINDER @ INTERIOR AND EXTERIOR

SET 04

- LOCKSET PASSAGE- MARKS 195 SERIES, LEVER, 26D FINISH - FULL MORTISE BUTT STAINLESS HINGES, STANLEY CB1900 4 1/2"X4 1/2" (3) - DOOR STOP- FLOOR MOUNTED-DOME; ROCKWOOD 440, 626 FINISH - SURFACE CLOSER- LCN 4040XP, 689 FINISH @ PUSH SIDE
- DOOR LOUVER, ZERO 20X20" CECO
- (2) 12" KICKPLATE STAINLESS IVES 8400, US32D FINISH - SILENCERS - ROCKWOOD 608 GRAY (METAL DOORS ONLY)

SET 05

- LOCKSET SINGLE DUMMY HANDLE- MARKS 195 SERIES, LEVER, 26D FINISH @ PULL SIDE ONLY
- STAINLESS HINGES, STANLEY FOR BI-FOLD DOORS (3) EACH DOOR
- HEAVY DUTY TOP TRACK KIT FOR BI-FOLD DOORS, CUT TO FIT

SET 06

- LOCKSET PASSAGE- MARKS 195 SERIES, LEVER, 26D FINISH - DOOR STOP- FLOOR MOUNTED-DOME; ROCKWOOD 440, 626 FINISH

SHEET NOTES


- 1. DOOR TO HAVE 1" UNDERCUT. 2. PAINT ALL DOOR FRAMES EXISTING AND NEW COLOR P-3, REFER TO FINISH SCHEDULE ON SHEET A05.01.
- 3. PAINT EXISTING DOORS COLOR P-3, REFER TO FINISH
- SCHEDULE ON SHEET A05.01. 4. NEW DOORS COLOR SHALL BE STAINED, COLOR: SHERWIN
- WILLIAMS RANCH OAK, SW3125-O. 5. NEW DOOR SHALL BE PAINTED COLOR P-3. REFER TO FINISH SCHEDULE ON SHEET A05.01.
- 6. SPLIT FINISH DOOR SHALL BE PAINTED TO MATCH EXISTING ON EXTERIOR SIDE. THE INTERIOR SIDE OF DOOR SHALL BE PAINTED COLOR P-3. REFER TO FINISH
- SCHEDULE ON SHEET A05.01. WOOD CASING TO MATCH EXISTING.
- 8. REPLACE EXISTING KNOB DOOR HANDLES WITH LEVER
- SPECS: MARKS 195 SERIES. GC TO COORDINATE ANY
- KEYED LOCKSETS WITH OC FACILITIES. 9. INSTALL KICKDOWN DOOR HOLDER
- uni



- A COORDINATE ALL HARDWARE WITH DOOR SWING. CLOSERS TO BE ON INTERIOR OF ROOMS. DOOR STOP SHALL BE FLOOR MOUNTED AND INSTALLED ON INTERIOR OF ROOMS, U.N.O.
- B ALL HARDWARE FINISH TO MATCH EXISTING, U.N.O. WHERE MULTIPLE FINISHES EXIST, NOTIFY ARCHITECT IMMEDIATELY AND CONFIRM FINAL FINISH SELECTION BEFORE ORDERING.
- C ALL EXISTING DOORS AND FRAMES TO BE PAINTED, REFER TO FINISH SCHEDULE FOR COLOR. D ALL DOOR HARDWARE SHALL BE LEVER TYPE MEETING
- REQUIREMENTS OF ADA.
- CONTRACTOR SHALL COORDINATE ALL HARDWARE KEYING WITH THE OWNER AND OBTAIN OWNER'S APPROVAL PRIOR TO PLACING HARDWARE ORDER.
- F REFER TO SPECIFICATIONS FOR HARDWARE FINISH. G AT DOORS AND SIDELIGHTS WHERE GLASS IS USED THE GLASS SHALL BE SAFETY GLAZED (TEMPERED) AND TESTED IN ACCORDANCE WITH ANSI-Z-97.
- H PANIC HARDWARE SHALL BE PUSH-PAD TYPE TO EGRESS DIRECTION AND SHALL NOT REQUIRE MORE THAN ONE OPERATION TO UNLATCH. ALL EGRESS DOORS SHALL BE OPERABLE WITHOUT THE USE OF A KEY OR SPECIAL KNOWLEDGE.
- ALL DOORS TO HAVE MINIMUM 32" CLEAR OPENING WIDTH IN ACCORDANCE W/ SECTION 1008.1.1 OF THE IBC. J PROVIDE EACH ASSEMBLY WITH ALL SUPPORTS,
- EQUIPMENT, AND MECHANISMS NECESSARY FOR A COMPLETE OPERABLE INSTALLATION. INSTALL WEATHERSTRIPPING AFTER DOOR IS INSTALLED AND ADJUSTED.
- K PROVIDE ALL OTHER MATERIALS SUCH AS BRACKETS FASTENERS, BACK-UP PLATES AND OTHER ACCESSORIES NOT SPECIFICALLY DESCRIBED BUT REQUIRED FOR A COMPLETE OPERABLE FINISH HARDWARE INSTALLATION.
- L EXTERIOR DOOR THRESHOLD SHALL NOT EXCEED ONE HALF INCHES (1/2") IN HEIGHT AND SHALL HAVE A 1:2 BEVEL.
- M ALL DOOR HARDWARE, AS APPLICABLE, SHALL COMPLY WITH THE REQUIREMENTS OF NFPA 101, SECTION 7.2.1.5.4.
- **ARCHITECTURAL DESIGN COLLABORATIVE** 945 N. PENNSYLVANIA AVENUE WINTER PARK, FLORIDA 32789 OFFICE: (407) 629-1188 FAX: (407) 388-1220 WWW. ADCINTERNATIONAL.NET AA-C001315 STATE OF FLORIDA MARIA FERREIRA AR-95752 Architect • Seal/Signature Project Documents for: FLORIDA Proiect **GREAT OAKS VILLAGE WITTENSTEIN COTTAGE** ADA UPGRADES AND RENOVATIONS 1784 E. MICHIGAN STREET ORLANDO, FL 32806 Issue Date & Issue Description Drawn By Checked By 60% CD SET 07.27.16 JS KA 09.15.16 90% CD SET JS KA 12.02.16 PERMIT/BID SET JS KA 01.25.17 PERMIT COMMENTS JS KA GC / CLIENT COORD. JS 02/24/2017 KA 02.27.17 CONST. ISSUE SET JS KA **Client Information** ORANGE COUNTY CAPITAL PROJECTS DIVISION 400 E SOUTH STREET 5th FLOOR ORLANDO, FL 32801 Project Number Issue Date 15253 02/27/2017 Drawn By Project Status CONSTRUCTION ISSUE SET Checked By Scale

File Name X:\dwgs\15253 OC Wittenstein House ADA\CAD\SHEETS\ A00.30 DOOR, FRAME & HARDWARE SCHEDULES.dwg

Consultant • Seal/Signature

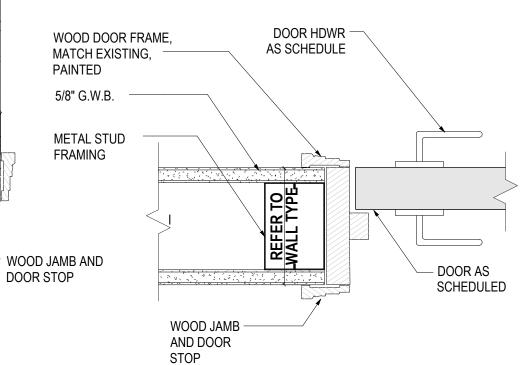

WOOD DOOR JAMB


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Sheet Title:

DOOR, FRAME & HARDWARE SCHEDULES

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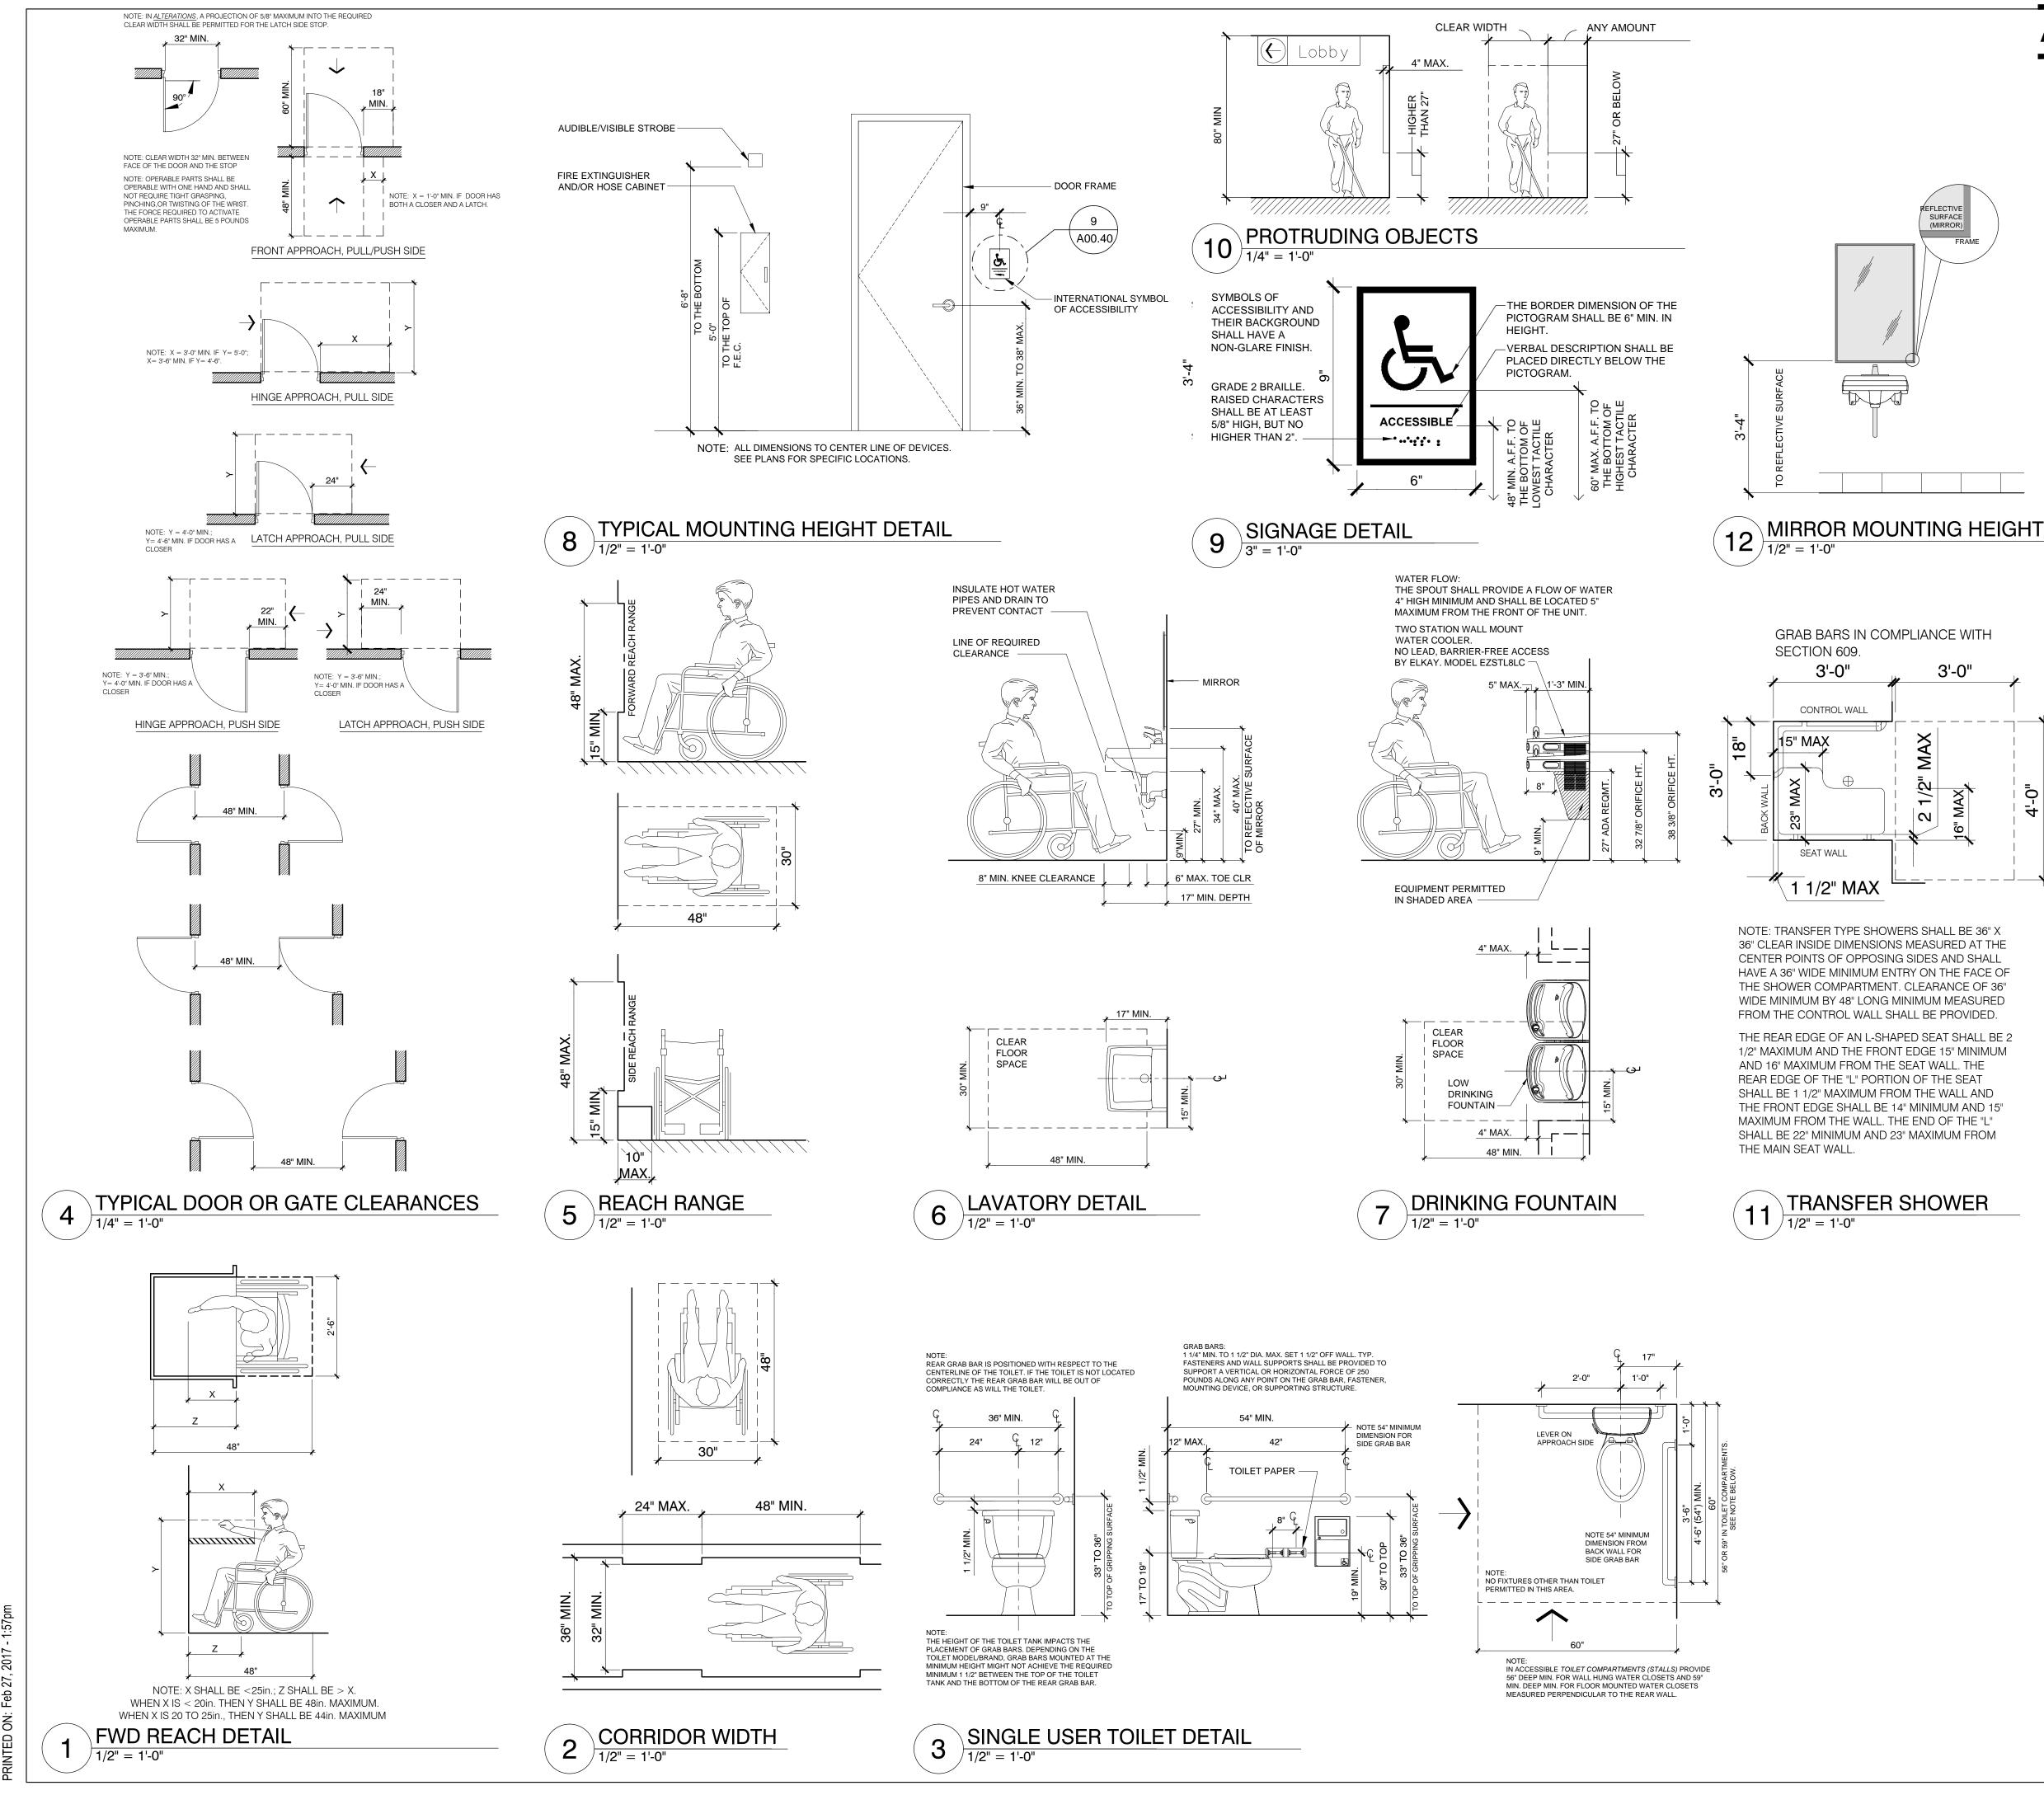


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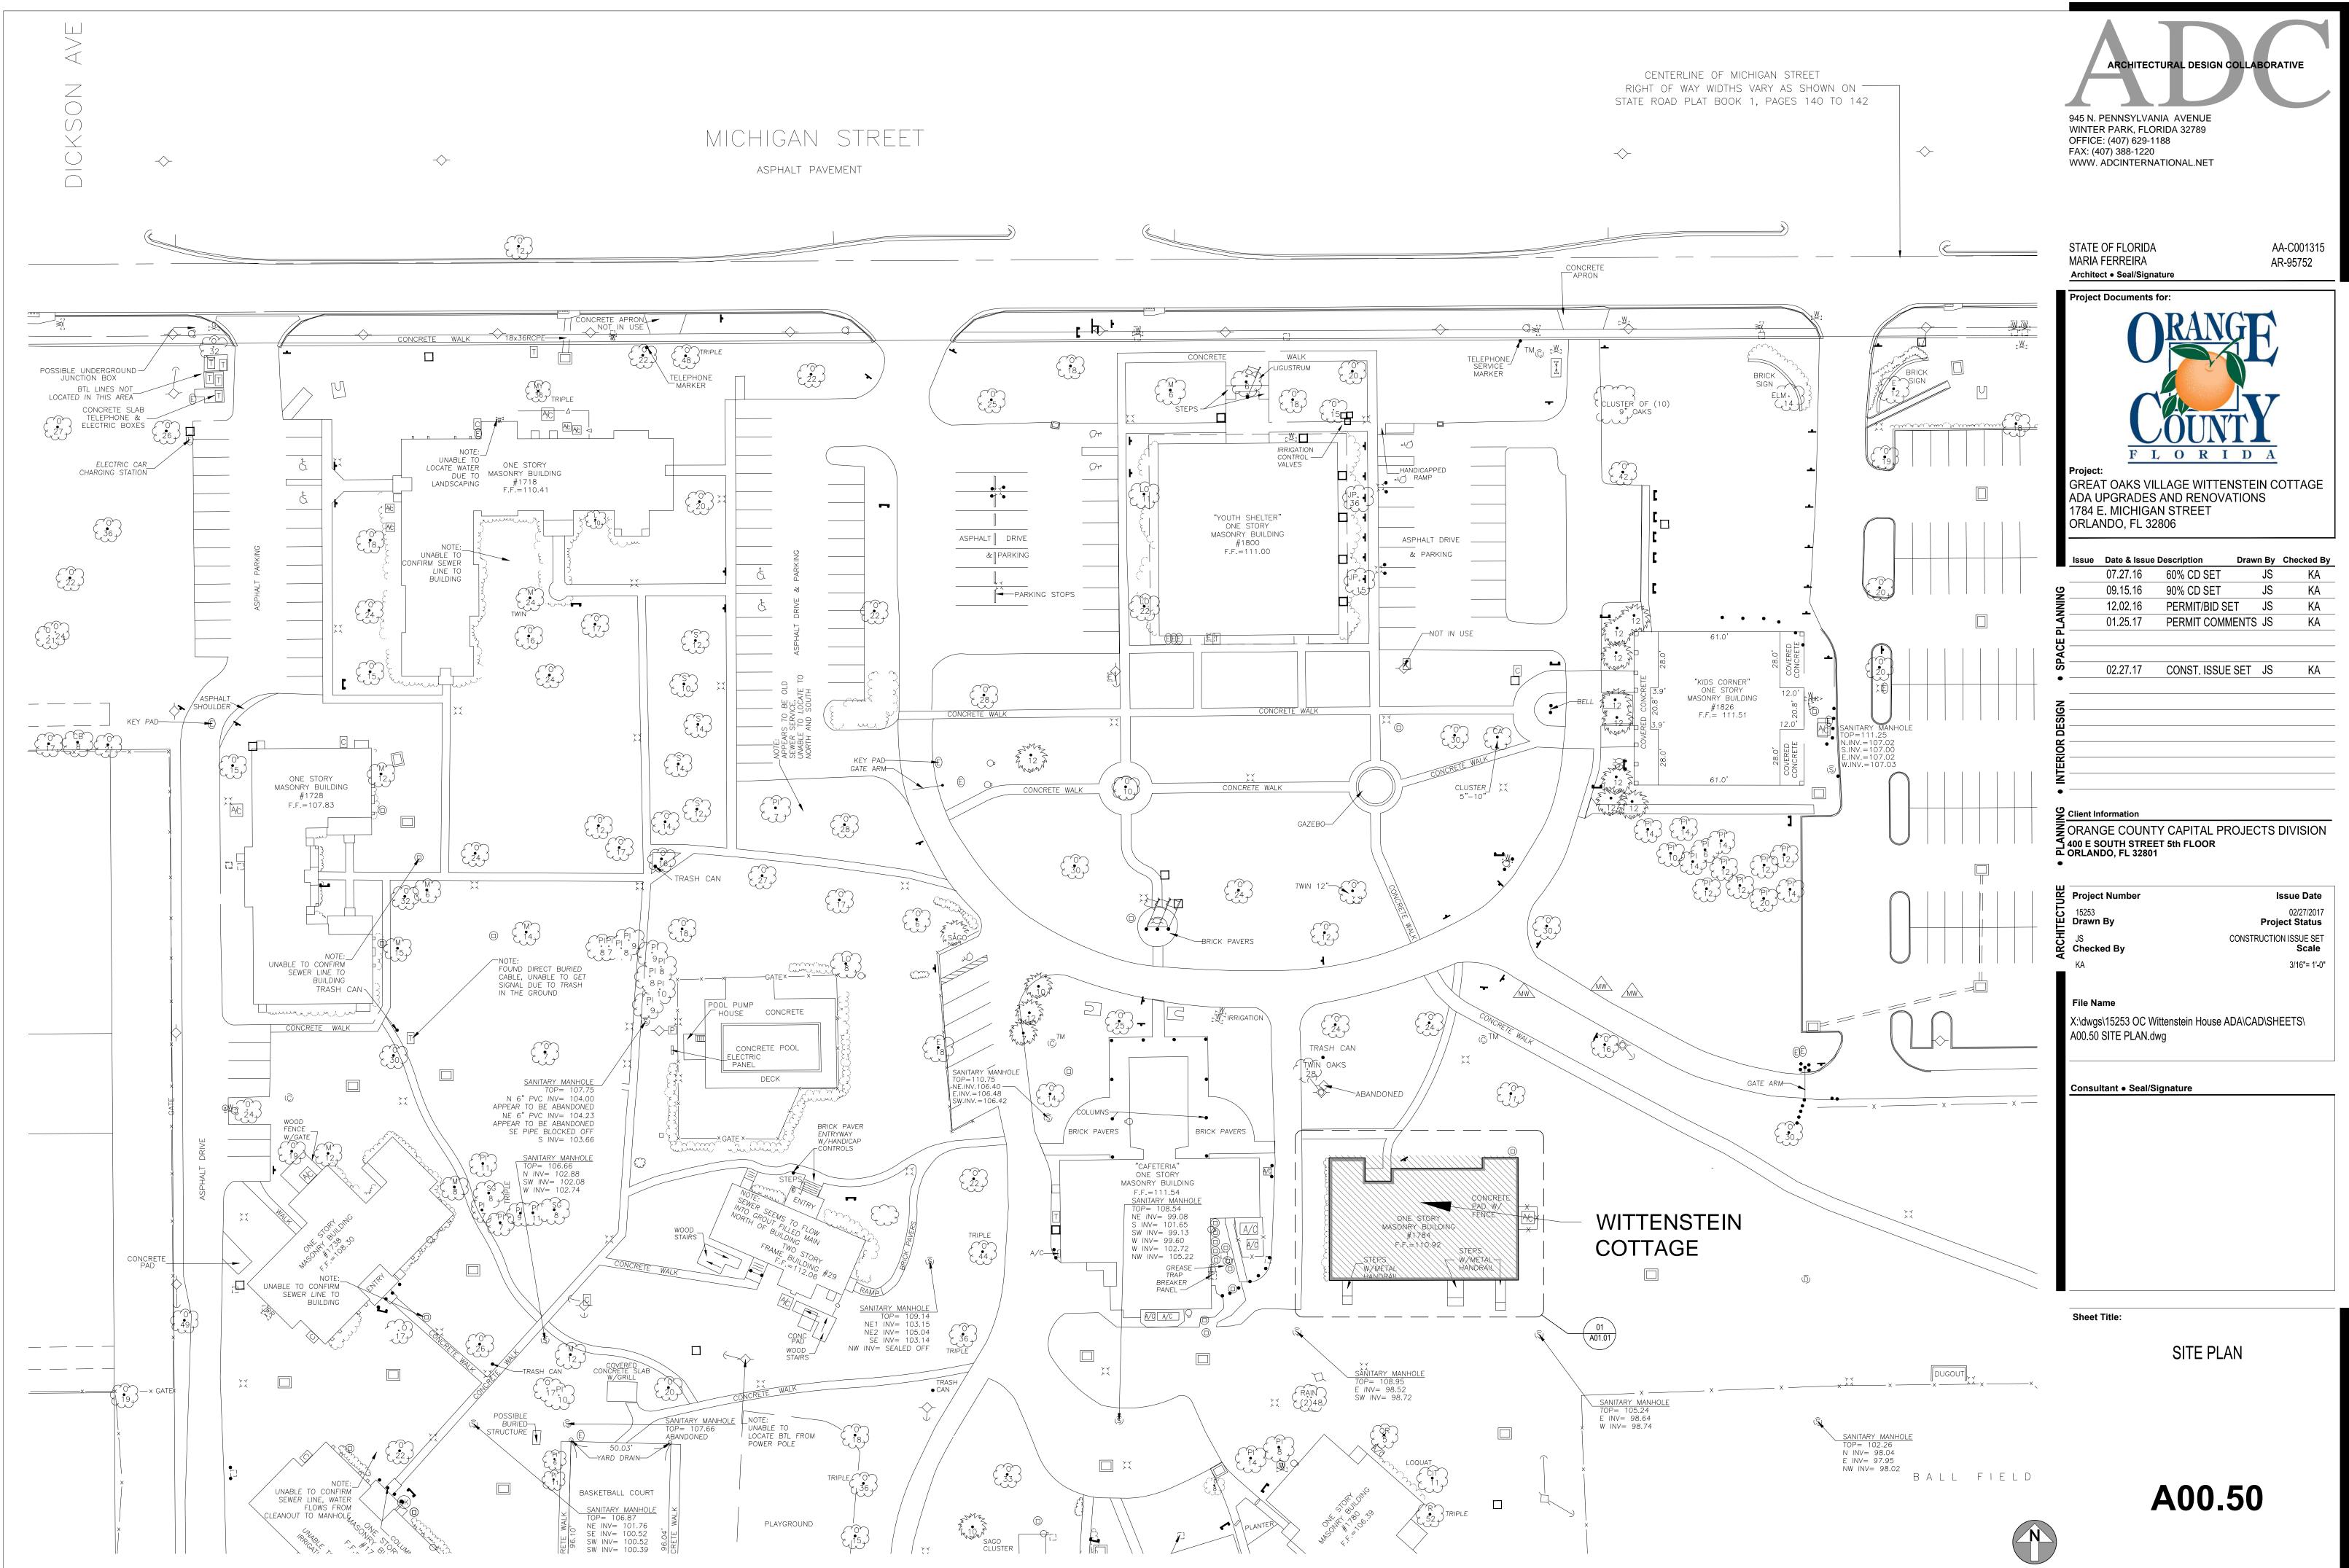
	ARCHITECTURAL DESIGN CO	LABORATIVE
	945 N. PENNSYLVANIA AVENUE WINTER BARK EL OPIDA 32789	
OF ADJACENT FRAME WE DOOR HEAD < 12" WE DOOR HEAD < 12" D STRIKE SIDE D STRIKE SIDE STRIKE SIDE D STRIKE SIDE STRIKE SIDE STRIKE SIDE STRIKE SIDE STRIKE	WINTER PARK, FLORIDA 32789 OFFICE: (407) 629-1188 FAX: (407) 388-1220	1
E DOOR I BREATER BREATER	WWW. ADCINTERNATIONAL.NET	
ABOVE 2" OR GR		
	STATE OF FLORIDA MARIA FERREIRA Architect • Seal/Signature	AA-C001315 AR-95752
AliGN WITH TOP OF ADJACENT FRAME AliGN WITH TOP OF ADJACENT FRAME MOUNT ON STRIKE SIDE ALIGN MOUNT ON STRIKE SIDE ALIGN TON STRIKE S	Architect Seal/Signature Project Documents for:	'
	CRANC	
LOW LEVEL EXIT SIGN WALL-MOUNTED (WHERE OCCURS) AT EXIT SIGN AT		
EXIT DOOR EXIT DOOR		\mathbf{N}
	Project: GREAT OAKS VILLAGE WITTENS	
	ADA UPGRADES AND RENOVATI 1784 E. MICHIGAN STREET	
	ORLANDO, FL 32806	
	Issue Date & Issue Description D 07.27.16 60% CD SET	Drawn By Checked By JS KA
		JS KA
VARIES 1 15/16"	01.25.17 PERMIT COMMEN	
	В ————————————————————————————————————	
- HOLLOW METAL FRAME BEYOND	•	SET JS KA
INSULATED HOLLOW METAL DOOR PER SCHEDULE	DESIGN	
SWEEP AS SPECIFIED		
CONT. MTL. SILL PAN FLASHING	Client Information	
	ORANGE COUNTY CAPITAL PRO	JECTS DIVISION
	● ORLANDO, FL 32801 ●	
EXTERIOR	Project Number 15253	Issue Date 02/27/2017
	Drawn By	Project Status
	Checked By KA	Scale VARIES
L. @ EXT. HM. FRAME 1	File Name	
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	A00.31 Typical Standards.dwg	
	Consultant • Seal/Signature	
SHEET NOTES		
1. REFER TO SHEET A00.40 FOR ACCESSIBILITY DETAILS.		
	Sheet Title:	
	TYPICAL STAND	JARDS


A00.31

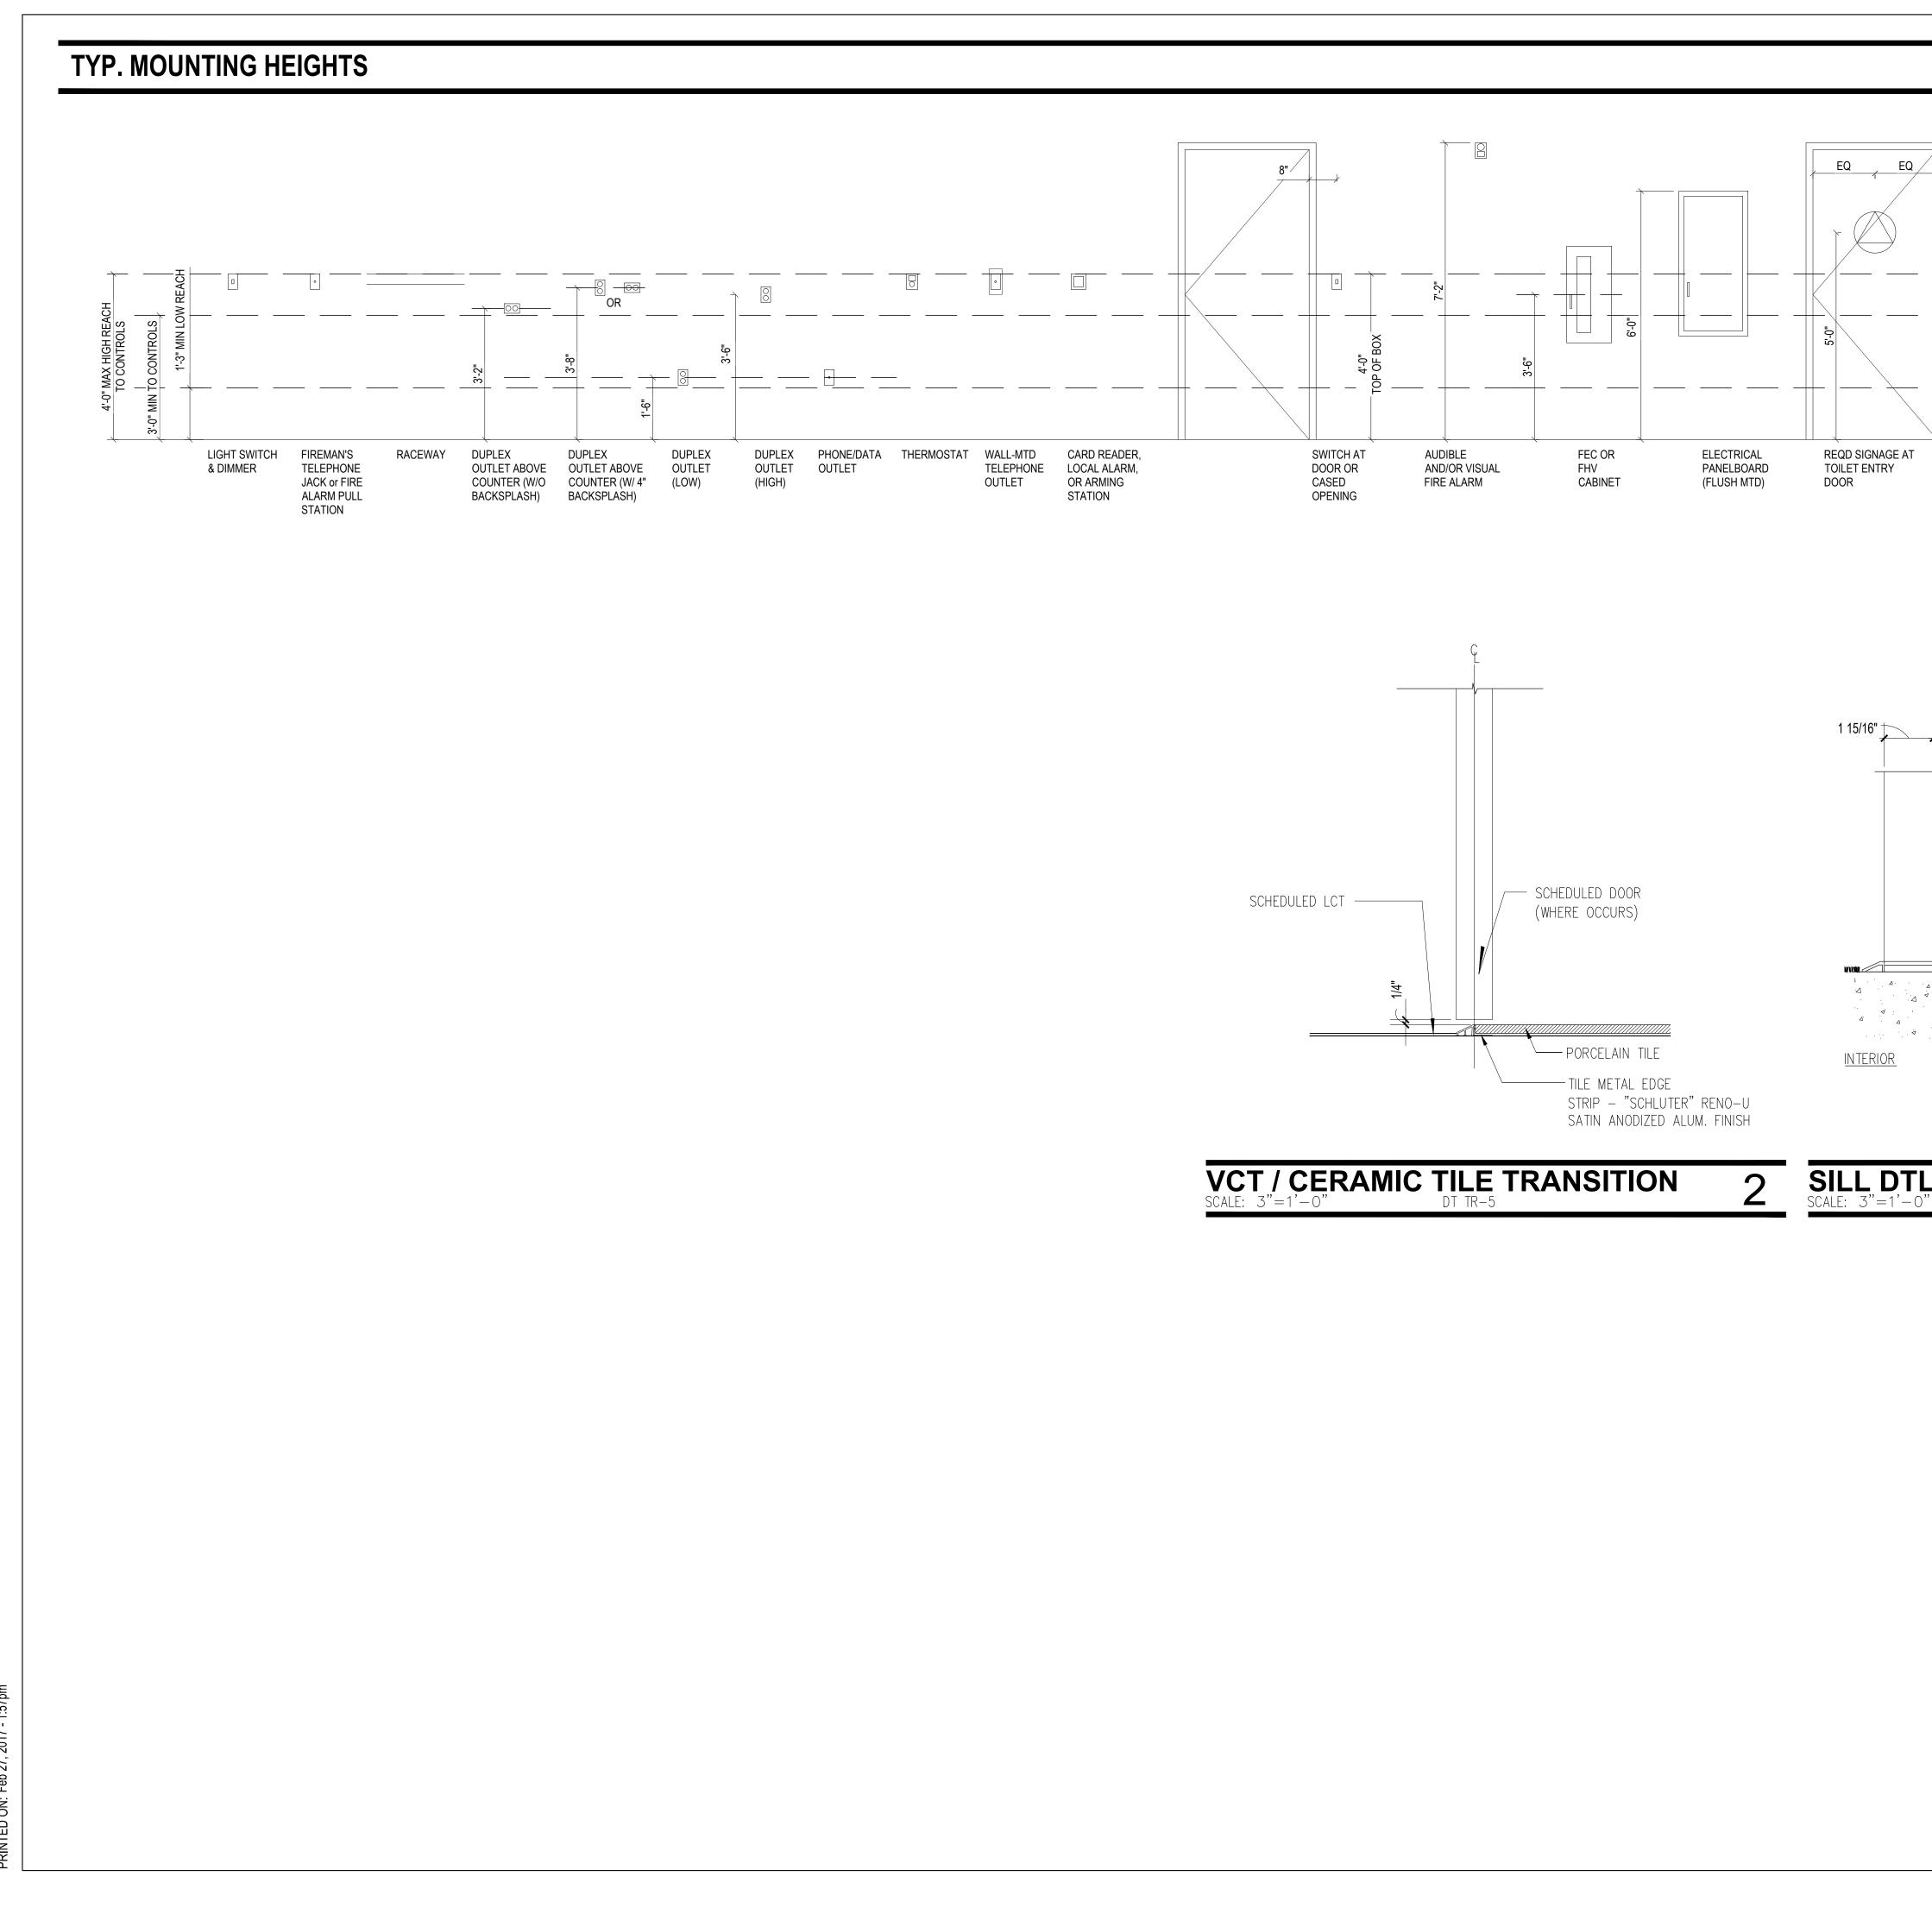N



	THE WALLS AND FLOORS OF TOILET, BATHING AND SHOWER ROOMS SHALL HAVE A SMOOTH, HARD, NONABSORBENT SURFACE. THE INTERSECTIONS OF SUCH FLOORS WITH WALLS SHALL HAVE A	ARCHITECTURAL DESI	GN COLLABORATIVE
	SMOOTH, HARD, NONABSORBENT VERTICAL BASE THAT EXTENDS UPWARD ONTO THE WALLS AT LEAST 4 INCHES. WALLS AND PARTITIONS WITHIN 2 FEET OR URINALS AND WATER CLOSETS SHALL HAVE A SMOOTH, HARD, NONABSORBENT SURFACE, TO A HEIGHT OF 4 FEET ABOVE THE FLOOR, AND EXCEPT FOR STRUCTURAL ELEMENTS, THE MATERIALS USED IN SUCH WALLS SHALL BE OF A TYPE THAT IS NOT ADVERSELY AFFECTED BY MOISTURE. ACCESSORIES SUCH AS GRAB BARS, TOWEL BARS, PAPER DISPENSERS AND SOAP DISHES, PROVIDED ON OR WITHIN WALLS, SHALL BE INSTALLED AND SEALED TO PROTECT STRUCTURAL ELEMENTS FROM MOISTURE.	945 N. PENNSYLVANIA AVENUE WINTER PARK, FLORIDA 32789 OFFICE: (407) 629-1188 FAX: (407) 388-1220 WWW. ADCINTERNATIONAL.NET	
	2. ALL DIMENSIONS ARE ABOVE FINISHED FLOOR (A.F.F.). DIMENSIONS THAT ARE NOT STATED AS "MAXIMUM" OR "MINIMUM" ARE ABSOLUTE.		
	3. ALL DIMENSIONS ARE TO FINISH SURFACES AND SHALL BE CONSIDERED "CLEAR" DIMENSIONS. THE ACCESSIBLE 5 FOOT TURNING CIRCLE IS A "CLEAR" DIMENSION CONTINUOUS FROM THE FLOOR AND UP THE WALLS. THE FINISHED BASE AND/OR TRIM MATERIALS SHALL NOT DIMINISH THE REQUIRED 5 FOOT DIMENSION AT THE FLOOR OR THE WALLS OF THE ROOM. GC SHALL LAY OUT THE WORK TO ACCOMMODATE THE THICKNESS OF MATERIALS AND ALLOW FOR VARIATIONS IN EXISTING AND NEW SURFACES AND MATERIALS TO PROVIDE THE REQUIRED "CLEAR"	STATE OF FLORIDA MARIA FERREIRA Architect • Seal/Signature Project Documents for:	AA-C001315 AR-95752
	DIMENSIONS. 4. IF TOILETS ARE UPGRADED FOR ACCESSIBILITY COMPLIANCE REFER TO SHEET A08.01 & .02 FOR ADDITIONAL ACCESSIBILITY DETAILS, NOTES AND THE ACCESSORIES AND FIXTURE	ORAI	YGF
	SCHEDULES. 5. DETAILS SUPERSEDE PLANS. IN THE EVENT OF CONFLICTING INFORMATION GC TO CONTACT ARCHITECT IMMEDIATELY.		
	 FLOOR SURFACES SHALL BE SLIP-RESISTANT. EVERY CORRIDOR AND AISLE SERVING AN OCCUPANT LOAD OF 10 OR MORE SHALL BE NOT LESS THAN 44" IN WIDTH. 		V
— AHT	8. ABRUPT CHANGES IN LEVEL ALONG ANY ACCESSIBLE ROUTE SHALL NOT EXCEED 1/2" IN HEIGHT. LEVEL CHANGES NOT EXCEEDING 1/4" MAY BE VERTICAL. BEVEL OTHERS WITH A SLOPE NO GREATER THAN 1:2	F L O R Project:	I D A
<u>41 </u>	9. LATCHING AND LOCKING DOORS THAT ARE HAND ACTIVATED AND WHICH ARE IN A PATH OF TRAVEL SHALL BE OPERABLE WITH A SINGLE EFFORT BY LEVER TYPE HARDWARE, PANIC BARS, PUSH-PULL ACTIVATING BARS, OR OTHER HARDWARE DESIGNED TO PROVIDE PASSAGE WITHOUT REQUIRING THE ABILITY TO GRASP THE OPENING HARDWARE. MOUNT DOOR OPENING HARDWARE BETWEEN 30" AND 44" ABOVE FLOOR FINISH.	GREAT OAKS VILLAGE WIT ADA UPGRADES AND RENO 1784 E. MICHIGAN STREET ORLANDO, FL 32806	
	10. MAXIMUM PULL OR PUSH EFFORT TO OPERATE DOORS SHALL NOT EXCEED 8.5 POUNDS FOR EXTERIOR DOORS AND 5 POUNDS FOR INTERIOR DOORS, MEASURED AT RIGHT ANGLES TO HINGED DOORS AND AT CENTER PLANE OF SLIDING OR FOLDING DOORS. CORRESPONDING DEVICES OR AUTOMATIC DOOR OPERATORS MAY BE UTILIZED TO MEET THE ABOVE STANDARDS. MAXIMUM EFFORT TO OPERATE REQUIRED FIRE DOORS MAY BE INCREASED NOT TO EXCEED 15 POUNDS.	Issue Date & Issue Description 07.27.16 60% CD SI 09.15.16 90% CD SI 12.02.16 PERMIT/B 01.25.17 PERMIT C	et js ka
	11. THE BOTTOM 10" OF ALL DOORS (EXCEPT SLIDING AND AUTOMATIC) SHALL HAVE A SMOOTH UNINTERRUPTED SURFACE TO ALLOW THE DOOR TO BE OPENED BY A WHEELCHAIR FOOTREST WITHOUT CREATING A TRAP OR HAZARDOUS CONDITION. PROVIDE A 10" HIGH SMOOTH PANEL ON THE PUSH SIDE OF NARROW FRAME DOORS.	• 02.27.17 CONST. IS	SUE SET JS KA
4'-0"	12. EVERY REQUIRED ENTRANCE OR PASSAGE DOORWAY SHALL BE NOT LESS THAN 3' IN WIDTH AND NOT LESS THAN 6'-8" IN HEIGHT. DOORS SHALL BE CAPABLE OF OPENING AT LEAST 90 DEGREES AND SHALL BE SO MOUNTED THAN THE	DESIGN	
	CLEAR WIDTH OF THE DOORWAY IS NOT LESS THAN 32". 13. WHERE A PAIR OF DOORS IS UTILIZED, AT LEAST ONE OF THE DOORS SHALL PROVIDE A CLEAR, UNOBSTRUCTED OPENING WIDTH OF 32" WITH THE LEAF POSITIONED AT AN ANGLE OF 90 DEGREES FROM ITS CLOSED POSITION.		
	14. IDENTIFY ACCESSIBLE ENTRANCES WITH AT LEAST ONE STANDARD SIGN AND WITH ADDITIONAL DIRECTIONAL SIGNS, AS REQUIRED, VISIBLE FROM APPROACHING PEDESTRIAN	•	
	WAYS. 15. THE FLOOR OR LANDING ON EACH SIDE OF AN ENTRANCE OR PASSAGE DOOR SHALL BE LEVEL AND CLEAR. THE LEVEL AND CLEAR AREA SHALL HAVE A LENGTH IN THE DIRECTION OF DOOR SWING OF AT LEAST 60" AND THE LENGTH OPPOSITE THE DIRECTION OF DOOR SWING OF 44" AS MEASURED AT RIGHT ANGLES TO THE PLANE OF THE DOOR IN ITS CLOSED POSITION. (REFER TO A.D.A. DRAWING FOR IN ITS CLOSED POSITION. (REFER TO A.D.A. DRAWING FOR	Client Information ORANGE COUNTY CAPITAL 400 E SOUTH STREET 5th FLOOI ORLANDO, FL 32801 •	
	CLEARANCES BASED ON DIFFERENT APPROACHES) 16. FLOORS OR LANDINGS SHALL BE NOT MORE THAN 1/2" LOWER THAN THE THRESHOLD OF THE DOORWAY. CHANGE IN LEVEL BETWEEN 1/4" AND 1/2" SHALL BE BEVELED WITH A	Project Number 15253 Drawn By	Issue Date 02/27/2017 Project Status
	SLOPE NO GREATER THAN 1:2.		CONSTRUCTION ISSUE SET
	17. TO ALERT THE VISUALLY IMPAIRED, MARK THE UPPER APPROACH AND THE LOWER TREAD OF EACH INTERIOR STAIR WITH A STRIP OF CLEARLY CONTRASTING COLOR AT LEAST 2" WIDE, PLACED PARALLEL TO AND NOT MORE THAN 1" FROM THE NOSE OF THE STEP OR LANDING. THE STRIP SHALL BE OF A MATERIAL THAT IS SLIP RESISTANT AS THE OTHER TREADS OF THE STAID	KA	Scale VARIES
	APPROACH AND THE LOWER TREAD OF EACH INTERIOR STAIR WITH A STRIP OF CLEARLY CONTRASTING COLOR AT LEAST 2" WIDE, PLACED PARALLEL TO AND NOT MORE THAN 1" FROM THE NOSE OF THE STEP OR LANDING. THE STRIP	α ΄	VARIES
	 APPROACH AND THE LOWER TREAD OF EACH INTERIOR STAIR WITH A STRIP OF CLEARLY CONTRASTING COLOR AT LEAST 2" WIDE, PLACED PARALLEL TO AND NOT MORE THAN 1" FROM THE NOSE OF THE STEP OR LANDING. THE STRIP SHALL BE OF A MATERIAL THAT IS SLIP RESISTANT AS THE OTHER TREADS OF THE STAIR. 18. CENTER ELECTRICAL RECEPTACLE OUTLETS NOT LESS THAN 15" ABOVE THE FLOOR OR WORKING PLATFORM. 19. SANITARY FACILITIES LOCATED ON AN ACCESSIBLE FLOOR OF A BUILDING SHALL BE ACCESSIBLE TO THE PHYSICALLY 	 KA File Name X:\dwgs\15253 OC Wittenstein Hou 	VARIES
	 APPROACH AND THE LOWER TREAD OF EACH INTERIOR STAIR WITH A STRIP OF CLEARLY CONTRASTING COLOR AT LEAST 2" WIDE, PLACED PARALLEL TO AND NOT MORE THAN 1" FROM THE NOSE OF THE STEP OR LANDING. THE STRIP SHALL BE OF A MATERIAL THAT IS SLIP RESISTANT AS THE OTHER TREADS OF THE STAIR. 18. CENTER ELECTRICAL RECEPTACLE OUTLETS NOT LESS THAN 15" ABOVE THE FLOOR OR WORKING PLATFORM. 19. SANITARY FACILITIES LOCATED ON AN ACCESSIBLE FLOOR OF A BUILDING SHALL BE ACCESSIBLE TO THE PHYSICALLY HANDICAPPED. 20. ENTRY TO SANITARY FACILITIES: A. 44" CLEAR AISLES OR CORRIDORS WHERE OCCUPANT LOAD IS 10 OR MORE. B. DOORWAYS TO HAVE A 32" CLEAR OPENING. C. ON APPROACH SIDE, PROVIDE A 60" CLEAR LEVEL SPACE WHEN DOOR SWINGS TOWARD APPROACH AND 44" SPACE WHEN DOOR SWINGS AWAY FROM APPROACH. REFER TO ADA DRAWING FOR 	File Name X:\dwgs\15253 OC Wittenstein Hou A00.40 ACCESSIBILITY INFO AL.0	VARIES
	 APPROACH AND THE LOWER TREAD OF EACH INTERIOR STAIR WITH A STRIP OF CLEARLY CONTRASTING COLOR AT LEAST 2" WIDE, PLACED PARALLEL TO AND NOT MORE THAN 1" FROM THE NOSE OF THE STEP OR LANDING. THE STRIP SHALL BE OF A MATERIAL THAT IS SLIP RESISTANT AS THE OTHER TREADS OF THE STAIR. 18. CENTER ELECTRICAL RECEPTACLE OUTLETS NOT LESS THAN 15" ABOVE THE FLOOR OR WORKING PLATFORM. 19. SANITARY FACILITIES LOCATED ON AN ACCESSIBLE FLOOR OF A BUILDING SHALL BE ACCESSIBLE TO THE PHYSICALLY HANDICAPPED. 20. ENTRY TO SANITARY FACILITIES: A. 44" CLEAR AISLES OR CORRIDORS WHERE OCCUPANT LOAD IS 10 OR MORE. B. DOORWAYS TO HAVE A 32" CLEAR OPENING. C. ON APPROACH SIDE, PROVIDE A 60" CLEAR LEVEL SPACE WHEN DOOR SWINGS TOWARD APPROACH AND 44" SPACE WHEN DOOR SWINGS AWAY FROM APPROACH. REFER TO ADA DRAWING FOR CLEARANCES BASED ON DIFFERENT APPROACHES. 21. THE AMERICANS WITH DISABILITIES ACT (A.D.A.) PROVIDES THAT ALTERATIONS TO A FACILITY AUST BE MADE IN SUCH A MANNER THAT, TO THE MAXIMUM EXTENT FEASIBLE, THE ALTERED PORTIONS OF THE FACILITY ARE READILY ACCESSIBLE TO INDIVIDUALS WITH DISABILITIES. GENERAL CONTRACTOR ACKNOWLEDGES THAT THE REQUIREMENTS OF A.D.A. WILL BE SUBJECT TO VARIOUS AND POSSIBLY CONTRADICTORY INTERPRETATIONS. THE ARCHITECT THEREFORE, WILL USE ITS BEST PROFESSIONAL EFFORTS TO INTERPRET A.D.A. REQUIREMENTS AND OTHER FEDERAL, STATE AND LOCAL LAWS, RULES, CODES, ORDINANCES AND REGULATIONS AS THEY APPLY TO THE PROJECT. THE ARCHITECT, HOWEVER, CANNOT AND DOES NOT WARRANT OR GUARANTEE THAT OWNER WILL COMPLY WITH ALL INTERPRETATIONS OF THE AND COLAL LAWS, RULES, CODES, ORDINANCES AND REGULATIONS AS THEY AND OR THE OTHER FEDERAL, STATE AND LOCAL LAWS, RULES, CODES, ORDINANCES AND REGULATIONS AS THEY 	File Name X:\dwgs\15253 OC Wittenstein Hou A00.40 ACCESSIBILITY INFO AL.0	se ADA\CAD\SHEETS\ lwg
	 APPROACH AND THE LOWER TREAD OF EACH INTERIOR STAIR WITH A STRIP OF CLEARLY CONTRASTING COLOR AT LEAST 2' WIDE, PLACED PARALLEL TO AND NOT MORE THAN 1' FROM THE NOSE OF THE STEP OR LANDING. THE STRIP SHALL BE OF A MATERIAL THAT IS SLIP RESISTANT AS THE OTHER TREADS OF THE STAIR. 18. CENTER ELECTRICAL RECEPTACLE OUTLETS NOT LESS THAN 15' ABOVE THE FLOOR OR WORKING PLATFORM. 19. SANITARY FACILITIES LOCATED ON AN ACCESSIBLE FLOOR OF A BUILDING SHALL BE ACCESSIBLE TO THE PHYSICALLY HANDICAPPED. 20. ENTRY TO SANITARY FACILITIES: A. 44' CLEAR AISLES OR CORRIDORS WHERE OCCUPANT LOAD IS 10 OR MORE. B. DOORWAYS TO HAVE A 32'' CLEAR OPENING. C. ON APPROACH SIDE, PROVIDE A 60' CLEAR LEVEL SPACE WHEN DOOR SWINGS TOWARD APPROACH AND 44'' SPACE WHEN DOOR SWINGS TOWARD APPROACH ES. 21. THE AMERICANS WITH DISABILITIES ACT (A.D.A.) PROVIDES THAT ALTERATIONS TO A FACILITY MUST BE MADE IN SUCH A MANNER THAT, TO THE MAXIMUM WE STENT FEASIBLE, THE ALTERED PORTIONS OF THE FACILITY ARE READILY ACCESSIBLE TO INDIVIDUALS WITH DISABILITIES. GENERAL CONTRACTOR ACKNOWLEDGES THAT THE REQUIREMENTS OF A.D.A. WILL BE SUBJECT TO VARIOUS AND POSSIBLY CONTRACTOR ACKNOWLEDGES THAT THE REQUIREMENTS OF A.D.A. WILL BE SUBJECT TO VARIOUS AND POSSIBLY CONTRACTORY INTERRETATIONS. THE ARCHITECT THERFORE, WILL USE ITS BEST PROFESSIONAL EFFORTS TO INTERPRET A.D.A. REQUIREMENTS AND OTHER FEDERAL, STATE AND LOCAL LAWS, RULES, CODES, ORDINANCES AND REGULATIONS AS THEY APPLY TO THE PROJECT. THE ARCHITECT, HOWEVER, CANNOT AND DOES NOT WARRANT OR GUARANTEE THAT OWNER WILL COMPLY WITH ALL INTERPRETATIONS OF THE A.D.A. REQUIREMENTS AND/ OR THE OTHER FEDERAL, STATE AND LOCAL LAWS, RULES, CODES, ORDINANCES AND REGULATIONS AS THEY APPLY TO THE PROJECT. 22. THE SCOPE OF WORK INDICATED ON THESE DRAWINGS IS FOR SPECIFIC ITEMS SELECTED DY OWNER FOR CUSTOMER ACCESS TO	 File Name X:\dwgs\15253 OC Wittenstein Hou A00.40 ACCESSIBILITY INFO AL. Consultant • Seal/Signature 	se ADA\CAD\SHEETS\ lwg



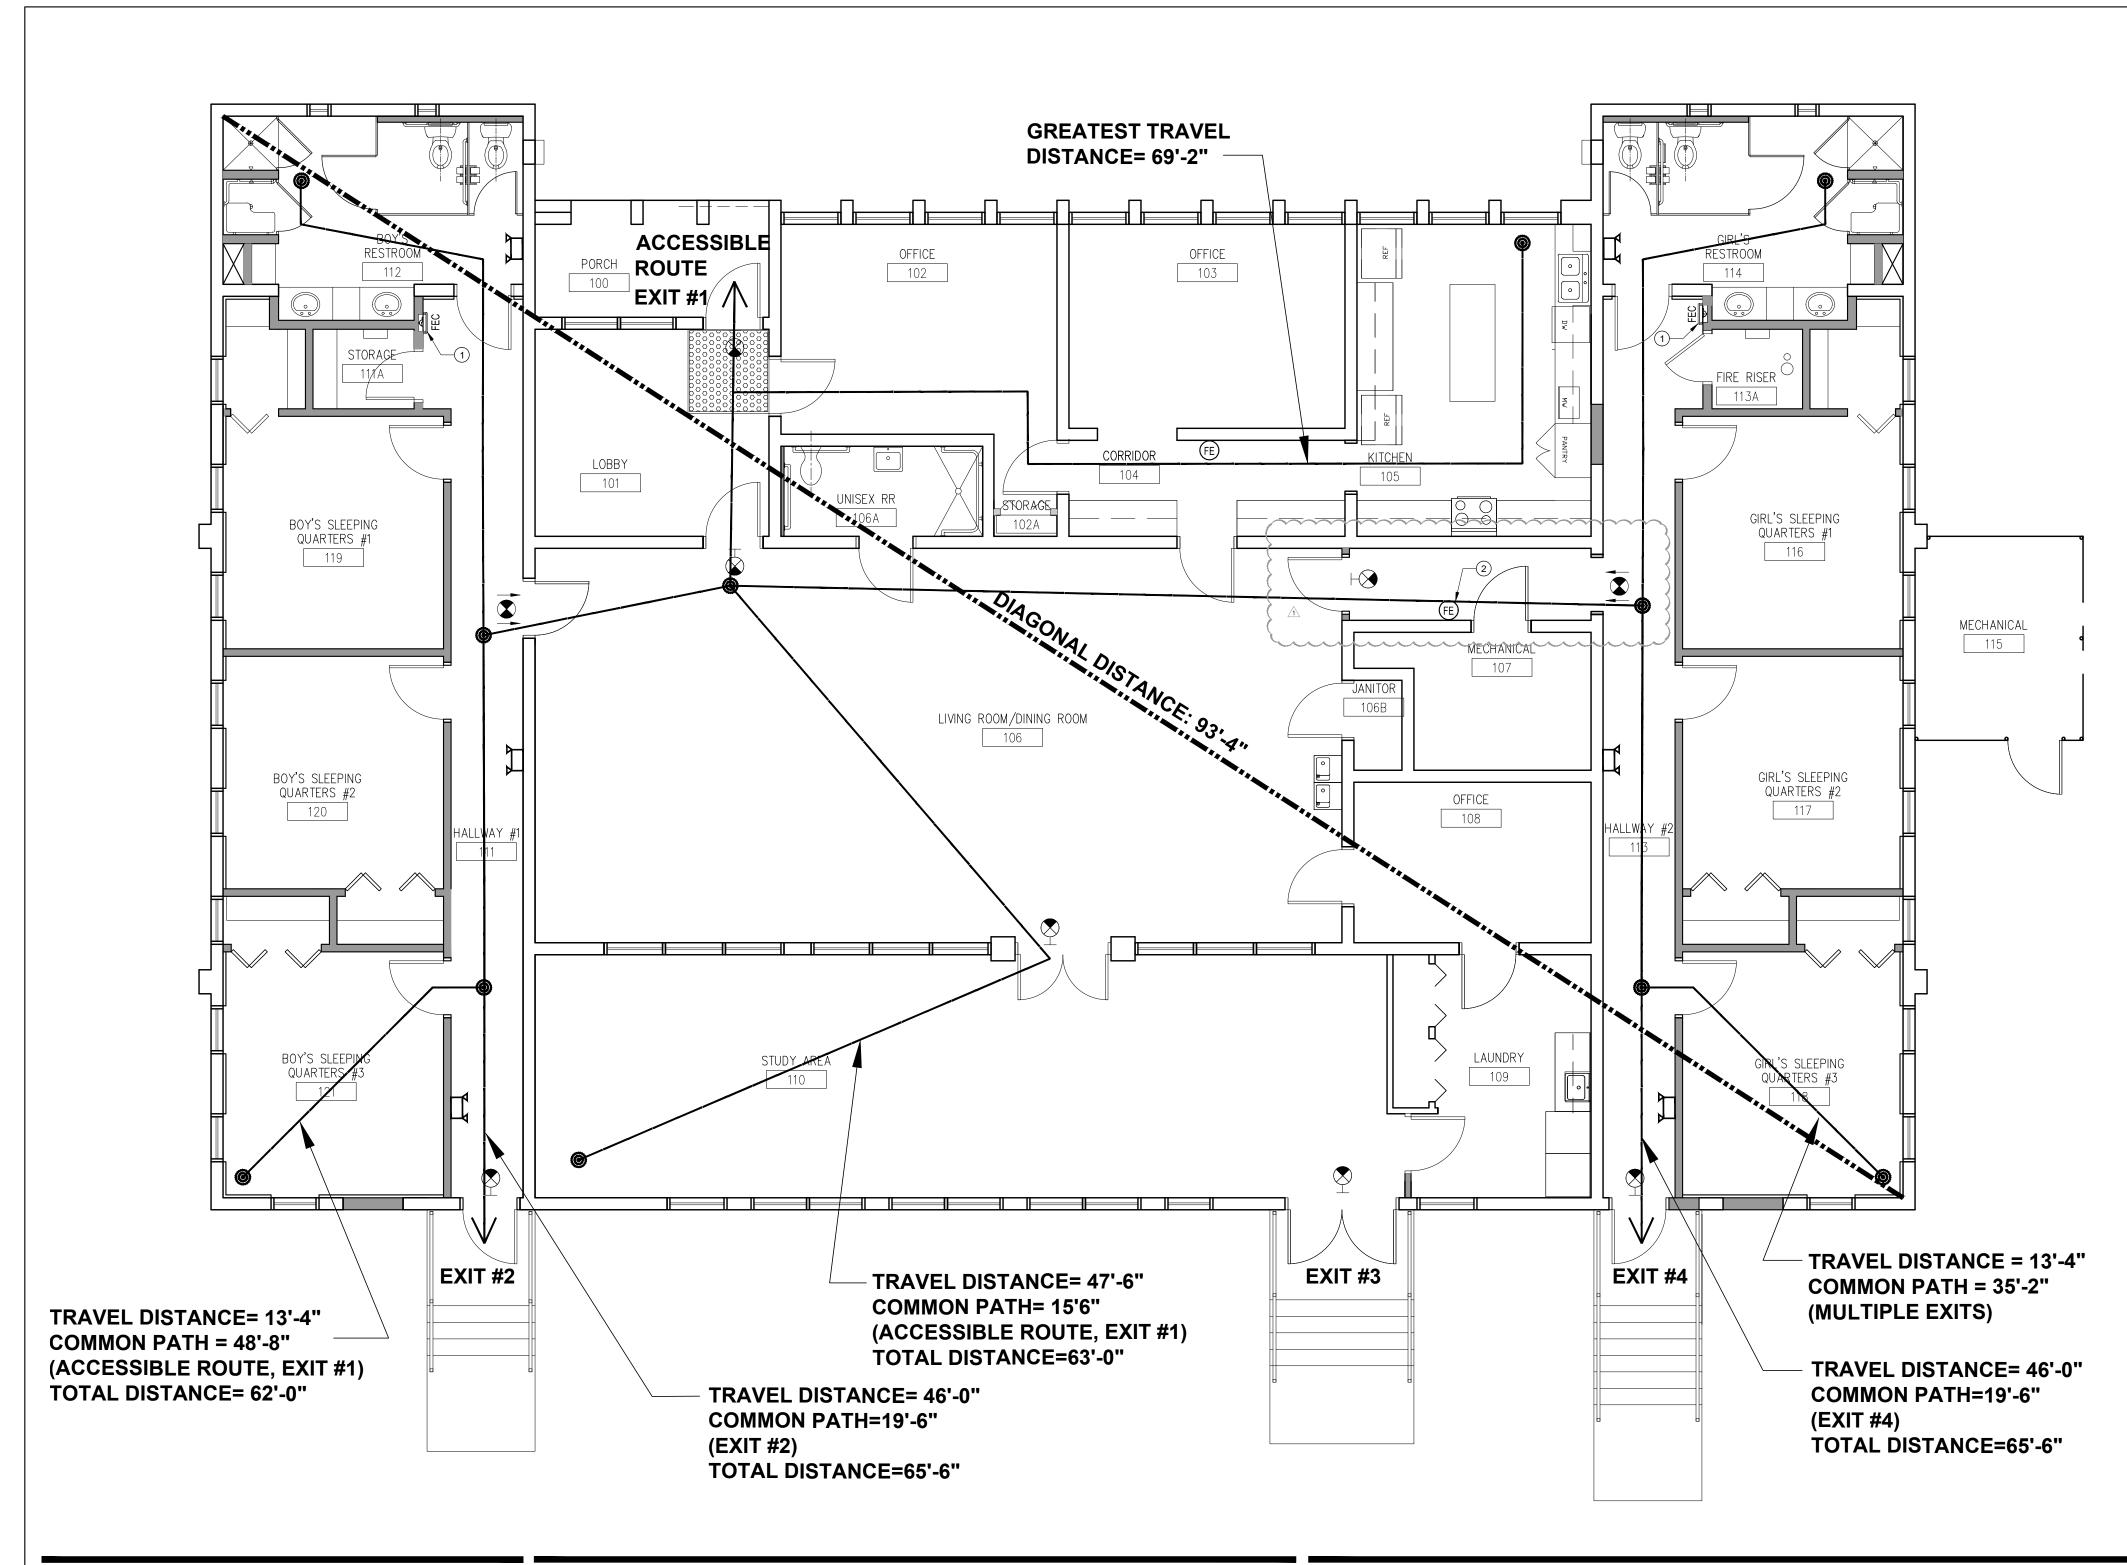

KEY NOTES

1 WALL RECESSED FIRE EXTINGUISHER CABINET

2 INSTALL WALL HUNG FIRE EXTINGUISHER

LEGEND

REMARKS
TRAVEL DISTANCE
EXIT SIGNAGE - SEE MEP DRAWINGS FOF
EXISTING WALL
NEW NON RATED WALL TO UNDERSIDE C
FIRE EXTINGUISHER CABINET
EMERGENCY LIGHTS

PROJECT INFORMATION / CODE SUMMARY

OR SPECIFICATIONS

OF EXISITNG CEILING TILE

APPLICABLE CODES

FLORIDA BUILDING CODE - (5th EDITION 2014) FLORIDA BUILDING CODE ACCESSIBILITY (5th EDITION 2014) FLORIDA BUILDING CODE - EXISTING BUILDING- (5th EDITION 2014) FLORIDA FIRE PREVENTION CODE - (5th EDITION) NFPA 101 - LIFE SAFETY CODE 2012 WITH FLORIDA AMENDMENTS NFPA 1- UNIFORM FIRE CODE 2012 WITH FLORIDA AMENDMENTS NFPA 70 - NATIONAL ELECTRICAL CODE - 2011 FLORIDA MECHANICAL CODE - 2014

CITY OF ORLANDO JURISDICTION

OCCUPANCY GROUP CLASSIFICATION: MAX. PROJECTED RESIDENTS:

RESIDENTIAL:

RESIDENTIAL R4 - GROUP HOME 12 OCC. TOTAL IN BEDROOMS PLUS (4) MAX SUPPORT STAFF TOTAL OF (16) OCCUPANTS OR LESS. OFFICES PROVIDED FOR 24 HOUR STAFF WHICH ARE AN ACCESSORY USE TO THE R-4 OCCUPANCY.

EXITS

SEE LIFE SAFETY SUMMARY AND DIAGRAM MAX. TRAVEL DISTANCE: 250 FT. PROVIDED: 99 FT. MAX. COMMON PATH OF TRAVEL: 75 FT (SI PROVIDED: 35 FT. MAX. DEAD END CORRIDOR: 50FT. (SI PROVIDED: 0 FT. EGRESS CAPACITY: 137 x .2 = 170" (3 de PROVIDED:


CONSTRUCTION TYPE:

SPRINKLERED or NONSPRINKLERED: HEIGHT: **CLASSIFICATION OF WORK:**

PLUMBING REQUIREMENTS:

NOTE: WATER CLOSETS, LAVATORIES, & DF PROVIDED IN THE BUILDING COMMON AREA & DRINKING FOUNTAINS TO REMAIN AND AI SAME AMOUNT OF NEW PLUMBING FIXTUR


	ARCHITECTURAL DESIGN COLLABORAT 945 N. PENNSYLVANIA AVENUE	IVE
	WINTER PARK, FLORIDA 32789 OFFICE: (407) 629-1188 FAX: (407) 388-1220 WWW. ADCINTERNATIONAL.NET	
		C001315 95752
	Project Documents for:	TTAGE
	ORLANDO, FL 32806 Issue Date & Issue Description Drawn By C	hecked By
	07.27.16 60% CD SET JS 09.15.16 90% CD SET JS 12.02.16 PERMIT/BID SET JS 1 01.25.17 PERMIT COMMENTS JS	KA KA KA KA
	• 02.27.17 CONST. ISSUE SET JS	KA
	 Client Information ORANGE COUNTY CAPITAL PROJECTS DI 400 E SOUTH STREET 5th FLOOR ORLANDO, FL 32801 	VISION
	D 15253 Drawn By Project JS CONSTRUCTION I Checked By	Sue Date 02/27/2017 It Status ISSUE SET Scale 3/16"= 1'-0"
	File Name X:\dwgs\15253 OC Wittenstein House ADA\CAD\SHEE A00.51 LIFE SAFETY PLAN.dwg	ETS\
KEY PLAN	Consultant • Seal/Signature	
AREA OF WORK (SPRINKLERED) SPRINKLERED) SPRINKLERED)		
= 27.4" doors @ 34" ONE AT 68") XISTING PRINKLERED BUILDING XISTING LTERATION / RENOVATION	Sheet Title:	
NEW FLOOR PLAN RINKING FOUNTAINS ARE A. EXISTING RESTROOMS ARE TO BE REPLACED WITH RES.	A00.51	
	7	

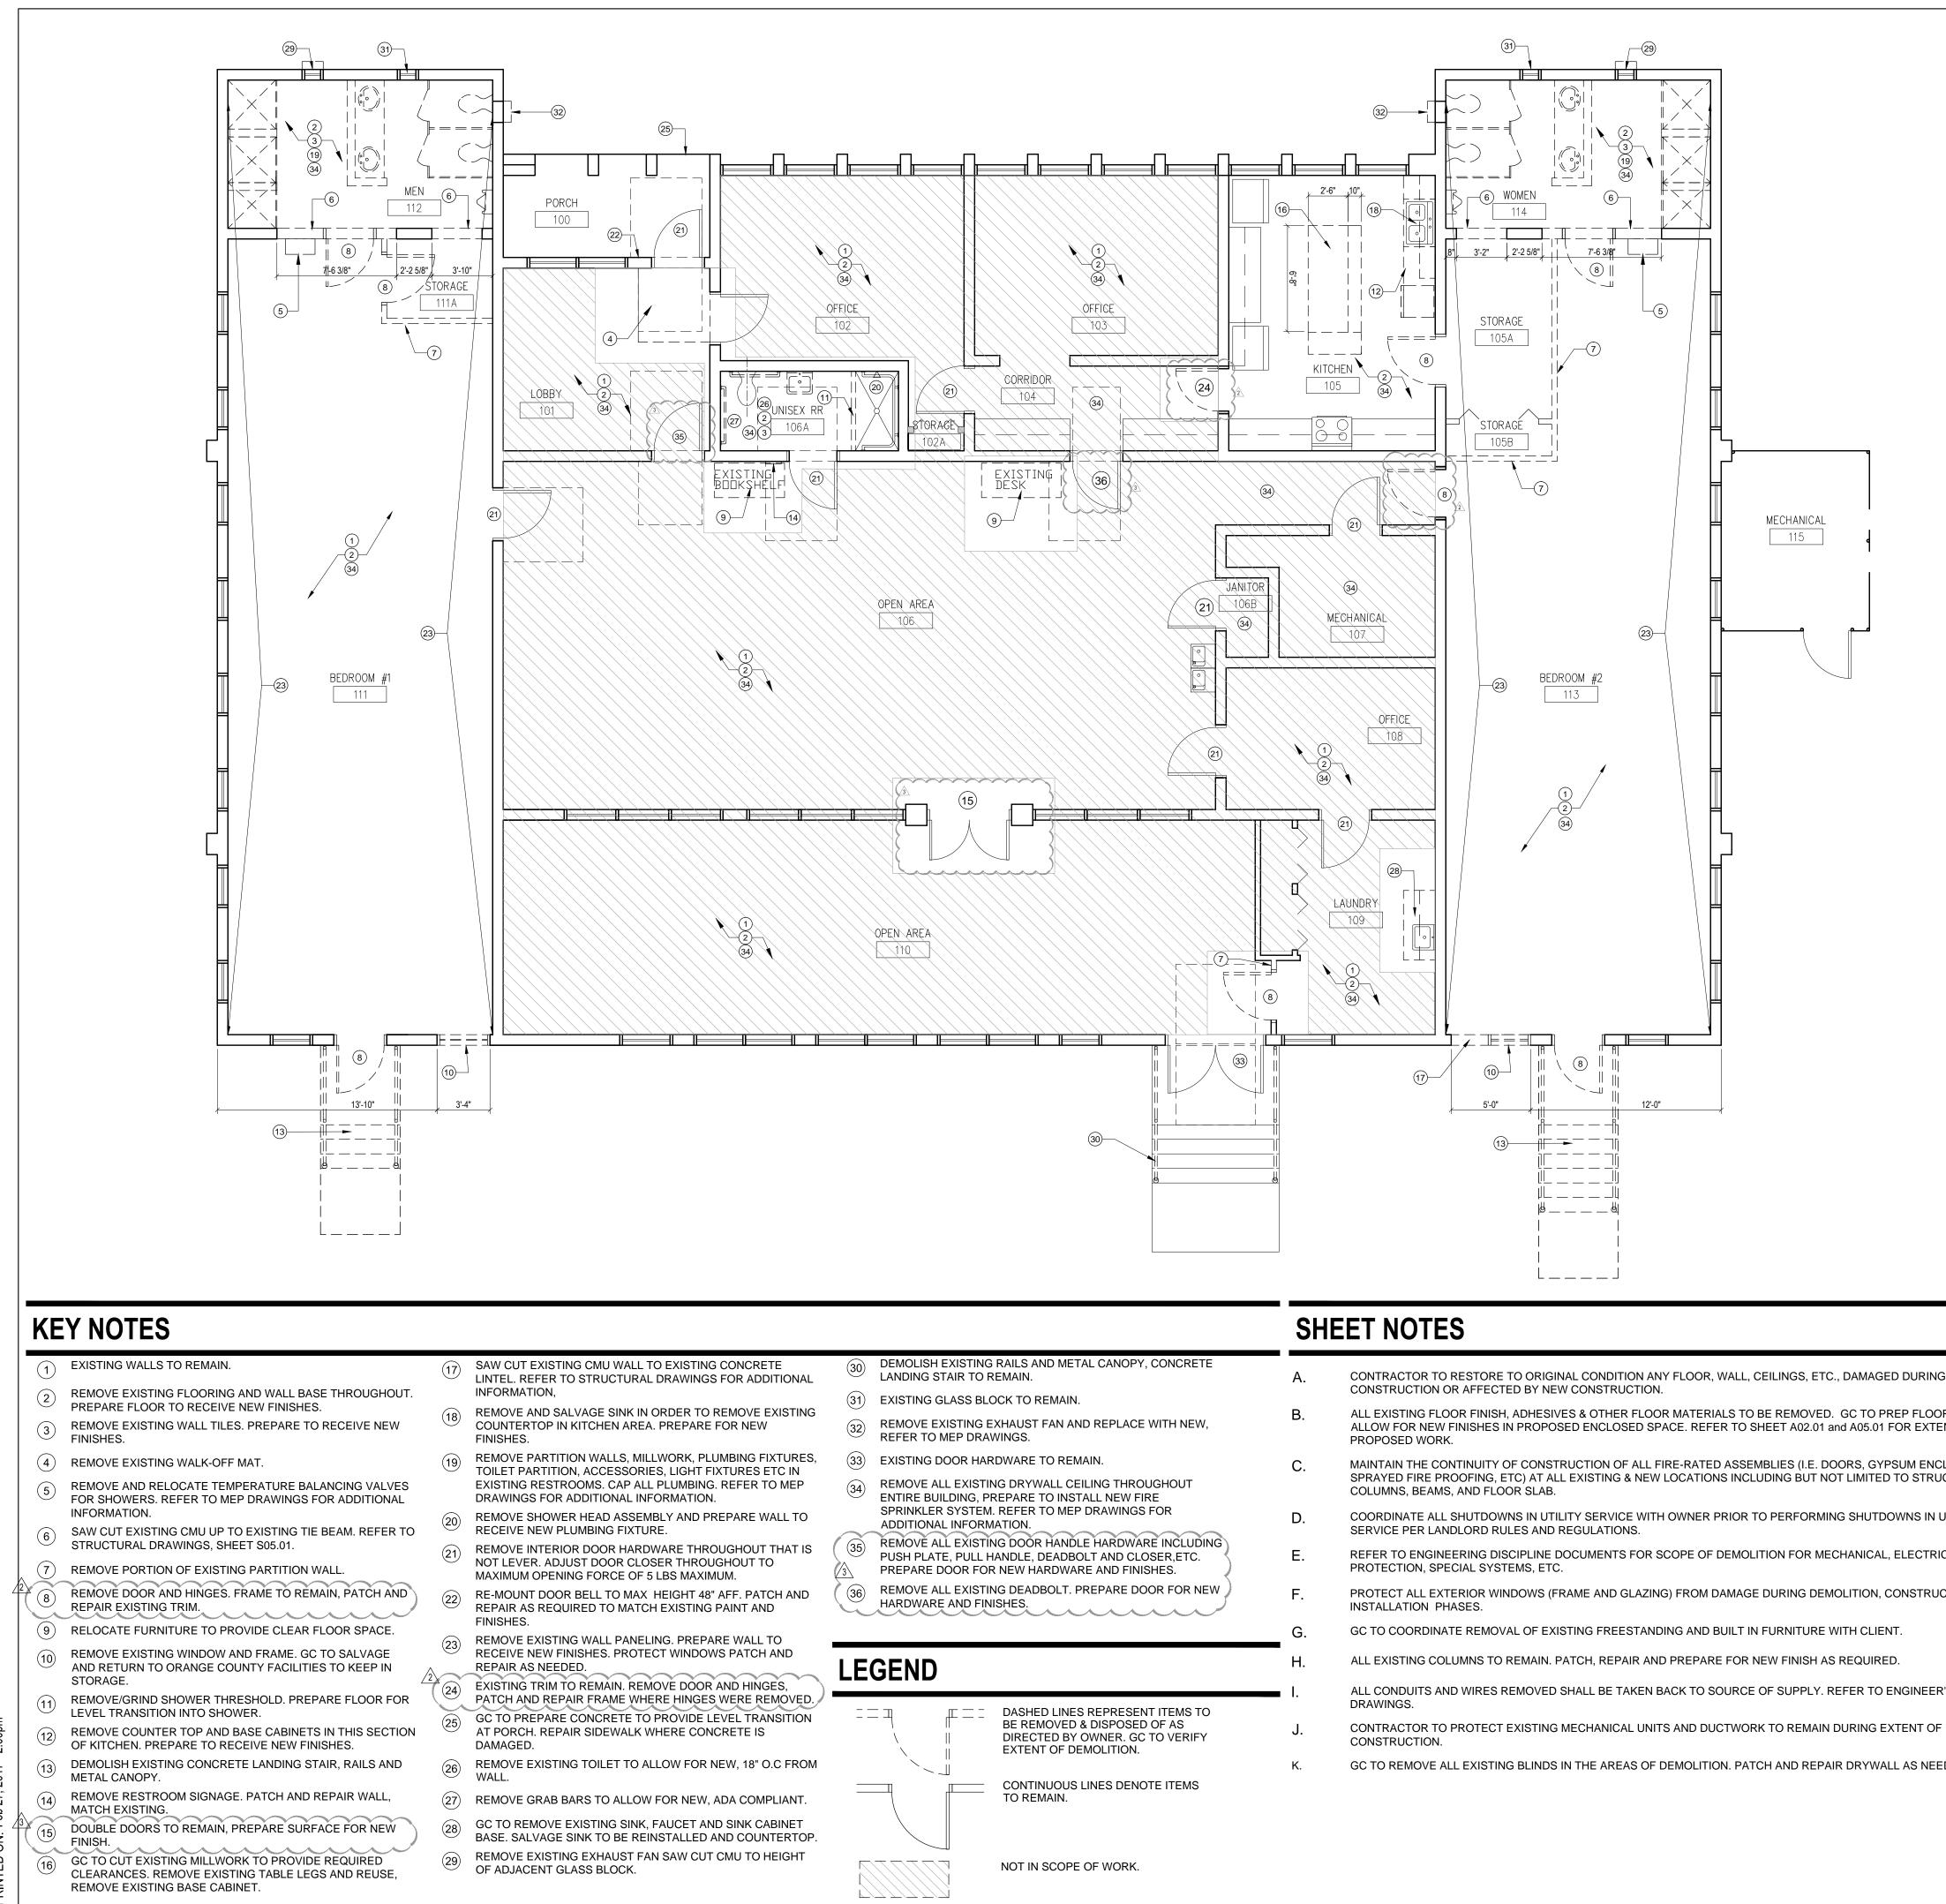

CONTRACTOR TO RESTORE TO ORIGINAL CONDITION ANY FLOOR, WALL, CEILINGS, ETC., DAMAGED DURING ALL EXISTING FLOOR FINISH, ADHESIVES & OTHER FLOOR MATERIALS TO BE REMOVED. GC TO PREP FLOOR TO ALLOW FOR NEW FINISHES IN PROPOSED ENCLOSED SPACE. REFER TO SHEET A02.01 and A05.01 FOR EXTENT OF MAINTAIN THE CONTINUITY OF CONSTRUCTION OF ALL FIRE-RATED ASSEMBLIES (I.E. DOORS, GYPSUM ENCLOSURES, SPRAYED FIRE PROOFING, ETC) AT ALL EXISTING & NEW LOCATIONS INCLUDING BUT NOT LIMITED TO STRUCTURAL COORDINATE ALL SHUTDOWNS IN UTILITY SERVICE WITH OWNER PRIOR TO PERFORMING SHUTDOWNS IN UTILITY REFER TO ENGINEERING DISCIPLINE DOCUMENTS FOR SCOPE OF DEMOLITION FOR MECHANICAL, ELECTRICAL, FIRE PROTECT ALL EXTERIOR WINDOWS (FRAME AND GLAZING) FROM DAMAGE DURING DEMOLITION, CONSTRUCTION, AND GC TO COORDINATE REMOVAL OF EXISTING FREESTANDING AND BUILT IN FURNITURE WITH CLIENT. ALL EXISTING COLUMNS TO REMAIN. PATCH, REPAIR AND PREPARE FOR NEW FINISH AS REQUIRED. ALL CONDUITS AND WIRES REMOVED SHALL BE TAKEN BACK TO SOURCE OF SUPPLY. REFER TO ENGINEER'S

GC TO REMOVE ALL EXISTING BLINDS IN THE AREAS OF DEMOLITION. PATCH AND REPAIR DRYWALL AS NEEDED.

	ARCHITECTURAL DESIGN COLLABORATIVE 945 N. PENNSYLVANIA AVENUE WINTER PARK, FLORIDA 32789 OFFICE: (407) 629-1188 FAX: (407) 388-1220 WWW. ADCINTERNATIONAL.NET
	STATE OF FLORIDA AA-C001315 MARIA FERREIRA AR-95752 Architect • Seal/Signature Project Documents for:
	Project: GREAT OAKS VILLAGE WITTENSTEIN COTTAGE ADA UPGRADES AND RENOVATIONS 1784 E. MICHIGAN STREET ORLANDO, FL 32806
	Issue Date & Issue Description Drawn By Checked By 07.27.16 60% CD SET JS KA 09.15.16 90% CD SET JS KA 12.02.16 PERMIT/BID SET JS KA 12.02.16 PERMIT COMMENTS JS KA 12.02.16 Detemuit Coord JS KA 12.02.17 GC / CLIENT COORD JS KA 12.02/20/2017 GC / CLIENT COORD JS KA 13 02/224/2017 GC / CLIENT COORD JS KA 02.27.17 CONST. ISSUE SET JS KA
	 Client Information ORANGE COUNTY CAPITAL PROJECTS DIVISION 400 E SOUTH STREET 5th FLOOR ORLANDO, FL 32801
	Project Number Issue Date 15253 02/27/2017 Drawn By Project Status JS CONSTRUCTION ISSUE SET Checked By Scale KA 3/16"= 1'-0" File Name X:\dwgs\15253 OC Wittenstein House ADA\CAD\SHEETS\ A01.01 DEMOLITION PLAN.dwg
KEY PLAN	Consultant • Seal/Signature
EXISTING FLOOR PLAN	Sheet Title: DEMOLITION PLAN
	A01.01

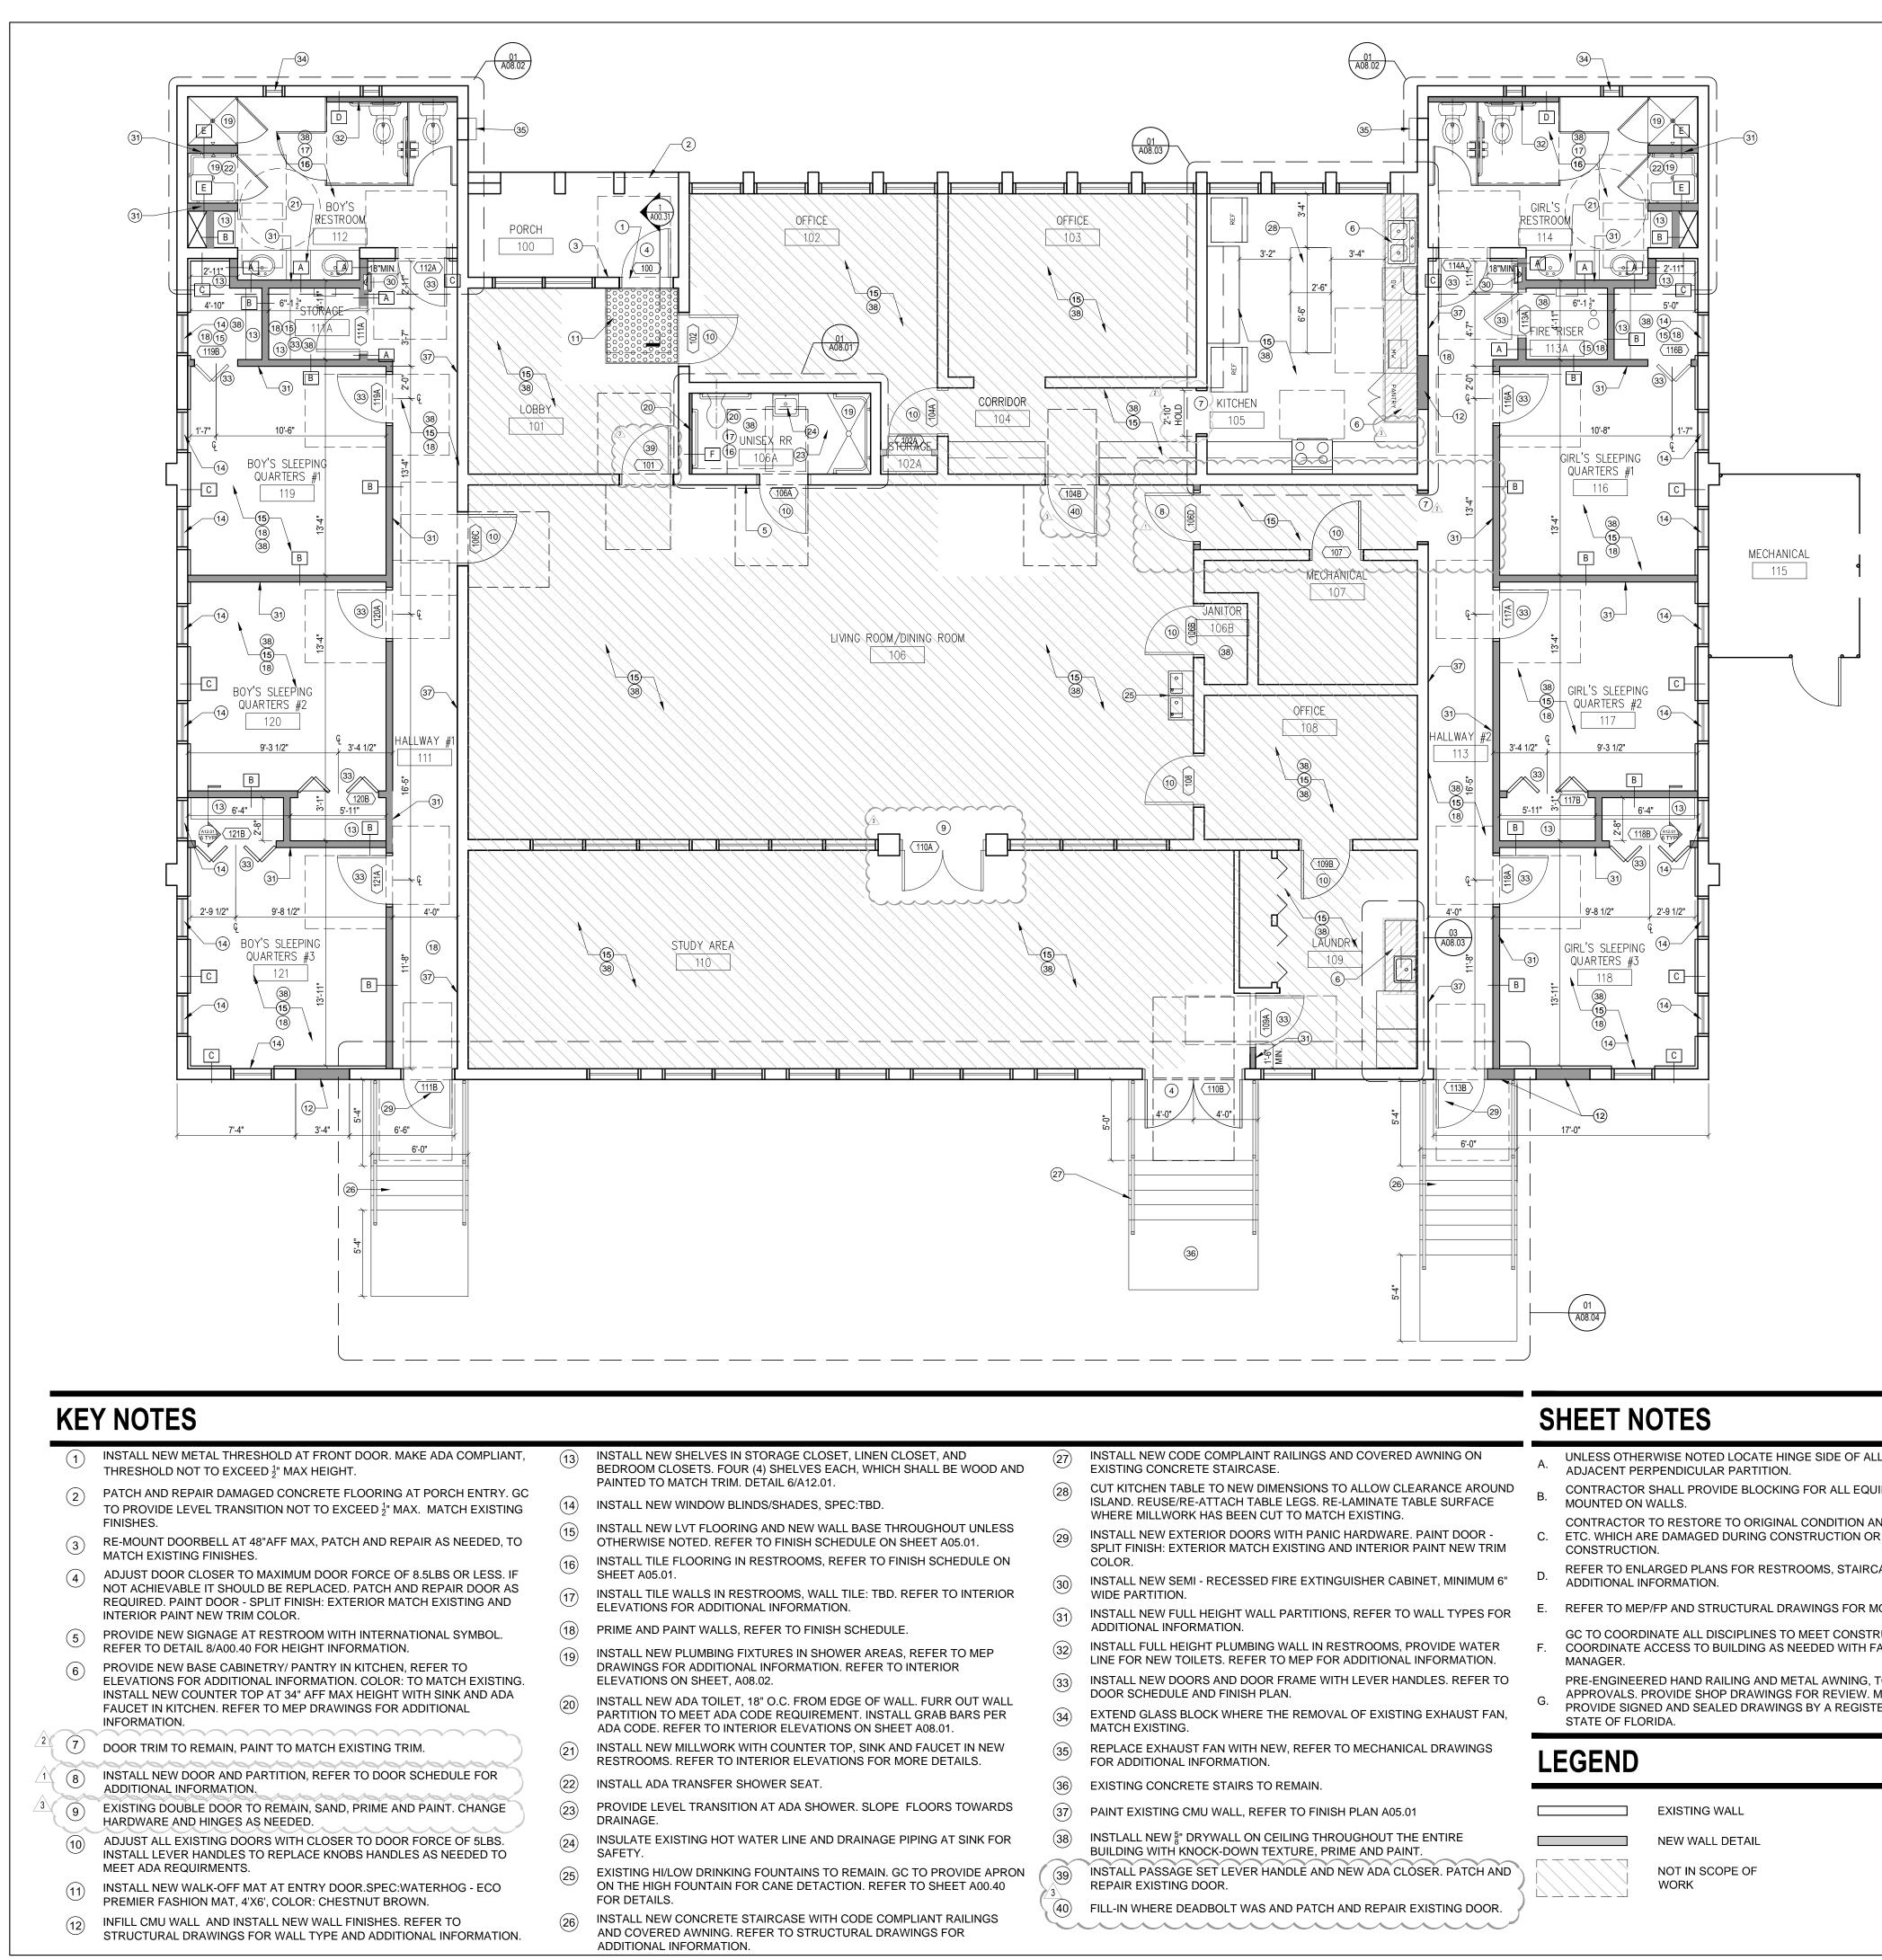


- UNLESS OTHERWISE NOTED LOCATE HINGE SIDE OF ALL DOORS 6" FROM
- CONTRACTOR SHALL PROVIDE BLOCKING FOR ALL EQUIPMENT AND ACCESSORIES
- CONTRACTOR TO RESTORE TO ORIGINAL CONDITION ANY FLOOR, WALLS, CEILINGS, C. ETC. WHICH ARE DAMAGED DURING CONSTRUCTION OR AFFECTED BY NEW
- REFER TO ENLARGED PLANS FOR RESTROOMS, STAIRCASES AND KITCHEN FOR
- REFER TO MEP/FP AND STRUCTURAL DRAWINGS FOR MORE INFORMATION.
- GC TO COORDINATE ALL DISCIPLINES TO MEET CONSTRUCTION DEADLINES. COORDINATE ACCESS TO BUILDING AS NEEDED WITH FACILITIES AND BUILDING
- PRE-ENGINEERED HAND RAILING AND METAL AWNING, TO MEET FLORIDA PRODUCT APPROVALS. PROVIDE SHOP DRAWINGS FOR REVIEW. MANUFACTURER SHALL PROVIDE SIGNED AND SEALED DRAWINGS BY A REGISTERED ENGINEER IN THE

ADDITIVE BID ITEMS

- CONTRACTOR TO PRICE OUT REPLACING ALL LIGHTING TO LED FIXTURES THROUGHOUT AS ADDITIVE BID ITEM.
- 2. CONTRACTOR TO PRICE PAINTING THROUGHOUT AS AN ADDITIVE BID ITEM.
- CONTRACTOR TO PRICE OUT REPLACING EXISTING COUNTER TOPS IN KITCHEN WITH SOLID SURFACE AS ADDITIVE BID ITEM. REFER TO SHEET A05.01 FOR FINISH SCHEDULE.


ARCHITECTURAL DESIGN COLLABORATIVE 945 N. PENNSYLVANIA AVENUE WINTER PARK, FLORIDA 32789 OFFICE: (407) 629-1188 FAX: (407) 388-1220 WWW. ADCINTERNATIONAL.NET STATE OF FLORIDA AA-C001315 MARIA FERREIRA AR-95752 Architect • Seal/Signature **Project Documents for:** FLORIDA Project: GREAT OAKS VILLAGE WITTENSTEIN COTTAGE ADA UPGRADES AND RENOVATIONS 1784 E. MICHIGAN STREET ORLANDO, FL 32806 ssue Date & Issue Description Drawn By Checked By 60% CD SET 07.27.16 JS KA 09.15.16 90% CD SET JS KA 12.02.16 PERMIT/BID SET JS KA PERMIT COMMENTS JS 01.25.17 KA 02/20/2017 GC / CLIENT COORD. JS KA GC / CLIENT COORD. KA 02/24/2017 JS 02.27.17 CONST. ISSUE SET JS KA Client Information ORANGE COUNTY CAPITAL PROJECTS DIVISION 400 E SOUTH STREET 5th FLOOR ORLANDO, FL 32801 Project Number Issue Date 15253 02/27/2017 Drawn By Project Status CONSTRUCTION ISSUE SET Checked By Scale 3/16"= 1'-0" File Name X:\dwgs\15253 OC Wittenstein House ADA\CAD\SHEETS\ A02.01 CONSTRUCTION PLAN.dwg Consultant • Seal/Signature Sheet Title: CONSTRUCTION PLAN

KEY PLAN

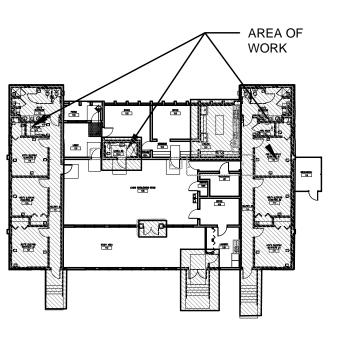

NEW FLOOR PLAN

A02.01

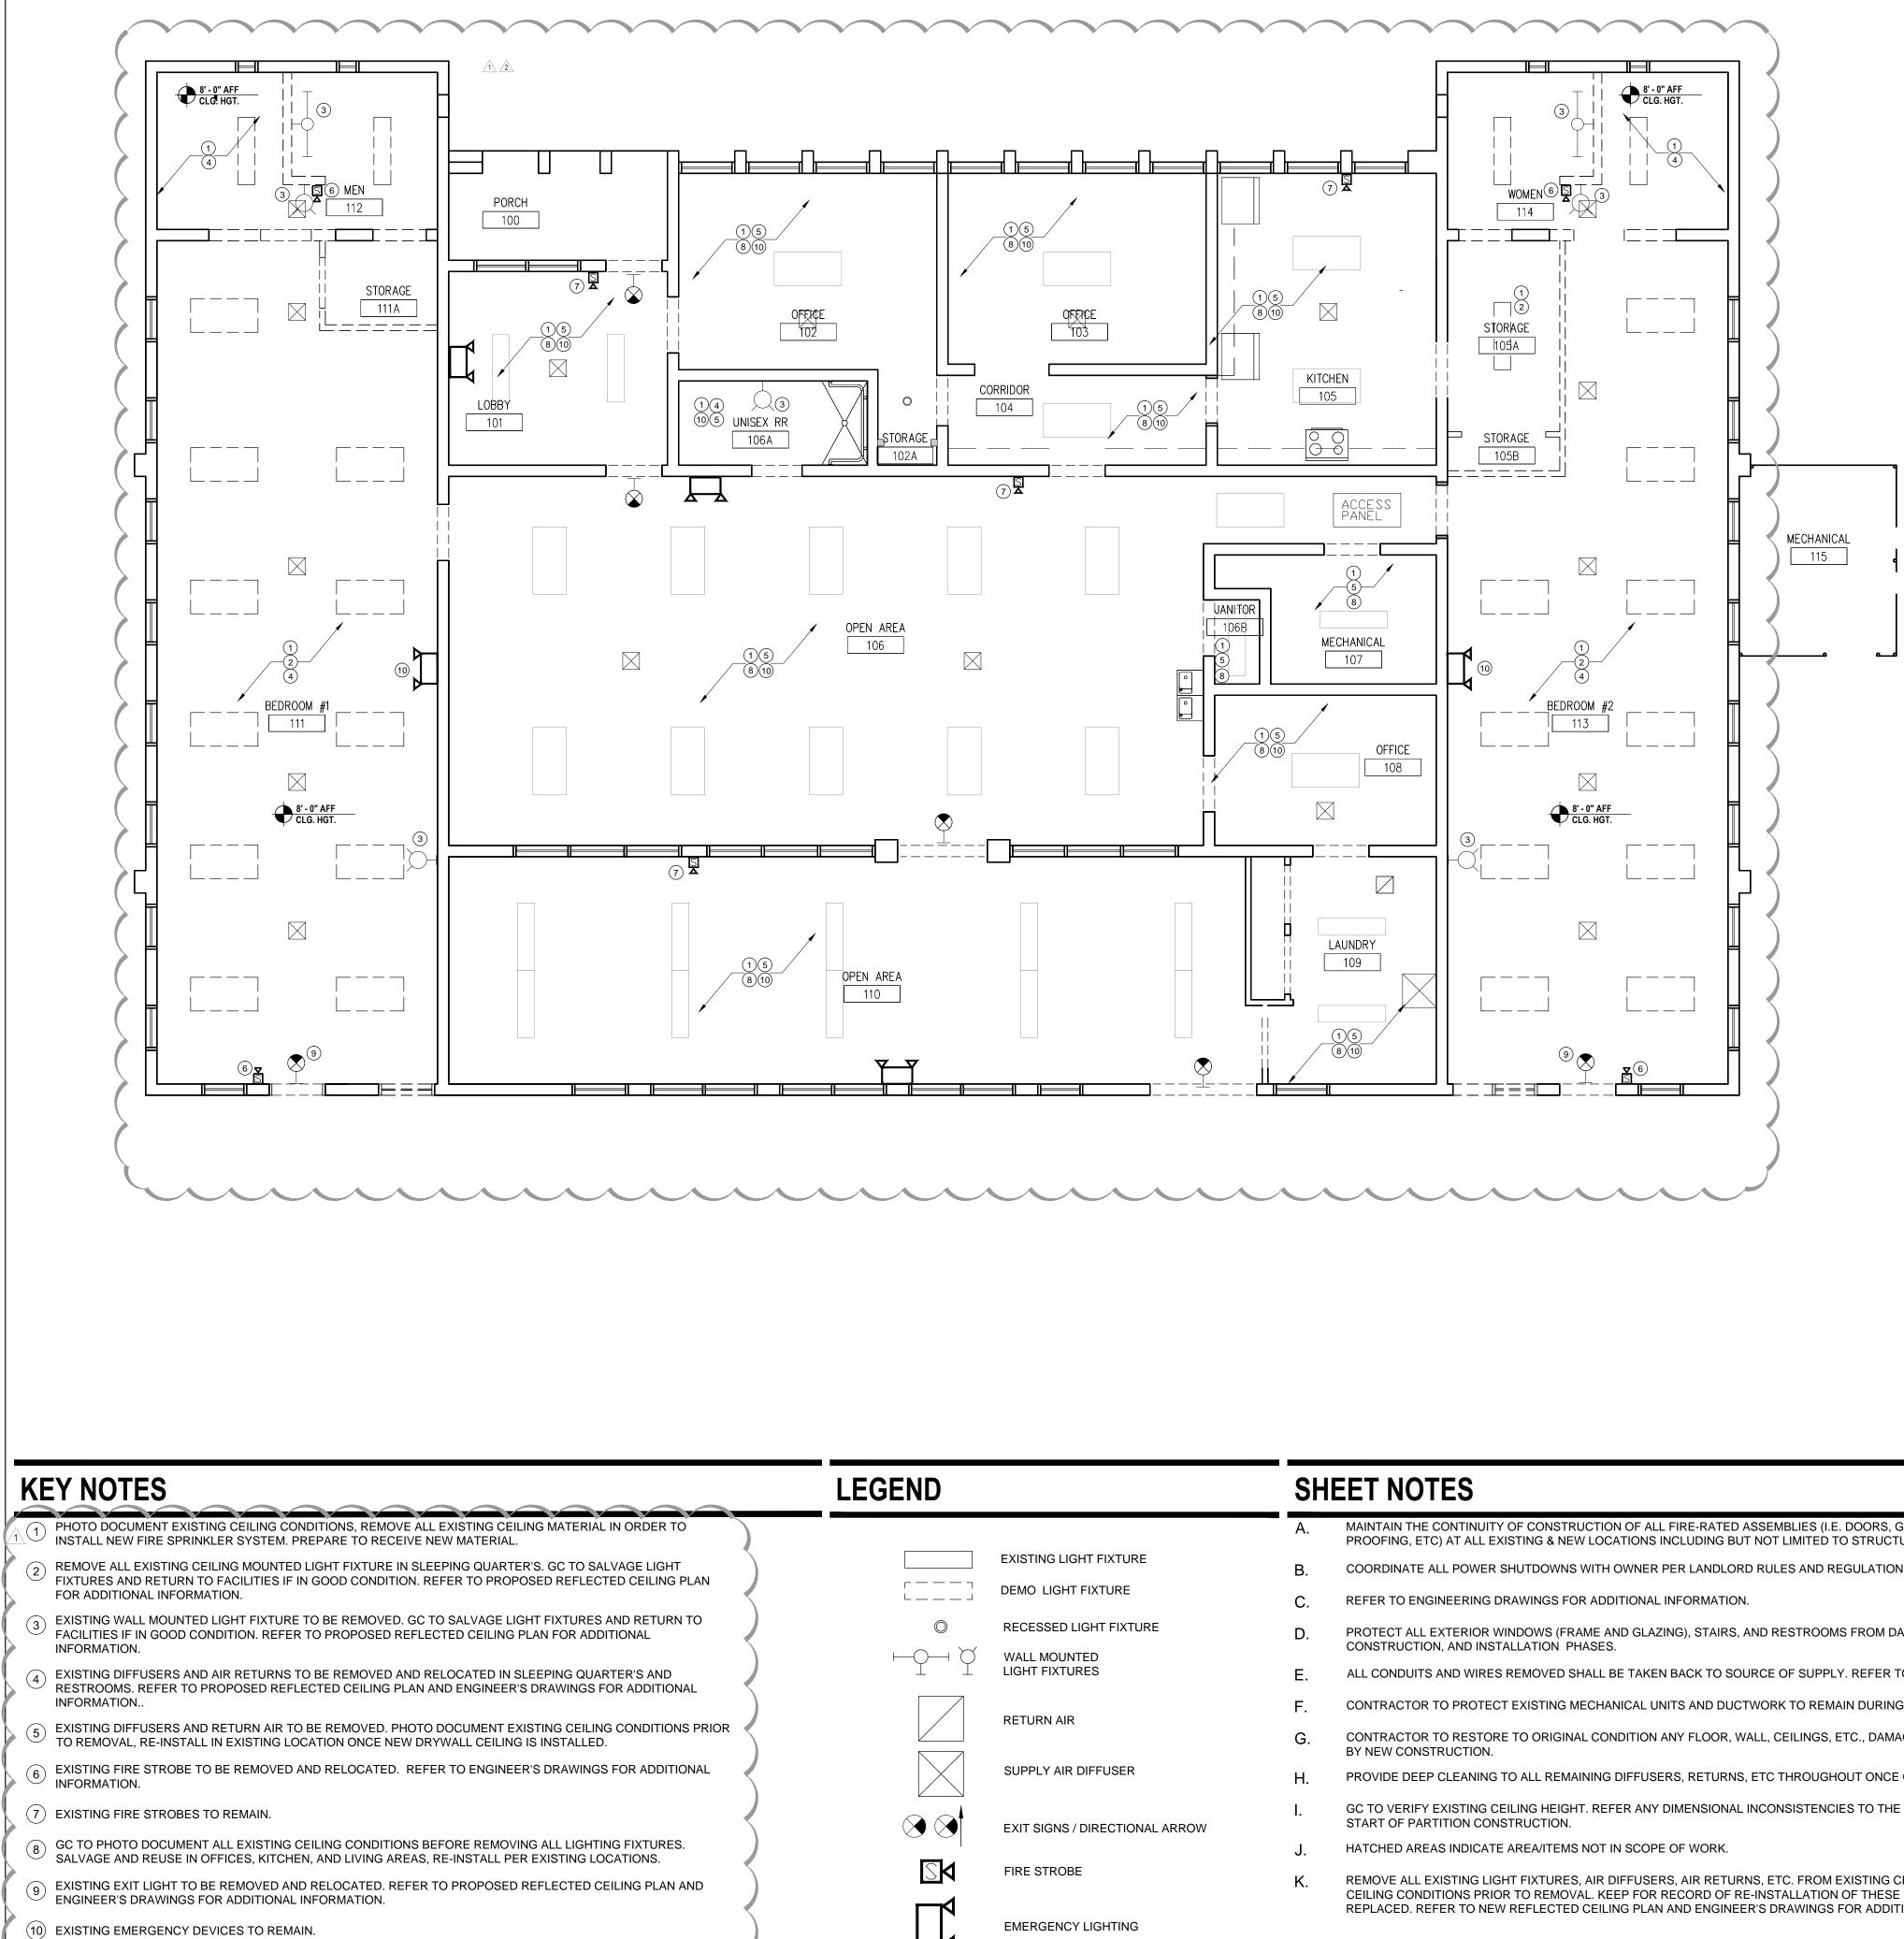

)		SH	EET NOTES
		А.	MAINTAIN THE CONTINUITY OF CONSTRUCTION OF ALL FIRE-RATED ASSEMBLIES (I.E. DOORS, GYPSUM ENCLOSURES, SPRAY PROOFING, ETC) AT ALL EXISTING & NEW LOCATIONS INCLUDING BUT NOT LIMITED TO STRUCTURAL COLUMNS, BEAMS, AND
	EXISTING LIGHT FIXTURE	В.	COORDINATE ALL POWER SHUTDOWNS WITH OWNER PER LANDLORD RULES AND REGULATIONS.
J	DEMO LIGHT FIXTURE	C.	REFER TO ENGINEERING DRAWINGS FOR ADDITIONAL INFORMATION.
0	RECESSED LIGHT FIXTURE	D.	PROTECT ALL EXTERIOR WINDOWS (FRAME AND GLAZING), STAIRS, AND RESTROOMS FROM DAMAGE DURING DEMOLITION,
\neg	WALL MOUNTED LIGHT FIXTURES	E.	CONSTRUCTION, AND INSTALLATION PHASES. ALL CONDUITS AND WIRES REMOVED SHALL BE TAKEN BACK TO SOURCE OF SUPPLY. REFER TO ENGINEER'S DRAWINGS.
		F.	CONTRACTOR TO PROTECT EXISTING MECHANICAL UNITS AND DUCTWORK TO REMAIN DURING EXTENT OF CONSTRUCTION.
	RETURN AIR	G.	CONTRACTOR TO RESTORE TO ORIGINAL CONDITION ANY FLOOR, WALL, CEILINGS, ETC., DAMAGED DURING CONSTRUCTION BY NEW CONSTRUCTION.
$\left \right $	SUPPLY AIR DIFFUSER	Н.	PROVIDE DEEP CLEANING TO ALL REMAINING DIFFUSERS, RETURNS, ETC THROUGHOUT ONCE CONSTRUCTION IS COMPLETE
	EXIT SIGNS / DIRECTIONAL ARROW	Ι.	GC TO VERIFY EXISTING CEILING HEIGHT. REFER ANY DIMENSIONAL INCONSISTENCIES TO THE ARCHITECT FOR RESOLUTION START OF PARTITION CONSTRUCTION.
		J.	HATCHED AREAS INDICATE AREA/ITEMS NOT IN SCOPE OF WORK.
N N	FIRE STROBE	K.	REMOVE ALL EXISTING LIGHT FIXTURES, AIR DIFFUSERS, AIR RETURNS, ETC. FROM EXISTING CEILING. GC TO PHOTO DOCUM CEILING CONDITIONS PRIOR TO REMOVAL. KEEP FOR RECORD OF RE-INSTALLATION OF THESE ITEMS ONCE NEW DRYWALL O REPLACED. REFER TO NEW REFLECTED CEILING PLAN AND ENGINEER'S DRAWINGS FOR ADDITIONAL INFORMATION.
₽	EMERGENCY LIGHTING		


ADDITIVE BID ITEMS

CONTRACTOR TO PRICE OUT REPLACING ALL LIGHTING TO LED FIXTURES THROUGHOUT AS ADDITIVE BID ITEM.

ARCHITECTURAL DESIGN COLLABORATIVE 945 N. PENNSYLVANIA AVENUE WINTER PARK, FLORIDA 32789 OFFICE: (407) 629-1188 FAX: (407) 388-1220 WWW. ADCINTERNATIONAL.NET AA-C001315 STATE OF FLORIDA MARIA FERREIRA AR-95752 Architect • Seal/Signature **Project Documents for:** FLORIDA Project: GREAT OAKS VILLAGE WITTENSTEIN COTTAGE ADA UPGRADES AND RENOVATIONS 1784 E. MICHIGAN STREET ORLANDO, FL 32806 Issue Date & Issue Description Drawn By Checked By 07.27.16 60% CD SET JS KA 09.15.16 90% CD SET JS KA 12.02.16 PERMIT/BID SET JS KA 01.25.17 PERMIT COMMENTS JS KA 02/20/2017 GC / CLIENT COORD. JS KA 02.27.17 CONST. ISSUE SET JS KA Client Information ORANGE COUNTY CAPITAL PROJECTS DIVISION 400 E SOUTH STREET 5th FLOOR ORLANDO, FL 32801 Project Number Issue Date 15253 02/27/2017 Drawn By Project Status CONSTRUCTION ISSUE SET Checked By Scale 3/16"= 1'-0" KA File Name X:\dwgs\15253 OC Wittenstein House ADA\CAD\SHEETS\ A04.01A DEMO REFLECTED CEILING PLAN.dwg Consultant • Seal/Signature Sheet Title: DEMO REFLECTED CEILING PLAN


KEY PLAN

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Client Information ORANGE COUNTY CAPITAL PROJECTS DIVI 400 E SOUTH STREET 5th FLOOR ORLANDO, FL 32801
Project: GREAT OAKS VILLAGE WITTENSTEIN COTT ADA UPGRADES AND RENOVATIONS 1784 E. MICHIGAN STREET ORLANDO, FL 32806 Drawn By Chee 07.27.16 60% CD SET JS 09.15.16 90% CD SET JS 12.02.16 PERMIT/BID SET JS 02.27.17 CONST. ISSUE SET JS 00 ORANGE COUNTY CAPITAL PROJECTS DIVI 400 E SOUTH STREET 5th FLOOR 00 Project Number Issue 15253 02/ 02/ JS CONSTRUCTION ISS Checked By S KA 3/16 File Name X:\dwgs\15253 OC Wittenstein House ADA\CAD\SHEETS A04.01B REFLECTED CEILING PLAN.dwg S
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Consultant • Seal/Signature

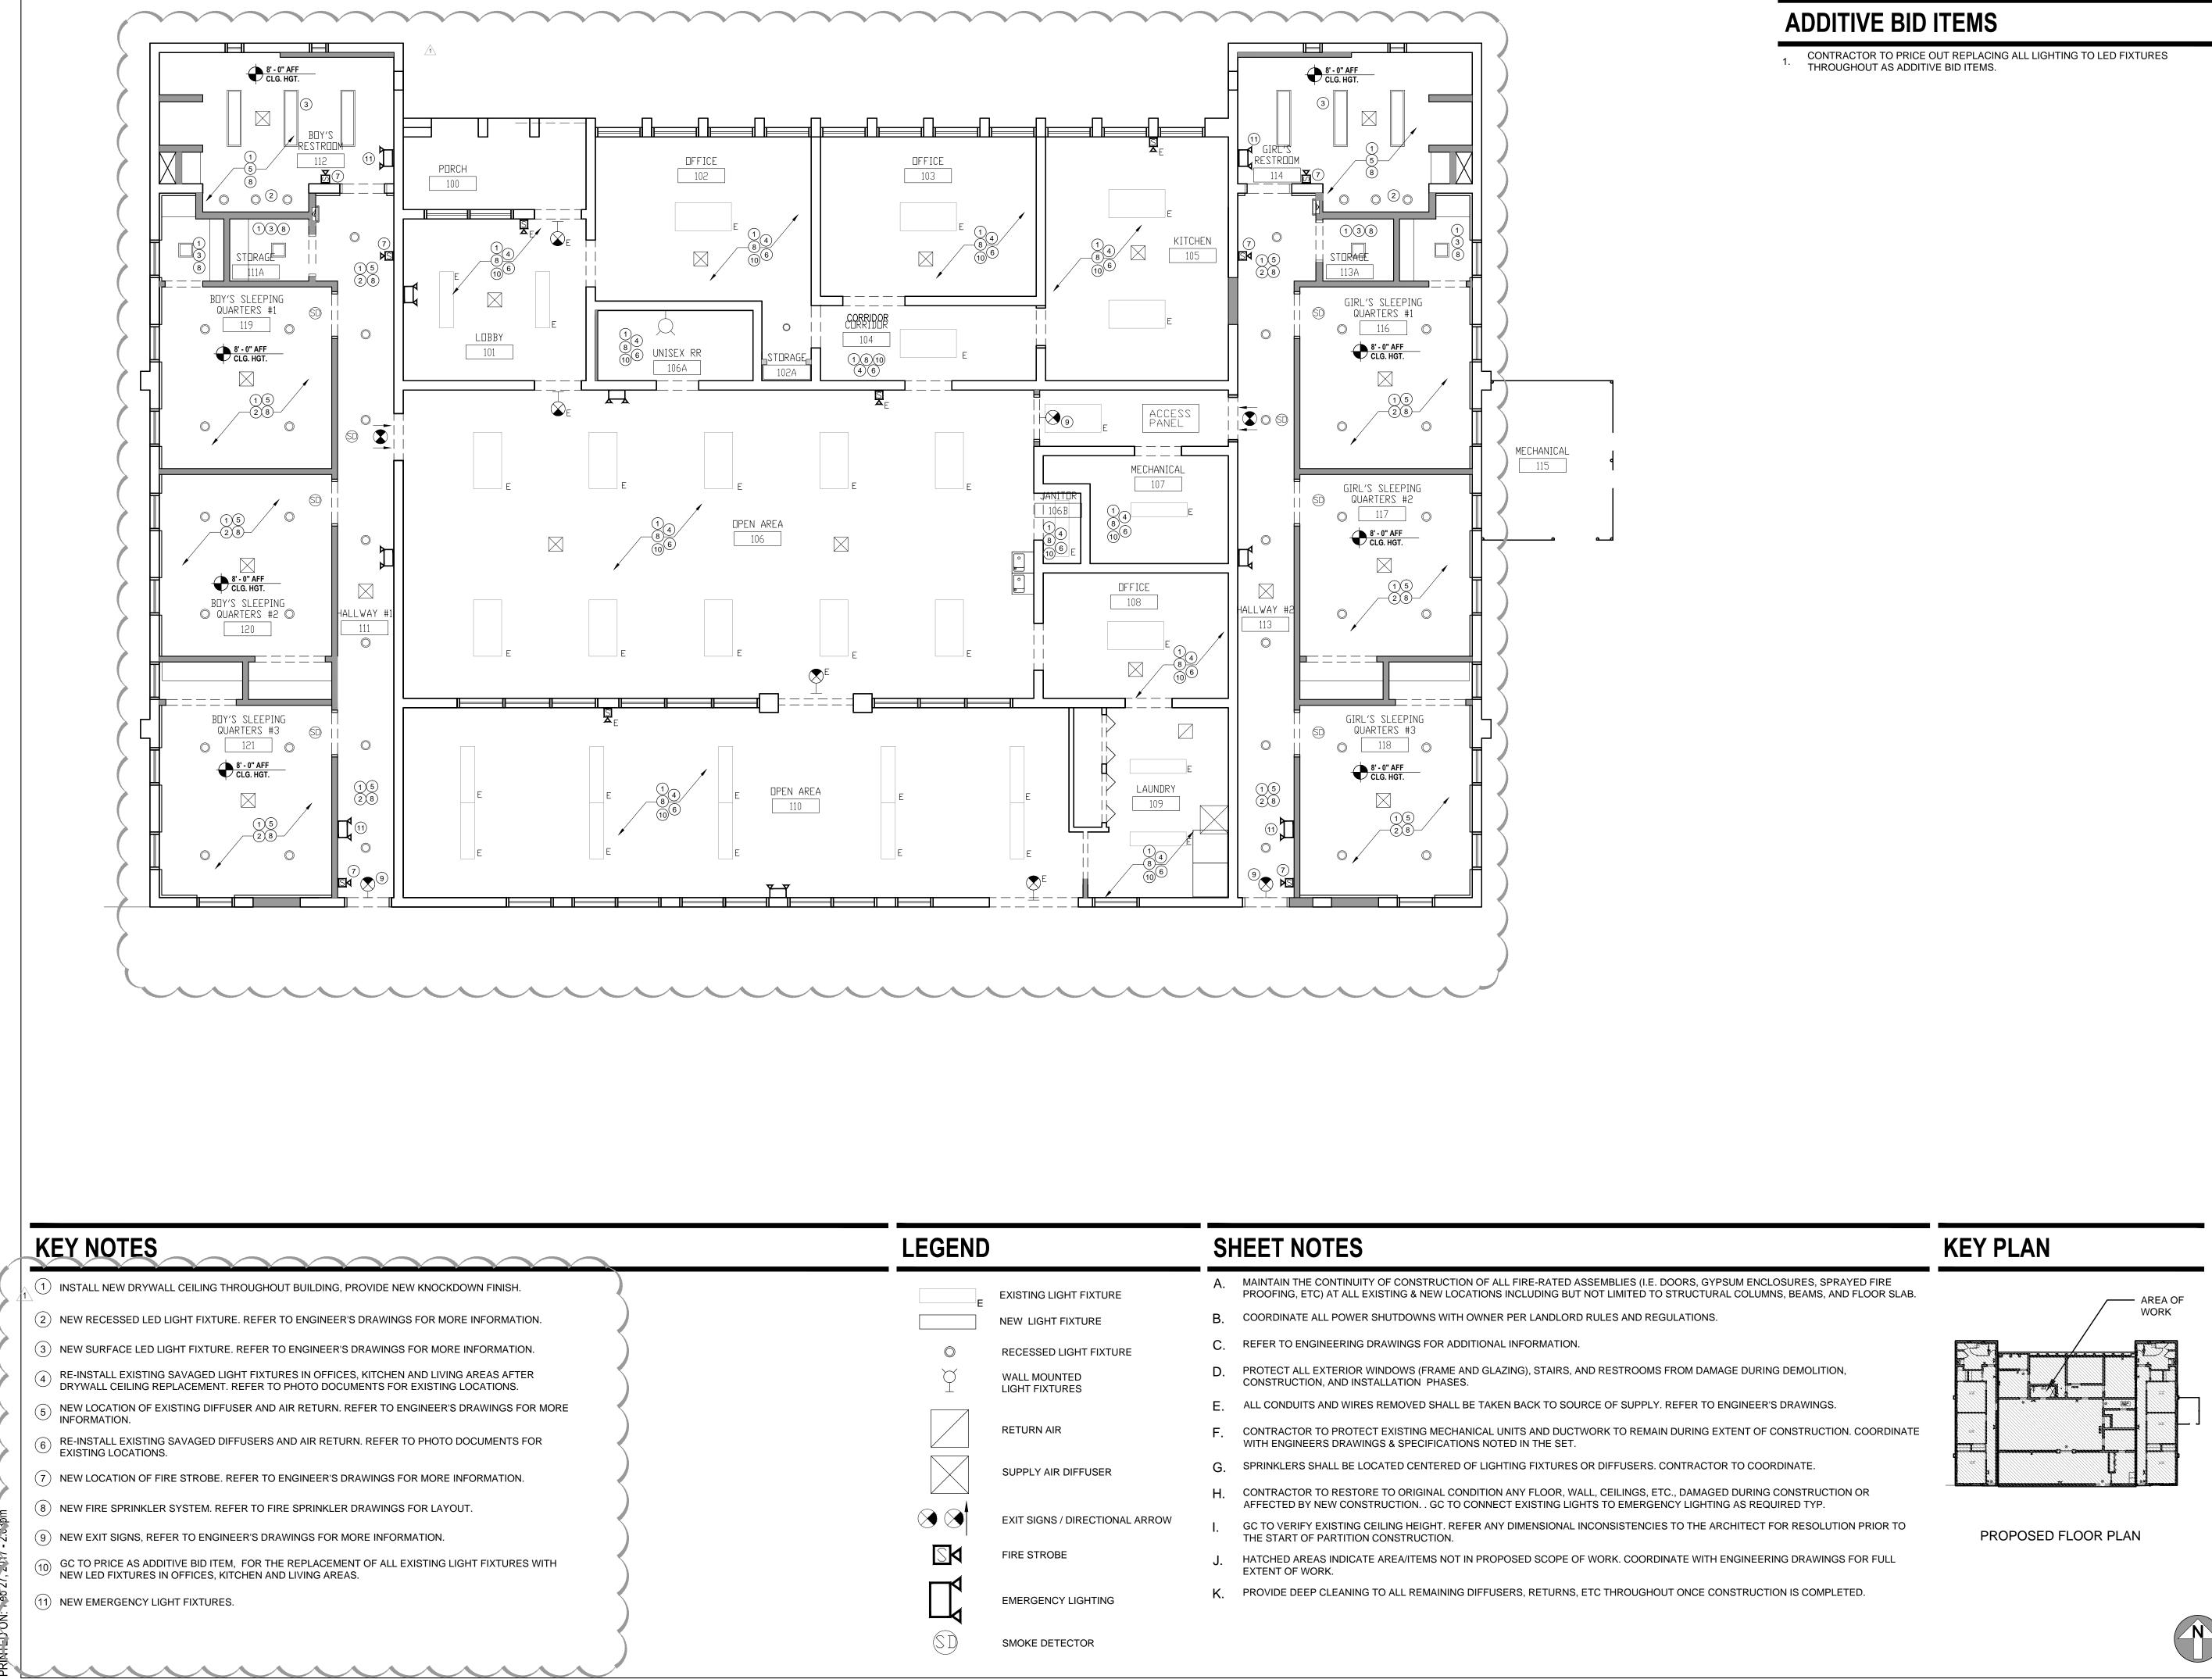



KEY NOTES

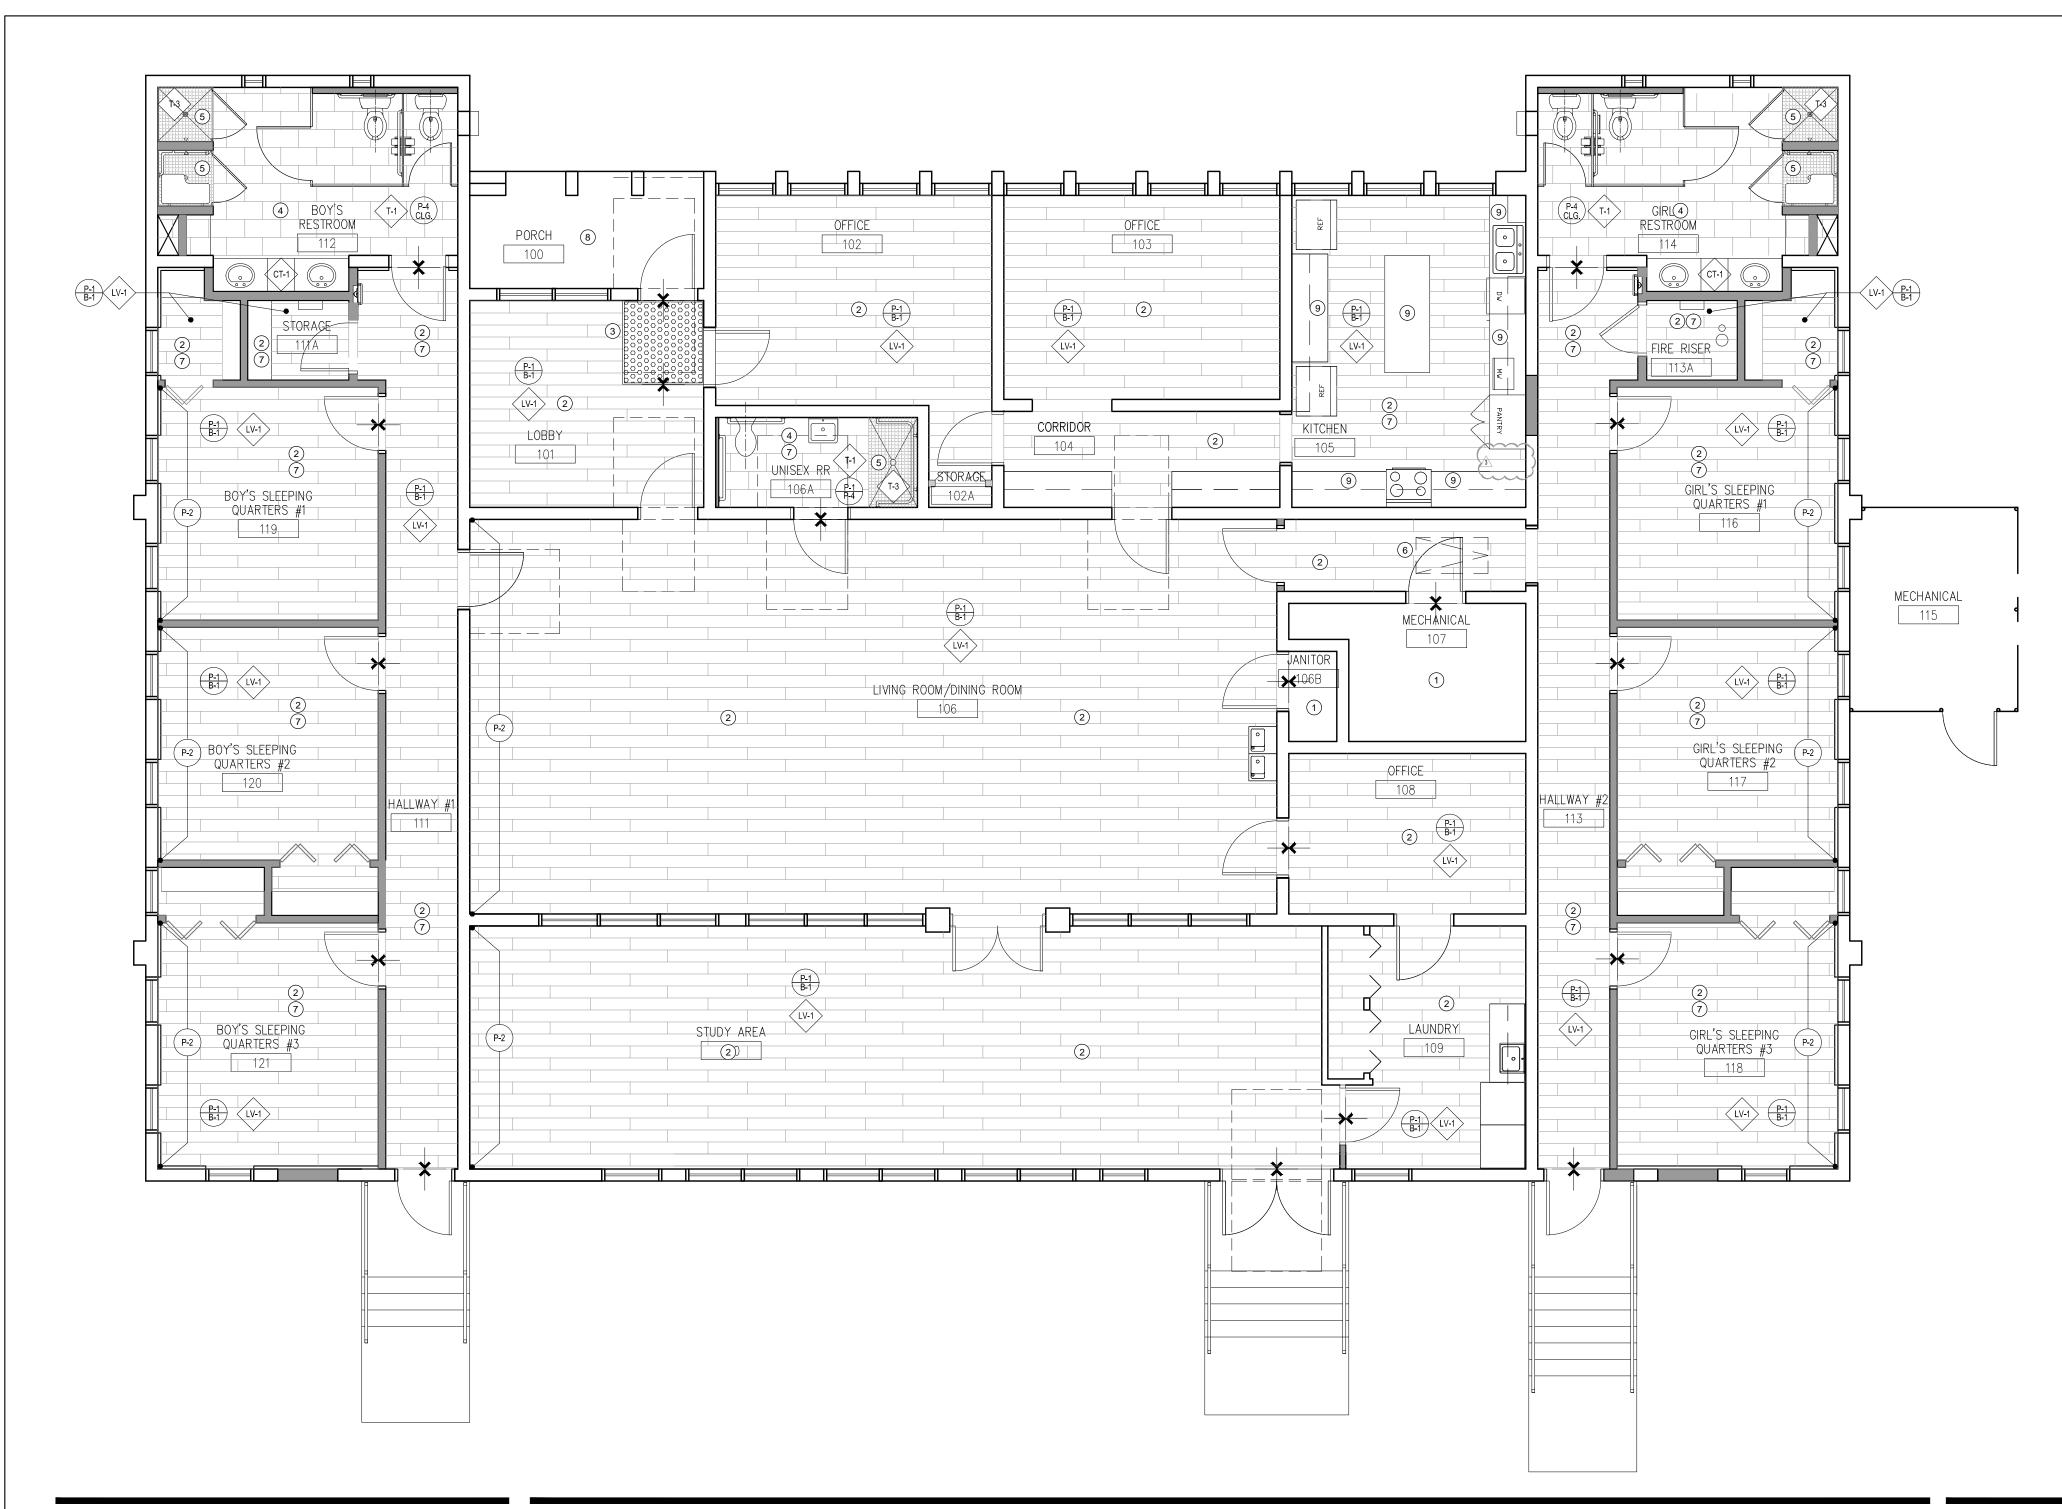- (1) EXISTING TO REMAIN. NO WORK REQUIRED.
- 2 INSTALL NEW LVT FLOORING THROUGHOUT UNLESS OTHERWISE INDICATED. INSTALL NEW WALL BASE THROUGHOUT SPACE.
- (3) INSTALL WALK-OFF MAT AT ENTRY.
- (4) INSTALL NEW TILE FLOORING, REFER TO INTERIOR ELEVATIONS P-2 FOR WALL TILE INFORMATION.
- 5 INSTALL SHOWER FLOORING, SLOPE TOWARDS DRAIN. REFER TO INTERIOR ELEVATIONS FOR WALL TILE DESIGN.
- 6 PAINT EXISTING ATTIC ACCESS DOOR AND FRAME TO MATCH CEILING COLOR.
- 7 PRIME AND PAINT WALLS AS INDICATED. GC TO PRICE OUT ALTERNATE COST TO PAINT ENTIRE INTERIOR SPACES THROUGHOUT BUILDING.
- 8 PAINT EXTERIOR CONCRETE FLOORING AT FRONT ENTRY, MATCH EXISTING.
- 9 GC TO PRICE AS ADDITIVE BID ITEM FOR THE REPLACEMENT OF [/] LAMINATE COUNTER TOPS TO SOLID SURFACE AND UNDERMOUNT SINK. REFER TO SPEC: CT-2.

FINISH SCHEDULE

-1	MANUF:	BENJAMIN MOORE
	STYLE:	INTERIOR SATIN LATEX
	COLOR:	WHEELING NEUTRAL, HC-92
	AREA:	GENERAL WALL PAINT
	FINISH:	SATIN FINISH
	NOTES:	GC MAY PROVIDE APPROVED EQUAL UNDER SUBSTITUTION REQUEST.
	FLAME SPREAD RA	ATING CLASS A
-2	MANUF:	BENJAMIN MOORE
	STYLE:	INTERIOR SATIN LATEX
	COLOR:	VAN COURTLAND BLUE, HC-145
	AREA:	ACCENT WALL PAINT
	FINISH:	SATIN FINISH
	NOTES:	GC MAY PROVIDE APPROVED EQUAL UNDER SUBSTITUTION REQUEST.
	FLAME SPREAD RA	ATING CLASS A
-3	MANUF:	BENJAMIN MOORE
	STYLE:	INTERIOR SATIN LATEX
	COLOR:	KINGSPORT GRAY, HC-86
	AREA:	BASEBOARD, TRIM PAINT, AND EXISTING DOORS.
	FINISH:	SEMI-GLOSS FINISH
	NOTES:	GC MAY PROVIDE APPROVED EQUAL UNDER SUBSTITUTION REQUEST.
	FLAME SPREAD RA	ATING CLASS A
-4	MANUF:	BENJAMIN MOORE
	STYLE:	INTERIOR SATIN LATEX
	COLOR:	SIMPLY WHITE, HC-117
	AREA:	GENERAL CEILING PAINT, WINDOW TRIM AND WOODEN SHELVES
	FINISH:	EGGSHELL FINISH

CT-1	MANUF:	DUPONT	T-1	MANUF:	DALTILE		
	STYLE:	CORIAN - PRIVATE COLLECTION		STYLE:	EXHIBITION - COLORBODY PORCELAIN	A.	. EXISTING DOOR RUSTED OR DAM
	COLOR:	WITCH HAZEL		COLOR:	12X24" ECRU - EX12, TEXTURED		HANDLES WITH
	AREA:	RESTROOM COUNTER TOPS		AREA:	RESTROOM TILE FLOORING		BUILDING.
	INSTALLATION:	INTEGRATED SINK BOWL, GLACIER ICE		INSTALLATION:	BRICK PATTERN, ¹ / ₈ GROUT	В.	PROTECT ALL W
	NOTES:	GC MAY PROVIDE APPROVED EQUAL UNDER SUBSTITUTION REQUEST.		NOTES:	GC MAY PROVIDE APPROVED EQUAL UNDER SUBSTITUTION REQUEST.	C.	PATCH AND REF GC TO CLEAN, F
CT-2	MANUF: STYLE:	DUPONT CORIAN	T-2	MANUF:	DALTILE		NEEDED. REPLA EXISTING.
	COLOR:	LINEN		STYLE:	FORMULA - COLORBODY PORCELAIN 12X24"	D.	PATCH AND REF
	AREA:	KITCHEN COUNTER & 4" BACKSPLASH		COLOR:	THEOREM IVORY - FM93, POLISHED		THROUGHOUT E
	NOTES:	ITEM TO BE PRICED AS AN ALTERNATE.		AREA:	RESTROOM WALL TILE	E	REPAIR AND/OR
				INSTALLATION:	STRAIGHT, 1/16" GROUT	L.	AS NECESSARY
PL-1	MANUF: STYLE:	NEVAMAR PREMIUM LAMINATE		NOTES:	GC MAY PROVIDE APPROVED EQUAL UNDER SUBSTITUTION REQUEST.	F.	PATCH AND REF
	COLOR:	TENDU, WZ2007 -PV	Т-3	MANUF:	DALTILE		REFER TO NEW
	AREA:	RESTROOM VANITY CABINET	1-5	STYLE:	KEYSTONE BLEND -1X1"	G	. PLACE ANY NEV
	NOTES:	GC MAY PROVIDE APPROVED EQUAL UNDER SUBSTITUTION REQUEST.		COLOR:	DK04 BEACH BLEND	0.	INSTALLATION T ENVIRONMENT.
B-1	MANUF: STYLE:	JOHNSONITE INFLECTION, MW-XX-G		AREA: INSTALLATION:	RESTROOM SHOWER FLOORING STRAIGHT	H.	REFER TO INTER
	COLOR:	80 FAWN				I.	
	AREA:	5.25" GENERAL WALL BASE	SP-1	MANUF: STYLE:	ASI GLOBAL PARTITIONS SOLID PLASTIC (HDPE)		COLORS.
LV-1	MANUF:	PATCRAFT		COLOR:	IVORY ESSENCE SPECKLE - 9500		
	STYLE:	1600V - 7X48" PLANKS		AREA:	RESTROOM SHOWER DOORS AND		
	COLOR:	00796 RUM		INSTALLATION:	TOILET PARTITIONS REFER TO ELEVATIONS		
	AREA:	MAIN FLOORING THOUGHOUT		NOTES:	GC MAY PROVIDE APPROVED EQUAL		
	NOTES:	GC MAY PROVIDE APPROVED EQUAL UNDER SUBSTITUTION REQUEST.			UNDER SUBSTITUTION REQUEST.		

SHEET NOTES

- EPAIR EXISTING FRAMES AS NEEDED.
- LACE ANY DAMAGED WINDOW SILLS, MATCH
- EPAIR ANY EXISTING DAMAGED DRYWALL T ON THE FINISH SCHEDULE.
- RY TO MATCH EXISTING.
- EPAIR ANY CEILING DAMAGE DURING W PAINT ON THE FINISH SCHEDULE.
- EW MATERIALS IN SPACE AT LEAST 3 DAYS BEFORE
- ERIOR ELEVATIONS FOR ADDITIONAL INFORMATION.
- OOR SCHEDULE FOR DOOR AND FRAME FINISH

	ARCHITECTURAL DESIGN COLLABORATIVE 945 N. PENNSYLVANIA AVENUE WINTER PARK, FLORIDA 32789 OFFICE: (407) 629-1188 FAX: (407) 388-1220 WWW. ADCINTERNATIONAL.NET
	STATE OF FLORIDA AA-C001315 MARIA FERREIRA AR-95752 Architect • Seal/Signature
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KEY PLAN	Consultant • Seal/Signature
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ORS TO REMAIN, REPAIR AND/OR REPLACE ANY AMAGED HINGES AS NEEDED. REPLACE ALL KNOB TH LEVEL HANDLES ON ALL DOORS THROUGHOUT

WINDOWS AND FRAMES DURING CONSTRUCTION.


, REPAIR AND PAINT EXISTING WINDOW FRAMES AS

T BUILDING. PAINT TO MATCH EXISTING OR REFER

OR REPLACE ANY DAMAGED FLOORING/CARPETING

ON AS REQUIRED. PAINT TO MATCH EXISTING OR

N TO ALLOW THE NEW MATERIAL TO ACCLIMATE TO

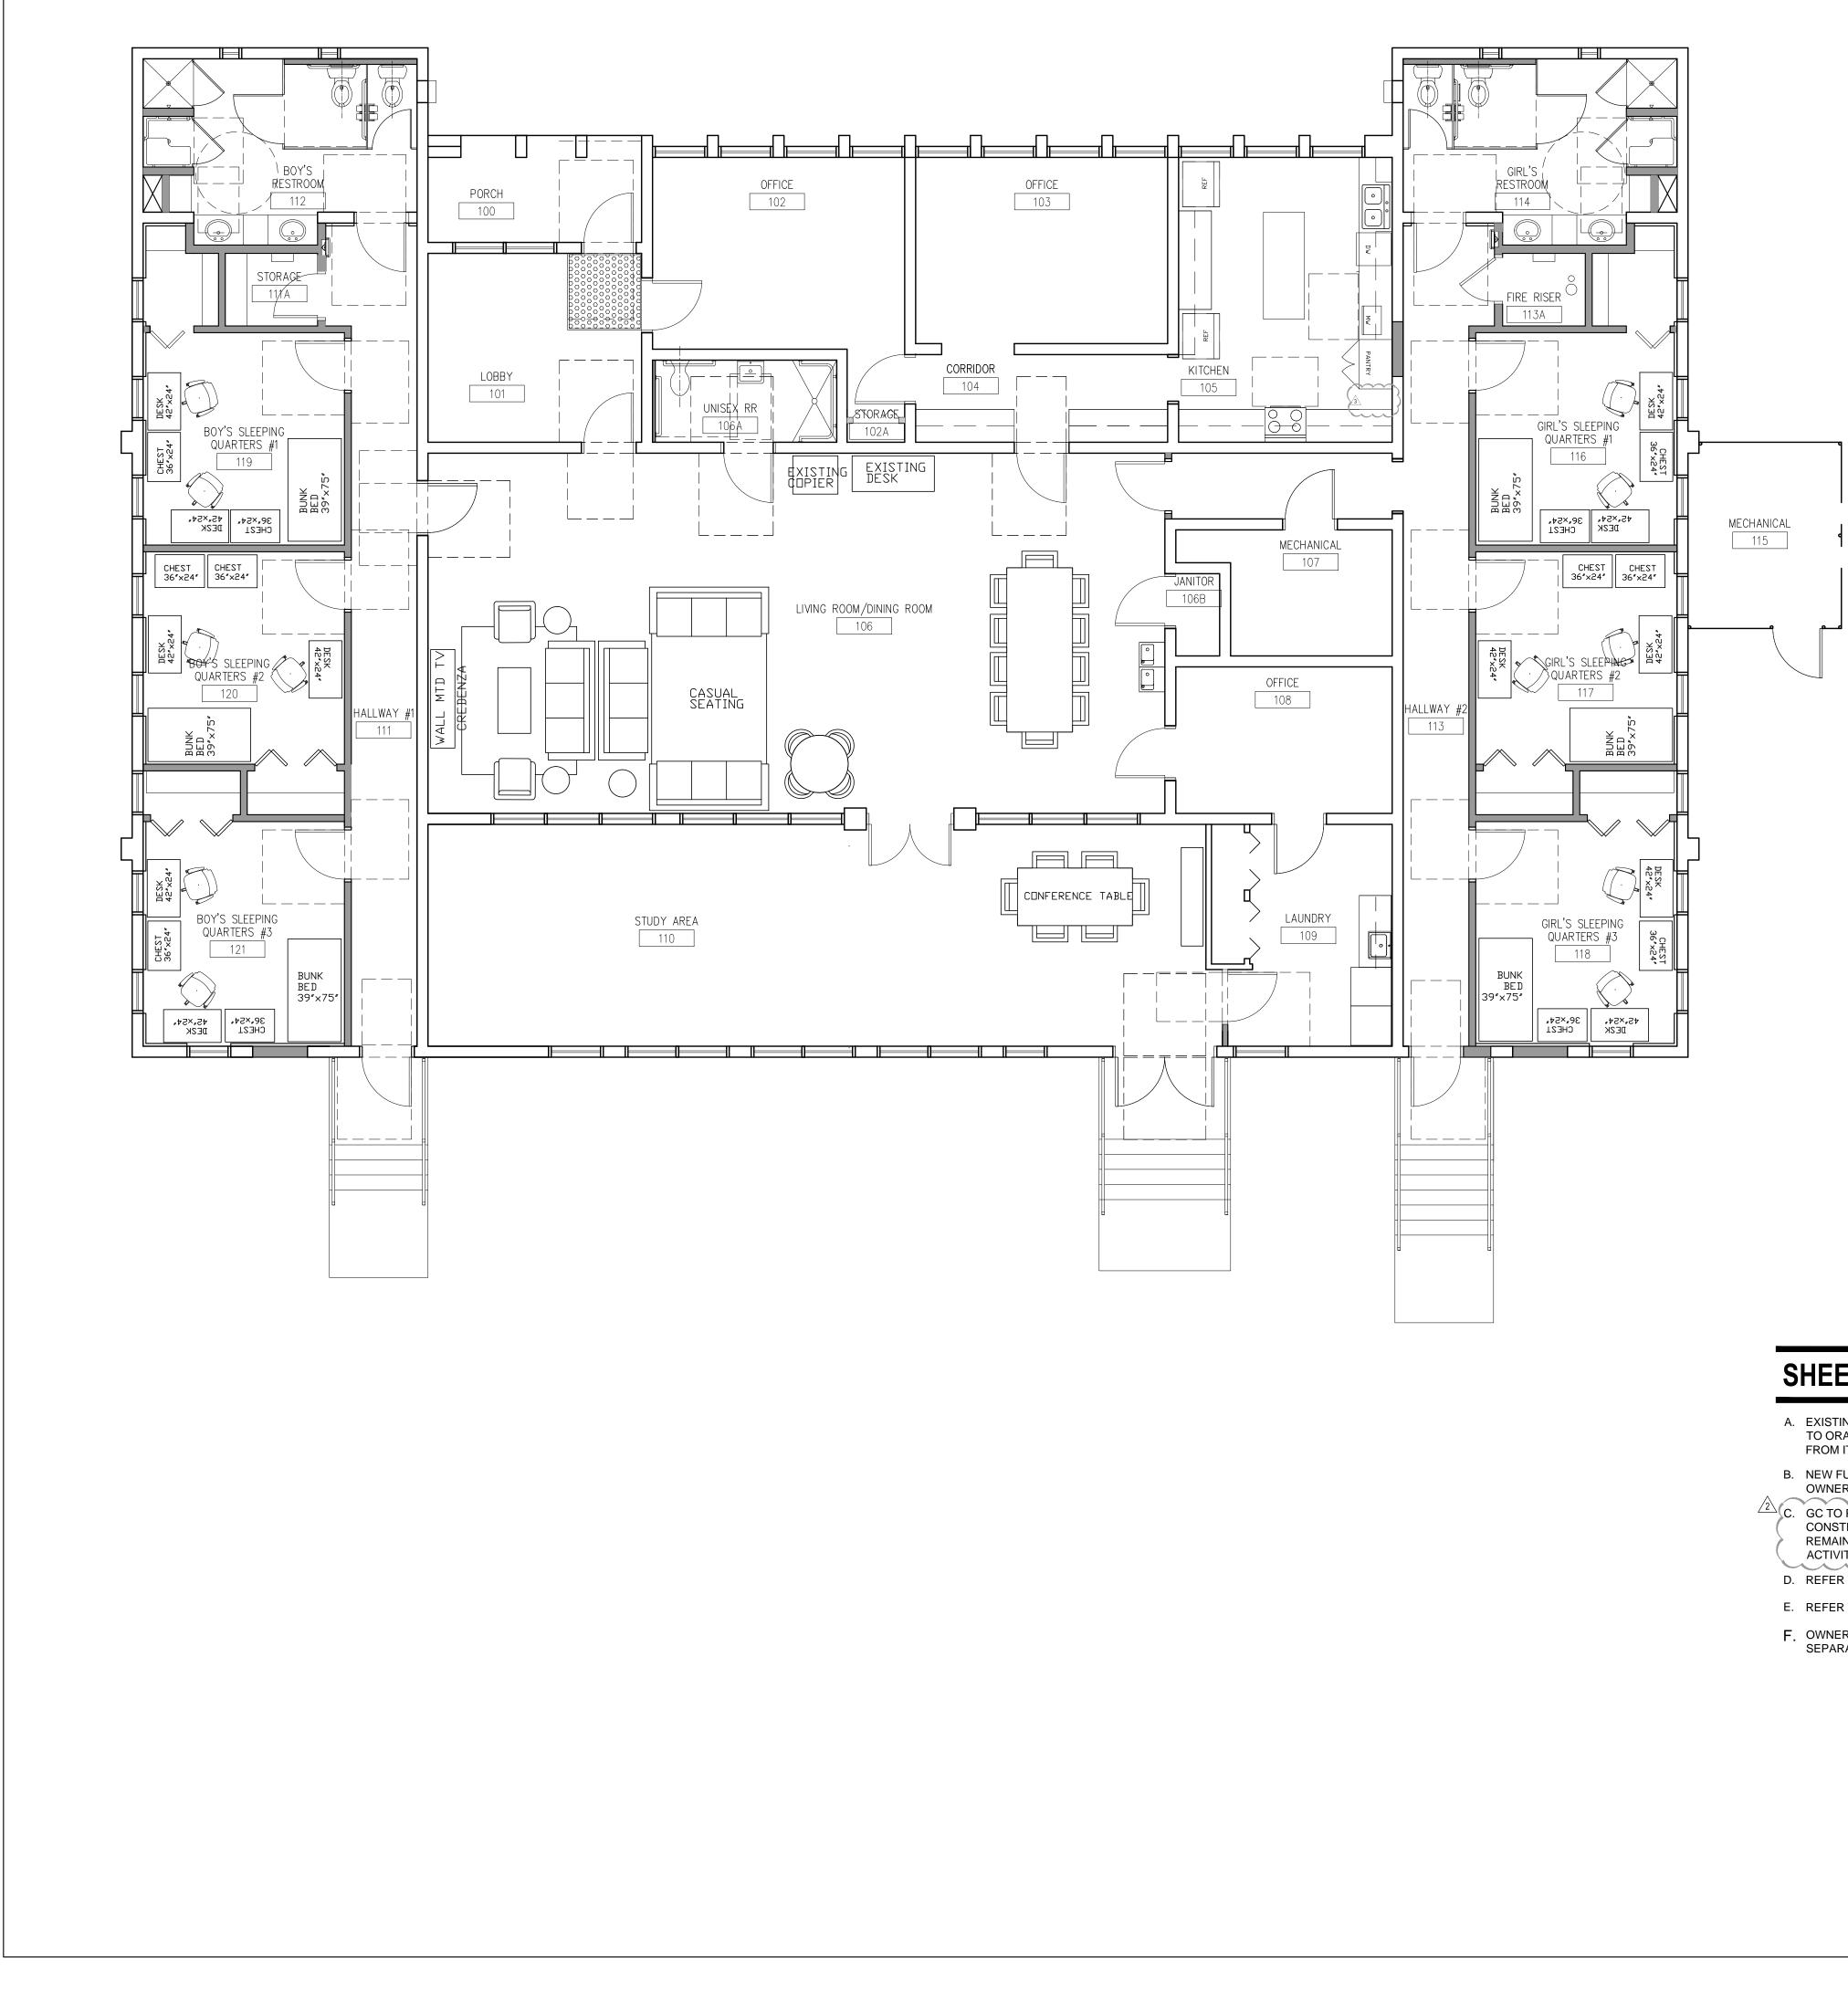

SHEET NOTES

- A. EXISTING OFFICE FURNITURE AND EQUIPMENT TO BE RETURNED TO ORANGE COUNTY FACILITIES. COORDINATE WITH MANAGER FROM ITEMS TO BE REMOVED / REPLACED.
- B. NEW FURNITURE AND EQUIPMENT SHALL BE PURCHASED BY OWNER. GC TO COORDINATE DELIVERY AND INSTALLATION.
- $\frac{2}{2}$ C. GC TO PROTECT REMAINING FURNITURE AND EQUIPMENT FROM CONSTRUCTION ACTIVITIES AND PROVIDE DEEP CLEANING OF REMAINING FURNITURE IF SOILED FROM CONSTRUCTION ACTIVITIES.
- D. REFER TO THIS SHEET FOR FURNITURE LAYOUT.
- E. REFER TO SPECIFICATION BOOK FOR ADDITIONAL INFORMATION.
- F. OWNER TO PURCHASE AND PROCURE FURNITURE UNDER SEPARATE CONTRACT.


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	STATE OF FLORIDA MARIA FERREIRA Architect • Seal/Signature	AA-C001315 AR-95752
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	Consultant • Seal/Signature	
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KEY PLAN AREA OF WORK

NEW FLOOR PLAN


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TAG	ITEM	MANUFACTURE	CESSORIES SCHEDU
1	PAPER TOWEL DISPENSOR	WAUSAU	75010
2	SOAP DISPENSOR - TOUCH FREE	GOJO	1919-04
3	CHANNEL FRAME MIRROR (FULLY ADHERE TO WALL)	BOBRICK	B-1658 2436
4	GRAB BAR, 36" LONG	BOBRICK	B-5806
5	GRAB BAR, 42" LONG	BOBRICK	B-5806
6	GRAB BAR, 18" LONG, VERTICAL	BOBRICK	B-5806
7	TOILET PAPER DISPENSER - SURFACE MTD.	BOBRICK	B-265
8	SANITARY NAPKIN DISPOSAL	BOBRICK	B-254
9A	RESTROOM SIGN - WOMEN	EAGLESTONE OR EQ.	5304 WHITE ON
9B	RESTROOM SIGN - MEN	EAGLESTONE OR EQ.	5302 WHITE ON
10	RESTROOM SIGN - UNISEX ACCESSIBLE	EAGLESTONE OR EQ.	5306 WHITE ON
11	TWO-WALL GRAB BAR	BOBRICK	B-6861
12	GRAB BAR, 48" LONG	BOBRICK	B-5806
13	GRAB BAR, 24" LONG	BOBRICK	B-5806
14	ADA SHOWER SEAT	BOBRICK	B-5181
15	SEAT COVER DISPENSER	BOBRICK	B-221

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		945 N. PENNSYLVANIA AVENUE WINTER PARK, FLORIDA 32789 OFFICE: (407) 629-1188 FAX: (407) 388-1220 WWW. ADCINTERNATIONAL.NET	
	3	STATE OF FLORIDA MARIA FERREIRA Architect • Seal/Signature	AA-C001315 AR-95752
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SCALE: 1/2	2" = 1'-0"	Project: GREAT OAKS VILLAGE WITTEN ADA UPGRADES AND RENOVA 1784 E. MICHIGAN STREET ORLANDO, FL 32806	
		Issue Date & Issue Description 07.27.16 60% CD SET 09.15.16 90% CD SET 12.02.16 PERMIT/BID SE 01.25.17 PERMIT COMM	
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10DEL NO.	REMARKS BLACK TRANSLUCENT BLACK AND SILVER BRIGHT-POLISHED STAINLESS STEEL FINISH - TEMPERED	Sheet Title:	
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	SATIN STAINLESS STEEL REVERSIBLE SOLID PHENOLIC FOLDING SHOWER SEAT STAINLESS STEEL SURFACE MOUNTED	A08.	01

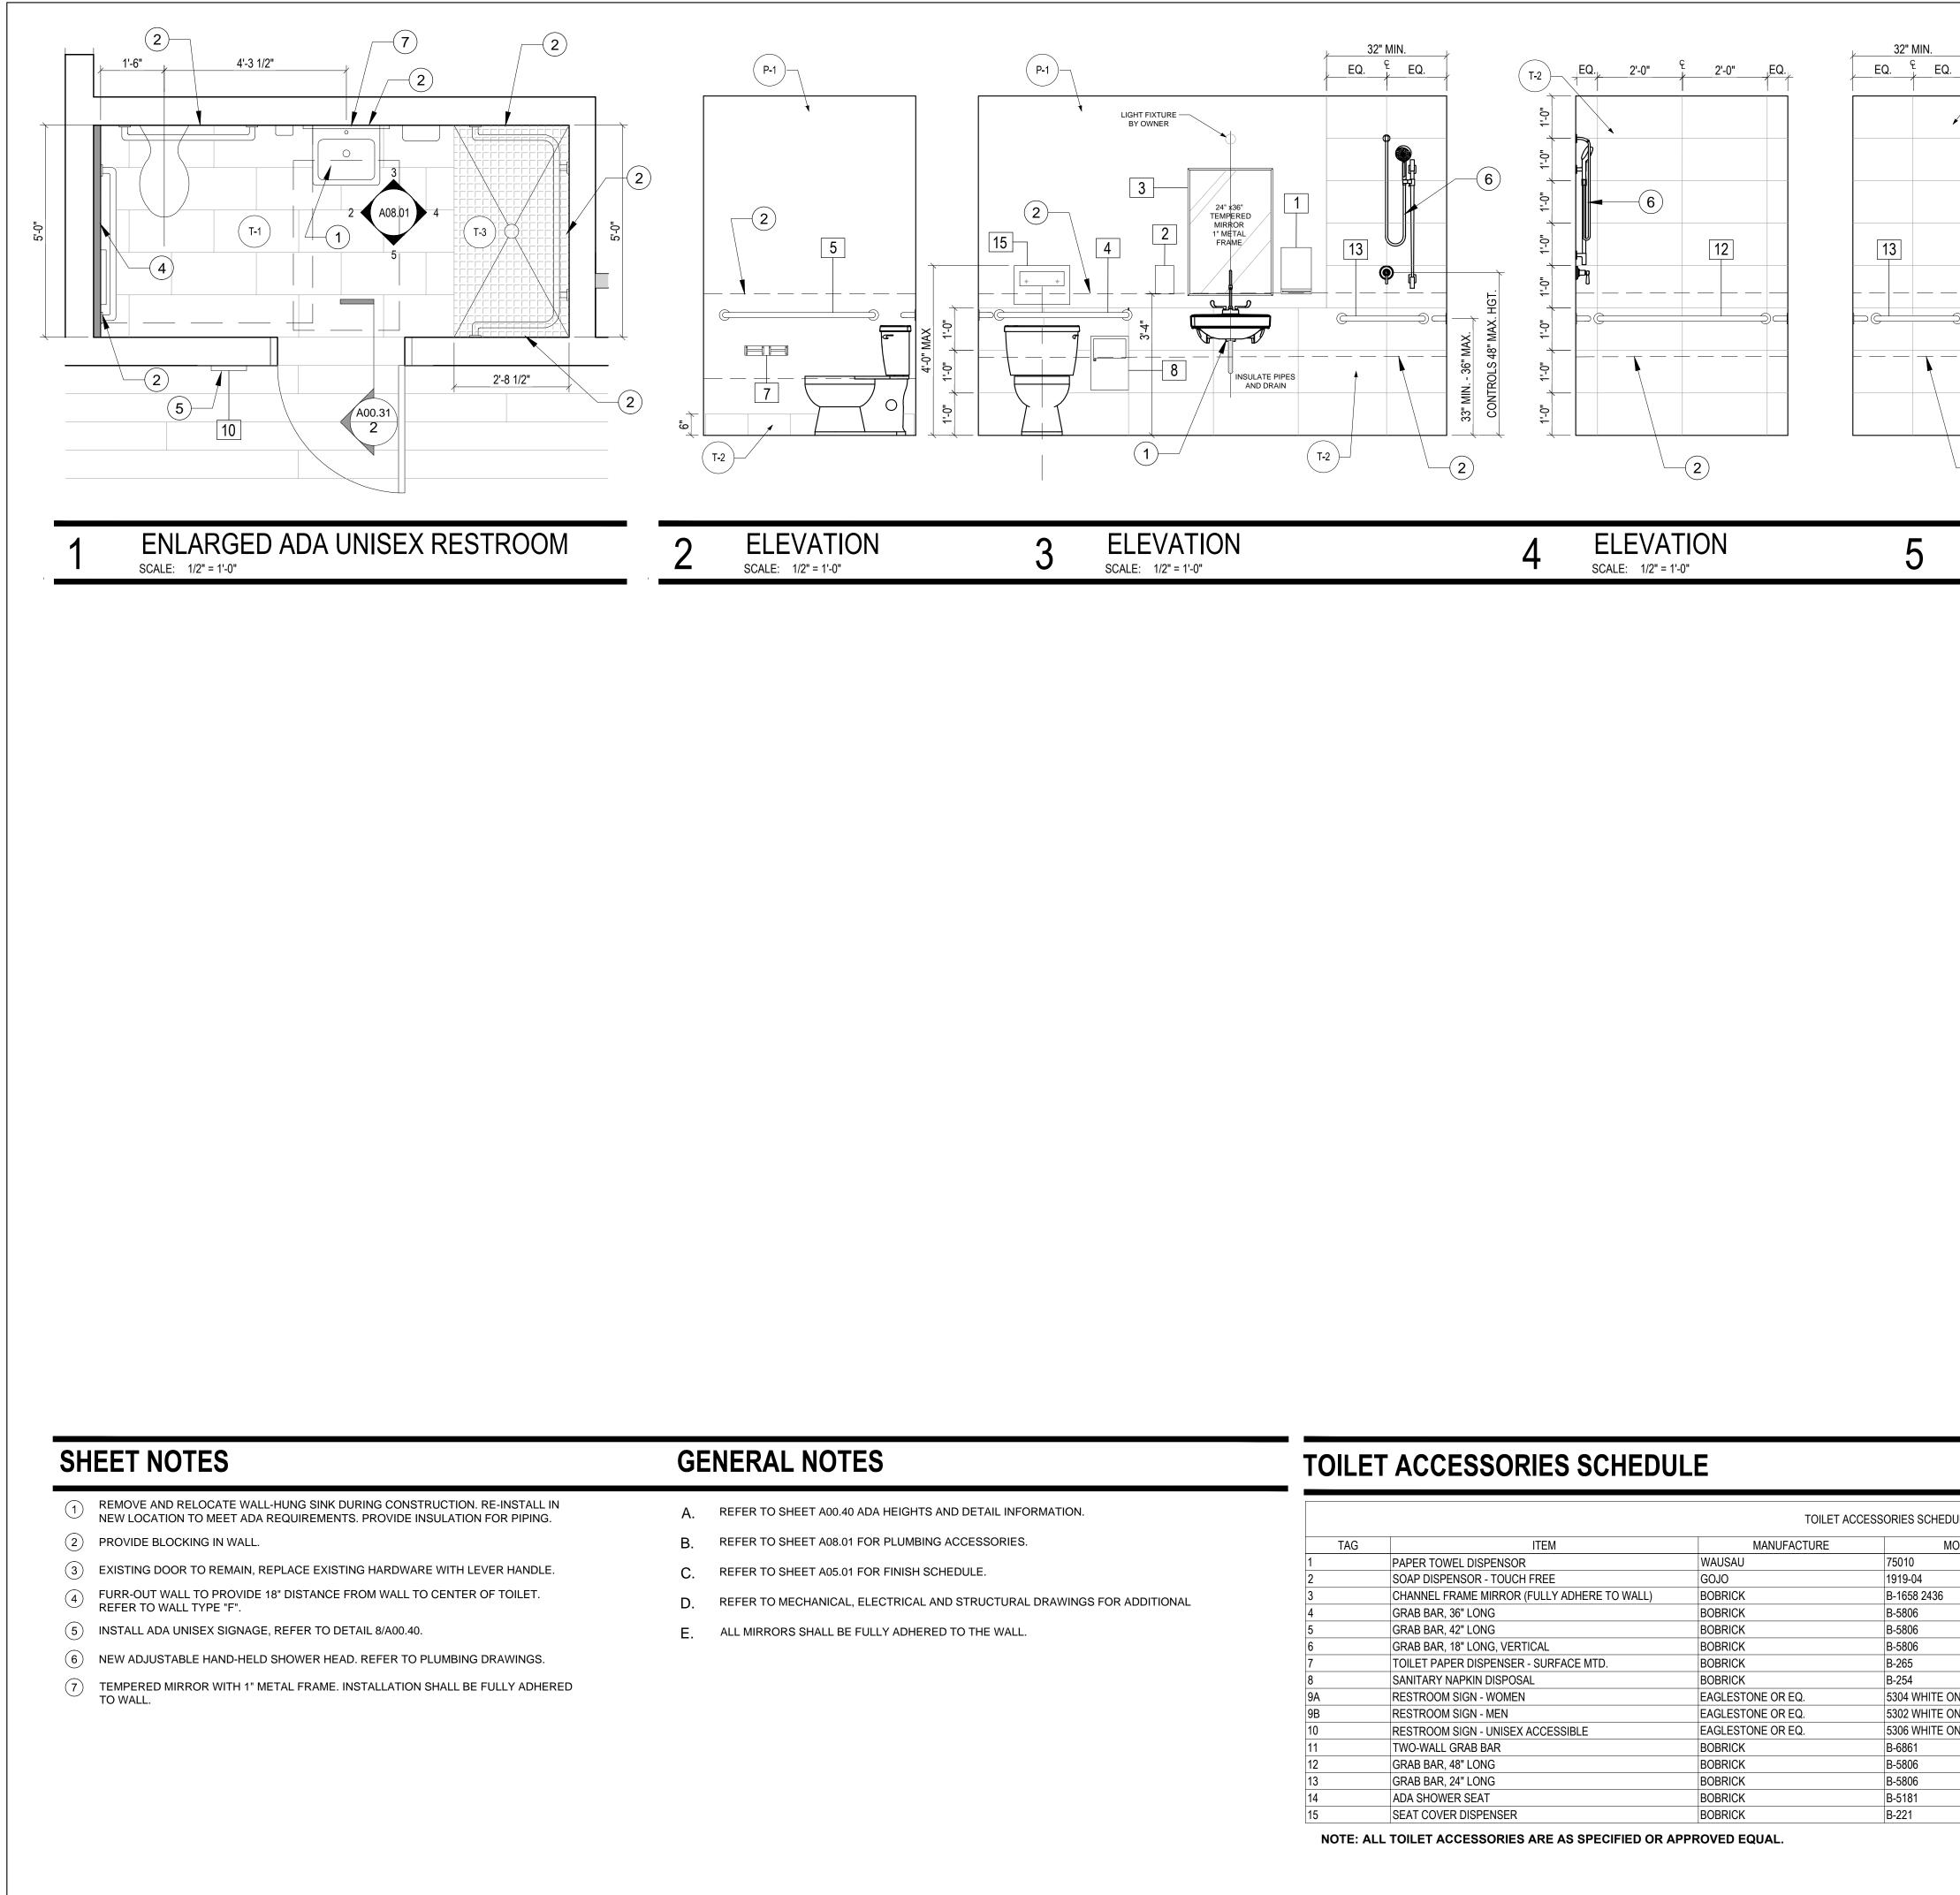

7 NEW ADJUSTABLE HAND-HELD SHOWER HEAD WITH CONTROL VALUE. REFER TO PLUMBING DRAWINGS.


8 NEW FIXED SHOWER HEAD WITH CONTROL VALUE, REFER TO PLUMBING DRAWINGS.

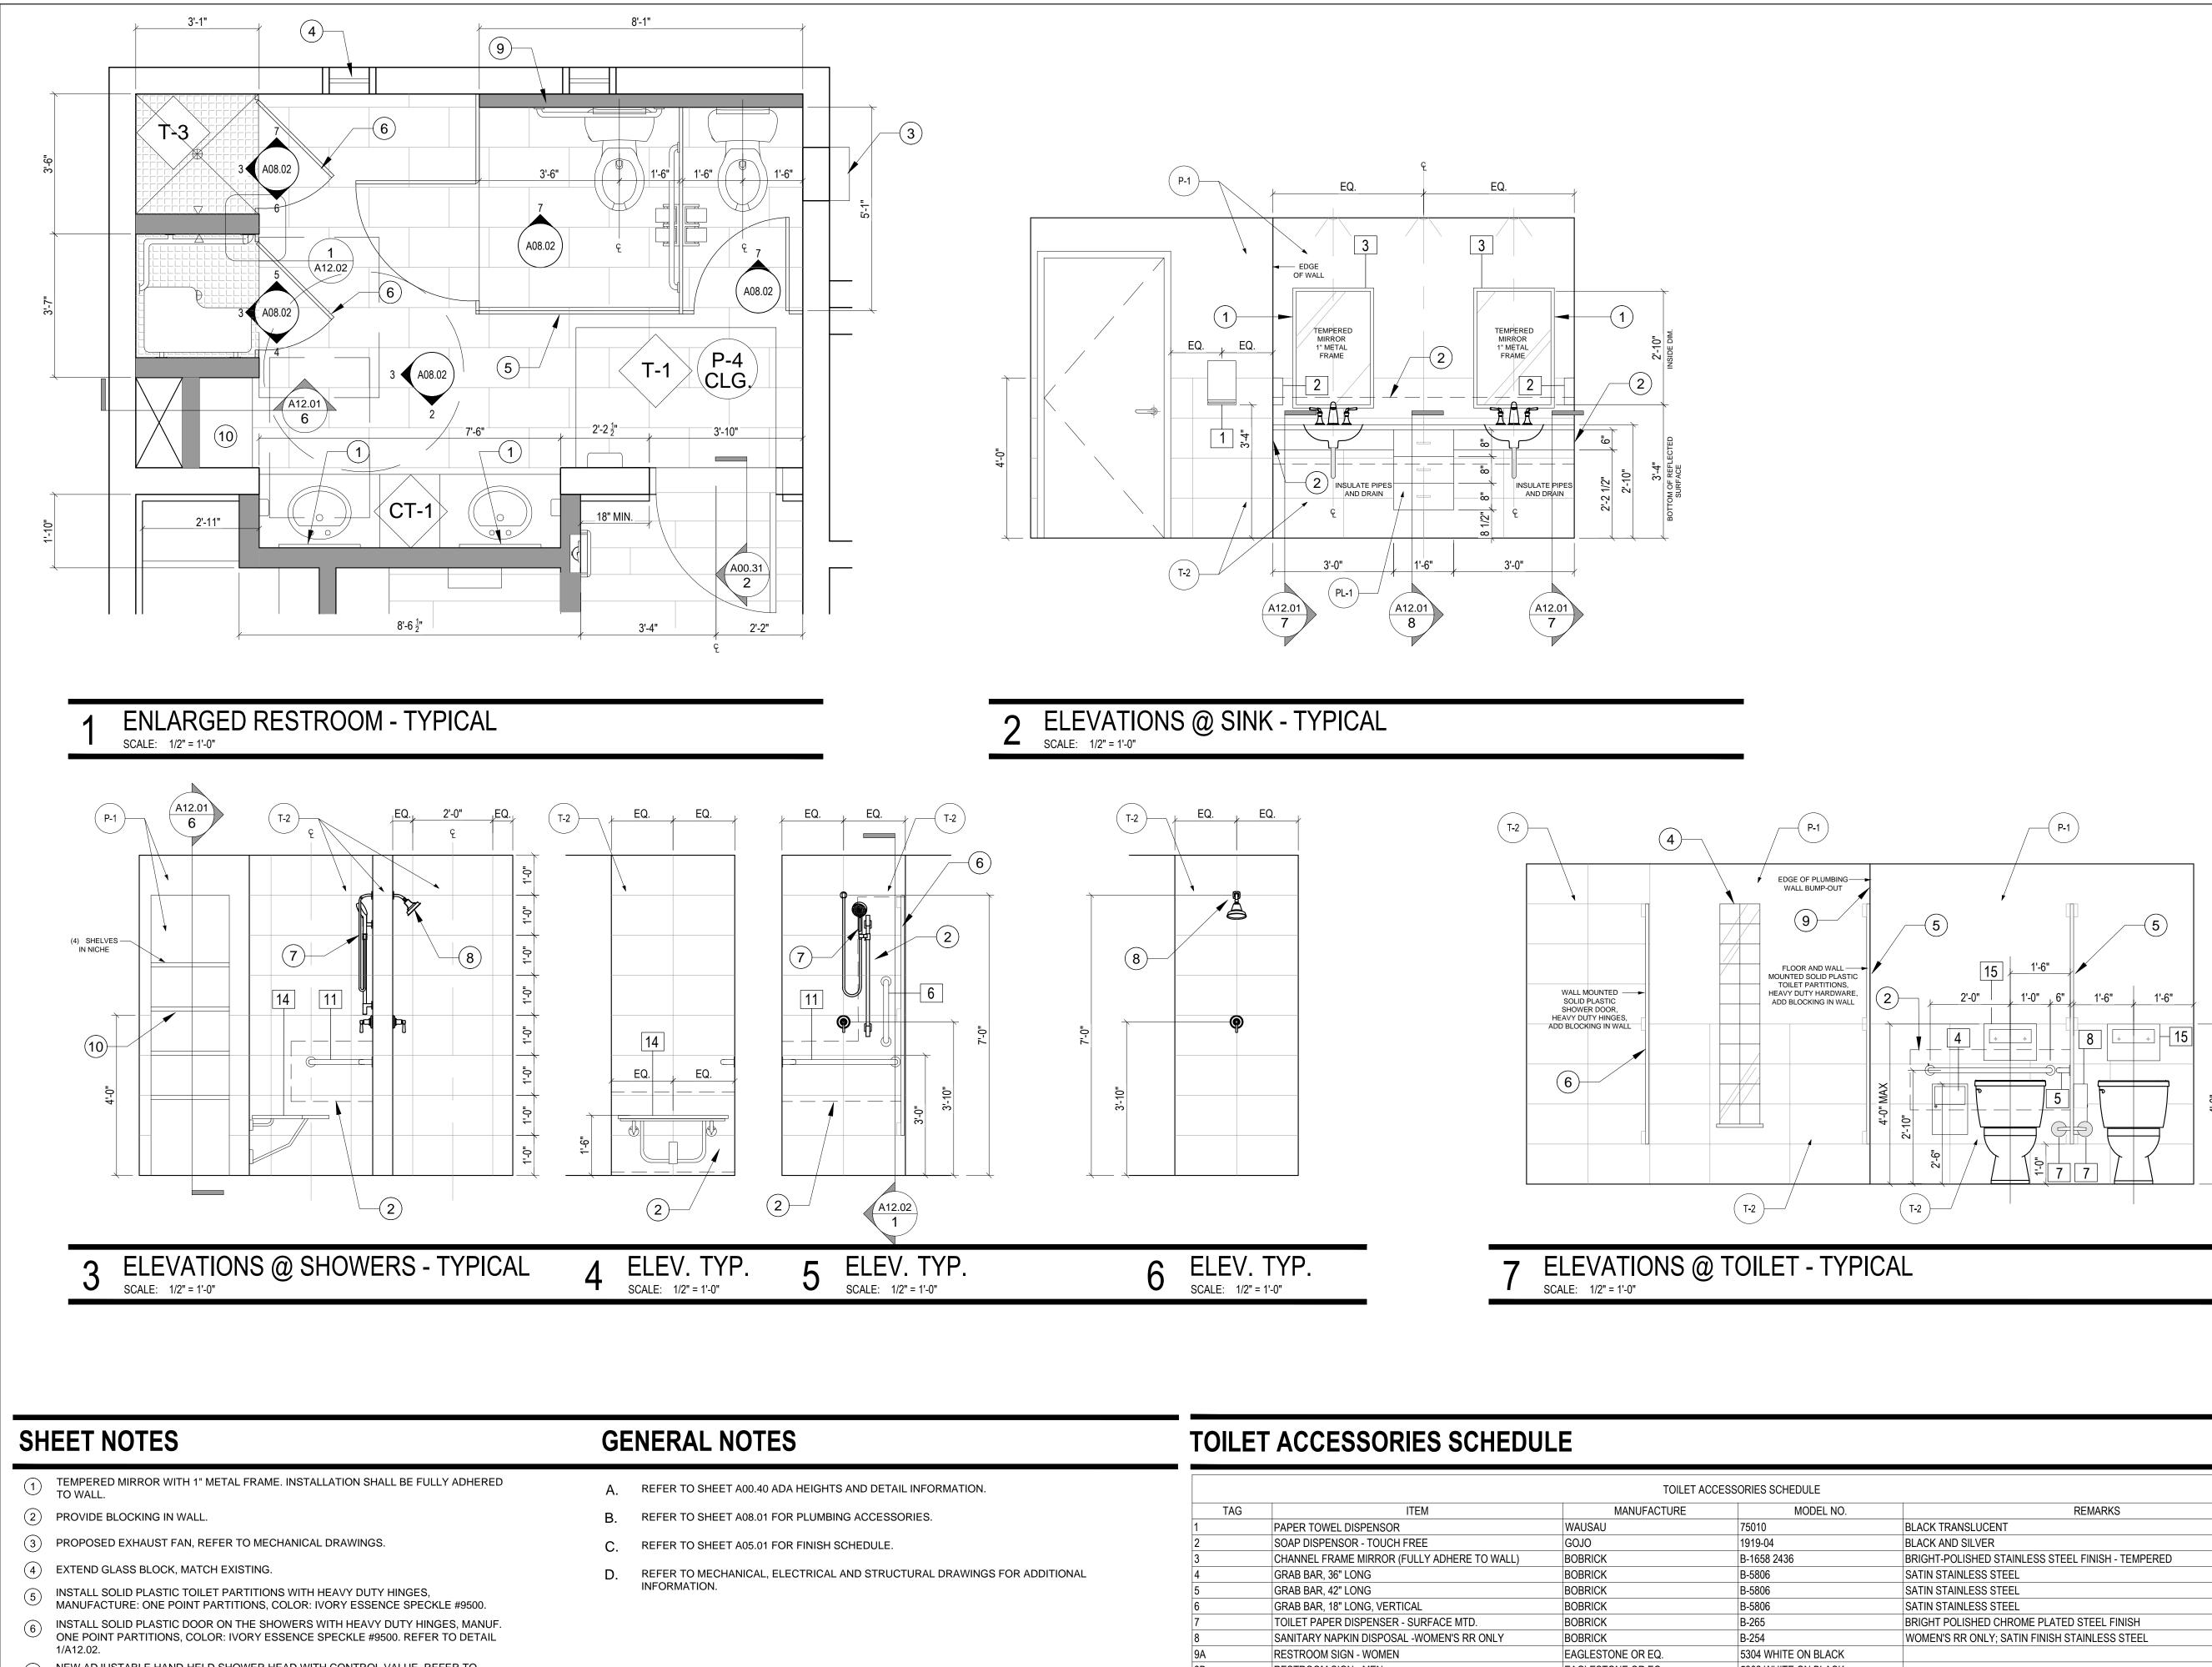
(9) FURR-OUT WALL TO PROVIDE PLUMBING WALL . REFER TO WALL TYPE "D".


(10) INSTALL FOUR (4) WOODEN PAINTED SHELVES, REFER TO DETAIL 6/A12.01

TAG	ITEM	MANUFACTURE	MODEL NO.	REMARKS		
	PAPER TOWEL DISPENSOR	WAUSAU	75010	BLACK TRANSLUCENT		
	SOAP DISPENSOR - TOUCH FREE	GOJO	1919-04	BLACK AND SILVER		
	CHANNEL FRAME MIRROR (FULLY ADHERE TO WALL)	BOBRICK	B-1658 2436	BRIGHT-POLISHED STAINLESS STEEL FINISH - TEMPERED		
	GRAB BAR, 36" LONG	BOBRICK	B-5806	SATIN STAINLESS STEEL		
	GRAB BAR, 42" LONG	BOBRICK	B-5806	SATIN STAINLESS STEEL		
	GRAB BAR, 18" LONG, VERTICAL	BOBRICK	B-5806	SATIN STAINLESS STEEL		
	TOILET PAPER DISPENSER - SURFACE MTD.	BOBRICK	B-265	BRIGHT POLISHED CHROME PLATED STEEL FINISH		
	SANITARY NAPKIN DISPOSAL -WOMEN'S RR ONLY	BOBRICK	B-254	WOMEN'S RR ONLY; SATIN FINISH STAINLESS STEEL		
A	RESTROOM SIGN - WOMEN	EAGLESTONE OR EQ.	5304 WHITE ON BLACK			
В	RESTROOM SIGN - MEN	EAGLESTONE OR EQ.	5302 WHITE ON BLACK			
0	RESTROOM SIGN - UNISEX ACCESSIBLE	EAGLESTONE OR EQ.	5306 WHITE ON BLACK			
1	TWO-WALL GRAB BAR	BOBRICK	B-6861	SATIN STAINLESS STEEL		
2	GRAB BAR, 48" LONG	BOBRICK	B-5806	SATIN STAINLESS STEEL		
3	GRAB BAR, 24" LONG	BOBRICK	B-5806	SATIN STAINLESS STEEL		
4	ADA SHOWER SEAT	BOBRICK	B-5181	REVERSIBLE SOLID PHENOLIC FOLDING SHOWER SEAT		
	SEAT COVER DISPENSER	BOBRICK	B-221	STAINLESS STEEL SURFACE MOUNTED		


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G SHOWER SEAT D				, <u> </u>	

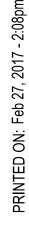

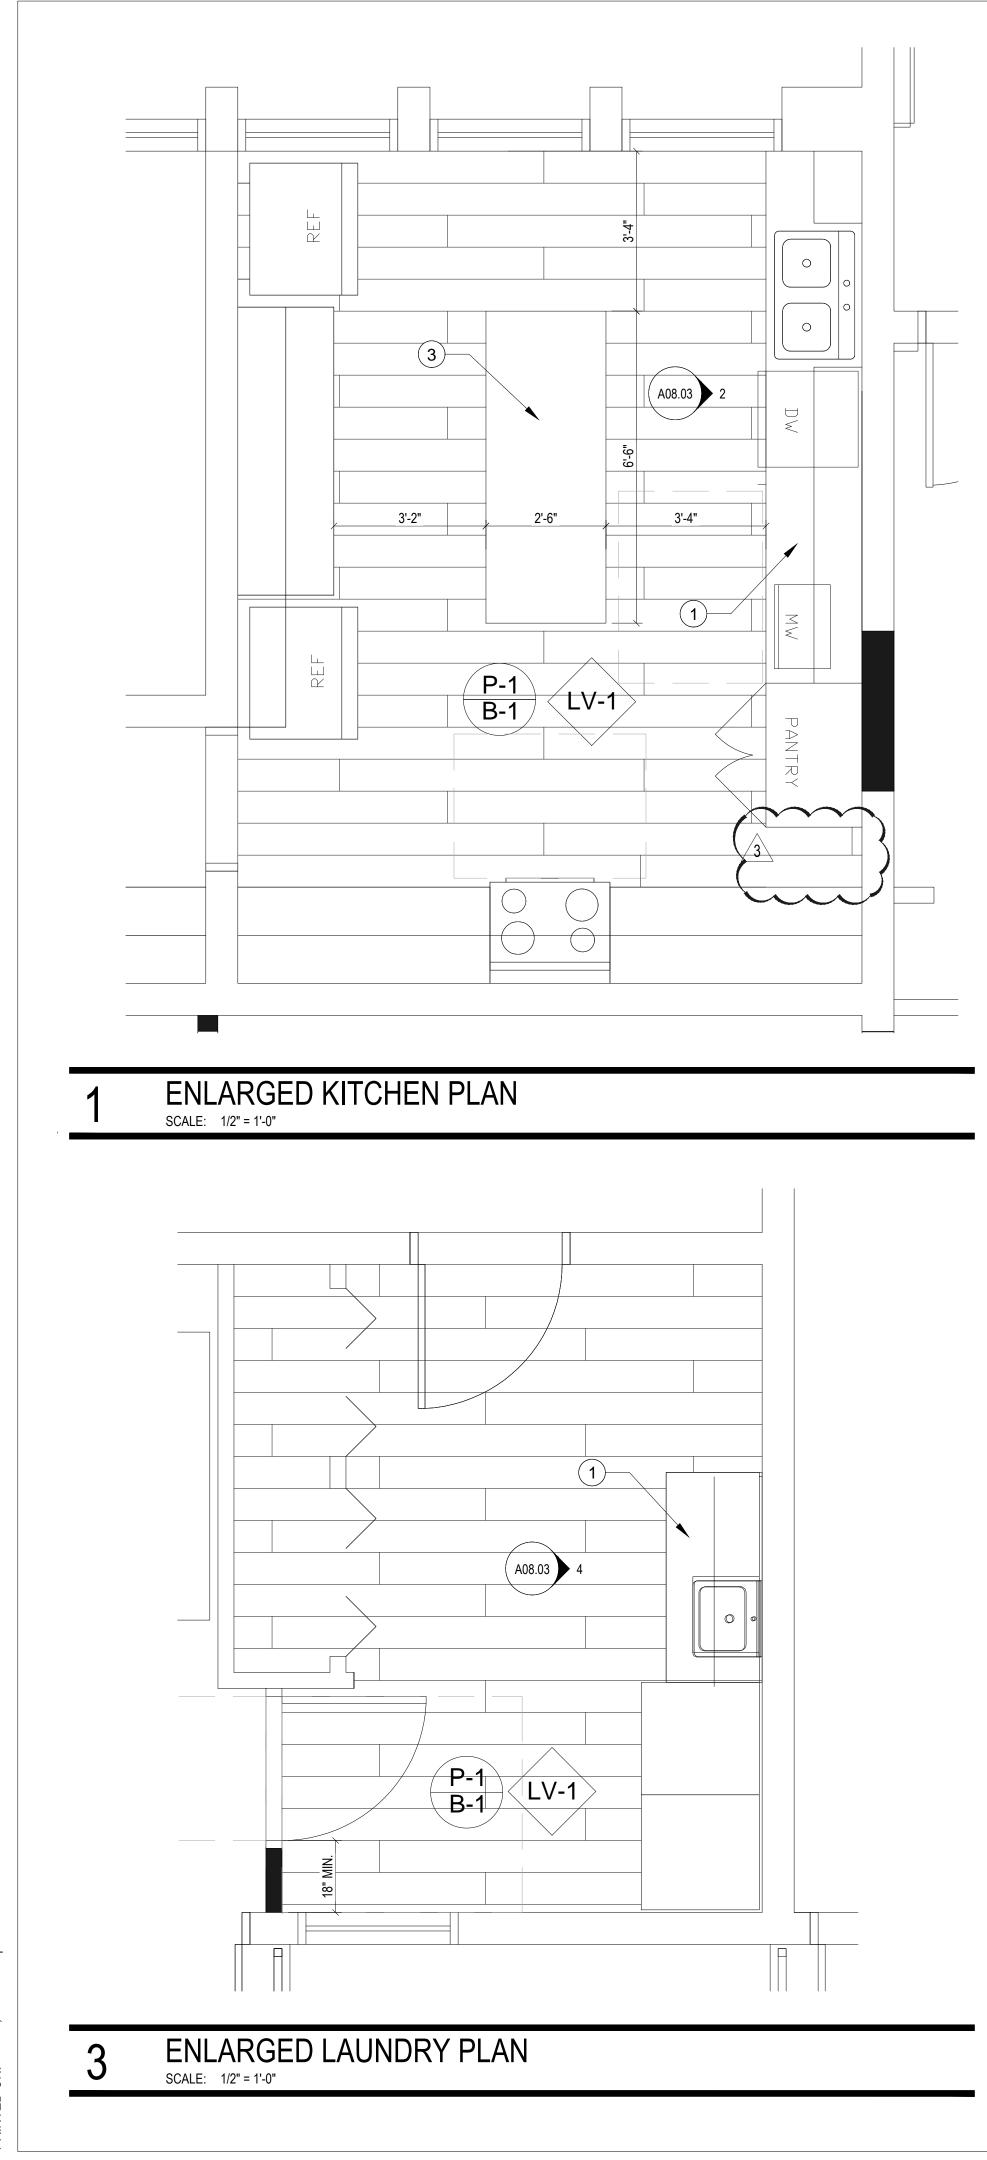

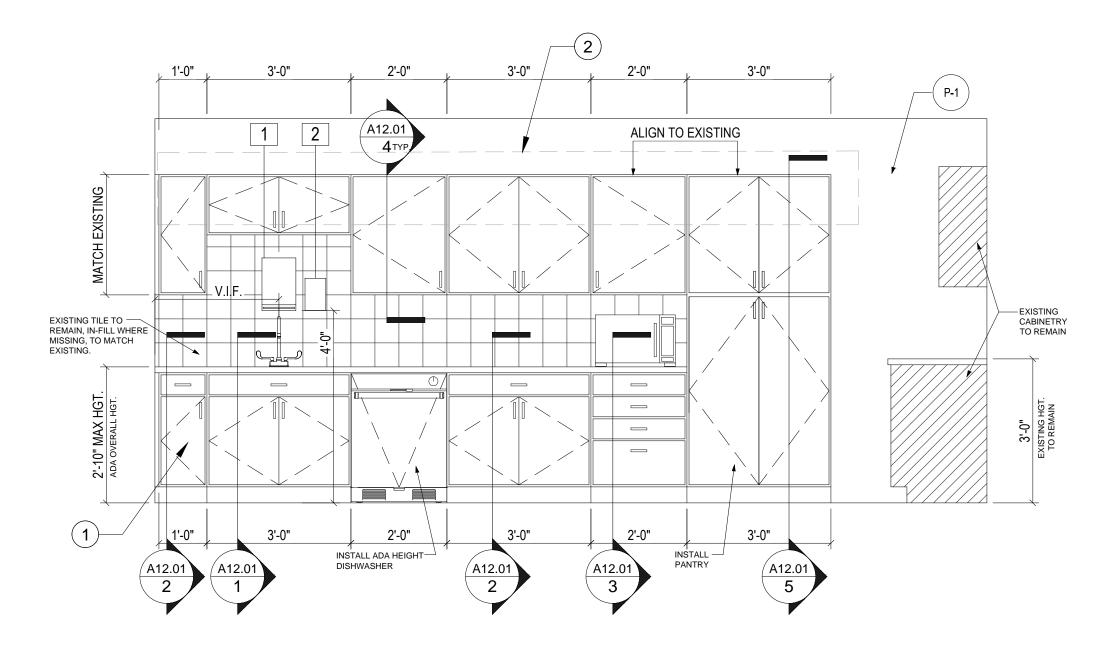

2 ELEVATION - KITCHEN SCALE: 1/2" = 1'-0"

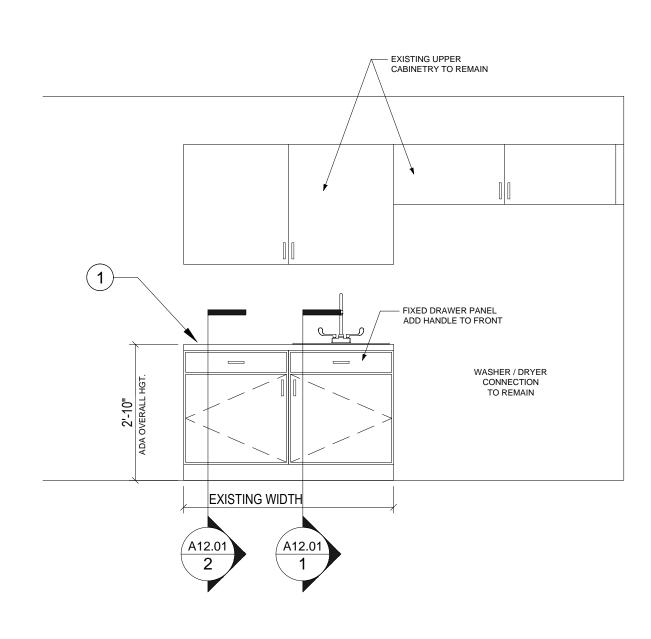

SHEET NOTES

- 1 INSTALL NEW CABINETRY WITH NEW COUNTER TOP, TOTAL OF 34" AFF, FINISH TO MATCH EXISTING.
- (2) PROVIDE BLOCKING IN WALL FOR UPPER CABINETS.
- (3) CUT EXISTING ISLAND COUNTER TO NEW SIZE.



STATE OF FLORIDA
MARIA FERREIRA
Architect Seal/Signature

Project Documents for:

Project:

AA-C001315 AR-95752

SHEET NOTES

- A. REFER TO SHEET A00.40 ADA HEIGHTS AND DETAIL INFORMATION.
- B. REFER TO SHEET A08.01 FOR PLUMBING ACCESSORIES.
- C. REFER TO SHEET A05.01 FOR FINISH SCHEDULE.
- D. REFER TO MECHANICAL, ELECTRICAL AND STRUCTURAL DRAWINGS FOR ADDITIONAL

Issue Date & Issue Description Drawn By Checked By 60% CD SET 07.27.16 JS KA 09.15.16 90% CD SET JS KA 12.02.16 PERMIT/BID SET JS KA 01.25.17 PERMIT COMMENTS JS KA GC / CLIENT COORD. JS 02/24/2017 KA 02.27.17 CONST. ISSUE SET JS KA

FLORIDA

GREAT OAKS VILLAGE WITTENSTEIN COTTAGE

ADA UPGRADES AND RENOVATIONS 1784 E. MICHIGAN STREET ORLANDO, FL 32806

Solution

ORANGE COUNTY CAPITAL PROJECTS DIVISION 400 E SOUTH STREET 5th FLOOR ORLANDO, FL 32801

Project Number			
15253 Drawn By			
JS Checked By			
KA			

File Name

Issue Date 02/27/2017 Project Status CONSTRUCTION ISSUE SET Scale 1/2" = 1'-0"

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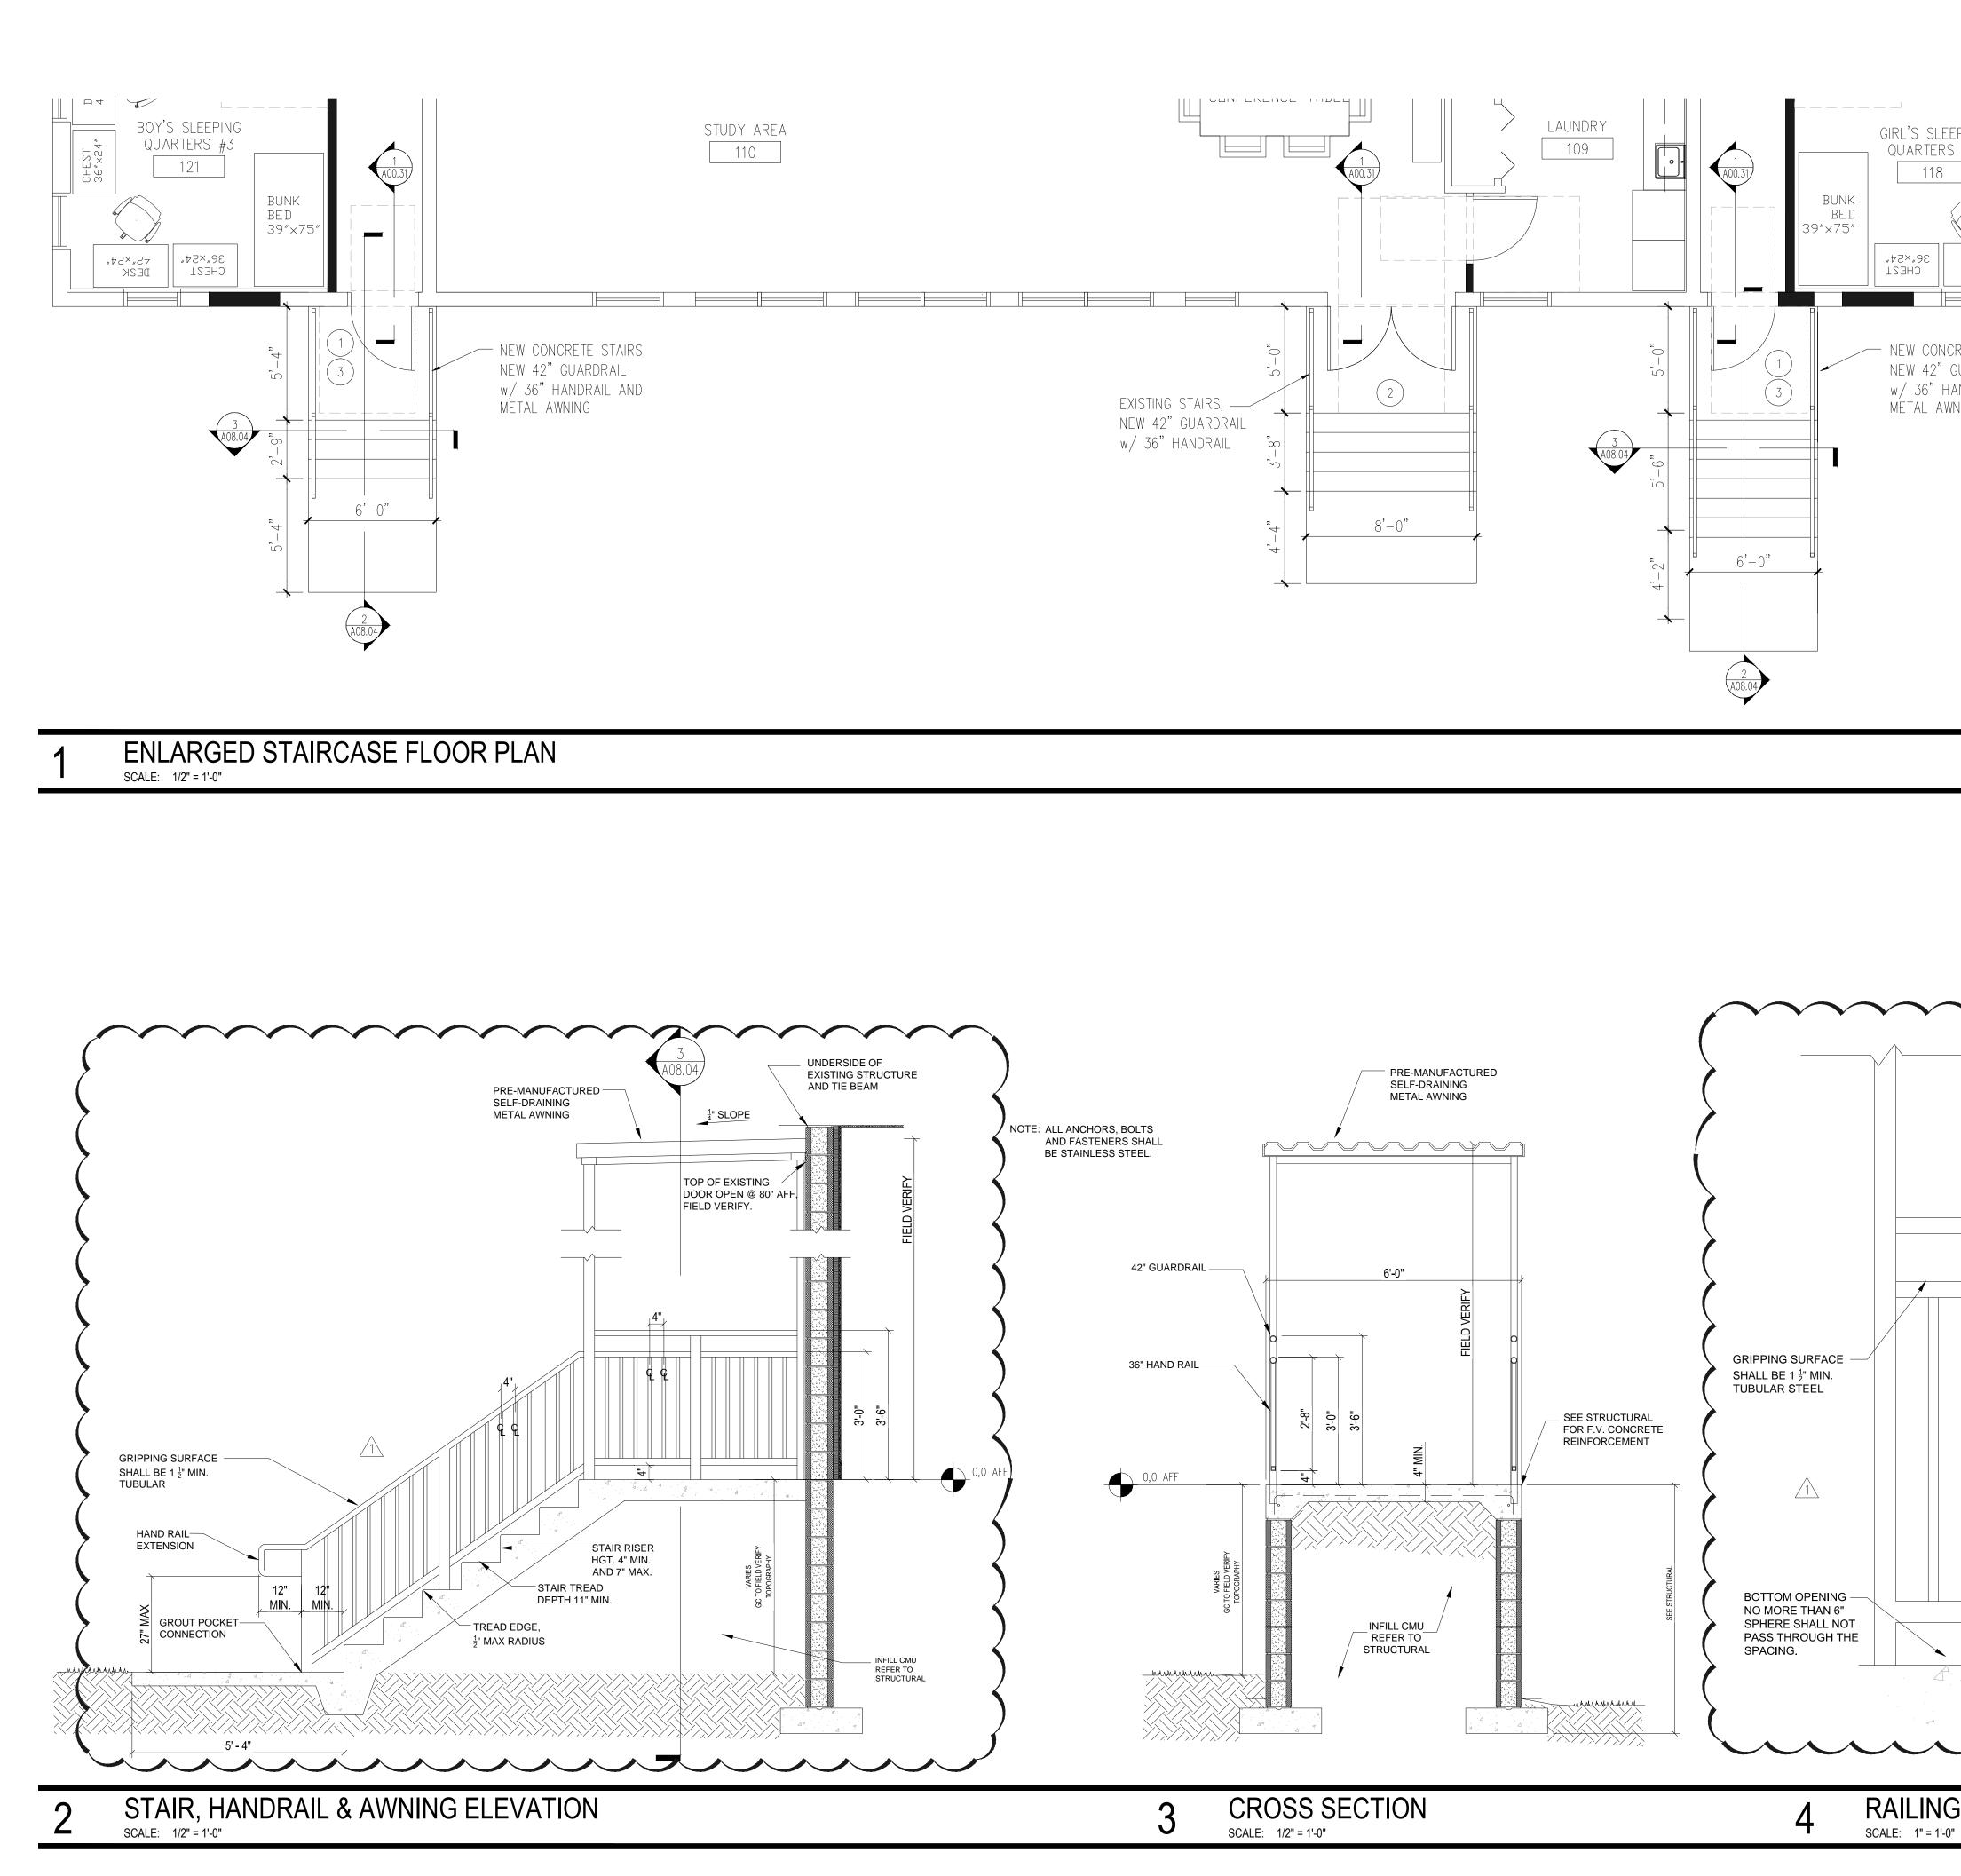
Consultant

Seal/Signature

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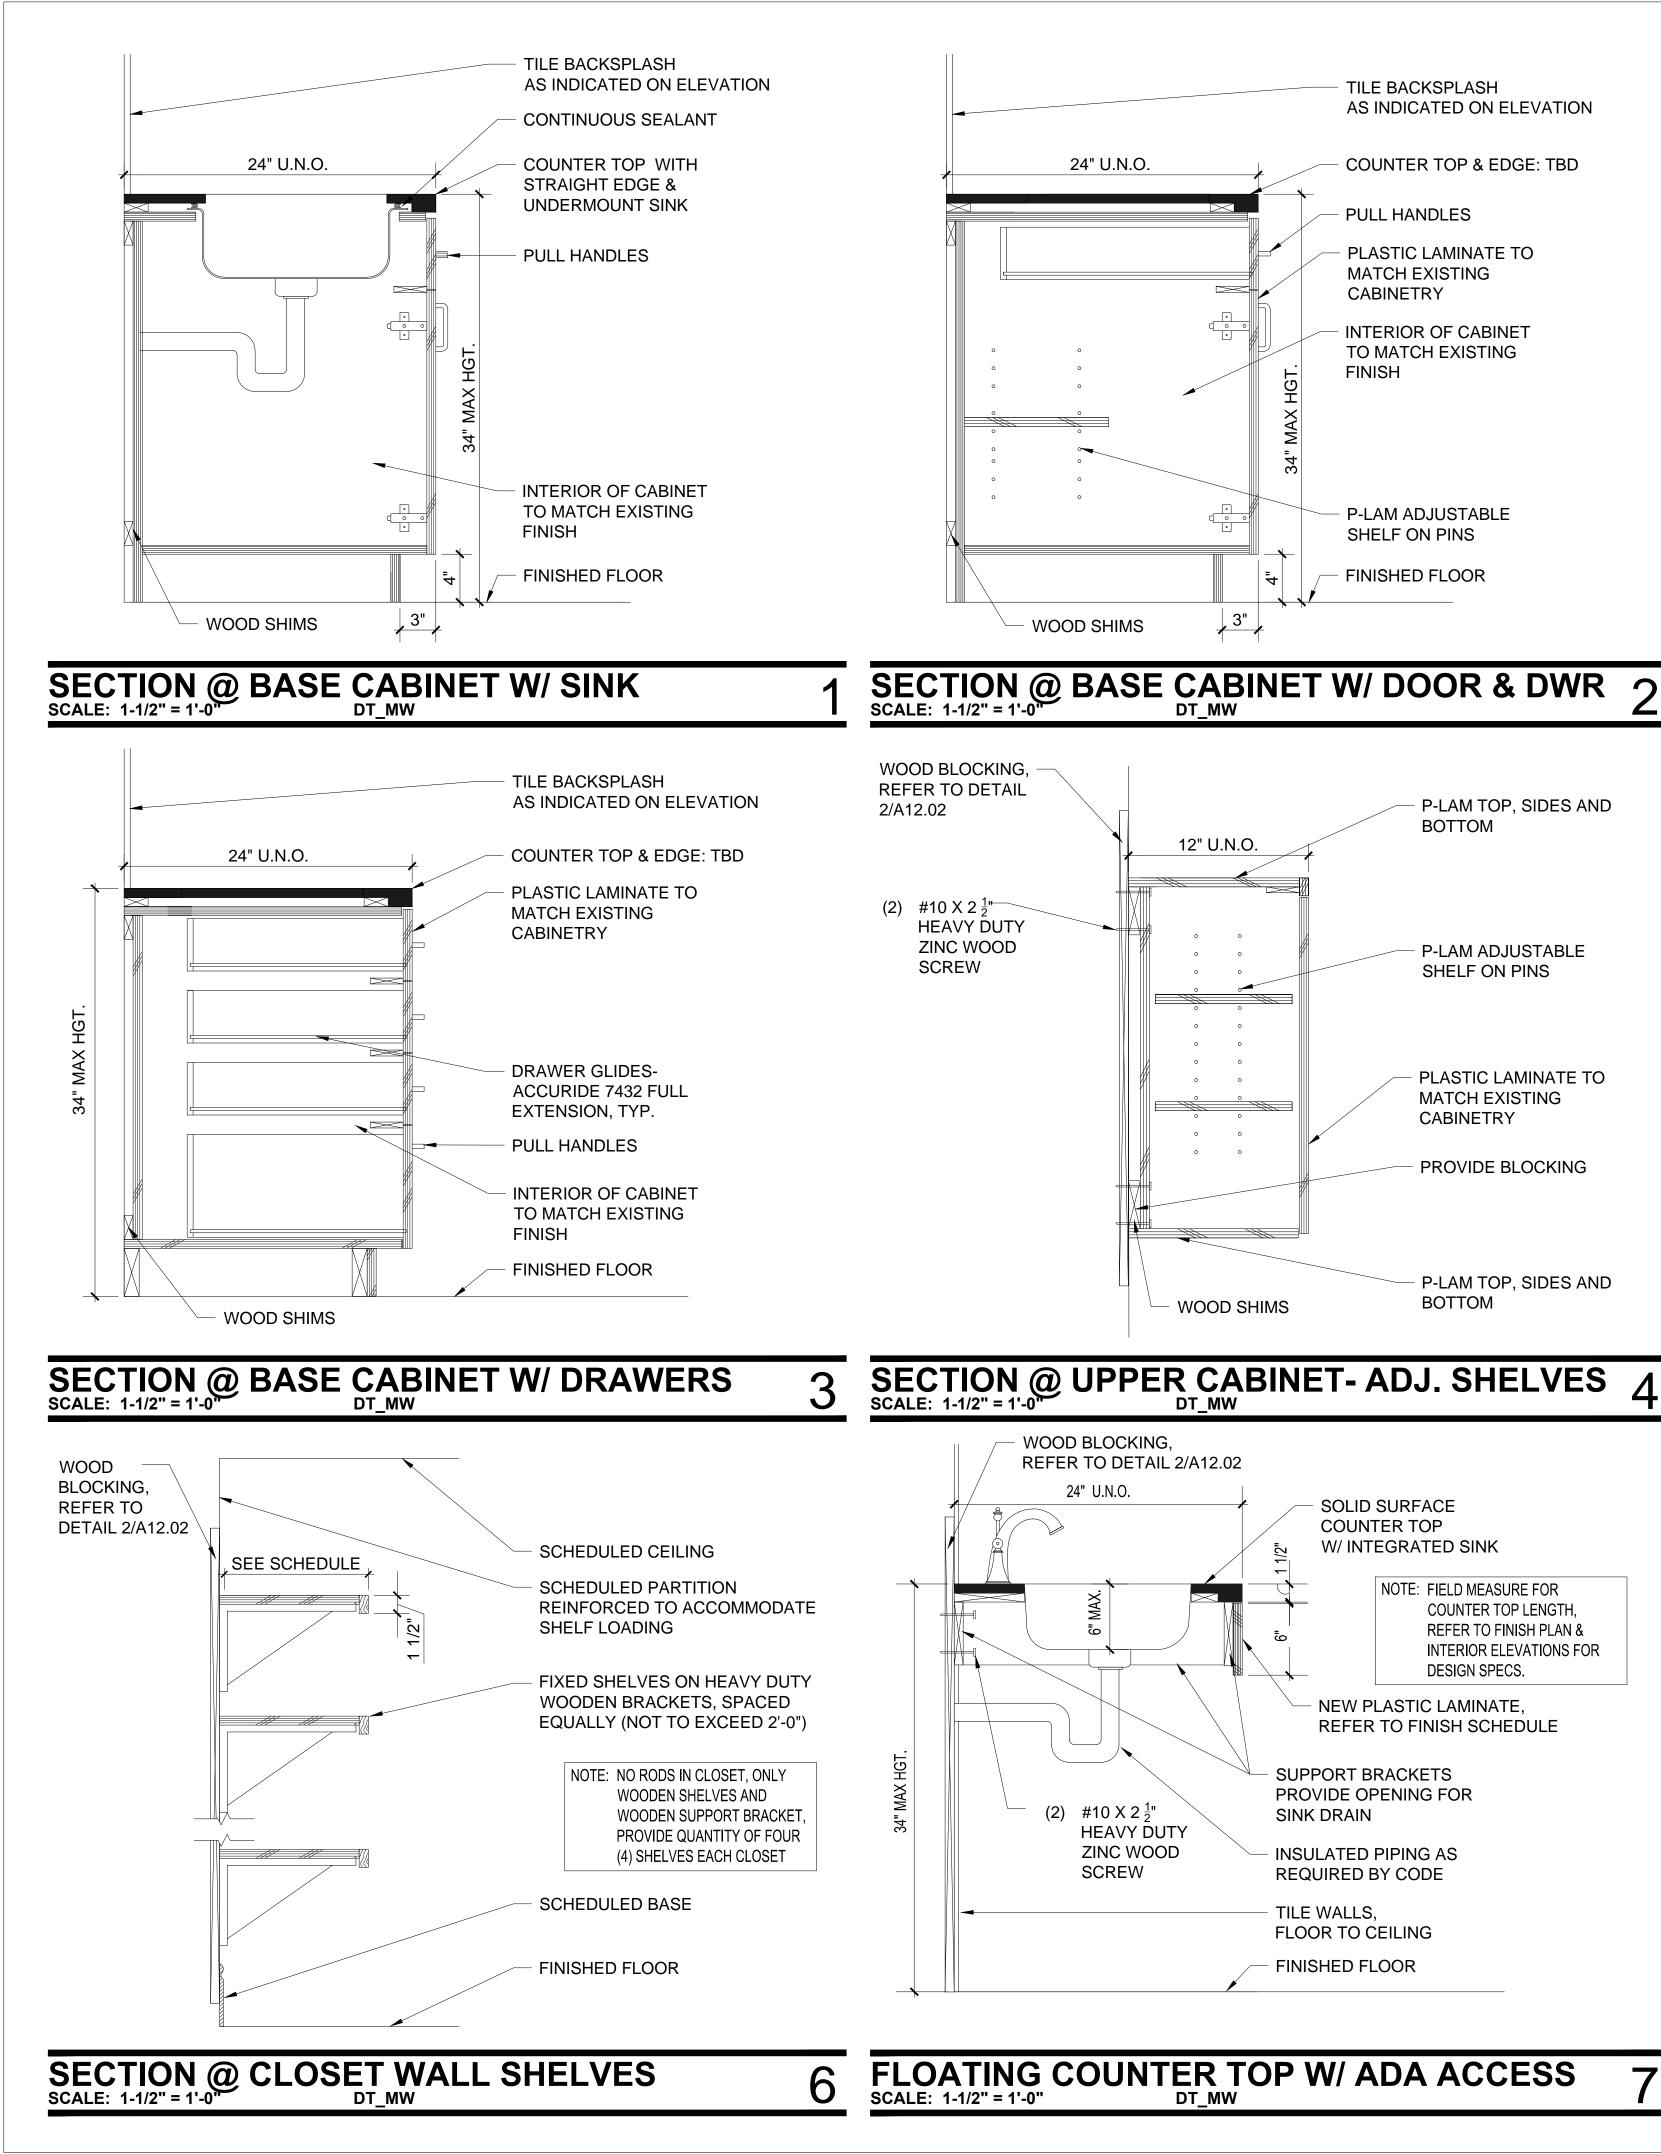
ENLARGED KITCHEN PLAN & ELEVATIONS







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	SHEET NOTES		
EPING 5 #3 5 #3 5 #3	 5X5' MINIMUM CLEAR LANDING 2% SLOPE ALL DIRECTIONS MAX. EXISTING STAIRCASE TO REMAIN, INSTALL NEW HAND RAILING AND PRE-FABRICATED METAL AWNING. CONSTRUCTION NEW STAIRCASE, INSTALL NEW 42" GUARDRAIL AND 36" HAND RAILING AND PRE-FABRICATED METAL AWNING. REFER TO STRUCTURAL DRAWINGS FOR ADDITIONAL INFORMATION. REFER TO GENERAL NOTE "E" ON THIS SHEET FOR SPEC INFO. 	ARCHITECTURAL DESIGN COLLABORATIVE 945 N. PENNSYLVANIA AVENUE WINTER PARK, FLORIDA 32789 OFFICE: (407) 629-1188 FAX: (407) 388-1220 WWW. ADCINTERNATIONAL.NET	
DESK		STATE OF FLORIDA MARIA FERREIRA Architect • Seal/Signature	AA-C001315 AR-95752
		Project Documents for:	
CRETE STAIRS, GUARDRAIL ANDRAIL AND	GENERAL NOTES		A.F.
INING	 A. REFER TO SHEET A00.40 ADA HEIGHTS AND DETAIL INFORMATION. B. REFER TO ELECTRICAL AND STRUCTURAL DRAWINGS FOR ADDITIONAL INFORMATION. C. PRE-ENGINEERED HAND RAILING AND SELF-DRAINING METAL AWNING, TO MEET FLORIDA PRODUCT APPROVALS. PROVIDE SHOP DRAWINGS FOR REVIEW. MANUFACTURER SHALL PROVIDE SIGNED AND SEALED DRAWINGS BY A 	Project:	
	REGISTERED ENGINEER IN THE STATE OF FLORIDA. D. GENERAL CONTRACTOR TO FIELD VERIFY TOPOGRAPHY BEFORE BUILDING STAIRS AND ADJUST STAIR HEIGHTS	GREAT OAKS VILLAGE WITTE ADA UPGRADES AND RENOV 1784 E. MICHIGAN STREET	
	 ACCORDINGLY. E. BASIS OF DESIGN SHALL BE DITTMER ARCHITECTURAL ALUMINUM, DITT-DECK, COLOR: CLEAR ANODIZED OR EQUA 	ORLANDO, FL 32806	
	ALUMINUM, DITT-DECK, COLOK. CLEAK ANODIZED OK EQUA	Issue Date & Issue Description 07.27.16 60% CD SET 09.15.16 90% CD SET 12.02.16 PERMIT/BID S 1 01.25.17 02.27.17 CONST_ISSUE	
	-	• 02.27.17 CONST. ISSUE	E SET JS KA
		NSISE NON SECONTY CAPITAL PE VIN ORANGE COUNTY CAPITAL PE 400 E SOUTH STREET 5th FLOOR ORLANDO, FL 32801 • Project Number	ROJECTS DIVISION
GUARD RAIL IS REC FOR STAIRS OVER 3 MORE. SPHERE 8" II DIAMETER SHALL N PASS THROUGH OP ABOVE 34" HIGH.	30" OR N OT	Project Number 15253 Drawn By JS Checked By KA File Name X:\dwgs\15253 OC Wittenstein House A A08.04 STAIRCASE DETAILS.dwg	02/27/2017 Project Status CONSTRUCTION ISSUE SET Scale VARIES
4"			
	HANDRAILING 34" MIN 38" MAX HGT GUARDRAILING 42"	Consultant • Seal/Signature	
		STAIRCASE	DETAILS
		A08	04
G DETAIL - TYP		AUO,	.v- 1



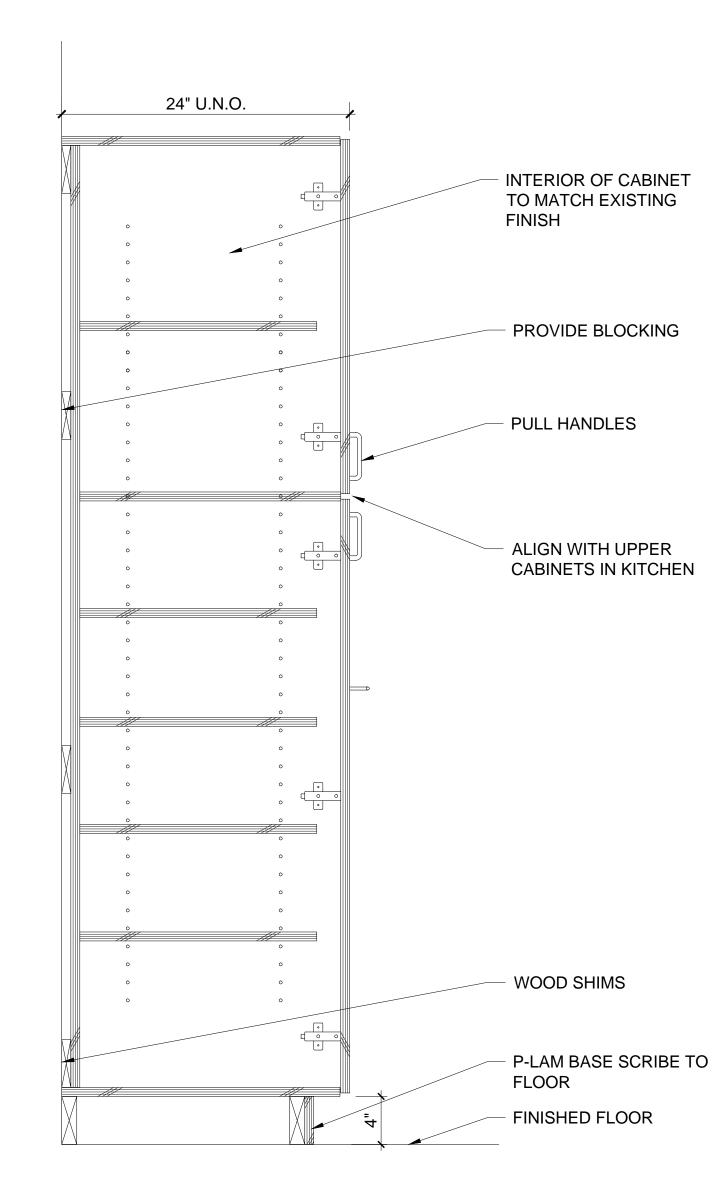


SECTION @ PANTRY CABINET- ADJ. SHELVES5

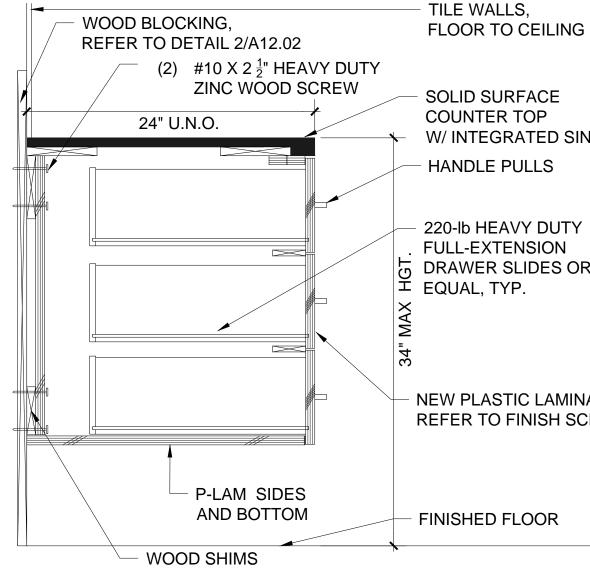

SECTION @ FLOATING CABINET W/ DWRS

1. ALL MILLWORK DOOR HINGES TO BE 120 DEGREE, HEAVY DUTY EUROPEAN STYLE. GC TO SIZE HARDWARE LENGTHS SO THERE IS NOT INTERFERENCE WITH WALLS OR OTHER OBSTRUCTIONS.

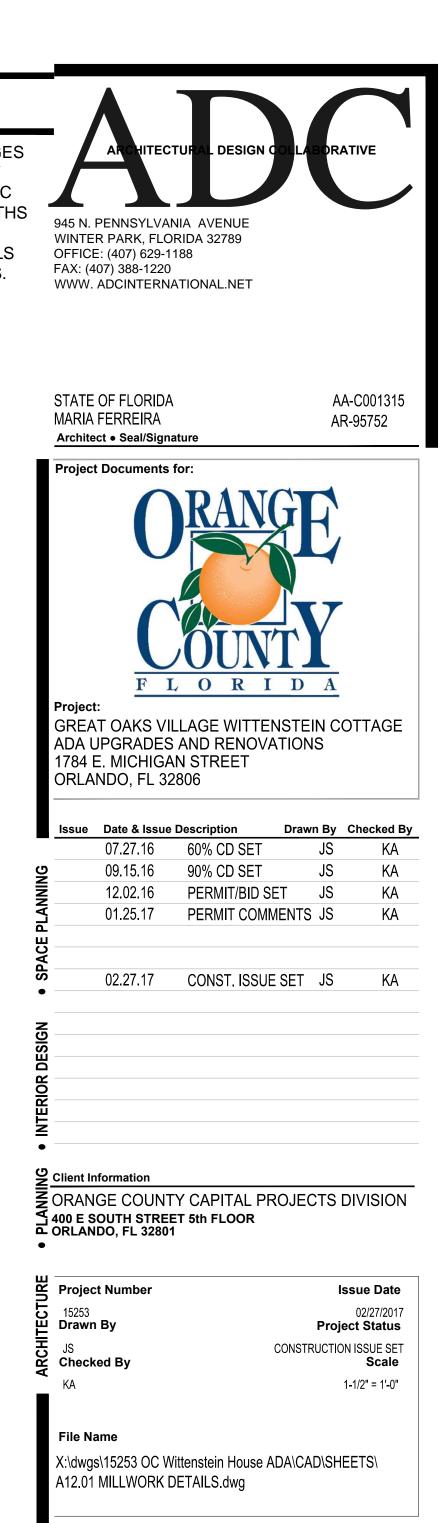

SOLID SURFACE COUNTER TOP W/ INTEGRATED SINK HANDLE PULLS

220-lb HEAVY DUTY FULL-EXTENSION DRAWER SLIDES OR

NEW PLASTIC LAMINATE, **REFER TO FINISH SCHEDULE**

FINISHED FLOOR






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MILLWORK DETAILS

Consultant • Seal/Signature

A12.01

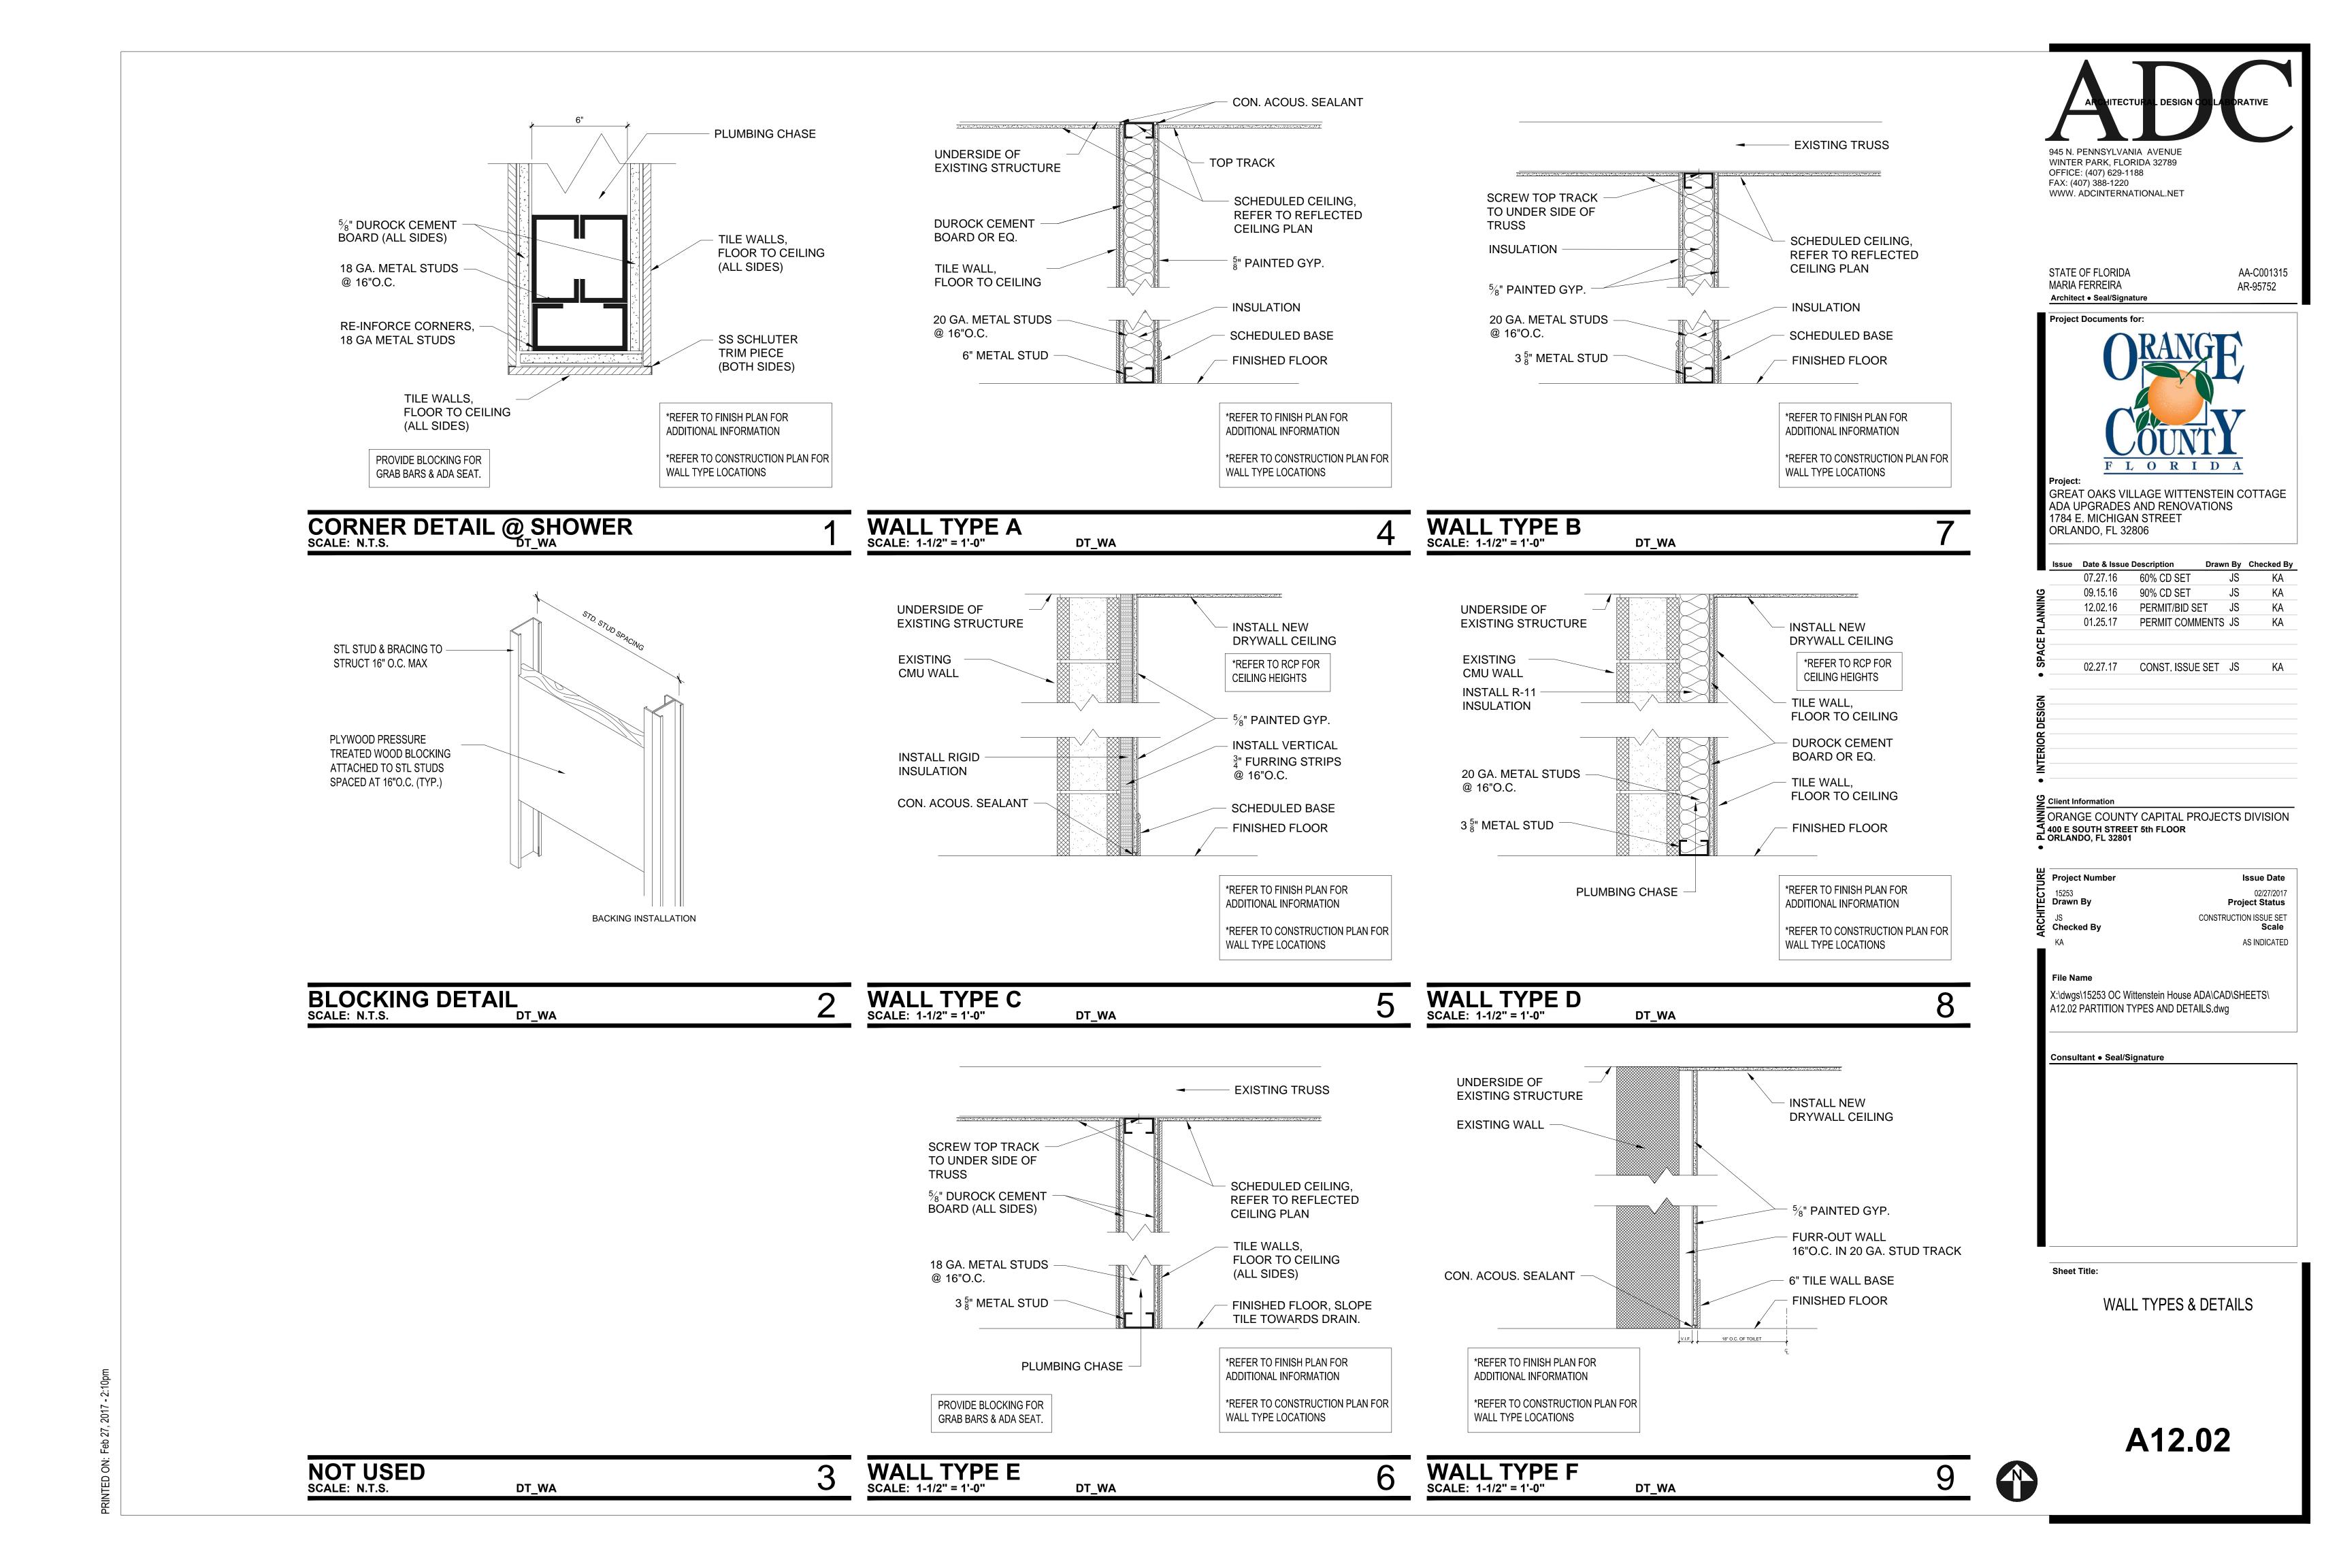

THE FIRE SUPPRESSION ENGINEERING DOCUMENTS AND BOOK SPECIFICATIONS ARE PREPARED EXCLUSIVELY FOR THIS PROJECT AND ARE IN COMPLIANCE WITH THE FOLLOWING STANDARD. THE INSTALLING CONTRACTOR IS RESPONSIBLE FOR PREPARING WORKING PLANS AND HYDRAULIC CALCULATIONS AS DEFINED BY 2010 ED. NFPA 13. THE WORKING PLANS AND HYDRAULIC CALCULATIONS SHALL BE SUBMITTED TO THE ENGINEER OF RECORD FOR REVIEW AND APPROVAL. THE APPROVED SHOP DRAWINGS AND HYDRAULIC CALCULATIONS SHALL BE SUBMITTED TO THE LOCAL AUTHORITY HAVING JURISDICTION FOR FINAL APPROVAL AND BUILDING PERMIT.

61G15-32.003 COMMON REQUIREMENTS TO ALL FIRE PROTECTION ENGINEERING DOCUMENTS. (1) THE FIRE PROTECTION SYSTEM ENGINEERING DOCUMENTS SHALL PROVIDE THE ÉNGINEERING REQUIREMENTS TO BE USED IN THE PREPARATION OF THE FIRE PROTECTION SYSTEM LAYOUT DOCUMENTS AND TO INDICATE THE NATURE AND SCOPE OF THE WORK, AND TO DESCRIBE, DETAIL, DIMENSION, LABEL AND DEFINE THE FIRE PROTECTION COMPONENTS, SYSTEM(S). MATERIALS, ASSEMBLIES, EQUIPMENT AND ITS STRUCTURAL AND UTILITY SUPPORT SYSTEM(S), INSOFAR AS THEY INVOLVE THE SAFEGUARDING OF LIFE, HEALTH OR PROPERTY. (2) THE FIRE PROTECTION SYSTEM ENGINEERING DOCUMENTS SHALL SPECIFY THE APPLICABLE REQUIREMENTS FOR THE ACCEPTANCE TESTING OF THE FIRE PROTECTION SYSTEM AND COMPONENTS, WHICH SHALL BE BASED UPON APPLICABLE CODES AND STANDARDS, WHERE AVAILABLE.

(3) THE OCCUPANCY OF THE AREA OR DESCRIPTION OF A SPECIFIC HAZARD BEING PROTECTED BY THE FIRE PROTECTION SYSTEM(S) SHALL BE SHOWN ON THE FIRE PROTECTION SYSTEM ENGINEERING DOCUMENTS.

(4) THE APPLICABLE CODE AND STANDARD TO BE USED IN THE PREPARATION OF THE FIRE PROTECTION SYSTEM LAYOUT DOCUMENTS SHALL BE SHOWN ON THE FIRE PROTECTION SYSTEM ENGINEERING DOCUMENTS. WHEN CODES AND STANDARDS ARE NOT AVAILABLE OR APPLICABLE, AND SAID LAYOUT DOCUMENTS ARE TO BE BASED ON ENGINEERING JUDGMENT, ANY REASONS AND ASSUMPTIONS MADE TO DEVELOP THE FIRE PROTECTION CONCEPT SHALL BE IDENTIFIED ON THE FIRE PROTECTION SYSTEM ENGINEERING DOCUMENTS (5) STRUCTURAL SUPPORT AND STRUCTURAL OPENINGS REQUIRED BY THE FIRE PROTECTION SYSTEM SHALL BE SHOWN ON THE FIRE PROTECTION SYSTEM ENGINEERING DOCUMENTS AND SHALL BE REFERENCED ON STRUCTURAL ENGINEERING DOCUMENTS. (6) WHEN LAYOUT DOCUMENTS CONTAIN MATERIAL DEVIATION FROM THE ENGINEER OF

RECORD'S FIRE PROTECTION SYSTEM ENGINEERING DOCUMENT, SUCH LAYOUT DOCUMENTS ARE NOT COMPLIANT UNLESS THEY ARE ACCOMPANIED BY REVISED ENGINEERING DOCUMENTS MADE AND SEALED BY THE ENGINEER OF RECORD FOR THE FIRE PROTECTION SYSTEM. (7) REQUIREMENTS FOR ACTIVATION CONTROL SYSTEMS, SEQUENCE, OPERATING PARAMETERS,

INTERLOCKS, SAFETY RELATED DEVICES, INDICATORS AND ALARMS, SHALL BE SHOWN ON THE FIRE PROTECTION SYSTEM ENGINEERING DOCUMENTS, UNLESS SHOWN ON OTHER RELATED DOCUMENTS.

(8) ANY INFORMATION DEEMED APPROPRIATE BY THE ENGINEER OF RECORD TO ASSIST THE AUTHORITY HAVING JURISDICTION IN UNDERSTANDING THE OWNER'S INTENDED USE AND PROPOSED PROTECTION OF THE BUILDING OR FACILITY AND TO PROVIDE SUFFICIENT DIRECTION TO THE INSTALLATION CONTRACTOR OR OTHER INTERESTED PARTIES REGARDING THE LAYOUT OF THE SYSTEM(S), SHALL BE INCLUDED IN THE FIRE PROTECTION SYSTEM ENGINEERING DOCUMENTS.

SPECIFIC AUTHORITY 471.008, 471.033(2), FS LAW IMPLEMENTED 471.005(7), 471.033(2), FS

61G15-32.004 DESIGN OF WATER BASED FIRE PROTECTION SYSTEMS. (1) WATER BASED FIRE PROTECTION SYSTEMS INCLUDE, BUT ARE NOT LIMITED TO, AUTOMATIC SPRINKLER SYSTEMS OF WET, DRY, FINE WATER SPRAY (MIST), MANUAL, AND DELUGE VALVE CONTROLLED TYPES, PUMPING SYSTEMS, STANDPIPES, FIRE WATER MAINS AND DEDICATED FIRE PROTECTION WATER SOURCES.

(2) TO ENSURE MINIMUM DESIGN QUALITY IN FIRE PROTECTION SYSTEM ENGINEERING DOCUMENTS, SAID DOCUMENTS SHALL INCLUDE AS A MINIMUM THE FOLLOWING INFORMATION WHEN APPLICABLE:

(A) THE POINT OF SERVICE FOR THE FIRE PROTECTION WATER SUPPLY AS DEFINED BY 633.021(18) F.S.

(B) APPLICABLE NFPA STANDARD TO BE APPLIED, OR IN THE CASE WHERE NO SUCH STANDARD EXISTS, THE ENGINEERING STUDY, JUDGMENTS, AND/OR PERFORMANCE BASED ANALYSIS AND CONCLUSIONS.

(C) CLASSIFICATION OF HAZARD OCCUPANCY FOR EACH ROOM OR AREA. (D) DESIGN APPROACH, WHICH INCLUDES SYSTEM TYPE, DENSITIES, DEVICE TEMPERATURE RATING. AND SPACING FOR EACH SEPARATE HAZARD OCCUPANCY. (E) CHARACTERISTICS OF WATER SUPPLY TO BE USED, SUCH AS MAIN SIZE AND LOCATION,

WHETHER IT IS DEAD-END OR CIRCULATING; AND IF DEAD-END, THE DISTANCE TO THE NEAREST CIRCULATING MAIN, AS WELL AS ITS MINIMUM DURATION AND RELIABILITY FOR THE MOST HYDRAULICALLY DEMANDING DESIGN AREA.

(F) WHEN PRIVATE OR PUBLIC WATER SUPPLIES ARE USED, THE FLOW TEST DATA, INCLUDING DATE AND TIME OF TEST. WHO CONDUCTED TEST OR SUPPLIED INFORMATION. TEST ELEVATION. STATIC GAUGE PRESSURE AT NO FLOW, FLOW RATE WITH RESIDUAL GAUGE PRESSURE, HYDRANT FLOW COEFFICIENT, AND LOCATION OF TEST IN RELATION TO THE HYDRAULIC POINT OF SERVICE.

(G) VALVING AND ALARM REQUIREMENTS TO MINIMIZE POTENTIAL FOR IMPAIRMENTS AND UNRECOGNIZED FLOW OF WATER.

(H) MICROBIAL INDUCED CORROSION (MIC). THE ENGINEER OF RECORD SHALL MAKE REASONABLE EFFORTS TO IDENTIFY WATER SUPPLIES THAT COULD LEAD TO MICROBIAL INDUCED CORROSION (MIC). SUCH EFFORTS MAY CONSIST OF DISCUSSIONS WITH THE LOCAL WATER PURVEYOR AND/OR FIRE OFFICIAL, FAMILIARITY WITH CONDITIONS IN THE LOCAL AREA. OR LABORATORY TESTING OF WATER SUPPLIES. WHEN CONDITIONS ARE FOUND THAT MAY RESULT IN MIC CONTAMINATION OF THE FIRE PROTECTION PIPING, THE ENGINEER SHALL DESIGN CORRECTIVE MEASURES.

(I) BACKFLOW PREVENTION AND METERING SPECIFICATIONS AND DETAILS TO MEET LOCAL WATER PURVEYOR REQUIREMENTS INCLUDING MAXIMUM ALLOWABLE PRESSURE DROP. (J) QUALITY AND PERFORMANCE SPECIFICATIONS OF ALL YARD AND INTERIOR FIRE PROTECTION COMPONENTS.

(3) CONTRACTOR SUBMITTALS WHICH DEVIATE FROM THE ABOVE MINIMUM DESIGN PARAMETERS SHALL BE CONSIDERED MATERIAL DEVIATIONS AND REQUIRE SUPPLEMENTAL ENGINEERING APPROVAL AND DOCUMENTATION.

(4) IN THE EVENT THE ENGINEER OF RECORD PROVIDES MORE INFORMATION AND DIRECTION THAN IS ESTABLISHED ABOVE, HE OR SHE SHALL BE HELD RESPONSIBLE FOR THE TECHNICAL ACCURACY OF THE WORK IN ACCORDANCE WITH APPLICABLE CODES, STANDARDS, AND SOUND ENGINEERING PRINCIPLES.

SPECIFIC AUTHORITY 471.008, 471.033(2), FS LAW IMPLEMENTED 471.005(7), 471.033(2), FS HISTORY--NEW 5-19-93, FORMERLY 21H-32.004, AMENDED 4-2-2000, 6-26-01, 7–12–05

HISTORY--NEW 5-19-93, FORMERLY 21H-32.003, AMENDED 4-2-2000, 6-26-01

FIRE PROTECTION LEGEND

DESCRIPTION

<u>SYMBOL</u>

×××××××

NEW 160" \" SPRINKLER (MATCH EXISTING) RELOCATED 160" \" SPRINKLER EXISTING 160° \" SPRINKLER NEW SPRINKLER PIPING EXISTING SPRINKLER PIPING EXISTING SPRINKLER PIPING TO BE REMOVED CONNECT TO EXISTING

FIRE PROTECTION ABREVIATIONS

ABOVE FINISHED FLOOR	AFF
BELOW FINISHED GRADE	BFG
BELOW FINISHED FLOOR	BFF
CONTINUATION	CONT
CONNECTION	CONN
DIAMETER	DIA
DOWN	DN
DRAWING	DWG
NOT IN CONTRACT	NIC
NOT TO SCALE	NTS
REDUCED PRESSURE BACKFLOW PREVENTER	RPBP
SQUARE FEET	SF
UNLESS NOTED OTHERWISE	U.N.O.

FIRE SPRINKLER HEAD LEGEND

SYMBOL	ORF	TEMP	RESPONSE	K-FAC	FINISH	MODEL	STYLE	PLATE	MFG.
•	*	155 °	*	*	BRASS *		RECESSED	WHITE	*
* = ALL NEW AND/OR REPLACED EXISTING SPRINKLERS SHALL MATCH THE CHARACTERISTICS OF									

FIRE PROTECTION LEGEND

•	NEW 160° PENDENT SPRINKLER
0	NEW 160° UPRIGHT SPRINKLER
۲	EXISTING SPRINKLER TO REMAIN
	NEW SPRINKLER PIPING
	EXISTING SPRINKLER PIPING
×××××××	Existing sprinkler piping to be removed

THE EXISTING SPRINKLERS.

NEW SPRINKLER SYSTEM WILL BE HYDRAULICALLY DESIGNED FOR LIGHT HAZARD OCCUPANCY.

OCCUPANCY CLASSIFICATION: SYSTEM TYPE: DESIGN DENSITY: HYDRAULIC REMOTE AREA: SPRINKLER ORIFICE SIZE: DURATION OF SUPPLY: HOSE STREAM ALLOWANCE:

OCCUPANCY CLASSIFICATION: SYSTEM TYPE: DESIGN DENSITY: HYDRAULIC REMOTE AREA: SPRINKLER ORIFICE SIZE: DURATION OF SUPPLY: MAXIMUM COVERAGE/SPRINKLER HEAD: HOSE STREAM ALLOWANCE:

FLOW TEST INFORMATION: FLOW TEST DATE: 7/22/2016 HYDRANT: P14684

STATIC PRESSURE: 64 PSI **RESIDUAL PRESSURE: 46 PSI** FLOW: 1140 GPM

DESIGN CRITERIA:

DESIGN	OF THE
1.	NFPA [·]
2.	NFPA 2 AND TH
WATER	SUPPLY
1.	THE EX TREATE
<u>GENER</u>	AL NOTES

GUARDS

ADDITIONAL COST.

FIRE PROTECTION DATA

LIGHT HAZARD

.10 GPM/SQ. FT.

1,500 SQ. FT.

225 SQ. FT.

ORDINARY HAZARD GROUP I

WET PIPE

1/2"

30 MIN.

100 GPM

WET PIPE

1/2"

.15 GPM/SQ. FT.

1,500 SQ. FT.

60 - 90 MIN.

130 SQ. FT.

250 GPM

OCCUPANCY CLASSIFICATIONS AS NOTED ON PLANS

MAXIMUM COVERAGE/SPRINKLER HEAD:

- THE FOLLOWING PUBLICATIONS SHALL BE USED AS A REFERENCE FOR FIRE SUPPRESSION SYSTEM ON THIS PROJECT.
 - 13 (2010 ED.), STANDARD FOR THE INSTALLATION OF SPRINKLER SYSTEMS.
 - 24 (2010 ED.), STANDARD FOR THE INSTALLATION OF PRIVATE FIRE SERVICE MAINS HEIR APPURTENANCES.


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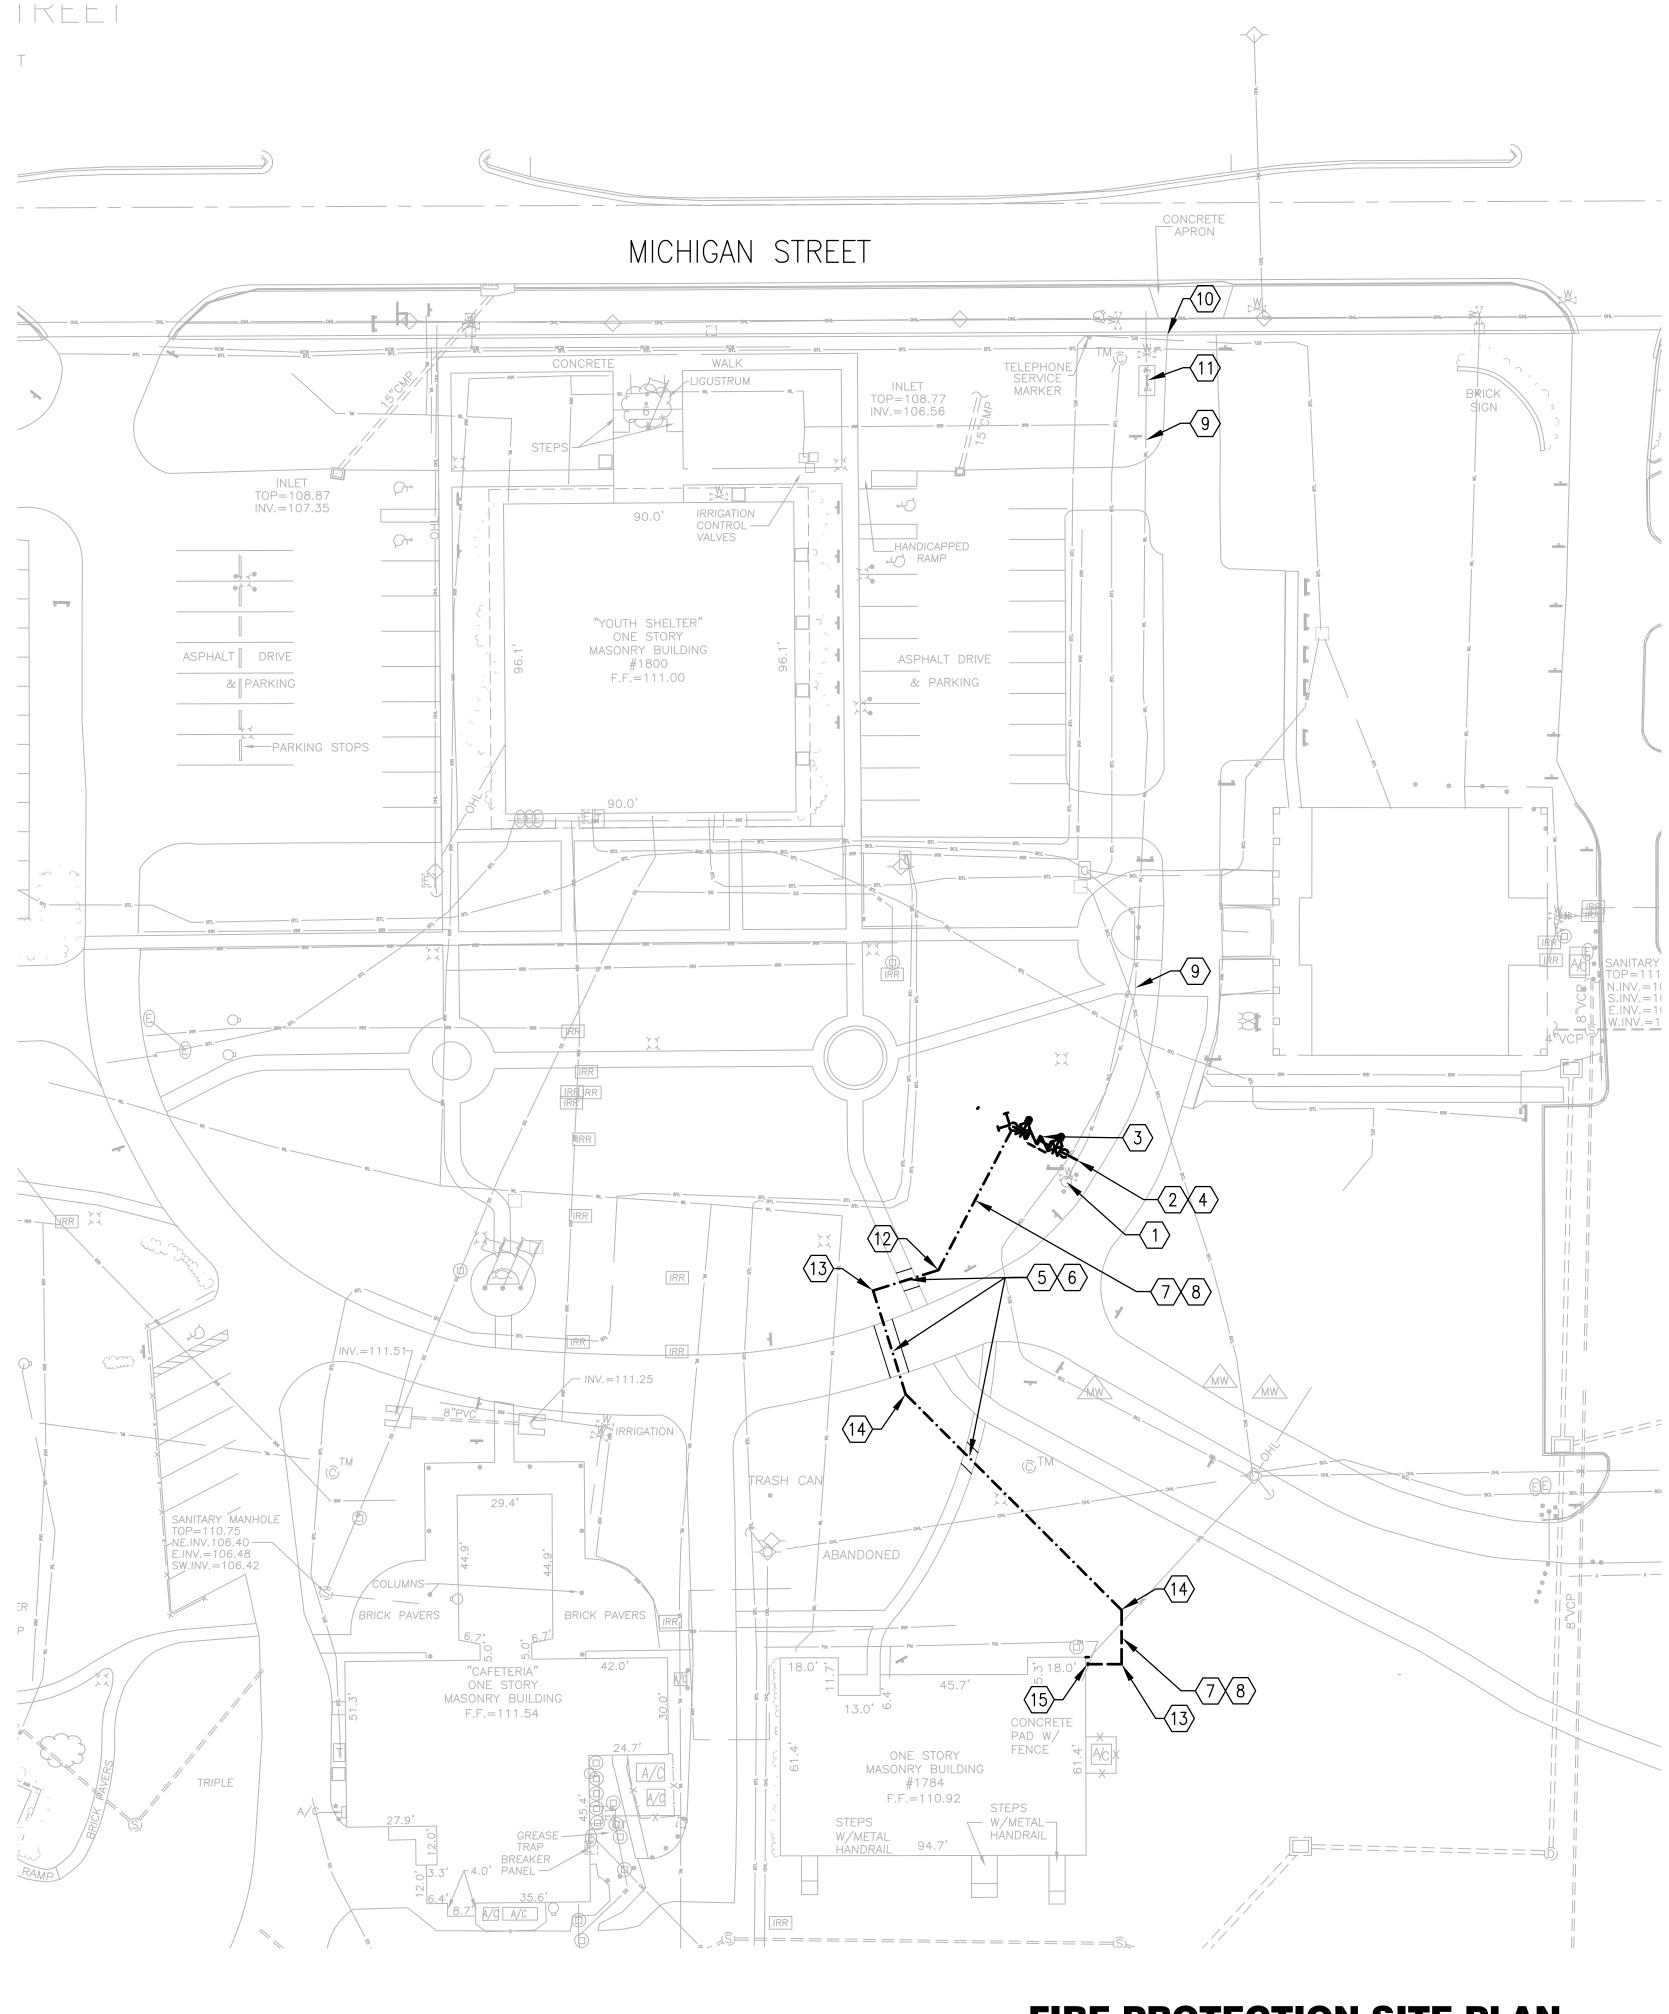
EXISTING WATER SUPPLY HAS NO REPORTED CASES OF M.I.C. - THE WATER SYSTEM IS ED WITH A CURROSION INHIBITOR.

- 1. THE FIRE PROTECTION SYSTEMS SHALL COMPLY WITH THE ABOVE REFERENCED NFPA STANDARDS AND ALL STATE AND LOCAL CODES AND REQUIREMENTS.
- 2. FINAL SYSTEM ACCEPTANCE AND APPROVAL SHALL BE CONDUCTED BY THE LOCAL AHJ AND THE ARCHITECT/ENGINEER.
- 3. CONTRACTOR'S SPRINKLER SYSTEM LAYOUT (SHOP DRAWINGS), HYDRAULIC CALCULATIONS AND MATERIAL DATA SHALL BE SUBMITTED TO THE ARCHITECT/ENGINEER AND STATE FIRE MARSHALL FOR APPROVAL PRIOR TO SYSTEM INSTALLATIÓN.
- 4. THE FIRE PROTECTION SYSTEMS SHOWN REPRESENT THE DESIGN INTENT OF THE ENGINEER OF RECORD, IN ACCORDANCE WITH STATE REGULATION 61G15-32. IT IS THE RESPONSIBILITY OF THE CONTRACTOR TO COORDINATE INSTALLATION WITH ALL OTHER TRADES. THE CONTRACTOR SHALL PROVIDE COMPLETE SPRINKLER SYSTEM LAYOUT DRAWINGS WITH ANY ADDITIONAL OFFSETS, SPRINKLERS OR SYSTEM COMPONENTS AS REQUIRED FOR A COMPLETE AND OPERABLE SYSTEM AND TO AVOID CONFLICTS WITH OTHER TRADES.
- 5. SEE ARCHITECTURAL REFLECTED CEILING PLANS FOR CEILING TYPES. HEIGHTS AND ALL ASSOCIATED DATA.
- 6. PROVIDE FIRE STOP ASSEMBLIES FOR ALL PENETRATIONS OF SMOKE/FIRE WALLS, CEILINGS AND FLOORS. FIRE STOP ASSEMBLIES SHALL MEET ASTM E-814. SEE FIRE RATED PIPE PENETRATION DETAILS.
- 7. ALL DRAIN AND DRY PIPE SYSTEM PIPING AND FITTINGS SHALL BE GALVANIZED BOTH INSIDE AND OUTSIDE.
- 8. INSTALL ADDITIONAL SPRINKLERS UNDER ALL EXPOSED DUCTWORK OR OBSTRUCTIONS OR COMBINATIONS OF OBSTRUCTIONS EXCEEDING 48" IN WIDTH. PROVIDE ADDITIONAL SPRINKLERS AS REQUIRED FOR PROPER COVERAGE OF OBSTRUCTIONS IN ACCORDANCE WITH NFPA 13.
- 9. ALL SPRINKLER HEADS INSTALLED WITHIN MECHANICAL ROOMS, STORAGE ROOMS, JANITORS CLOSETS OR AREAS SUBJECT TO MECHANICAL INJURY SHALL BE PROTECTED WITH LISTED
- 10. COORDINATE PIPE ROUTING WITH DUCT ROUTING, EQUIPMENT LOCATIONS, ELECTRICAL INSTALLATIONS AND BUILDING STRUCTURAL MEMBERS. DO NOT ROUTE PIPING OVER ELECTRICAL PANELS. PIPING ROUTED OVER ELECTRICAL PANELS SHALL BE REROUTED AT NO
- 11. PROVIDE TAMPER SWITCHES ON ALL CONTROL VALVES.
- 12. SLOPE ALL PIPING TO THE SYSTEM MAIN DRAIN AS REQUIRED TO INSURE PROPER DRAINAGE. IT IS THE CONTRACTOR'S RESPONSIBILITY TO INSURE THAT ALL PIPING IS DRAINABLE. ADDITIONAL DRAINS AND PLUGS SHALL BE INSTALLED WHERE REQUIRED TO COMPLY WITH THE ABOVE REFERENCED CODES.
- 13. ALL ROLL GROOVED AND CUT GROOVED COUPLINGS AND FITTINGS SHALL BE PROVIDED BY A SINGLE MANUFACTURER.
- 14. SPRINKLERS SHALL BE CENTERED IN CEILING TILES IN AREAS WITH LAY-IN TILES AND VISUALLY ALIGNED IN AREAS WITH SMOOTH CEILINGS.
- 15. THIS PROJECT INVOLVES THE ADDITION AND/OR ALTERATION OF 49 OR LESS SPRINKLERS. AS PERMITTED BY STATE STATUE 553.79 AND 633.021, A STATE LICENSED SPRINKLER CONTRACTOR SHALL DESIGN THE REQUIRED SPRINKLER DRAWINGS AND HYDRAULIC CALCULATIONS. DRAWINGS AND CALCULATIONS SHALL BE SUBMITTED FOR REVIEW AND APPROVAL BY THE AHJ PRIOR TO INSTALLATION.
- ARCHITECTURAL DESIGN COLLABORATIVE 945 N. PENNSYLVANIA AVENUE WINTER PARK, FLORIDA 32789 OFFICE: (407) 629-1188 FAX: (407) 388-1220 WWW. ADCINTERNATIONAL.NET STATE OF FLORIDA AA-C001315 MARIA FERREIRA AR-95752 Architect • Seal/Signature **Project Documents for:** LORID GREAT OAKS VILLAGE WITTENSTEIN COTTAGE ADA UPGRADES AND RENOVATIONS 1784 E. MICHIGAN STREET ORLANDO, FL 32806 sue Date & Issue Description Drawn By Checked By 07.27.16 60% CD SET JS KA 09.15.16 90% CD SET JS KA 12.02.16 PERMIT/BID SET JS KA 01.25.17 PERMIT COMMENTS JS KA 02.27.17 CONST. ISSUE SET JS KA Client Information SORANGE COUNTY CAPITAL PROJECTS DIVISION 400 E SOUTH STREET 5th FLOOR G ORLANDO, FL 32801 Project Number Issue Date 15253 02/27/2017 Drawn By Project Status WRH CONSTRUCTION ISSUE SET Checked By Scale киĘВ File Name Q:\PROJECT FILES\2016\2016-066 Wittenstein House Reno\Drawings\ 1300-F001-2016066.dwg onsultant • Seal/Signature SGM# ENGINEERING 935 Lake Baldwin Lane Orlando, FL 32814 Tel: 407-767-5188 FAX: 407-767-5772 WWW.SGMENGINEERING.COM OPYRIGHT © 2014 SGM ENGINEERING. INC SGM #: 2016-066 JOHN EDWARD BALL-FL66893 Sheet Title:

Fire Protection Symbols Legend and General Notes

F0.01



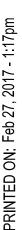

FIRE PROTECTION SITE PLAN

GENERAL NOTES:

- ALL FIRE PROTECTION PIPING AND EQUIPMENT SHALL BE INSTALLED IN ACCORDANCE WITH THE FLORIDA BUILDING CODE 5TH EDITION (2014) AND NFPA 24-2010 REQUIREMENTS.
- b. THE SUBSURFACE INFORMATION FOR THIS PROJECT MAY NOT BE AN ADEQUATE REPRESENTATION OF ACTUAL CONDITIONS FOR PROJECT CONSTRUCTION. THE CONTRACTOR SHALL FIELD VERIFY ALL EXISTING UTILITIES WITHIN CONSTRUCTION AREA. ANY CONFLICTS WITH EXISTING UTILITIES SHALL BE BROUGHT TO THE IMMEDIATE ATTENTION OF THE ENGINEER. SURVEY INFORMATION TO VERIFY EXISTING UTILITIES, LOCATION, DEPTH, HAS NOT BEEN PROVIDED. SURVEY IN PROGRESS.
- c. AN APPROVED WATER SUPPLY CAPABLE OF SUPPLYING THE REQUIRED FIRE FLOW FOR FIRE PROTECTION SHALL BE PROVIDED TO ALL PREMISES UPON WHICH FACILITIES, BUILDINGS, OR PORTIONS OF BUILDINGS ARE HEREAFTER CONSTRUCTED OR MOVED INTO THE JURISDICTION.
- d. ALL PIPE CROSSINGS SHALL MEET FDEP REQUIREMENTS. SEE GENERAL NOTES SHEET FOR SEPARATION REQUIREMENTS.
- e. PAINTING EXPOSED WATER PIPING, VALVES AND FITTINGS:
- e.1. PAINT ALL EXTERIOR ABOVEGROUND SURFACES OF THE DOMESTIC WATER PIPE RISERS, ELBOWS OR BENDS, AND ADJUSTABLE PIPE SUPPORTS WITH OSHA BLUE
- e.2. PAINT ALL EXTERIOR ABOVEGROUND SURFACES OF THE FIRE WATER PIPE RISERS, ELBOWS OR BENDS, AND ADJUSTABLE PIPE SUPPORTS WITH OSHA RED.
- e.3. PAINT ALL EXTERIOR ABOVEGROUND SURFACES OF THE IRRIGATION WATER PIPE RISERS, ELBOWS OR BENDS, AND ADJUSTABLE PIPE SUPPORTS WITH PANTONE PURPLE 522C.
- e.4. DO NOT PAINT ANY GLASS PARTS, MECHANICAL STEMS, PVC, INFORMATION TAGS AND BRASS PARTS AND FITTINGS.


1. EXISTING FIRE HYDRANT.

- CONNECT TO EXISTING YARD PIPING WITH 6"x4" TAPPING SLEEVE AND VALVE PER CITY OF ORLANDO ENGINEERING SPECIFICATIONS. CONTRACTOR SHALL VERIFY SIZE, TYPE, LOCATION, AND DEPTH OF EXISTING YARD PIPING.
- CONTRACTOR SHALL PROVIDE AN OUC APPROVED REDUCED PRESSURE DETECTOR ASSEMBLY (RPDA) WITH A FIRE DEPARTMENT CONNECTION (2-WAY).
- 4. CONTRACTOR SHALL VERIFY EXISTING FIRE HYDRANT SHUTOFF VALVE IS DOWNSTREAM OF THE POINT OF CONNECTION.
- CONTRACTOR SHALL COORDINATE WITH THE OWNER FOR ANY DISRUPTIONS TO ROADWAYS, SIDEWALKS, AND PATHS, AT LEAST 72 HOURS IN ADVANCE.
- OPEN CUT EXISTING PAVEMENT, SIDEWALKS, AND PATHS AS NECESSARY FOR INSTALLATION OF THE FIRE PROTECTION MAIN AS SHOWN. CONTRACTOR SHALL RESTORE CONDITIONS TO BETTER OR EQUAL TO EXISTING CONDITIONS.
- 7. OPEN CUT EXISTING GROUND AS NECESSARY FOR INSTALLATION OF THE FIRE PROTECTION MAIN AS SHOWN. CONTRACTOR SHALL RESTORE CONDITIONS TO BETTER OR EQUAL TO EXISTING CONDITIONS.
- 8. 4" UNDERGROUND FIRE PROTECTION MAIN.
- 9. EXISTING FIRE MAIN.
- 10. EXISTING FIRE MAIN POINT OF CONNECTION.
- 11. EXISTING FIRE MAIN CONTROL VALVES.
- 12. 4" 45° ELBOW.
- 13. 4"90°ELBOW.
- 14. 4"22-1/2°ELBOW.
- 15. SEE DRAWING F1.01 FOR CONTINUATION.

	ARCHITECTURAL DESIGN COLLABORATIVE 945 N. PENNSYLVANIA AVENUE WINTER PARK, FLORIDA 32789 OFFICE: (407) 629-1188 FAX: (407) 388-1220 WWW. ADCINTERNATIONAL.NET STATE OF FLORIDA AA-C001315	
	MARIA FERREIRA AR-95752 Architect • Seal/Signature	
	Project Documents for:	
	Project:GREAT OAKS VILLAGE WITTENSTEIN COTTAGE ADA UPGRADES AND RENOVATIONS 1784 E. MICHIGAN STREET ORLANDO, FL 32806	
	Issue Date & Issue Description Drawn By Checked By	
IJ	07.27.16 60% CD SET JS KA 09.15.16 90% CD SET JS KA	
SPACE PLANNING	12.02.16 PERMIT/BID SET JS KA	
EPLA	01.25.17 PERMIT COMMENTS JS KA	
PACE		
• S	02.27.17 CONST. ISSUE SET JS KA	
ING • INTERIOR DESIGN	Client Information	
₹	ORANGE COUNTY CAPITAL PROJECTS DIVISION 400 E SOUTH STREET 5th FLOOR ORLANDO, FL 32801	
-URE	Project Number Issue Date	
ITECI	15253 02/27/2017 Drawn By Project Status	
ARCHITECTUR	JSRH CONSTRUCTION ISSUE SET Checked By Scale	
	KÆ ^B File Name Q:\PROJECT FILES\2016\2016-066 Wittenstein House Reno\Drawi 1300-F100-2016066.dwg Consultant ● Seal/Signature	ng
	SGANAAC, J SGANAAC, J STARE BALDWIN LANE 035 LAKE BALDWIN LANE 153 LAKE BALDWIN LAKE BALDWIN LANE 153 LAKE BAL	
	JOHN EDWARD BALL-FL66893	
	Sheet Title:	
	Fire Protection Site Plan	



F1.00

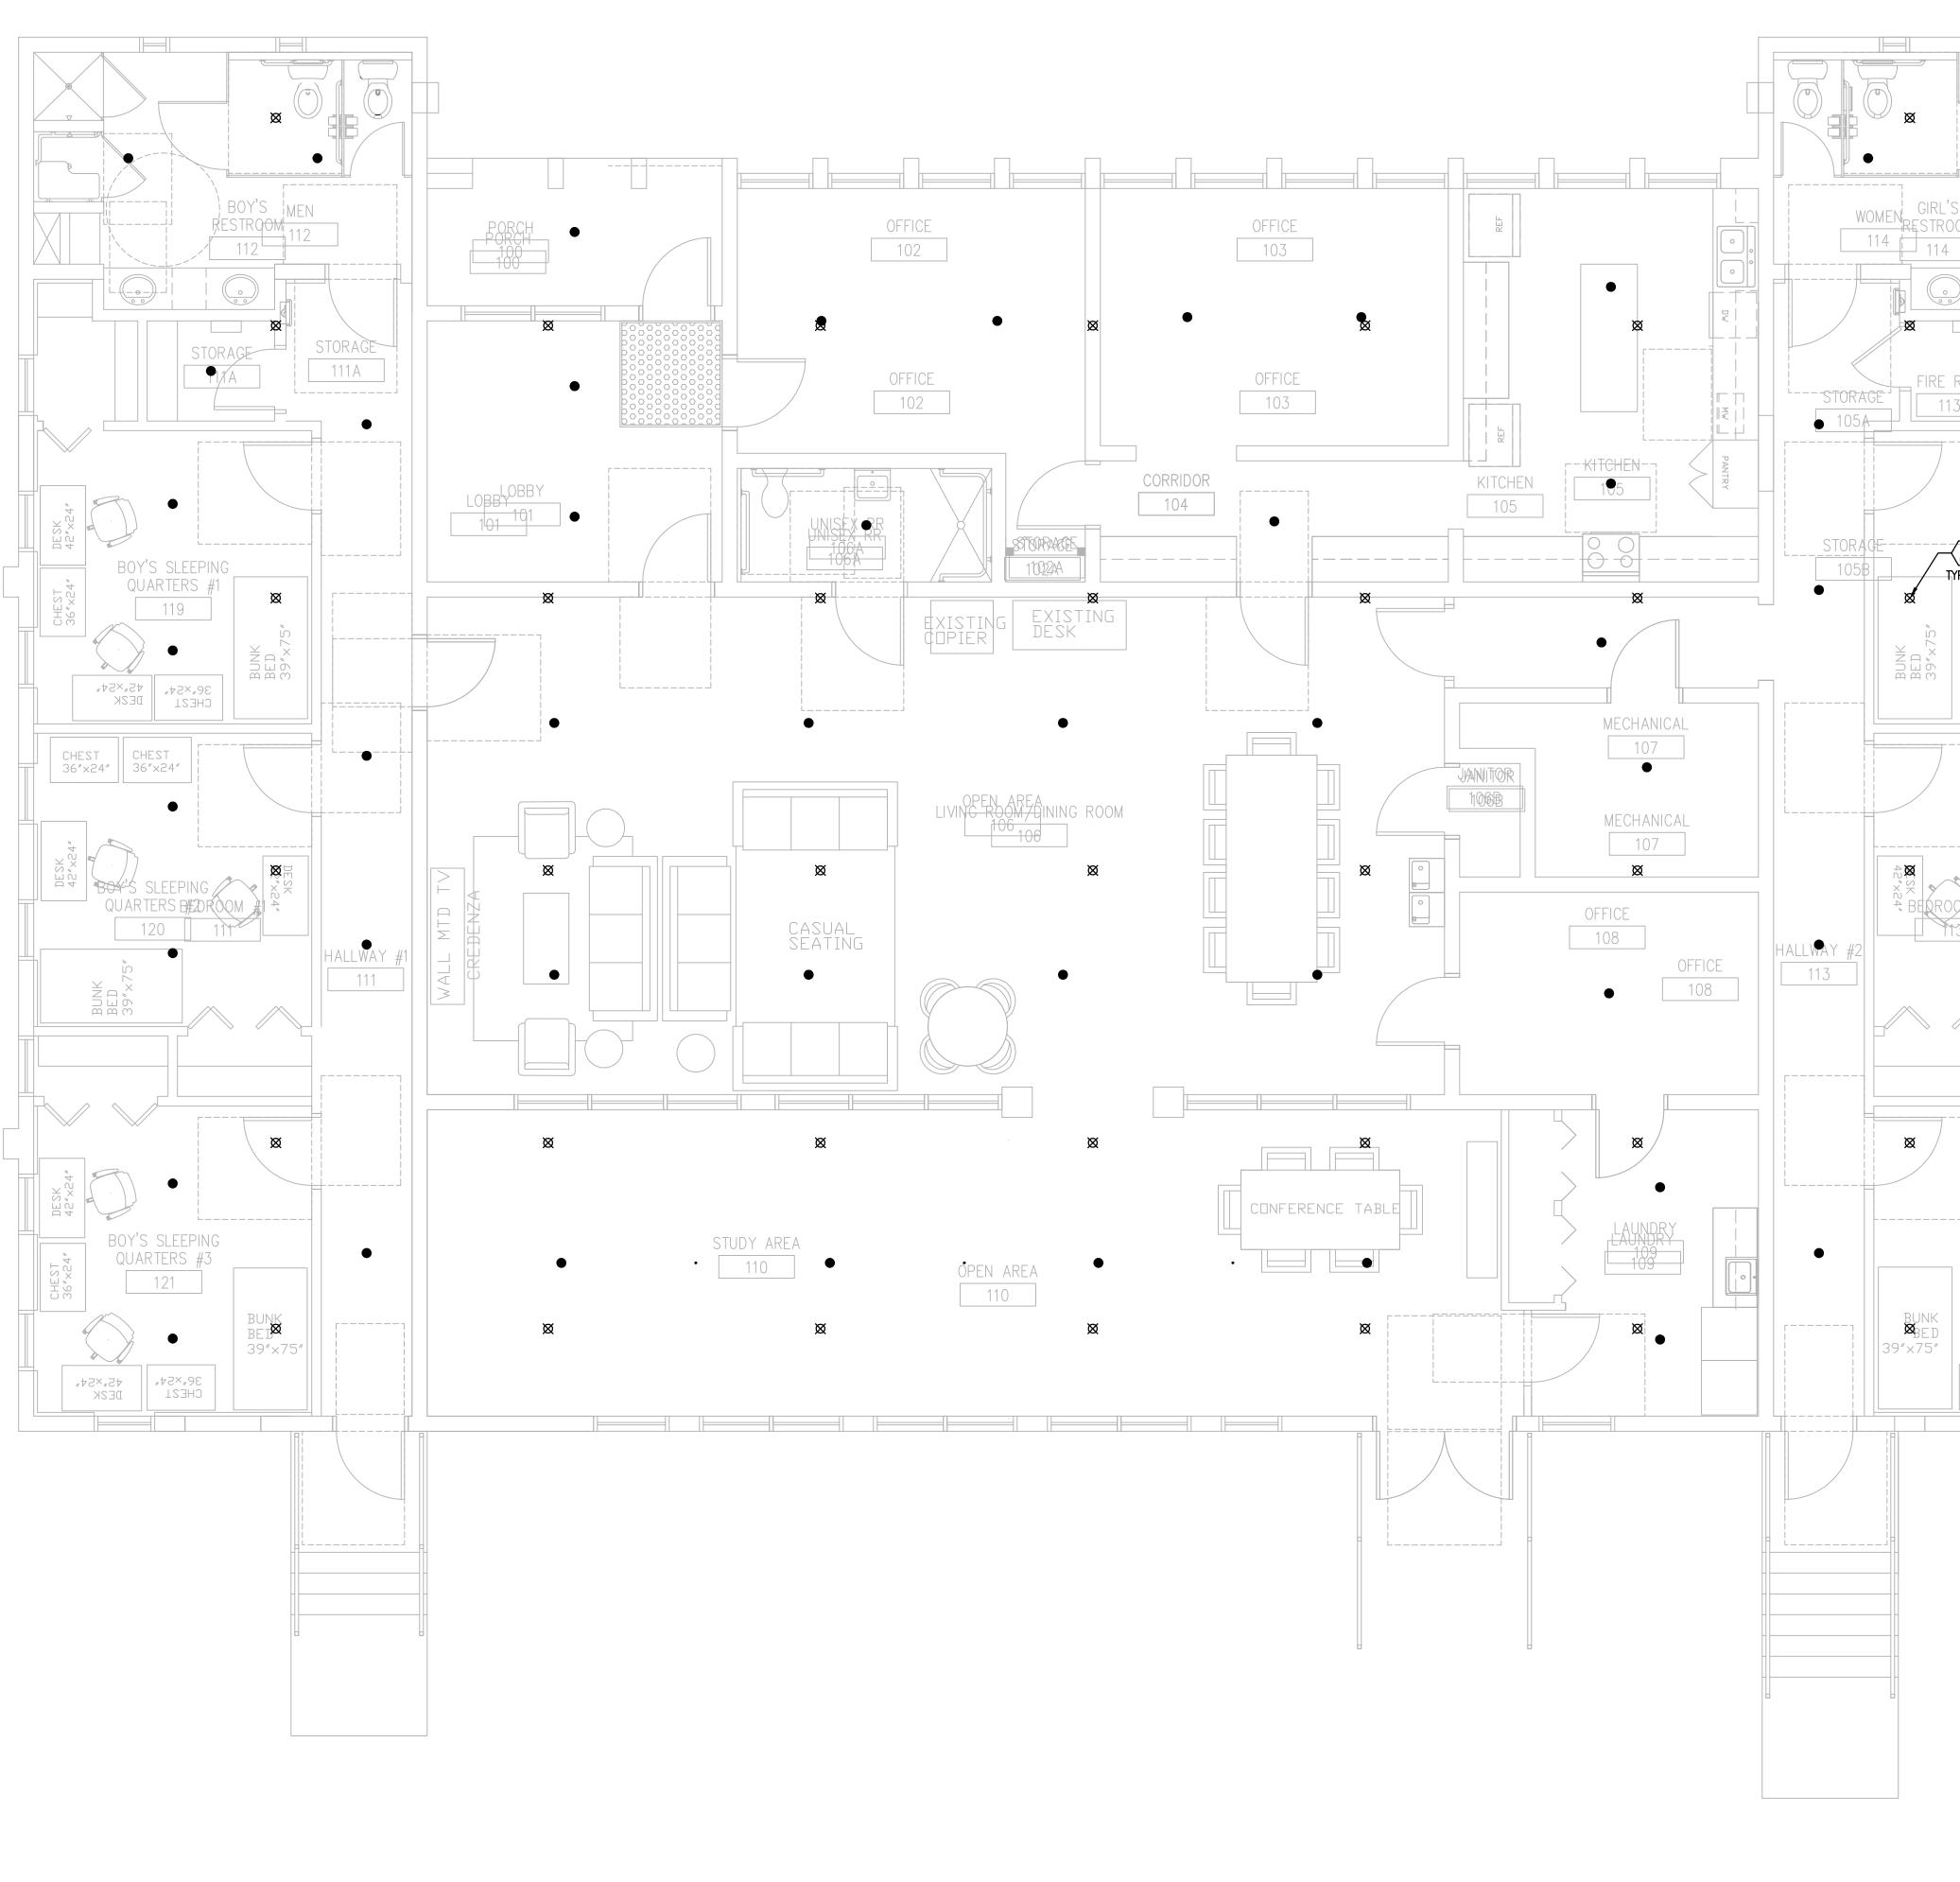


FIRE PROTECTION PLAN SCALE: 1/4"=1'-0"


0 2' 4'

	ARCHITECTURAL DESIGN C	OLLABORATIVE
	945 N. PENNSYLVANIA AVENUE WINTER PARK, FLORIDA 32789 OFFICE: (407) 629-1188 FAX: (407) 388-1220 WWW. ADCINTERNATIONAL.NET	
	STATE OF FLORIDA MARIA FERREIRA Architect • Seal/Signature	AA-C001315 AR-95752
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GIRL'S SLEEPING	• 02.27.17 CONST. ISSUE	SET JS KA
GENERAL NOTES: GENERAL NOTES: a. REFER TO SYMBOL LEGEND DRAWING FOR ADDITIONAL REQUIREMENTS. b. REFER TO SPECIFICATION FOR ADDITIONAL REQUIREMENTS.	Client Information ORANGE COUNTY CAPITAL PR 400 E SOUTH STREET 5th FLOOR ORLANDO, FL 32801	OJECTS DIVISION
 ADDITIONAL INEQUINEMENTS. C. ALL WORK SHALL BE INSTALLED IN ACCORDANCE WITH THE FLORIDA BUILDING CODE 5th EDITION (2014). d. ALL WORK SHALL BE INSTALLED IN ACCORDANCE WITH NFPA 13–2010. 	ଫୁ Checked By K4EB	Issue Date 02/27/2017 Project Status CONSTRUCTION ISSUE SET Scale
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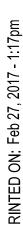
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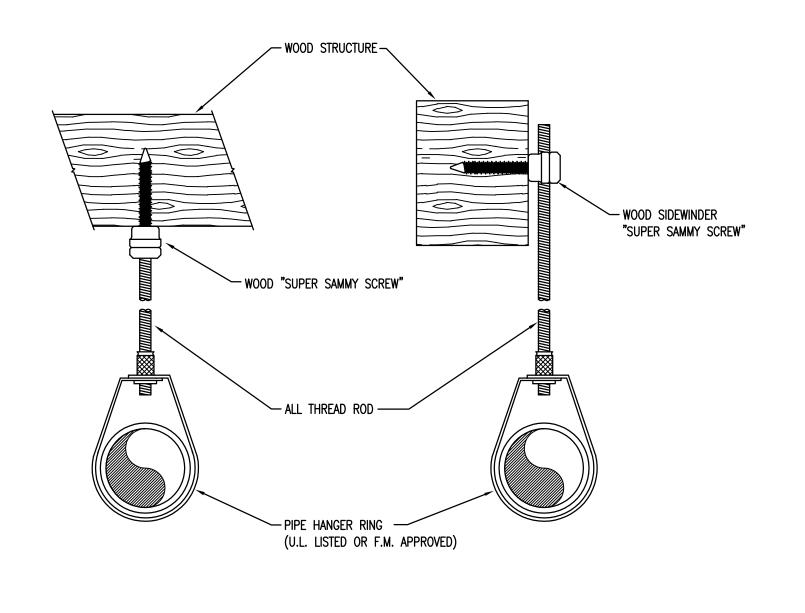




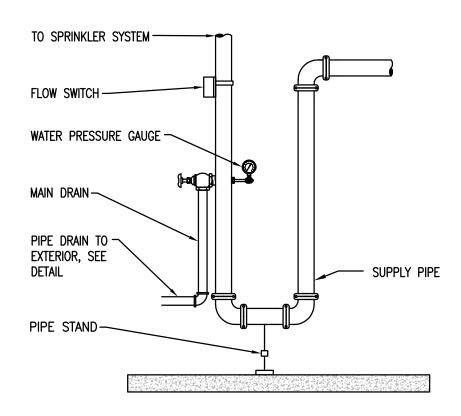


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	JOHN EDWARD BALL-FL66893
	Sheet Title: Fire Protection Details
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ABBREVIATIONS

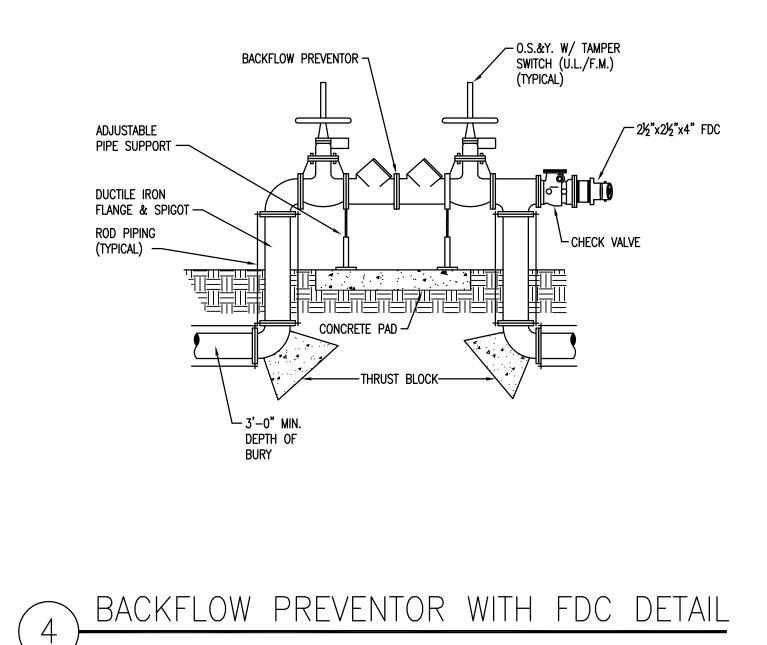CW	COLD WATER
HW	HOT WATER RETURN
HWR	LIQUID PROPANE
LP	DRAIN, WASTE, AND VENT
DWV	WASTE
W.	ACID WASTE
A.W.	CONDENSATE
COND.	VENT
V.	VENT THRU ROOF
VTR	CLEANOUT
CO	WALL CLEANOUT
WCO	FLOOR CLEANOUT
FCO	EXTERIOR CLEANOUT (GRADE)
ECO	BALANCING VALVE
B.V.	ABOVE
AB.	DOWN
DN.	CEILING
CLG.	MINIMUM
MIN.	CHROME PLATED
C.P.	STAINLESS STEEL
S.S.	SLOPE
SL.	GAUGE
GA.	BUILDING
BLDG.	CONNECTION
CONN.	EXISTING
EXIST.	AS HIGH AS POSSIBLE
A.F.F.	ABOVE FINISHED FLOOR
F.F.E.	FINISHED FLOOR ELEVATION
I.E.	INVERT ELEVATION
FD	FLOOR DRAIN
H.D.	HUB DRAIN
RD	ROOF DRAIN
I.E.	INVERT ELEVATION
FD	FLOOR DRAIN

_____ — — — GW— — — — — — — AW — — — — ____AW______ _____ _____ ____ _____ _____SI____ -----ST--------_____ _____ _____ _____ — I P— 0 · ____M______ _____ (# PXXX) PXXX

LEGEND

SOIL OR WASTE LINE (BELOW GRADE) SOIL OR WASTE LINE (ABOVE GRADE) GREASE WASTE PIPING (BELOW GRADE) ACID WASTE PIPING (BELOW GRADE) ACID WASTE PIPING (ABOVE GRADE) CONDENSATE DRAIN PIPING VENT PIPING EXISTING WASTE PIPING (BELOW GRADE) EXISTING WASTE PIPING (ABOVE GRADE) EXISTING VENT PIPING STORM DRAIN PIPING (BELOW GRADE) STORM DRAIN PIPING (ABOVE GRADE) STORM DRAIN OVERFLOW (ABOVE GRADE) DOMESTIC COLD WATER PIPING HOT WATER PIPING HOT WATER RETURN PIPING EXISTING COLD WATER PIPING EXISTING HOT WATER PIPING EXISTING HOT WATER RETURN PIPING LIQUID PROPANE PIPING TRAP 2-WAY CLEANOUT (ECO) CLEANOUT (CO/WCO) FLOOR CLEANOUT (FCO) TWO PIECE, FULL PORT BALL VALVE SWING CHECK VALVE GATE VALVE VERTICAL SHUT-OFF VALVE (GATE) CIRCUIT SETTER TYPE BALANCING VALVE CIRCULATOR PUMP (VERTICAL) INDICATES NEW CONNECTION TO EXISTING UTILITIES INDICATES RISER/DETAIL NUMBER, SHEET FOUND, AND RISER VIEW, (IF APPLICABLE)

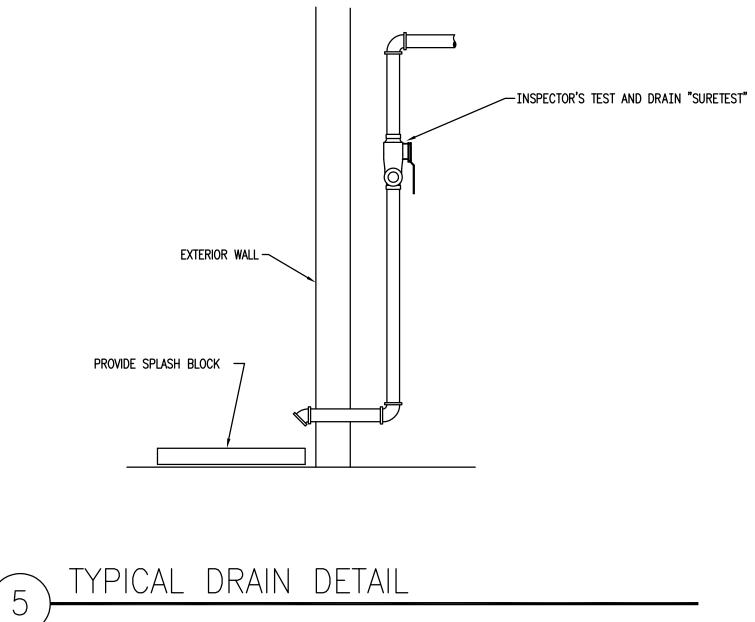GENERAL PLUMBING DEMOLITION NOTES

- CONTRACTOR SHALL FIELD VERIFY EXACT LOCATIONS AND SIZES OF EXISTING 1. SERVICES SHOWN ON DRAWINGS PRIOR TO PRICING, FABRICATION, OR CONSTRUCTION. CONTRACTOR SHALL FIELD LOCATE ALL OTHER EXISTING EQUIPMENT, FIXTURES, AND SERVICES IN THE AREA OF THIS PROJECT.
- CONTRACTOR SHALL VERIFY INVERT ELEVATIONS OF SEWERS TO WHICH NEW SEWER LINES ARE TO BE CONNECTED BEFORE INSTALLATION OF NEW SEWER LINE.
- 3. CONTRACTOR TO REPAIR SLAB TO PRECONSTRUCTION CONDITIONS AFTER TRENCH CUTTING THE SLAB AS REQUIRED FOR SANITARY SEWER INSTALLATION.

GENERAL PLUMBING NOTES


- REFERENCE THE SPECIFICATIONS FOR MATERIALS AND EQUIPMENT STANDARDS.
- THE INSTALLATION OF THE PLUMBING SYSTEMS AND EQUIPMENT SHALL COMPLY WITH ALL APPLICABLE CODES INCLUDING BUT NOT LIMITED TO THE 2014 FLORIDA BUILDING CODE AND 2014 FLORIDA PLUMBING CODE.
- 3. THE CONTRACTOR SHALL COORDINATE THE INTERRUPTION OF ALL UTILITY SERVICES WITH OWNER'S REPRESENTATIVE. PROVIDE A MINIMUM OF FIVE WORKING DAYS ADVANCED NOTICE. OR PER PLUMBING SPECIFICATIONS, OF SCHEDULED UTILITY DISCONNECTION.
- PLANS ARE NOT COMPLETELY TO SCALE. PIPE ROUTING SHOWN IS SCHEMATIC AND IS NOT INTENDED TO INDICATE EXACT LOCATION OF PIPING AND VALVES. CONTRACTOR SHALL PROVIDE ANY ADDITIONAL FITTINGS REQUIRED FOR PROPER INSTALLATION AND TO MAINTAIN PROPER CLEARANCES. COORDINATE WITH ALL TRADES AND OTHER POTENTIAL OBSTRUCTIONS AND ROUTE PIPING TO AVOID INTERFERENCES.
- 5. CONCEAL PIPING ABOVE CEILINGS, WITHIN WALLS OR CHASES EXCEPT IN MECHANICAL ROOMS OR AS SPECIFICALLY NOTED.
- FIRESTOP ALL PENETRATIONS THROUGH RATED WALLS, CEILINGS, AND FLOORS WITH LISTED ASSEMBLIES AND SLEEVE WHERE REQUIRED. FIRESTOP ASSEMBLIES SHALL BE EQUAL OR EXCEED THE RATING OF THE WALL OR FLOOR. ALL FIRESTOP ASSEMBLIES SHALL MEET ASTM E-814 REQUIREMENTS. SEE ARCHITECTURAL DRAWINGS FOR FINAL FINISHES AND ADDITIONAL PIPE PENETRATION REQUIREMENTS.
- PROVIDE ACCESS PANELS TO ALL VALVES LOCATED WITHIN CHASES OR NON-ACCESSIBLE CEILINGS. REFER TO ARCHITECTURAL DRAWINGS FOR CEILING TYPES. ALL VALVES SHALL BE ACCESSIBLE AND LABELED FOR SYSTEM SERVED.
- 8. REFER TO ARCHITECTURAL DRAWINGS FOR FIXTURE LOCATIONS AND MOUNTING HEIGHTS.
- INSTALL CODE REQUIRED FIXED AIR GAPS ON ALL INDIRECT WASTE CONNECTIONS SERVING EQUIPMENT, AND APPLIANCES.
- 10. PROVIDE CLEANOUTS ON ALL SANITARY DRAIN & WASTE, STORM DRAIN, AND CONDENSATE DRAIN PIPING AS INDICATED ON THE DRAWINGS, AND AS REQUIRED BY LOCAL AND STATE CODES. INSTALL CLEANOUTS IN ACCESSIBLE LOCATIONS. COORDINATE TOP OF FLOOR/GRADE CLEANOUT ELEVATION WITH TOP OF FINISHED GRADE.
- 11. INSTALL HOSE BIBBS AND EXTERIOR WALL HYDRANTS AT 18" ABOVE FINISHED FLOOR AND FINISHED GRADE.
- 12. ALL FLOOR DRAINS SHALL BE INSTALLED WITH A TRAP GUARD INSERT. ALL FLOOR DRAINS SHALL BE INSTALLED WITH GRATES FLUSH TO THE FINISHED FLOOR.
- 13. ALL FLOOR, WALL AND CEILING OPENINGS CREATED BY THE REMOVAL OF EXISTING PLUMBING RELATED ITEMS SHALL BE REPAIRED TO MATCH EXISTING ADJACENT FINISHES AND WALL CONSTRUCTION.
- 14. UNLESS NOTED OTHERWISE, SLOPE ALL SANITARY DWV, STORM DRAIN, AND CONDENSATE DRAIN PIPING 3" PIPE SIZE & LARGER A MINIMUM OF 1/8" PER FT. OF RUN, AND 2-1/2" PIPE SIZE AND SMALLER A MINIMUM 1/4" PER FT. OF RUN. SLOPE VENT PIPING DOWN & BACK TO FIXTURES.
- 15. EACH PLUMBING VENT SHALL TERMINATE NOT LESS THAN 10 FT. FROM, OR AT LEAST 3 FT. ABOVE ANY WINDOW, DOOR, OPENING, AIR INTAKE, OR VENT SHAFT.
- 16. PROVIDE WATER HAMMER ARRESTORS AT ALL PLUMBING FIXTURES OR BATTERY OF FIXTURES WITH QUICK-CLOSING VALVES. WATER HAMMER ARRESTORS SHALL BE SIZED PER PDI STANDARDS. AIR CHAMBERS SHALL NOT BE CONSIDERED AN EQUAL TO WATER HAMMER ARRESTORS AND SHALL NOT BE INSTALLED.
- 17. WATER SERVICE PIPE AND THE BUILDING SEWER SHALL BE SEPARATED BY 5 FEET OF UNDISTURBED OR COMPACTED EARTH. THE REQUIRED SEPARATION DISTANCE SHALL NOT APPLY WHERE THE BOTTOM OF THE WATER SERVICE PIPE WITHIN 5 FEET OF THE SEWER IS A MINIMUM OF 12 INCHES ABOVE THE TOP OF THE HIGHEST POINT OF THE SEWER AND THE PIPE MATERIALS CONFORM TO APPLICABLE PLUMBING CODES.
- 18. UNLESS NOTED OTHERWISE, RUN CW & HW PIPING FULL SIZE THRU LENGTH OF CHASE, AND MAKE CONNECTIONS TO FIXTURES AS INDICATED IN THE PLUMBING FIXTURE SCHEDULE. PROVIDE RIGID SUPPORT AND BLOCKING IN CHASE FOR HEADER AND BRANCH PIPING, AND FOR FLUSH VALVES TO PREVENT ANY MOVEMENT.
- 19. PROVIDE BALANCING VALVES WITH THREADED CONNECTIONS IN HOT WATER RETURN PIPING, AND BALANCE SYSTEM FOR PROPER OPERATION. REFER TO PLUMBING FIXTURE SCHEDULE.
- 20. COORDINATE THE EXACT LOCATION OF FLOOR AND ROOF DRAINS WITH ARCHITECT PRIOR TO CONSTRUCTION.
- 21. PROVIDE ALL NECESSARY VALVES, TRAPS, FLOW CONTROLS, FILTERS, BACKFLOW ASSEMBLIES, FAUCETS, STOPS, TAILPIECES, VACUUM BREAKERS, IF NOT FURNISHED WITH EQUIPMENT.
- 22. CONTRACTOR SHALL ROUGH-IN ALL WASTES AND SUPPLIES TO ALL EQUIPMENT ACCORDING TO MANUFACTURER'S SPECIFICATIONS AND MAKE FINAL CONNECTIONS.
- 23. PROVIDE SUPPLY STOPS ON HOT AND COLD WATER PIPE SUPPLYING ALL FIXTURES AND EQUIPMENT.
- 24. PROVIDE APPROVED CHROME PLATED TYPE VACUUM BREAKERS WHERE REQUIRED BY LOCAL CODES, AND AS INDICATED ON PLANS FOR NEW WORK.
- 25. SUBMIT CORE-DRILL PLAN TO STRUCTURAL ENGINEER AND ARCHITECT FOR REVIEW PRIOR TO STARTING ANY WORK.
- 26. PROVIDE DIELECTRIC UNIONS WHERE CONNECTIONS ARE MADE BETWEEN DISSIMILAR PIPE MATERIALS.
- 27. SEE RISER DIAGRAMS FOR PIPE SIZES AND ROUTING NOT SHOWN ON PLANS.
- 28. METERING AND SITE UTILITY CONNECTIONS SHALL BE PROVIDED ON SITE UTILITY DRAWINGS. ALL SERVICES SHOWN ON THIS SET OF PLANS TERMINATE 5'-0" FROM BUILDING, UNLESS SHOWN OTHERWISE ON DRAWINGS. PLUMBING CONTRACTOR SHALL MAKE FINAL CONNECTIONS TO SITE UTILITES. (INC. CLEANOUTS, INCREASES, BACKWATER VALVES, ETC.)
- 29. PRESSURE REDUCING VALVES SHALL BE PROVIDED WHERE THE WATER PRESSURE EXCEEDS 80 PSI AT ANY PLUMBING FIXTURE. WATER VELOCITY SHALL NOT EXCEED 8 FEET PER SECOND.
- 30. COORDINATE EXACT LOCATION OF FLOOR DRAINS AND HUB DRAINS FOR HVAC EQUIPMENT WITH MECHANICAL CONTRACTOR. CONDENSATE PIPING SHALL NOT DISCHARGE INTO SANITARY SYSTEM.
- 31. DO NOT PENETRATE WALL FOOTINGS WITH PIPING, COORDINATE WITH GENERAL CONTRACTOR TO DROP FOOTINGS AS REQUIRED TO CLEAR PLUMBING SERVICES WHERE ABSOLUTELY NECESSARY. ALL PIPING PENETRATING A BEARING WALL OR FOOTING MUST BE SLEEVED AND LOCATION APPROVED BY STRUCTURAL ENGINEER.
- 32. IF THE INTENT OF THE INFORMATION SHOWN ON THESE DOCUMENTS IS NOT CLEAR, OR IS CAPABLE OF MORE THAN ONE INTERPRETATION, SUCH MATTERS WILL BE BROUGHT TO THE ATTENTION OF THE ARCHITECT/ENGINEER IN WRITING BEFORE THE SUBMISSION OF BIDS, AND THE ARCHITECT/ENGINEER SHALL MAKE CORRECTION OR EXPLANATION IN WRITING.
- 33. WHERE THE CONTRACTOR PROPOSES ALTERNATE SOLUTIONS, DIFFERENT ROUTINGS OF PIPING, DIFFERENT LOCATIONS OF EQUIPMENT, FIXTURES, ETC., THE CONTRACTOR SHALL BE RESPONSIBLE FOR ALL OF THE RAMIFICATIONS OF THE PROPOSED CHANGE THAT ARE NOT INCLUDED IN HIS PROPOSAL, BUT BECOME APPARENT AT A LATER DATE, AND SHALL BEAR THE CONSEQUENCES OF CORRECTING ANY AND ALL CONFLICTS, DEFICIENCIES OR OTHER PROBLEMS AT NO INCREASE IN COST OR INCREASE IN CONSTRUCTION TIME ALLOTTED.

				PLU	MBI	NG EQUIPMENT SCHEDULE
MARK	FIXTURE	SOIL/ WASTE	VENT	COLD WATER	HOT WATER	DESCRIPTION
FCO	FLOOR CLEAN-OUT	-	-	-	-	<u>WATTS #CO-200-RX</u> , EPOXY COATED CAST IRON FLOOR CLEANOUT WITH 5 IN. (127MM) ROUND ADJUSTABLE GASKETED HEAVY DUTY NICKEL BRONZE TOP, REMOVABLE GAS TIGHT GASKETED BRASS CLEANOUT PLUG AND NO HUB (STANDARD) OUTLET.
FD-1	FLOOR DRAIN	3"	-	-	-	<u>WATTS #FD-100-A</u> , ADJUSTABLE ROUND NICKEL BRONZE STRAINER, EPOXY COATED CAST IRON FLOOR DRAIN WITH ANCHOR FLANGE, REVERSIBLE CLAMPING COLLAR WITH PRIMARY AND SECONDARY WEEPHOLES, AND NO HUB (STANDARD) OUTLET.
HB-1	HOSE BIBB	-	-	3/4"	-	WOODFORD #24, ANTI-SIPHON, VACUM BREAKER, DESIGNED FOR MILD CLIMATE AREAS. ASSE STANDARD 1011 APPROVED, FURNISHED WITH POLYCARBONATE WHEEL HANDLE AND LOSE TEE KEY ALUMINUM, BRASS OR CHROME BOX.
wco	WALL CLEAN-OUT	-	-	-	-	WATTS #CO-440-RD, WALL CLEANOUT WITH TWO-PIECE EXPANDABLE CLEANOUT PLUG, STAINLESS STEEL ACCESS COVER, AND VANDAL PROOF STAINLESS STEEL SCREW.


			PLU	JMBI	NG F	IXTURE SCHEDULE
MARK	FIXTURE	SOIL/ WASTE	VENT	COLD WATER	HOT WATER	DESCRIPTION
L-1	LAVATORY	1-1/2"	2"	1/2"	1/2"	<u>CHINA:</u> AMERICAN STANDARD #0355.027 'LUCERNE' WALL HUNG LAVATORY, 4" SPREAD FAUCET HOLES, FRONT OVERFLOW, WHITE. <u>FAUCET:</u> T&S #B-0871 FAUCET, 4" CENTERSET DECK MOUNTED. SUPPLY WITH BRADLEY #S59-4000A THERMOSTATIC MIXING VALVE. BRASS CRAFT, 1/4 ROUGH BRASS STOPS, SCREEN DRAIN, PLASTIC ESCUTCHEONS, SUPPLIES, TRAPS, & DISPOSAL WASTE.
WC-1	WATER CLOSET	3"	2"	1/2"	-	AMERICAN STANDARD #2898.012, ELONGATED TANK TYPE, VITREOUS CHINA, LOW- CONSUMPTION (1.6 GPF/6.0 LPF), 12" ROUGHING-IN. SEAT: CHURCH #9500C, ENLOGATED SEAT OPEN FRONT LESS COVER, SOLID PLASTIC, CONCEALED CHECK STAINLESS STEEL HINGES.
WC-2	WATER CLOSET-ADA	3"	2"	1/2"	-	AMERICAN STANDARD #2998.012, ELONGATED TANK TYPE, VITREOUS CHINA, LOW- CONSUMPTION (1.6 GPF/6.0 LPF), 12" ROUGHING-IN, 16-1/2" RIM HEIGHT. SEAT: CHURCH #9500C, ENLOGATED SEAT OPEN FRONT LESS COVER, SOLID PLASTIC, CONCEALED CHECK STAINLESS STEEL HINGES.
SH-1	SHOWER	1-1/2"	1-1/2"	1/2"	1/2"	<u>SHOWER:</u> 36"x36" SHOWER RECEPTOR, TILE WALLS & DOORS BY OTHERS. <u>FAUCET:</u> MOEN #T552EP 'BRANTFORD', CHROME FINISH SHOWER TRIM, 2.0 GPM MAX. <u>SHOWER DRAIN</u> : OATEY 130 SERIES, PVC PLASTIC.
SH-2	SHOWER-ADA	1-1/2"	1-1/2"	1/2"	1/2"	<u>SHOWER:</u> 36"X36" ROLL IN SHOWER RECEPTOR (SEAT, GRAB BARS & TILE WALLS BY OTHERS) <u>FAUCET:</u> MOEN #T552EP 'BRANTFORD', CHROME FINISH SHOWER TRIM, 2.0 GPM MAX. <u>SHOWER DRAIN</u> : OATEY 130 SERIES, PVC PLASTIC.
SH-3	SHOWER-ADA	1-1/2"	1-1/2"	1/2"	1/2"	SHOWER: STERLING: #72131100, 60"x32-1/2" SHOWER RECEPTOR, VIKRELL MATERIAL. CERAMIC TILE WALL SURROUNDS. <u>FAUCET:</u> MOEN #T552EP 'BRANTFORD', CHROME FINISH SHOWER TRIM, 2.0 GPM MAX. <u>SHOWER DRAIN</u> : SHOWER DRAIN: ZURN #FD2254, ADJUSTABLE SHOWER DRAIN, CHROME PLATED.
NOTE: 1. ALL FIXTU	URES SHALL COMPLY WITH TABLE	604.4 OF	THE FLOI	RIDA PLU	MBING C	ODE FOR WATER CONSERVATION.

2. CONTRACTOR MAY SUBMIT AN APPROVED EQUIVALENT MANUFACTURER FOR ALL FIXTURES.


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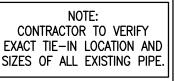


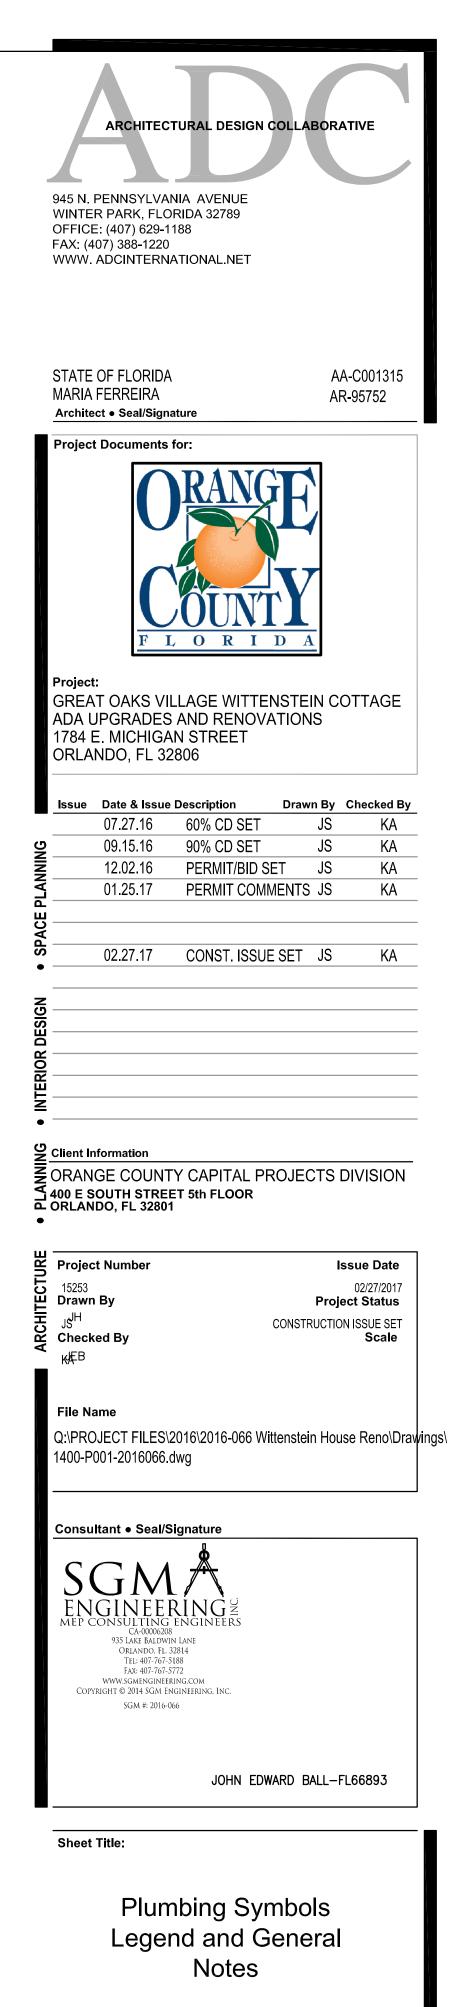
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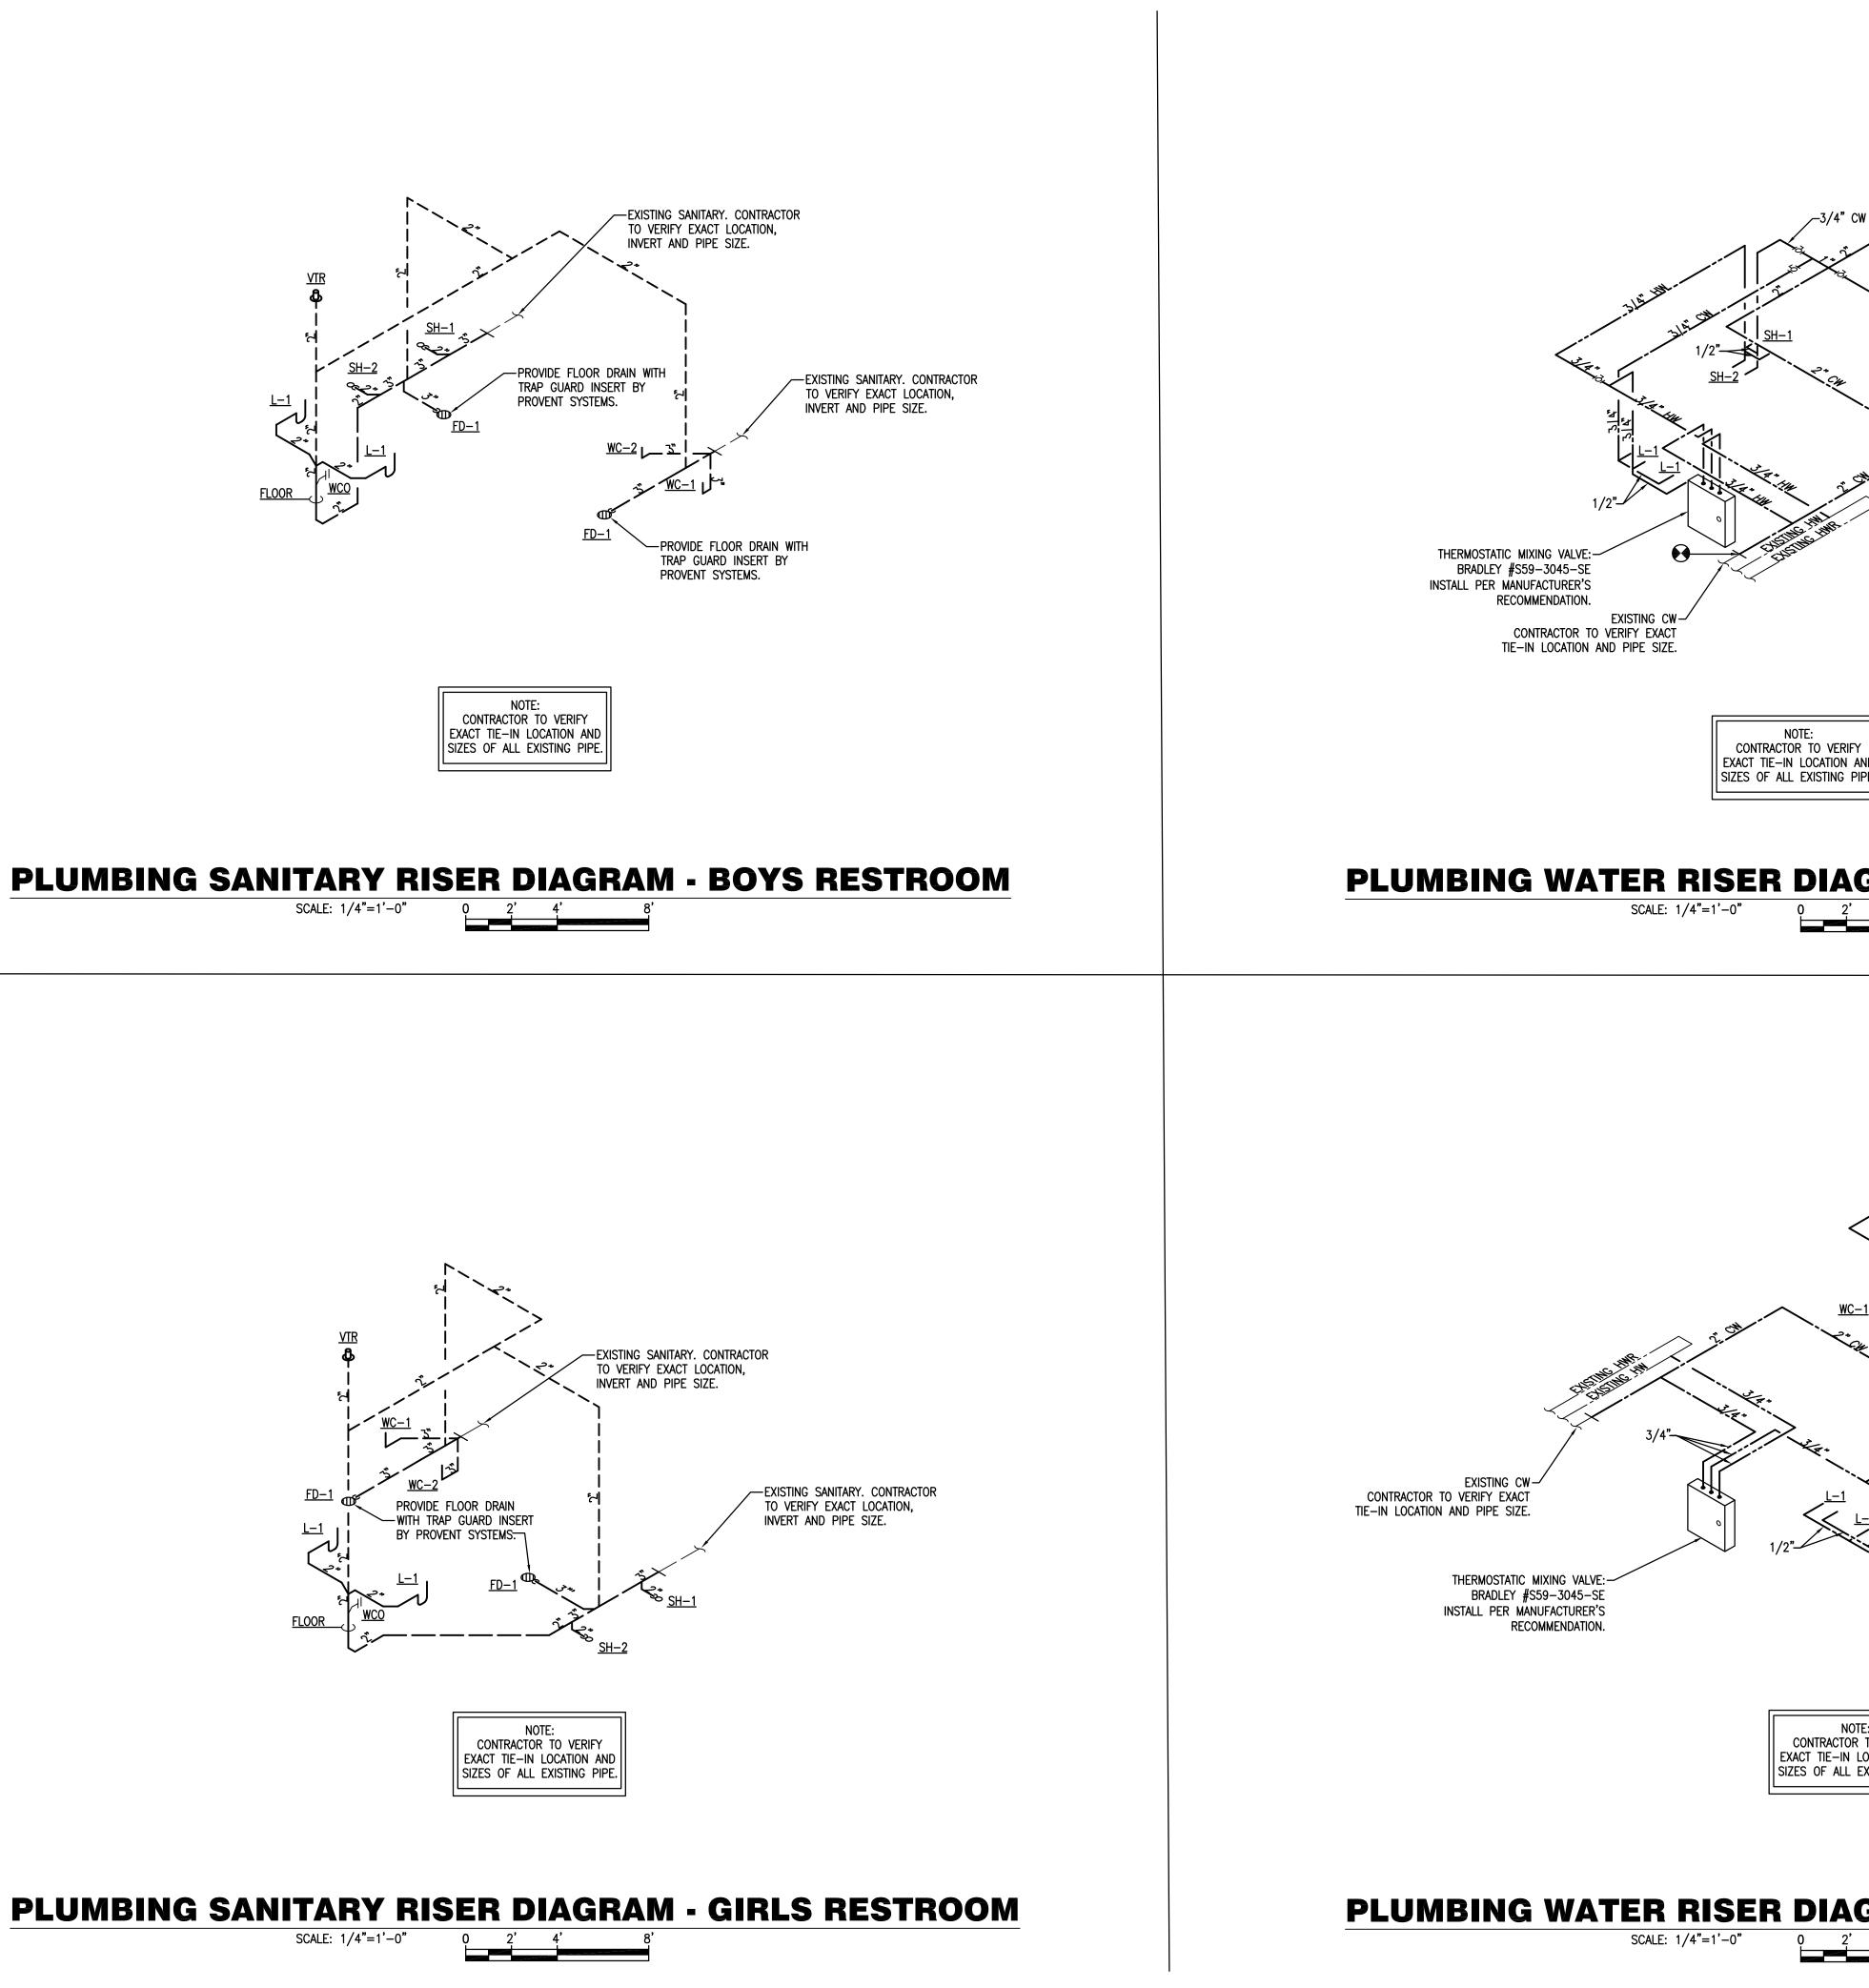


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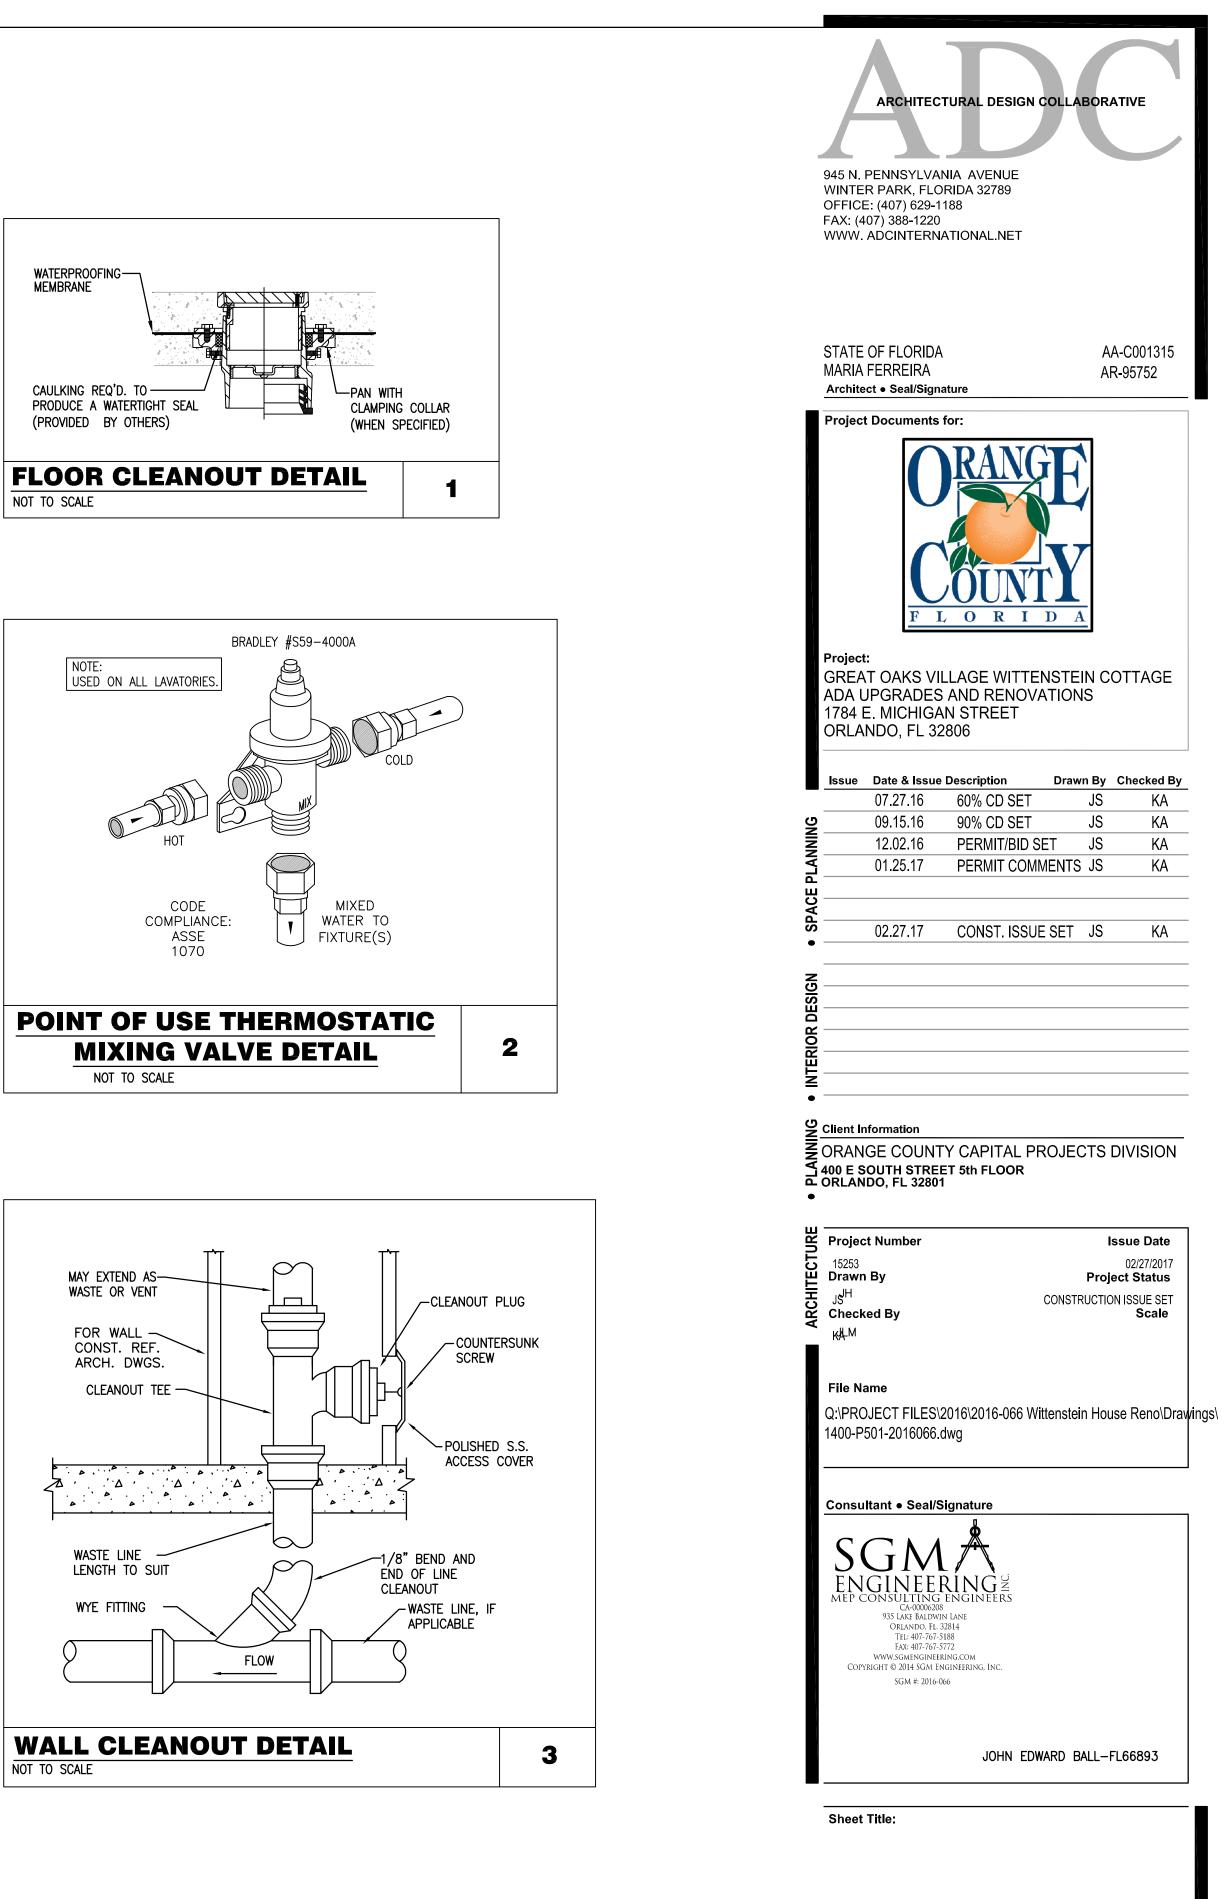


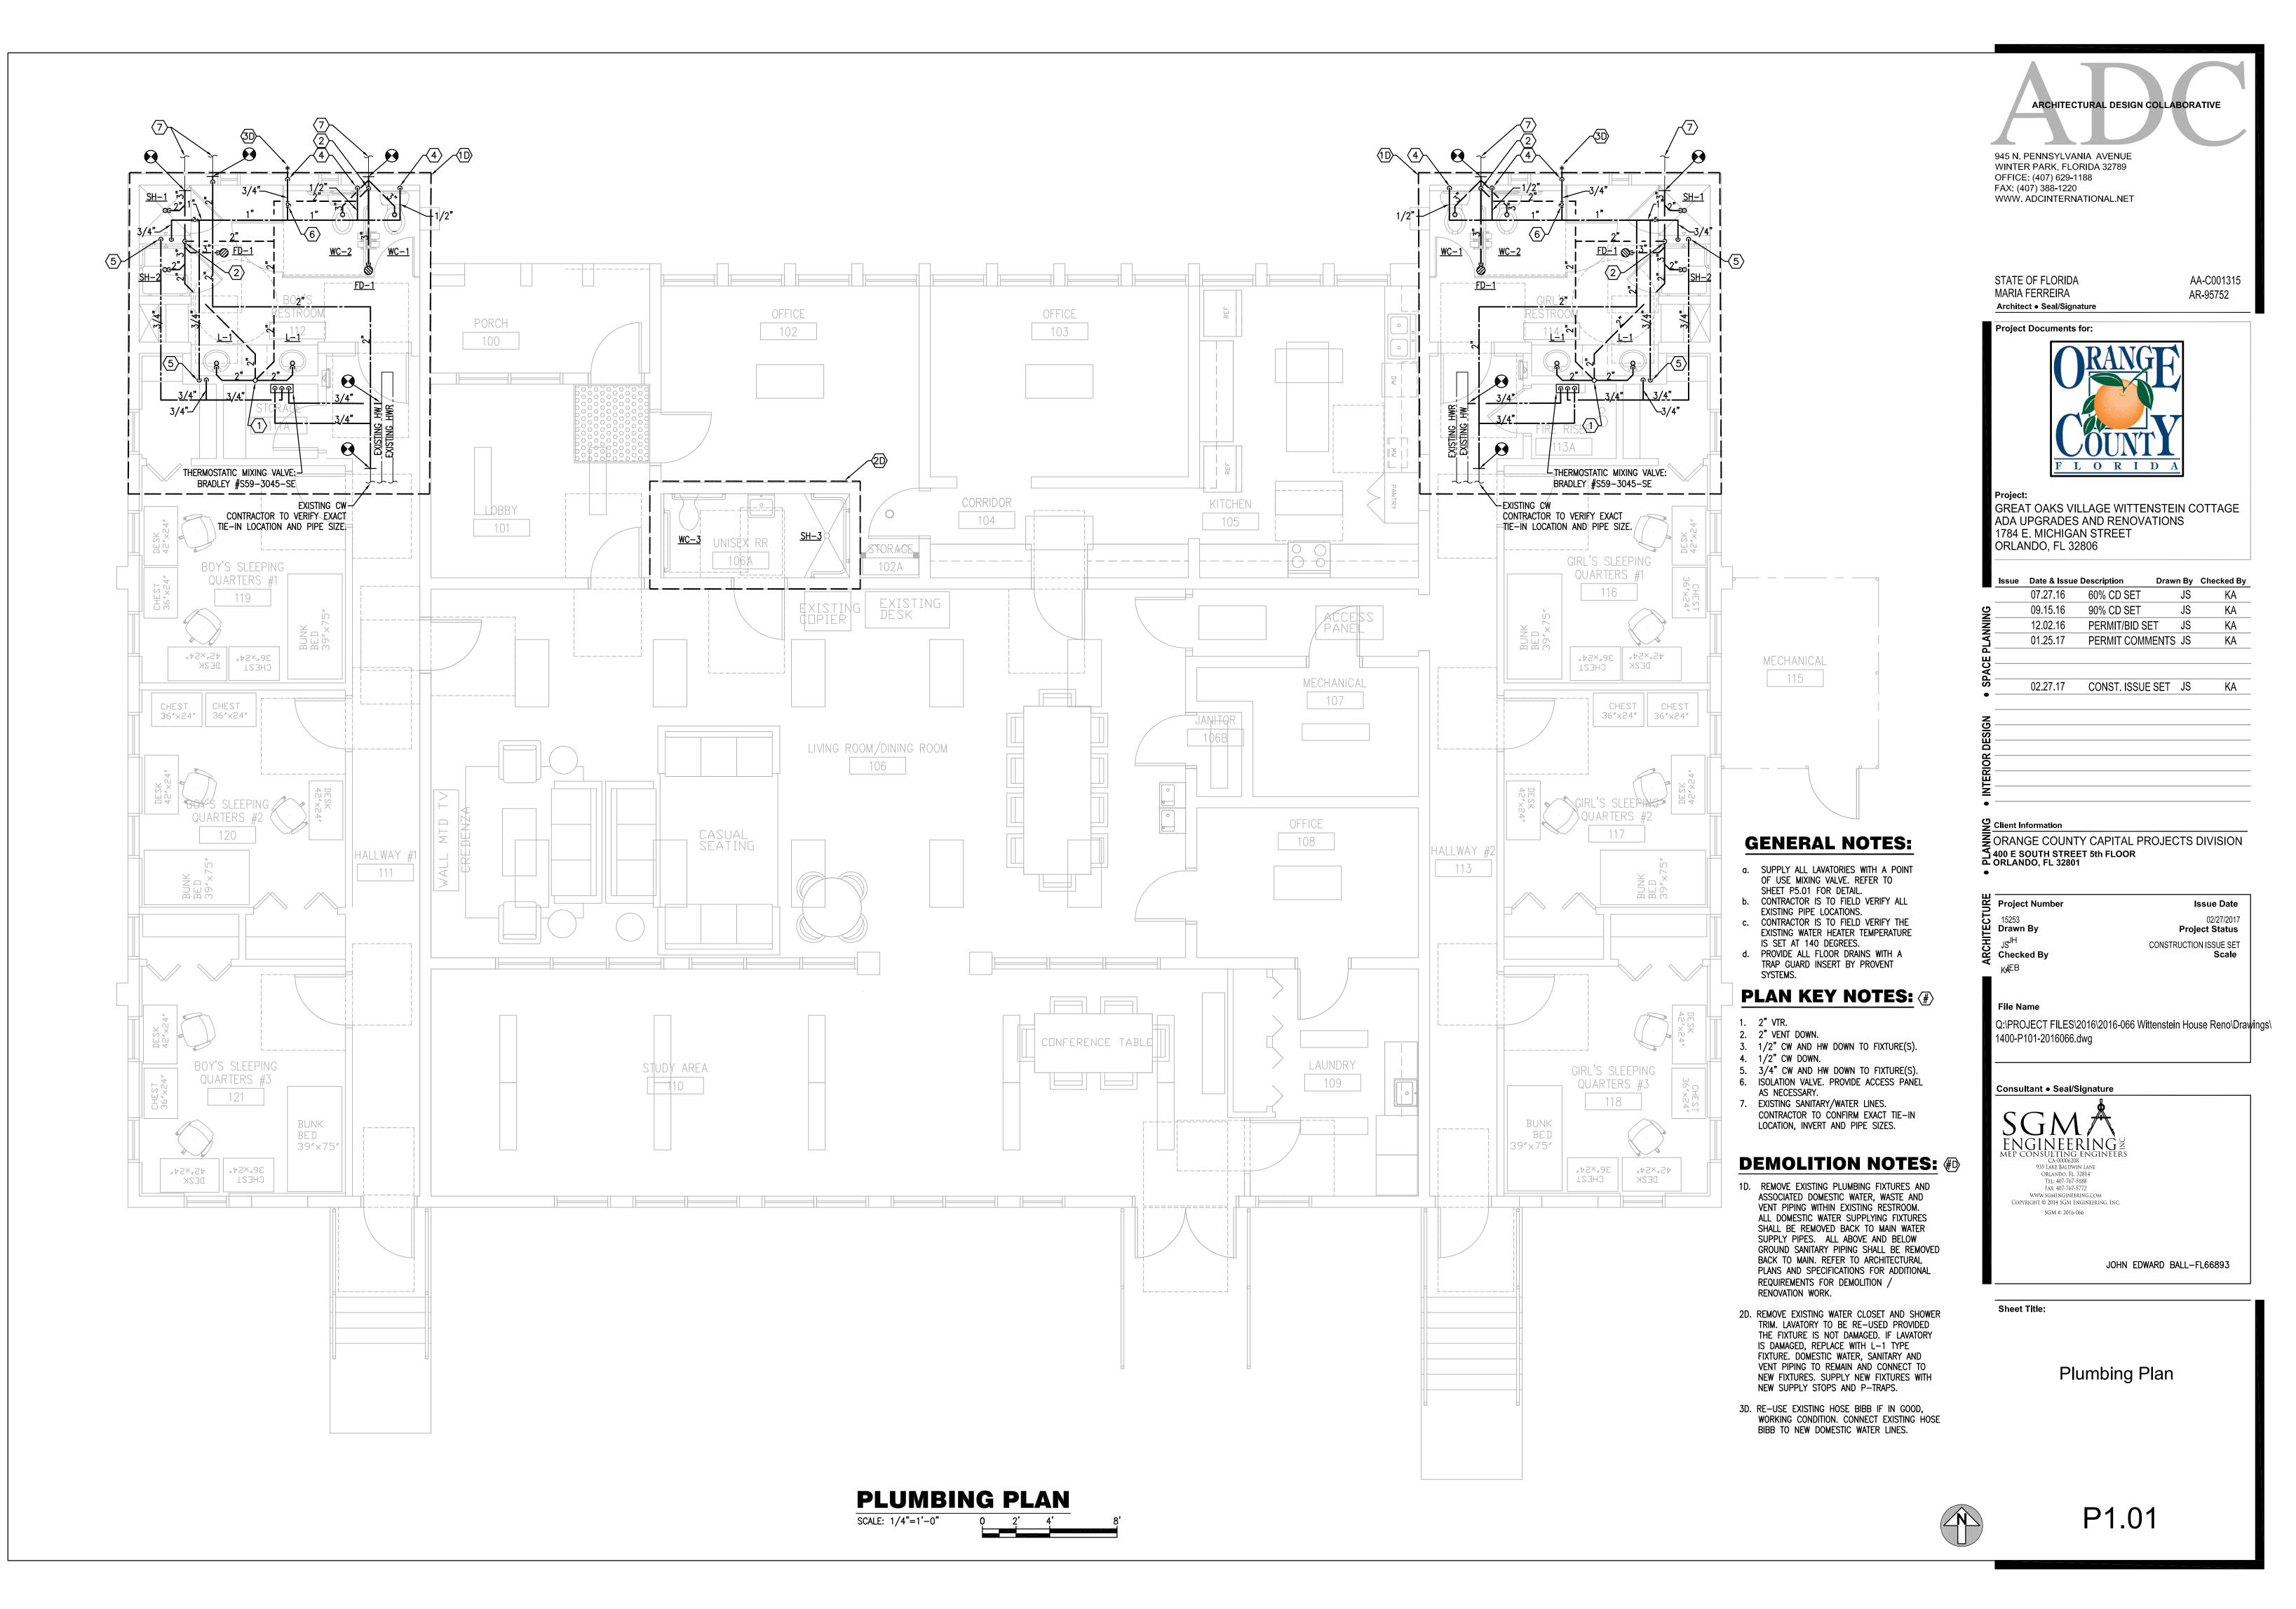


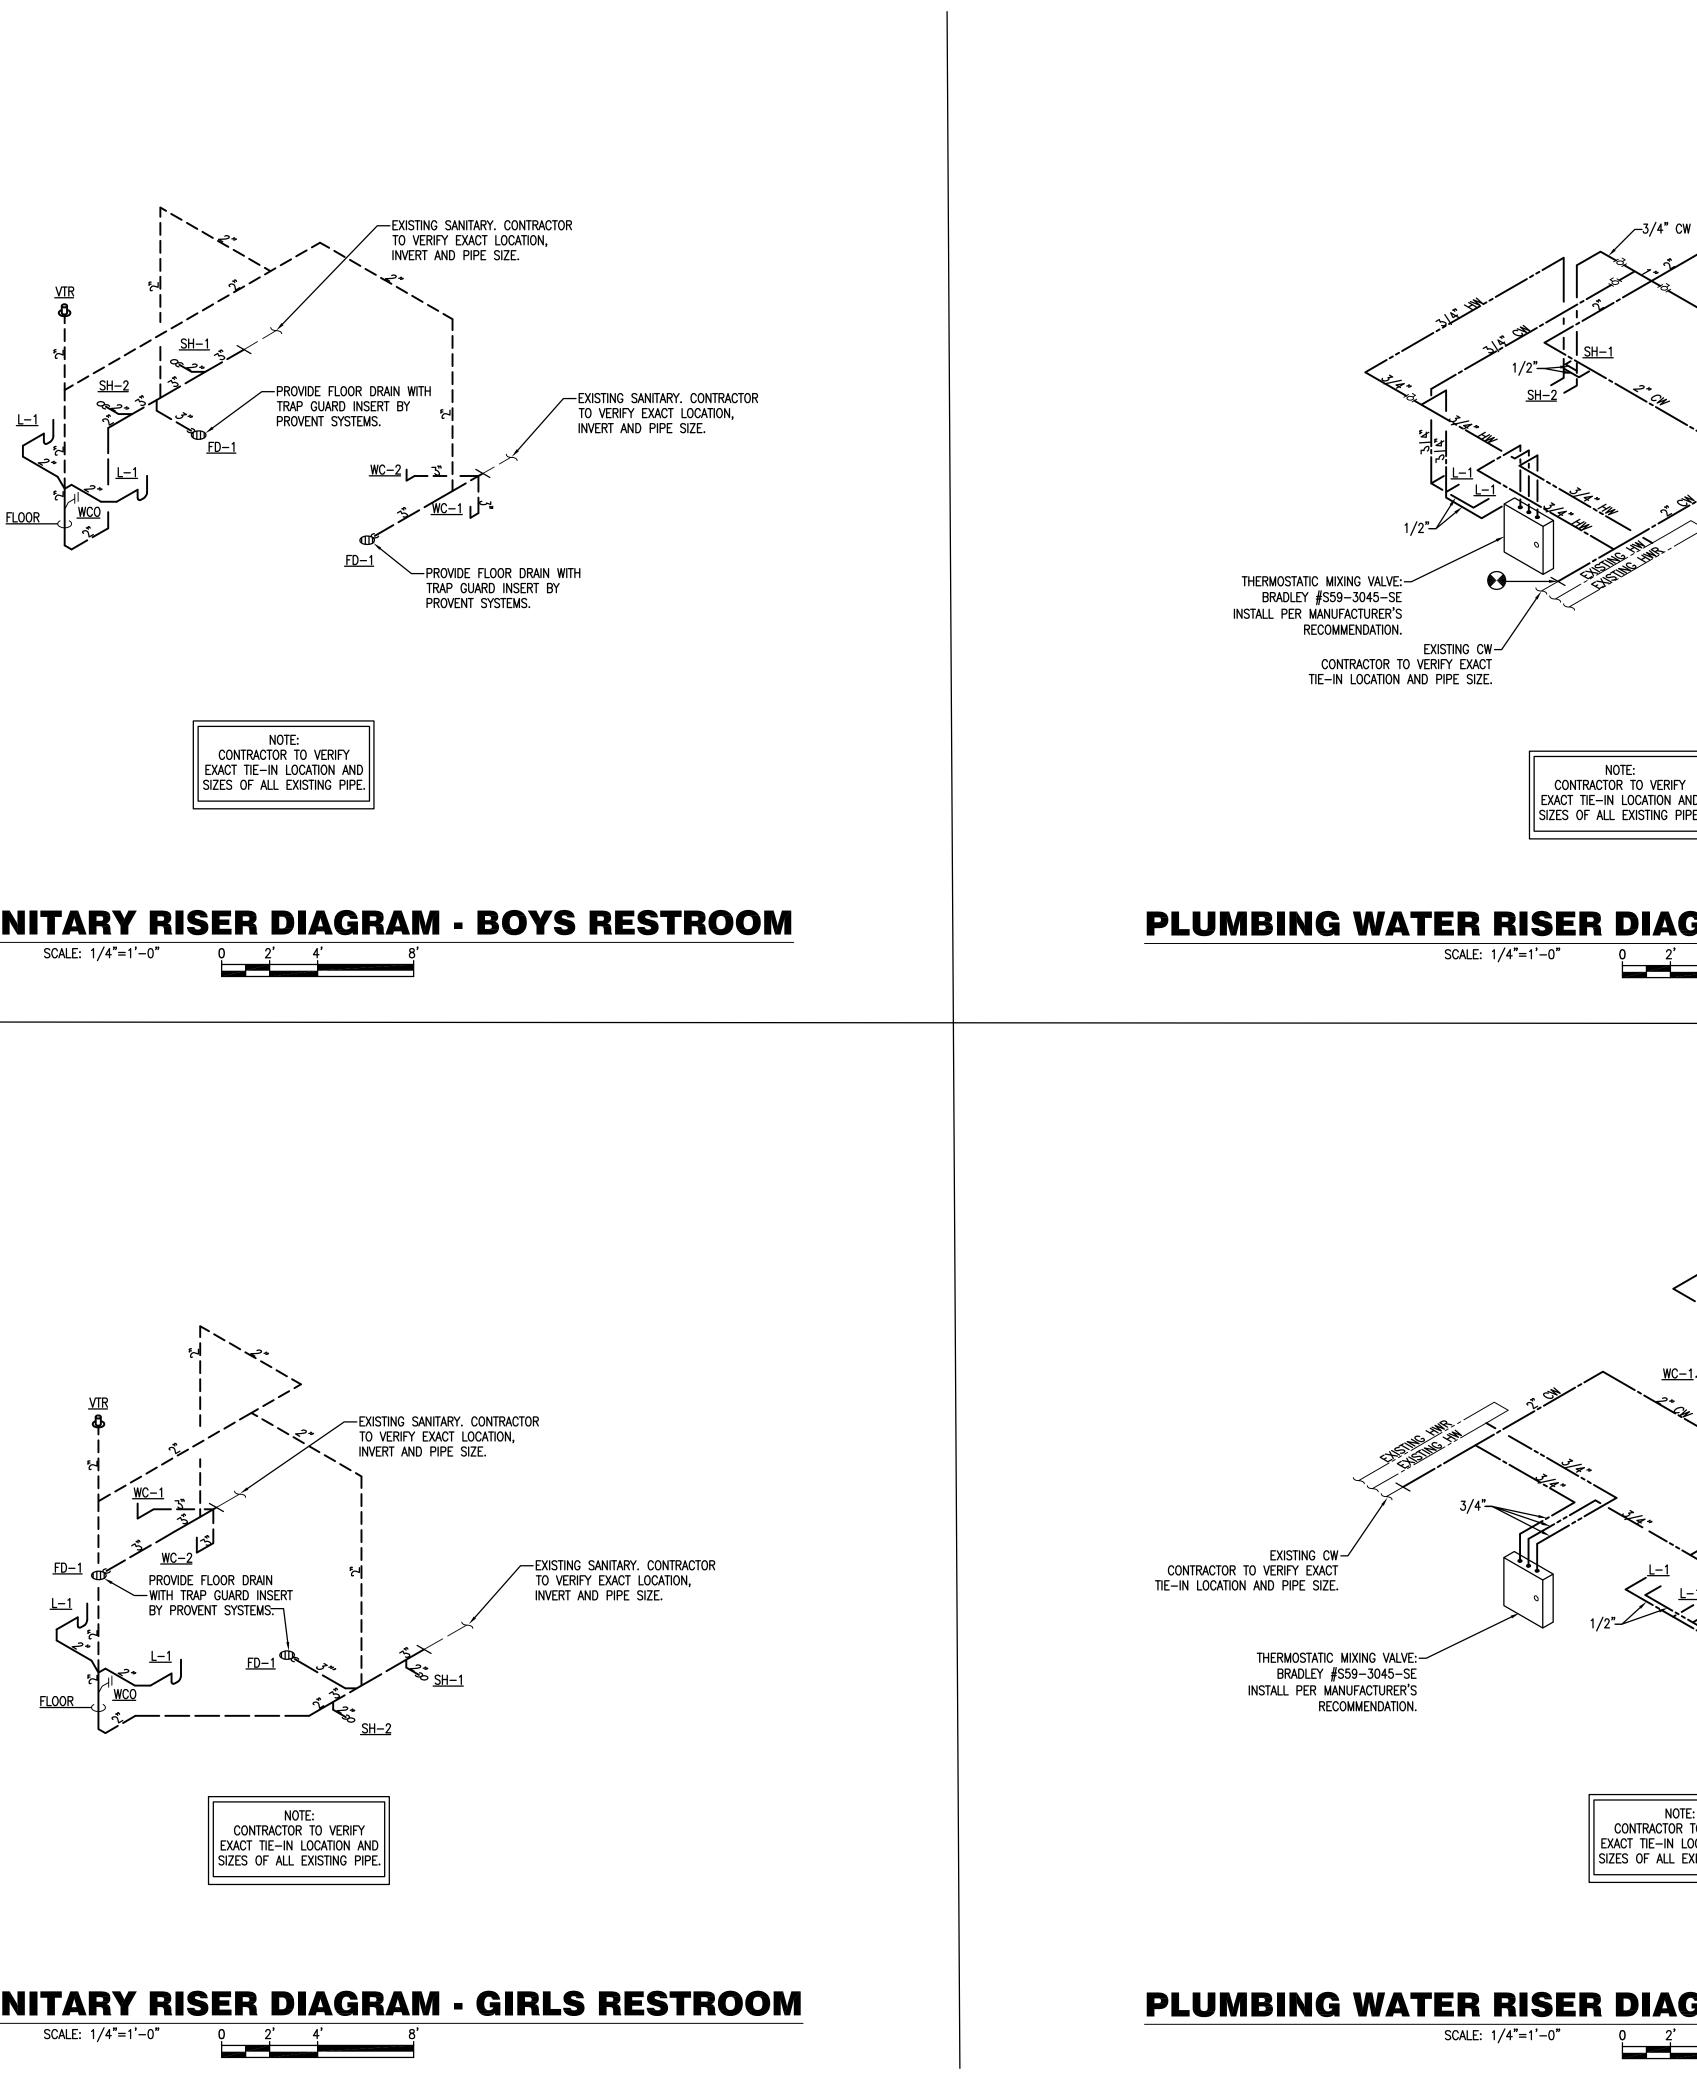


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	STATE OF FLORIDA AA-C001315 MARIA FERREIRA AR-95752 Architect • Seal/Signature
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Plumbing Details
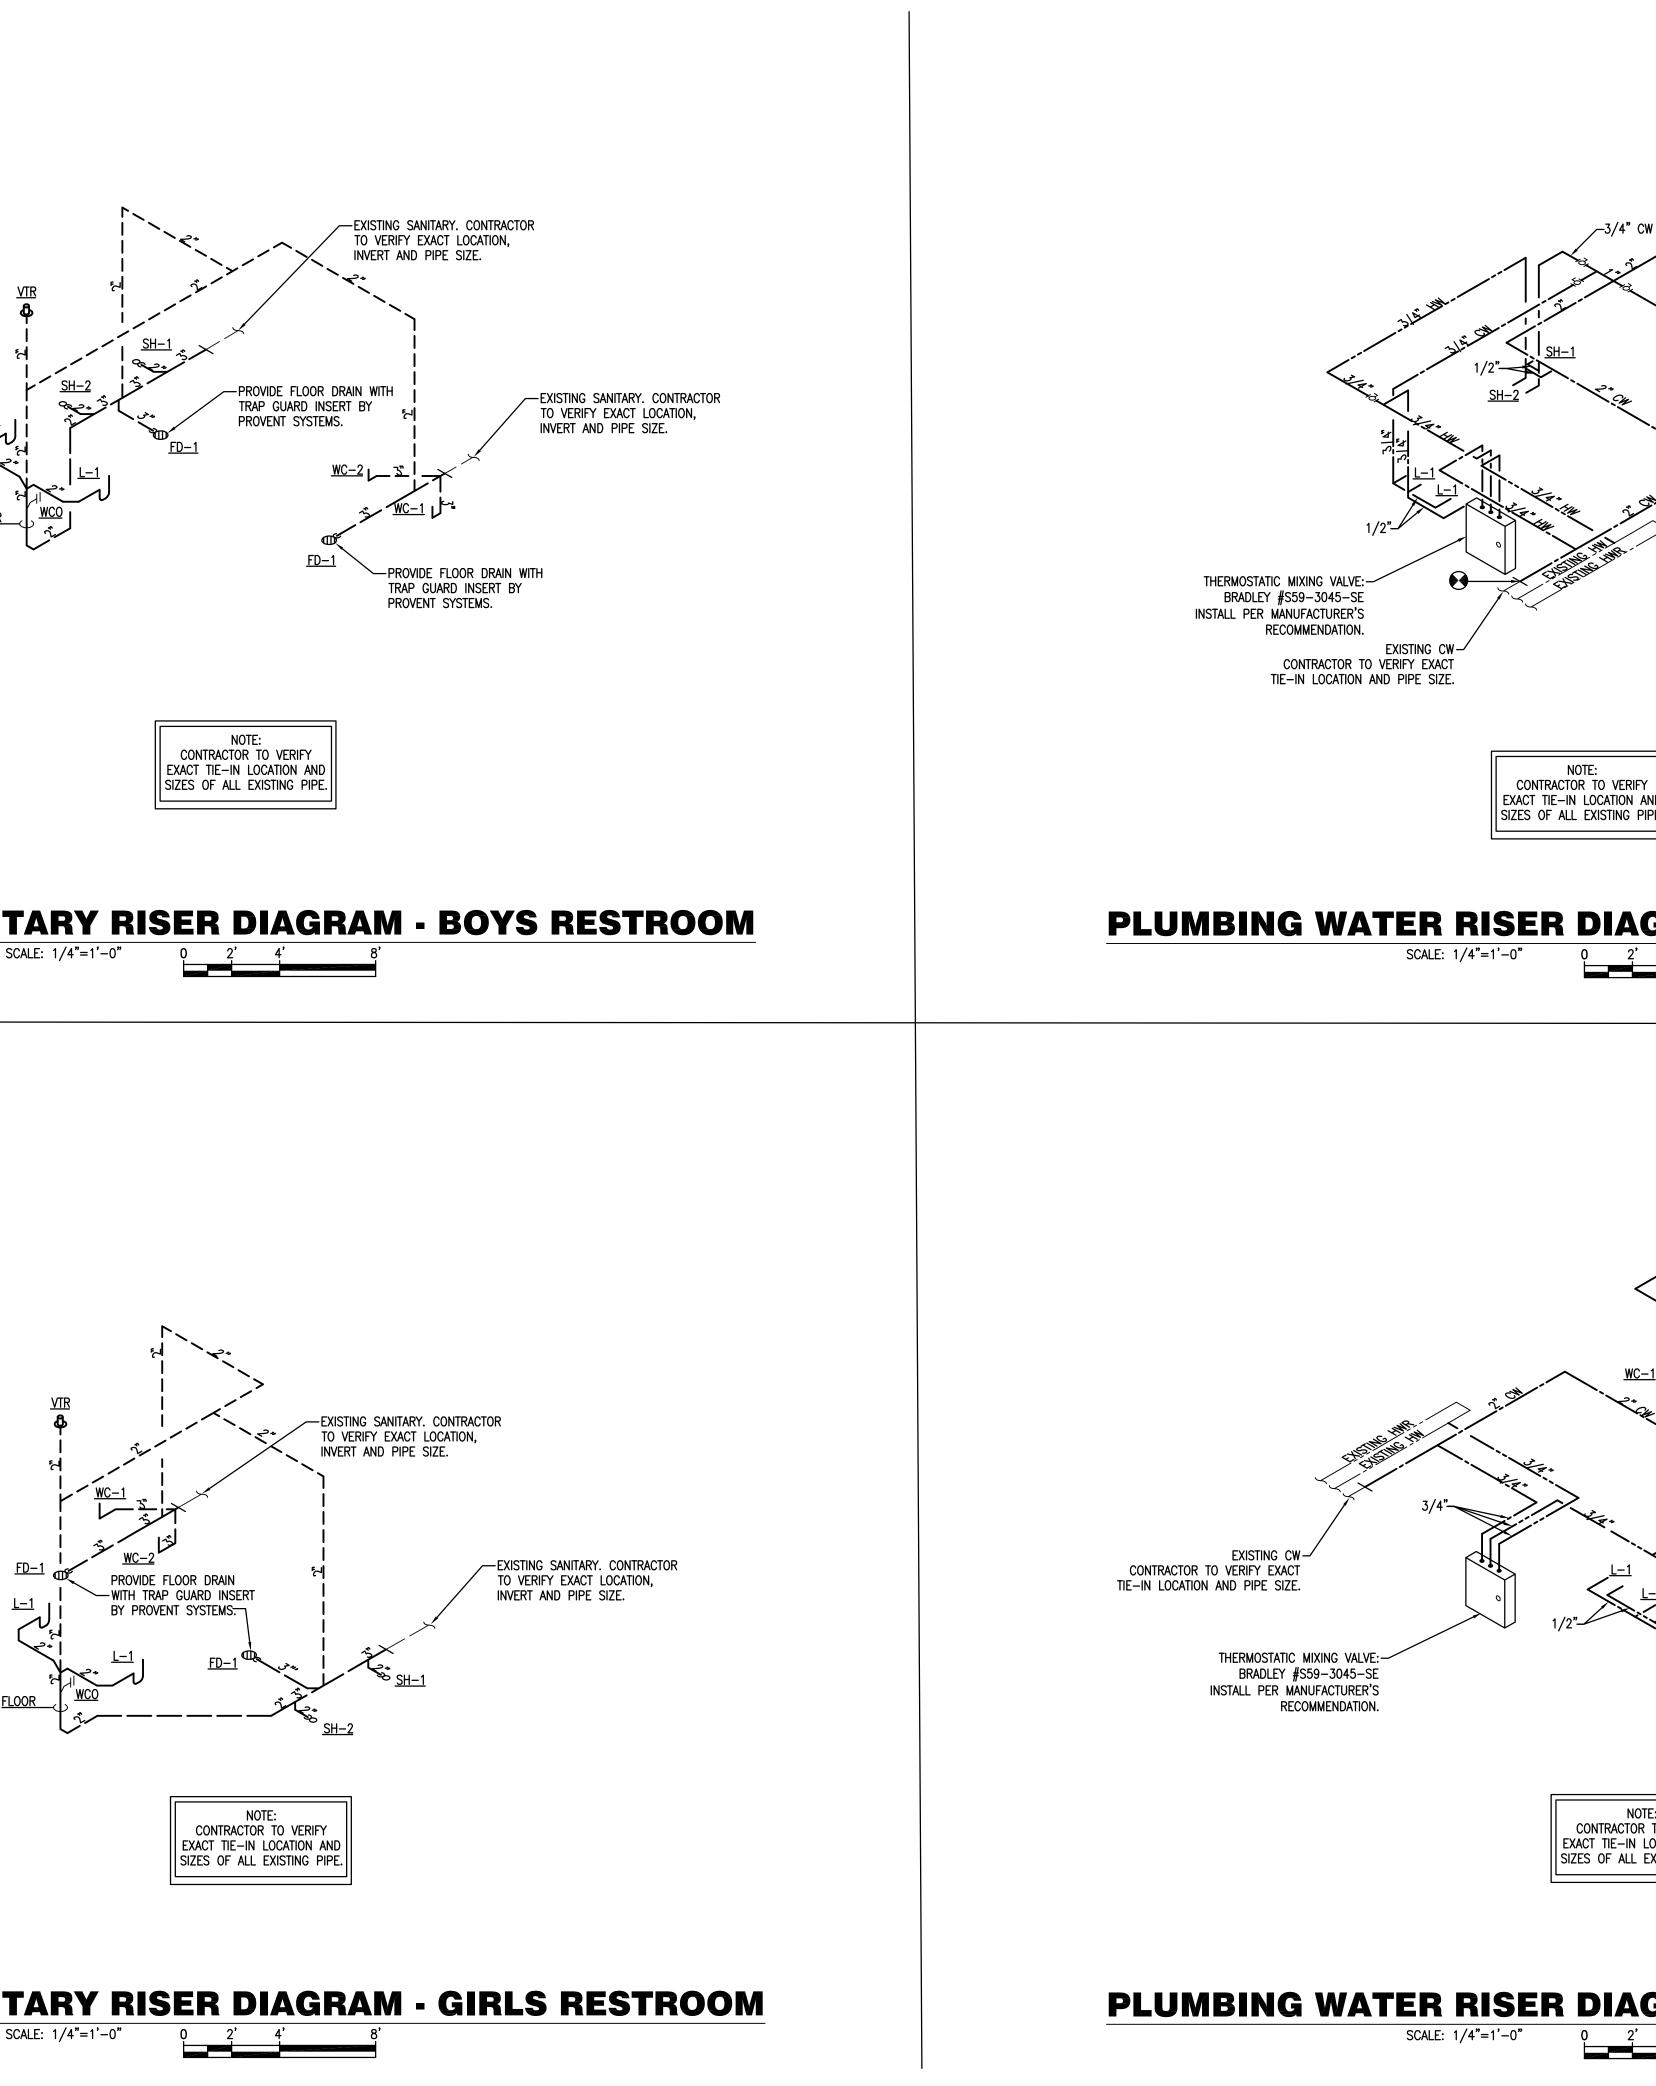
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MECHANICAL GENERAL NOTES

- . IF THE INTENT OF ARCHITECT/ ENGINEER WITH REGARD TO ANY DETAIL IS NOT CLEAR, OR IS CAPABLE OF MORE THAN ONE INTERPRET WILL BE BROUGHT TO THE ATTENTION OF THE ARCHITECT/ENGINEER IN WRITING BEFORE THE SUBMISSION OF BIDS, AND THE ARCHITE MAKE CORRECTION OR EXPLANATION IN WRITING. OTHERWISE, NO EXTRA CHARGE WILL BE ALLOWED FOR THE WORK OR MA ARCHITECT/ENGINEER WILL REQUIRE, PROVIDED THAT IT COMES WITHIN A REASONABLE INTERPRETATION OF THE DRAWINGS AND SPECIFICA
- 2. THE PLANS AND SPECIFICATIONS ARE INTENDED AS A GENERAL DESCRIPTION OF THE WORK TO BE PERFORMED. ALL ITEMS NOT SPECIF SHOWN, BUT NECESSARY FOR THE COMPLETION OF THE INSTALLATION, SHALL BE FURNISHED AND INSTALLED BY THIS CONTRACTOR. TH THOROUGHLY ACQUAINT THEMSELVES WITH THE MECHANICAL, ARCHITECTURAL, STRUCTURAL AND ELECTRICAL PLANS BEFORE SUBMITTING ADDITIONAL COMPENSATION WILL BE ALLOWED DUE TO THE CONTRACTOR'S FAILURE TO FAMILIARIZE THEMSELVES WITH THE PLANS.
- 3. ALL WORK SHALL BE IN ACCORDANCE WITH THE FLORIDA BUILDING CODE 2014.
- 4. THE SIZE AND LOCATION OF EQUIPMENT INSTALLED UNDER DIVISION 23 MECHANICAL SHALL BE COORDINATED WITH OTHER TRA EQUIPMENT SHALL BE VERIFIED WITH MANUFACTURER'S CERTIFIED DRAWINGS. TRANSITIONS TO ALL EQUIPMENT SHALL BE VERIFIED EQUIPMENT FURNISHED.
- 5. DUCTWORK AND PIPING TO MECHANICAL EQUIPMENT SHALL BE INSTALLED IN A MANNER THAT DOES NOT OBSTRUCT EQUIPMENT SERVICE (
- 6. COORDINATE WORK WITH ALL TRADES INCLUDING, BUT NOT LIMITED TO, ARCHITECTURAL, STRUCTURAL, CIVIL, LIGHTING, POWER SYS FIRE PROTECTION EXISTING AND NEW WORK.
- 7. INTERRUPTION OF EXISTING SERVICES SHALL BE MINIMAL AND SHALL BE FULLY COORDINATED WITH THE OWNER AND ALL TRADES IN ADV ALL INTERRUPTIONS DURING NON-CRITICAL TIMES.
- B. DISCONNECT SWITCHES REQUIRED FOR THE MECHANICAL EQUIPMENT SHALL BE PROVIDED BY DIVISION 26 ELECTRICAL EXCEPT SCHEDULE.
 9. ALL EQUIPMENT, DUCTWORK, ETC., SHALL BE SUPPORTED AS DETAILED AND/OR SPECIFIED. PROVIDE ADDITIONAL SUPPORTS AS REQU
- VIBRATION-FREE, RIGID INSTALLATION. SUPPORT ALL OBJECTS FROM STRUCTURE WITHOUT PENETRATING THE CEILING.
- 10. ALL HVAC EQUIPMENT LOCATION & WEIGHT SHALL BE COORDINATED AND APPROVED BY THE ARCHITECT, STRUCTURAL ENGINEER, CON PRIOR TO PURCHASE AND INSTALLATION.
- 11. REFER TO TYPICAL DETAILS FOR DUCTWORK AND INSTALLATION OF EQUIPMENT.
- 12. ALL DUCTWORK SHALL BE CONSTRUCTED AND INSTALLED IN ACCORDANCE WITH NFPA 90A AND 90B.
- 13. DUCT SIZES SHOWN ARE MINIMUM INSIDE DIMENSIONS.
- 14. SEE SPECS. FOR GAUGES, THICKNESS, BRACING, REQUIREMENTS, ETC., OF DUCTWORK.
- 15. BEFORE FABRICATION, VERIFY AND COORDINATE ALL DIMENSIONS IN FIELD. DUCT SIZES AND ALL OPENINGS THRU BUILDING CONST EQUIPMENT FURNISHED.
- 16. ALL WORK SHALL BE COORDINATED WITH ALL TRADES INVOLVED. OFFSETS IN DUCTS AND PIPING (INCLUDING DIVIDING DUCTS) AND OBSTRUCTIONS SHALL BE PROVIDED AT NO ADDITIONAL COST.
- 17. ALL DUCTWORK AND PIPING IS SHOWN SCHEMATICALLY. PROVIDE ALL TRANSITIONS, ELBOWS, FITTINGS, ETC., TO ALLOW SMOOTH FLO FITTINGS SHALL TRANSITION TO FULL SIZE OF THE SUM OF BOTH BRANCHES, UPSTREAM OF SPLIT.
- 18. ACCESS PANELS IN DUCTWORK AND CEILINGS SHALL BE PROVIDED WHERE REQUIRED FOR OPERATION, BALANCING, MAINTENANCE AND ALL MECHANICAL EQUIPMENT INCLUDING CONTROL DAMPERS, TEMPERATURE CONTROL DEVICES, SMOKE DETECTORS, FIRE DAMPERS AND STATIONS.
- 19. MAINTAIN CLEARANCE OF A MINIMUM OF 6" BETWEEN DUCTWORK, PIPING, EQUIPMENT, ETC., AND ALL FIRE RATED AND FIRE/SMOKE ALLOW FOR INSPECTIONS OF RATED WALLS.
- 20. PROVIDE TRANSITIONS AT DIFFUSER NECKS AS REQUIRED TO MATCH SIZES OF FLEX DUCTS TO BE CONNECTED.
- 21. PROVIDE VOLUME DAMPERS IN ALL BRANCH DUCTS FROM MAIN TRUNK LINES OF LOW PRESSURE SYSTEMS.
- 22. COORDINATE DIFFUSER, GRILLE AND REGISTER LOCATIONS WITH ARCHITECTURAL REFLECTED CEILING PLANS AND EQUIPMENT OF ALL TRADES
- 23. COORDINATE WITH ARCHITECT BEFORE PURCHASING GRILLES, REGISTERS, DIFFUSERS, LOUVERS AND OTHER AIR DISTRIBUTION DEVICES TO
- 24. SIDEWALL REGISTERS AND LINEAR TYPE DIFFUSERS SHALL BE INSTALLED LEVEL ALONG A COMMON ELEVATION IN THE SPACE SERVED.
- 25. DAMPERS AND INSIDES OF DUCTS VISIBLE THROUGH GRILLES, REGISTERS AND DIFFUSERS SHALL BE PAINTED FLAT BLACK.
- 26. ALL OPERABLE THERMOSTAT PARTS SHALL BE MOUNTED 48" ABOVE FINISHED FLOOR. ROOM THERMOSTATS DO NOT REQUIRE COVERS. VO VOLT UNLESS OTHERWISE INDICATED.
- 27. COORDINATE COMBINATION THERMOSTAT/HUMDISTAT LOCATIONS WITH FURNITURE/EQUIPMENT LAYOUTS, WINDOWS AND DOOR SWING AREAS.
- 28. ALL CONTROL WIRING AND HARDWARE TO COMPLETE THE HVAC CONTROL SYSTEM SHALL BE FURNISHED AND INSTALLED UNDER DIVISION 23 MECHANICAL OF THESE CONTRACT DOCUMENTS UNLESS OTHERWISE SPECIFIED OR INDICATED ON DRAWINGS.

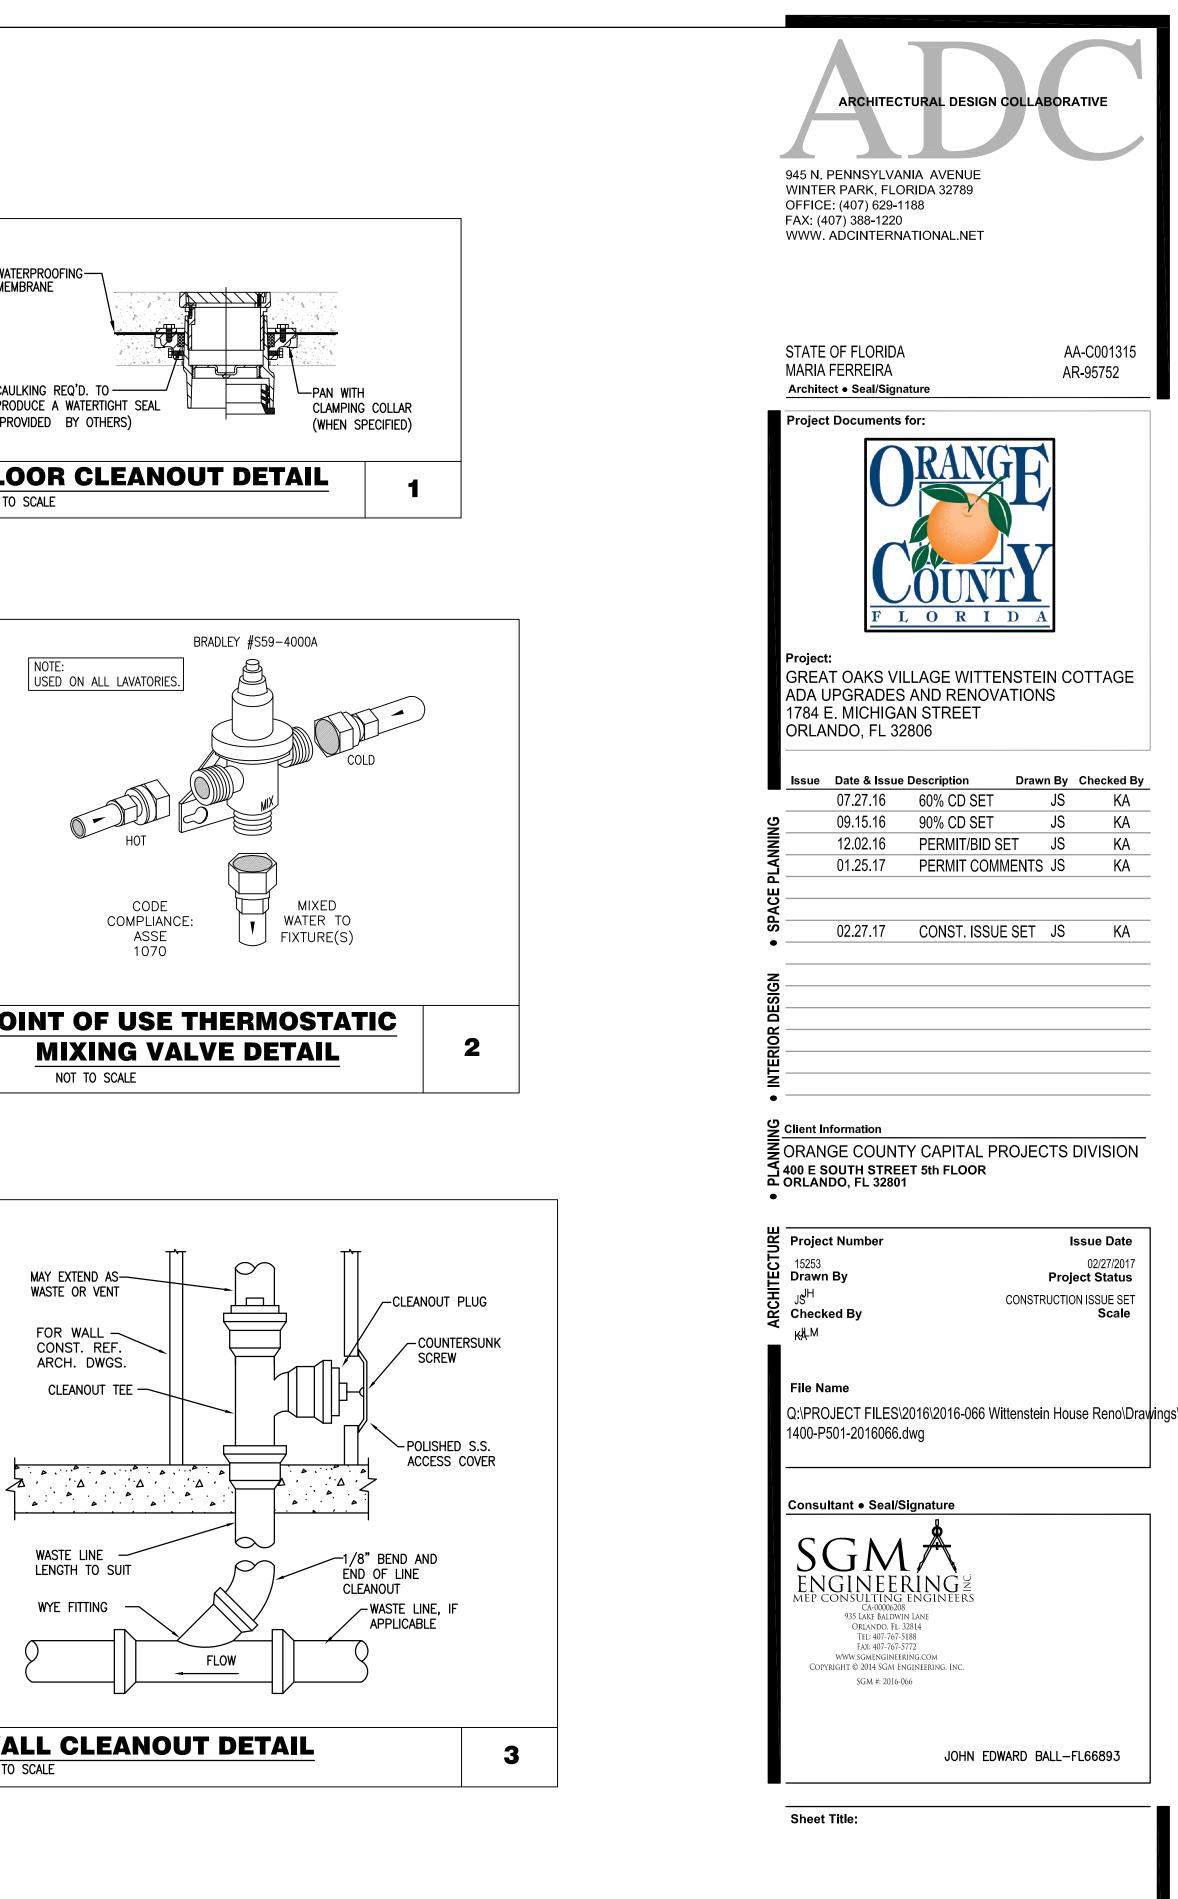
				EX	JAU	IST F		SCHED	ULE				
	00105	0514	E.S.P. IN	FAN	м	DTOR DATA		TYPE OF	MAKE	MODEL		SONES	REMARKS
MARK	SPACE SERVED	CFM	INCHES H ₂ 0	RPM	RPM	VOLTS/PH	APMS	FAN	MARE	MODEL	DRIVE	SUNES	REMARKS
EF-1	RESTROOM	360	0.10	843	1500	120/1	1.7	SIDE WALL	BROAN OR APPROVED EQUAL	MODEL 12C	DIRECT	8.0	1–2
EF-2	RESTROOM	360	0.10	843	1500	120/1	1.7	SIDE WALL	BROAN OR APPROVED EQUAL	MODEL 12C	DIRECT	8.0	1–2

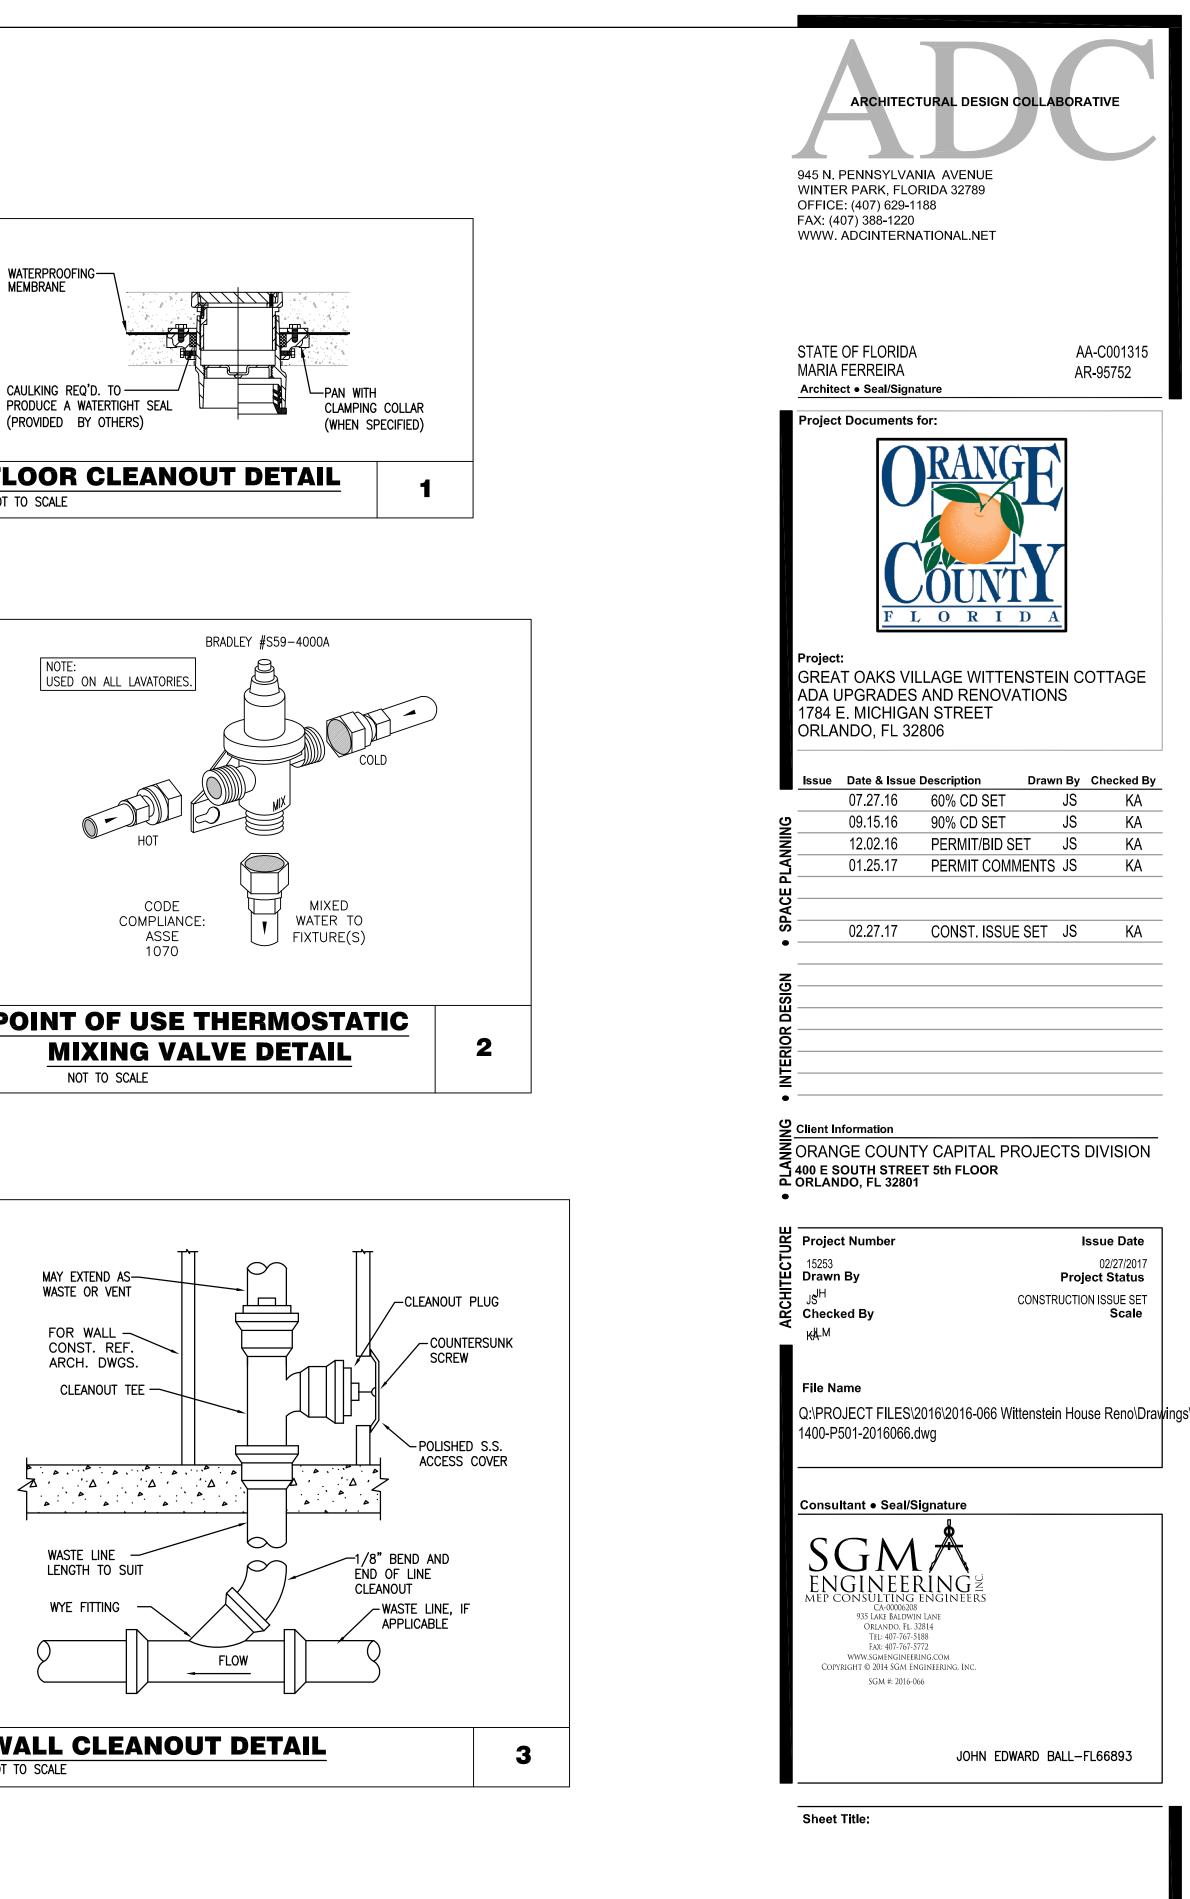.

NOTES:


PROVIDE FANS WITH BACKDRAFT DAMPERS.
 PROVIDE A WEATHERHOOD WITH INSECT SCREEN.

		MECHANICAL	ABBRI	EVIATIONS	MEG	CHANICAL SYMB
					PIPING	
RETATION, SUCH MATTERS HITECT/ ENGINEER SHALL	A	AIR	HR	HOUR		
MATERIAL WHICH THE	AAV	AUTOMATIC AIR VENT	HVAC	HEATING VENTILATING		
ICATIONS.	AC	AIR CONDITIONING		AND AIR CONDITIONING	—	POINT OF CONNECTION
	ACU	AIR CONDITIONING UNIT	HZ	HERTZ (CYCLES PER SECOND)		FOINT OF CONNECTION
CIFICALLY MENTIONED OR	AD	ACCESS DOOR, AIR DRYER				
THIS CONTRACTOR SHALL	AFF	ABOVE FINISHED FLOOR	ID	INSIDE DIAMETER		POINT OF DISCONNECTION
NG THEIR FINAL BID. NO	AFG	ABOVE FINISHED GRADE	IN	INCH		
	AHU ALUM	AIR HANDLING UNIT ALUMINUM			Ū	COMPLIATION THERMOSTAT (HUMAN
	AP	ACCESS PANEL	KEF	KITCHEN EXHAUST FAN		COMBINATION THERMOSTAT/HUMI
	APD	AIR PRESSURE DROP	KW	KILOWATT	S	TEMPERATURE SENSOR
RADES. CONNECTION TO	ATC	AUTOMATIC TEMPERATURE CONTROL	LDB	LEAVING DRY BULB		
IED AND PROVIDED FOR	AV	AIR VENT	LWB	LEAVING WET BULB		CARBON DIOXIDE SENSOR
			LOR	LIMIT OF REMOVAL		
CLEARANCES.	BDD BOT	BACK DRAFT DAMPER BOTTOM	MAX	MAXIMUM	(SD) SD	SMOKE DETECTOR
	BFP	BACKFLOW PREVENTER	MBC	MASTER BUILDING CONTROLLER		SMORE DETECTOR
SYSTEMS, PLUMBING, AND	BTU	BRITISH THERMAL UNIT	MBH	THOUSAND BTU PER HOUR		
			MD	MANUAL DAMPER		FIRE STAT
	C	CELSIUS, DEGREE CELSIUS	MIN	MINIMUM		
ADVANCE TO SCHEDULE	CENT	CENTRIFUGAL	N	NORTH	X	EXISTING FIRE DAMPER
	CFM	CUBIC FEET PER MINUTE	NA	NOT APPLICABLE		EXISTING TINE DAWI EN
PT WHEN INDICATED ON	CHWS&R	CHILLED WATER SUPPLY & RETURN	NO OR #	NUMBER, NORMALLY OPEN		
FI WHEN INDICATED ON	CLG	CEILING	NTS	NOT TO SCALE		FIRE DAMPER
	CF	CEILING FAN CLEAN OUT	me			
QUIRED TO PROVIDE A	CO COND	CONDENSATE	OA	OUTSIDE AIR		
	COND	CONDENSATE	OBD	OPPOSED BLADE DAMPER		SMOKE DAMPER
	DB	DRY BULB, DOWN BLOW	OD	OUTSIDE DIAMETER		
CONTRACTOR AND OWNER	DCW	DOMESTIC COLD WATER	OPER	OPERATING		MANUAL VOLUME DAMPER
	DEG	DEGREE				
	DELIV	DELIVERY	PSI	POUNDS PER SQUARE INCH		
	DHW	DOMESTIC HOT WATER	PSIG	POUNDS PER SQUARE INCH GAUGE		CARBON MONOXIDE SENSOR
	DISC	DISCONNECT				
	DN	DOWN	RA	RETURN AIR		TAP WITH 45° ENTRY
			REG	REGISTER		
	EA	EXHAUST AIR, EACH	RF	RETURN FAN		
	EAT	ENTERING AIR TEMPERATURE	RG	RETURN GRILLE	EUH	ELECTRIC UNIT HEATER
NSTRUCTION SHALL SUIT	EDB	ENTERING DRY BULB	RH	RELATIVE HUMIDITY		
NSTRUCTION STALL SUT	EF	EXHAUST FAN	RHC	REHEAT COIL	EMS	ENERGY MANAGEMENT SYSTEM
	EFF	EFFICIENCY	RM	ROOM		
ND TRANSITIONS AROUND	ELEV	ELEVATION			M	MOTOR OPERATED DAMPER
	EMS ENT	ENERGY MANAGEMENT SYSTEM ENTERING	SA	SUPPLY AIR		
	ERG	EXISTING RETURN GRILLE	SEF	SMOKE EXHAUST FAN		
FLOWS. ALL SPLIT DUCT	EWB	ENTERING WET BULB	SF	SUPPLY FAN	DIAN DET	ALL IDENTIELCAT
			S/FD	SMOKE/FIRE DAMPER	PLAN-DEI	AIL IDENTIFICAT
) VISUAL INSPECTION OF	F	FAHRENHEIT	т	THERMOSTAT	DETAIL NUMBER	
AND AIRFLOW MEASURING	FD	FIRE DAMPER, FLOOR DRAIN	TEC	TERMINAL EQUIPMENT CONTROLLER		≤ 1
	FPM	FEET PER MINUTE	TEMP	TEMPERATURE		N-##
	FPS	FEET PER SECOND	T/D	TRANSFER DUCT		SHEET WHERE
E RATED PARTITIONS, TO	F/SD FT	FIRE/SMOKE DAMPER FEET	TYP	TYPICAL		DETAIL IS SHOWN
	GPH	GALLONS PER HOUR	V	VENT, VOLT		
	GPM	GALLONS PER MINUTE	VD	VOLUME DAMPER	SECTION I	DENTIFICATION
	GLY	GLYCOL	VERT	VERTICAL		
	GRV	GRAVITY RELIEF VENTILATOR	WB	WET BULB	SECTION NUMBER	
DES.	GWS	GLYCOL WATER SUPPLY	WPD	WATER PRESSURE DROP		
	GWR	GLYCOL WATER RETURN				
to verify finish.	HHWS&R	HEATING HOT WATER SUPPLY & RETURN	1WB	ONE WAY BLOW		SHEET WHERE
	HOA	HAND-OFF-AUTOMATIC	2WB 3WB	TWO WAY BLOW THREE WAY BLOW		DETAIL IS SHOWN
	HP	HORSEPOWER, HEAT PUMP	0110			
VOLTAGE SHALL BE 24						
S.						
	1				1	

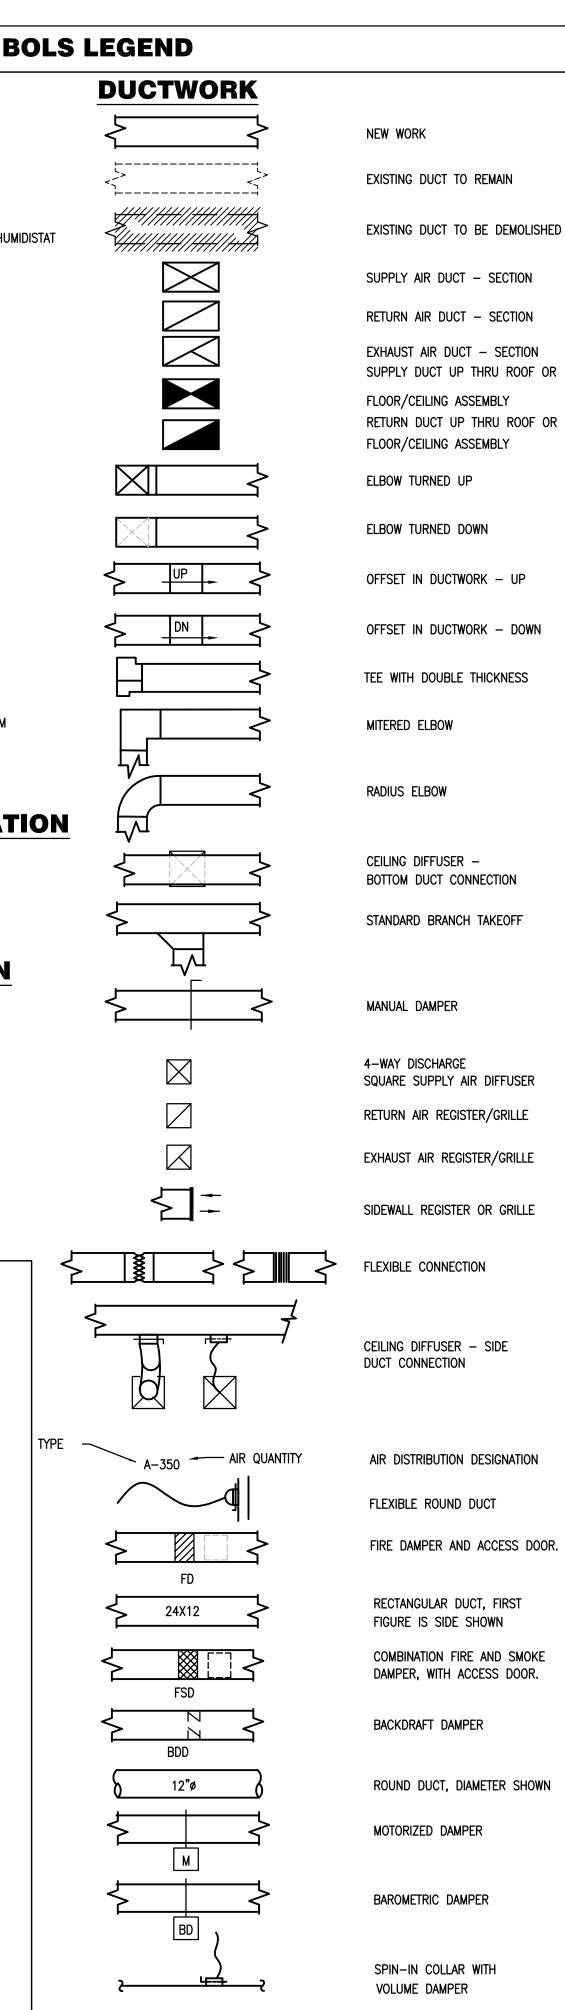

ARCHITE	CTURAL DESIGN COLL	ABORATI	- /E
945 N. PENNSYLV			
WINTER PARK, FL OFFICE: (407) 629	-1188		
FAX: (407) 388-122 WWW. ADCINTER			
STATE OF FLORID	۱۵	AA-C	001315
MARIA FERREIRA		AR-9	
Architect Seal/Sig	gnature		
Project Document	ts for:		
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1784 E. MICHIG	SAN STREET		
ORLANDO, FL 3	32806		
Issue Date & Issu	ue Description Dra	awn By Ch	ecked Bv
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09.15.16	90% CD SET	JS	KA
12.02.16	PERMIT/BID SET	JS	KA KA
01.23.17	PERMIT COMMENT	5 12	<u> </u>
02.27.17	CONST. ISSUE SET	r JS	KA
Client Information			
ORANGE COUN	ITY CAPITAL PROJE	ECTS DIV	/ISION
ORANGE COUN	EET 5th FLOOR	ECTS DIV	/ISION
ORANGE COUN 400 E SOUTH STR ORLANDO, FL 328	EET 5th FLOOR		
ORANGE COUN	EET 5th FLOOR	Issu	/ISION e Date 2/27/2017
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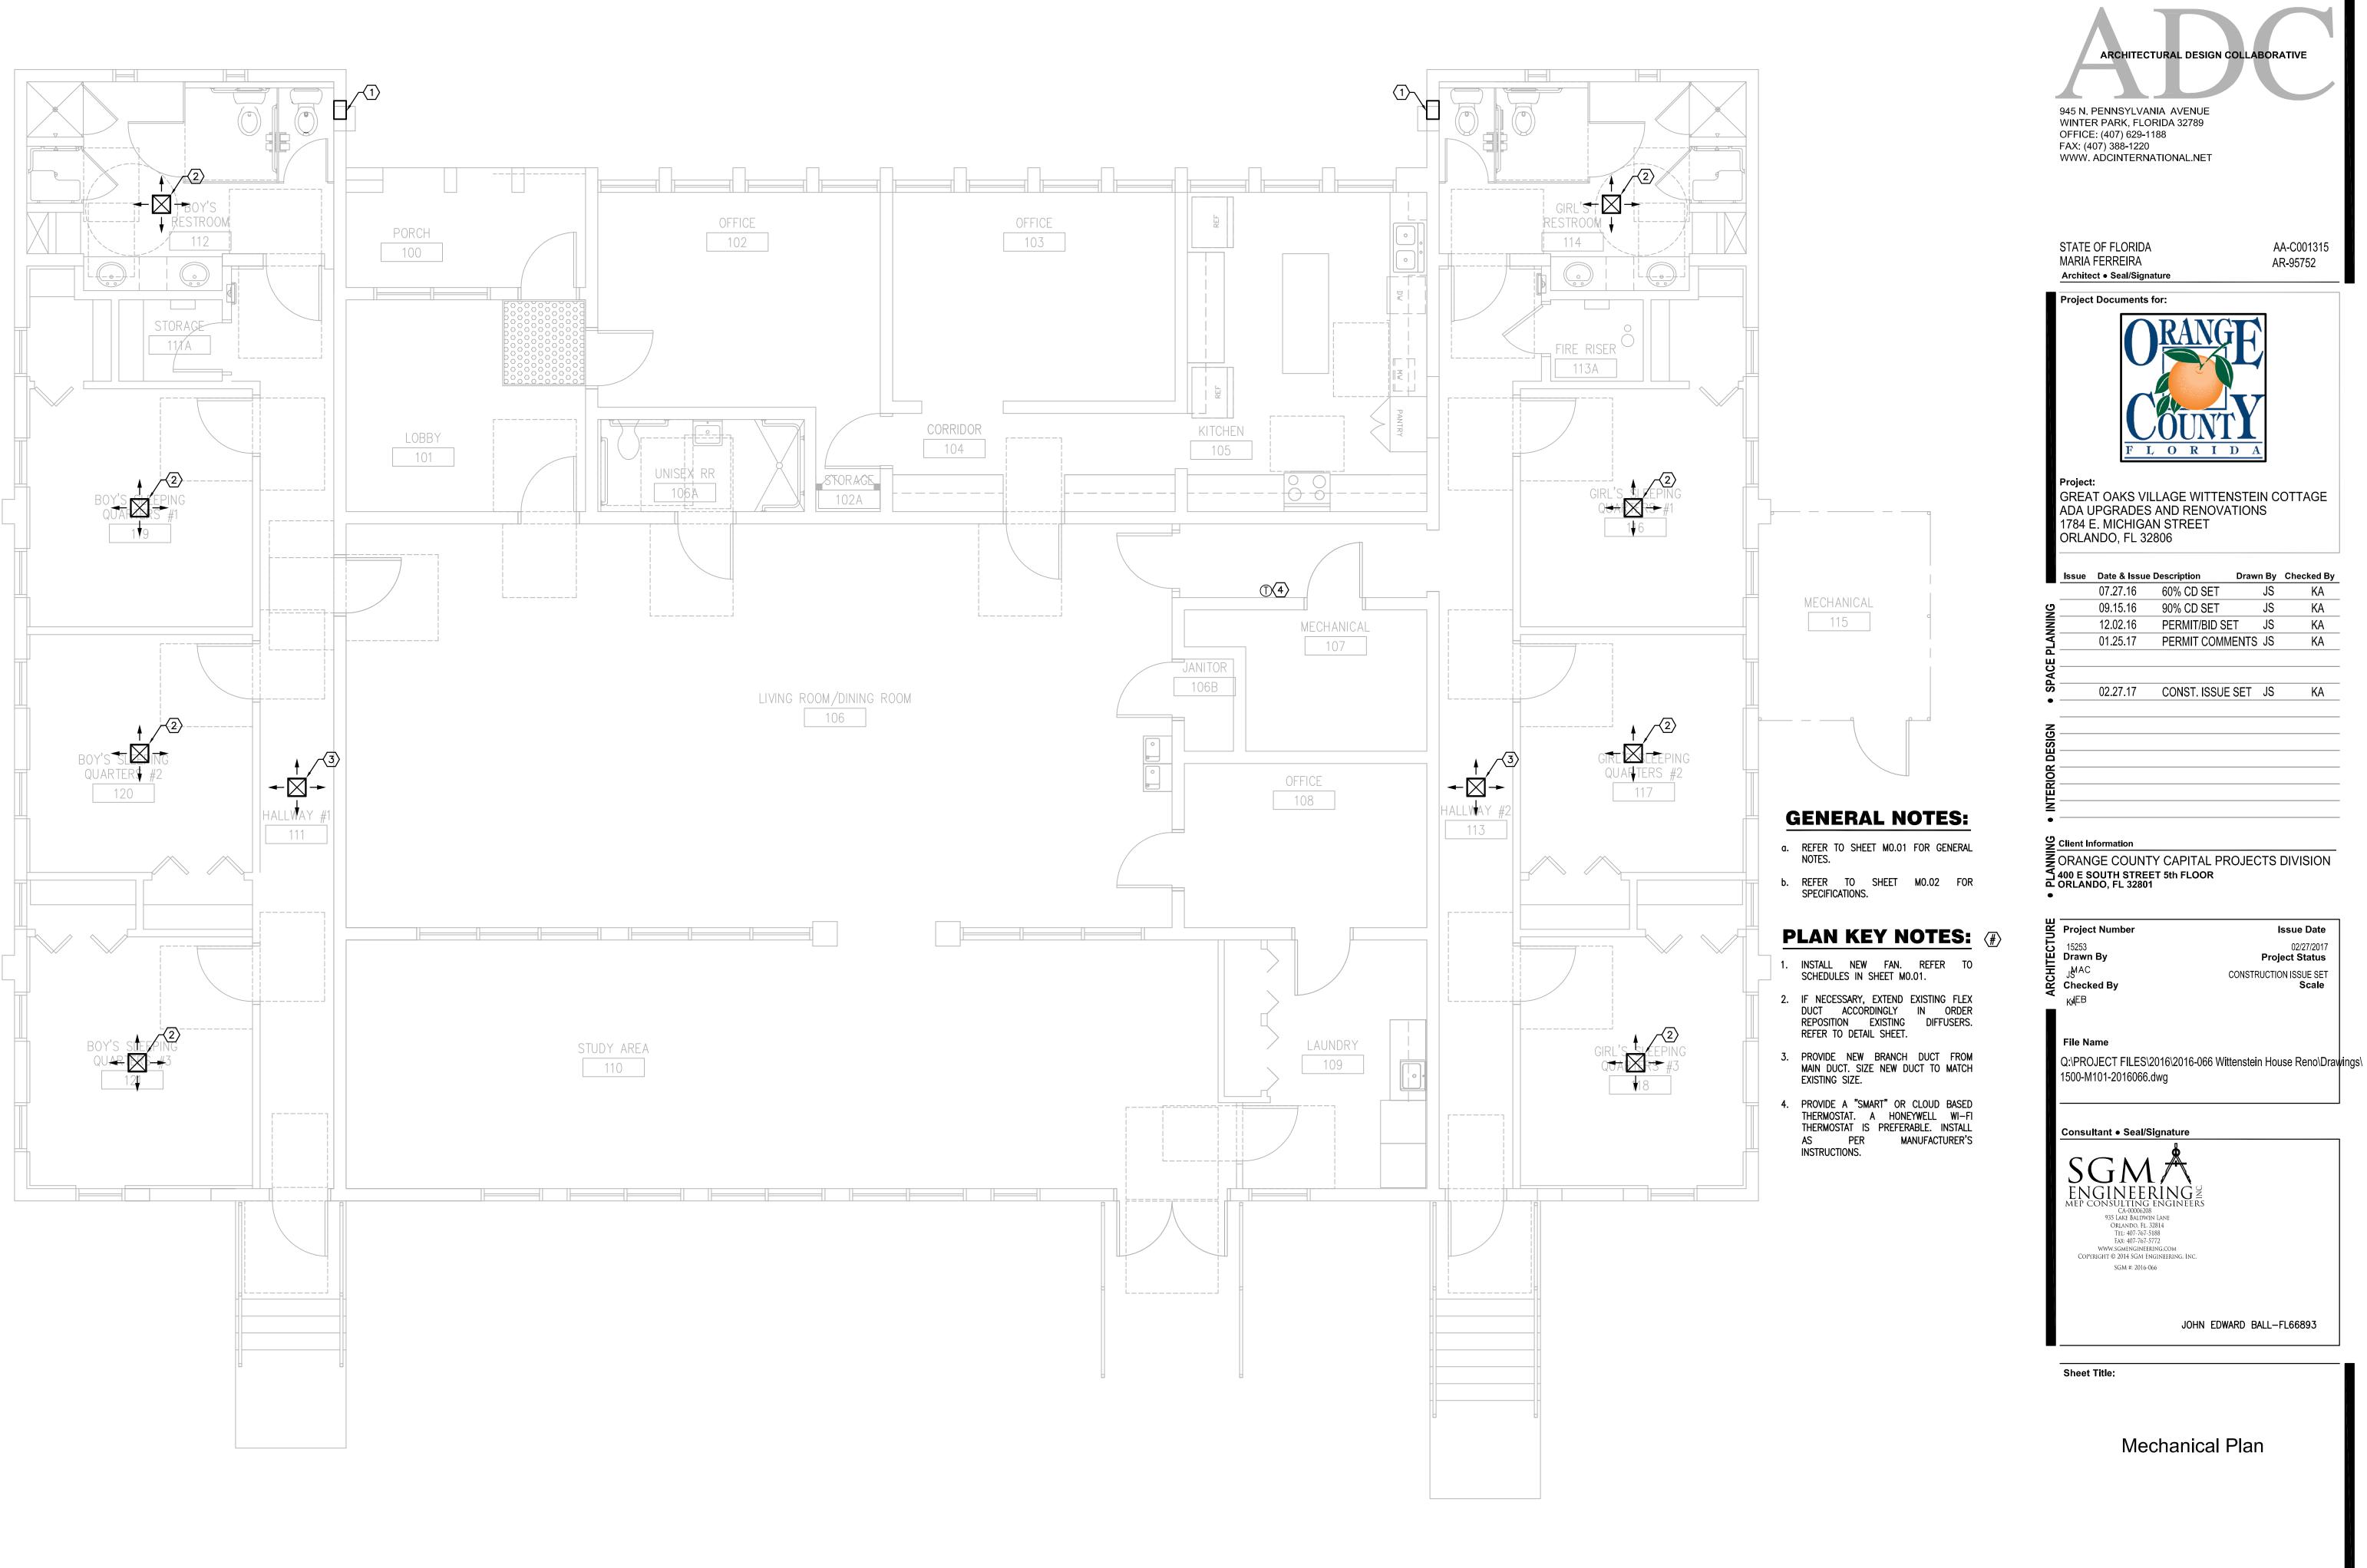
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SCALE: 1/4"=1'-0"


kINTED ON: Feb 27, 2017 - 1:17pm

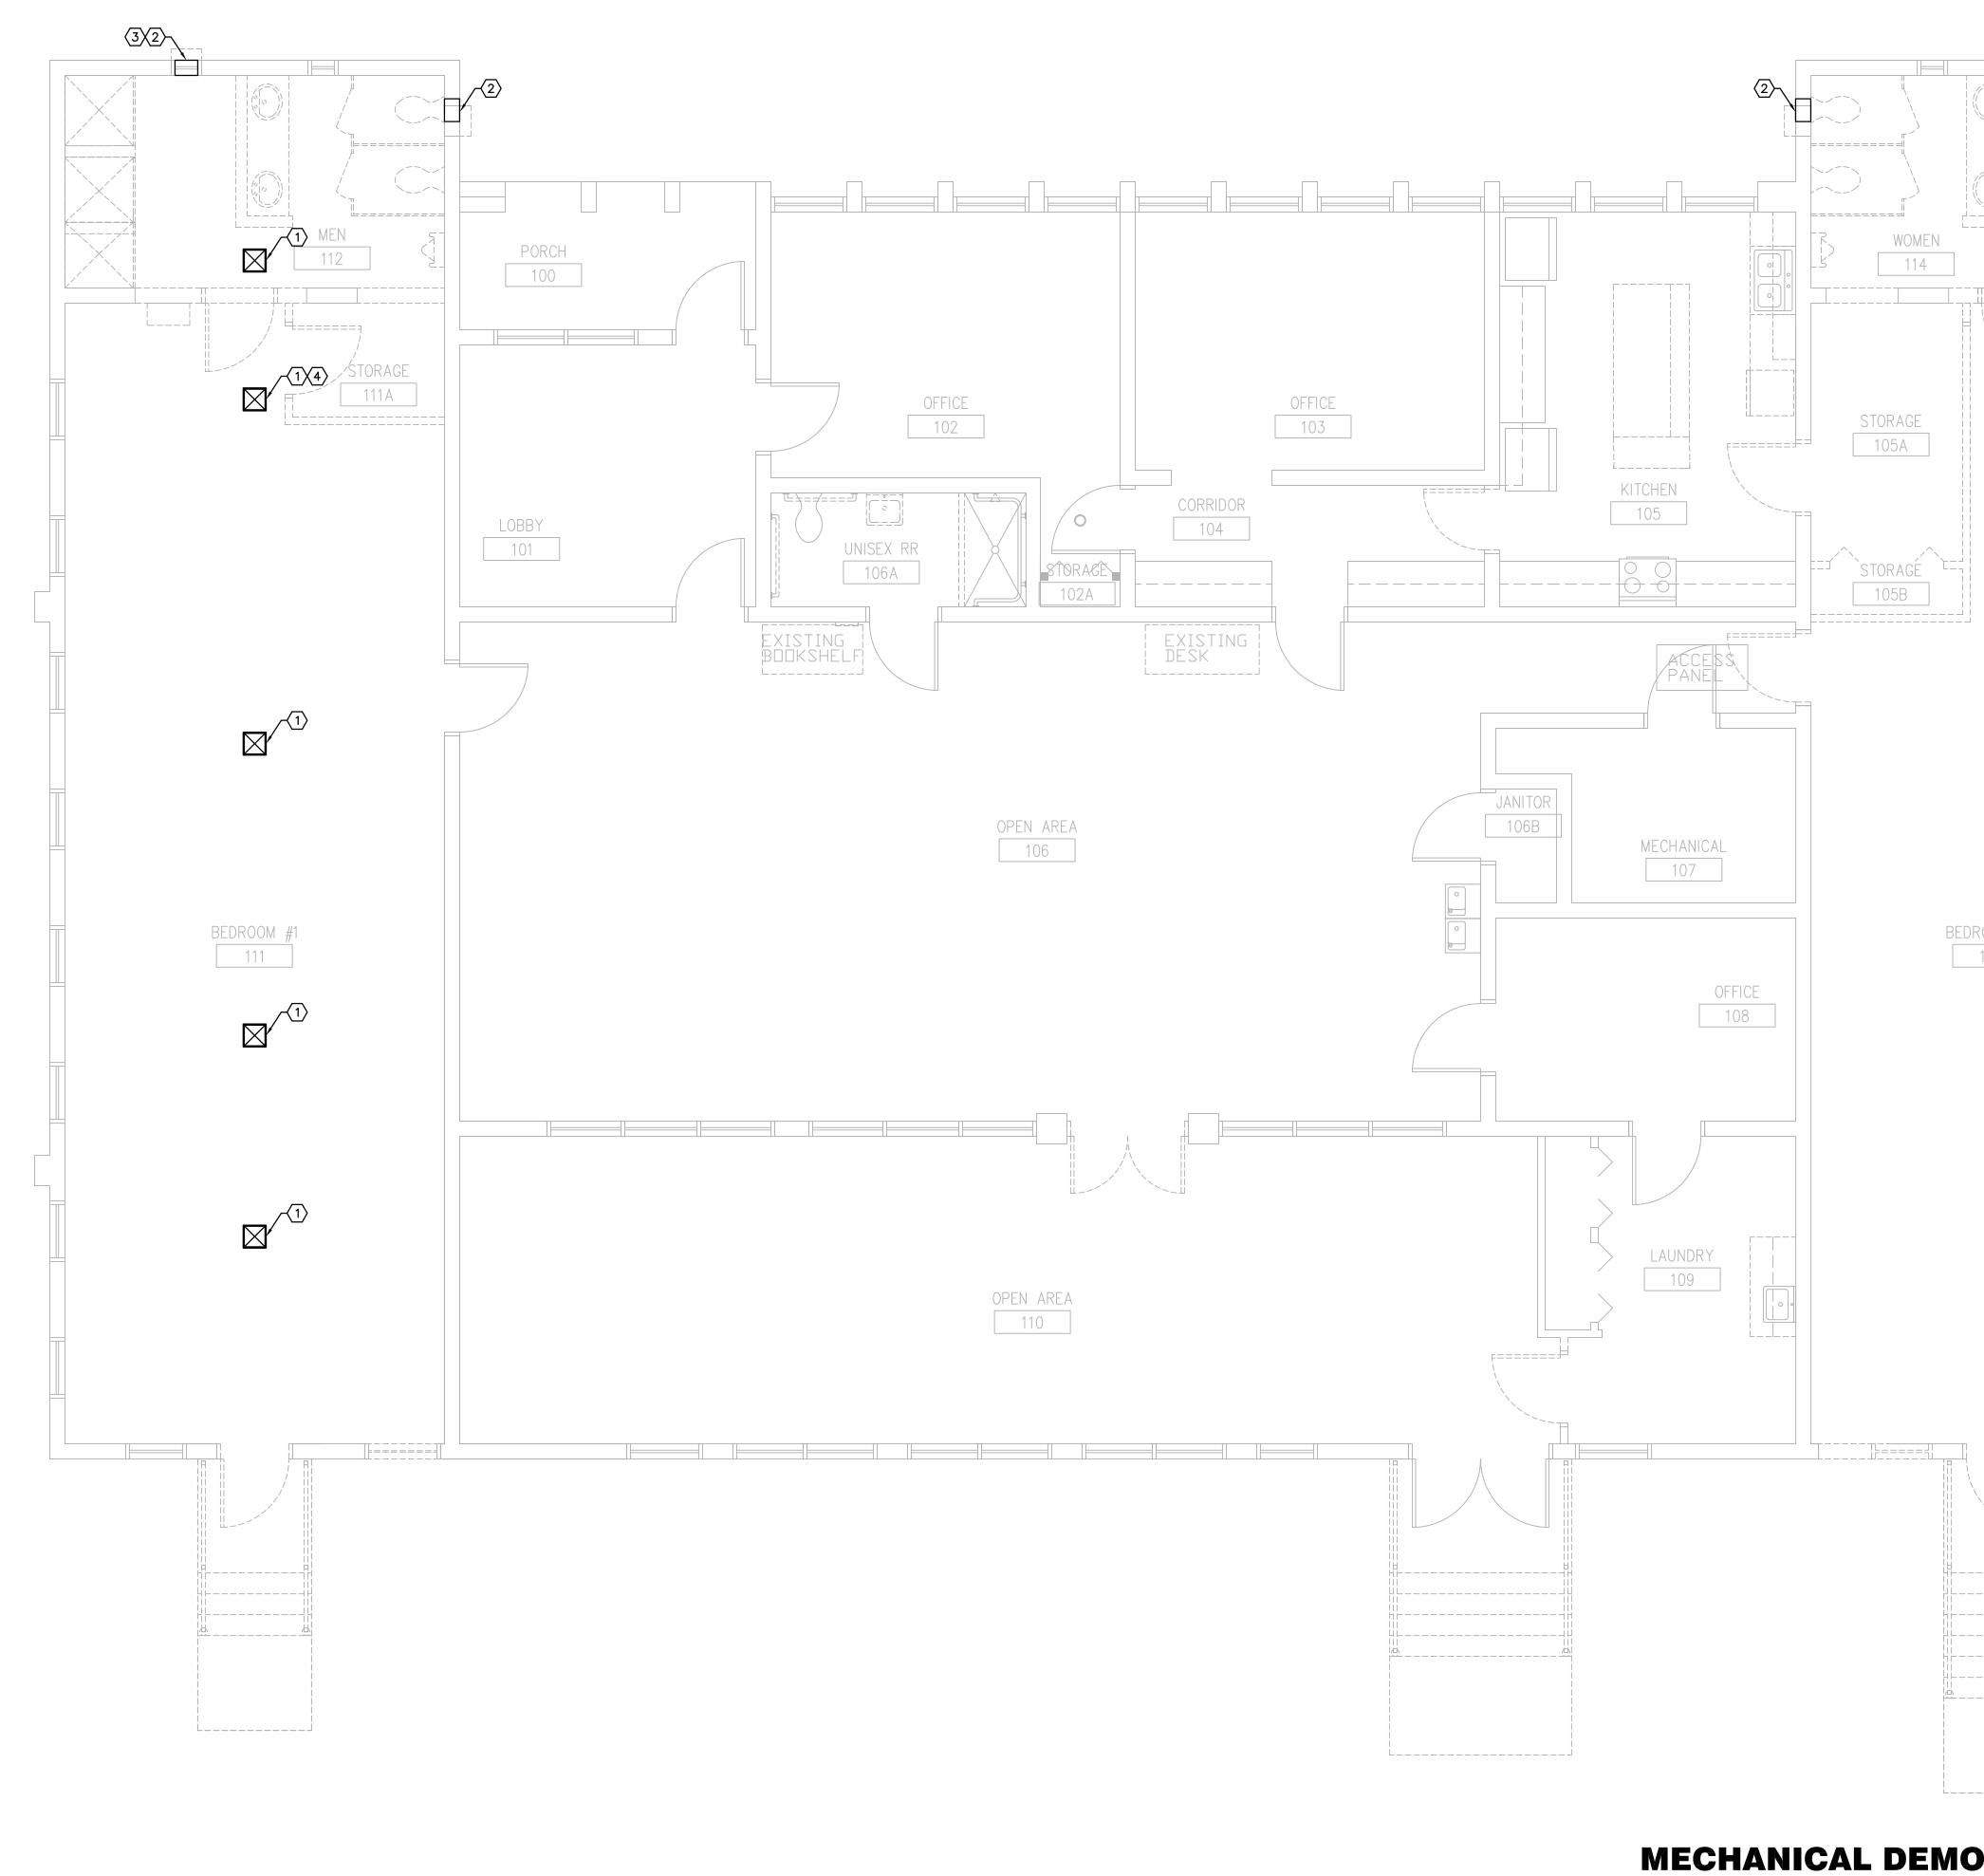			ARCHITECTURAL DESIG	SN COLLABORATIVE
			945 N. PENNSYLVANIA AVENUE WINTER PARK, FLORIDA 32789 OFFICE: (407) 629-1188 FAX: (407) 388-1220 WWW. ADCINTERNATIONAL.NET	
			STATE OF FLORIDA MARIA FERREIRA Architect • Seal/Signature Project Documents for:	AA-C001315 AR-95752
			Project: GREAT OAKS VILLAGE WIT ADA UPGRADES AND RENO 1784 E. MICHIGAN STREET	TENSTEIN COTTAGE
	MECHANICAL 115	 SPACE PLANNING 	ORLANDO, FL 32806 Issue Date & Issue Description 07.27.16 60% CD SE 09.15.16 90% CD SE 12.02.16 PERMIT/BII 01.25.17 PERMIT CO 02.27.17 CONST. ISS	T JS KA DISET JS KA DMMENTS JS KA
ROOM #2 113	GENERAL NOTES:		Client Information ORANGE COUNTY CAPITAL 400 E SOUTH STREET 5th FLOOR ORLANDO, FL 32801	PROJECTS DIVISION
	 a. REFER TO SHEET MO.01 FOR GENERAL NOTES. b. REFER TO SHEET MO.02 FOR SPECIFICATIONS. PLAN KEY NOTES: 1. REMOVE AND PRESERVE DIFFUSES FOR REUSE. CLEAN DIFFUSER THOROUGHLY 	CHITECTURE •	Project Number ¹⁵²⁵³ Drawn By J ^{MAC} Checked By KAEB	Issue Date 02/27/2017 Project Status CONSTRUCTION ISSUE SET Scale
	 UPON REINSTALLATION. 2. REMOVE EXHAUST FANS. 3. PATCH WALL OPENING. MATCH SURROUNDINGS FINISH. REFER TO ARCHITECTURAL SHEETS FOR MORE DETAILS. 4. REMOVE EXISTING BRANCH AND FLEX DUCT. PATCH AND SEAL DUCTWORK AND INSULATE. 		File Name Q:\PROJECT FILES\2016\2016-066 1500-MD101-2016066.dwg Consultant • Seal/Signature SGM	Wittenstein House Reno\Drawings
				EDWARD BALL-FL66893
			Sheet Title: Mechan Demolition	
			MD1	.01



MECHANICAL PLAN SCALE: 1/4"=1'-0" 0 2' 4'



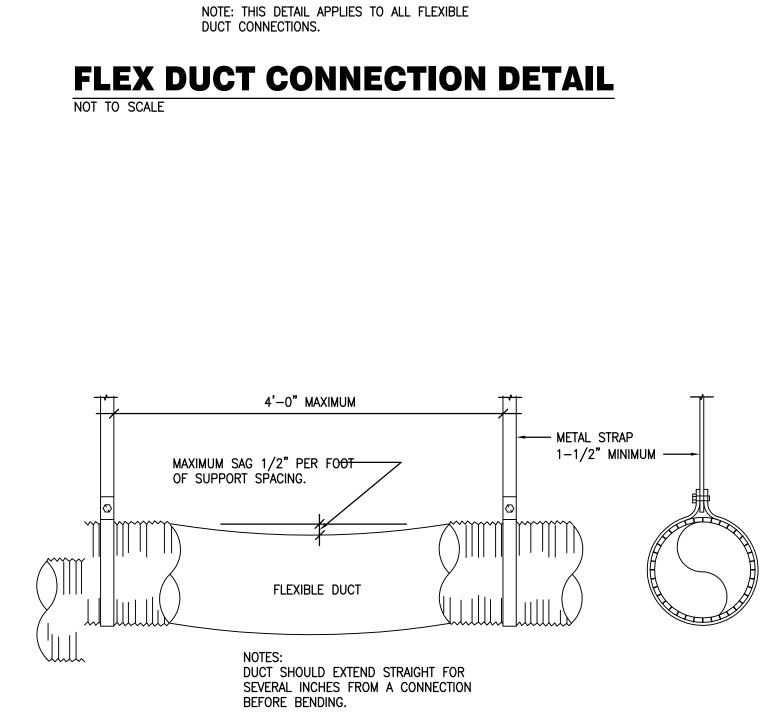

- SLIP VAPOR BARRIER OVER SPACER BAND AND ATTACH DRAW BAND.


SPACER.


L DRAW BAND


FLEX DUCT

NOT TO SCALE

20 27 -A \Box

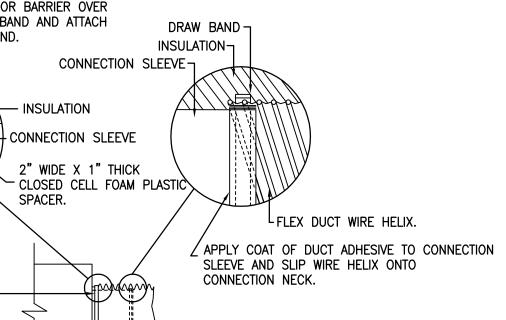

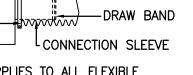


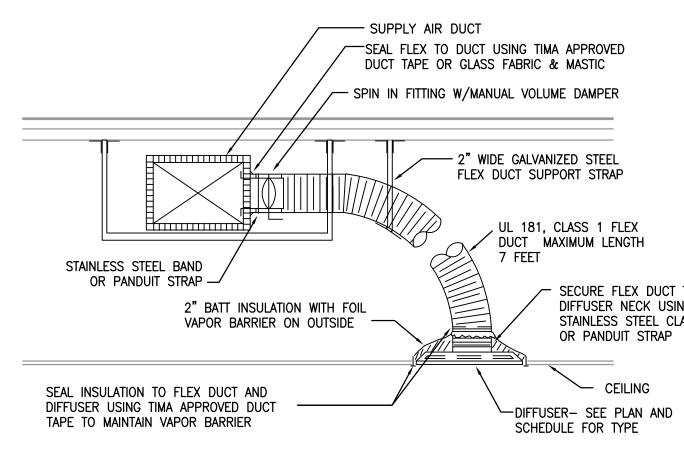

DUCT TO SUPPLY DIFFUSER CONN. DETAIL NOT TO SCALE

SUPPORT SYSTEM MUST NOT DAMAGE DUCT OR CAUSE OUT OF ROUND SHAPE.

FLEX DUCT SUPPORT

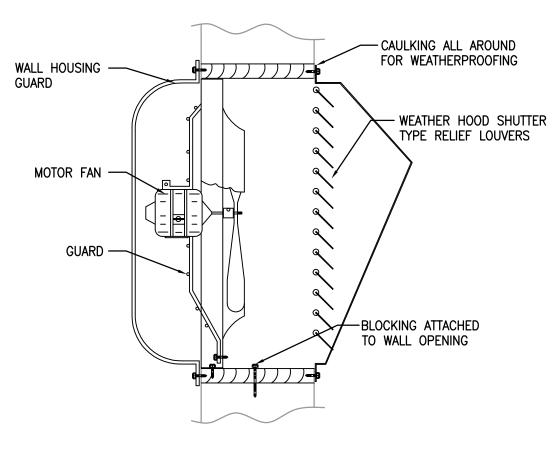

WALL EXHAUST FAN NOT TO SCALE

	945 N. PENNSYLV WINTER PARK, FI OFFICE: (407) 629 FAX: (407) 388-122 WWW. ADCINTER	-ORIDA 32789 -1188 20			
	STATE OF FLORIE MARIA FERREIRA Architect • Seal/Sig			AA-C0 AR-957	
	Project Document Project: GREAT OAKS V ADA UPGRADE 1784 E. MICHIG	VILLAGE WI SAND REN SAN STREE	IOVATION	- N COTT	AGE
	Issue Date & Iss	32806 ue Description	Drawı	a Pyr Char	cked By
	07.27.16	60% CD \$	SET	JS	KA
NING	09.15.16	90% CD S		JS JS	KA KA
SPACE PLANNING	01.25.17		COMMENTS		KA
PACE					
• S	02.27.17	CONST.	SSUE SET	JS	KA
GN					
INTERIOR DESIGN					
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BLANNING	ORANGE COUN 400 E SOUTH STR ORLANDO, FL 328 Project Number 15253 Drawn By JMAC Checked By	EET 5th FLOC 101 S\2016\2016-0 66.dwg I/Signature CRING Z G ENGINEERS 108 S7-5188 57-5772 HERING.COM 4 ENGINEERING, INC. 16-066	CONSTR	Issue 02/2 Project S UCTION ISSI S	Date 27/2017 tatus UE SET Scale
BLANNING	ORANGE COUN 400 E SOUTH STR ORLANDO, FL 328 Project Number 15253 Drawn By JMAC Checked By K4M File Name Q:\PROJECT FILE 1500-M501-201606 Consultant • Sea SGA ENGINET Consultant • Sea SIARE BAI ORLANDO, TE: 407-7 HXX: 407-7 WWW.SGMENGIN COPYRIGHT © 2014 SGM	EET 5th FLOC 101 S\2016\2016-0 66.dwg I/Signature CRING Z G ENGINEERS 108 S7-5188 57-5772 HERING.COM 4 ENGINEERING, INC. 16-066	CONSTR	Issue 02/2 Project S UCTION ISSI S	Date 27/2017 tatus UE SET Scale

M5.01

 SECURE FLEX DUCT TO DIFFUSER NECK USING STAINLESS STEEL CLAMP OR PANDUIT STRAP

CEILING

	1'x4' FLUORESCENT FIXTURE	
	2'x2' FLUORESCENT FIXTURE	(
•	2'x4' FLUORESCENT FIXTURE	
	4' WALL MOUNT FLUORESCENT LUMINAIRE	(
	4' WALL MOUNT FLUORESCENT LUMINAIRE, EMERGENCY	
	1'x4' FLUORESCENT FIXTURE, BATTERY/EMERGENCY	
	2'x2' FLUORESCENT FIXTURE, BATTERY/EMERGENCY	ĺ
	2'x4' FLUORESCENT FIXTURE, BATTERY/EMERGENCY	
	4' FLUORESCENT STRIP FIXTURE	E
⊢-●1	4' FLUORESCENT STRIP FIXTURE, BATTERY/EMERGENCY	E
<u>⊢-</u> ΩI	4' FLUORESCENT STRIP FIXTURE, WALL MOUNTED	
⊢ <u>₽</u>	4' FLUORESCENT STRIP FIXTURE, WALL MOUNTED, BATTERY/EMERGENCY	E F
	TRACK FIXTURE	
0	CEILING MOUNTED RECESSED, DOWN LIGHT CEILING MOUNTED RECESSED, EMERGENCY DOWN LIGHT	-
\diamond	CEILING MOUNTED RECESSED, WALL WASHER (ARROW	l R
	INDICATES DIRECTION OF WASH)	ے ا
Q	SURFACE MOUNTED LIGHTING FIXTURE	
•	WALL MOUNTED SCONCE FIXTURE, BATTERY/EMERGENCY EMERGENCY LIGHT FIXTURE	
₹		
×	SINGLE FACE EXIT LIGHT FIXTURE ARROW INDICATES DIRECTION OF EGRESS	
	DOUBLE FACE EXIT LIGHT FIXTURE ARROW INDICATES DIRECTION OF EGRESS	
SWITCH		-
	SWITCH	FIRE
\$ \$2 \$3	SWITCH, 2 POLE	
\$ <u>3</u>	SWITCH, 3-WAY	
\$ <mark>M</mark> \$⊳	MOTOR RATED SWITCH DIMMER SWITCH	l
-		[
LIAUIII		н
CI	*PIR–CEILING MOUNT SENSOR 24 VDC/VAC, 11mA, WATTSTOPPER CI–205 OR EQUAL.	
(DT)	*DUAL ULTRASONIC/PIR-CEILING MOUNT SENSOR, 24 VDC/VAC, 35mA. WATTSTOPPER DT-305 OR EQUAL.	
	*DUAL ULTRASONIC/PIR-WALL MOUNT SENSOR, 24 VAC/VDC,	. (
$\langle w \rangle$	35mA. WATTSTOPPÉR DT-205 OR EQUAL.	(
<	*ULTRASONIC-CEILING CORRIDOR MOTION SENSOR, 24 VDC/VAC, 40mA. WATTSTOPPER WT-2250 OR EQUAL.	(
\$	PIR-WALL SWITCH DECORATOR MOTION SENSOR, 120/277 VAC,	
	800/1200W. WATTSTOPPER PW-100 OR EQUAL. DUAL ULTRASONIC/PIR-WALL SWITCH DECORATOR MOTION	
D1	SENSOR, 120/277VAC, 800/1200W. WATTSTOPPER DW-100 OR EQUAL.	s ₍
D2	DUAL ULTRASONIC/PIR-DUAL RELAY WALL SWITCH DECORATOR	
	MOTION SENSOR, 120/277VAC, 800/1200W. WATTSTOPPER DW-200 OR EQUAL.	(
D3	DUAL ULTRASONIC/PIR-MULTI-WAY WALL SWITCH DECORATOR MOTION SENSOR, 120/277VAC, 800/1200W. WATTSTOPPER	
_	DW-103 OR EQUAL.	
P	POWER PACK 120/277 VAC; 20 AMPS, 225mA SECONDARY. WATTSTOPPER BZ-150 OR EQUAL.	
	*FOR LOW VOLTAGE OCCUPANCY SENSORS, PROVIDE POWER PACK(S) 120/277 VAC; 20 AMPS, 225mA SECONDARY AS	<u>ہ۔ [</u>
	NEEDED FOR ZONE/AREA CONTROL. WATTSTOPPER BZ-150 OR	
	EQUAL.	<u></u> ر •
POWER	DISTRIBUTION	* <u>F</u> C
	120/208V PANELBOARD, RECESSED	۳ <u>۴</u> ۲
	120/208V PANELBOARD, SURFACE MOUNT 277/480V PANELBOARD, SURFACE MOUNT	<u>*</u> F C
	277/480V PANELBOARD, RECESSED	<u>"F</u>
	FEEDER OR BRANCH CIRCUIT CONCEALED IN WALL,	n -
	CEILING OR FLOOR HOMERUN CONSISTING OF ONE SINGLE-PHASE, 1-POLE	PRE
1R1-1	CIRCUIT: (2) 12 AWG + (1) 12 AWG GND IN 3/4" CONDUIT, UNLESS OTHERWISE NOTED. PANELBOARD AND CIRCUIT	
	DESIGNATION ARE INDICATED.	
\frown	HOMERUN CONSISTING OF ONE SINGLE-PHASE, 2-POLE	
1M1-1:3	CIRCUIT: (2) 12 AWG + (1) 12 AWG GND IN 3/4" CONDUIT, UNLESS OTHERWISE NOTED. PANELBOARD AND CIRCUIT	↓ ↓
	DESIGNATIONS ARE INDICATED.	° ≺
	HOMERUN CONSISTING OF TWO SINGLE-PHASE CIRCUITS: (3)	
1R1-1,3	12 AWG + (1) 12 AWG GND IN 3/4" CONDUIT, UNLESS OTHERWISE NOTED. PANELBOARD AND CIRCUIT DESIGNATION	
	ARE INDICATED.	
1R1-1,3,5	HOMERUN CONSISTING OF THREE SINGLE-PHASE CIRCUITS: (4) 12 AWG + (1) 12 AWG GND IN 3/4" CONDUIT, UNLESS	
,,,,,,	OTHERWISE NOTED. PANELBOARD AND CIRCUIT DESIGNATIONS ARE INDICATED.	
	HOMERUN CONSISTING OF ONE THREE-PHASE CIRCUITS: (3)	<
1M1-1:3:5	12 AWG + (1) 12 AWG GND IN 3/4" CONDUIT, UNLESS OTHERWISE NOTED. PANELBOARD AND CIRCUIT DESIGNATIONS	•
	ARE INDICATED.	
		 []

WER DEVICES SINGLE RECEPTACLE Θ DUPLEX RECEPTACLE € DOUBLE DUPLEX RECEPTACLE ⊕= ABOVE COUNTER DUPLEX RECEPTACLE DUPLEX RECEPTACLE, HALF SWITCHED €= SPECIAL PURPOSE RECEPTACLE \bigcirc BLACK DUPLEX RECEPTACLE FOR COMPUTER WORKSTATION Ğ BLACK QUAD RECEPTACLE FOR COMPUTER WORKSTATION Ğ∰ – Ð CEILING MOUNTED RECEPTACLE ₽' RECESSED FLOOR RECEPTACLE ₽ DUPLEX RECEPTACLE, GROUND FAULT DUPLEX RECEPTACLE, GROUND FAULT, ABOVE COUNTER ₽ QUAD RECEPTACLE, GROUND FAULT PP POWER POLE ⊐ DISCONNECT SWITCH J JUNCTION BOX \bigcirc FLOOR MOUNTED JUNCTION BOX С EQUIPMENT CONNECTION • DOOR BELL PUSH BUTTON TRANSFORMER СН DOOR BELL MOTOR GROUND BUS BAR E ALARM SYSTEM Ρ MANUAL FIRE ALARM PULL STATION FIRE ALARM COMBINATION SPEAKER/STROBE DEVICE (75 CANDELA MINIMUM, 110 CANDELA WHERE NOTED) Sd \square FIRE ALARM COMBINATION HORN/STROBE DEVICE (75 CANDELA MINIMUM, 110 CANDELA WHERE NOTED) E-FIRE ALARM STROBE ONLY, 75 CANDELA MINIMUM FIRE ALARM SPEAKER - CEILING MOUNTED (F) $\Box \triangleleft$ FIRE ALARM SPEAKER – WALL MOUNTED (**↓**_F 135 HEAT DETECTOR HEAT DETECTOR - RATE OF RISE ONLY . ₽_{R/F} HEAT DETECTOR - COMBINATION: RATE OF RISE AND FIXED TEMP (\mathbf{S}) SMOKE DETECTOR DUCT SMOKE DETECTOR - "R" = RETURN, "S" = SUPPLY. è⊙=-PROVIDE LED SUPERVISORY INDICATOR FOR BOTH DETECTORS IN AN ACCESSIBLE LOCATION AND CLEARLY LABELED. Ψž DUCT SMOKE DETECTOR REMOTE TEST INDICATOR (AIM) ADDRESSABLE INPUT MODULE (AOM) ADDRESSABLE OUTPUT MODULE ΜМ MONITOR MODULE СМ CONTROL MODULE RELAY WEATHERPROOF WATER FLOW SWITCH MONITOR MODULE CONNECTED TO FIRE WF , SPRINKLER SYSTEM WEATHERPROOF TAMPER SWITCH MONITOR MODULE CONNECTED TO FIRE SPRINKLER SYSTEM vs , "FACU" FIRE ALARM CONTROL UNIT "FACU" FAAP" FIRE ALARM ANNUNCIATOR PANEL "FAAP" FATC FIRE ALARM TERMINAL CABINET "FATC", NEMA 1 RATED FACP" FIRE ALARM CONTROL PANEL "FACP" EMISE DISTRIBUTION SYSTEM

	MOUNTING 3" ABOVE COUNTER OR B X = MOUNTING (F)LUSH, (S)URFACE, (P)OLE, (R)ACEWAY, (D)OUBLE GANG
	N = $\#$ OF DATA JACKS
C → × N	COMMUNICATIONS "INFORMATION OU HEIGHT UNLESS OTHERWISE NOTED.
	SPECIAL NOTES:
	1. DATA JACKS: EACH RJ45 CAT6 JACK FOR DAT DEDICATED UTP 4 PR CAT6 CAE
▼ [₩] _{F1}	WALL TELEPHONE OUTLET FOR HOUSE FINISHED FLOOR TO TOP.
⊲sx	WALL DATA OUTLET. SURFACE MOUNT FLOOR TO TOP OF BACKBOX. X =
	FLOOR BOX DATA OUTLET. DATA OUTL UTP HOMERUN TO COMM ROOM. X =
	3/4" PLYWOOD BACKBOARD. BY DIVIS
	TELEVISION OUTLET MOUNTED AT 96" SQUARE BACKBOX, SINGLE GANG P-F CEILING SPACE, AND (2) CAT-6 CABI

NOTE: SOME SYMBOLS SHOWN ON THIS LEGEND MAY NOT PERTAIN TO THIS PROJECT.

TYPE	DESCRIPTION	DESIGN SELECTION	DESIGN SELECTION	DESIGN SELECTION	VOLTS	LAMPS/FIXT.
А	6" RECESSED LED DOWNLIGHT. RETROFIT KIT AND SEPARATE CAN.	CREE # CR6 800L 30K E26 PROVIDE WITH NEW RETROFIT HOUSING	APPROVED EQUAL	APPROVED EQUAL	120	LED 800 LUM
В	SURFACE LED WRAPAROUND	RAB # GUS 436 YW	APPROVED EQUAL	APPROVED EQUAL	120	LED 4100 LUN
С	6" RECESSED LED DOWNLIGHT OVER MIRROR. RETROFIT KIT AND SEPARATE CAN.	CREE # CR6 800L 30K E26 PROVIDE WITH NEW RETROFIT HOUSING	APPROVED EQUAL	APPROVED EQUAL	120	LED 800 LUN
F	FLUSH MOUNTED LED LOW LEVEL STEP LIGHT	JUNO# IC113 LED-3K-840WH	APPROVED EQUAL	APPROVED EQUAL	120	LED (6 WAT
EM	SURFACE MOUNTED 2 HEAD EMERGENCY LIGHT	BEHGELLI# PEH-1	APPROVED EQUAL	APPROVED EQUAL	120	LED
X1	UNIVERSAL MOUNTED SINGLE FACE EXIT LIGHT	BEHGELLI# UNOSALR 1W	APPROVED EQUAL	APPROVED EQUAL	120	LED
X2	UNIVERSAL MOUNTED DOUBLE FACE EXIT LIGHT	BEHGELLI# UNOSALR 2W	APPROVED EQUAL	APPROVED EQUAL	120	LED

ABBREVIATIONS

A	AMPERES	INC	INC
AE	AUDIO ENHANCEMENT	JB	JUN
AFC	ABOVE FINISHED CEILING	kV	KILO
AFF	ABOVE FINISHED FLOOR	kVA	KILO
AFG	ABOVE FINISHED GRADE	kVAR	KILO
AIC	AMPERES INTERRUPTING		AMF
	CAPACITY	kW	KILO
AL	ALUMINUM	kWH	KILO
AWG	AMERICAN WIRE GAUGE	LTG	LIGH
BFC	BELOW FINISHED CEILING	m	MET
BFG	BELOW FINISHED GRADE	mm	MILI
С	CONDUIT	MAX	MAX
CAB	CABINET	МСВ	MAII
CFCI	CONTRACTOR FURNISHED	MCC	MOT
	CONTRACTOR SUPPLIED	MCP	MOT
СКТ	CIRCUIT	MFR	MAN
CLG	CEILING	MH	MET
CL	CENTERLINE	MIN	MIN
CT's	CURRENT TRANSFORMERS	MISC	MIS
CU	COPPER	MTR	MOT
DISC	DISCONNECT(ING)	MTD	MOL
DWG	DRAWING(S)	MTG	MOL
EA	EACH	NEC	NAT
EF	EXHAUST FAN	OFOI	OWN
EMT	ELECTRICAL METALLIC TUBING		OWN
EQUIP	EQUIPMENT	PNL	PAN
EUH	ELECTRIC UNIT HEATER	PSI	PUL
EWC	ELECTRIC WATER COOLER	PVC	POL
EWH	ELECTRIC WATER HEATER	REC	REC
EXH	EXHAUST	RGS	RIGI
EXIST	EXISTING	TEL	TEL
EXP	EXPLOSION PROOF	TYP	TYP
FA	FIRE ALARM	UON	UNL
FLA	FULL LOAD AMPERES	V	VOL
FLUOR	FLUORESCENT	VA	VOL
GFCI	GROUND FAULT CIRCUIT	VFD	VAR
0. 0.	INTERRUPTER	W	WAT
GFP	GROUND FAULT PROTECTION	WP	WEA
GND	GROUND	XFMR	TRA
HGT	HEIGHT		
HID	HIGH INTENSITY DISCHARGE		
HPS	HIGH PRESSURE SODIUM		
HOA	HAND-OFF-AUTOMATIC		
HP	HORSEPOWER		
HVAC	HEATING/VENTILATING/		
TIVAG	AIR CONDITIONING		
ЦV	HIGH VOLTAGE		
HV			

	INCANDESCENT
	JUNCTION BOX
	KILO-VOLTS KILO-VOLTS-AMPERES
~	KILO-VOLTS-AMPERES KILO-VOLTS-
२	
	AMPERES REACTIVE
	KILO-WATTS
	KILO-WATT-HOURS
	LIGHTING
	METER
	MILLIMETER
	MAXIMUM
}	MAIN CIRCUIT BREAKER
;	MOTOR CONTROL CENTER
)	MOTOR CIRCUIT PROTECTOR
	MANUFACTURER
	METAL HALIDE
	MINIMUM
2	MISCELLANEOUS
	MOTOR
	MOUNTED
	MOUNTING
	NATIONAL ELECTRICAL CODE
I	OWNER FURNISHED
	OWNER INSTALLED
	PANEL
	PULL STATION INSIDE
	POLYVINYL CHLORIDE
	RECEPTACLE
	RIGID GALVANIZED STEEL
	TELEPHONE
	TYPICAL
1	UNLESS OTHERWISE NOTED
	VOLTS
	VOLT-AMPERES
	VARIABLE FREQUENCY DRIVE
	WATTS
	WEATHER PROOF
R	TRANSFORMER
IN IN	

BACK SPLASH E, (M)ODULAR FURNITURE ADAPTER G FLUSH, (PD) PEDESTAL

OUTLET" MOUNTED. AT RECEPTACLE D. MODULE AND FACEPLATE

DATA SHALL BE CONNECTED TO A ABLE JSE PHONE. MOUNTED AT 52" ABOVE

NTED AT 48" ABOVE FINISHED = # OF DATA JACKS

JTLET INSTALLED IN FLOOR BOX WITH = # OF DATA JACKS VISION 16

96" ABOVE FINISHED FLOOR. PROVIDE 4" P-RING, 1" CONDUIT TO ACCESSIBLE ABLE TO CLOSEST IDF ROOM.

1784 E. MICHIGAN STREET ORLANDO, FL 32806 Issue Date & Issue Description Drawn By Checker 07.27.16 60% CD SET JS K 09.15.16 90% CD SET JS K 12.02.16 PERMIT/BID SET JS K 01.25.17 PERMIT COMMENTS JS K		ignature	rchitect ● Seal/Sigı
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	KA	CONST. ISSUE	02.27.17
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MEP CONSOLTTING ENGINEERS CA-00006208 935 Lake Baldwin Lane Orlando. FL 32814 TEL: 407-767-5188 FAX: 407-767-5772 WWW.SGMENGINEERING.COM COPYRIGHT © 2014 SGM ENGINEERING, INC. SGM #: 2016-066		GM Engineering, Inc.	SGM #: 2016

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GENERAL NOTES:

- C. NFPA 72 NATIONAL FIRE CODE D. FLORIDA FIRE PREVENTION CODE (2010)
- (WITHIN 4").
- 3. ABSOLUTELY NO SPLICES WILL BE ALLOWED IN ANY SYSTEMS WIRES. PROVIDE FULL LENGTH WIRING BETWEEN DEVICES AND TERMINALS.
- 4. PROVIDE RACEWAYS FOR ALL WIRING.
- INDICATED ON THIS SCHEDULE.
- DIMENSIONS.
- 10. LOCATE CEILING MOUNTED ITEMS AS SHOWN ON THE ARCHITECTURAL REFLECTED CEILING
- 11. WHERE INSTALLATION ABOVE COUNTER IS INDICATED, INSTALL ITEM 0'-1" FROM BOTTOM OF BACKBOX TO TOP OF COUNTER (OR BACKSPLASH IF SO EQUIPPED). HORIZONTALLY ALIGN BOTTOM OF ITEMS WHERE MORE THAN ONE IS LOCATED ABOVE THE SAME COUNTER.
- 12. VISIT THE EXISTING FACILITY AND CAREFULLY EXAMINE THOSE PORTIONS OF THE BUILDING AND SITE AFFECTED BY THIS WORK BEFORE SUBMITTING PROPOSALS, SO AS TO BECOME FAMILIAR WITH THE EXISTING CONDITIONS AND DIFFICULTIES THAT WILL AFFECT EXECUTION OF THE WORK. SUBMISSION OF A PROPOSAL WILL BE CONSTRUED AS EVIDENCE THAT SUCH EXAMINATION HAS BEEN MADE AND LATER CLAIMS FOR LABOR, EQUIPMENT OR MATERIALS REQUIRED BECAUSE OF DIFFICULTIES ENCOUNTERED WILL NOT BE RECOGNIZED.
- 13. ALL 120V, 20A BRANCH CIRCUIT CONDUCTORS SHALL UTILIZE #12 COPPER CONDUCTORS MINIMUM THROUGHOUT.
- 14. A. EXCEPT WHERE SPECIFICALLY NOTED OTHERWISE, THE CONTRACTOR SHALL PROVIDE NEW CONDUIT FOR ALL CONDUCTORS THAT ARE INSTALLED AS A PART OF THIS PROJECT. INSULATED PLASTIC BUSHINGS ARE TO BE PROVIDED ON ALL CONDUIT STUB-OUTS AND stub-ups.
- B. UNLESS SPECIFICALLY INDICATED OTHERWISE, ALL EQUIPMENT, CONDUIT, WIRE AND ALL REQUIRED ACCESSORIES AND REQUIRED AS PART OF THE INSTALLATION AND USE OF STATED EQUIPMENT SHALL BE PROVIDED BY THE CONTRACTOR AS A PART OF THIS PROJECT.

AND NFPA COMPLIANT.

DRAWINGS AND SPECIFICATIONS.

TOUCHED UP.


- 15. 120 VOLT BRANCH CIRCUITS, WHERE THE LENGTH OF CIRCUIT CONDUCTORS COMPLETE FROM CIRCUIT BREAKER IN SOURCE PANEL TO ANY DEVICE ON THE CIRCUIT IS 101-175 FEET FROM THE PANEL, ARE TO HAVE #10 MINIMUM BRANCH CIRCUIT WIRING HOMERUN (3/4"C.) FROM PANEL CIRCUIT BREAKER TO FIRST DEVICE AND #12 BRANCH CIRCUIT WIRING THROUGHOUT THE REMAINDER OF THE CIRCUIT (CONDUIT SIZE PER SPEC AND NEC). FIRST 75 FT. OF COMBINED HOMERUN AND BRANCH CIRCUIT TO BE MINIMUM #10 WIRE (3/4"C.).
- 16. 120 VOLT BRANCH CIRCUITS, WHERE THE LENGTH OF CIRCUIT CONDUCTORS COMPLETE FROM CIRCUIT BREAKER IN SOURCE PANEL TO ANY DEVICE ON THE CIRCUIT IS 151-225 FEET FROM THE PANEL, ARE TO HAVE #10 MINIMUM BRANCH CIRCUIT WIRING HOMERUN (3/4"C.) FROM PANEL CIRCUIT BREAKER TO FIRST DEVICE AND #10 BRANCH CIRCUIT WIRING THROUGHOUT THE REMAINDER OF THE CIRCUIT (3/4"C.).
- 17. 120 VOLT BRANCH CIRCUITS, WHERE THE LENGTH OF CIRCUIT CONDUCTORS COMPLETE FROM CIRCUIT BREAKER IN SOURCE PANEL TO ANY DEVICE ON THE CIRCUIT IS 226 FEET OR MORE FROM THE PANEL, ARE TO HAVE #8 MINIMUM BRANCH CIRCUIT WIRING HOMERUN (1"C.) FROM PANEL CIRCUIT BREAKER TO FIRST DEVICE AND #10 BRANCH CIRCUIT WIRING THROUGHOUT THE REMAINDER OF THE CIRCUIT (3/4"C.). FIRST 125 FT. OF COMBINED HOMERUN AND BRANCH CIRCUIT TO BE MINIMUM #8 WIRE (1"C.).


- 1. ALL ELECTRICAL WORK AND MATERIALS SHALL BE IN COMPLIANCE WITH ALL GOVERNING CODES AND STANDARDS. THIS SHALL INCLUDE BUT NOT BE LIMITED TO THE FOLLOWING. A. NFPA 70 NATIONAL ELECTRICAL CODE (2011 EDITION-FBC ADOPTED JUNE 30, 2015) B. FLORIDA BUILDING CODE (2014 5th EDITION)
- E. LOCAL REQUIREMENTS OF THE AUTHORITY HAVING JURISDICTION
- 2. COORDINATE ALL POWER AND SYSTEMS DEVICES SO THAT POWER RECEPTACLES AND VOICE/DATA OUTLETS ARE LOCATED AT THE SAME HEIGHT AND ADJACENT TO EACH OTHER
- 5. LOCATE LIGHT FIXTURES PRIOR TO THE INSTALLATION OF JUNCTION BOXES AND CONDUITS. HEIGHTS SHOWN ON THE DRAWINGS FOR A SPECIFIC ITEM TAKE PRECEDENCE OVER HEIGHTS
- 6. HEIGHTS REQUIRED BY THE CURRENT EDITION OF "AMERICANS WITH DISABILITIES ACT" AND ALL OTHER APPLICABLE CODES, STANDARDS, AND ORDINANCES TAKE PRECEDENCE OVER ALL OTHER DIMENSIONS, EXCEPT SPECIFIC HEIGHTS SHOWN ON DRAWINGS.
- 7. HEIGHTS REQUIRED BY EQUIPMENT SUPPLIERS TAKE PRECEDENCE OVER ALL OTHER
- 8. ALL HEIGHTS ON THIS SCHEDULE AND ON THE DRAWINGS ARE FROM FINISHED FLOOR OR GRADE TO TOP OF EXPOSED PORTION OF ITEM (ie. COVERPLATE, HOUSING, OR ENCLOSURE).
- 9. MAXIMUM ACCEPTABLE TOLERANCE OF ALL DIMENSIONS IS 1/16 INCH. ITEMS IN TILE SURFACES SHALL BE INSTALLED AS CLOSE AS POSSIBLE TO THE DIMENSION GIVEN AND SHALL BE HORIZONTALLY AND VERTICALLY CENTERED AND ALIGNED WITH THE TILE JOINTS.
- PLAN(S). WHERE ITEM IS SHOWN ON ELECTRICAL PLAN AND NOT SHOWN ON REFLECTED CEILING PLAN, CONSULT THE ARCHITECT AND LOCATE ACCORDINGLY.

- C. WHERE THE CONTRACTOR PROPOSES ALTERNATE SOLUTIONS, DIFFERENT ROUTINGS OF CONDUIT, DIFFERENT LOCATIONS OF EQUIPMENT, ETC., THE CONTRACTOR SHALL BE RESPONSIBLE FOR ALL OF THE RAMIFICATIONS OF THE PROPOSED CHANGE THAT ARE NOT INCLUDED IN HIS PROPOSAL, BUT BECOME APPARENT AT A LATER DATE, AND SHALL BEAR THE CONSEQUENCES OF CORRECTING ANY AND ALL CONFLICTS, DEFICIENCIES OR OTHER PROBLEMS AT NO INCREASE IN COST OR INCREASE IN CONSTRUCTION TIME ALLOTTED.
- D. THE INSTALLATION OF ALL DEVICES, INCLUDING MOUNTING HEIGHTS, SHALL BE FULLY ADA
- E. THE CONTRACTOR SHALL INCLUDE IN HIS SCOPE, (1) THE LABOR AND MATERIALS REQUIRED FOR CREATING OPENINGS FOR CONDUIT PENETRATIONS THROUGH WALLS, SLABS AND ROOF STRUCTURES, AS WELL AS THE SEALING OF THESE PENETRATIONS, AND (2) THE ROUTING OF CONDUITS AROUND IMPENETRABLE OBSTACLES, SUCH AS POURED-IN-PLACE BEAMS, COLUMNS, LINTELS AND SIMILAR OBSTRUCTIONS.
- F. THE CONTRACTOR SHALL VERIFY THE EXACT DIRECTION OF ALL DOOR SWINGS PRIOR TO ROUGH-IN OF BOXES MOUNTED IN WALLS.
- G. IF THE INTENT OF THE ARCHITECT/ENGINEER WITH REGARD TO ANY DETAIL IS NOT CLEAR, OR IS CAPABLE OF MORE THAN ONE INTERPRETATION, SUCH MATTERS SHALL BE BROUGHT TO THE A/E IN WRITING BEFORE THE SUBMISSION OF BIDS, AND THE A/E SHALL ISSUE CORRECTION OR CLARIFICATION IN WRITING. OTHERWISE, NO EXTRA COSTS OR EXTENSIONS OF TIME WILL BE BE ALLOWED FOR THE WORK OR MATERIAL THAT THE A/E WILL REQUIRE, PROVIDED THAT IT COMES WITHIN A REASONABLE INTERPRETATION OF THE
- H. THE CONTRACTOR SHALL THOROUGHLY CLEAN ALL EQUIPMENT TO BE COMPLETELY FREE OF INTERNAL DEBRIS AND EXTERIOR PAINT, MARKS, DIRT AND ALL SCRATCHES SHALL BE


	ARCHITECTURAL DESIGN COLLABO 945 N. PENNSYLVANIA AVENUE WINTER PARK, FLORIDA 32789 OFFICE: (407) 629-1188 FAX: (407) 388-1220 WWW. ADCINTERNATIONAL.NET	DRATIVE
	STATE OF FLORIDA MARIA FERREIRA Architect • Seal/Signature	AA-C001315 AR-95752
	Project Documents for: $\overrightarrow{Project Documents for:}$	
	Project: GREAT OAKS VILLAGE WITTENSTEIN ADA UPGRADES AND RENOVATIONS 1784 E. MICHIGAN STREET ORLANDO, FL 32806	COTTAGE
SPACE PLANNING		S KA S KA S KA S KA
 INTERIOR DESIGN 		
LANNI	Client Information ORANGE COUNTY CAPITAL PROJECT 400 E SOUTH STREET 5th FLOOR ORLANDO, FL 32801	S DIVISION
	၂၄၂B CONSTRUC Checked By K႔	Issue Date 02/27/2017 roject Status CTION ISSUE SET Scale
	File Name Q:\PROJECT FILES\2016\2016-066 Wittenstein H 1600-E001-2016066.dwg	louse Reno∖Drawir
	Consultant • Seal/Signature	
	JUSTIN L. MUNDELI	FL70700
	Sheet Title:	_
	Electrical General Notes	

E0.02

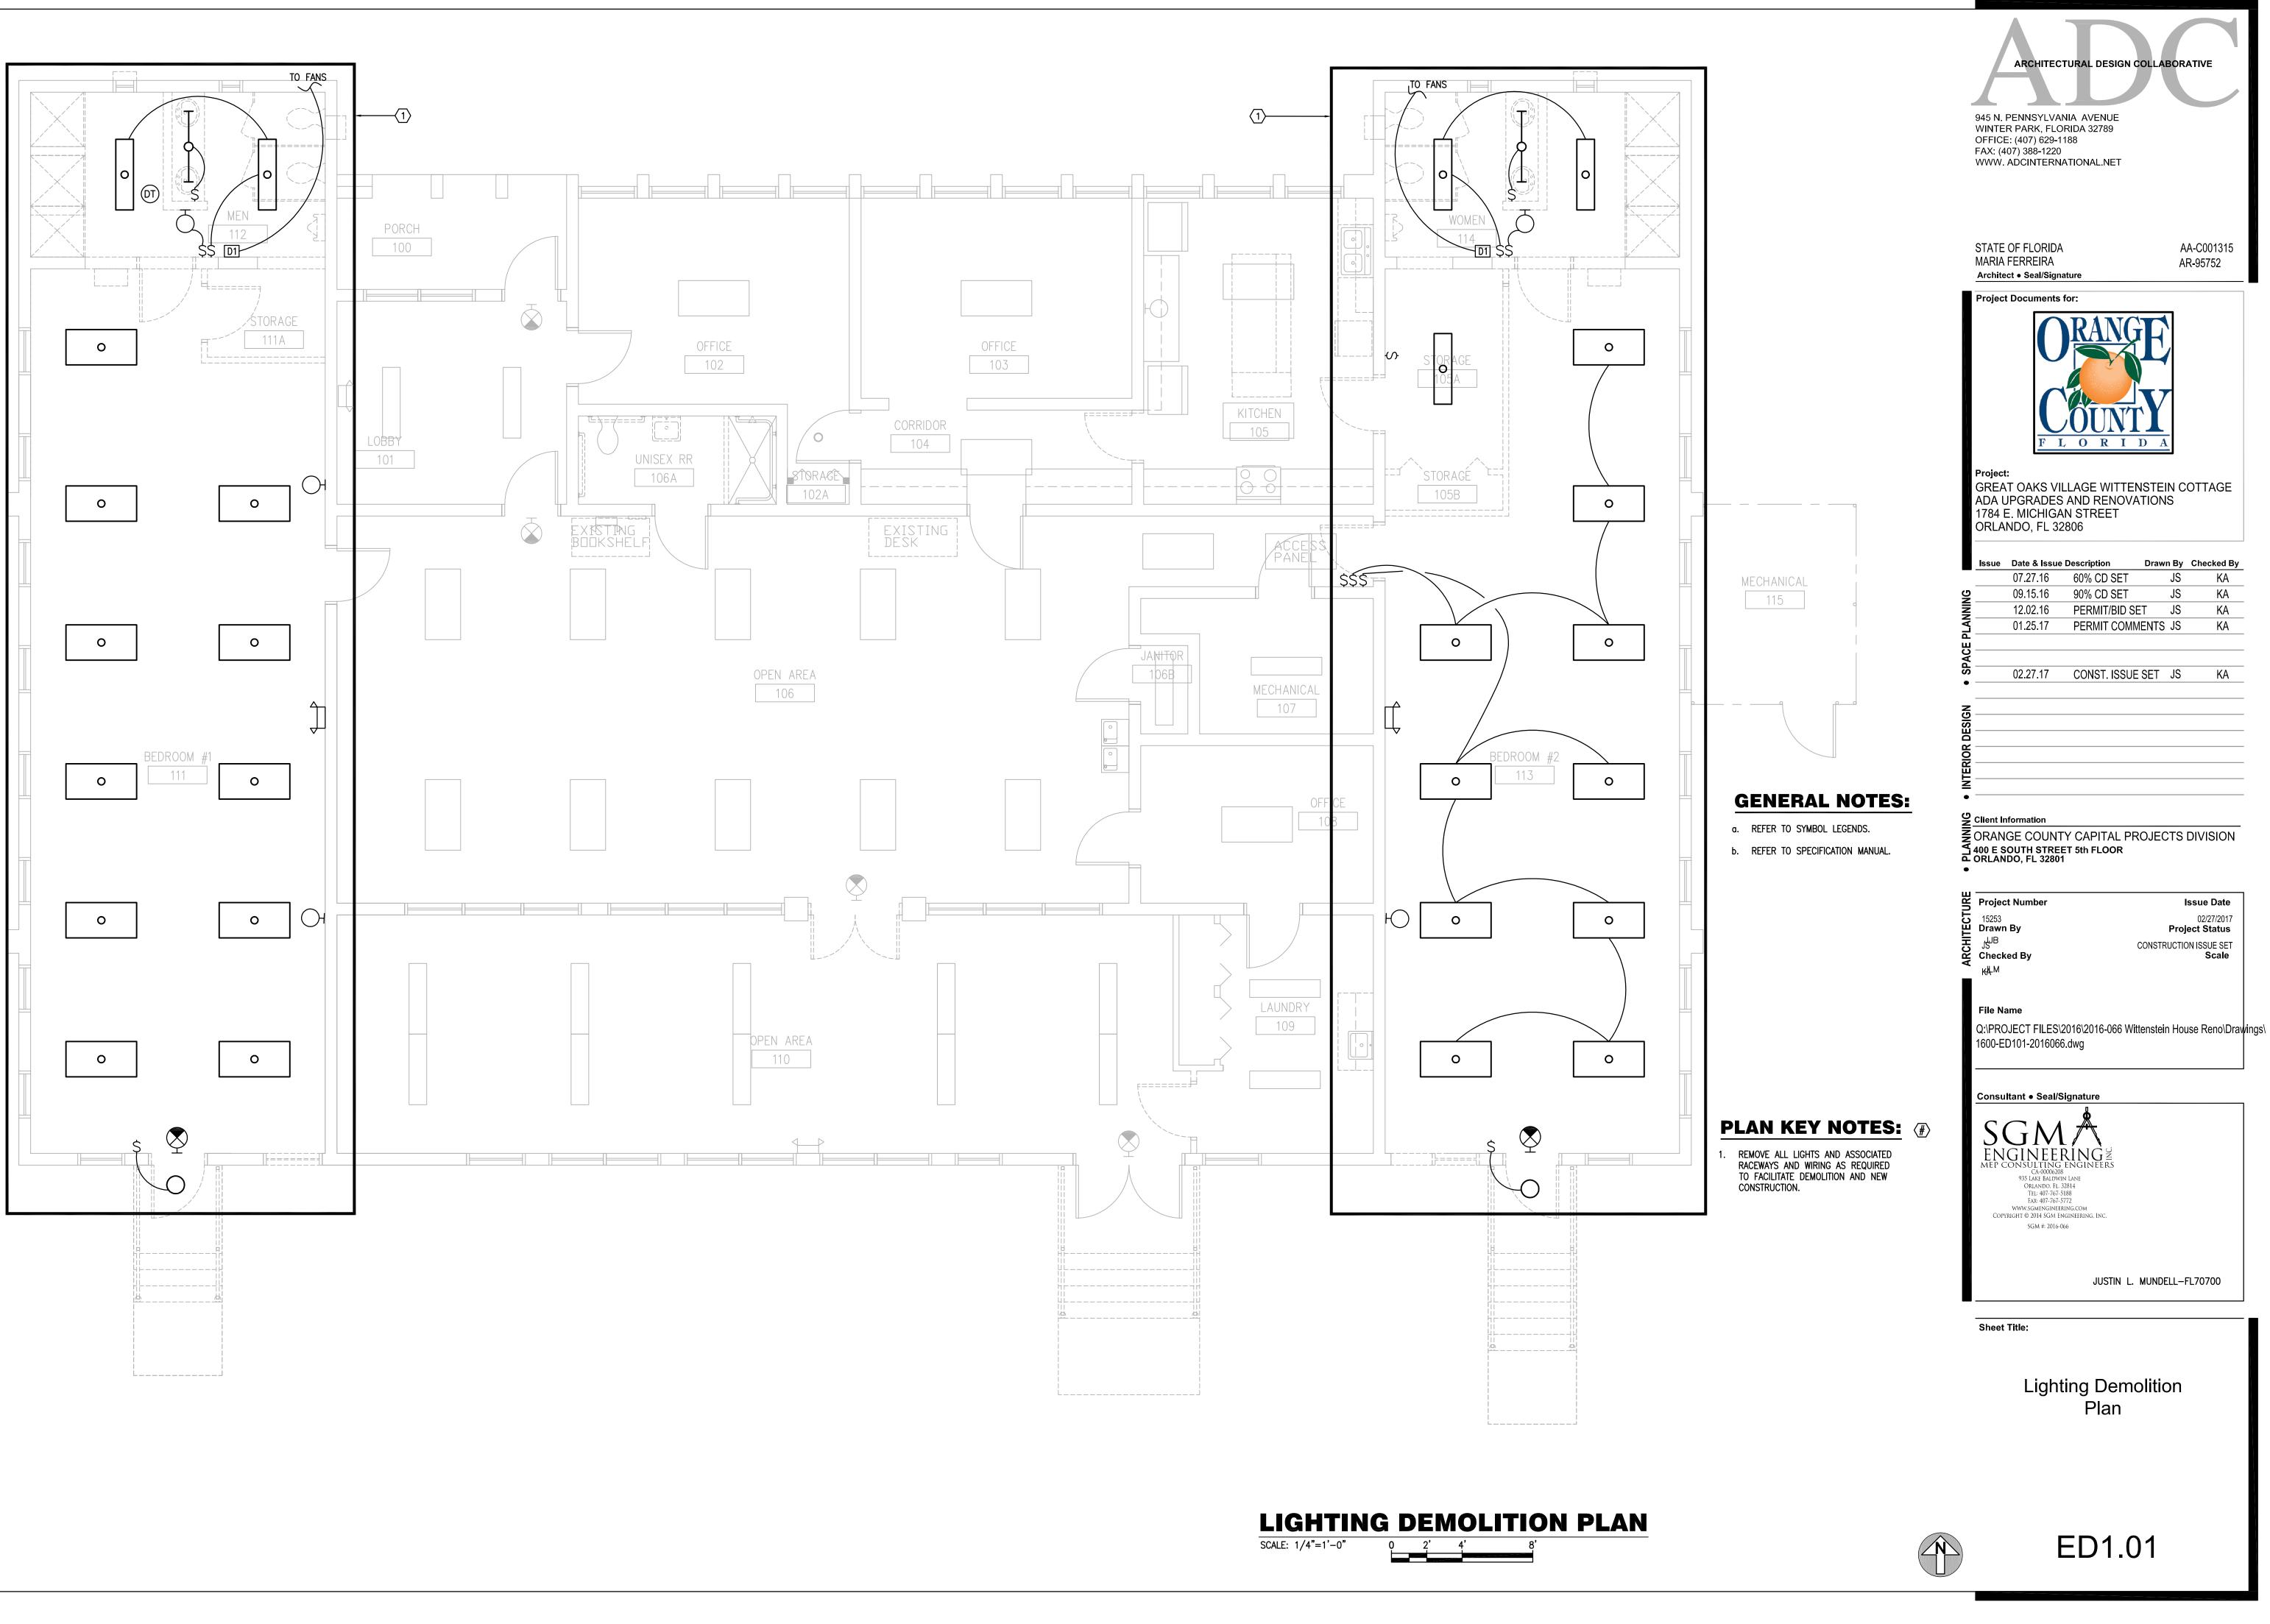


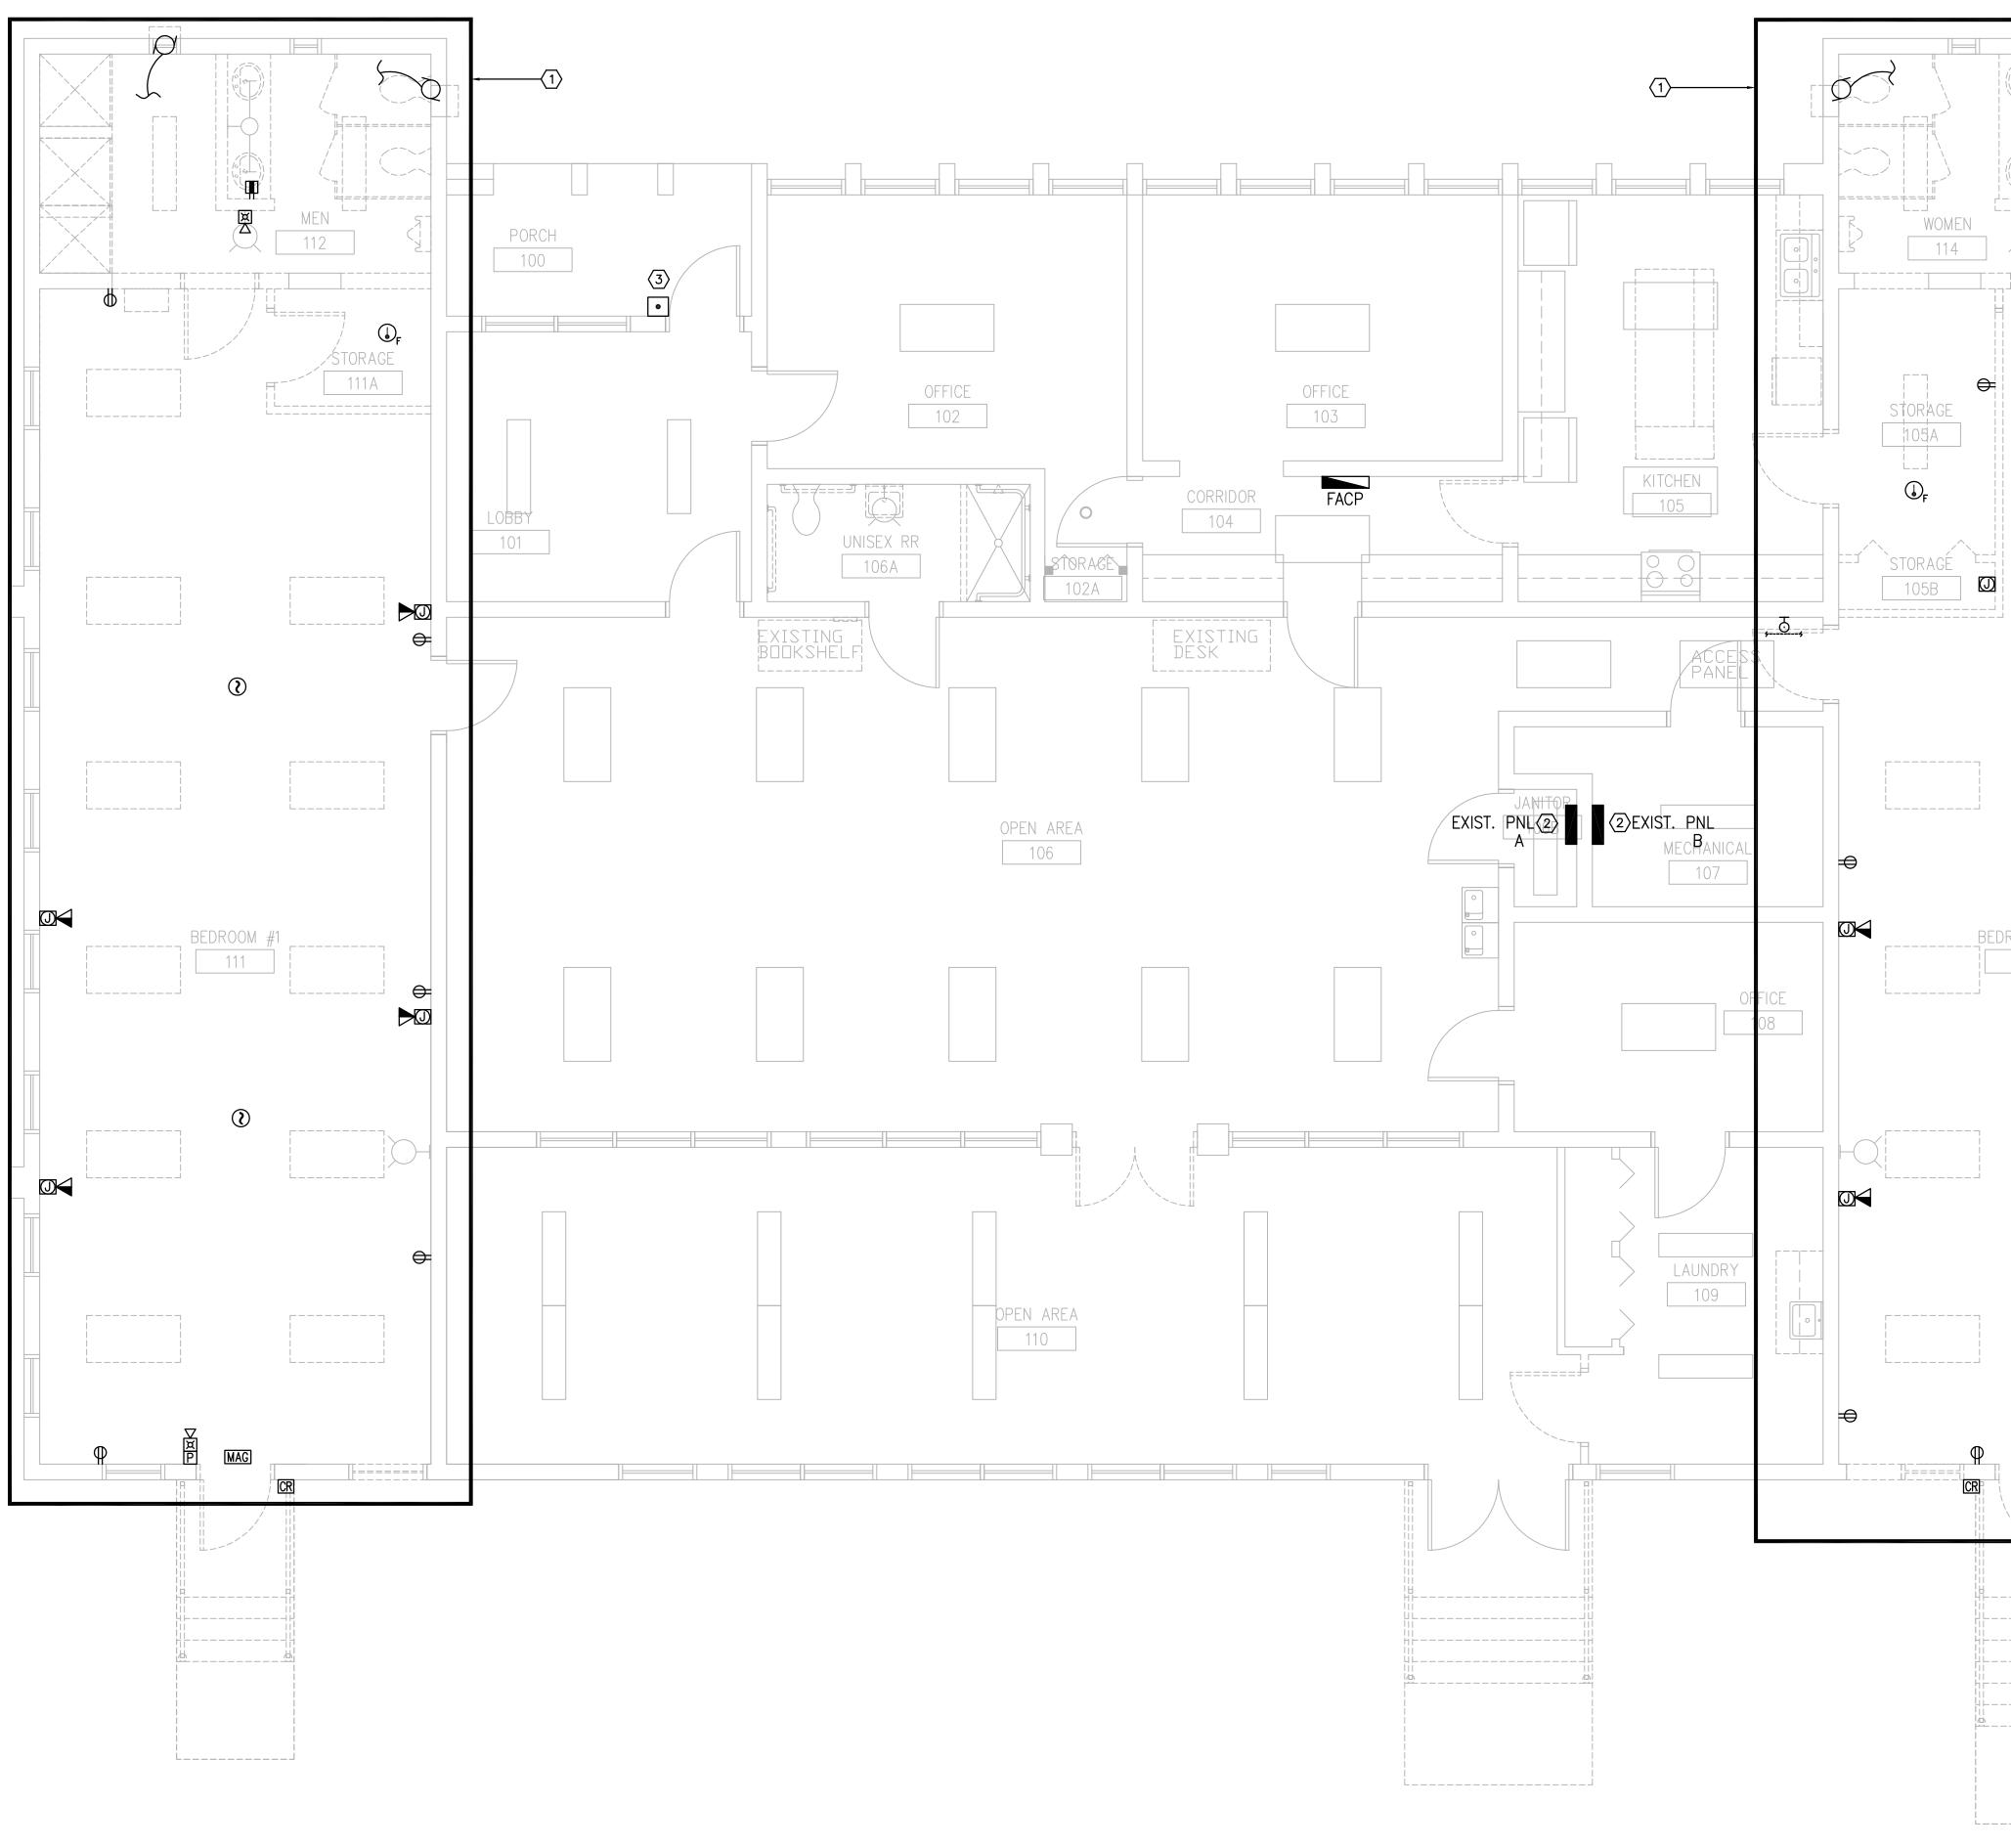


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EXIST.	MAIN ELECT SERVICE AND METER	ARCHITECTURAL DESIGN COLLABORATIVE 945 N. PENNSYLVANIA AVENUE WINTER PARK, FLORIDA 32789 OFFICE: (407) 629-1188 FAX: (407) 388-1220 WWW. ADCINTERNATIONAL.NET STATE OF FLORIDA MARIA FERREIRA AA-C001315 AR-95752 Architect • Seall/Signature
ROOM #2 113 G.	ENERAL NOTES: REFER TO SYMBOL LEGENDS.	Project Documents for: Image: Colspan="2">Image: Colspan="2" Colspan="2">Image: Colspan="2" Colspa="2" Colspa="2" Colspan="2" Colspan="2" Colspan="2" Col
MAG P 1. RE R/ RE AT 2. TE	AN KEY NOTES:	Project Number Issue Date 15253 02/27/2017 Drawn By Project Status JJB CONSTRUCTION ISSUE SET Checked By Scale WM Scale File Name Q:\PROJECT FILES\2016\2016-066 Wittenstein House Reno\Drawin 1600-ED102-2016066.dwg Consultant • Seal/Signature Consultant • Seal/Signature MEP CONSULTING ENGINEERS CA0000208 VISTARE RAIDWIN LANE ORLANDO, H. 32814 TE: 407-767-5372 YMW.SOGENGINEERING, INC.
3. RE	ND PROVIDE NEW TYPEWRITTEN PANEL RECTORY. EMOVE EXISTING DOORBELL SYSTEM ND PREPARE FOR REPLACEMENT.	SGM #: 2016-066 JUSTIN L. MUNDELL-FL70700 Sheet Title: Power Demolition Plan

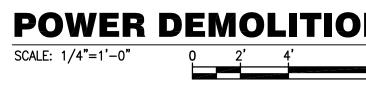



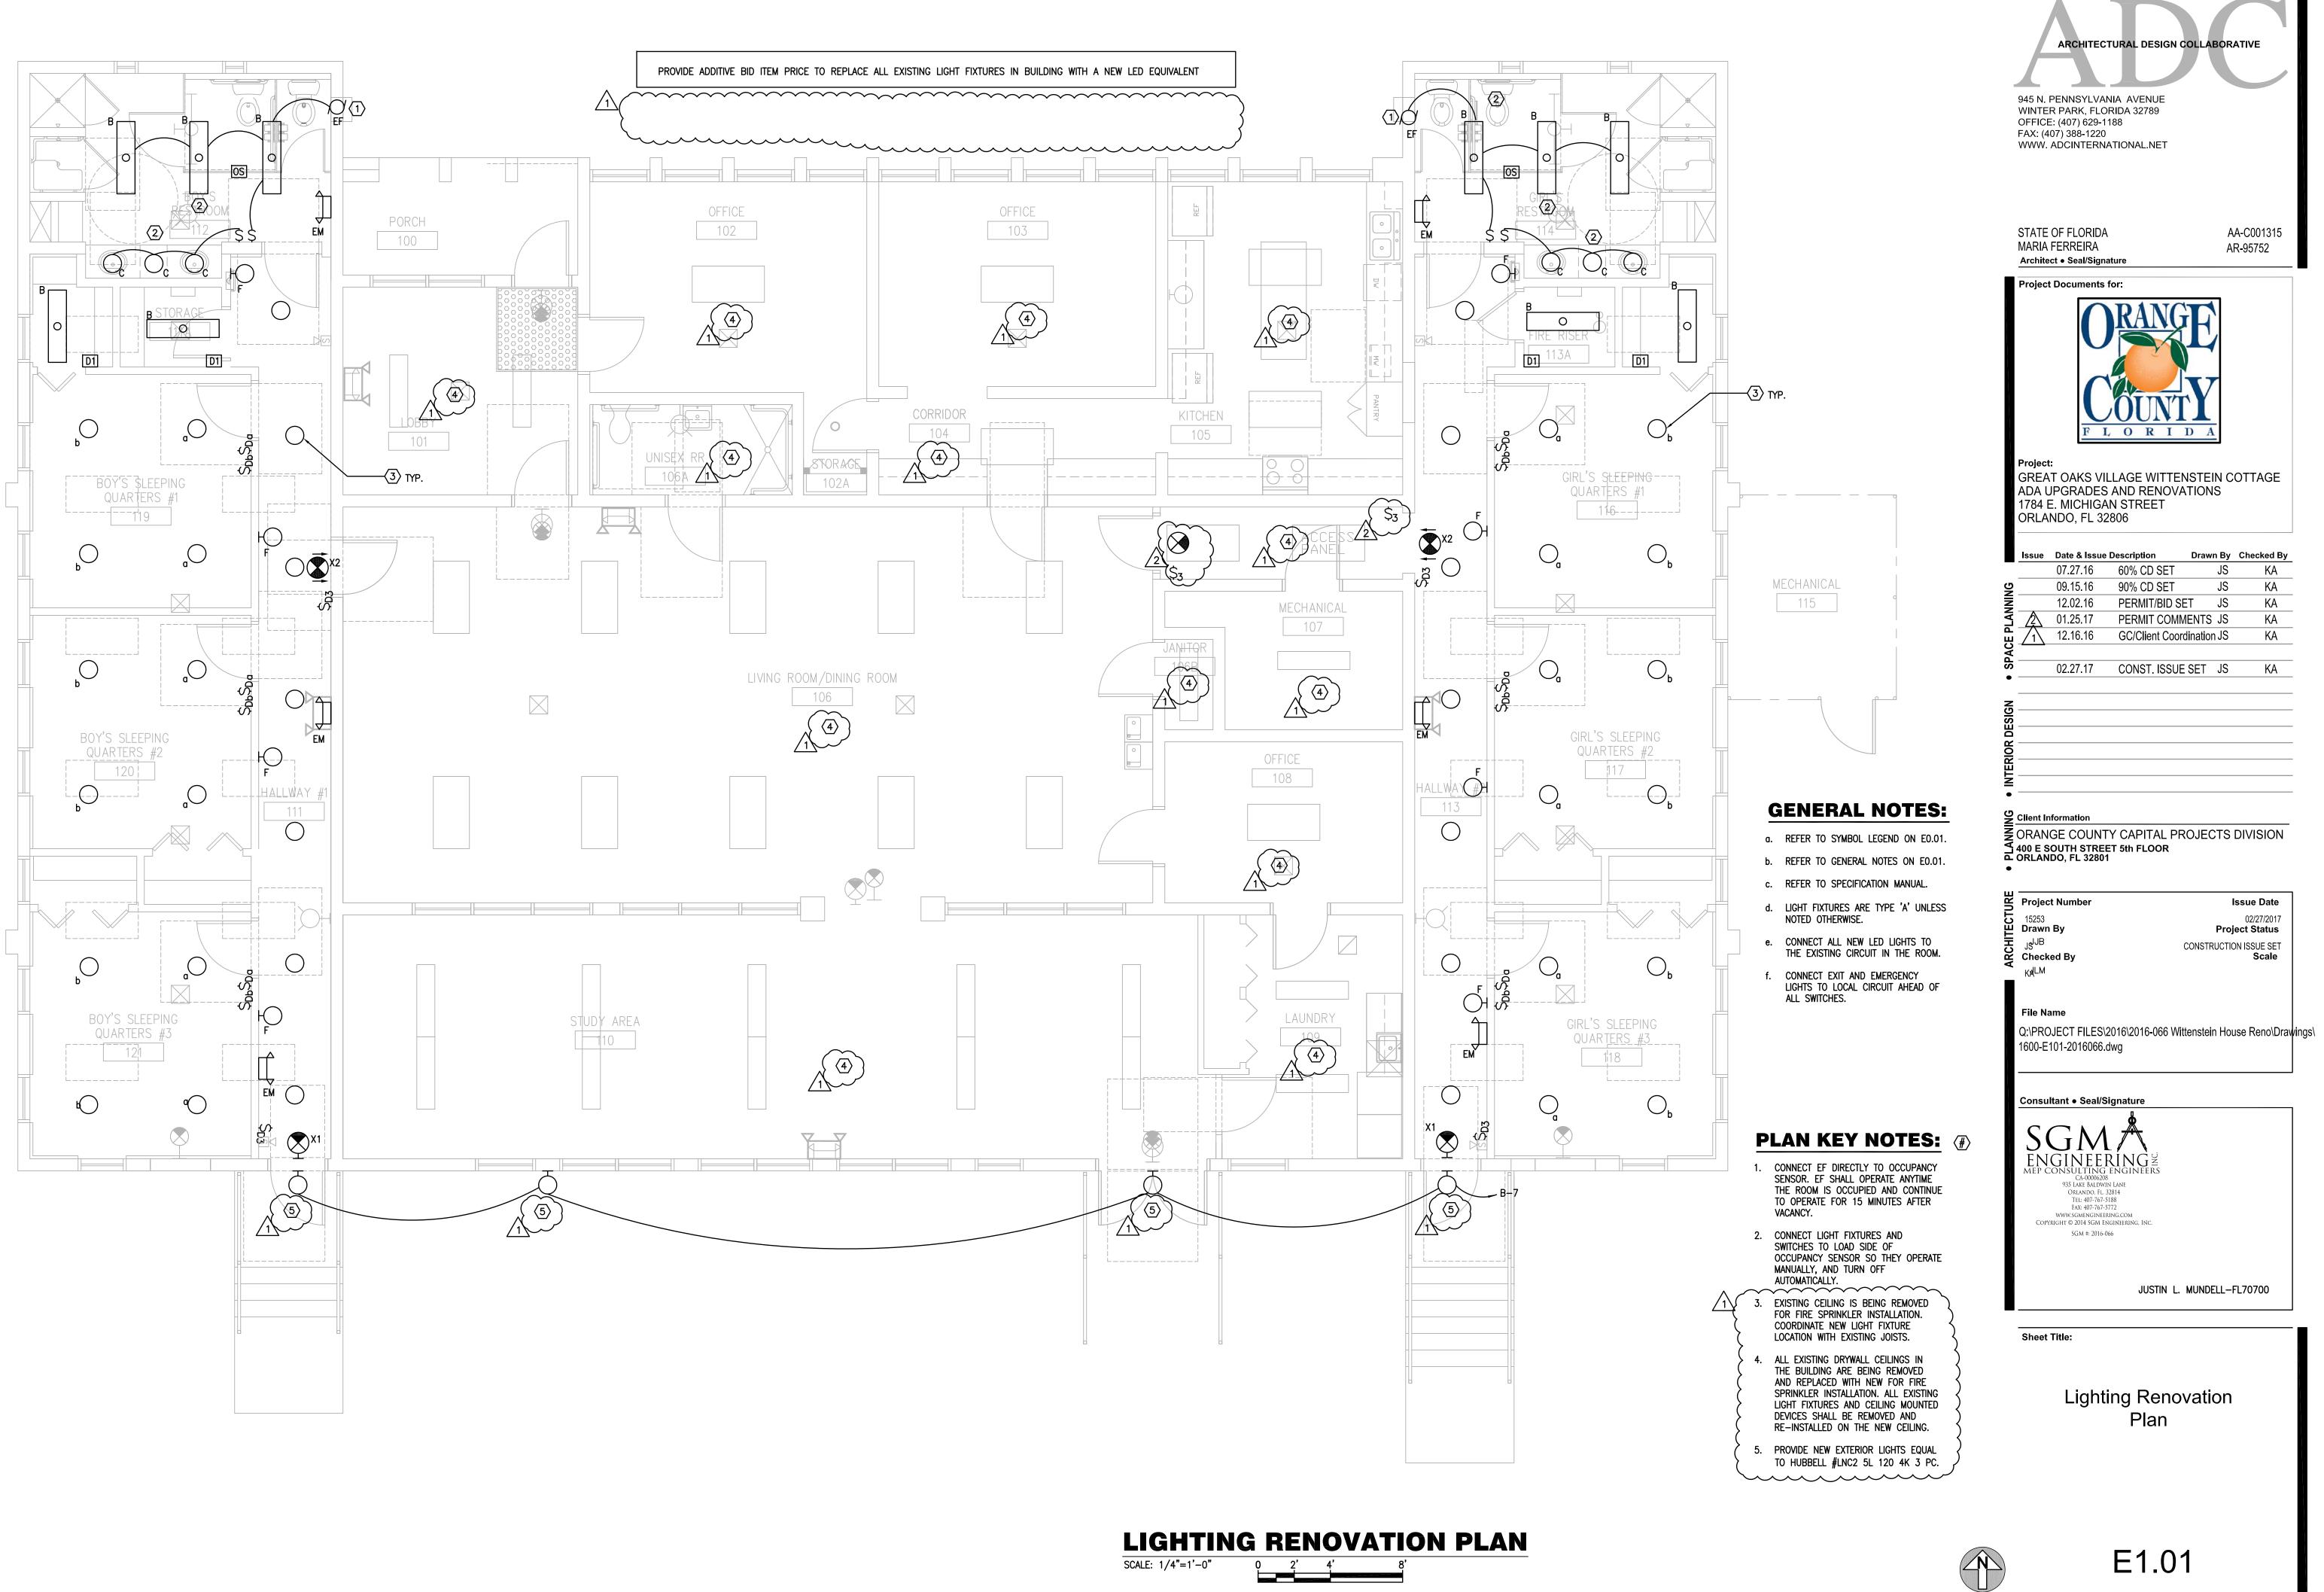

RINTED ON: Feb 27, 2017 - 1:18pm

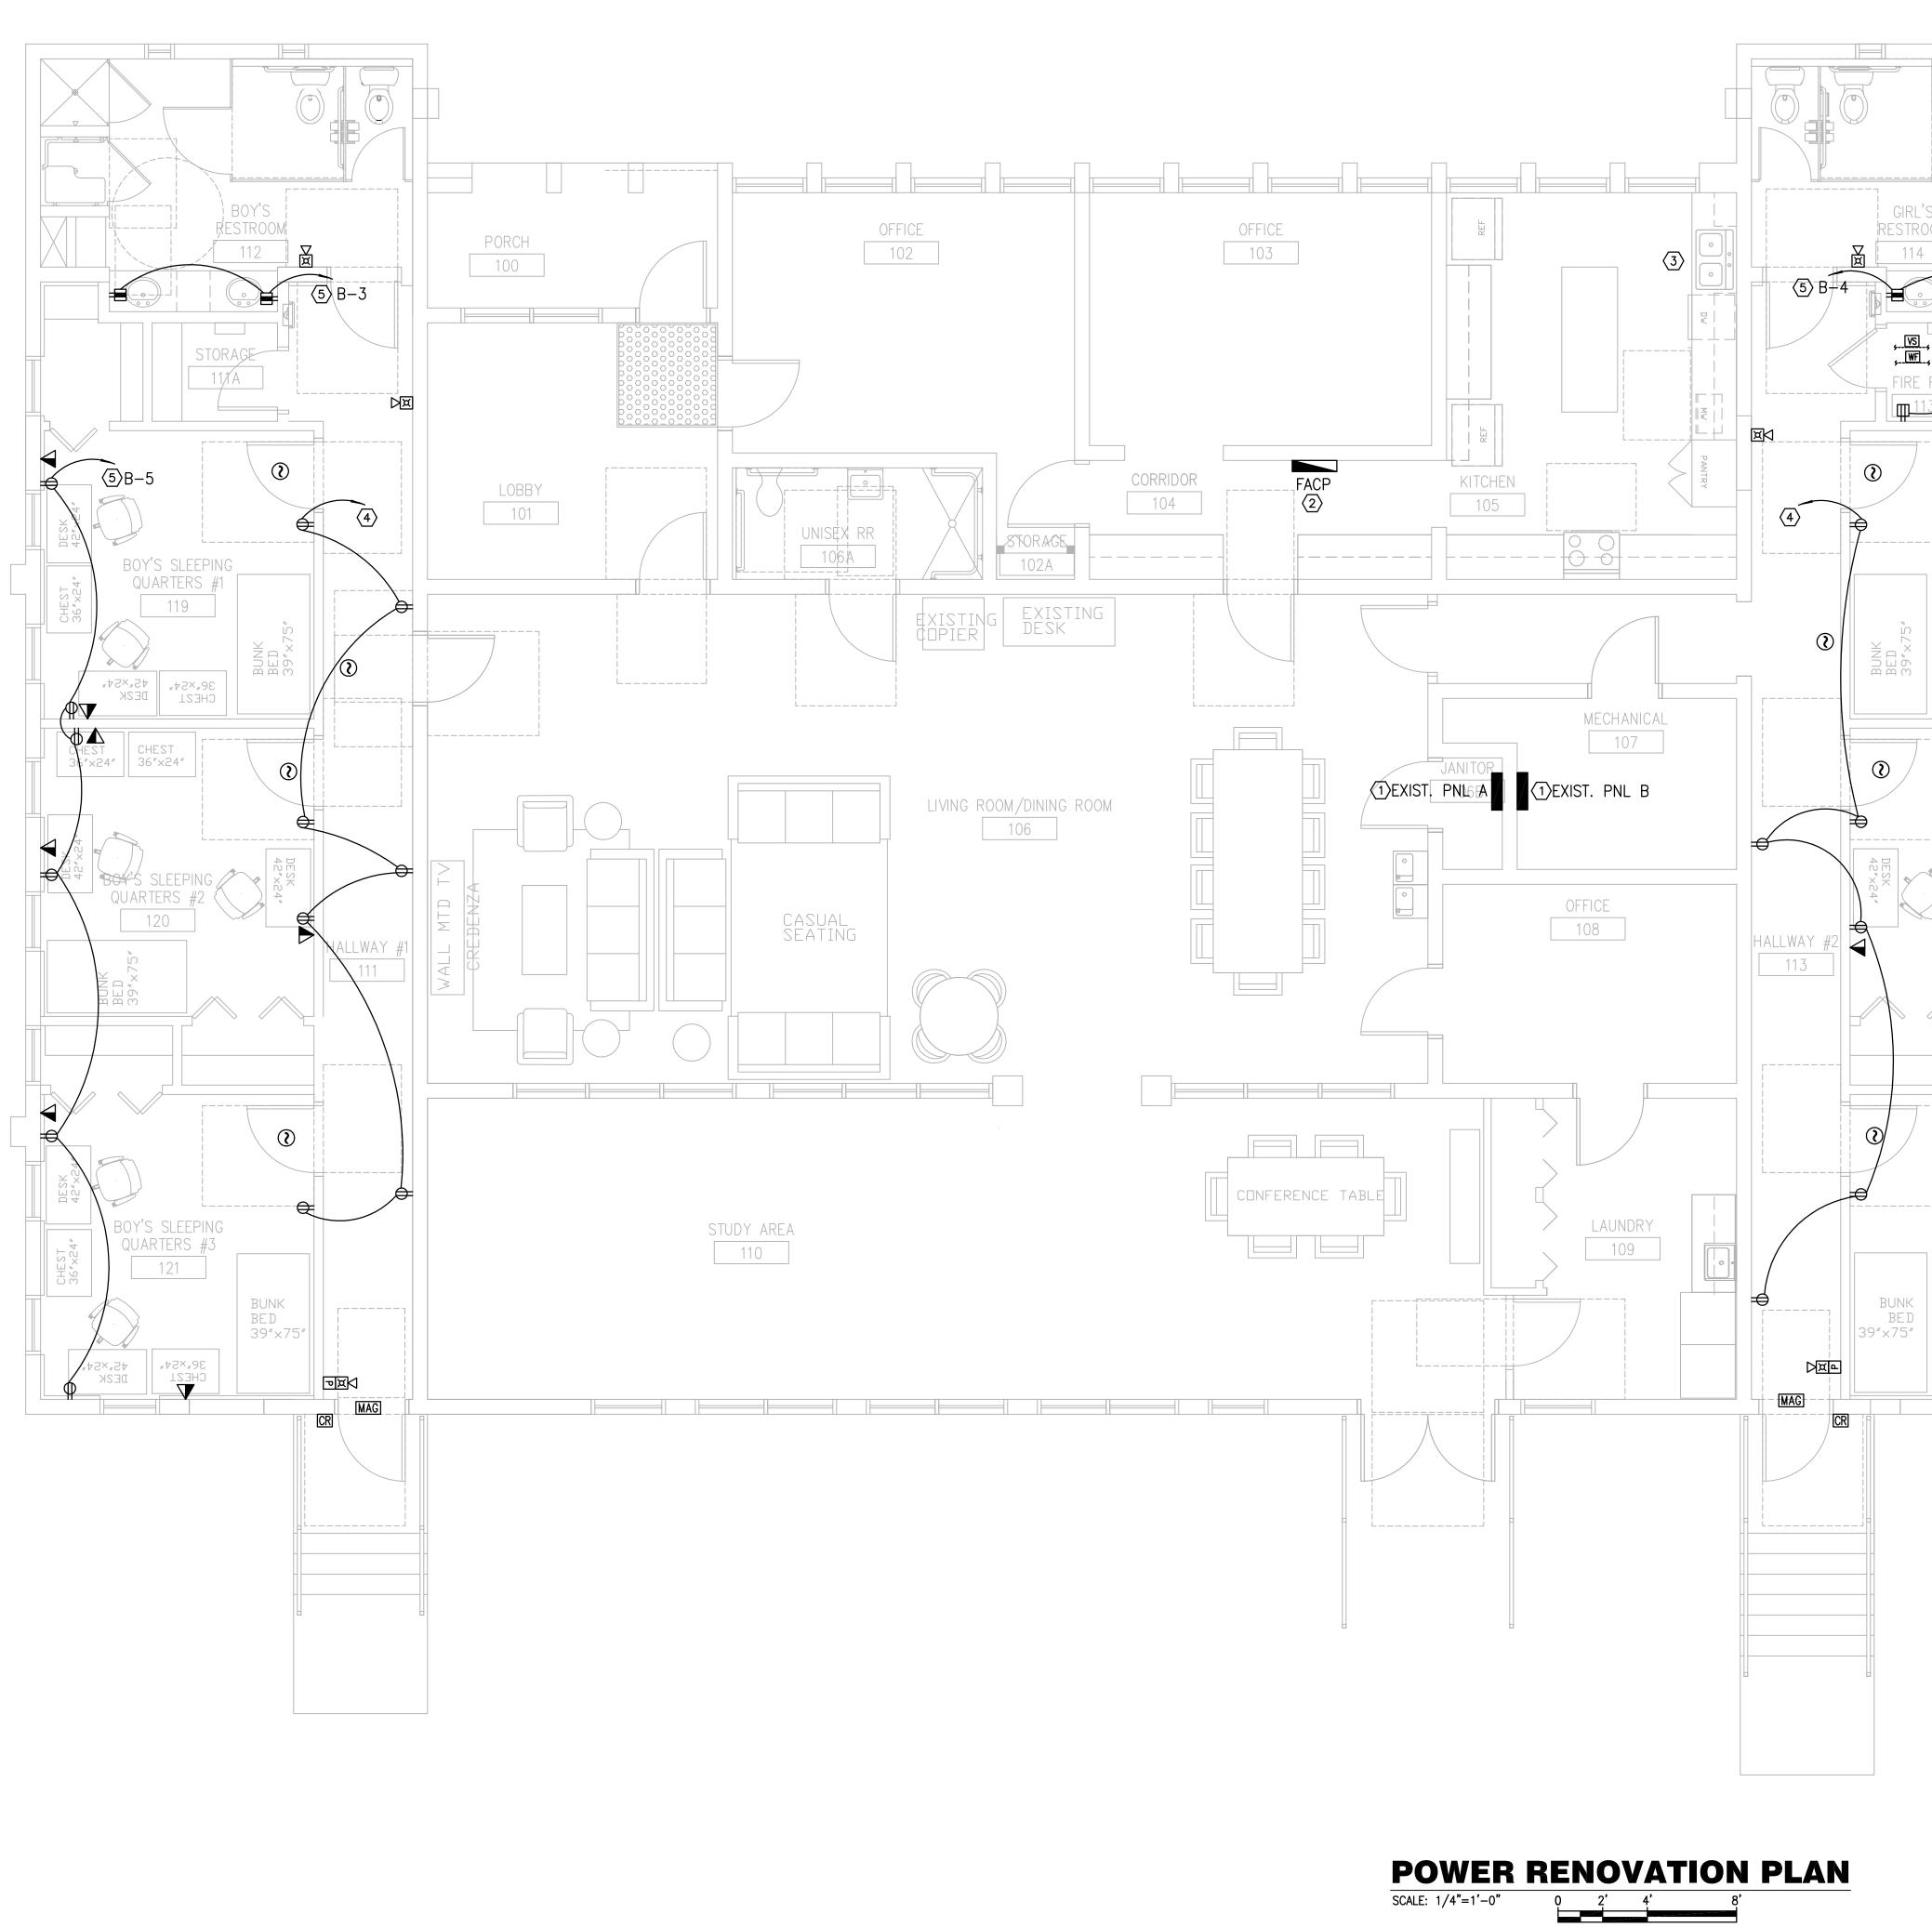, <u>vs</u> , 6	ARCHITECTURAL DESIGN CO	PLLABORATIVE
EXIST. MAIN ELECT SERVICE AND METER	WINTER PARK, FLORIDA 32789 OFFICE: (407) 629-1188 FAX: (407) 388-1220 WWW. ADCINTERNATIONAL.NET	
	STATE OF FLORIDA MARIA FERREIRA Architect • Seal/Signature	AA-C001315 AR-95752
$\overline{2}$ RISER $\overline{3}$ $\overline{5}$ B-6	Project Documents for:	E Y
GIRL'S SLEEPING QUARTERS #1 116 36"X24"	Project: GREAT OAKS VILLAGE WITTENS ADA UPGRADES AND RENOVAT 1784 E. MICHIGAN STREET ORLANDO, FL 32806	STEIN COTTAGE
LADINAHDAM	07.27.16 60% CD SET 09.15.16 90% CD SET 12.02.16 PERMIT/BID SET	
CHEST 36"x24"	Image: Weight of the second	
GIRL'S SLEEPHAG QUARTERS #2 117		
a. REFER TO SYMBOL LEGENDS.	Client Information ORANGE COUNTY CAPITAL PRO 400 E SOUTH STREET 5th FLOOR ORLANDO, FL 32801	DJECTS DIVISION
c. ALL NEW RECEPTACLE OUTLETS SHALL BE TAMPER-RESISTANT TYPE AS PER NEC 406.12/14.	Project Number 15253 Drawn By JS ^{JJB} CC	Issue Date 02/27/2017 Project Status
	H Js ^{JJB} CC Checked By K∦LM	ONSTRUCTION ISSUE SET Scale
GIRL'S SLEEPING QUARTERS #3 118	File Name Q:\PROJECT FILES\2016\2016-066 Witte 1600-E102-2016066.dwg	nstein House Reno∖Drawi
	Consultant • Seal/Signature	
#t2×.32 #t2×.2t ISBHO ISBHO ISBHO ISBHO <t< td=""><td>SGM ENGINEERING MEP CONSULTING ENGINEERS CA00006208 935 LAKE BALDWIN LANE ORLANDO, FL. 32814</td><td></td></t<>	SGM ENGINEERING MEP CONSULTING ENGINEERS CA00006208 935 LAKE BALDWIN LANE ORLANDO, FL. 32814	
2. EXPAND AND UPDATE EXISTING SILENT KNIGHT #5207 FACP TO ACCOMMODATE NEW FIRE ALARM DEVICES.	TEL: 407-767-5188 FAX: 407-767-5772 www.sgmengineering.com Copyright © 2014 SGM Engineering, Inc. SGM #: 2016-066	
3. INTERCEPT AND EXTEND EXISTING CIRCUIT AT COUNTER AS REQUIRED TO EXTEND CIRCUIT AND LOWER DEVICES TO NEW COUNTER TOP HEIGHT.	JUSTIN L. M	UNDELL-FL70700
 CONNECT TO EXISTING RECEPTACLE CIRCUIT IN THIS ROOM MADE AVAILABLE DURING DEMOLITION. CONNECT NEW CIRCUIT TO EXISTING 	Sheet Title:	
PANEL. 6. MAKE CONNECTION TO NEW TAMPER SWITCHES AT NEW BACKFLOW PREVENTOR/PIV VALVES. VERIFY EXACT LOCATION ON SITE. 7. MAKE CONNECTION TO NEW TAMPER AND FLOW SWITCHES AT NEW FIRE RISER.	Power Renova Plan	ation
) E1.02	

	MANUFACTURER:SQ. D.TYPE:NQODAIC RATING:10VOLTS L-N:120VOLTS L-L:240PHASE1	K A V V	AMPS			MAIN OF S.E R SHUNT	MC ML ATE	:B: .O: :D:	N/A	ED AMPS AMPS			Ρ	PANEL NAME:EX PNL BLOCATION:MECH ROOMMOUNTING:SURFACENEMA TYPE:1WIDTH :20.00DEPTH :5.75	IN IN	
	IDENTIFICATION	L O A D		/PHASE	(KVA)	CIRCL				LOAD/	PHASE	. ,	L O A D	IDENTIFICATION	CKT NO.	N C T E S
			A	В		TRIP	Р		TRIP		A	В	\square			
1	SPARE	S				20	1		20		0.90		E	MICROWAVE	2	
2 3	NEW GFI RECEPTS	R		0.36		20	1	1	20			0.36	R	NEW GFI RECEPTS	4	2
2 5	NEW BEDROOM RECEPTS	R	1.08			20	1		20		1.08		R	NEW BEDROOM RECEPTS	6	2
7	SPARE	S					1	1					S	SPARE	8	
9		R	0.36			20	1	1					S	SPARE	10	
11	OFFICE RECEPT	R		0.90		20	1	1	20			0.36	R	KITCHEN RECEPT	12	
13	DISPOSAL	E	0.50			20	1		20		0.36		R	KITCHEN RECEPT	14	
15	GFI RECEPT	R		0.54		20	1	1	20			0.36	R	KITCHEN RECEPT	16	
17	REFRIGERATOR	E	0.50			20	1	1	20		0.50		E	REFRIGERATOR	18	
19	PHONE SYSTEM	E		0.50		20	1	1	20			0.60	E	DISHWASHER	20	
21		R	0.90			20	1	1	20		0.90		E	MICROWAVE	22	
23		E		0.50		20	1	1	20			0.54	R	GFI RECEPT	24	
25	OFFICE RECEPT	R	1.08			20	1	1	20		0.36		R	GFI RECEPT	26	
27	FIRE ALARM PANEL	E		0.50		20	1	2	30			2.25	E	WATER HEATER	28	
29	EXIT/EM LIGHT CIRCUIT	L	0.50			20	1				2.25		E		30	
							+						+			
							+									-
							+						+			_
							+									_
					EED LUG	S AS INL			J, IF BLF	NINK (INU I	05ED)					
							2									
<u> </u>			4.9	3.3			<u> </u>				6.4	4.5	1			
		l	1.0	0.0	1						0.1	1.0	1			
	LIGHTING (L)		NN. LOAD (KVA) 0.50	DEMAND FACTOR 1.25	DEMAND LOAD (KVA) 0.63			ΓAL	CONNE TOTAI	ONNECTE CTED AN DEMAN	IPS/PH: ID KVA:	79 19.17	, ,			
	RECEPTACLES 1ST 10 KVA(R) RECEPTACLES OVER 10KVA(R) HVAC EQUIPMENT (H))	8.64 0.00 0.00	1.00 0.50 1.00	8.64 0.00 0.00		NO	DTES	S:				-	HE PANEL IN ACCORDANCE WITH		
	APPLIANCES (A) EQUIPMENT (E) LARGEST MOTOR (M))	0.00 9.90 0.00	1.00 1.00 1.25	0.00 9.90 0.00					E AS SPEC EW C.B.		RCUIT F	OR N	IEW RECEPTACLES.		
	OTHER (O) SPARE (S))	0.00	1.00 1.00	0.00											
	LINKED PANEL (P))N	ICLUDED I	NABOVE	IOIALS	l										

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MARIA	OF FLORIDA FERREIRA		AA-C AR-9	001315 5752
	t Documents			
ADA l	AT OAKS VI JPGRADES	LLAGE WITTEN	STEIN COT	TAGE
	E. MICHIGA NDO, FL 32			
Issue	Date & Issue 07.27.16 09.15.16 12.02.16 01.25.17	Description 60% CD SET 90% CD SET PERMIT/BID SET PERMIT COMME	JS JS T JS	necked By KA KA KA KA
<u>Client li</u> ORAN	02.27.17	CONST. ISSUE S		KA /ISION
	nformation IGE COUNT	CONST. ISSUE S	DJECTS DIV	
Projec 15253 Drawr J ^{JB}	nformation IGE COUNT SOUTH STREI IDO, FL 32807	TY CAPITAL PRO ET 5th FLOOR 1	DJECTS DIV	/ISION /ISION ие Date 2/27/2017 Status
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Project 15253 Drawr JSJB Check KAM File N Q:\PRC 1600-E Consu Consu	nformation IGE COUNT SOUTH STREI IDO, FL 32807 Ct Number n By Ked By ame DJECT FILES/C 401-2016066.0 Iltant • Seal/S GINEES CA-0006200 935 LAKE BALDWI ORLANDO, FL 107.67-5 FAX: 407.767-5 YWW.SGMENGINEE PATTEL: 407.767-5 YWW.SGMENGINEE PATTEL: 407.767-5 YWW.SGMENGINEE PATTEL: 407.767-5 YWW.SGMENGINEE PATTEL: 407.767-5 YWW.SGMENGINEE PATTEL: 407.767-5 YWW.SGMENGINEE YRIGHT © 2014 SGM EF SGM #: 2016-C	TY CAPITAL PRO TY CAPITAL PRO ET 5th FLOOR 2016\2016-066 Witted dwg 3016\2016-066 Witted 3016\2016-066 Witted 3016-066 Witted 3	DJECTS DIN Issu Project	/ISION /ISION /ISION Status SSUE SET Scale Reno\Dra

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